

## Appendix B Concept Design Drawings

# BARANGAROO FERRY HUB PRELIMINARY DESIGN

## FINAL CONCEPT DESIGN SKETCHES



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CONSTRUCTION

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REV	BY	DATE	DESCRIPTION	APPD.
C	DRM	31.10.14	FINAL CONCEPT DESIGN	
B	DRM	10.10.14	ALTERNATE CONCEPT DESIGN	
A	DRM	05.09.14	PRELIMINARY CONCEPT DESIGN	
A1	Original		Co-ordinate System: MGA Zone 56 Height Datum: A.H.D. Scale: NTS	

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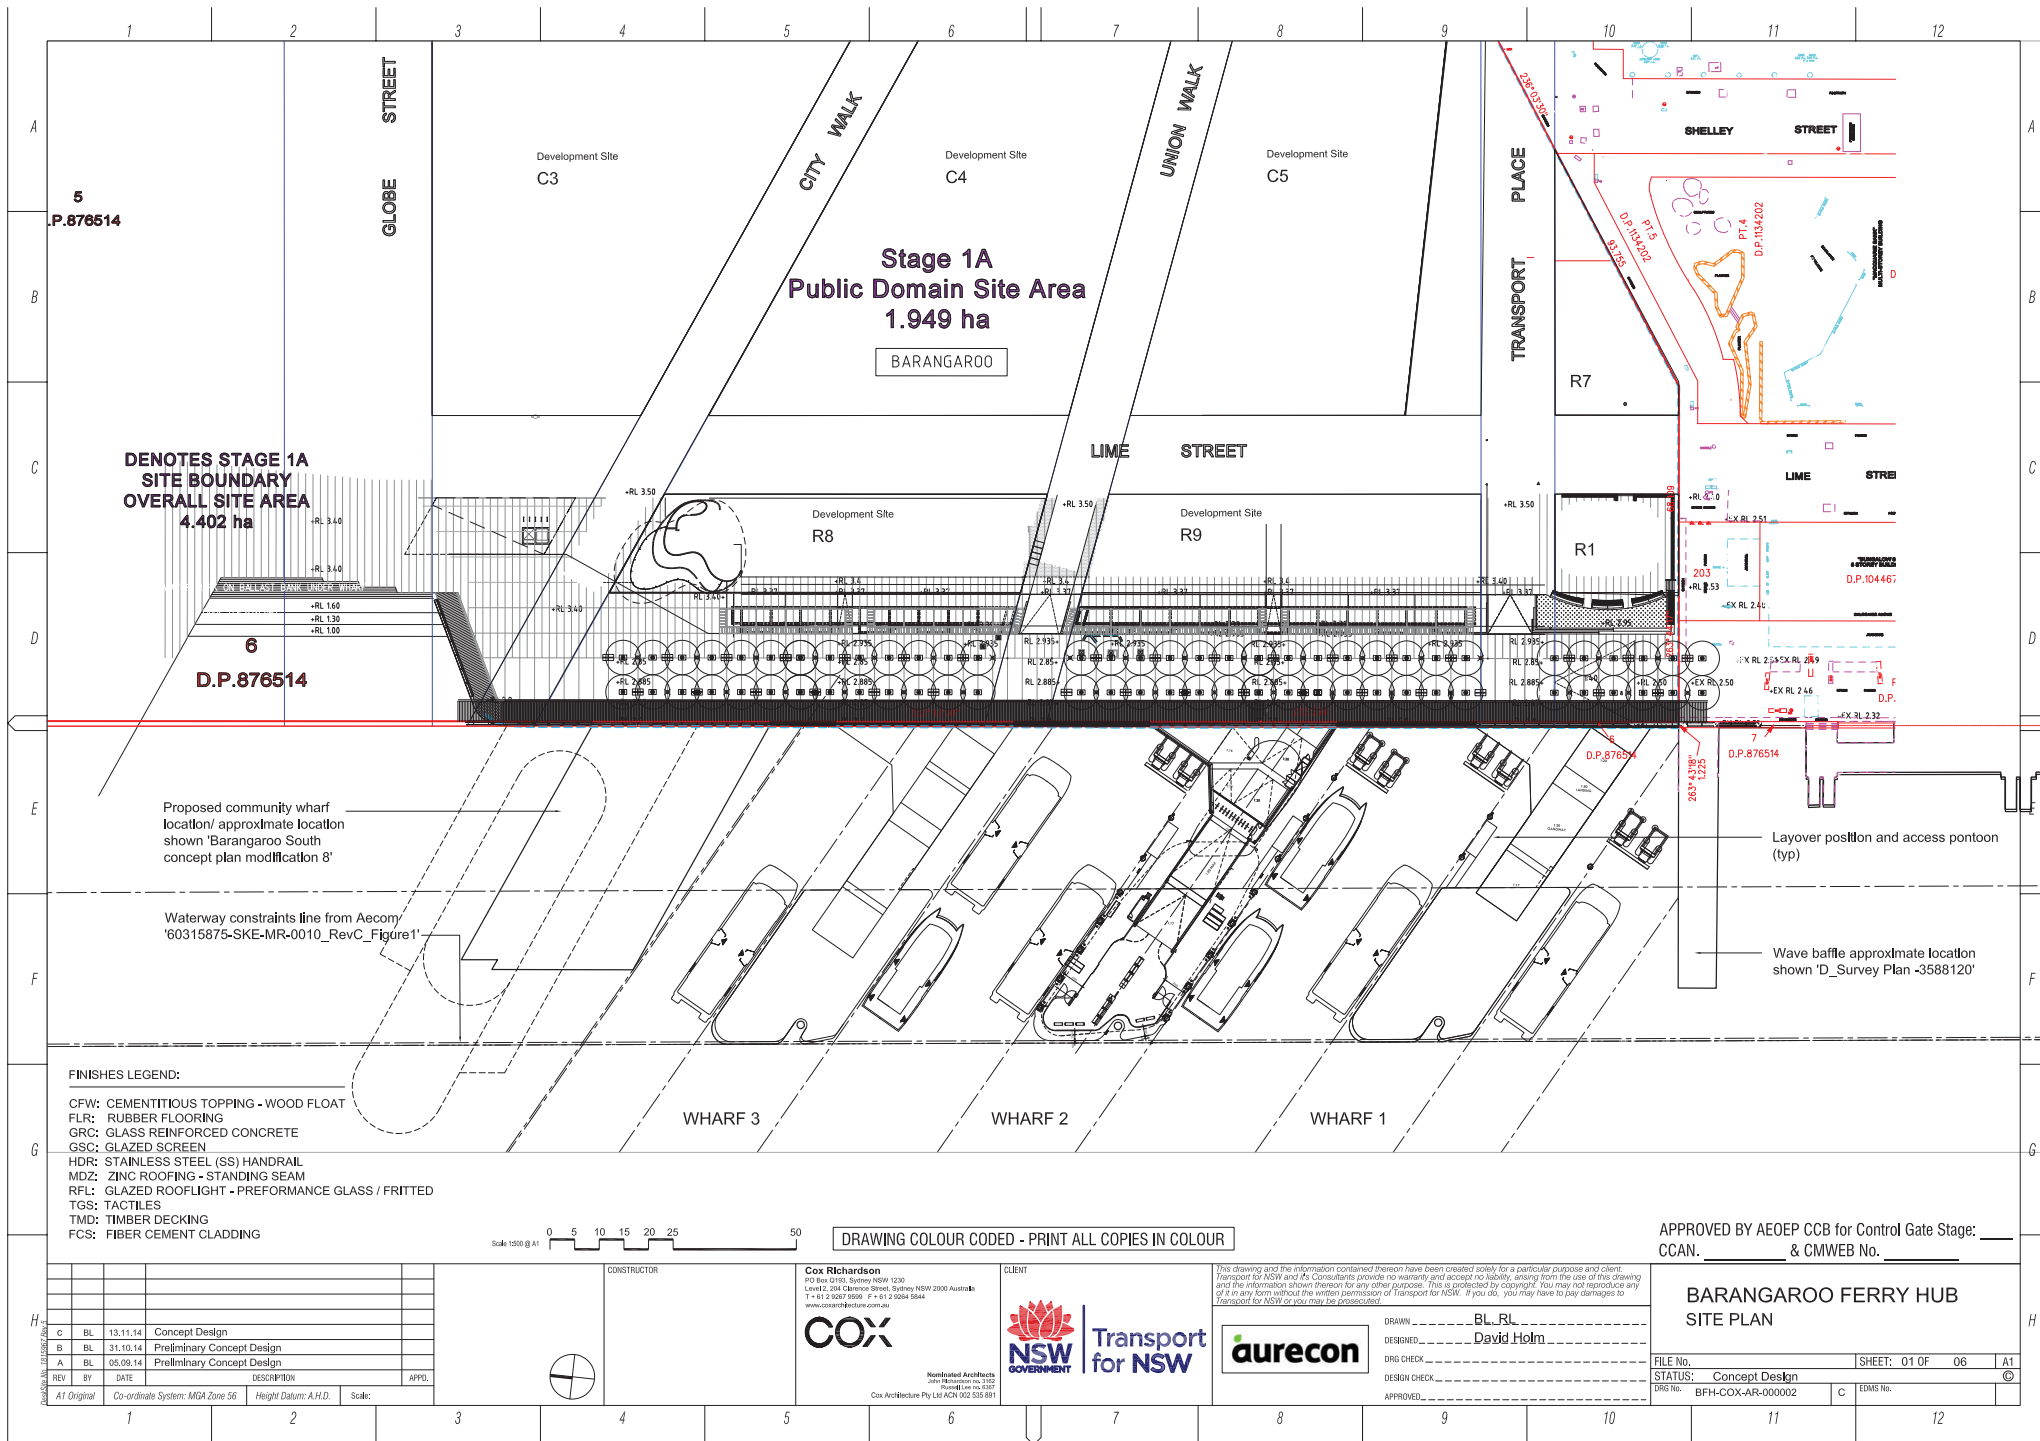


DRAWN: D. MULLER  
DESIGNED:  
DRG CHECK:  
DESIGN CHECK:  
APPROVED:

APPROVED BY AEOEP CCB for Control Gate Stage: \_\_\_\_\_  
CCAN. \_\_\_\_\_ & CMWEB No. \_\_\_\_\_

BARANGAROO FERRY HUB  
DARLING HARBOUR  
TITLE SHEET

FILE No. \_\_\_\_\_ SHEET: 1 OF 1 A1  
STATUS: PRELIMINARY CONCEPT DESIGN ©  
DRG No. BFH-AUR-GN-000001 C EEMS No. \_\_\_\_\_



**FINISHES LEGEND:**

- CFW: CEMENTITIOUS TOPPING - WOOD FLOAT
- FLR: RUBBER FLOORING
- GRC: GLASS REINFORCED CONCRETE
- GSC: GLAZED SCREEN
- HDR: STAINLESS STEEL (SS) HANDRAIL
- MDZ: ZINC ROOFING - STANDING SEAM
- RFL: GLAZED ROOFLIGHT - PREFORMANCE GLASS / FRITTED
- TGS: TACTILES
- TMD: TIMBER DECKING
- FCS: FIBER CEMENT CLADDING

Scale 1:500 @ A1

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**BARANGAROO FERRY HUB  
SITE PLAN**

REV	BY	DATE	DESCRIPTION	APPD.
C	BL	13.11.14	Concept Design	
B	BL	31.10.14	Preliminary Concept Design	
A	BL	05.09.14	Preliminary Concept Design	
AT	Original		Co-ordinate System: MGA Zone 56	
			Height Datum: A.H.D.	
			Scale:	



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**COX**

Notified Architects  
John Richardson no. 3152  
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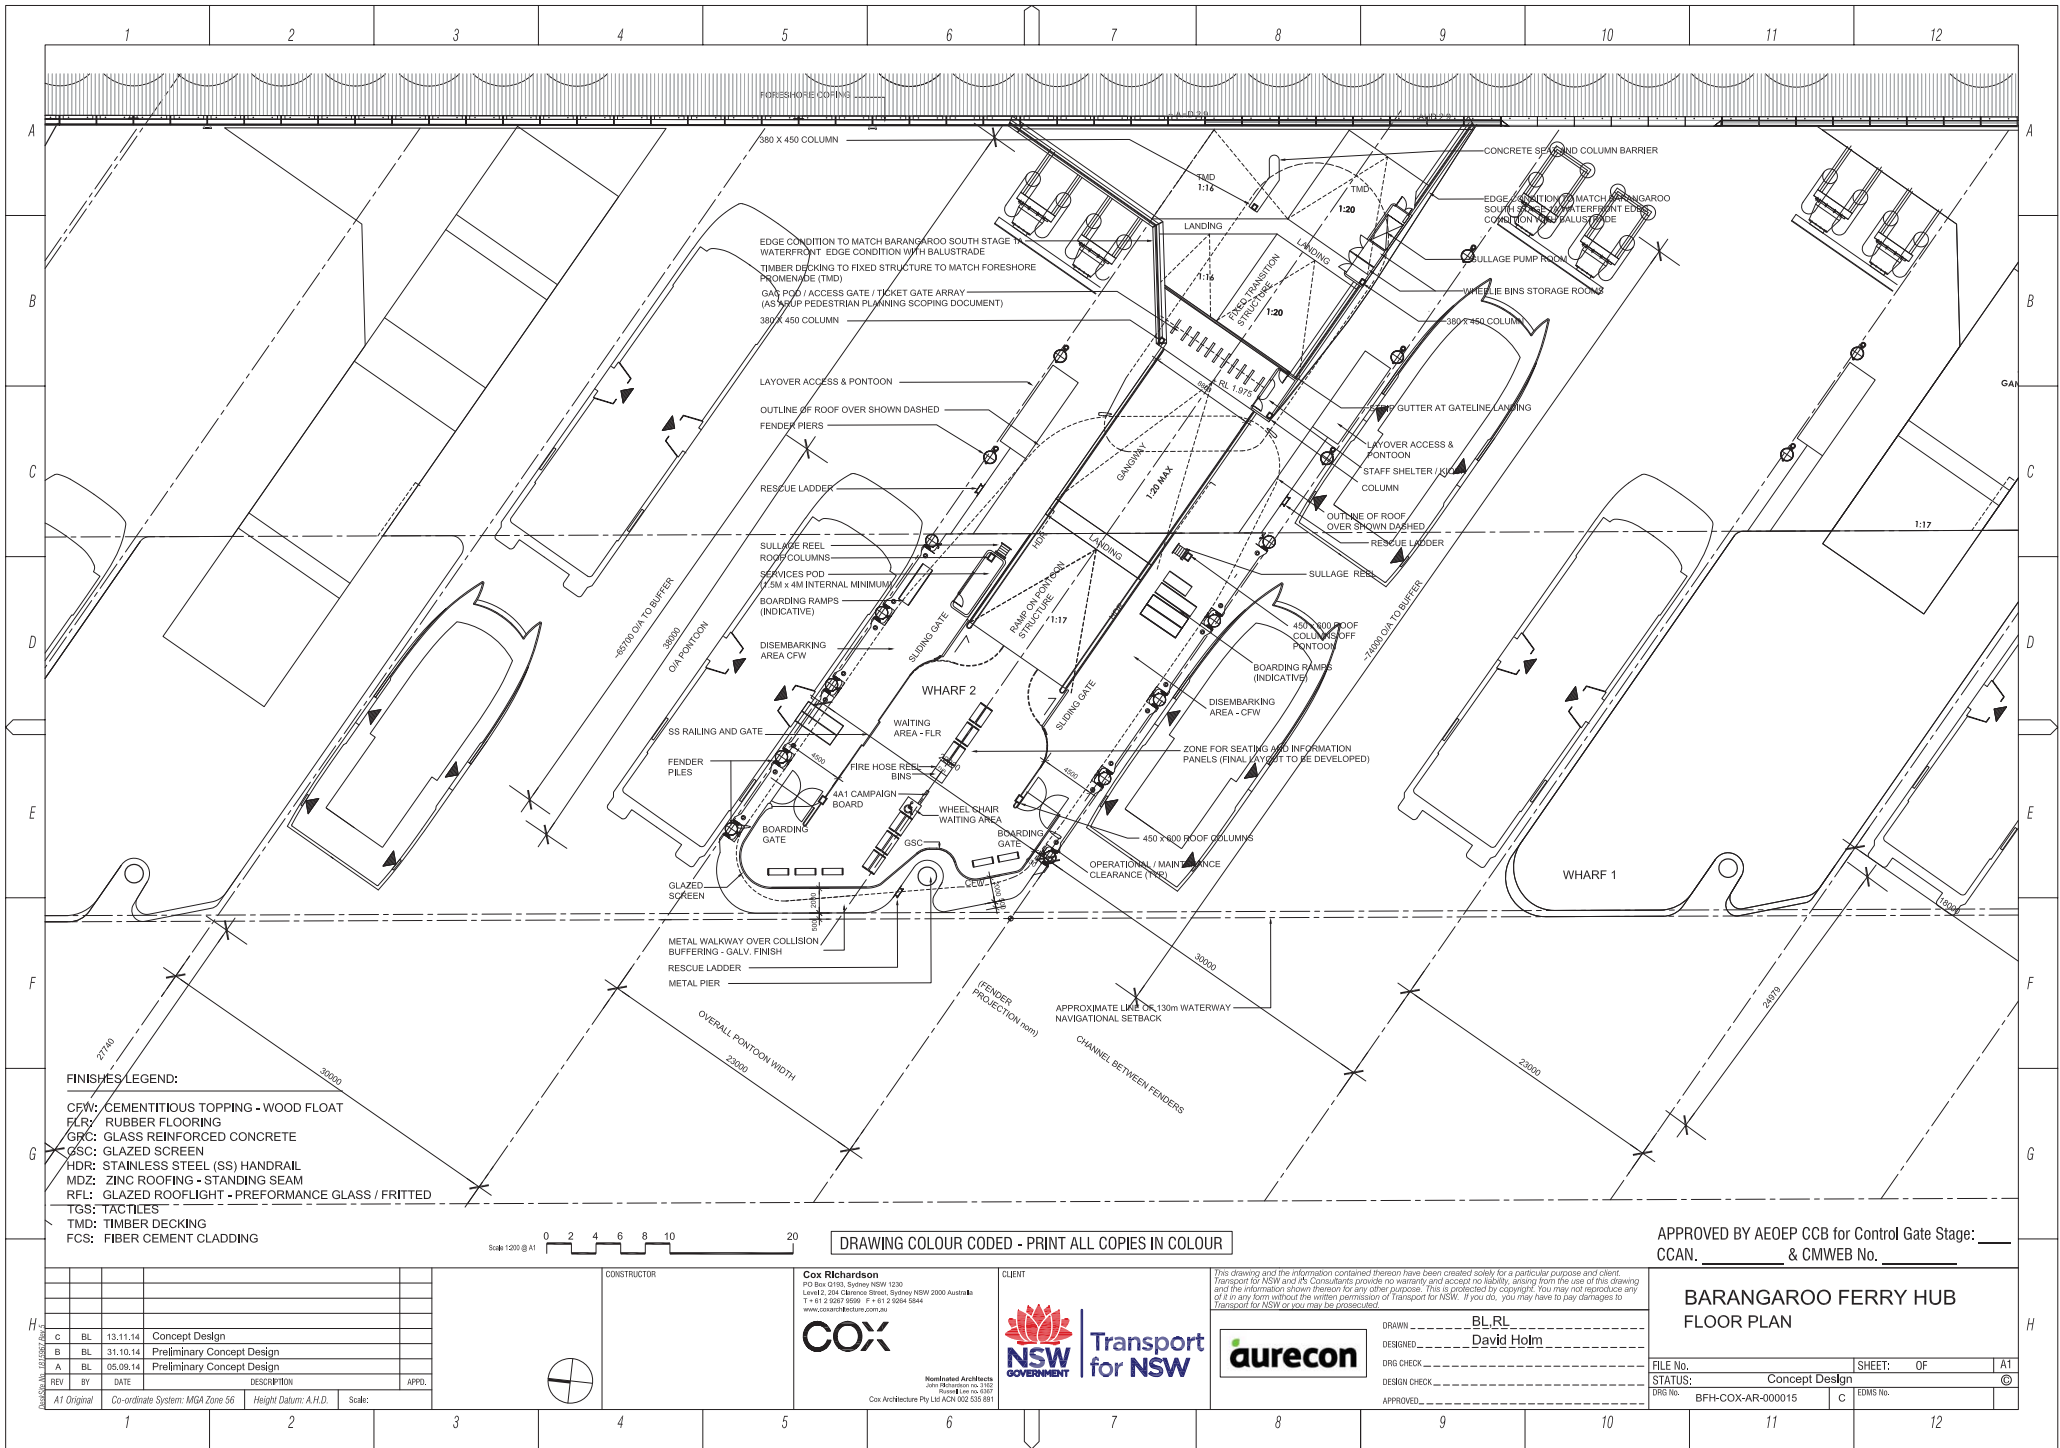
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DRAWN: BL, RL  
DESIGNED: David Holm  
DRC CHECK: \_\_\_\_\_  
DESIGN CHECK: \_\_\_\_\_  
APPROVED: \_\_\_\_\_

**aurecon**

FILE No.	Concept Design	SHEET: 01 OF 06	A1
DRG No.	BFH-COX-AR-000002	C	EDMS No.



FINISHES LEGEND:

- CFW: CEMENTITIOUS TOPPING - WOOD FLOAT
- FLR: RUBBER FLOORING
- GRC: GLASS REINFORCED CONCRETE
- GSC: GLAZED SCREEN
- HDR: STAINLESS STEEL (SS) HANDRAIL
- MDZ: ZINC ROOFING - STANDING SEAM
- RFL: GLAZED ROOFLIGHT - PERFORMANCE GLASS / FRITTED
- TGS: TACTILES
- TMD: TIMBER DECKING
- FCS: FIBER CEMENT CLADDING

Scale 1:200 @ A1

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BARANGAROO FERRY HUB  
FLOOR PLAN

REV	BY	DATE	DESCRIPTION	APPD.
C	BL	13.11.14	Concept Design	
B	BL	31.10.14	Preliminary Concept Design	
A	BL	05.09.14	Preliminary Concept Design	
A1	Original			

Co-ordinate System: MGA Zone 56    Height Datum: A.H.D.    Scale:



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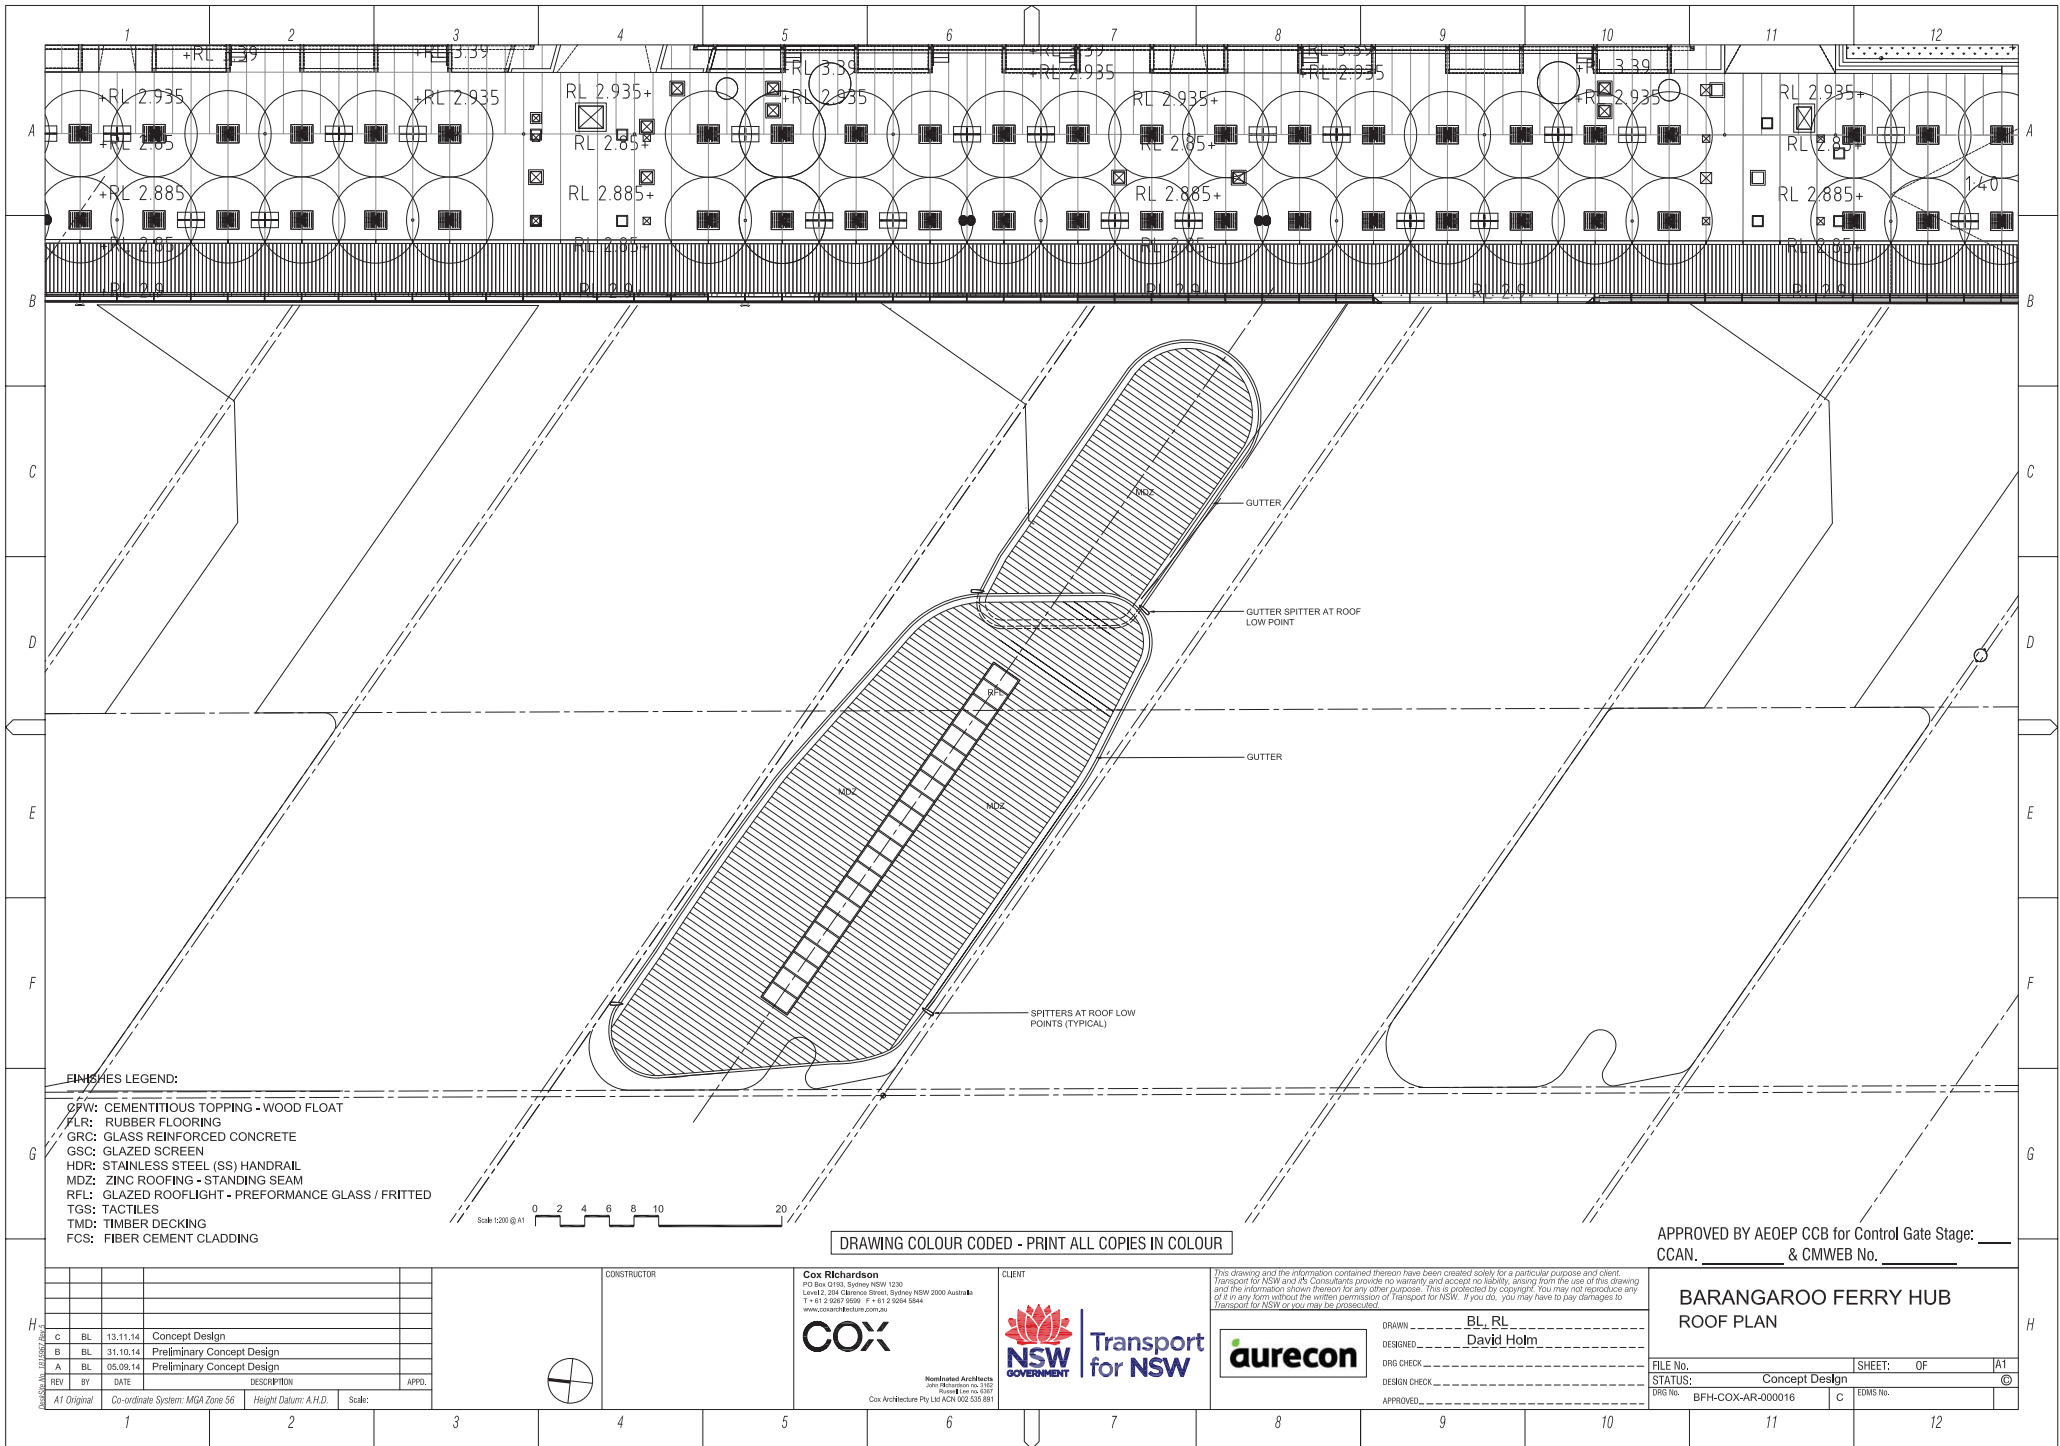
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DESIGNED BY: David Holm  
DGS CHECK: \_\_\_\_\_  
DESIGN CHECK: \_\_\_\_\_  
APPROVED: \_\_\_\_\_




FILE No.	STATUS: Concept Design	SHEET: OF	A1
DWG No.	BFH-COX-AR-000015	C	EDMS No.



FINISHES LEGEND:

- CPW: CEMENTITIOUS TOPPING - WOOD FLOAT
- FLR: RUBBER FLOORING
- GRC: GLASS REINFORCED CONCRETE
- GSC: GLAZED SCREEN
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- RFL: GLAZED ROOFLIGHT - PERFORMANCE GLASS / FRITTED
- TGS: TACTILES
- TMD: TIMBER DECKING
- FCS: FIBER CEMENT CLADDING

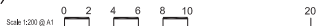

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BARANGAROO FERRY HUB  
ROOF PLAN

REV	BY	DATE	DESCRIPTION	APPD.
C	BL	13.11.14	Concept Design	
B	BL	31.10.14	Preliminary Concept Design	
A	BL	05.09.14	Preliminary Concept Design	
AT	Original		Co-ordinate System: MGA Zone 56	
			Height Datum: A.H.D.	
			Scale:	



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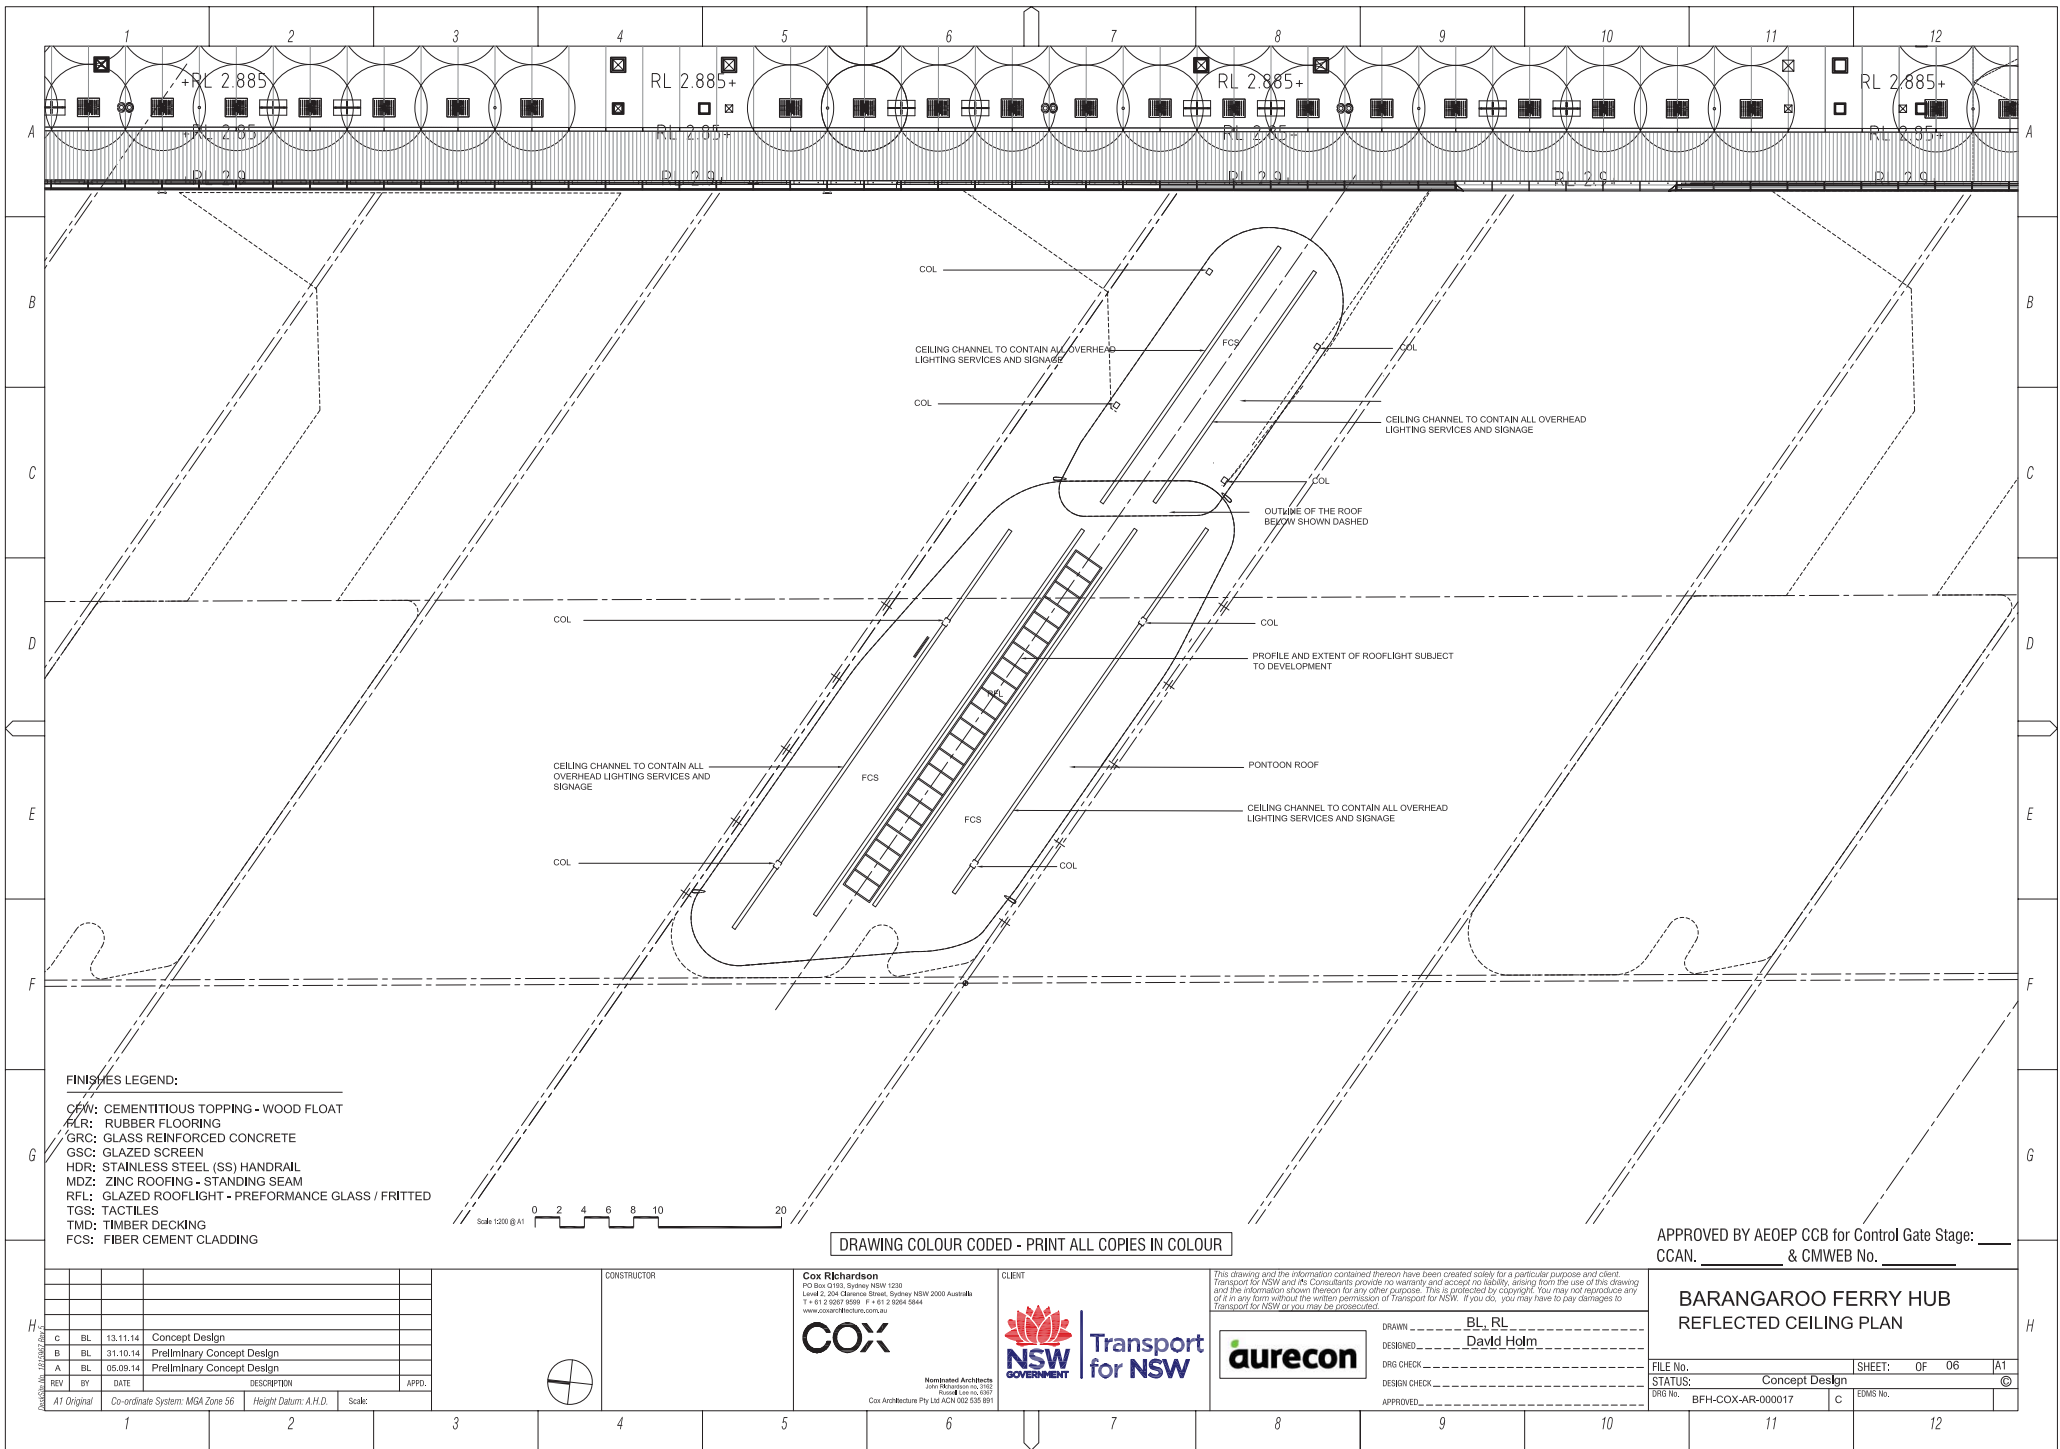
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DESIGNED	David Holm
DESIGN CHECK	
APPROVED	



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DWG No.	BFH-COX-AR-000016	
EIRMS No.	C	





**FINISHES LEGEND:**

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FLR: RUBBER FLOORING  
GRC: GLASS REINFORCED CONCRETE  
GSC: GLAZED SCREEN  
HDR: STAINLESS STEEL (SS) HANDRAIL  
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RFL: GLAZED ROOFLIGHT - PERFORMANCE GLASS / FRITTED  
TGS: TACTILES  
TMD: TIMBER DECKING  
FCS: FIBER CEMENT CLADDING

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**BARANGAROO FERRY HUB  
REFLECTED CEILING PLAN**

DRAWN BY: BL, RL  
DESIGNED BY: David Holm  
DRG CHECK: \_\_\_\_\_  
DESIGN CHECK: \_\_\_\_\_  
APPROVED: \_\_\_\_\_

FILE No. \_\_\_\_\_ SHEET: OF 06 JA1  
STATUS: Concept Design  
DRG No. BFH-COX-AR-000017 C EDMS No. \_\_\_\_\_

REV	BY	DATE	DESCRIPTION	APPROVED
C	BL	13.11.14	Concept Design	
B	BL	31.10.14	Preliminary Concept Design	
A	BL	05.09.14	Preliminary Concept Design	

A1 Original Co-ordinate System: MGA Zone 56 Height Datum: A.H.D. Scale: \_\_\_\_\_

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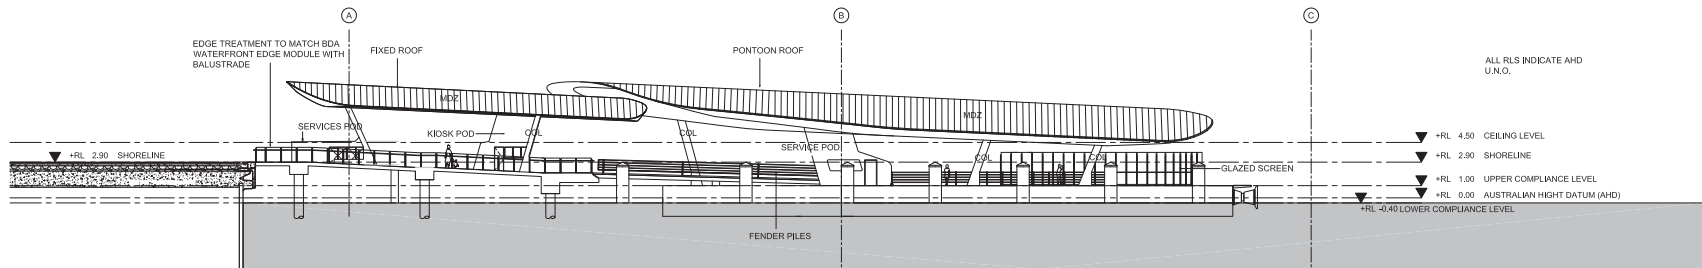
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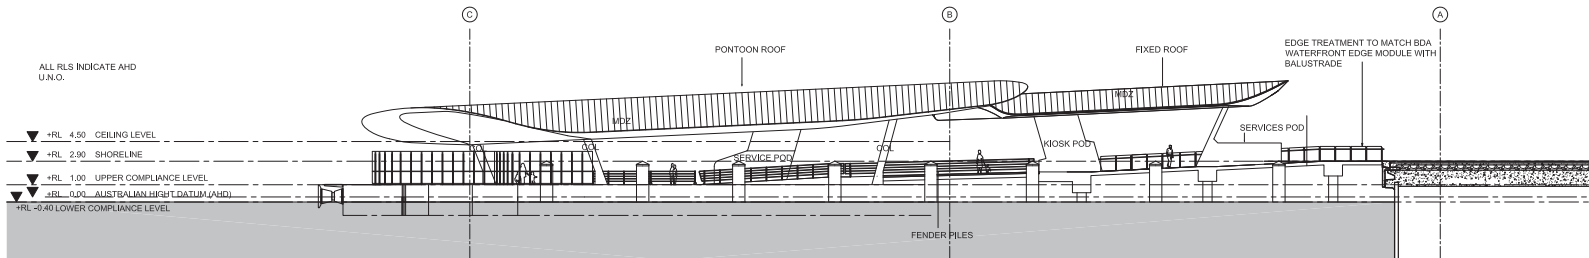
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NORTH ELEVATION



SOUTH ELEVATION

**FINISHES LEGEND:**

CFW: CEMENTITIOUS TOPPING - WOOD FLOAT  
 FLR: RUBBER FLOORING  
 GRC: GLASS REINFORCED CONCRETE  
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 TGS: TACTILES  
 TMD: TIMBER DECKING  
 FCS: FIBER CEMENT CLADDING

Scale 1:200 @ A1

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LEVEL DATUM TABLE		
DATUM	LEVEL (m AHD)	LEVEL (m C.D./LAT)
HAT	1.175	2.100
MHWS	0.695	1.620
MHWN	0.445	1.370
MSL	0.065	0.990
AHD	0.000	0.925
MLWN	-0.315	0.610
MLWS	-0.565	0.360
LAT	-0.925	0.000

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**BARANGAROO FERRY HUB ELEVATIONS**

REV	BY	DATE	DESCRIPTION	APPD.
C	BL	13.11.14	Concept Design	
B	BL	31.10.14	Preliminary Concept Design	
A	BL	05.09.14	Preliminary Concept Design	



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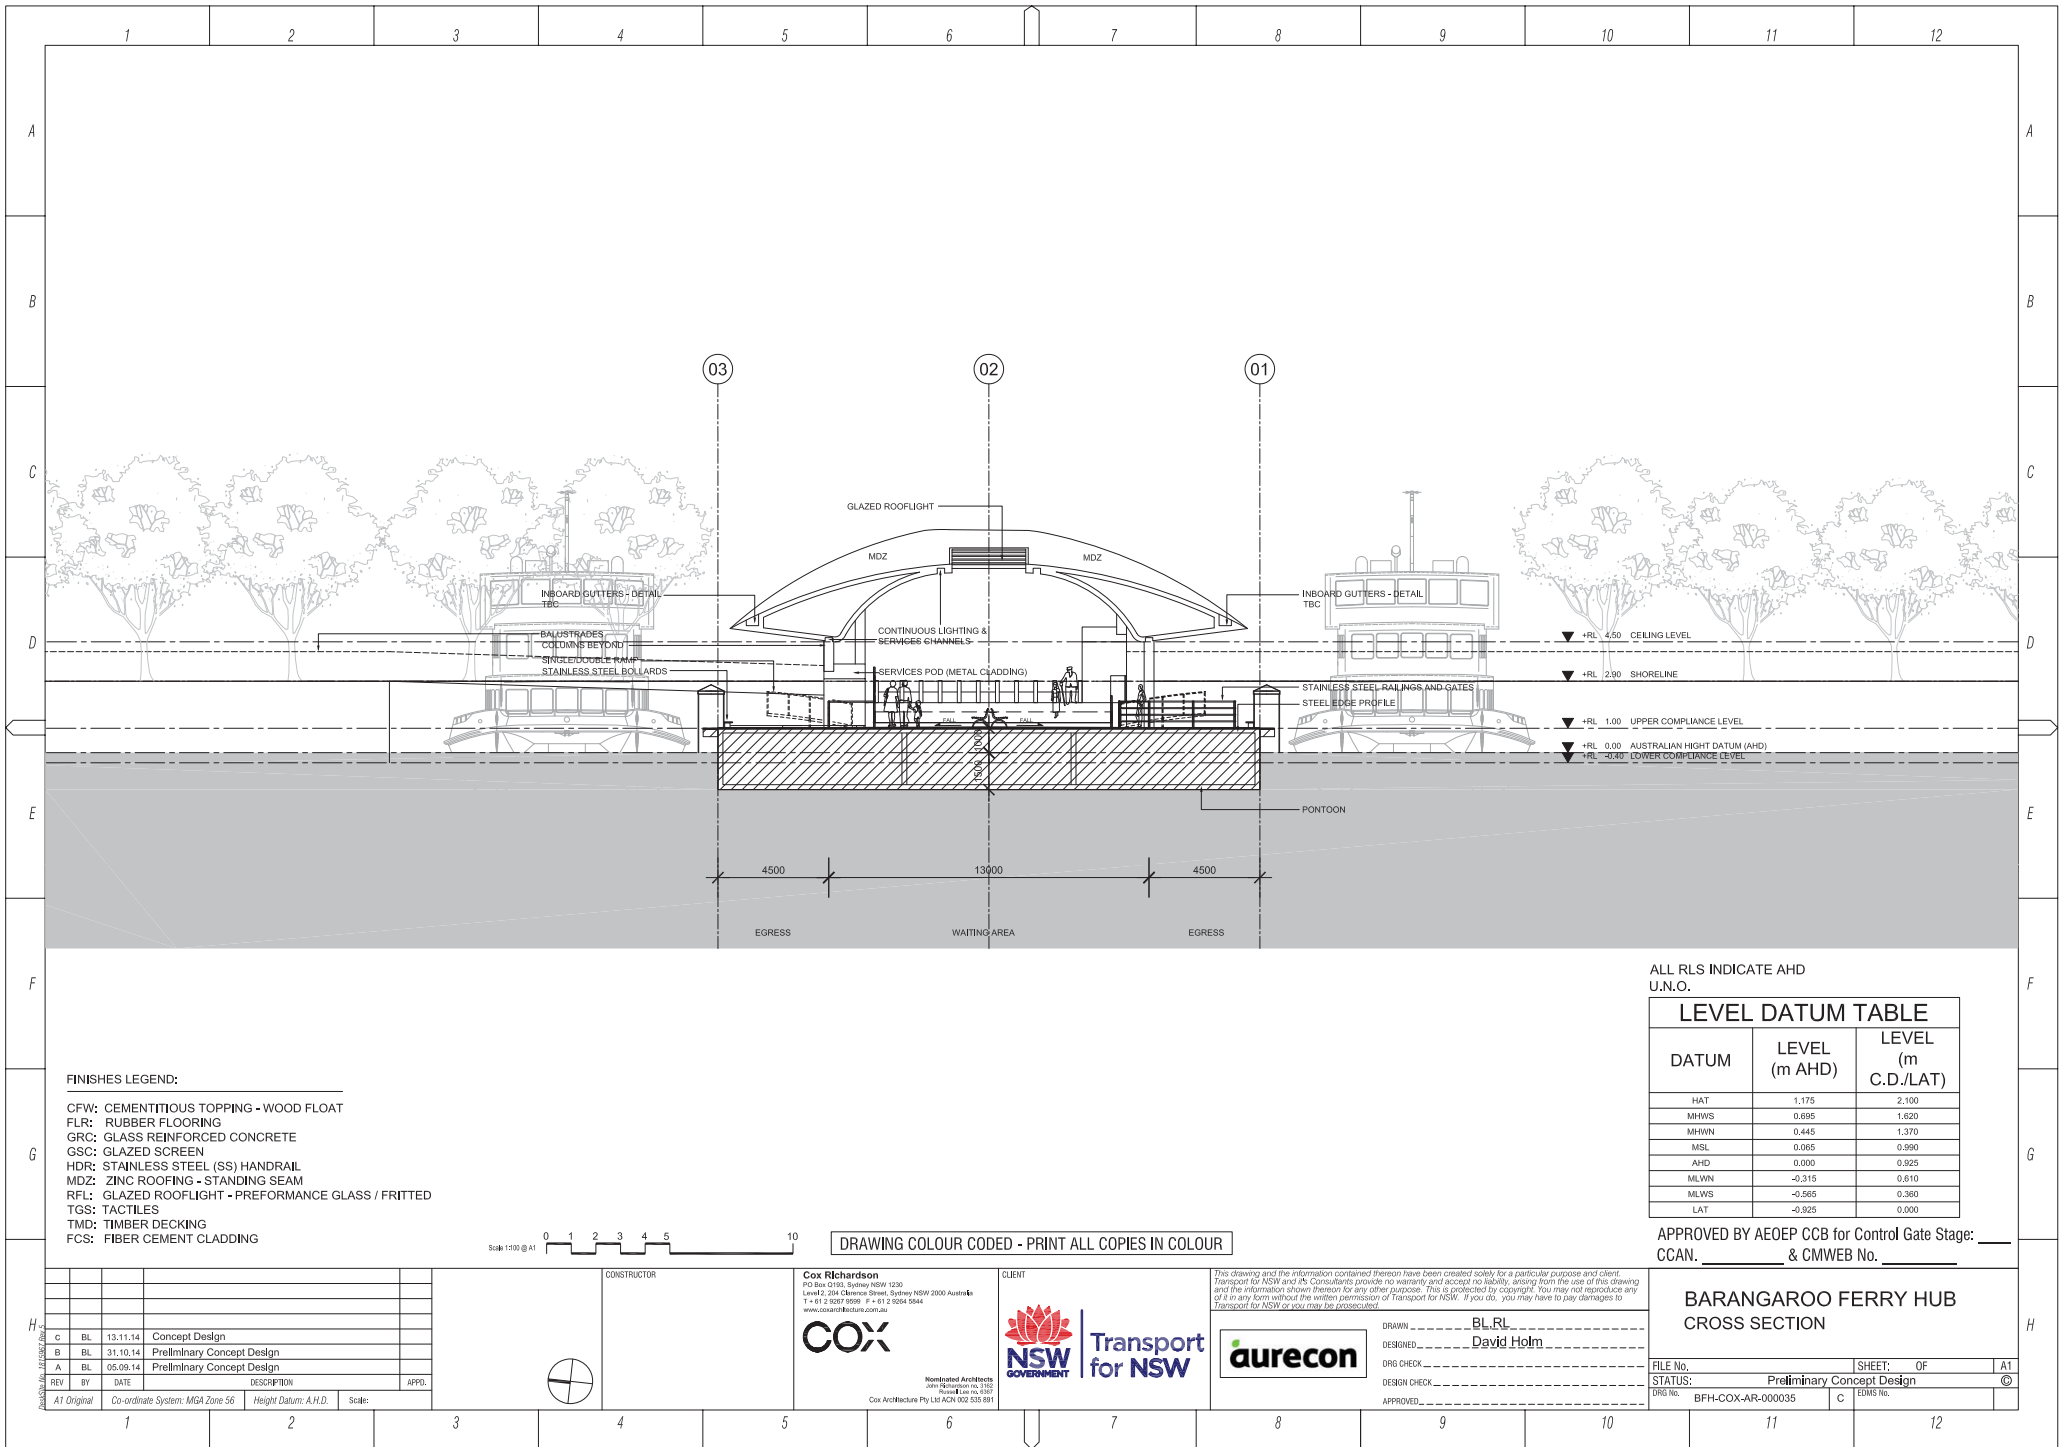


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 DESIGNED BY David Holm  
 DRG CHECK  
 DESIGN CHECK  
 APPROVED

FILE No.	STATUS: Concept Design	SHEET: OF	A1
DRG No. BFH-COX-AR-000021	C	EDMS No.	



ALL RLS INDICATE AHD  
U.N.O.

LEVEL DATUM TABLE		
DATUM	LEVEL (m AHD)	LEVEL (m C.D./LAT)
HAT	1.175	2.100
MHWNS	0.695	1.620
MHHWN	0.445	1.370
MSL	0.065	0.990
AHD	0.000	0.925
MLWNS	-0.315	0.610
MLWNS	-0.565	0.360
LAT	-0.925	0.000

APPROVED BY AE0EP CCB for Control Gate Stage: \_\_\_\_\_  
CCAN. \_\_\_\_\_ & CMWEB No. \_\_\_\_\_

BARANGAROO FERRY HUB  
CROSS SECTION

FILE No.	SHEET: OF	A1
STATUS:	Preliminary Concept Design	©
DRG No.	BFH-COX-AR-000035	C
EDMS No.		

FINISHES LEGEND:

CFW: CEMENTITIOUS TOPPING - WOOD FLOAT  
FLR: RUBBER FLOORING  
GRC: GLASS REINFORCED CONCRETE  
GSC: GLAZED SCREEN  
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RFL: GLAZED ROOFLIGHT - PREFORMANCE GLASS / FRITTED  
TGS: TACTILES  
TMD: TIMBER DECKING  
FCS: FIBER CEMENT CLADDING

Scale 1:100 @ A1

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REV	BY	DATE	DESCRIPTION	APPR.
C	BL	13.11.14	Concept Design	
B	BL	31.10.14	Preliminary Concept Design	
A	BL	05.09.14	Preliminary Concept Design	
A1 Original				
Co-ordinate System: MGA Zone 56				
Height Datum: A.H.D.				
Scale:				

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DRAWN	BL	RL
DESIGNED	David Holm	
DRG CHECK		
DESIGN CHECK		
APPROVED		





