

LOCATION PLAN

[illegible]

Technical Notes:
CONTRACTOR AND SUB-CONTRACTORS SHALL VERIFY ALL DIMENSIONS OF THIS DRAWING AND SITE CONDITIONS PRIOR TO ANY WORK COMMENCING.
ALL SHOP DRAWINGS SHALL BE SUBMITTED TO THE ARCHITECT, THE MANUFACTURER SHALL NOT COMMENCE ANY WORKS PRIOR TO THE RETURN OF APPROVED SHOP DRAWINGS SIGNED BY THE RELEVANT CONSULTANT.
IGNORED DIMENSIONS TAKE PRECEDENCE OVER SCALES DIMENSIONS.
THIS DRAWING SHOULD BE READ IN CONJUNCTION WITH ALL RELEVANT CONTRACTS, SPECIFICATIONS, DRAWINGS AND CONSULTANT DOCUMENTS.
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NOTE: ALL REVISIONS TO DRAWINGS WILL BE CLOUDED AND TAGGED

STRUCTURAL ELEMENTS SHOWN IN ARCHITECTURAL DRAWINGS ARE INDICATIVE ONLY AND NOT INCLUDED FOR SPATIAL CO-ORDINATION PURPOSES ONLY.

OR FULL STRUCTURAL DESIGN INCLUDING SUPERSTRUCTURE, BOWL, STRUCTURE, SUBSTRUCTURE SIZES & DETAILS, SLAB SIZES & DETAILS, SUB-SOIL & SHORING DETAILS, COLUMN / STRUCTURAL WALL SIZES & DETAILS REFER STRUCTURAL ENGINEER'S REPORT.

FINAL ENGINEERING CONNECTIONS AND MEMBER TYPES TO MATCH ARCHITECTURAL INTENT.

REFER TO SERVICE ENGINEERS DRAWING FOR LOCATION OF S.D.P. BOOMS, GPO'S AND WIRING DUCTS. REFER TO SERVICE ENGINEERS DRAWINGS FOR CO-ORDINATION OF LAB & WALL BLOKOUTS AND CORED PENETRATIONS.

REFER TO HYDRAULIC ENGINEER'S SERVICE PLAN FOR LOCATION OF SUB-FLOOR SERVICES.

REFER TO DOOR SCHEDULES FOR DOOR HARDWARE AND FINISHES DETAILS.

REFER TO MECHANICAL ENGINEERS' DRAWINGS TO CONFIRM SIZES OF ALL DUCT PENETRATIONS AND LOUVER OPENINGS.

REFER TO MECHANICAL ENGINEERS' DETAILS FOR PENETRATIONS AND BUILDING IN WITH THE EXISTING WALLS.

REFER TO MECHANICAL ENGINEERS' DRAWINGS FOR LOCATION OF ALL MECHANICAL UNITS USED IN HIGH LEVEL OPENINGS FOR PLUMBING IN CEILING SPACES. REFER TO MECHANICAL ENGINEER'S DRAWING.

ON ADDITIONAL STOREY FOR FORMATION WHERE NO DIMENSIONS SHOWN, REFER TO SERVICE ENGINEERS FOR CO-ORDINATED PENETRATIONS, DRAWINGS.

REFER TO ARCHITECTURAL SPECIFICATION, SCHEDULES AND ROOM DATA SHEETS FOR FATE AND FINISHES CODES FOR FURTHER DETAIL. AND OTHER MISCELLANEOUS ITEMS.



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Client _____
INSW

Project No.	
218018.00	

Project

**SYDNEY FOOTBALL
STADIUM**


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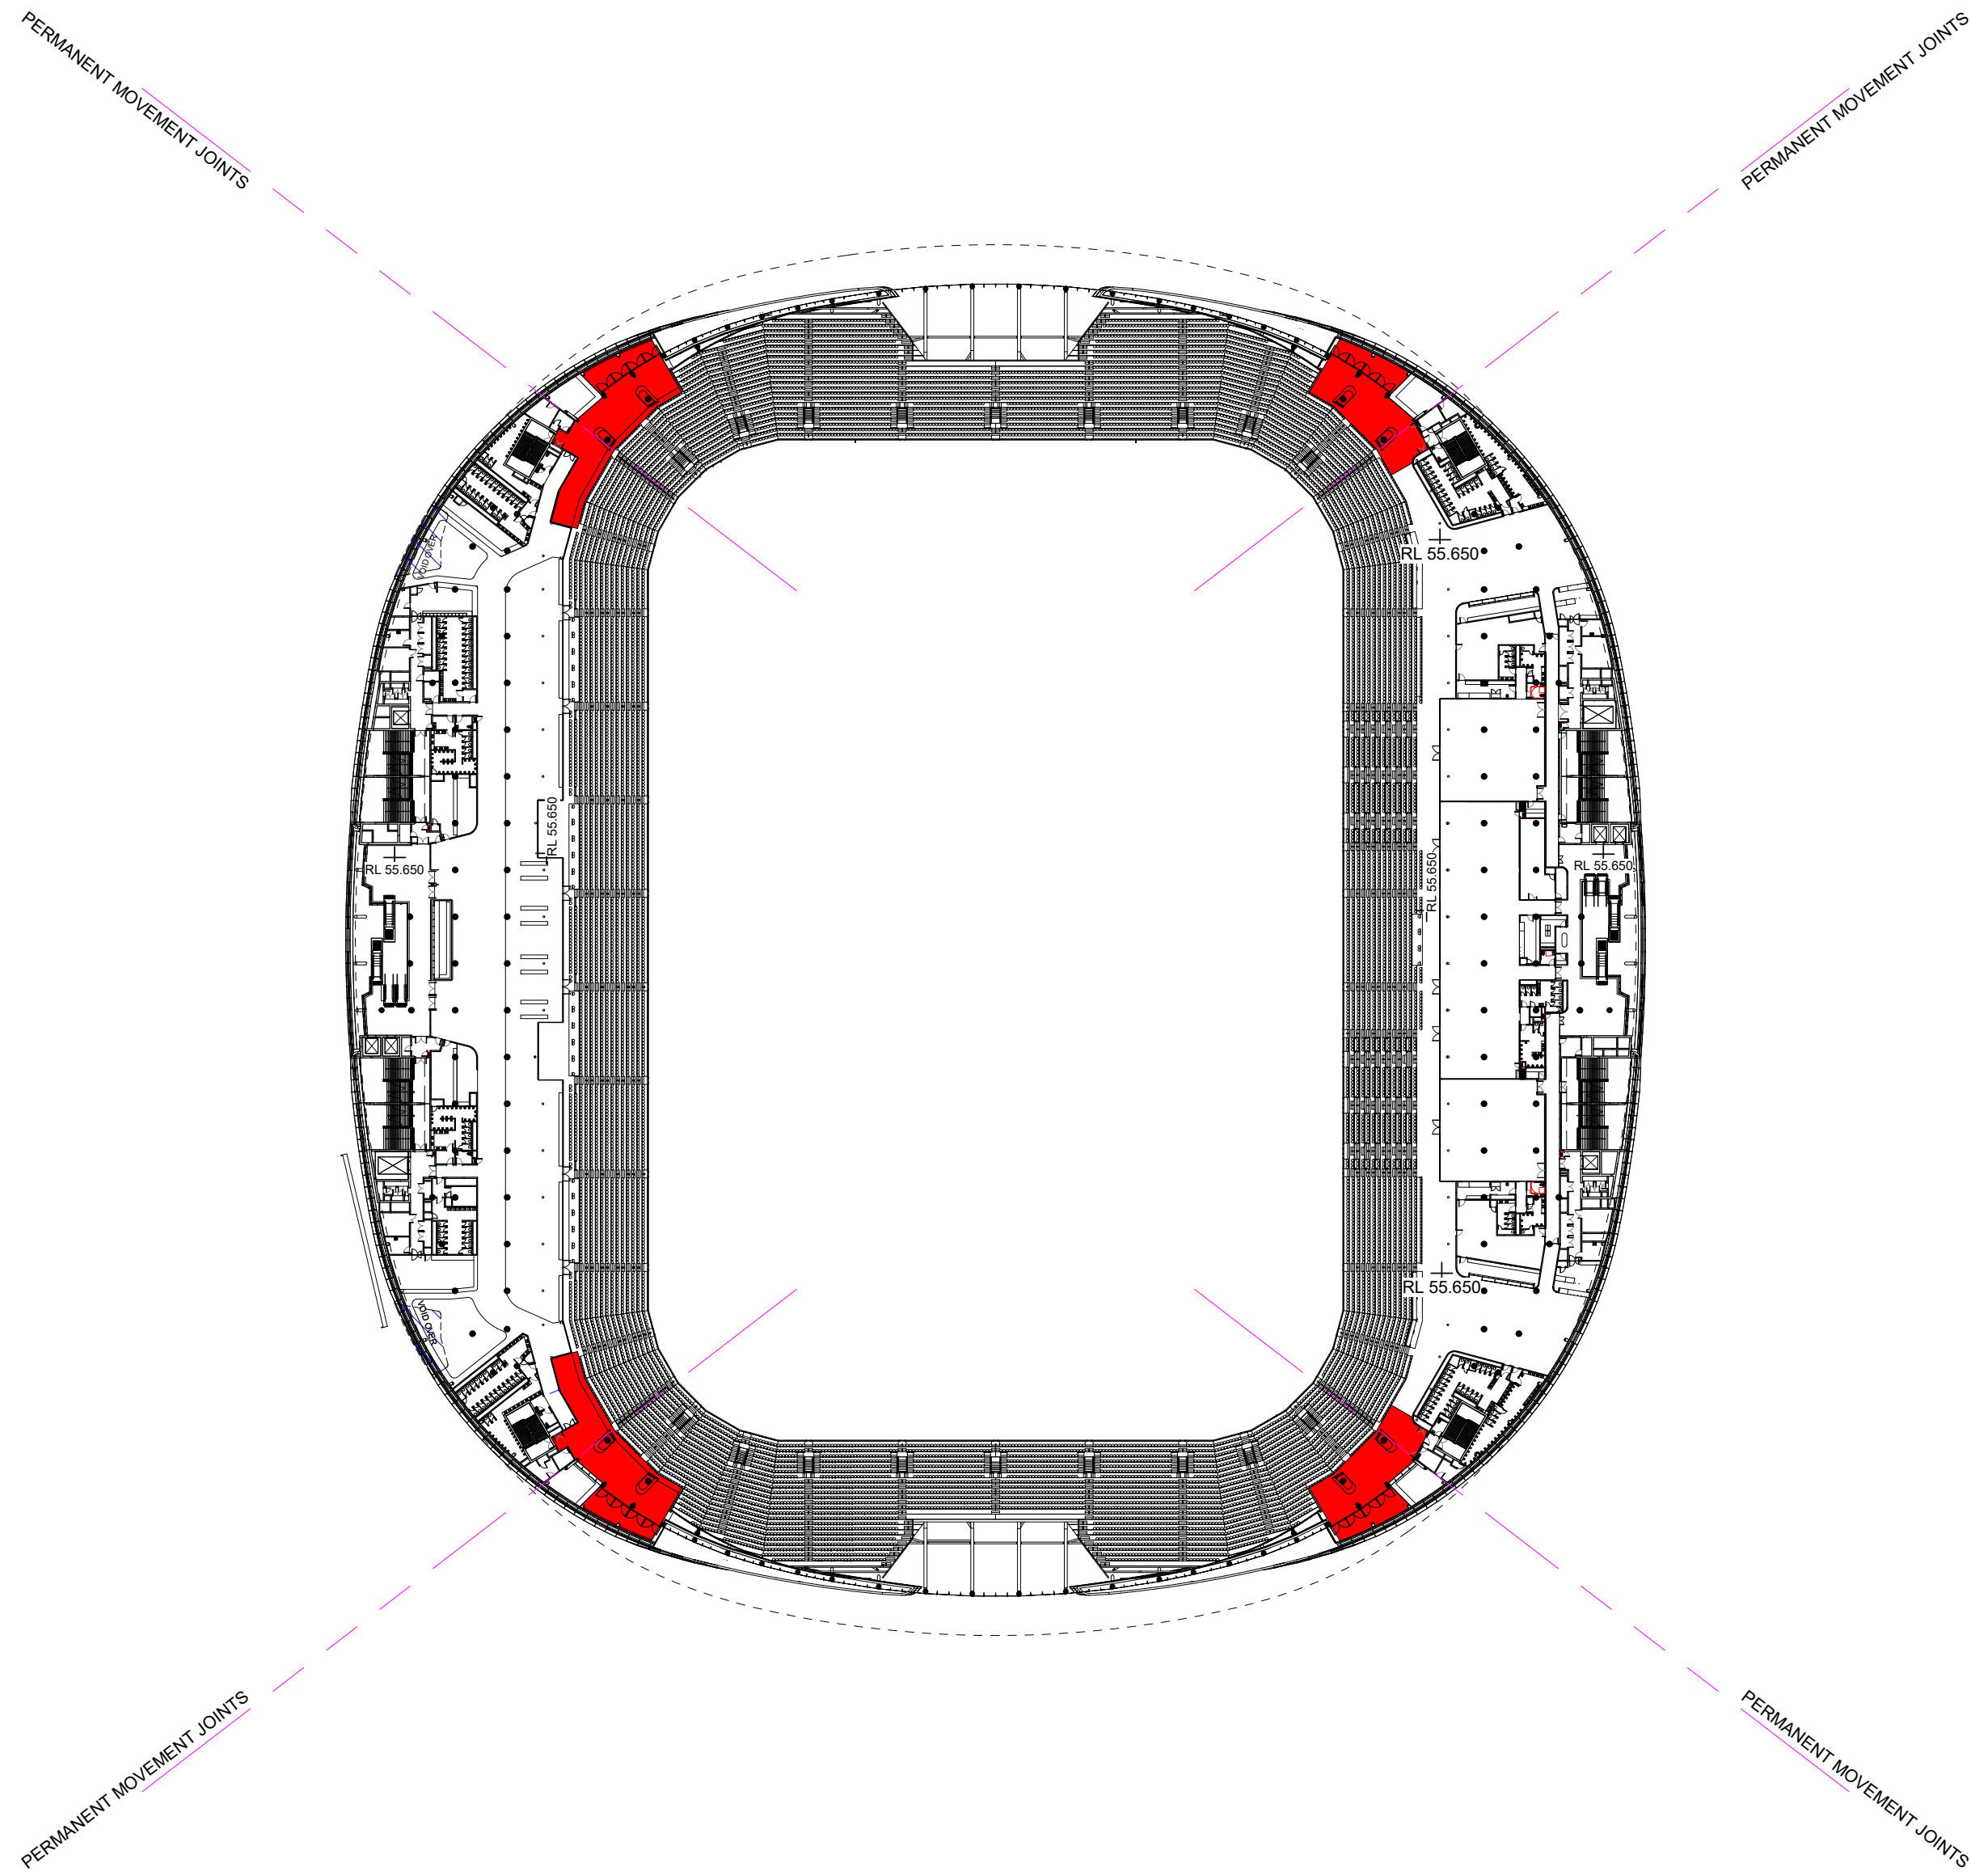
ACCESSIBLE TERRACES
PLANS

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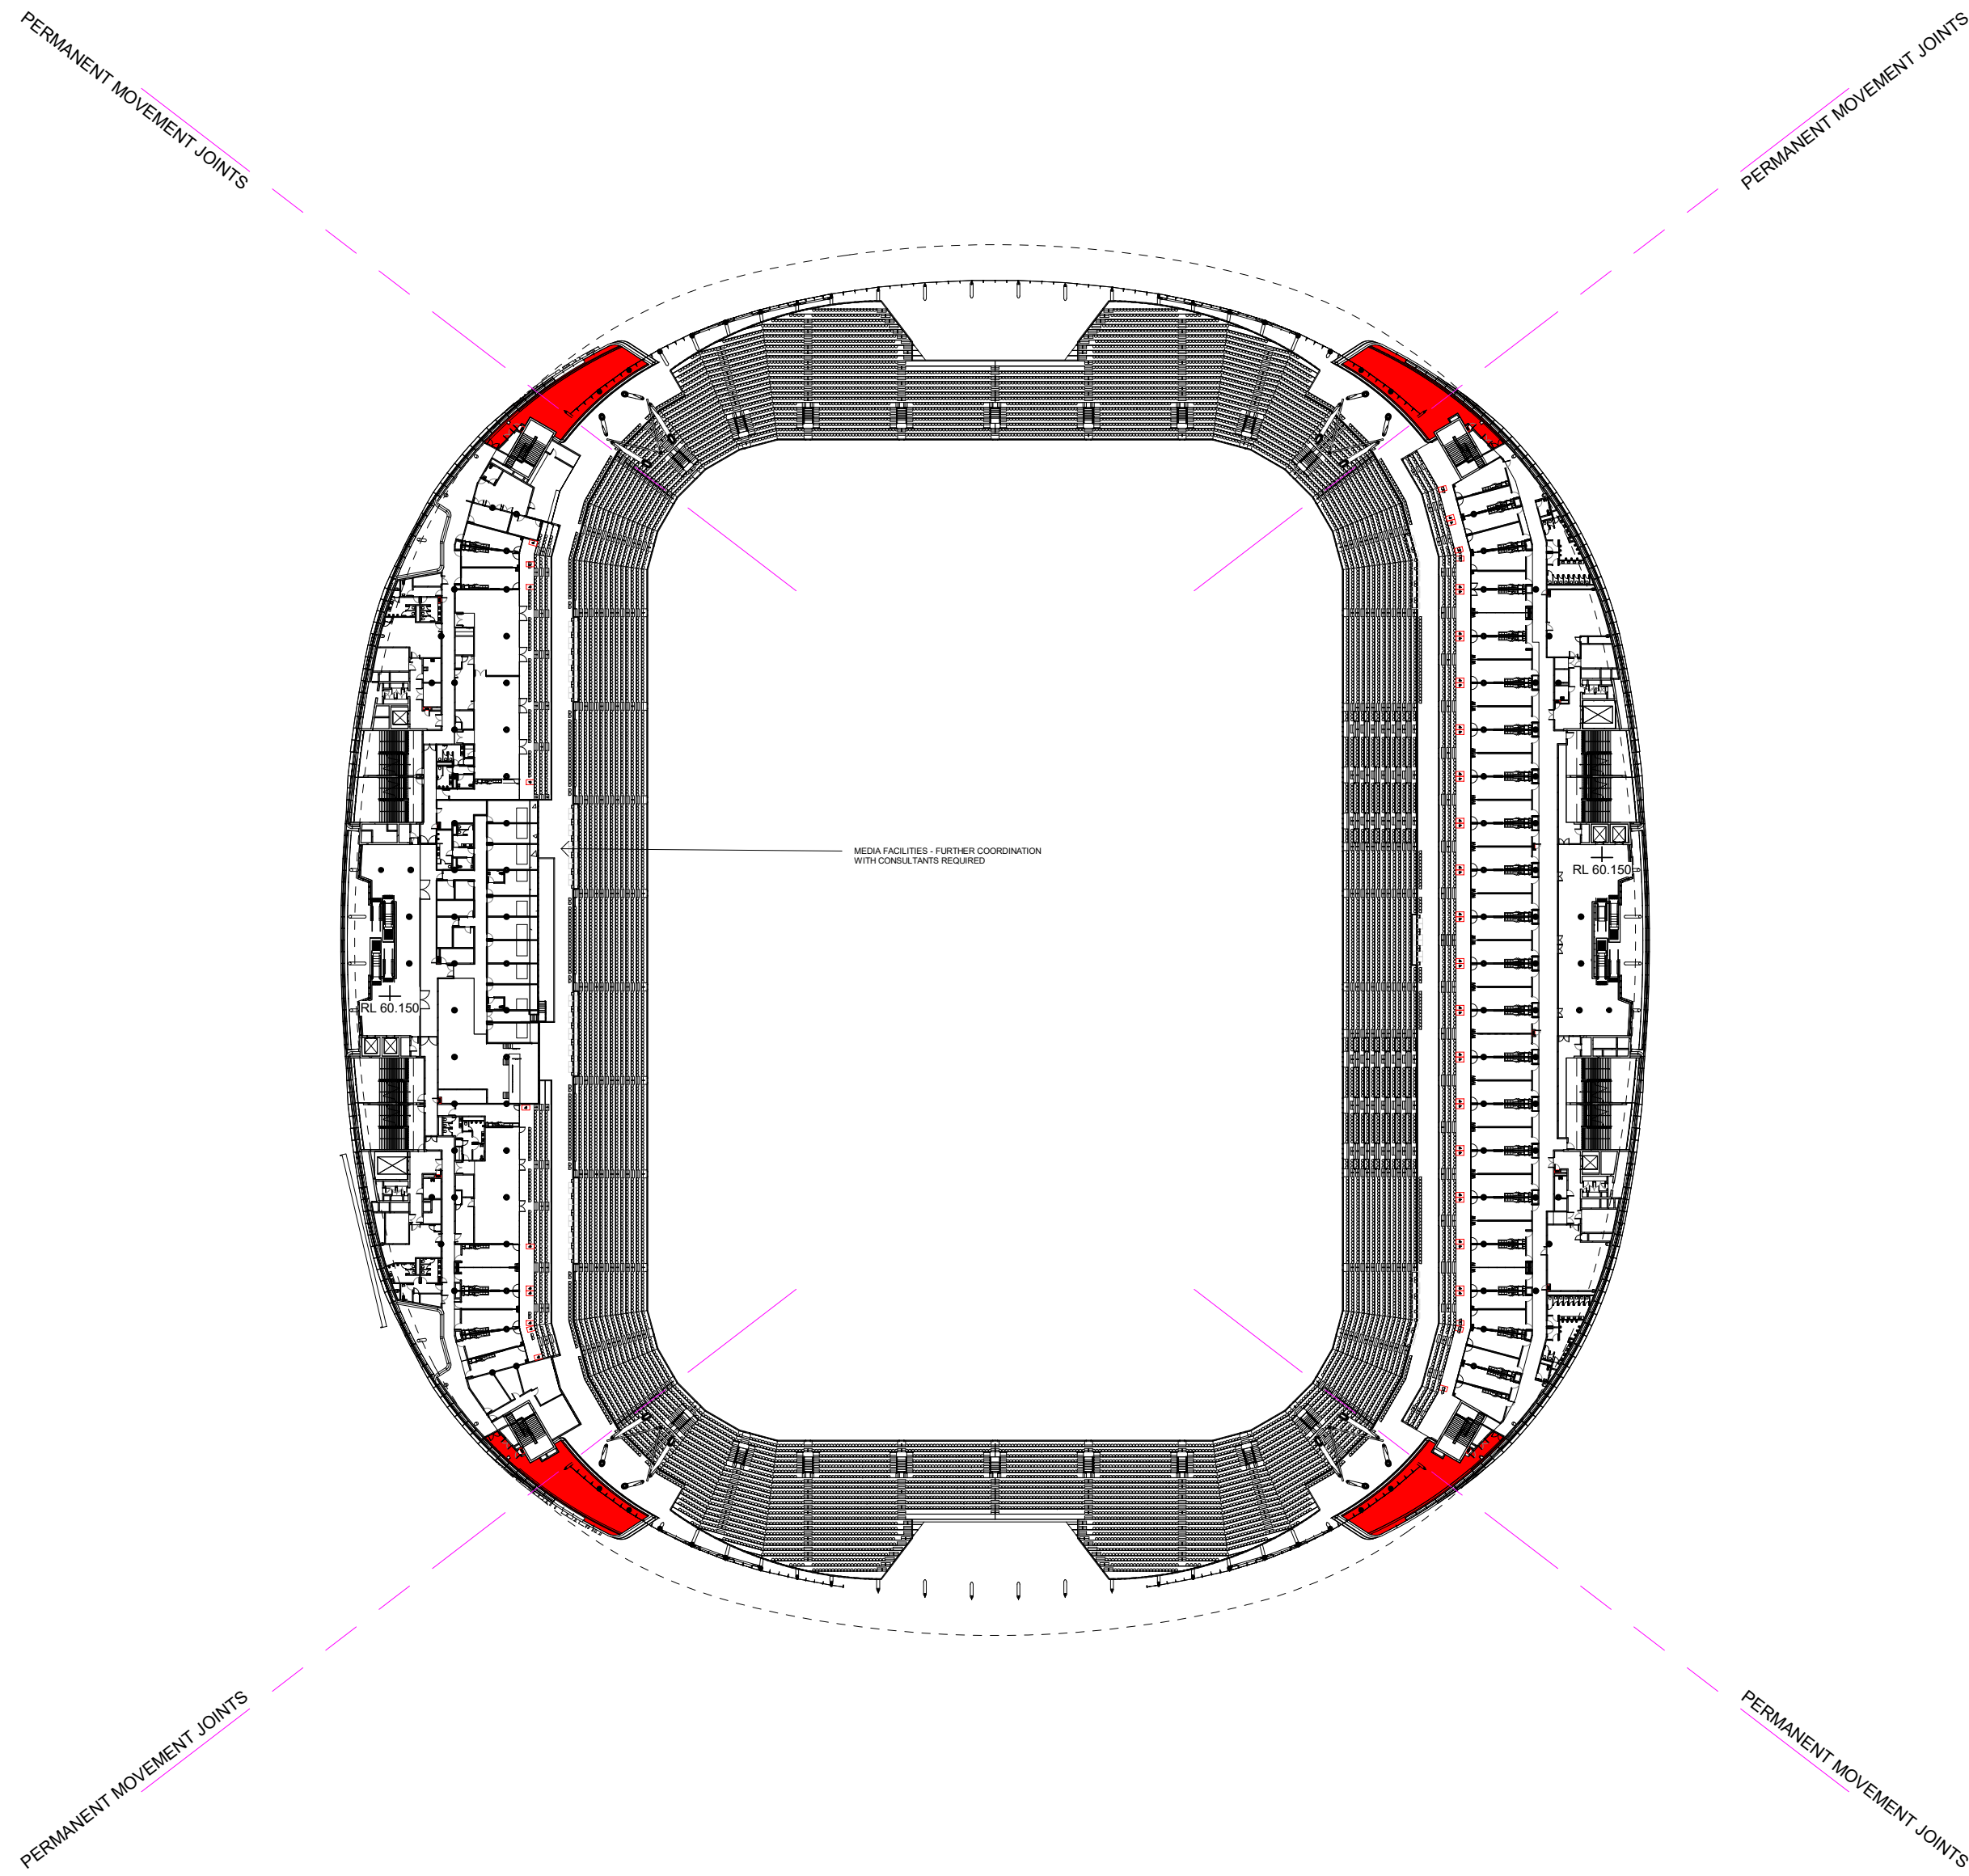
DESIGN DEVELOPMENT

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Co-ordinated:	Checker	Scale: As indicated @ AD
Project Architect:	Designer	Date: 20.09.19
Project Director:	Approver	Revision: A
Drawing Number:		North:
ASK326		


Cos Architecture Pty Ltd ACN 002 535 891



LEVEL CLUB ACCESSIBLE
TERRACES PLAN



LEVEL SUITE ACCESSIBLE
TERRACES PLAN

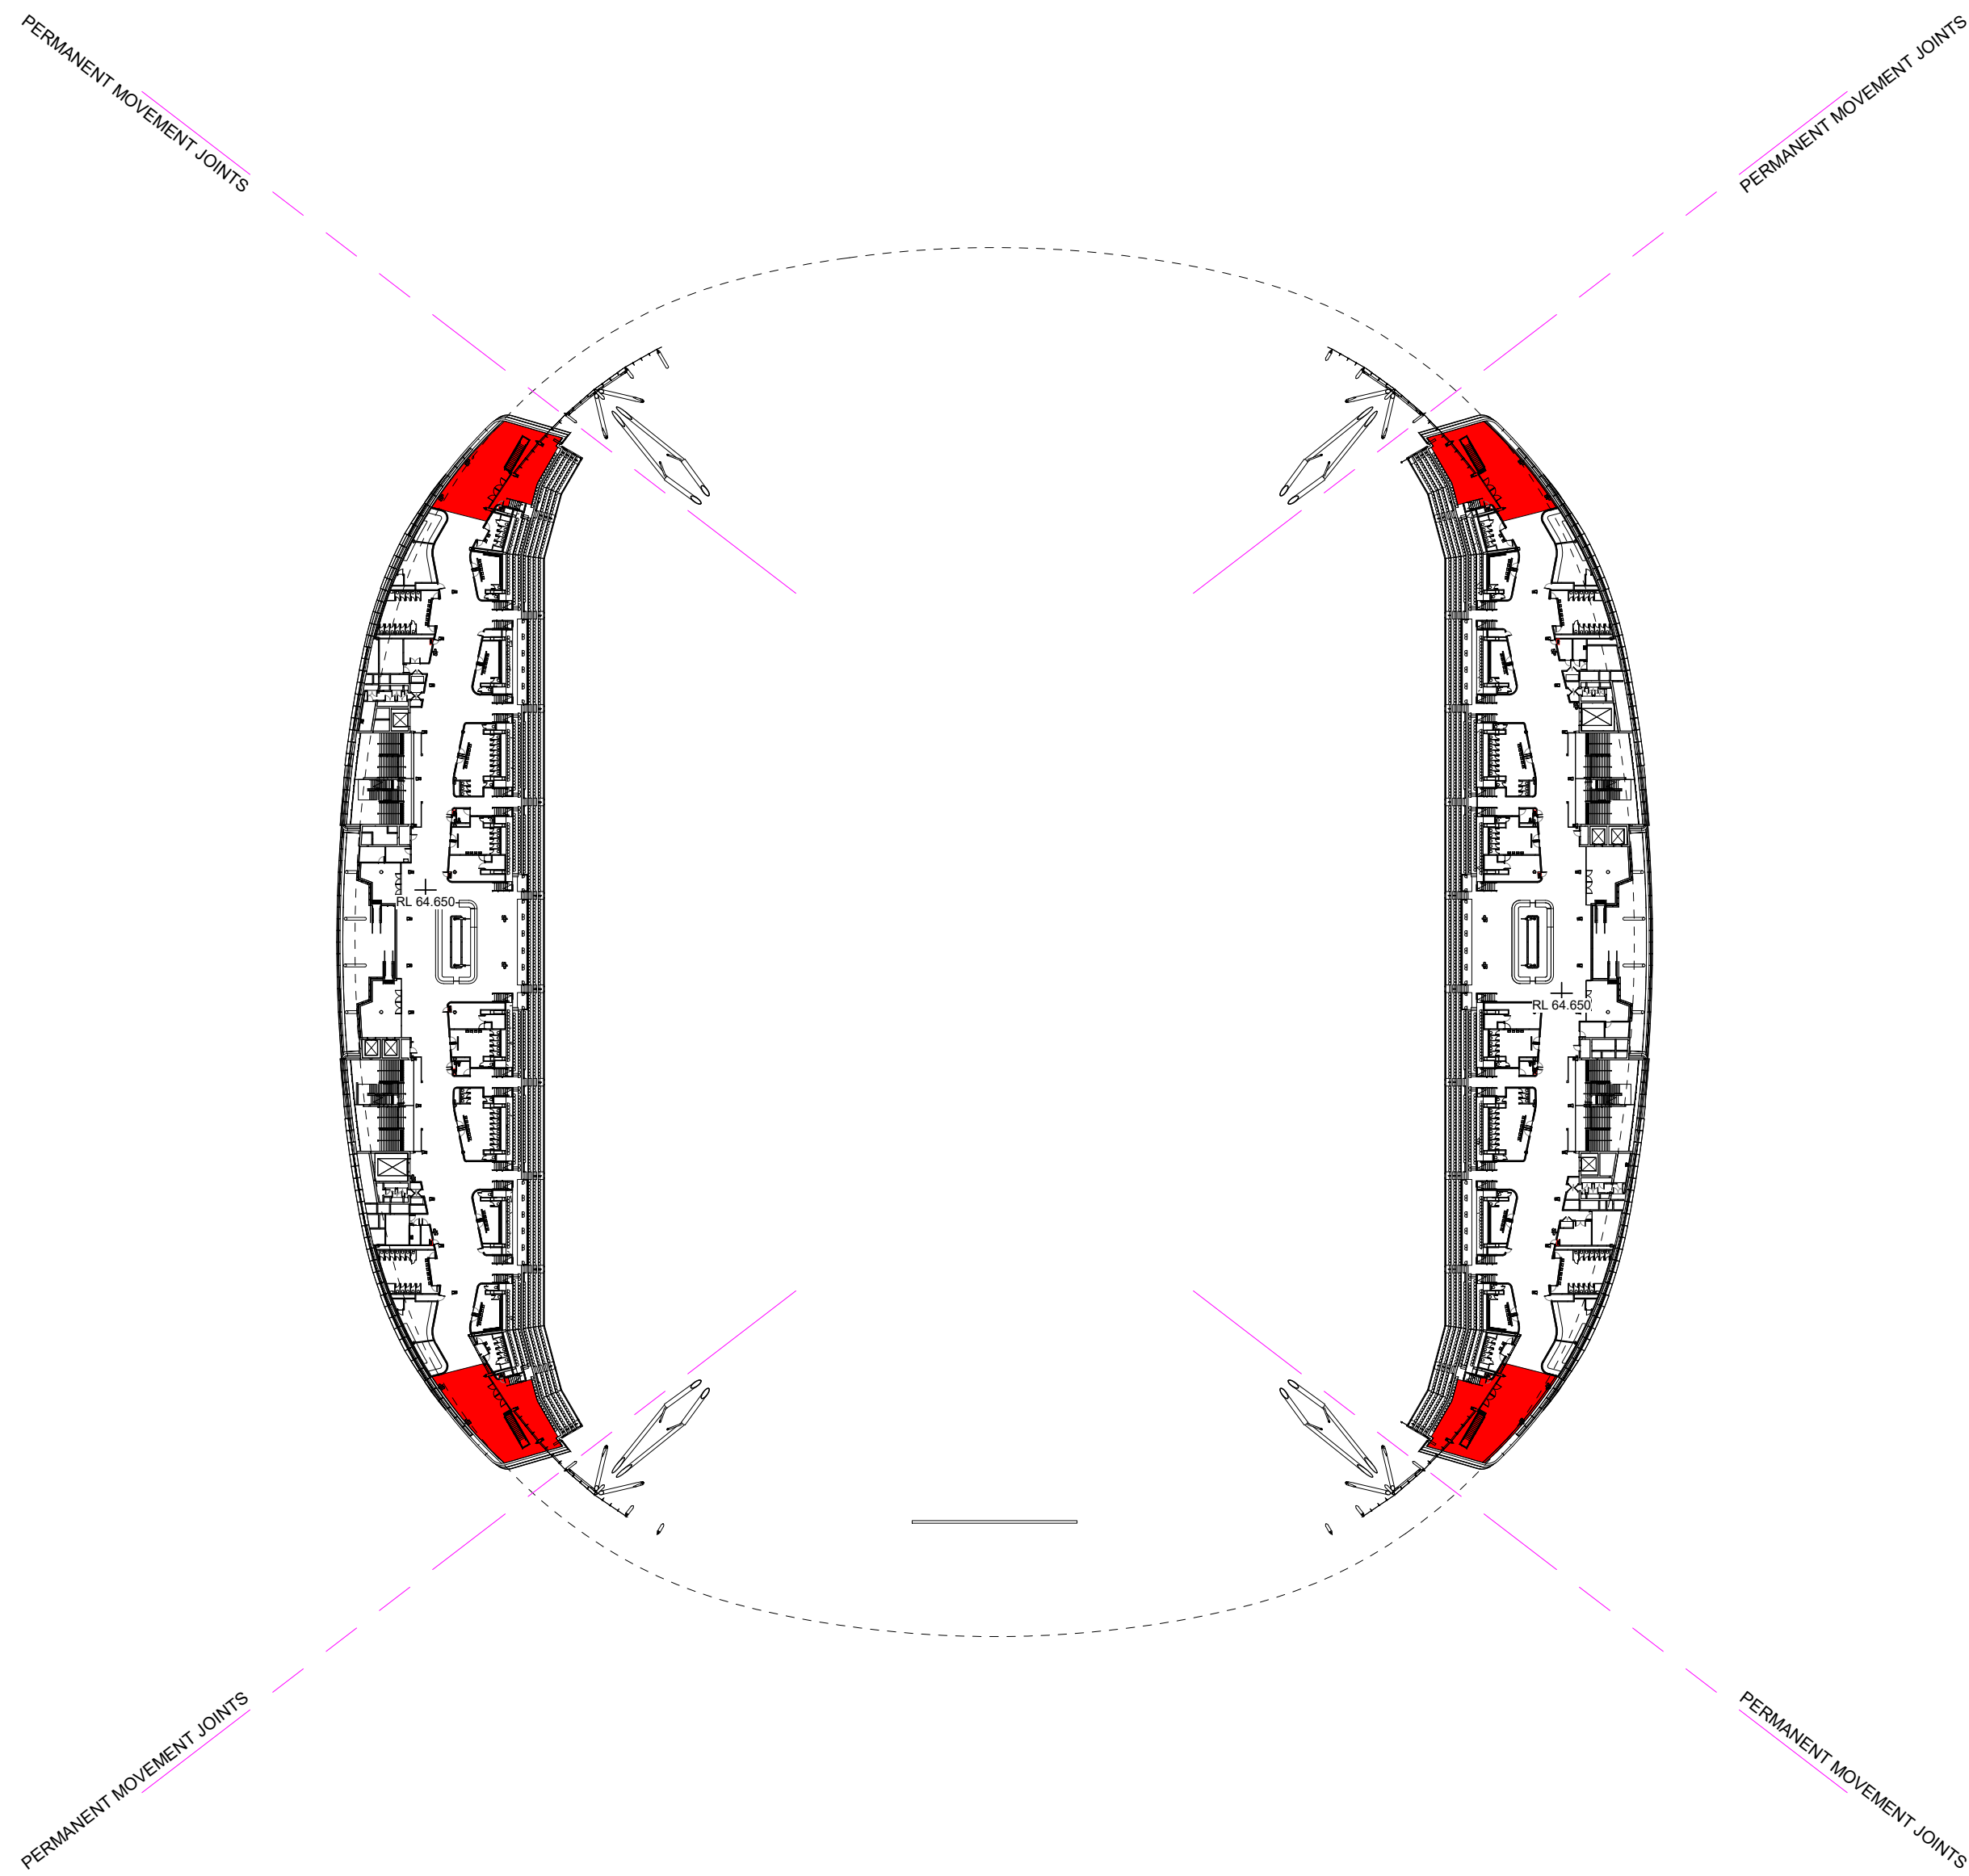

3
01.2

LEVEL UPPER ACCESSIBLE
TERRACES PLAN

SCALE 1 : 1000