
Proposed Data Centre Development

1 Sirius Road, Lane Cove West NSW 2066

Landscape Documentation For State Significant Development

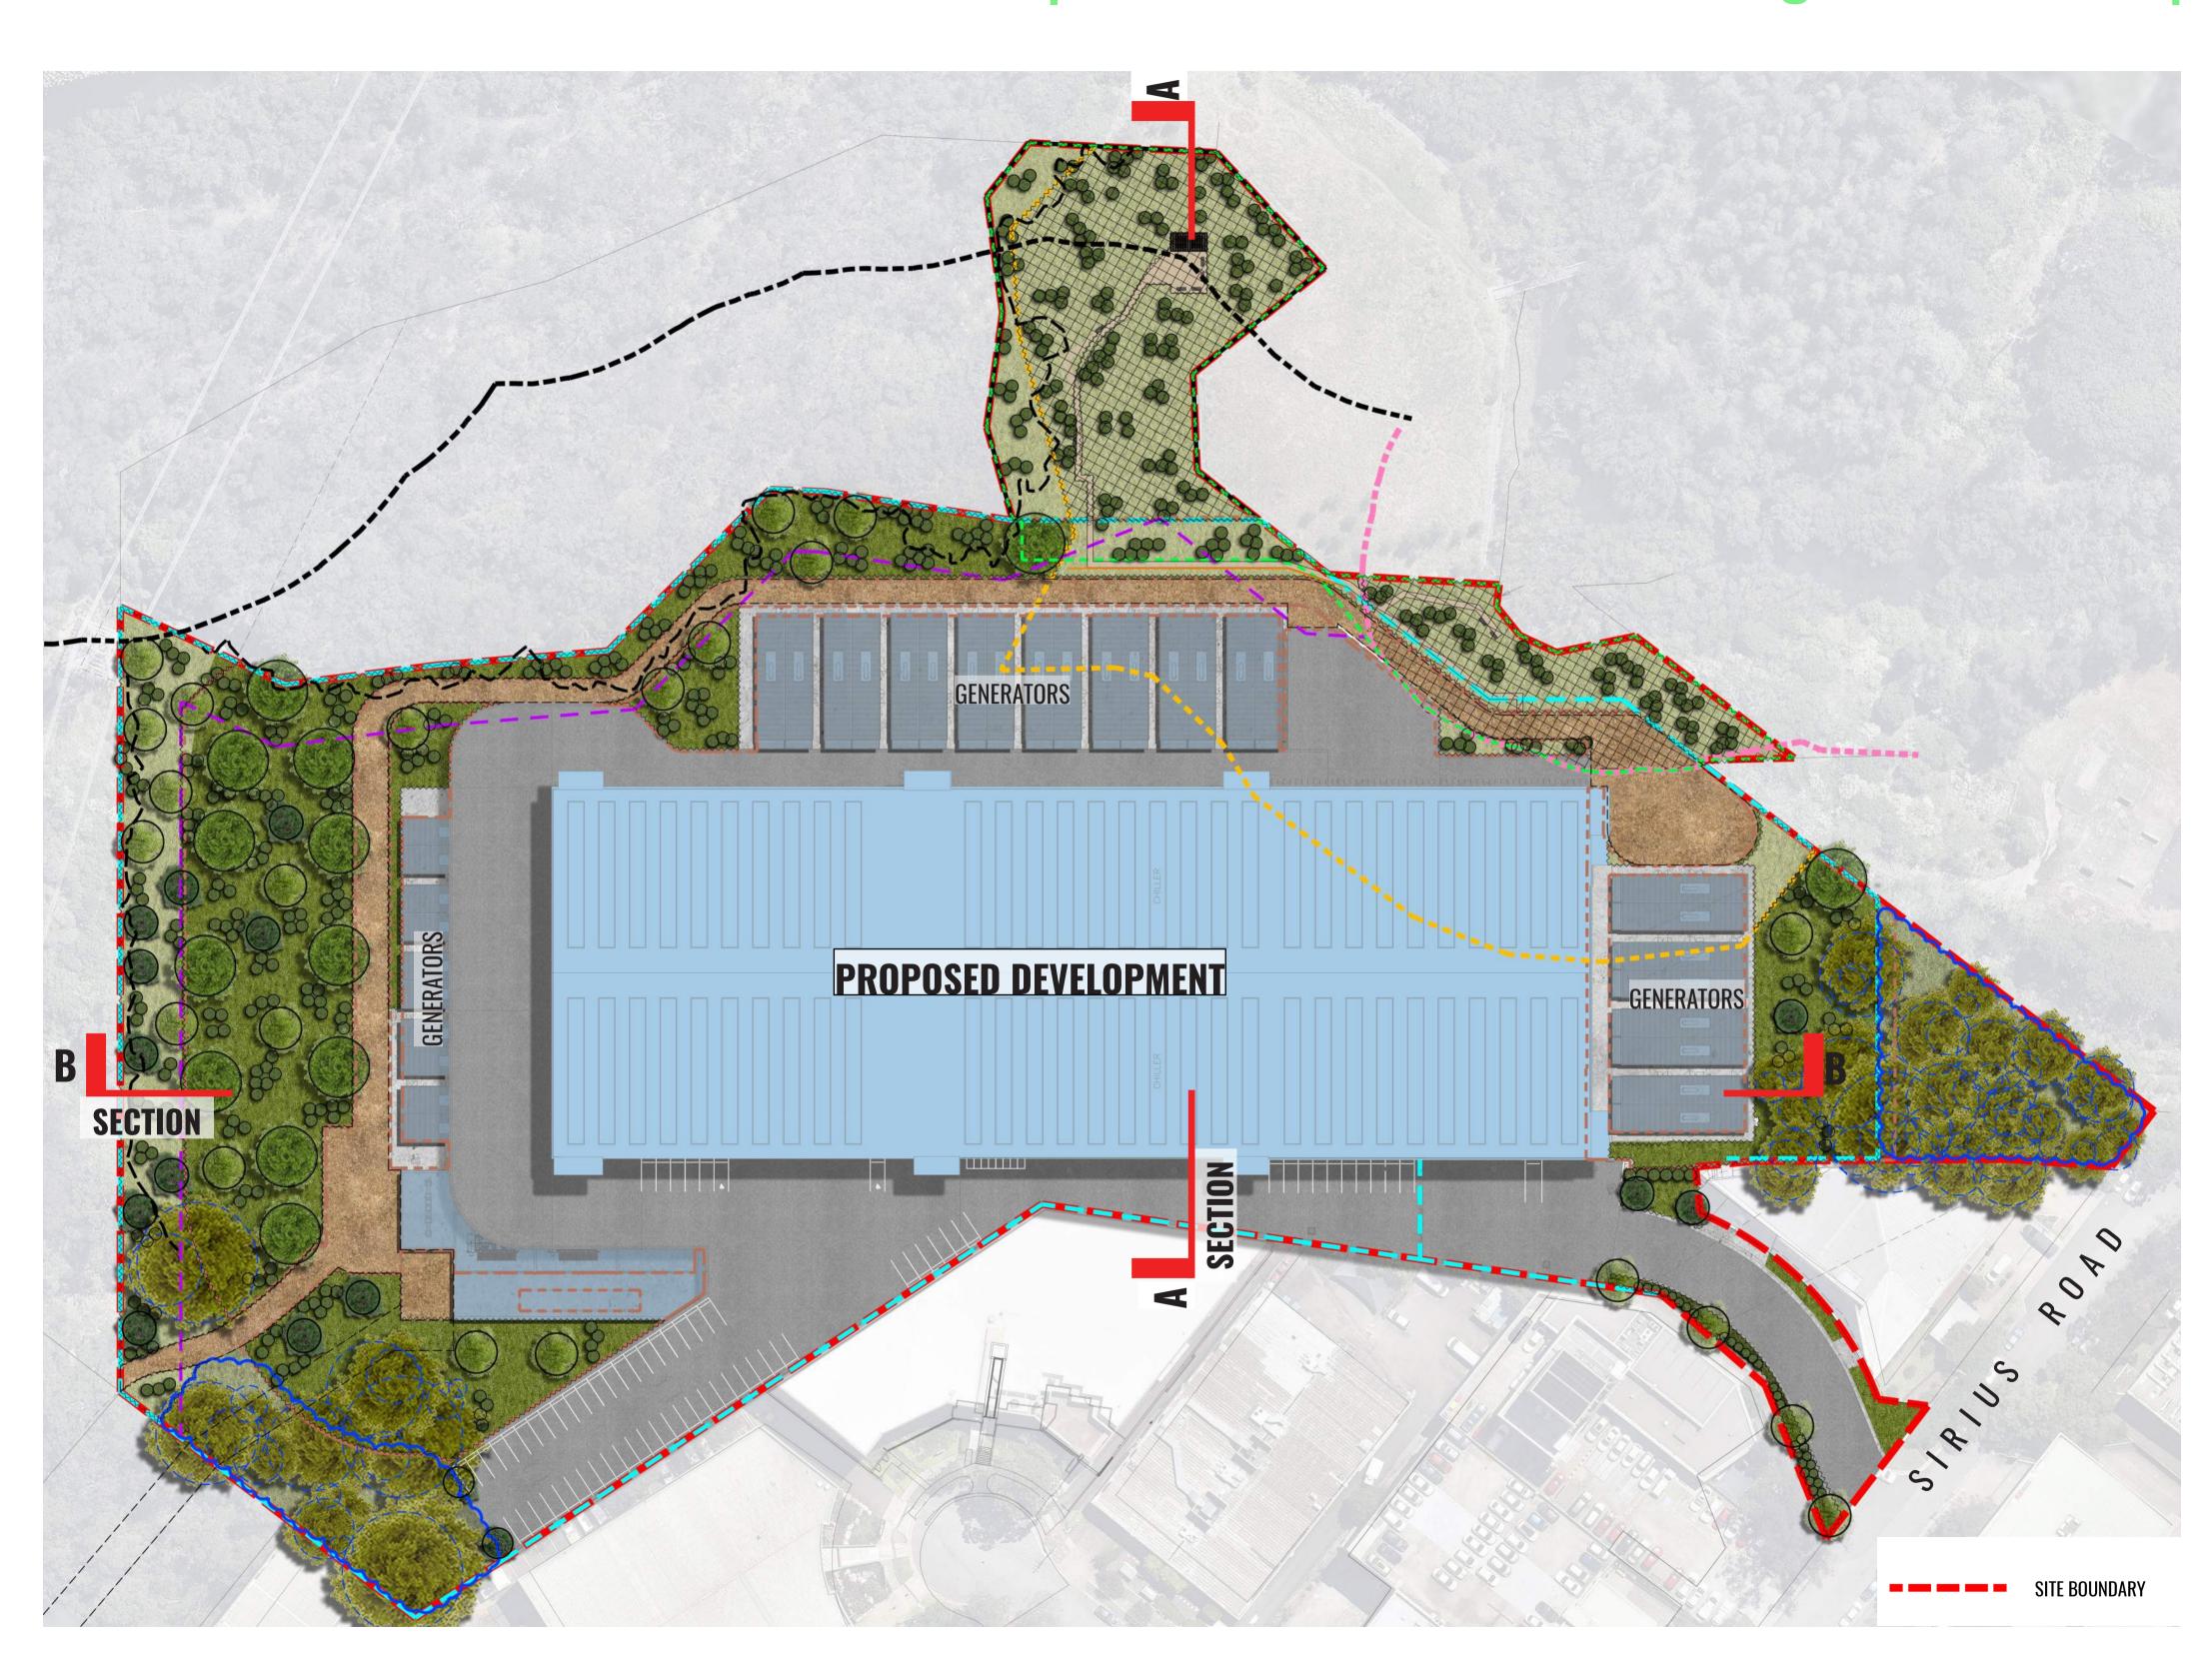

Drawing Register:

Drawing Name Dwg No. **LDA-00 Cover Sheet LDA-01 Landscape Masterplan LDA-02 Landscape Detailed Plan LDA-03 Landscape Sections: AA & BB LDA-04 Landscape Deep Soil Plan Existing Tree Plan & Tree Data Table LDA-05** LDA-06 **Typical Landscape Details & Specification Planting Schedules LDA-07**

Landscape Design Statement

The project at 1 Sirius Road, Lane Cove West, involves the development of a Data Centre within a development area of 3.9 ha. The site is accessed via an existing driveway from Sirius Road and is part of Lane Cove Business Park and zoned IN2 Light Industrial.

Landscaping design aims to provide the following:

- Adhering to the bushfire requirements.
- Preservation and retention of existing trees where possible.
- Strengthening local character with the use of local indigenous species.
- Provision of 10% of the site for Landscape Amenity for workers.
- To help screen and filter views of the development for users of the adjacent bushland and visual receptors within the wider context with tree and shrub planting.


Refer to Landscape Design Report LDR01 by Geoscapes for further design details.

Drawing Title:
Cover Sheet
DWG No:





Scale:	Date:	Job Number:	North:	Revis	sion		FOR DEVELOP	MENT A	PPROVAL
N/A	00.0040	101100		Rev	Date	Description		Drawn	Checked
	26.08.19	181108		C	26.08.19	FOR SSD SUBMISSION		SW	BG
				В	03.07.19	FOR SSD SUBMISSION		SW	BG
Project:	Prnnn	sed Data Centre		A	18.12.18	FOR SSD SUBMISSION		CC	BG
	ιτορο								
		Lane Cove Wes	st NSW 2066						

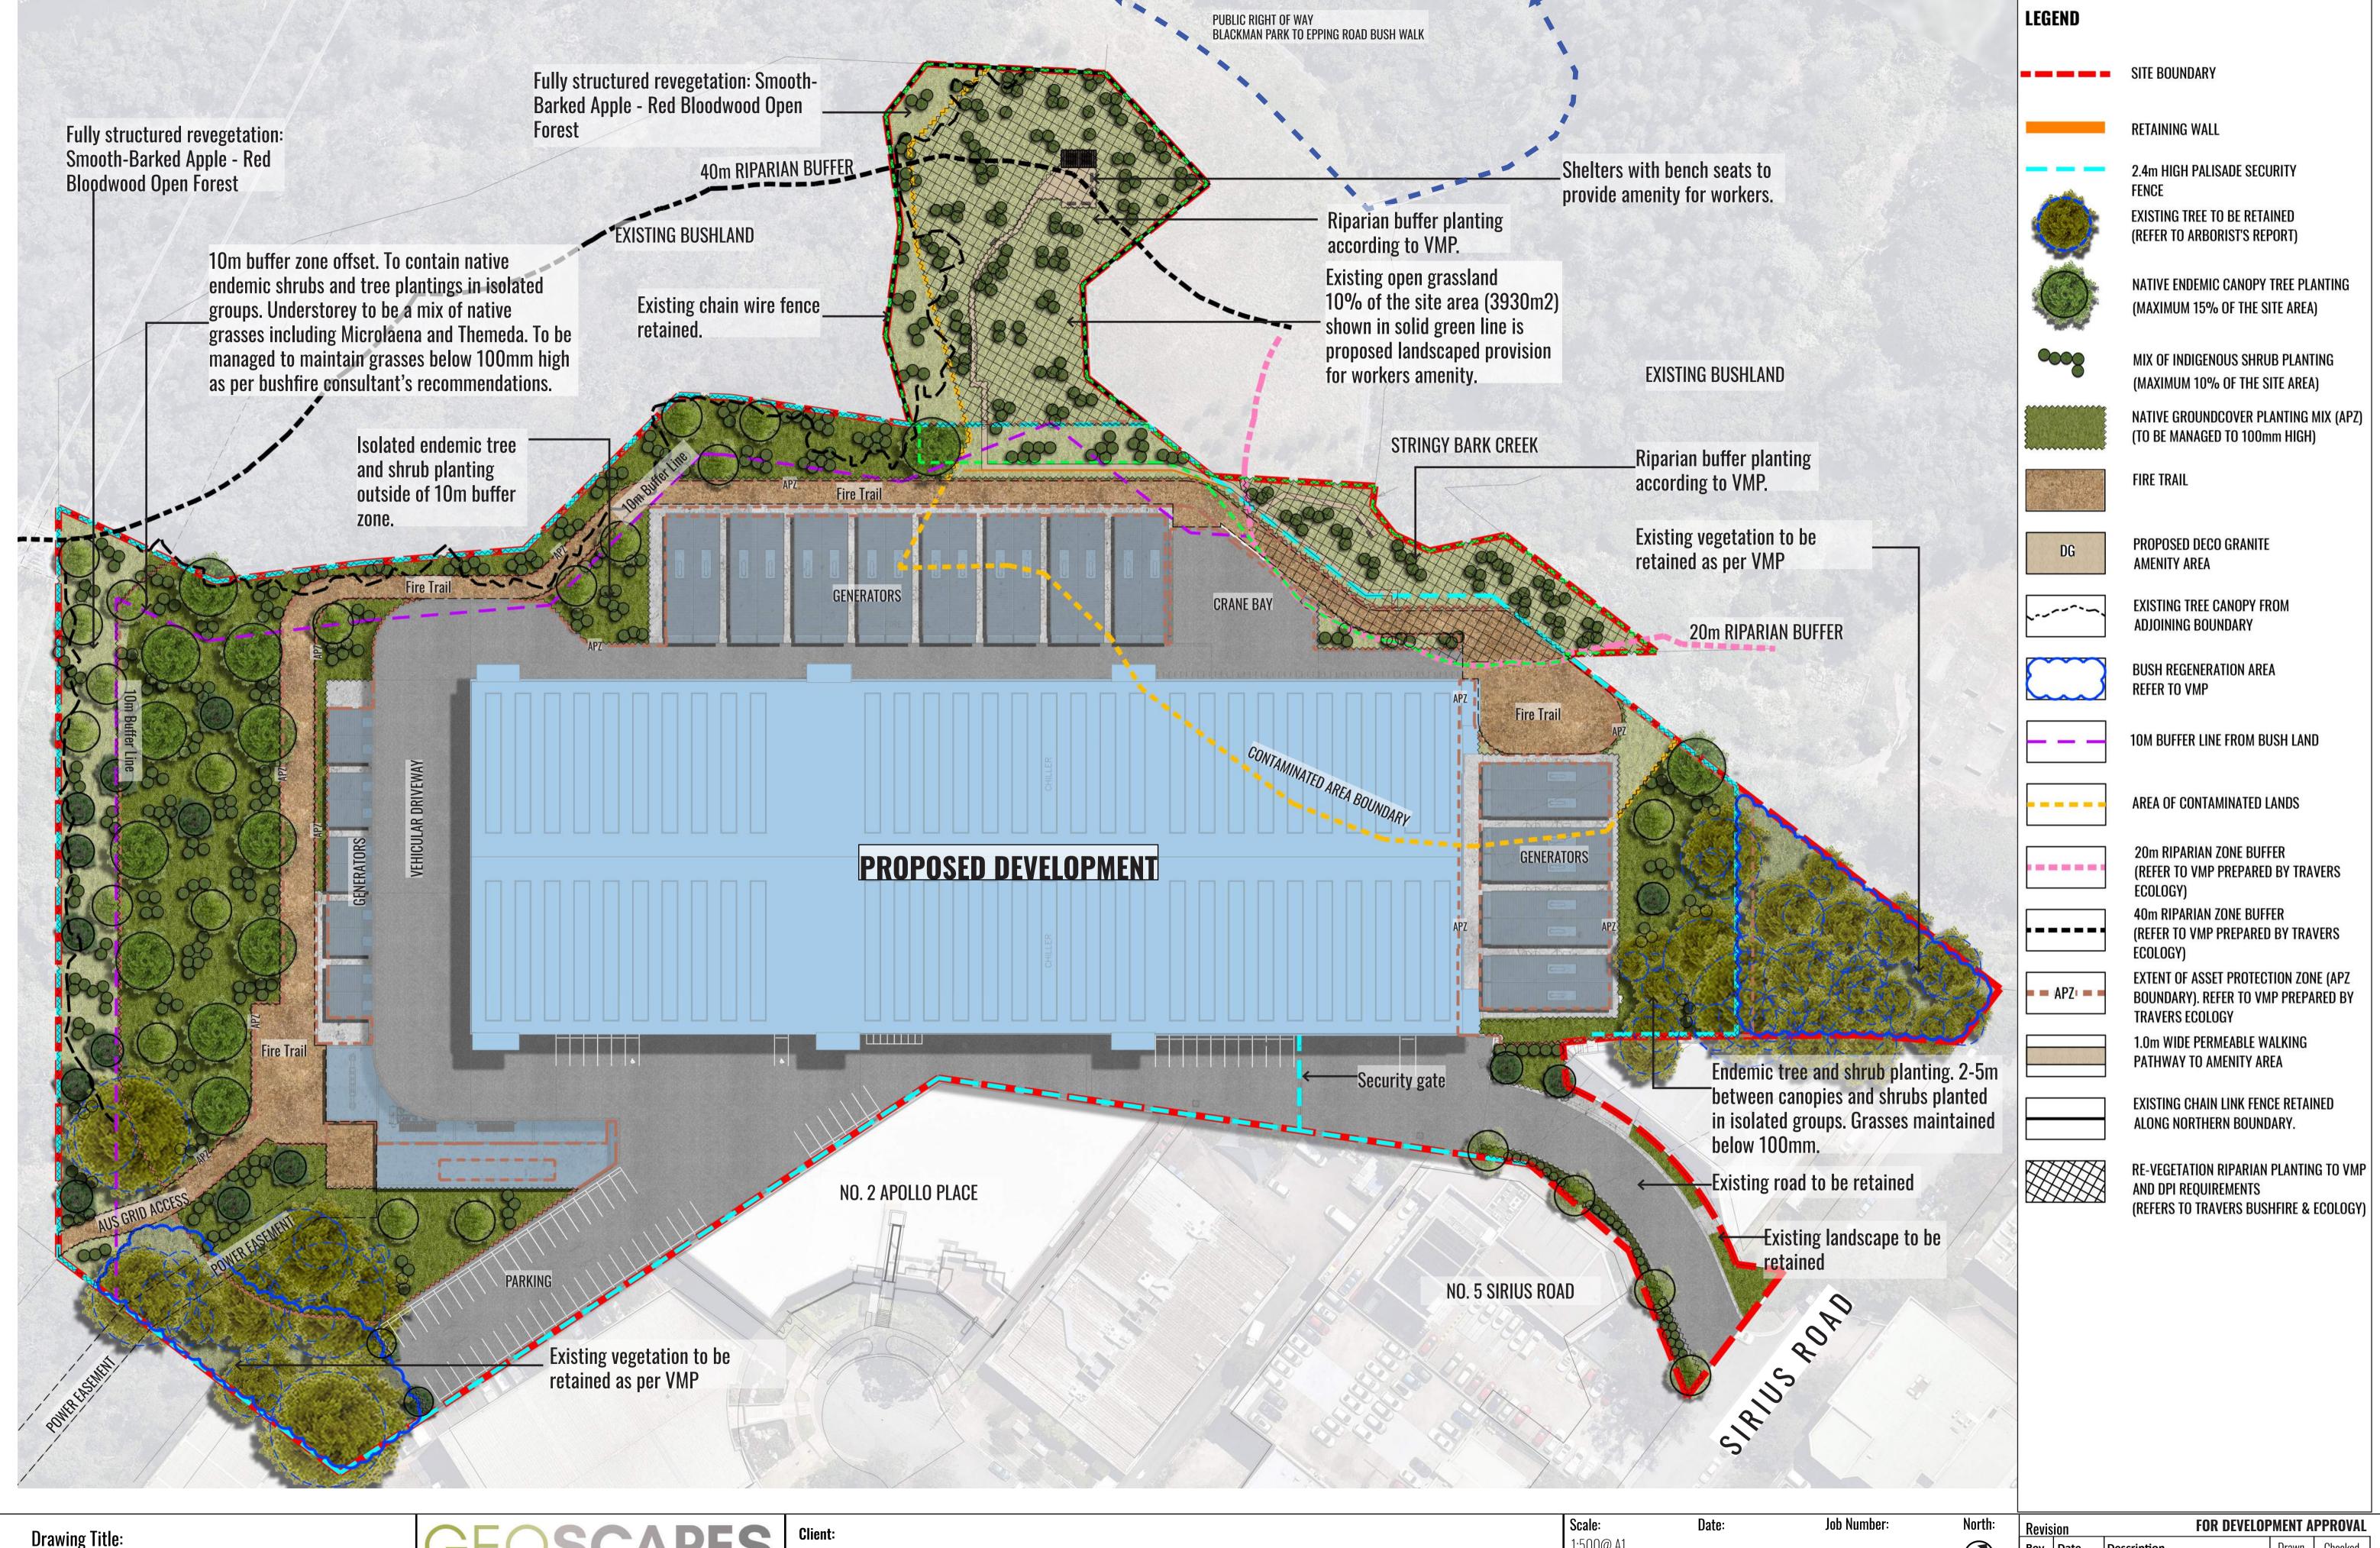

Drawing Title:

Landscape Masterplan


DWG No:


Suite 215, 284 Victoria Av, Chatswood NSW 2067 Ph. (02) 9411 1485 www.geoscapes.com.au ABN 84 620 205 781 ACN 620 205 781 Registered Landscape Architect #5868


GREENLOX

Scale:	Date:	Job Number:	North:	Re
1:500@ A1 1:1000 @ A3	26.08.19	181108		Re
111000 @ 710	20100110	101100		В
Project:	Pronosed	l Data Centre		A
,	1 100000			
		Lane Cove West I	NSW 2066	

	Kevis	<u> </u>	_	TON DEVELOR	WILITI A	IINOTAL
	Rev	Date	Description		Drawn	Checked
	C	26.08.19	FOR SSD SUBMISSION		SW	BG
	В	03.07.19	FOR SSD SUBMISSION		SW	BG
	A	18.12.18	FOR SSD SUBMISSION		CC	BG
66				-		

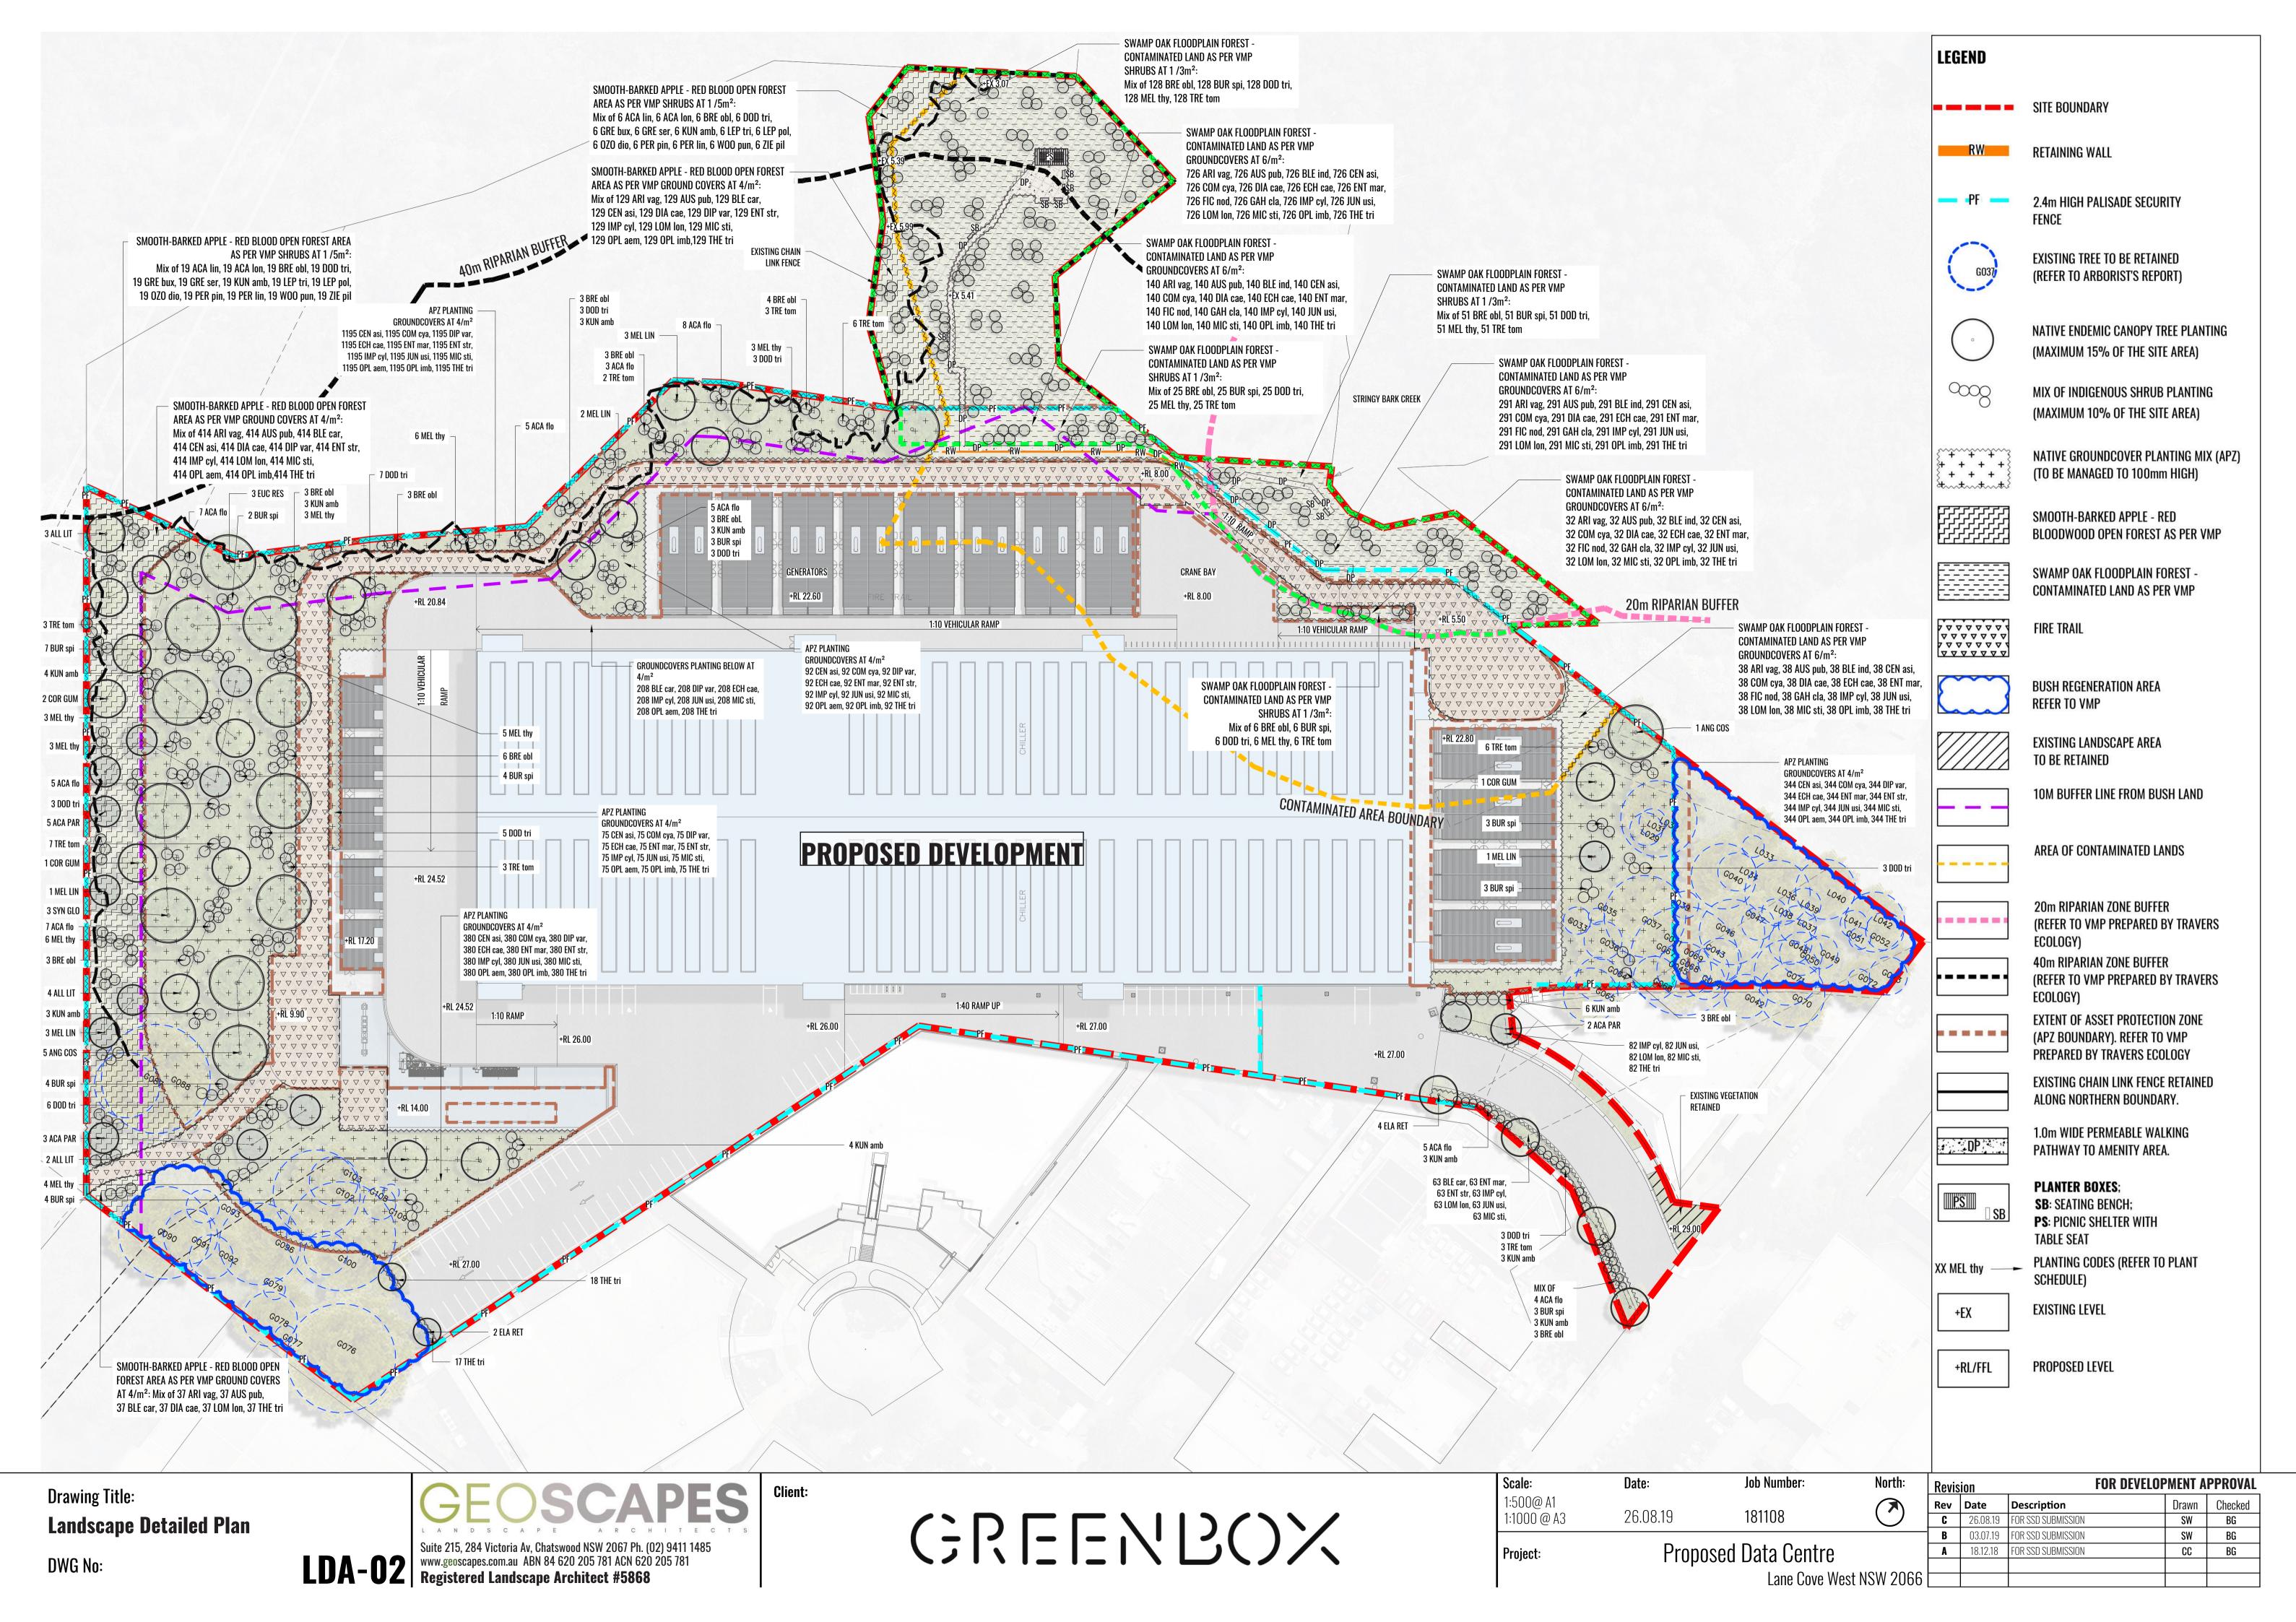

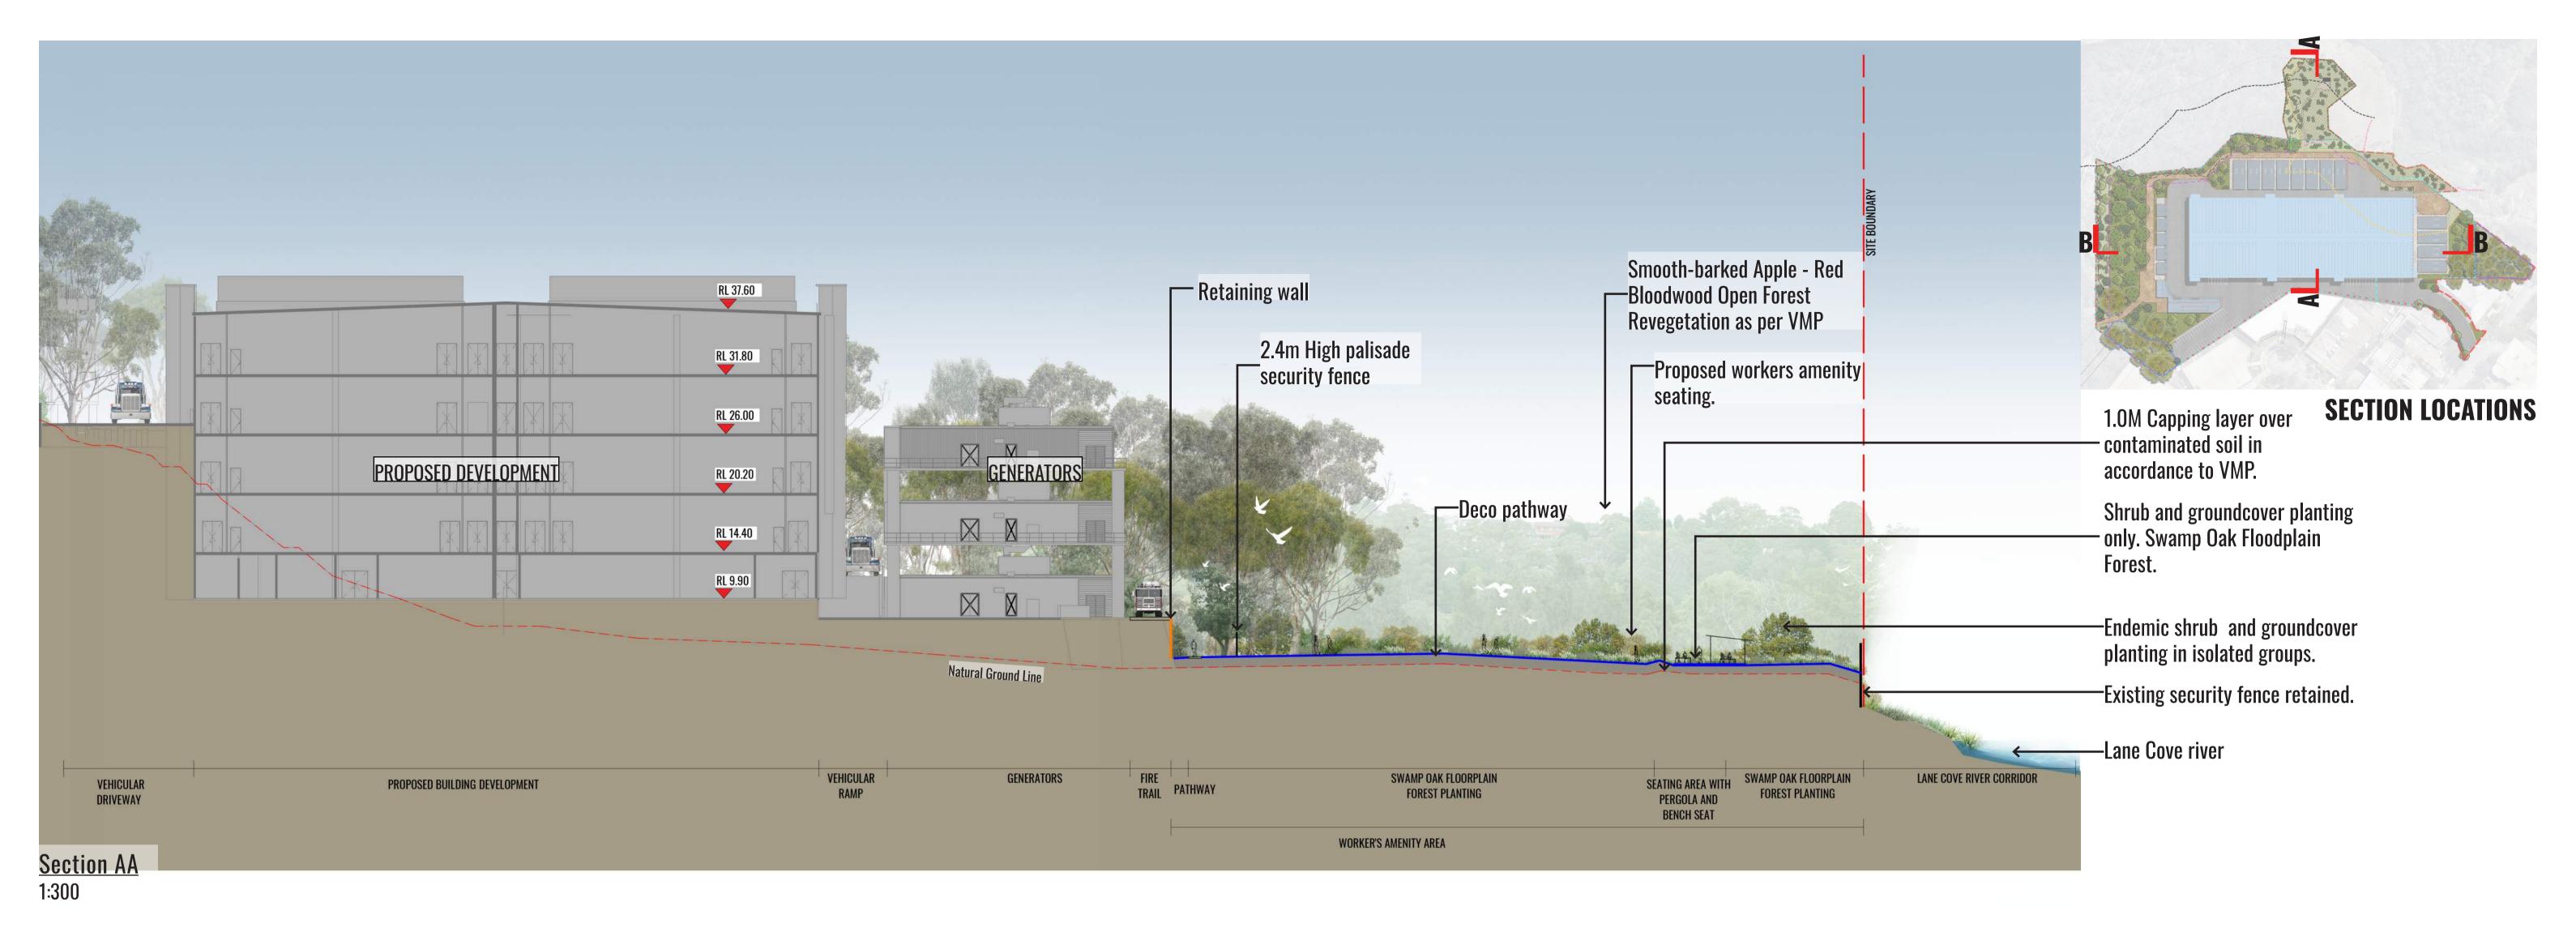

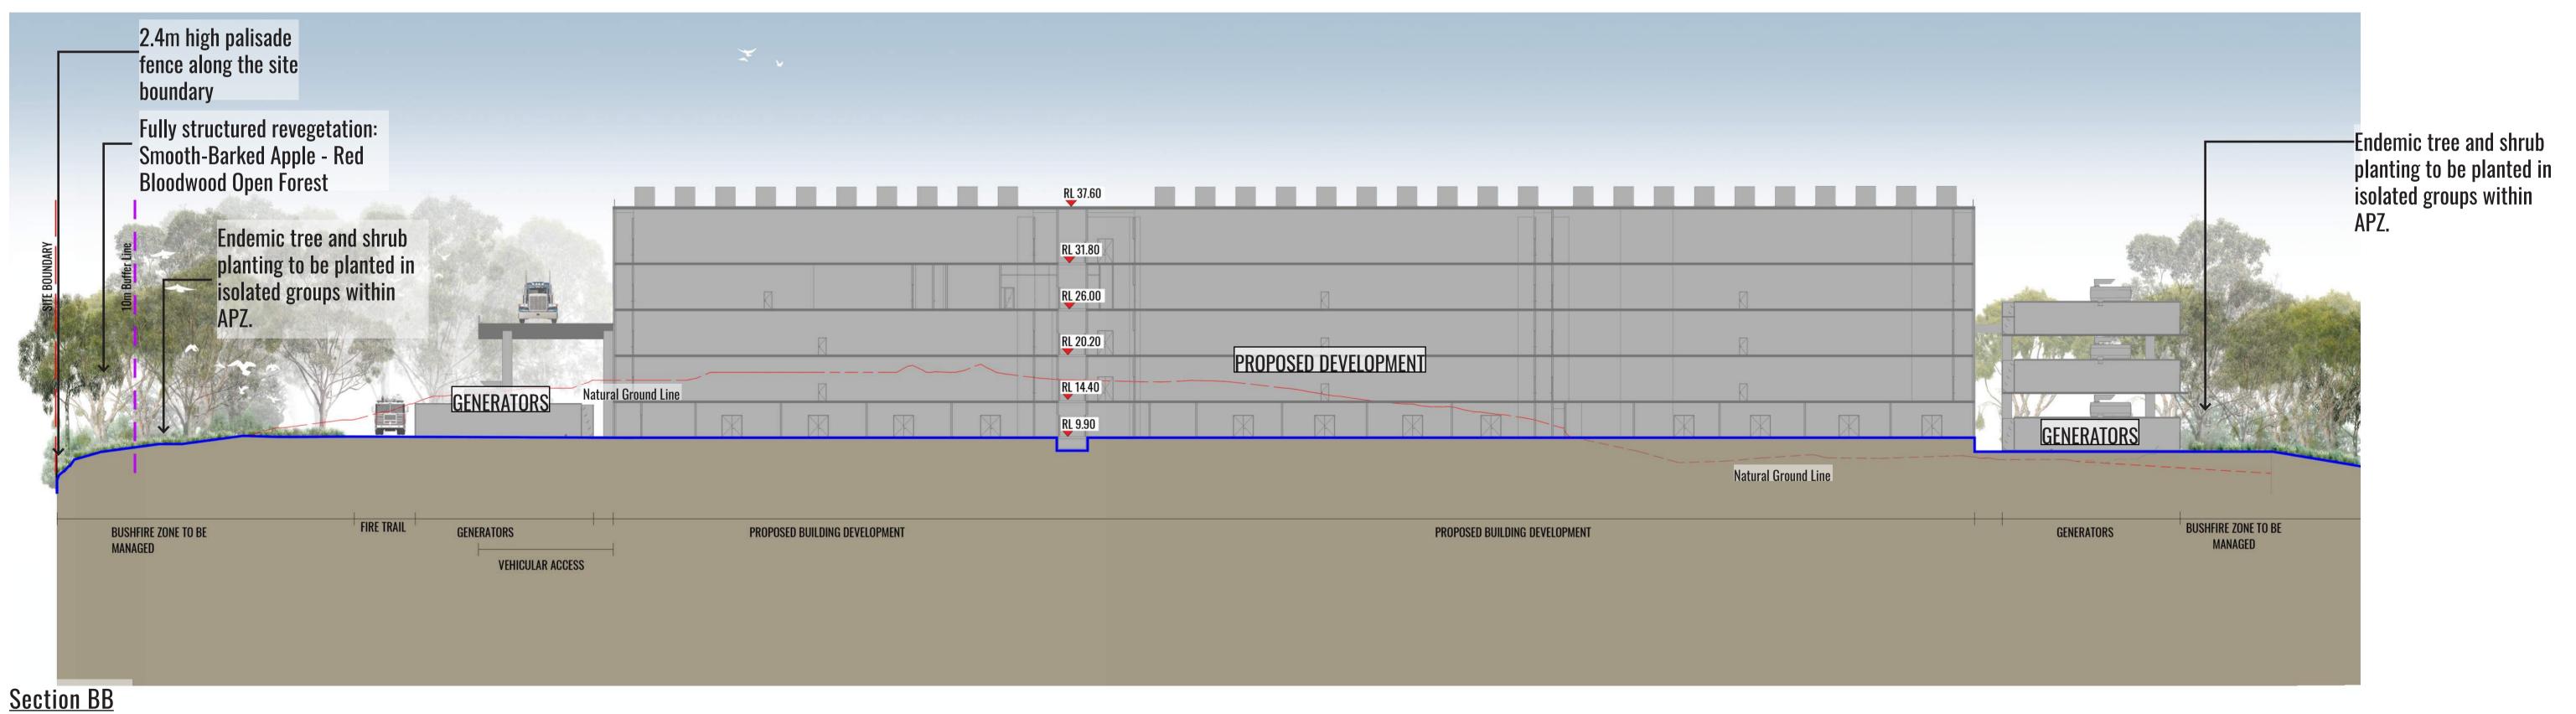

Drawing Title:

Landscape Sections - AA & BB


DWG No:

Suite 215, 284 Victoria Av, Chatswood NSW 2067 Ph. (02) 9411 1485 www.geoscapes.com.au ABN 84 620 205 781 ACN 620 205 781 Registered Landscape Architect #5868

Client:

GRENLOX

Scale:	Date: Job Number:		North:	Revision		FOR DE	FOR DEVELOPMENT APPROVAL		
AS SHOWN	00.0040	404400	N/A	Rev	Date	Description	Drawn	Checked	
	26.08.19	181108		C	26.08.19	FOR SSD SUBMISSION	SW	BG	
				В	03.07.19	FOR SSD SUBMISSION	SW	BG	
Project:	Proposed Data Centre			A	18.12.18	FOR SSD SUBMISSION	CC	BG	
,	1 1000	ood Data Contro							
		Lane Cove We	st NSW 2066						

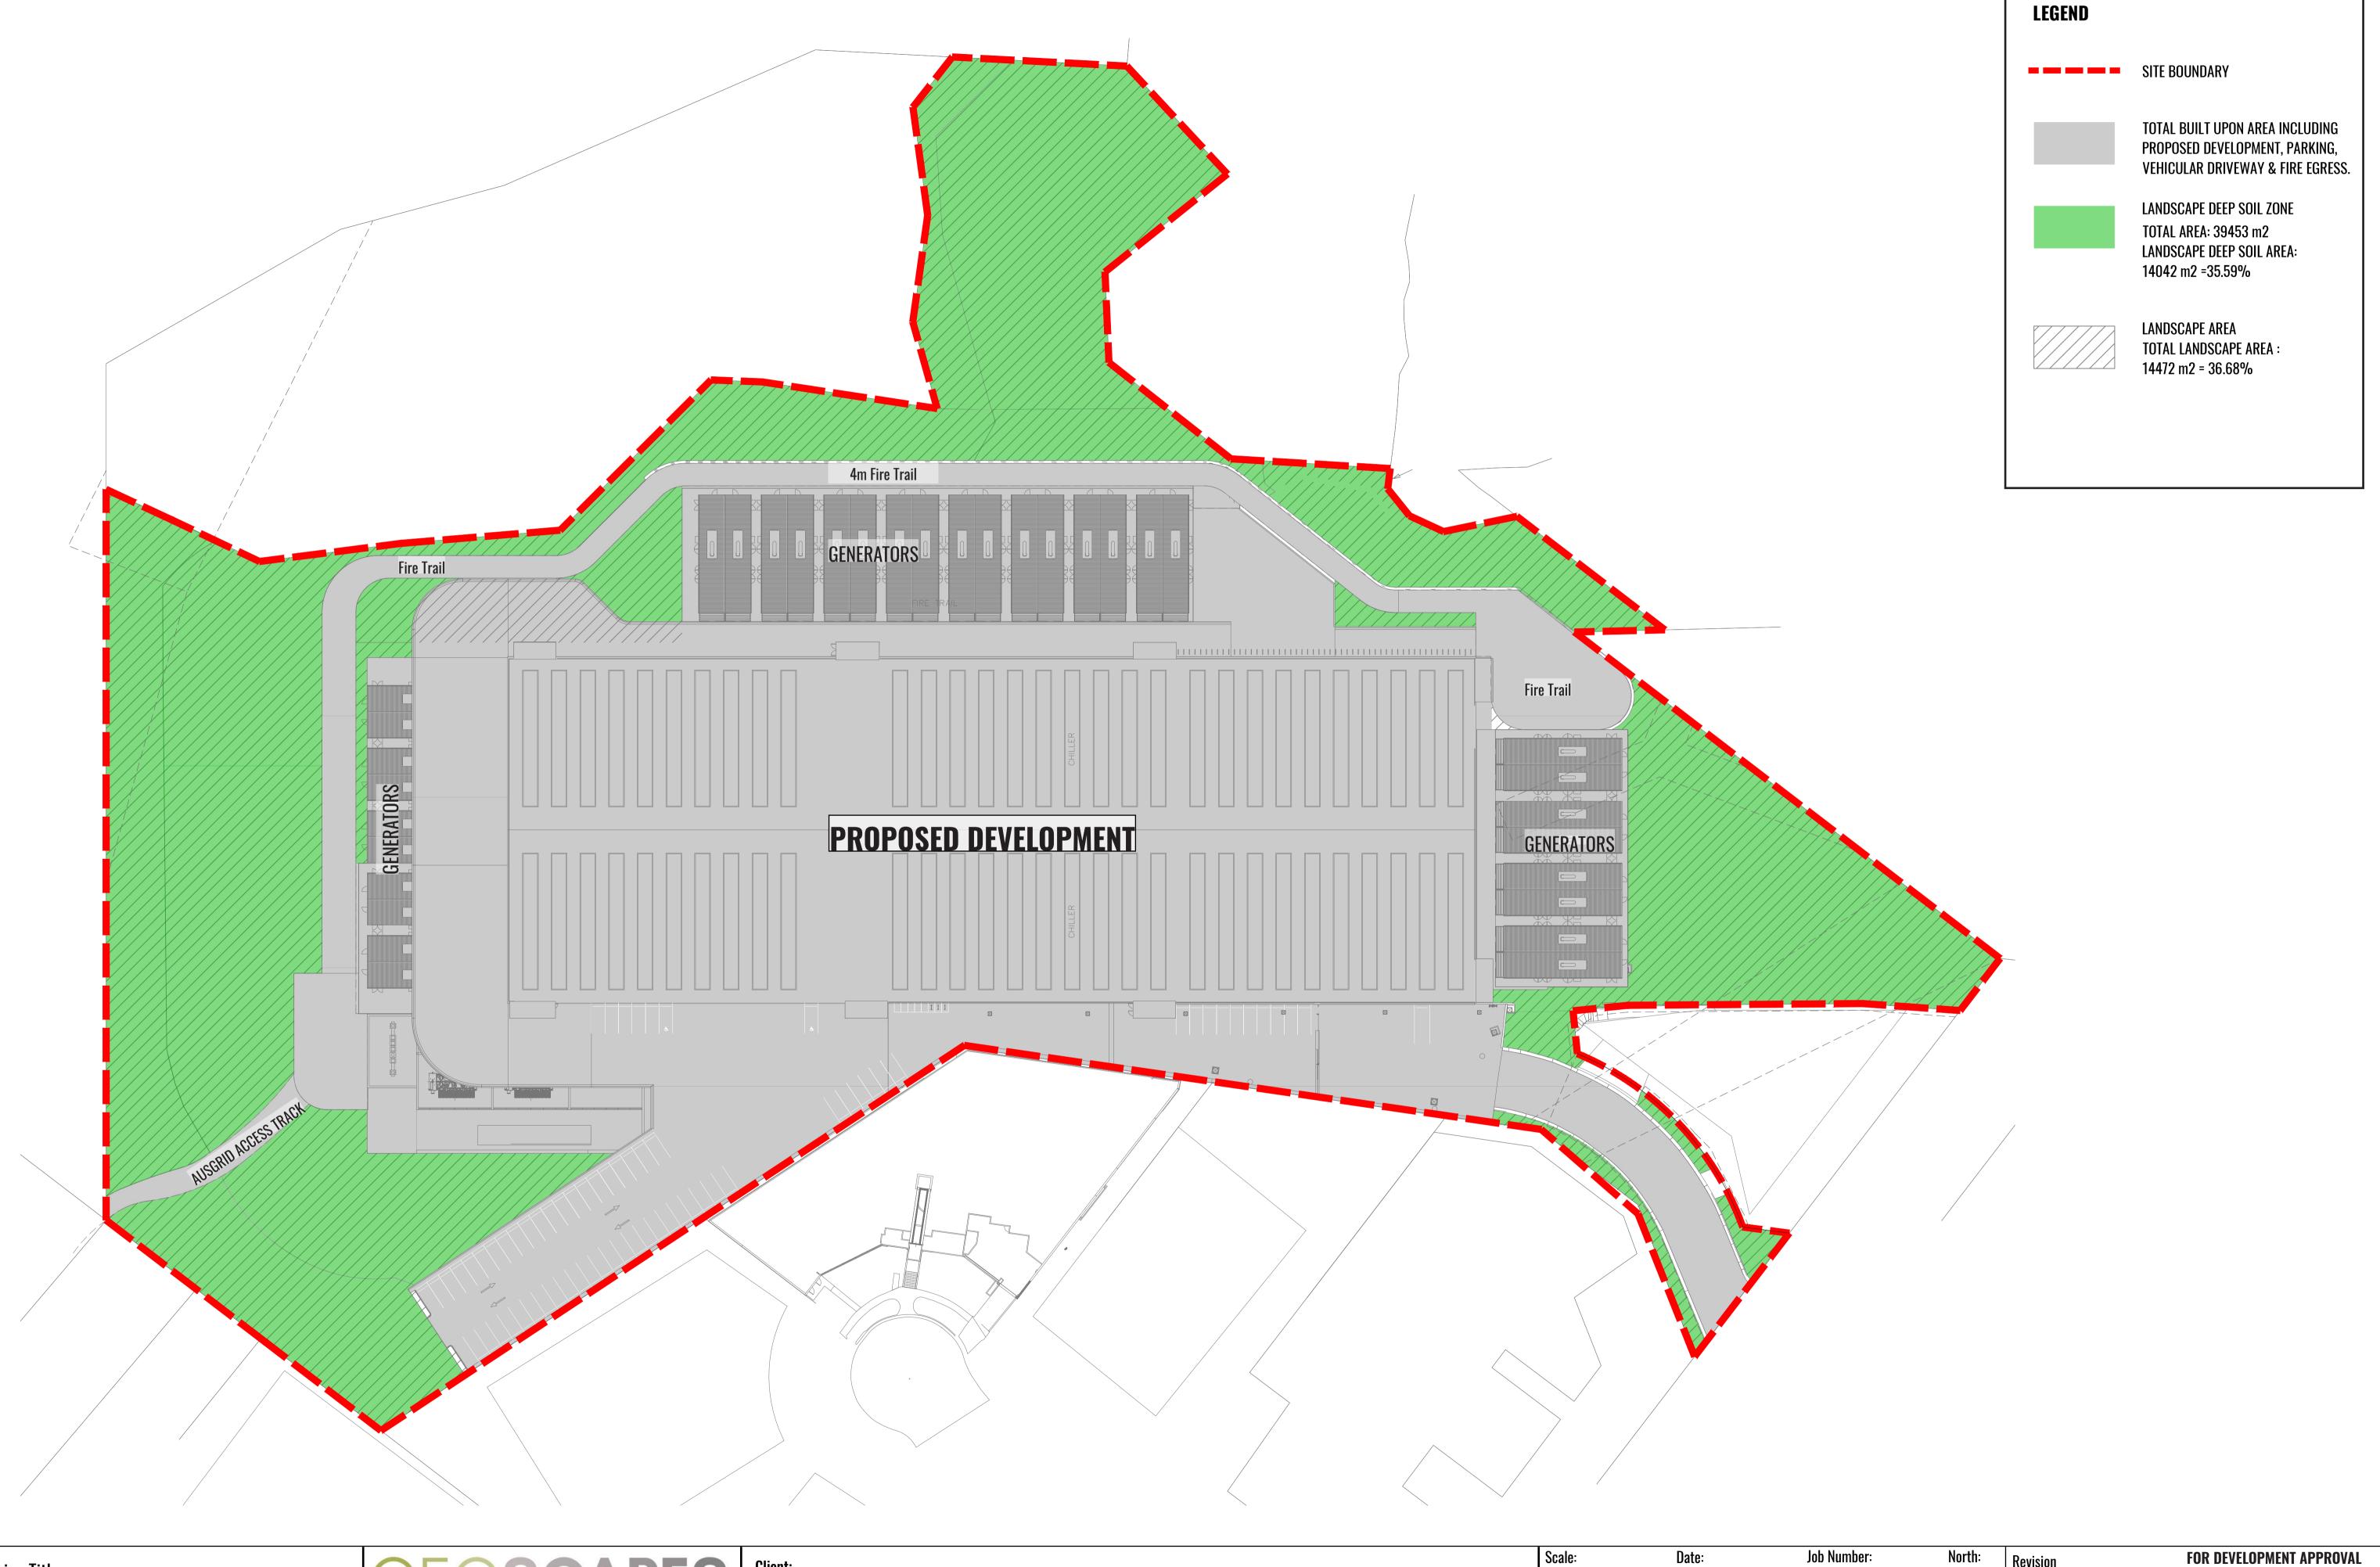


Drawing Title: **Landscape Deep Soil Plan**DWG No:

Suite 215, 284 Victoria Av, Chatswood NSW 2067 Ph. (02) 9411 1485 www.geoscapes.com.au ABN 84 620 205 781 ACN 620 205 781 Registered Landscape Architect #5868

GREENB()X

Scale:	Date:	Job Number:	North:	Revis	sion	
1:500@ A1	00 00 10	101100		Rev	Date	Descript
1:1000 @ A3	26.08.19	181108		C	26.08.19	FOR SSD SU
				В	03.07.19	FOR SSD SU
Project:	Prono	osed Data Centre		A	18.12.18	FOR SSD SU
.,	11000					
		Lane Cove We	st NSW 2066			

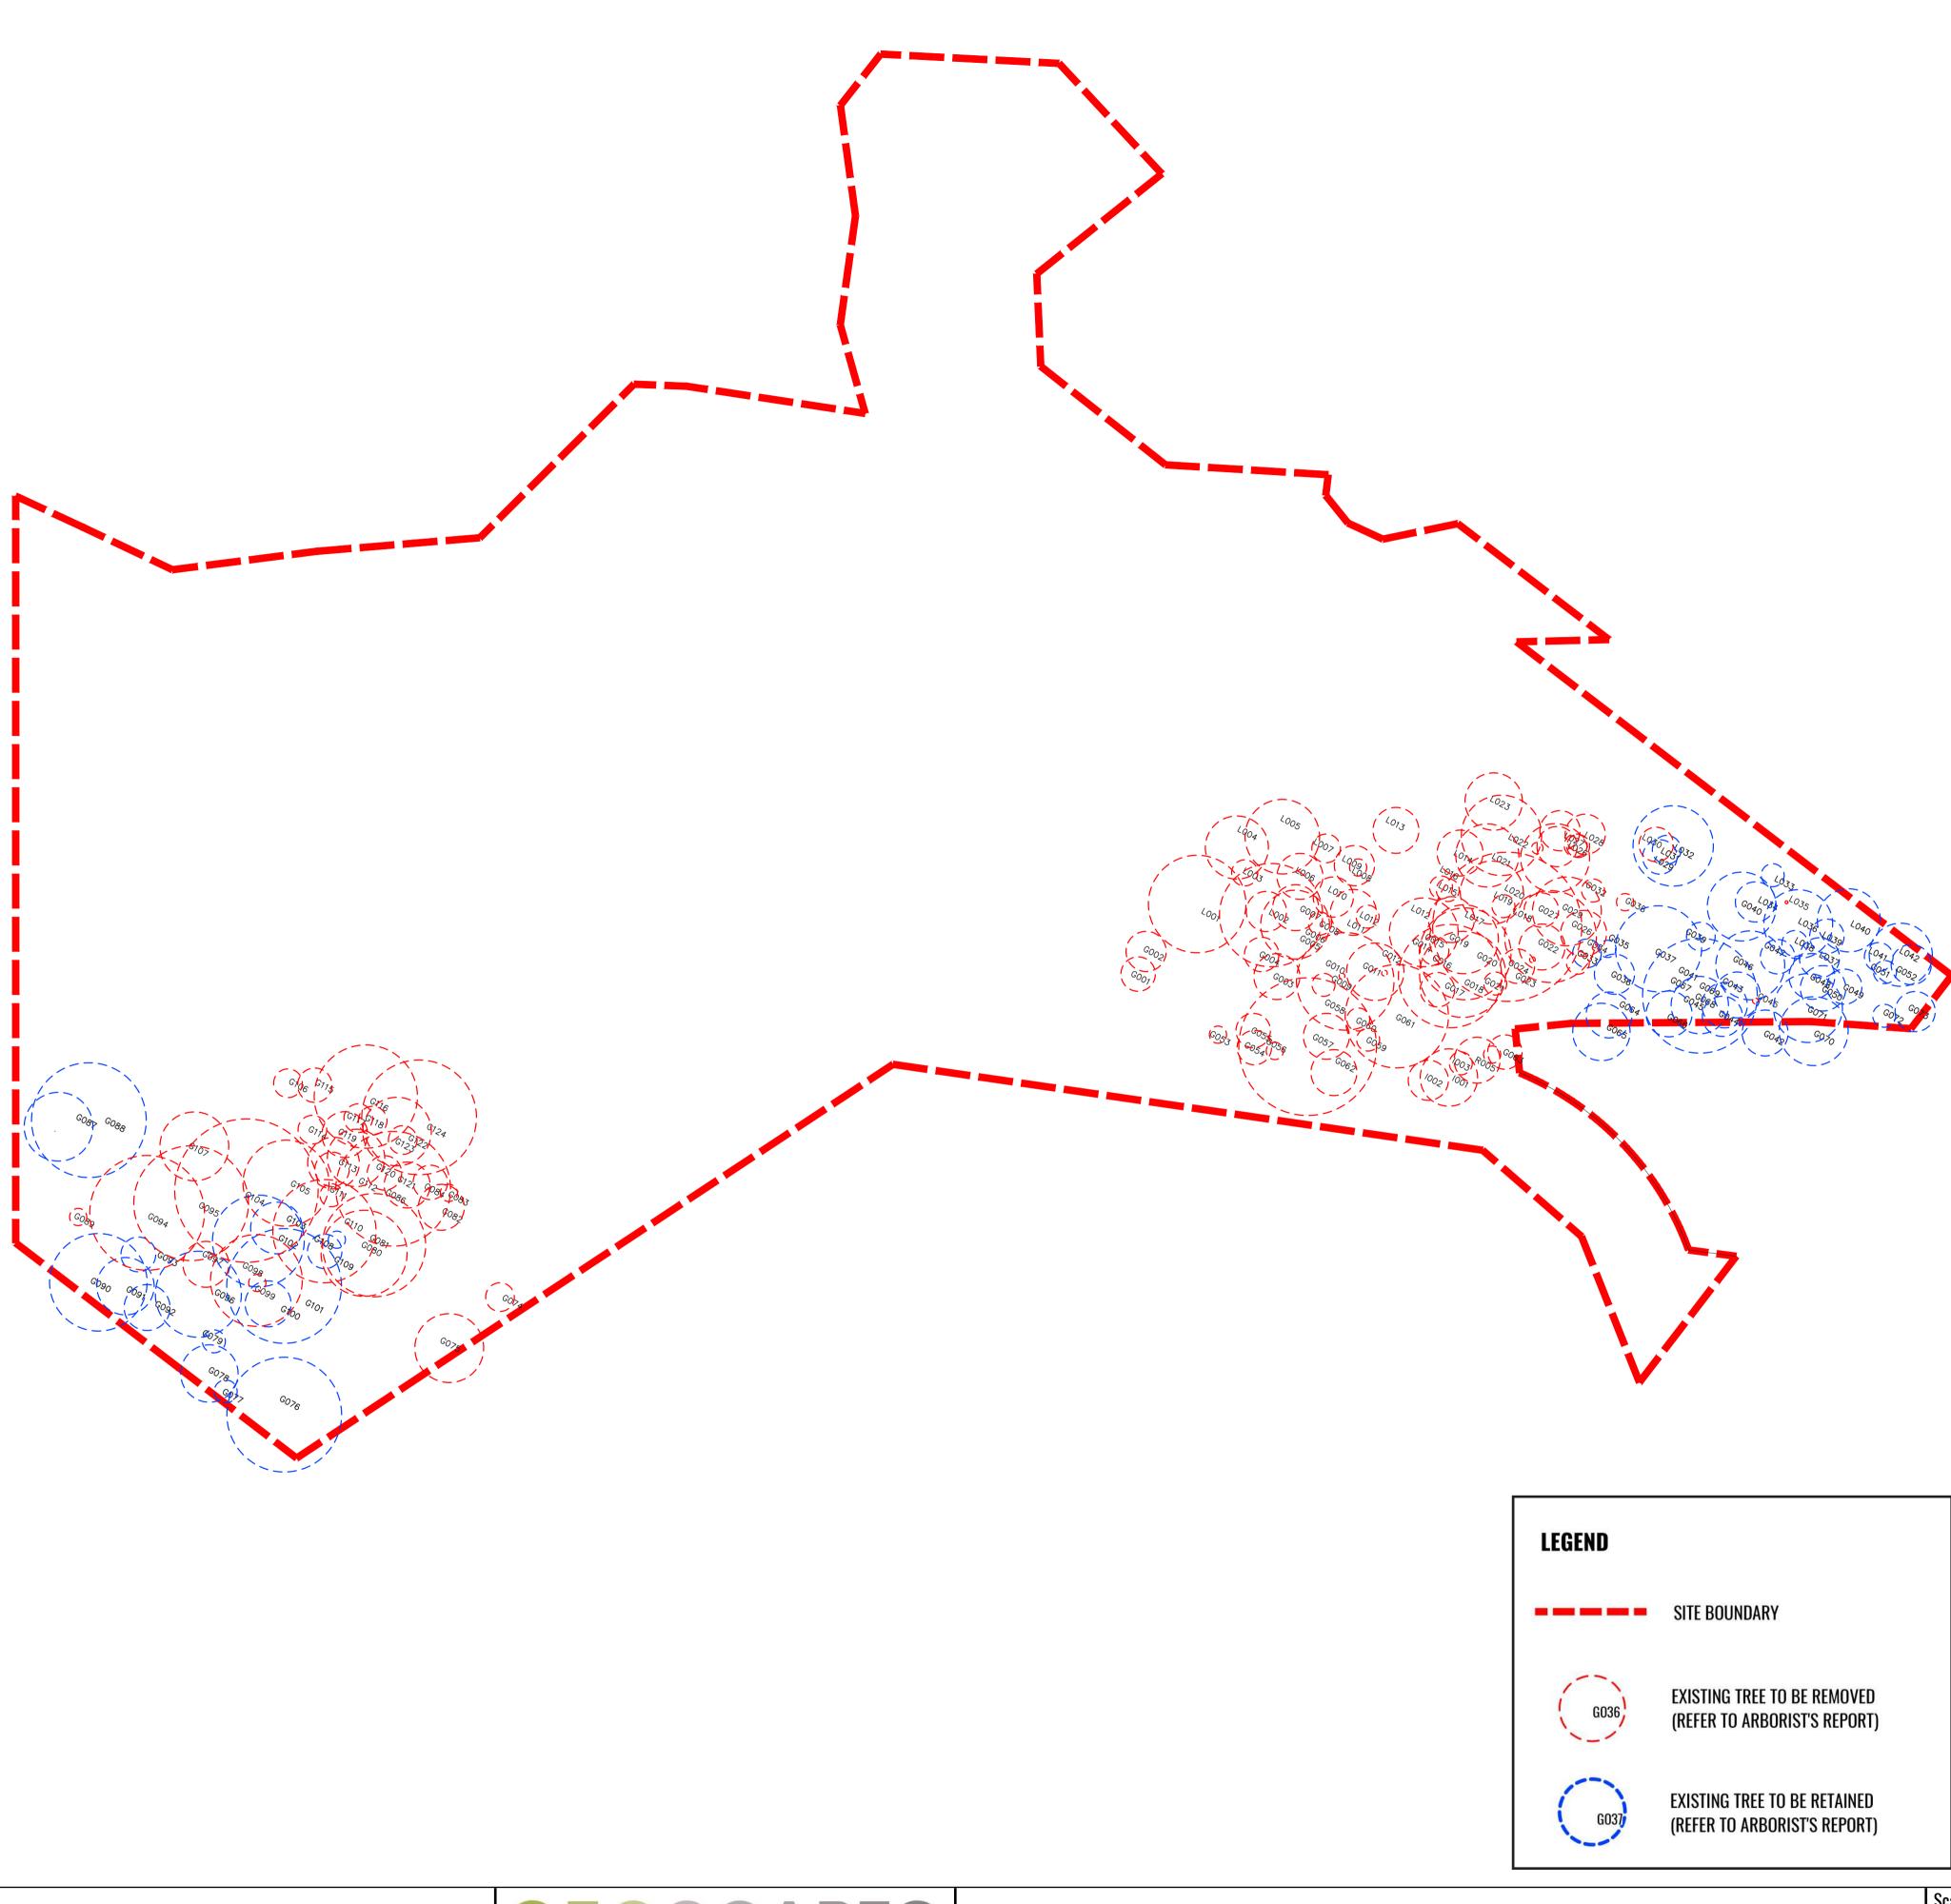

Scientific name T-G001 Camphor Laurel Cinnamomum camphora T-G002 Narrow-leaved Paperbark Melaleuca linariifolia T-G003 Red Bloodwood Corymbia gummifera T-G004 Smooth-barked Apple Angophora costata Eucalyptus piperita G005 Sydney Peppermint T-G006 Sydney Peppermint Eucalyptus piperita T-G007 Smooth-barked Apple Angophora costata G008 Smooth-barked Apple Angophora costata T-G009 Red Bloodwood Corymbia gummifera T-G010 Smooth-barked Apple Angophora costata T-G012 Smooth-barked Apple Angophora costata T-G013 Dead Stag Dead Stag T-G014 Red Bloodwood Corymbia gummifera T-G015 Dead Stag Dead Stag T-G016 Parramatta Wattle Acacia parramattensis T-G017 Sydney Peppermint Eucalyptus piperita T-G018 Smooth-barked Apple Angophora costata T-G019 Black She-oak allocasuarina littoralis T-G020 Smooth-barked Apple Angophora costata GO21 Smooth-barked Apple Angophora costata GO22 Cheese Tree Glochidion ferdinandi Glochidion ferdinandi T-G023 Cheese Tree T-G024 Dead Stag Dead Stag T-G025 Camphor Laurel Cinnamomum camphora T-G026 Dead Stag Dead Stag T-G027 Cheese Tree Glochidion ferdinandi Glochidion ferdinandi T-G029 Cheese Tree Glochidion ferdinandi T-G030 Red Mahogany Eucalyptus resinifera T-G031 Dead Stag Dead Stag Dead Stag T-G033 Cheese Tree Glochidion ferdinandi Dead Stag T-G034 Dead Stag T-G035 Cheese Tree Glochidion ferdinandi T-G036 Camphor Laurel Cinnamomum camphora T-G037 Smooth-barked Apple Angophora costata Γ-G038 Dead Stag T-G040 Hard-leaved Scribbly Gum | Eucalyptus sclerophylla T-G041 Hard-leaved Scribbly Gum | Eucalyptus sclerophylla Glochidion ferdinandi Cheese Tree Smooth-barked Apple Angophora costata r-G044 Red Mahogany Eucalyptus resinifera T-G045 Dead Stag Dead Stag GO47 Smooth-barked Apple Angophora costata G048 Smooth-barked Apple Angophora costata T-G049 Camphor Laurel Cinnamomum camphora Γ-G051 Red Mahogany Eucalyptus resinifera Camphor Laurel Cinnamomum camphora Black She-oak Allocasuarina littoralis Red Mahogany Eucalyptus resinifera T-G055 Red Mahogany Eucalyptus resinifera Eucalyptus resinifera Red bloodwood Corymbia gummifera Parramatta Wattle Acacia parramattensis Parramatta Wattle Acacia parramattensis Eucalyptus piperita Eucalyptus globoidea Swamp Oak Casuarina glauca Red Mahogany Eucalyptus resinifera Eucalyptus resinifera Dead Stag mooth-barked Apple Angophora costata Smooth-barked Apple Angophora costata Eucalyptus resinifera r-G071 Red Mahogany Eucalyptus resinifera Large-leaved Privet Ligustrum lucidum Γ-G074 Hard-leaved Scribbly Gum | Eucalyptus sclerophylla G-G075 Hard-leaved Scribbly Gum Eucalyptus sclerophylla Acacia parramattensis Red Mahogany Eucalyptus resinifera mooth-barked Apple mooth-barked Apple Angophora costata nooth-barked Apple Angophora costata mooth-barked Apple Angophora costata Eucalyptus sp. Dead Stag GO85 Smooth-barked Apple Angophora costata T-G086 Smooth-barked Apple Angophora costata

T-G088	White Stringybark Sydney Peppermint	Eucalyptus globoidea Eucalyptus piperita	Reta Reta
T-G089	Smooth-barked Apple	Angophora costata	Rem
T-G090	Sydney Peppermint	Eucalyptus piperita	Rem
T-G091	Smooth-barked Apple	Angophora costata	Reta
T-G092	Smooth-barked Apple	Angophora costata	Reta
T-G093	Sydney Peppermint	Eucalyptus piperita	Reta
T-G094	Sydney Peppermint	Eucalyptus piperita	Reta
T-G095	Sydney Peppermint	Eucalyptus piperita	Reta
T-G096	Smooth-barked Apple	Angophora costata	Rem
T-G097	Sydney Peppermint	Eucalyptus piperita	Rem
T-G098	Smooth-barked Apple	Angophora costata	Rem
T-G099	Sydney Peppermint	Eucalyptus piperita	Rem
T-G100	Smooth-barked Apple	Angophora costata	Rem
T-G101	Smooth-barked Apple	Angophora costata	Rem
T-G102	Smooth-barked Apple	Angophora costata	Rem
T-G103	Sydney Peppermint	Eucalyptus piperita	Rem
T-G104	Smooth-barked Apple	Angophora costata	Rem
T-G105	Sydney Peppermint	Eucalyptus piperita	Rem
T-G106	Sydney Peppermint	Eucalyptus piperita	Rem
T-G107	Sydney Peppermint	Eucalyptus piperita	Remo
T-G108	Smooth-barked Apple	Angophora costata	Remo
T-G109	Black She-oak	Allocasuarina littoralis	Rem
T-G110	Sydney Peppermint	Eucalyptus piperita	Rem
T-G111	Smooth-barked Apple	Angophora costata	Rem
T-G112	Red Mahogany	Eucalyptus resinifera	Rem
	Smooth-barked Apple	Angophora costata	
T-G113		- '	Rem
T-G114	Red Mahogany	Eucalyptus resinifera	Rem
T-G115	Sydney Peppermint	Eucalyptus piperita	Rem
T-G116	Red Mahogany	Eucalyptus resinifera	Remo
T-G117	Smooth-barked Apple	Angophora costata	Rem
T-G118	Smooth-barked Apple	Angophora costata	Rem
T-G119	Red Mahogany	Eucalyptus resinifera	Rem
T-G120	Sydney Peppermint	Eucalyptus piperita	Rem
T-G121	Red Bloodwood	Corymbia gummifera	Rem
T-G122	Smooth-barked Apple	Angophora costata	Rem
T-G123	Dead Stag	Dead Stag	Rem
T-G124	Smooth-barked Apple	Angophora costata	Rem
T-L001	Blackbutt	Eucalyptus pilularis	Rem
T-L002	Smooth-barked Apple	Angophora costata	Rem
T 1 000	Broad-leaved White	Eucolyptus umbro	Dom
T-L003	Mahogany	Eucalyptus umbra	Remo
T-L004	Smooth-barked Apple	Angophora costata	Remo
T-L005	Smooth-barked Apple	Angophora costata	Remo
T-L006	Smooth-barked Apple Broad-leaved White	Angophora costata	Rem
T-L007	Mahogany	Eucalyptus umbra	Rem
	Broad-leaved White		
T-L008	Mahogany	Eucalyptus umbra	Rem
T-L009	Dead Stag	Dead stag	Remo
T-L010	Smooth-barked Apple	Angophora costata	Remo
T-L011	Smooth-barked Apple	Angophora costata	Remo
T-L012	Dead Stag	Dead stag	Remo
T-L013	Smooth-barked Apple	Angophora costata	Remo
T-L014	Red Mahogany	Eucalyptus resinifera	Remo
T-L015	Smooth-barked Apple	Angophora costata	Remo
T-L016	Green Wattle	Acacia irrorata	Remo
T-L017	Smooth-barked Apple	Angophora costata	Rem
	Broad-leaved White		
T-L018	Mahogany	Eucalyptus umbra	Rem
T-L019	Cheese Tree	Glochidion ferdinandi	Rem
T-L020	Black She-oak	Allocasuarina littoralis	Rem
T-L021	Dead Stag	Dead Stag	Remo
T-L022	Red Mahogany	Eucalyptus resinifera	Remo
T-L023	Hickory Wattle	Acacia implexa	Rem
T-L024	Smooth-barked Apple	Angophora costata	Remo
T-L025	Large-leaved Privet	Ligustrum lucidum	Remo
T-L026	Large-leaved Privet	Ligustrum lucidum	Retai
T-L027	Small-leaved Privet	Ligustrum sinense	Retai
T-L028	Black Locust	Gleditsea tricanthos	Rem
T-L029	Black Locust	Gleditsea tricanthos	Retai
T-L030	Large-leaved Privet	Ligustrum lucidum	Retai
T-L031	Large-leaved Privet	Ligustrum lucidum	Rem
T-L032	Smooth-barked Apple	Angophora costata	Reta
T-L033	Cheese Tree	Glochidion ferdinandi	Reta
T-L034	Port Jackson Fig	Ficus rubiginosa	Rem
T-L035	Dead Stag	Dead Stag	Retai
T-L036	Smooth-barked Apple	Angophora costata	Rem
T-L037	Camphor Laurel	Cinnamomum camphora	Retai
T-L038	Cheese Tree	Glochidion ferdinandi	Reta
T-L039	Smooth-barked Apple	Angophora costata	Retai
T-L040	Smooth-barked Apple	Angophora costata	Retai
	Compher Lawrel	Cinnamamana	D
T 1 2 2 2 2	Camphor Laurel	Consending symmitors	Reta
T-L041	Red Bloodwood	Corymbia gummifera	Reta
T-L042	Smooth-barked Apple	Angophora costata	Reta
		1	
T-L042 T-r001	River Sheoak	Casuarina cunninghamiana	Non-
T-L042	River Sheoak	Casuarina cunninghamiana	Rem
T-L042 T-r001	River Sheoak River Sheoak	Casuarina cunninghamiana Casuarina cunninghamiana	
T-L042 T-r001 T-r002 T-r003	River Sheoak	Casuarina cunninghamiana	Remo
T-L042 T-r001 T-r002			

Checked

BG

Drawing Title:

Existing Tree Plan & Tree Data Table

DWG No:

Table


Suite 215, 284 Victoria Av, Chatswood NSW 2067 Ph. (02) 9411 1485


www.geoscapes.com.au ABN 84 620 205 781 ACN 620 205 781

Registered Landscape Architect #5868

GREENLOX

ale:	Date:	Job Number:	North:	Revis	sion		FOR DEVELOF	PMENT A	P
25@ A1	00 00 10	101100		Rev	Date	Description		Drawn	
000 @ A3	26.08.19	181108		C	26.08.19	FOR SSD SUBMISSION		SW	Ĺ
				В	03.07.19	FOR SSD SUBMISSION		SW	
ject:	Prnnn	sed Data Centre		A	18.12.18	FOR SSD SUBMISSION		CC	Г
,,000	ιτορο								Γ
		Lane Cove Wes	st NSW 2066						Γ

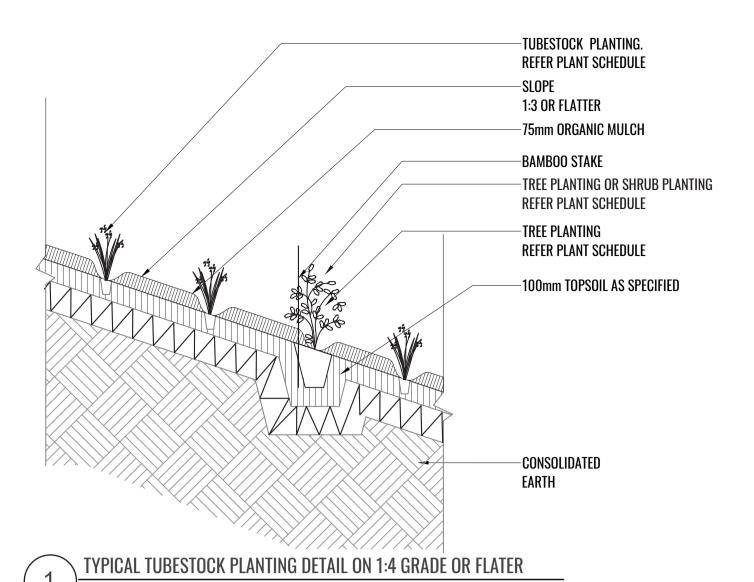


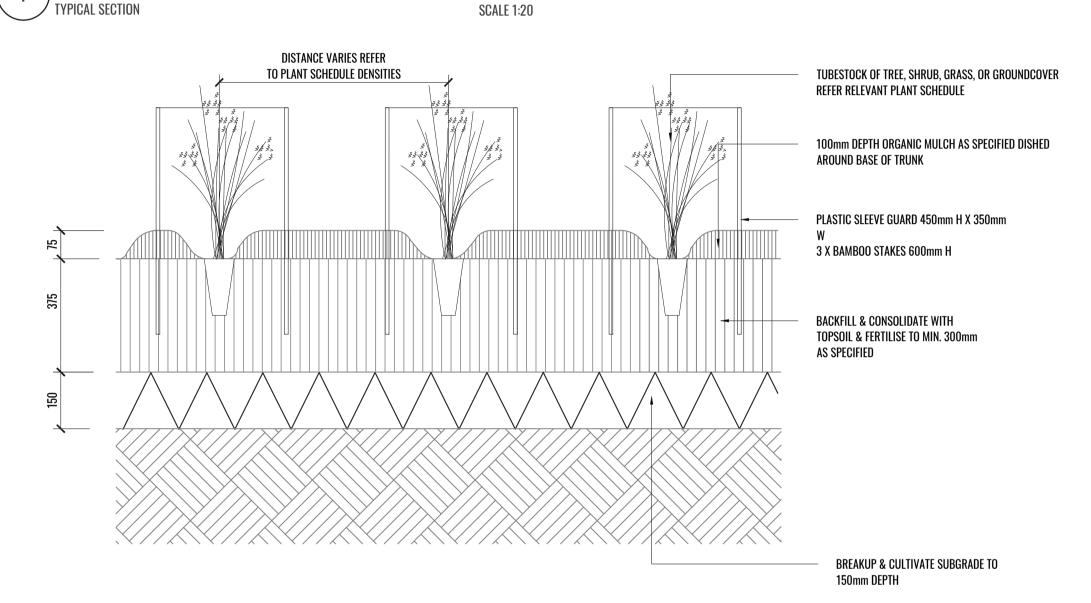

2 TYPICAL TUBESTOCK REVEGETATION PLANTING DETAIL IN NON CONTAMINATED AREAS
TYPICAL SECTION SCALE 1:10

NOTE: ALL REVEGETATION PLANTING MUST BE IN
ACCORDANCE WITH THE VEGETATION MANAGEMENT
SPECIFICATIONS AS PREPARED BY TRAVERS ECOLOGY
REFER TO DOCUMENT REF: 18AWE02V IN REVEG AREAS
STEEPER THAN 1:4 EROSION CONTROL MATTING SHOULD BE
USED WITHOUT MULCH

Client:

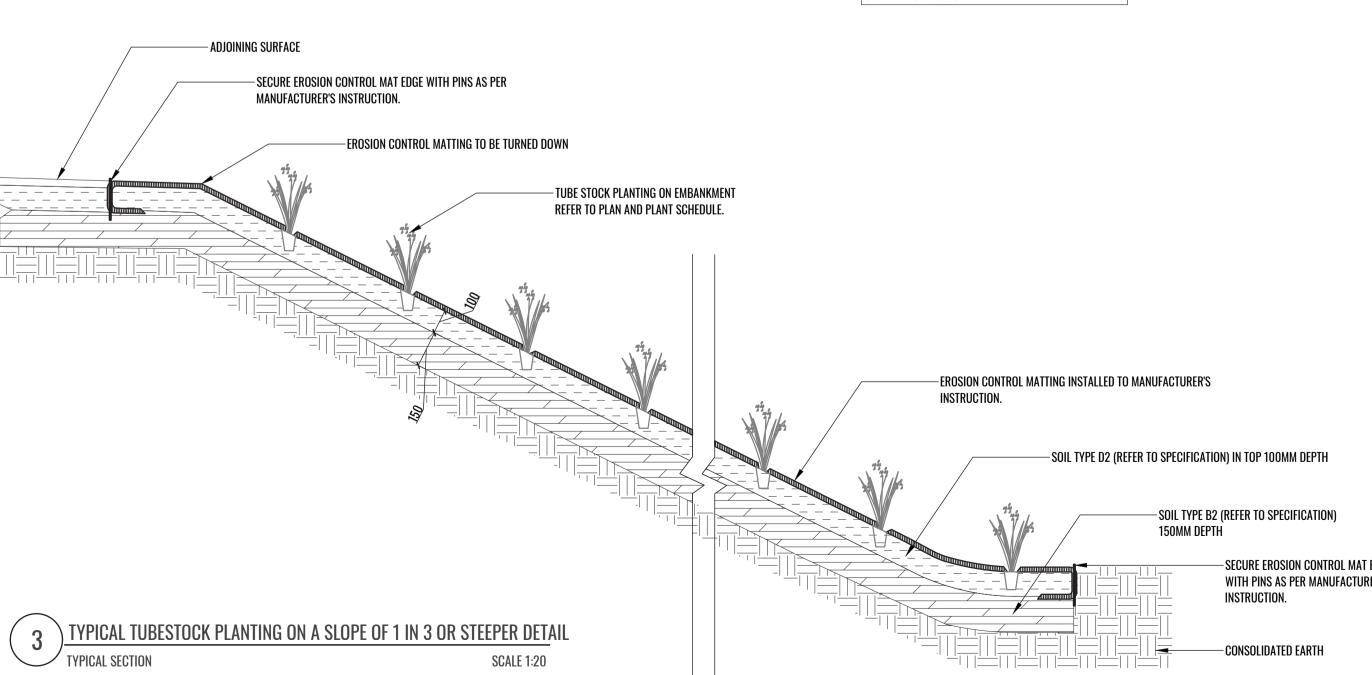

Typical Specifications

General

Maintenance shall mean the care and maintenance of the landscape works by accepted horticultural practice as rectifying any defects that become apparent in the landscape works under normal use. The landscape contractor shall attend the site on a weekly basis to maintain the landscape works for the term of the maintenance period commencing from practical completion

Standards

All grown or purchased plant stock must conform to all the conditions and requirements given in NATSPEC Guide: Specifying Trees. Soils to be in accordance with AS4419, mulching composts and conditioners to be in accordance with AS4454. Soils should conform to best practice specifications as listed in the Landscape Soils Handbook (Simon Leake & Elke Haege 2017).

Rubbish Removal

During the term of the maintenance period the Landscape Contractor shall undertake rubbish removal from the site on a weekly basis to ensure the site remains in tidy condition.

Weed Eradication

Weed growth that may occur in grassed, planted or mulched areas is to be removed using environmentally acceptable methods i.e. non-residual glyphosate herbicide (e.g. 'Roundup', applied in accordance with the manufacturer's directions).

Tree Replacement

Trees shall show signs of healthy vigorous growth and be free from disease and not exhibit signs of stress prior to handover to the client. Any trees or plant that die or fail to thrive, or are damaged or stolen will be replaced. Replacement material shall have the maintenance period extended in accordance with the landscape contract conditions. Trees and plant materials shall be equal to the minimum requirements of species specified and approved material delivered to site. Should the condition decline from the approved sample the Superintendent reserves the right to reject the tree / plants.

Frequency: as required.

Stakes

Adjust and/or replace stakes and ties where required. Remove staking and guying when instructed by the Superintendent

Pruning

Selective pruning may be required during the establishment period to promote a balanced canopy structure. These activities shall be carried out to the best horticultural and industry practice. All pruned material is to be removed from site.

Mulched Surfaces

All planter beds and garden areas shall have a minimum depth of 75mm Forest Fines mulch. All mulch is to be free of deleterious matter such as soil, weeds and sticks.

Mulched surfaces are to be kept clean and tidy and free of any deleterious material and foreign matter. Reinstate depths to a uniform level of 75mm with mulch as specified, mulch to be free of any wood material impregnated with CCA or similar toxic treatment. Top up mulch levels prior to handover to client.

Watering

Implement an appropriate hand watering regime in areas not irrigated in association with current watering programme to maintain plant health and vigour. The program shall reflect seasonal conditions and plant species.

Frequency: Weekly or as required.

.

Pest and Disease Control

The Landscape Contractor shall spray for pests and disease infestations when the pest and fungal attack has been positively identified and when their populations have increased to a point that will become detrimental to plant growth. Apply all pesticides to manufacturer's directions.

Frequency: weekly inspection

Fertilising

Generally check for signs of nutrient deficiencies (yellowing of leaves, failure to thrive), and adapt fertiliser regime to suit. Fertiliser should be applied at the beginning and the end of the (summer) growing season.

Bushfire (Refer to Bushfire Report)

Inner Protection Area (IPA) Fuel loads within the IPA are to be maintained so it does not exceed 4t/ha. Trees are to be maintained to ensure: canopy cover does not exceed 15%; trees (at maturity) do not touch or overhang the building; tree canopies (at maturity) should be well spread out and not form a continuous canopy; lower limbs should be removed up to a height of 2m above ground; preference should be given to smooth barked and evergreen trees. Shrubs are to be maintained to ensure: large discontinuities or gaps in vegetation; shrubs should not be located under trees; shrubs should not form more than 10% of ground cover; clumps of shrubs should be separated from exposed windows and doors by a distance of at least twice the height of vegetation.

Grass is to be maintained to ensure: A height of 10cm or less; leaves and debris is removed.

VEGETATION MANAGEMENT PLAN

Refer to VMP prepared by TRAVERS BUSHFIRE & ECOLOGY

Drawing Title:

Typical Landscape Details & Specifications

DWG No:

LDA-08





Scale:					ion	FOR DEVELOPMENT APPROVAL				
AS SHOWN	00.00.10	101100	N/A	Rev	Date	Description	Drawn	Checked		
	26.08.19	181108		C	26.08.19	FOR SSD SUBMISSION	SW	BG		
				В	03.07.19	FOR SSD SUBMISSION	SW	BG		
Project:	Pronc	sed Data Centre		A	18.12.18	FOR SSD SUBMISSION	CC	BG		
1	11000									
		Lane Cove We	est NSW 2066							

	PROPOSED GENERAL LANDSCAP		MATURE		PLANTING	
0005	DOTANIOAL NAME			0175		OTV4
CODE	BOTANICAL NAME	COMMON NAME	HEIGHT	SIZE	DENSITY	QTY*
	Canopy trees					
ANG COS	Angophora costata	Sydney Red Gum	20m	AS PER VMP	As Shown	6
COR GUM	Corymbia gummifera	Red Bloodwood	30m	AS PER VMP	As Shown	4
EUC RES	Eucalyptus resinifera	Red Mahogany	25m	AS PER VMP	As Shown	3
SYN GLO	Syncarpia glomulifera	Turpentine tree	25m	AS PER VMP	As Shown	3
	Sub-canopy trees					
ACA PAR	Acacia parramattensis	Parramatta Wattle	12m	AS PER VMP	As Shown	10
ALL LIT	Allocasuarina littoralis	Black Sheoak	10m	AS PER VMP	As Shown	9
ELA ret	Elaeocarpus reticulatus	Blueberry Ash	10m	AS PER VMP	As Shown	6
MEL LIN	Melaleuca linariifolia	Snow in Summer	8m	AS PER VMP	As Shown	10
	Shrubs 1 per 30m2					
ACA flo	Acacia floribunda	Sally Wattle	6m	AS PER VMP	As Shown	49
BRE obl	Breynia oblongifolia	Coffee Bush	6m	AS PER VMP	As Shown	34
BUR spi	Bursaria spinosa subsp. spinosa	Blackthorn	6m	AS PER VMP	As Shown	33
DOD tri	Dodonaea triquetra	Common Hop Bush	2m	AS PER VMP	As Shown	36
KUN amb	Kunzea ambigua	Tick Bush	2m	AS PER VMP	As Shown	35
MEL thy	Melaleuca thymifolia	Thyme Honey myrtle	2m	AS PER VMP	As Shown	33
TRE tom	Trema tomentosa	Native peach	2m	AS PER VMP	As Shown	26
	Groundcovers 4 per 1m2					
BLE car	Blechnum cartilagineum	Gristle Fern	0.4m	AS PER VMP	As per VMP	271
CEN asi	Centella asiatica	Asiatic pennywort	0.2m	AS PER VMP	As per VMP	2086
COM cya	Commelina cyanea	Scurvy weed	1m	AS PER VMP	As per VMP	2086
DIP var	Dipodium variegatum	Blotched hyacinth orchid	1m	AS PER VMP	As per VMP	2294
ECH cae	Echinopogon caespitosus	Hedgehog Grass	0.75m	AS PER VMP	As per VMP	2294
ENT mar	Entolasia marginata	Panic Grass	0.3m	AS PER VMP	As per VMP	2149
ENT str	Entolasia stricta	Right angled grass	0.8m	AS PER VMP	As per VMP	2149
IMP cyl	Imperata cylindrica	Cogongrass	0.6m	AS PER VMP	As per VMP	2439
JUN usi	Juncus usitatus	Common Rush	0.6m	AS PER VMP	As per VMP	2439
LOM Ion	Lomandra longifolia	Spiny Head mat rush	0.8m	AS PER VMP	As per VMP	145
MIC sti	Microlaena stipoides	Weeping Grass	0.8m	AS PER VMP	As per VMP	2439
OPL aem	·		0.3m	AS PER VMP	As per VMP	2086
	Oplismenus aemulus	Basket grass				
OPL imb	Oplismenus imbecillis	Basket grass	0.3m	AS PER VMP	As per VMP	2086
THE tri	Themeda triandra	Kangaroo Grass	0.7m	AS PER VMP	As per VMP	241

	SMOOTH-BARKED APPLE - REI	BLOODWOOD OPEN FOREST				
			MATURE		PLANTING	
CODE	BOTANICAL NAME	COMMON NAME	HEIGHT	SIZE	DENSITY	QTY*
	Shrubs 1 per 5m2					
ACA lin	Acacia linifolia	White Wattle	5m	AS PER VMP	As Shown	25
ACA Ion	Acacia longifolia	Sydney golden wattle	8m	AS PER VMP	As Shown	25
BRE obo	Breynia oblongifolia	Coffee Bush	6m	AS PER VMP	As Shown	25
DOD tri	Dodonaea triquetra	Common Hop Bush	2m	AS PER VMP	As Shown	25
GRE bux	Grevillea buxifolia	Grey spider flower	2m	AS PER VMP	As Shown	25
GRE ser	Grevillea sericea	Silky Grevillea	2m	AS PER VMP	As Shown	25
KUN amb	Kunzea ambigua	Tick Bush	3m	AS PER VMP	As Shown	25
LEP tri	Leptospermum trinervium	Paperbark Teatree	2m	AS PER VMP	As Shown	25
LEP pol	Leptospermum polygalifolium	Tantoon	3m	AS PER VMP	As Shown	25
OZO dio	Ozothamnus diosmifolius	Rice flower	2m	AS PER VMP	As Shown	25
PER pin	Persoonia pinifolia	Pine leaved Geebung	3m	AS PER VMP	As Shown	25
PER lin	Persoonia linearis	Narrow leaved Geebung	5m	AS PER VMP	As Shown	25
WOO pun	Woollsia pungens	Snow Wreath	2m	AS PER VMP	As Shown	25
ZIE pil	Zieria pilosa	Hairy Zieria	1.5m	AS PER VMP	As Shown	25
	Groundcovers 4 per 1m2					
ARI vag	Aristida vagans	Threeawn speargrass	0.80m	AS PER VMP	As per VMP	580
AUS pub	Austrostipa pubescens	Speargrass	1.0m	AS PER VMP	As per VMP	580
BLE car	Blechnum cartilagineum	Gristle fern	1.0m	AS PER VMP	As per VMP	580
CEN asi	Centella asiatica	Asiatic pennywort	0.2m	AS PER VMP	As per VMP	543
DIA cae	Dianella caerulea	Blue flax Lily	0.5m	AS PER VMP	As per VMP	580
DIP var	Dipodium variegatum	Blotched hyacinth orchid	1.0m	AS PER VMP	As per VMP	543
ENT str	Entolasia stricta	Right angled grass	0.8m	AS PER VMP	As per VMP	543
IMP cyl	Imperata cylindrica	Cogongrass	0.6m	AS PER VMP	As per VMP	543
LOM Ion	Lomandra longifolia	Spiny head Mat rush	0.8m	AS PER VMP	As per VMP	580
MIC sti	Microlaena stipoides	Weeping Grass	0.8m	AS PER VMP	As per VMP	543
OPL aem	Oplismenus aemulus	Basket grass	0.3m	AS PER VMP	As per VMP	543
OPL imb	Oplismenus imbecillis	Basket grass	0.3m	AS PER VMP	As per VMP	543
THE tri	Themeda triandra	Kangaroo Grass	0.7m	AS PER VMP	As per VMP	580
	i			-1		

					PLANTING	
CODE	BOTANICAL NAME	COMMON NAME	MATURE HEIGHT	SIZE	DENSITY	QTY*
	Shrubs 1 per 3m2					
BRE obl	Breynia oblongifolia	Coffee Bush	6m	AS PER VMP	As Shown	210
BUR spi	Bursaria spinosa subsp. spinosa	Native Blackthorn	3m	AS PER VMP	As Shown	210
DOD tri	Dodonaea triquetra	Common Hop Bush	5m	AS PER VMP	As Shown	210
MEL thy	Melaleuca thymifolia	Thyme Honey myrtle	2m	AS PER VMP	As Shown	210
TRE tom	Trema tomentosa	Native peach	1.5m	AS PER VMP	As Shown	210
	Groundcovers 6 per 1m2	·				
ARI vag	Aristida vagans	Threeawn speargrass	0.80m	AS PER VMP	As per VMP	1227
AUS pub	Austrostipa pubescens	Speargrass	1.0m	AS PER VMP	As per VMP	1227
BLE ind	Blechnum indicum	Swamp water fern	1.0m	AS PER VMP	As per VMP	1227
CEN asi	Centella asiatica	Asiatic pennywort	0.2m	AS PER VMP	As per VMP	1227
COM cya	Commelina cyanea	Scurvy weed	1m	AS PER VMP	As per VMP	1227
DIA cae	Dianella caerulea	Blue flax Lily	0.5m	AS PER VMP	As per VMP	1227
ECH cae	Echinopogon caespitosus	Hedgehog Grass	0.8m	AS PER VMP	As per VMP	1227
ENT mar	Entolasia marginata	Panic Grass	0.6m	AS PER VMP	As per VMP	1227
FIC nod	Ficinia nodosa	Knobby club rush	0.8m	AS PER VMP	As per VMP	1227
GAH cla	Gahnia clarkei	Tall Sawsedge	0.8m	AS PER VMP	As per VMP	1227
IMP cyl	Imperata cylindrica	Cogongrass	0.6m	AS PER VMP	As per VMP	1227
JUN usi	Juncus usitatus	Common Rush	0.6m	AS PER VMP	As per VMP	1227
LOM Ion	Lomandra longifolia	Spiny head Mat rush	0.8m	AS PER VMP	As per VMP	1227
MIC sti	Microlaena stipoides	Weeping Grass	0.8m	AS PER VMP	As per VMP	1227
OPL imb	Oplismenus imbecillis	Basket grass	0.3m	AS PER VMP	As per VMP	1227
THE tri	Themeda triandra	Kangaroo Grass	0.7m	AS PER VMP	As per VMP	1227

Drawing Title:
Planting Schedule

DWG No: LDA





Scale:	Date: Job Number:		North:	Revision			OR DEVELOPMENT A	PPROVAL
N/A	00.0040	404400	N/A	Rev	Date	Description	Drawn	Checked
	26.08.19	181108		C	26.08.19	FOR SSD SUBMISSION	SW	BG
	Proposed Data Centre			В	03.07.19	FOR SSD SUBMISSION	SW	BG
Project:				A	18.12.18	FOR SSD SUBMISSION	CC	BG
		Lane Cove Wes	t NSW 2066					