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ABN: 21 134 476 065 LEVEL 4, 89 YORK STREET SYDNEY NSW 2000, AUSTRALIA H; (02) 8299 4600 FAX: (03) 9685 2455 ABN 68 094 740 986 PH: (02) 8354 5100

PROJECT MANAGER





Health Health


Northern NSW


TWEED VALLEY HOSPITAL


771 Cudgen Road, Cudgen

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NOTE: MAXIMUM ENVELOPE DOES NOT REPRESENT BUILDING FORMS. The Maximum Planning Envelope describes the height, width and breadth limits of the proposed building forms. It is to be construed that the maximum planning envelope extends to interface with the existing natural ground level (and capturing basemen levels and associated substructure) or modified natural ground level. The Maximum Planning Envelope excludes econdary architectural features includion as exemples: excludes secondary architectural features including as examples; glazed canoples, unenclosed covered walkways, building services, hard landscaping, flag poles, lighting poles, fencing and waylinding signage or the like, which will occur beyond the boundary of the Maximum Planning Envelope

REV	DESCRIPTION	DATE
02	ISSUED FOR INFORMATION	22/01/2019
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- DRAWING TITLE

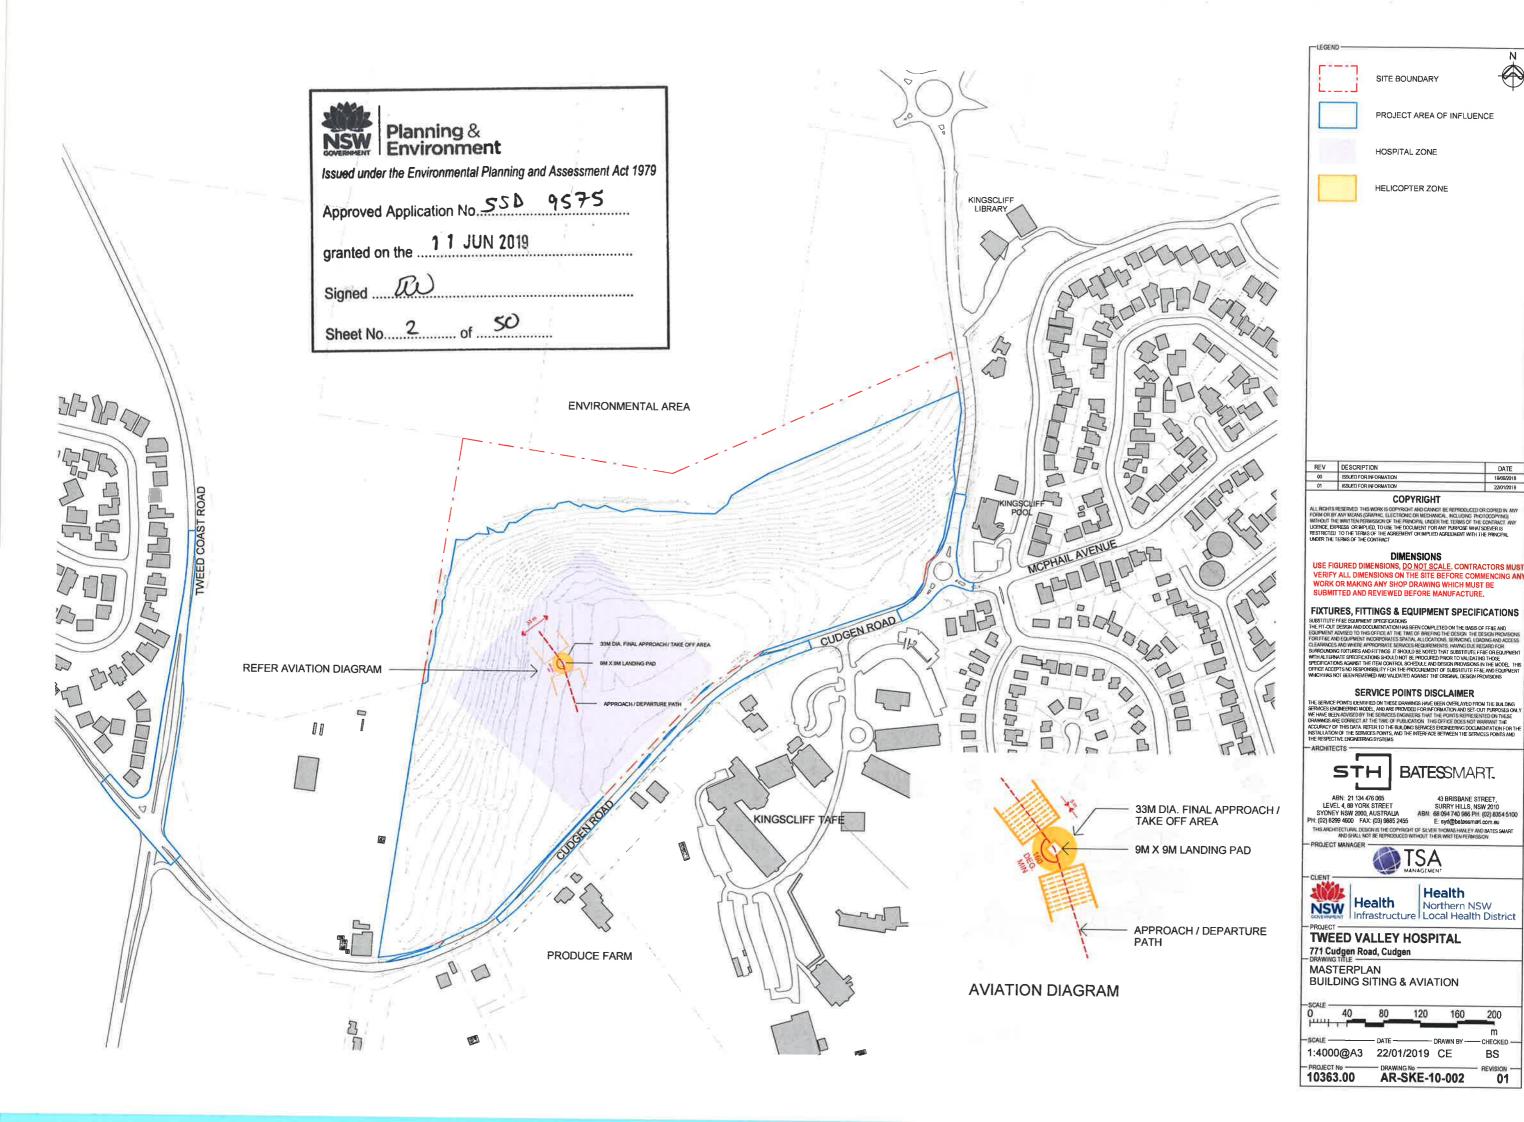
MASTERPLAN BUILDING FOOTPRINT & AREA OF INFLUENCE
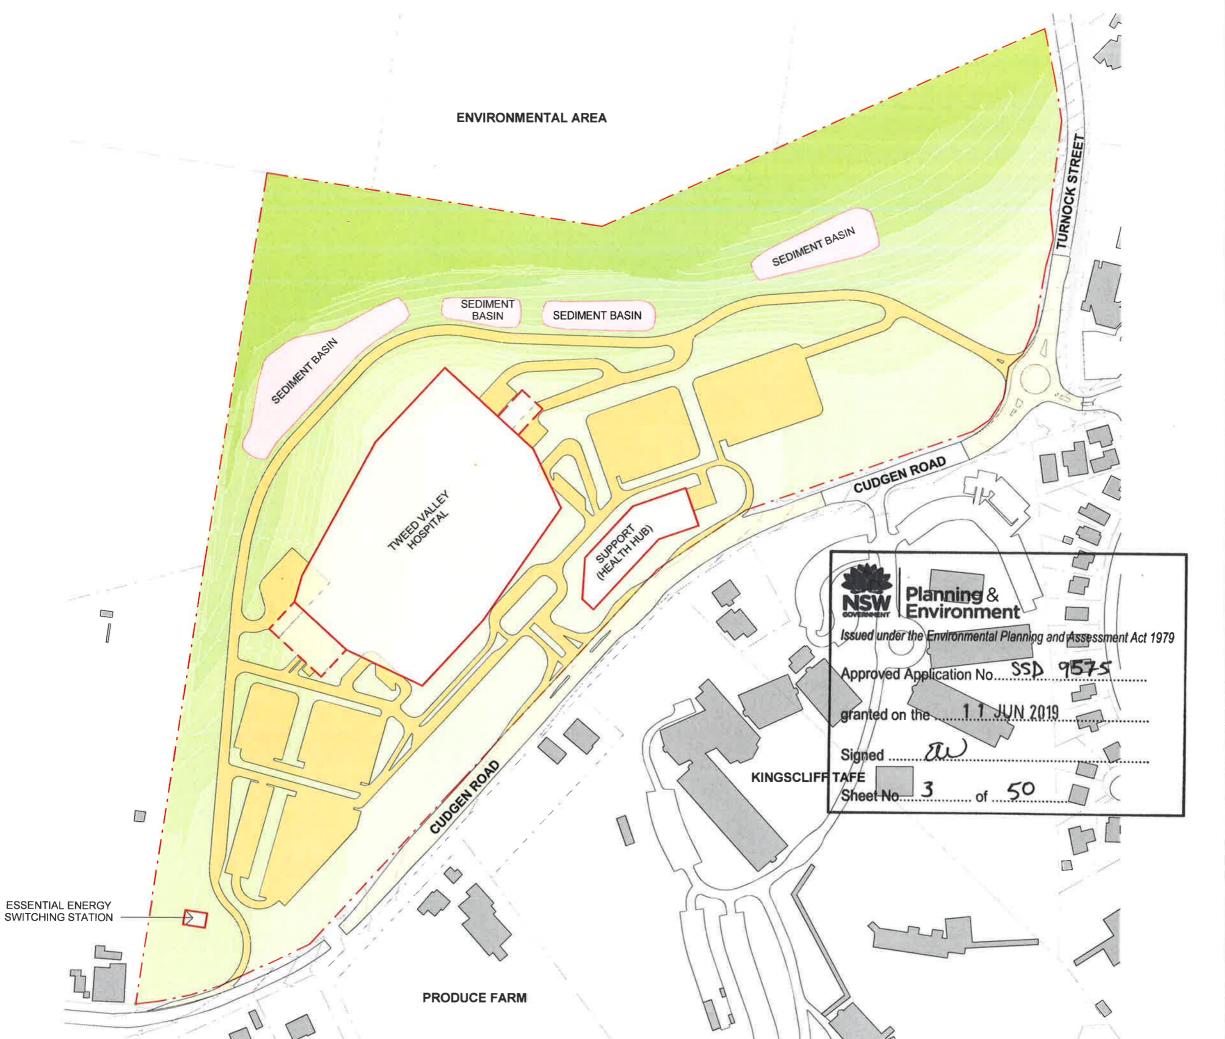
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AR-SKE-10-003

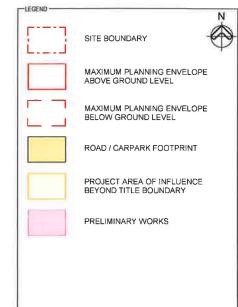



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TWEED VALLEY HOSPITAL

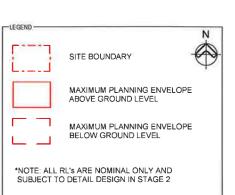
771 Cudgen Road, Cudgen

MASTERPLAN **BOUNDARY SETBACKS**



AR-SKE-10-004



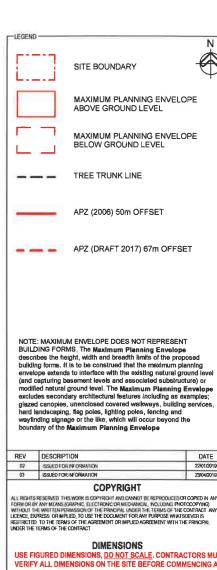

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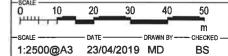
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TWEED VALLEY HOSPITAL

771 Cudgen Road, Cudgen


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ASSET PROTECTION ZONE



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AIN. 60 094 740 986 Pt. (02) 835 45100

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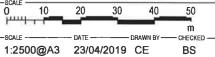


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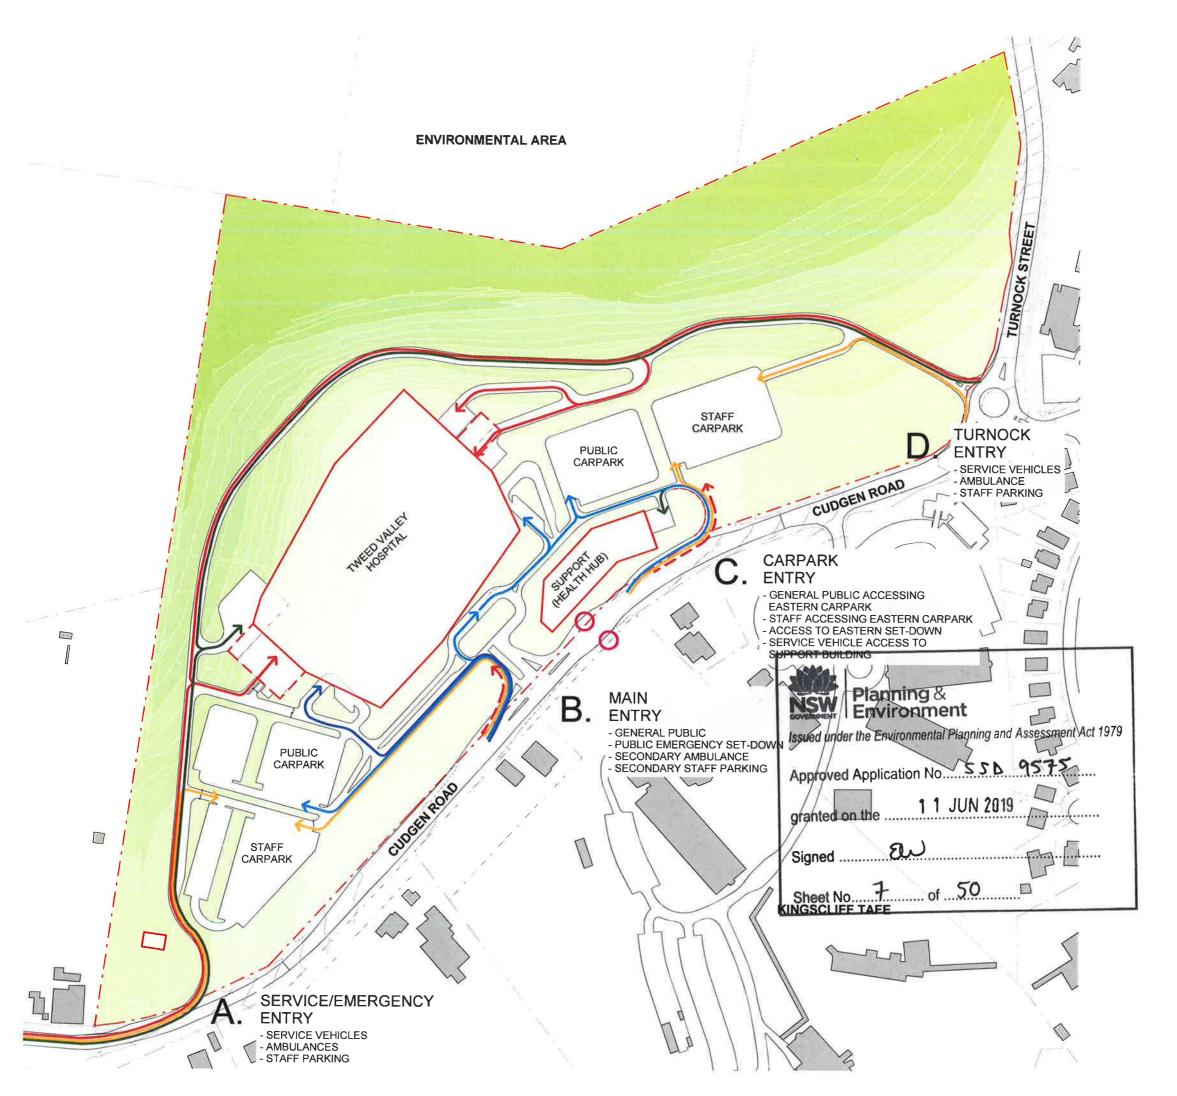
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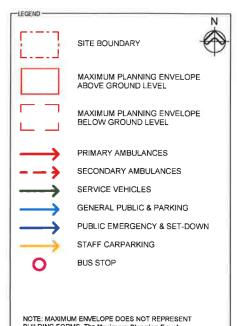
MASTERPLAN CONCEPT PLAN

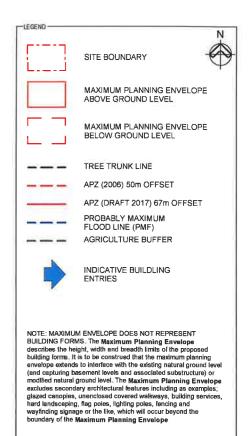

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AR-SKE-10-006





NOTE: MAXIMUM ENVELOPE DOES NOT REPRESENT BUILDING FORMS, The Maximum Planning Envelope describes the height, width and breadth limits of the proposed building forms. It is to be construed that the maximum planning envelope extends to interface with the existing natural ground level (and capturing basement levels and associated substructure) or (and captuning basement levels and associated substructure) or modified natural ground level. The Maximum Planning Envelope excludes secondary architectural features including as examples, glazed canopies, unenclosed covered walkways, building services, hard landscaping, flag poles, lighting poles, fencing and wayfinding signage or the like, which will occur beyond the boundary of the Maximum Planning Envelope

	REV	DESCRIPTION	DATE
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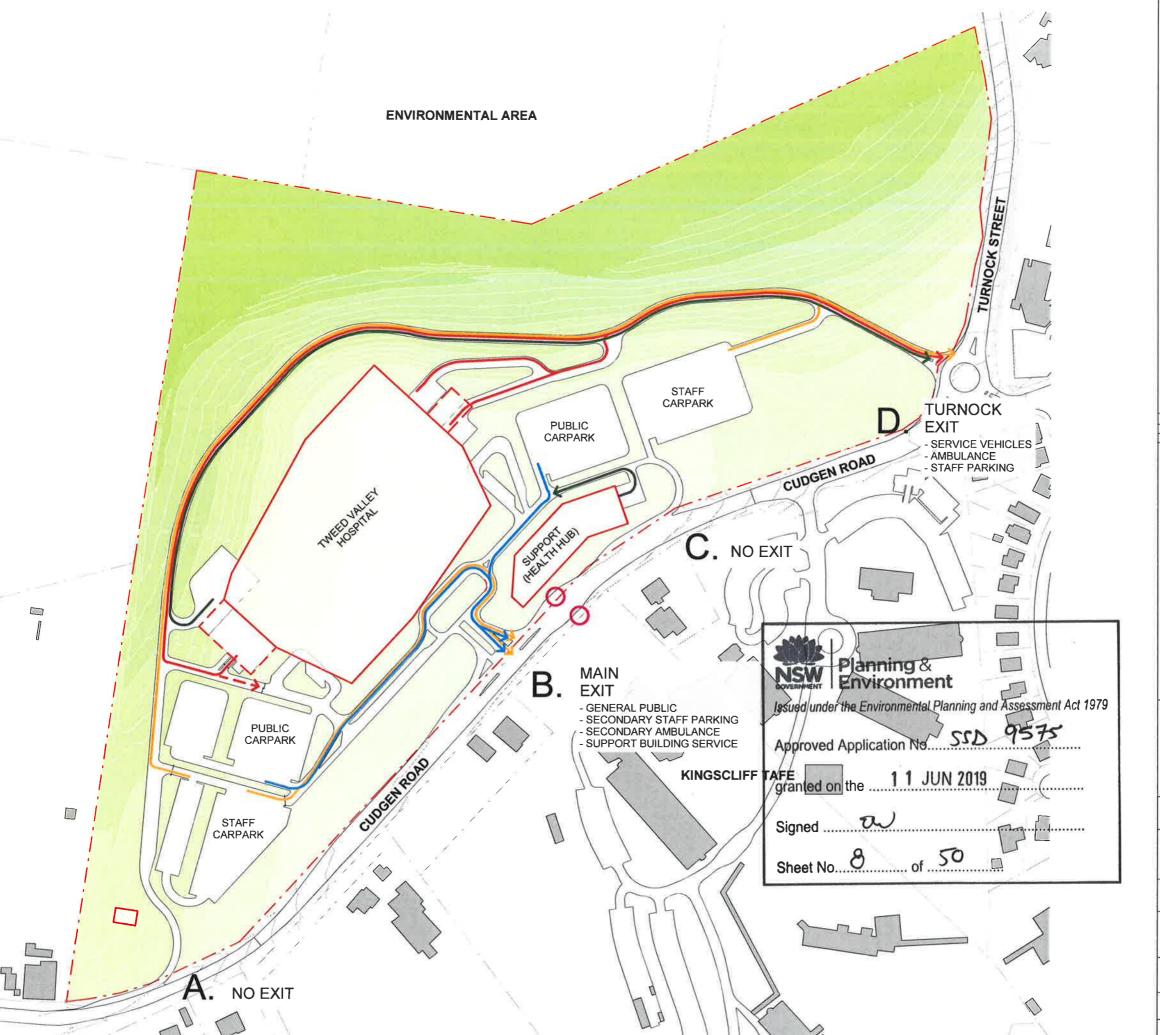
TWEED VALLEY HOSPITAL

771 Cudgen Road, Cudgen
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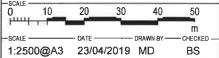




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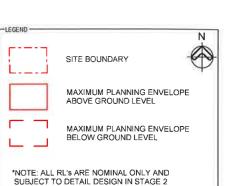
771 Cudgen Road, Cudgen

MASTERPLAN VEHICULAR EGRESS



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- 01	ISSUED FOR INFORMATION	22/01/2019

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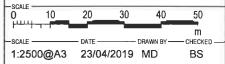
Health
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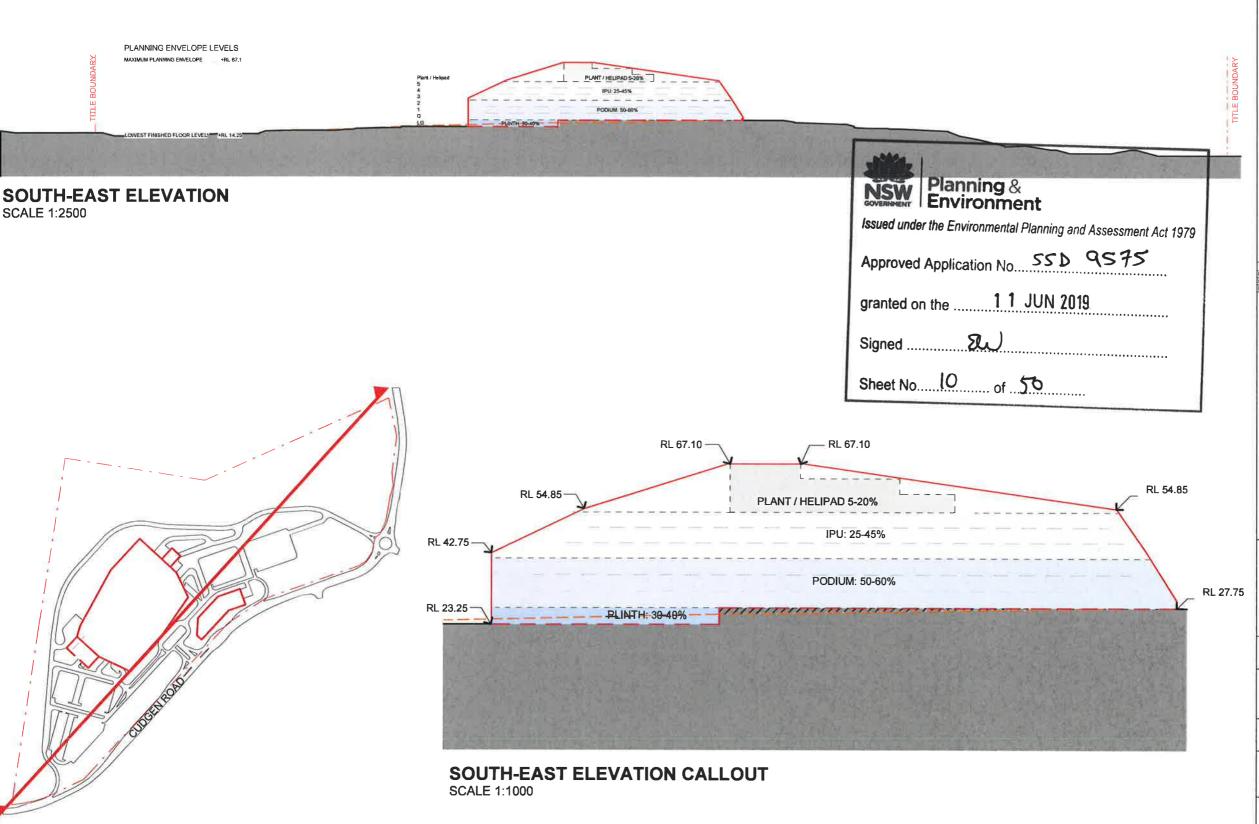
TWEED VALLEY HOSPITAL

771 Cudgen Road, Cudgen

MASTERPLAN PROPOSED SITE LEVELS



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NORTH-WEST ELEVATION CALLOUT SCALE 1:1000

MAXIMUM PLANNING ENVELOPE ABOVE **GROUND LEVEL** MAXIMUM PLANNING **ENVELOPE BELOW** GROUND LEVEL NATURAL GROUND LINE **GROUND LINE** ANTICIPATED DENSITY OF ENVELOPE PLINTH - 30-40% PODIUM - 50-60% IPU - 25-45% PLANT - 5-20% NOTE: MAXIMUM ENVELOPE DOES NOT REPRESENT NOTE: MAXIMUM ENVELOPE DOES NOT REPRESENT BUILDING FORMS. The Maximum Planning Envelope describes the height, width and breadth limits of the proposed building forms. It is to be construed that the maximum planning envelope extends to interface with the existing natural ground level (and capturing basement levels and associated substructure) or modified natural ground level. The Maximum Planning Envelope excludes secondary architectural features including as examples; glazed canopies, unenclosed covered walkways, building services, hard landscaping, flap poles, lighting poles, frencing and wayfinding signage or the like, which will occur beyond the boundary of the Maximum Planning Envelope DIMENSIONS USE FIGURED DIMENSIONS, <u>DO NOT SCALE</u>. CONTRACTORS MUST VERIFY ALL DIMENSIONS ON THE SITE BEFORE COMMENCING ANY WORK OR MAKING ANY SHOP DRAWING WHICH MUST BE SUBMITTED AND REVIEWED BEFORE MANUFACTURE FIXTURES, FITTINGS & EQUIPMENT SPECIFICATIONS INSTITUTE FRAE EQUIPMENT SPECIFICATIONS
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LEVEL 4, 89 YORK STREET SURRY HILLS, NSW 2010
SYDNEY NSW 2000, AUSTRALIA ABN: 68 094 740 986 PH; (02) 8354 5100
H; (02) 8298 4600 FAX: (03) 9885 2455 E: syd@balessmart.com.au
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AND SHALL NOT BE REPRODUCED WITHOUT THER MOST EN PERMISSION LEVEL 4, 89 YORK STREET SYDNEY NSW 2000, AUSTRALIA PH: (02) 8299 4600 FAX: (03) 9885 2455 PROJECT MANAGER TSA Health Northern NSW NSW TWEED VALLEY HOSPITAL

771 Cudgen Road, Cudgen
- DRAWING TITLE
NORTH-WEST ELEVATION

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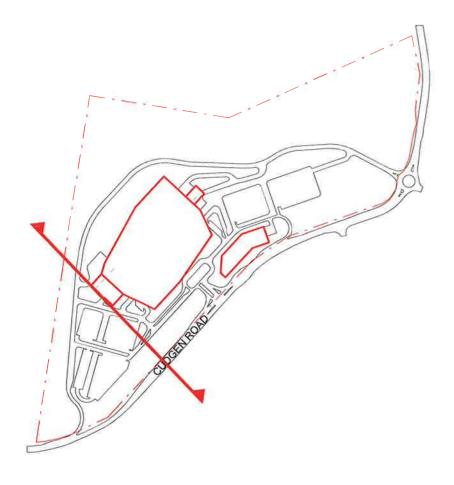
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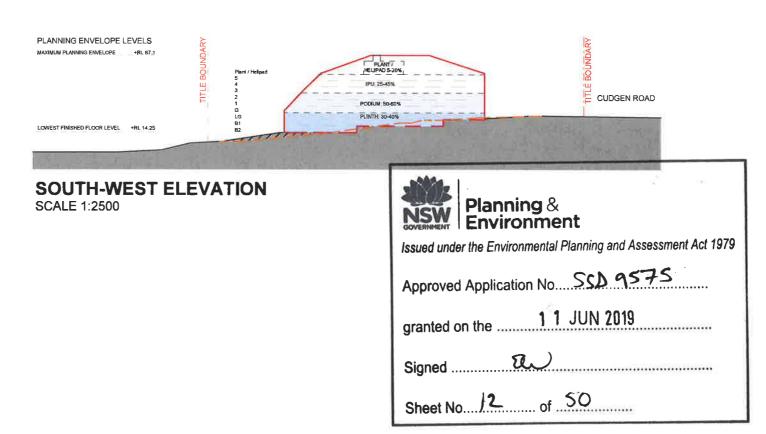
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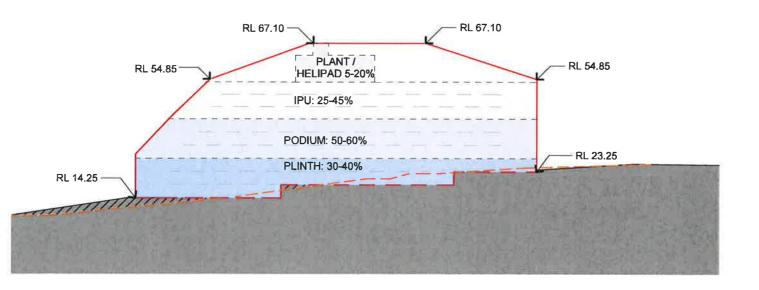
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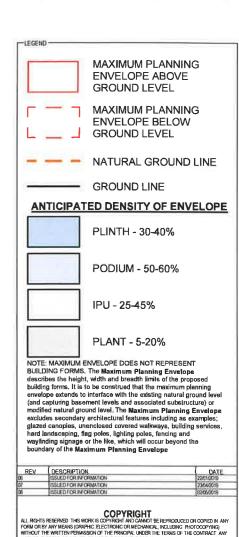
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SOUTH-WEST ELEVATION CALLOUT SCALE 1:1000



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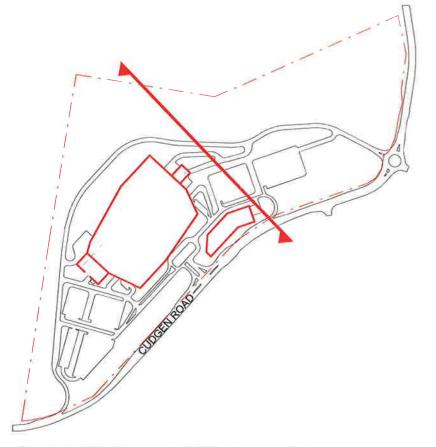
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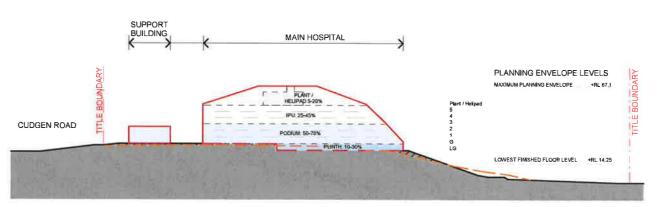
771 Cudgen Road, Cudgen

SOUTH-WEST ELEVATION

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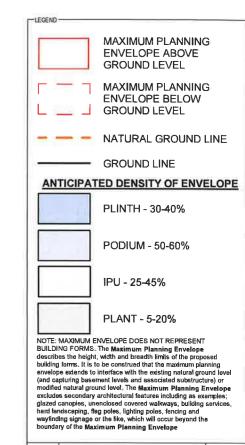
NORTH-EAST ELEVATION SCALE 1:2500

Planning & Environment Issued under the Environmental Planning and Assessment Act 1979 Approved Application No. 551 9575 1 1 JUN 2019 granted on the Signed Sheet No. 13 of 50

/ SUPPORT MAIN HOSPITAL BUILDING / RL 67.10 RL 67.10 PLANT / RL 54.85 -RL 54.85 HELIPAD 5-20% IPU: 25-45% RL 39.40 PODIUM: 50-60% RL 27.75--RL 23.25 PLINTH: 30-40%

NORTH-EAST ELEVATION CALLOUT

SCALE 1:1000



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06	ISSUED FOR INFORMATION	02/05/2019

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ABN: 21 134 476 065

SURRY HILLS NSW 2010 SYNNEY NSW 2000, AUSTRALIA

SYNNEY NSW 2000, AUSTRALIA

AIN: 68 094 749 986 PH; (02) 8354 5100

H: (02) 8299 4800 FAX: (03) 9885 2455

E: syd@belassmart.com au

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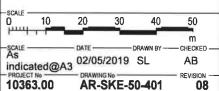







TWEED VALLEY HOSPITAL 771 Cudgen Road, Cudgen


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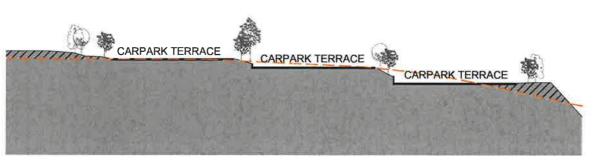


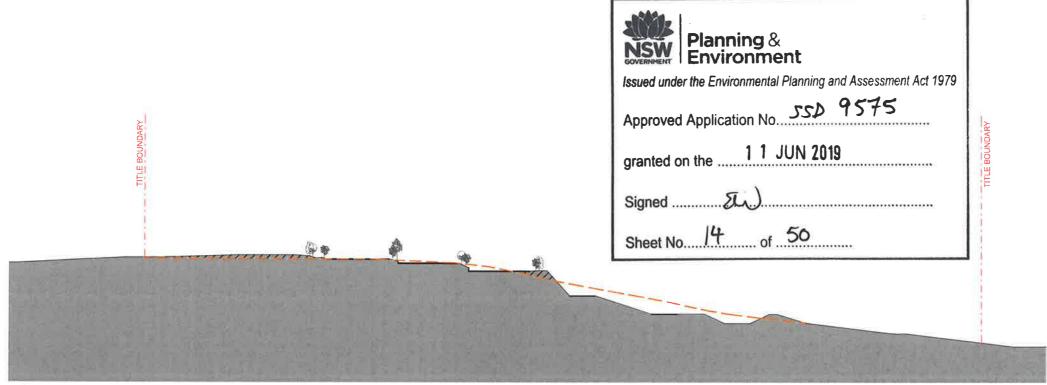

SITE SECTION B (EAST CARPARK)

SCALE 1:1000




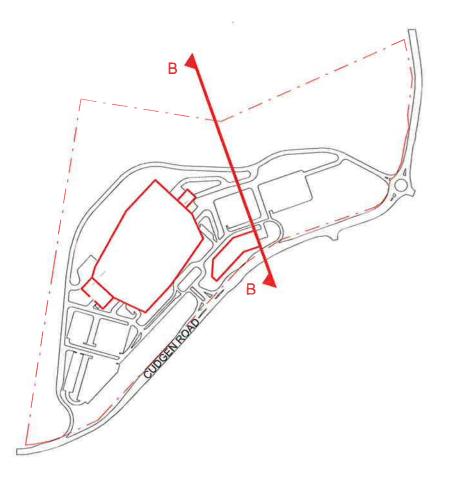

SITE SECTION B CALLOUT **SCALE 1:500**




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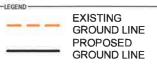


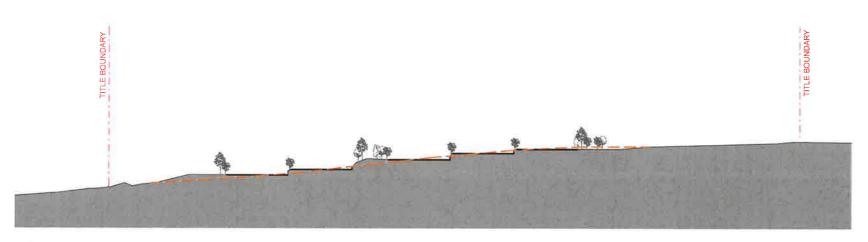SITE SECTION C (WEST CARPARK)

SCALE 1:1000

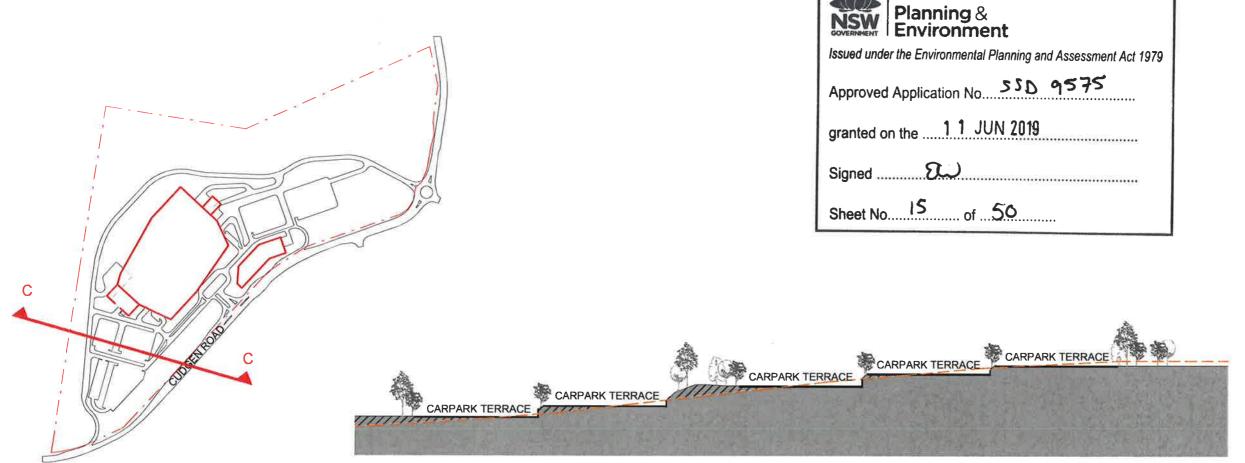

SITE SECTION C CALLOUT **SCALE 1:500**



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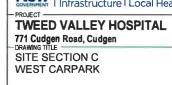
FIXTURES, FITTINGS & EQUIPMENT SPECIFICATIONS

SERVICE POINTS DISCLAIMER














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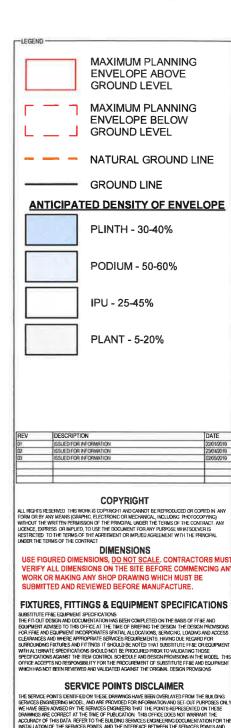


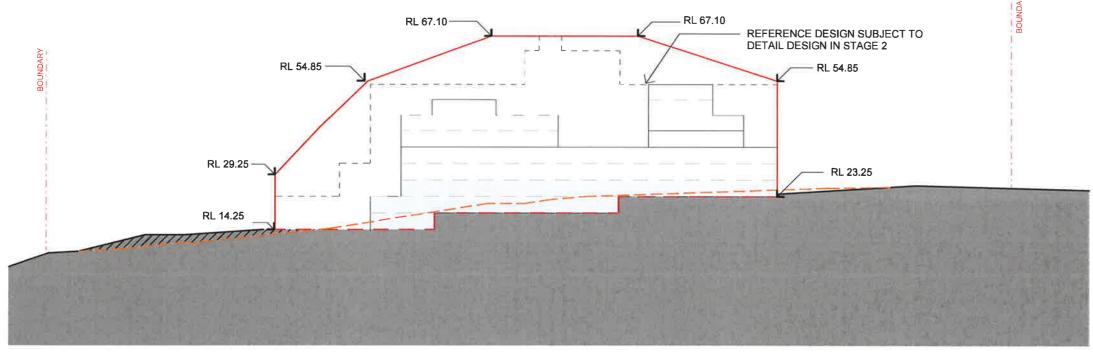BUILDING SECTION A

SCALE 1:1000



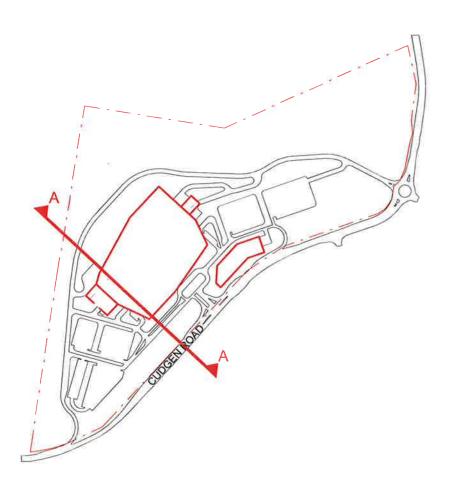

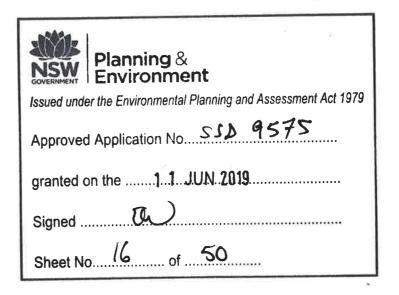





Northern NSW

TWEED VALLEY HOSPITAL

771 Cudgen Road, Cudgen

DRAWING TITLE

BUILDING SECTION A

AB EVISION -

indicated@A3 02/05/2019 SL 10363.00 AR-SKE-51-003

TWEED VALLEY HOSPITAL DEVELOPMENT **CUDGEN AND TWEED COAST ROAD INTERSECTION WORKS**

Planning & Environment Issued under the Environmental Planning and Assessment Act 1979 Approved Application No

granted on the ____1 1 JUN 2019

DESCRIPTION

DRAWING REGISTER AND CONSTRUCTION NOTES

CONCEPT INTERSECTION WORKS PLAN SHEET 1 OF 2

CONCEPT INTERSECTION WORKS PLAN SHEET 2 OF 2

GENERAL ARRANGEMENT AND KEY PLAN

DRAWING No.

20 10748 C300

20 10748 (330

20 10748 C331

20 10748 C332

GENERAL NOTES

- G1 THESE DRAWINGS SHALL BE READ IN CONJUNCTION WITH ARCHITECTURAL AND OTHER CONSULTANTS DRAWINGS AND SPECIFICATIONS AND WITH SUCH OTHER WRITTEN INSTRUCTIONS OR SKETCHES AS MAY BE ISSUED DURING THE COURSE OF THE CONTRACT, ANY DISCREPANCY SHALL BE REFERRED TO
- MATERIALS AND WORKMANSHIP SHALL BE IN ACCORDANCE WITH THE SPECIFICATION, CURRENT SAA CODES, BUILDING REGULATIONS AND THE REQUIREMENTS OF ANY OTHER RELEVANT STATUTORY
- THESE DRAWINGS MUST NOT BE SCALED, ALL DIMENSIONS ARE IN METERS, ALL SET OUT DIMENSIONS AND LEVELS, INCLUDING THOSE SHOWN ON THESE DRAWINGS SHALL BE IN ACCORDANCE WITH THE ARCHITECT'S DRAWINGS AND VERIFIED ON SITE,
- ALL SETOUT AND DIMENSIONS OF THE STRUCTURE INCLUDING KERBS AND RETAINING WALLS, AND BULK EARTHWORKS MUST BE TAKEN FROM THE ARCHITECT'S DRAWINGS, SETOUT OF THE STORMWATER PITS BY OTHERS, CONTRACTOR TO CONFIRM SETOUT OF SERVICE TRENCHING INCLUDING SUBSOIL ON SITE.
- G5 THE CONTRACTOR SHALL COMPLY WITH ALL REGULATIONS OF AUTHORITIES HAVING JURISDICTON OVER THE WORKS, REFER TO GEOTECHNICAL REPORT BY MORRISON GEOTECHNIC PTY LTD, REFERENCE: GE18/144, DATED AUGUST 2018
- G6 ALL DIMENSIONS AND REDUCED LEVELS MUST BE VERIFIED ON SITE BEFORE THE COMMENCEMENT OF
- G7 THE APPROVAL OF A SUBSTITUTION SHALL BE SOUGHT FROM THE SUPERINTENDENT BUT IS NOT AN AUTHORISATION OF A COST VARIATION. THE SUPERINTENDENT MUST APPROVE ANY COST VARIATION INVOLVED BEFORE ANY WORK STARTS.
- GB ALL LEVELS SHOWN ARE TO THE AUSTRALIAN HEIGHT DATUM:
- SERVICE INFORMATION SHOWN IS APPROXIMATE ONLY, PRIOR TO COMMENCEMENT OF ANY WORKS, THE CONTRACTOR SHALL LOCATE ALL UNDERGROUND SERVICES AND COMPLY WITH ALL REQUIREMENTS OF THOSE AUTHORITIES.
- G10 EXISTING SURFACE CONTOURS, WHERE SHOWN, ARE INTERPOLATED AND MAY NOT BE ACCURATE
- G11 UNLESS NOTED OTHERWISE, ALL VEGETATION SHALL BE STRIPPED TO A MINIMUM DEPTH OF 150mm UNDER ALL PROPOSED PAVEMENT AND BUILDING AREAS,
- G12 MAKE SMOOTH CONNECTION WITH ALL EXISTING WORKS.

SITEWORKS NOTES

- PRIOR TO THE PLACEMENT OF ANY PAVEMENTS, BUILDINGS OR DRAINS THE EXPOSED SUBGRADE SHALL BE COMPACTED TO A MINIMUM OF 98% STANDARD COMPACTION IN ACCORDANCE WITH TEST "E11 OF 0.5 1299 FOR THE TOP 300mm, ANY SOFT SPOTS SHALL BE REMOVED AND REPLACED WITH GRANULAR FILL TO THE ENGINEERS APPROVAL AND COMPACTED IN ACCORDANCE WITH THE COMPACTION REQUIREMENTS SET OUT BELOW, ON HIGHLY REACTIVE CLAY AREAS SITE EXCAVATED MATERIAL MAY BE USED WITH THE PRIOR AUTHORISATION OF THE ENGINEER...
- ALL FILL AND PAVEMENT MATERIALS SHALL BE COMPACTED IN ACCORDANCE WITH GEOTECHNICAL REPORT BY MORRISON GEOTECHNIC PTY LTD REFERENCE: GE18/14. DATED AUGUST 2018 MOISTURE CONTENT TO BE MAINTAINED AT -/- 2% OMC. MINIMUM COMPACTION REQUIREMENTS ARE DETAILED BELOW FOR (ALL REQUIREMENTS ARE TO VERIFIED BY A SUITABLY QUALIFIED GEOTECHNICAL ENGINEER):

FILL UNDER ANY FOOTINGS AND FLOOR SLABS FOR ANY STRUCTURE TO SUBGRADE LEVEL;

SELECTED FILL WITHOUT CONSPICUOUS CLAY CONTENT BIJJI DING BASECOURSE 98% MOD FILL UNDER ROAD PAVEMENTS. - TO WITHIN 500mm OF FINISHED SUBGRADE LEVEL - UP TO FINISHED SUBGRADE LEVEL . ROAD PAVEMENT MATERIALS;

THE MAXIMUM COMPACTION IS TO BE NO GREAT THAN 4% ON TOP OF THE ABOVE MENTION VALUES.

- GRADE EVENLY BETWEEN FINISHED SURFACE SPOT LEVELS: FINISHED SURFACE CONTOURS ARE SHOWN FOR CLARITY. WHERE FINISHED SURFACE LEVELS ARE NOT SHOWN, THE SURFACE SHALL BE GRADED SMOOTHLY SO THAT IT WILL DRAIN AND MATCH ADJACENT SURFACES OR STRUCTURES.
- ALL DIMENSIONS GIVEN ARE TO FACE OF KERB, CENTER OF PIPE OR EXTERIOR FACE OF BUILDING UNLESS NOTED OTHERWISE.
- ANY STRUCTURES, PAVEMENTS OR SURFACES DAMAGED, DIRTIED OR MADE UNSERVICABLE DUE TO CONSTRUCTION WORK SHALL BE REINSTATED TO THE SATISFACTION OF THE ENGINEER
- ANY FILL REQUIRED SHALL BE APPROVED BY THE ENGINEER / GEOTECHNICAL CONSULTANT
- CONTRACTOR IS TO ENSURE THAT ALL EXCAVATIONS ARE MAINTAINED IN A DRY CONDITION WITH NO
- SB ALL FINISHES AND COLOURS TO BE IN ACCORDANCE WITH ARCHITECTURAL SPECIFICATIONS
- S9 REFER TO STRUCTURAL DRAWINGS FOR CONCRETE, REINFORCEMENT AND RETAINING WALL DETAILS. S10 GENERALLY FOR TRENCHING WORKS THE CONTRACTOR MUST:
- A) COMPLY WITH THE GENERAL PROVISIONS OF PART 3.1 "MANAGING RISKS TO HEALTH AND SAFETY" OF NSW WORK AND HEALTH AND SAFETY REGULATION 2011
- B) COMPLY PART 63 DIVISION 3 "EXCAVATION WORK" OF NSW WORK HEALTH AND
- S11 PRIOR TO THE EXCAVATION OF ANY TRENCH DEEPER THAN 15 METRES THE CONTRACTOR MUST
 A) NOTIFY THE OCCUPATIONAL HEALTH AND SAFETY AUTHORITY ON THE APPROPRIATE FORM

STORMWATER DRAINAGE NOTES

- UNLESS NOTED OTHERWISE BY HYDRAULIC ENGINEERS DRAWINGS, ALL DOWNPIPES & GRATED INLETS SHALL BE CONNECTED TO PITS OR MAIN STORMWATER DRAINS WITH 150 DIA, UPVC PIPES LAID AT A MINIMUM GRADE OF 11H 100, FOR SYPHONIC ROOF DRAINAGE SYSTEMS ALL DOWNPIPES CONNECTION DRAIN SIZES TO BE CONNECTED INTO MAIN STORMWATER DRAINS SHALL BE IN ACCORDANCE WITH HYDRAULIC ENGINEERS DRAWINGS,
- ALL MAIN STORMWATER DRAINS SHALL BE CONSTRUCTED USING MATERIALS AS SPECIFIED ON THE DRAWINGS IN ACCORDANCE WITH THE APPROPRIATE A.S., IF NOT SPECIFIED THEN CLASS 2 RRJ RCP SHALL BE USED FOR DIAMETERS > 225mm, SEWER CLASS SEH UPVC IN ACCORDANCE WITH AS1260 SHALL BE USED FOR \$225mm DR SMALLER.
- SW3 ALL PIPEWORK TO BE INSTALLED IN ACCORDANCE WITH AS3725 FOR RCP AND AS2032 FOR PVC ALL BEDDING TO BE TYPE H2 UNLESS NOTED OTHERWISE
- SWA FOR ALL PITS > 12m DEEP STEP IRONS SHALL BE INSTALLED.
- PRECAST PITS MAY BE USED EXTERNAL TO THE BUILDING SUBJECT TO APPROVAL BY BONACCI
- WHERE SUBSOIL DRAINS PASS UNDER FLOOR SLABS AND VEHICULAR PAVEMENTS, UNSLOTTED UPVC SEWER GRADE PIPE IS TO BE USED
- SWB GRATES AND COVERS SHALL CONFORM WITH AS 3996 AND AS 1428 1 FOR ACCESS REQUIREMENTS
- CARE IS TO BE TAKEN WITH LEVELS OF STORMWATER LINES, GRADES ARE NOT TO BE REDUCED
- SW10 AT ALL TIMES DURING CONSTRUCTION OF STORMWATER PITS, ADEQUATE SAFETY PROCEDURES SHALL BE TAKEN TO ENSURE AGAINST THE POSSIBILITY OF PERSONNEL FALLING DOWN PITS:
- ALL EXISTING STORMWATER DRAINAGE LINES AND PITS THAT ARE TO REMAIN ARE TO BE INSPECTED AND CLEANED, DURING THIS PROCESS ANY PART OF THE STORMWATER DRAINAGE SYSTEM THAT WARRANTS REPAIR SHALL BE REPORTED TO THE SUPERINTENDENT/ENGINEER FOR

KERBING NOTES


- K1 ALL CONCRETE TO HAVE A MINIMUM COMPRESSIVE STRENGTH OF 32 MPa U.N.O.
- K3 EXPANSION JOINTS (EJ) TO BE FORMED FROM 10mm COMPRESSIBLE CORK FILLER BOARD FOR THE FULL DEPTH OF THE SECTION AND CUT TO PROFILE EXPANSION JOINTS TO BE LOCATED AT DRAINAGE PITS, ON TANKENT POINTS OF CURVES AND ELSEWHERE AT HAX 12m CENTRES EXCEPT FOR INTEGRAL KERBS WHERE THE EXPANSION JOINTS ARE TO MATCH THE JOINT LOCATIONS IN THE SLAB.
- WEAKENED PLANE JOINTS TO BE MIN 3mm WIDE AND LOCATED AT 3m CENTRES EXCEPT FOR INTEGRAL KERBS WHERE THE WEAKENED PLANE JOINTS ARE TO MATCH THE JOINT LOCATIONS IN THE SLAB
- BROOMED FINISH TO ALL RAMPED AND VEHICULAR CROSSINGS ALL OTHER KERRING OR DISH DRAINS
- THE THE REPLACEMENT OF REPOSE

 EXISTING ROAD PAYEMENT IS TO BE SAWCUT 900mm U.N.O. FROM THE LIP OF GUTTER, UPON COMPLETION OF THE NEW KERB AND GUTTER, NEW BASECOURSE AND SURFACE TO BE LAID
- 600mm WIDE U.N.D. EXISTING KERBS ARE TO BE COMPLETELY REMOVED WHERE NEW KERBS ARE SHOWN.

JOINTING NOTES


PEDESTRIAN FOOTPATH JOINTS

- EXPANSION JOINTS (EJ) ARE TO BE LOCATED WHERE POSSIBLE AT TANGENT POINTS OF CURVES
- SAWCUT JOINTS (SC) ARE TO BE LOCATED AT A MAX 15m x WIDTH OF PAVEMENT. THE TIMING OF THE SAWCUT IS TO BE CONFIRMED BY THE CONTRACTOR ON SITE. SITE CONDITIONS WILL DETERMINE HOW MANY HOURS AFTER THE CONCRETE POUR BEFORE THE SAW CUTS ARE COMMENCED.
- WHERE POSSIBLE JOINTS SHOULD BE LOCATED TO MATCH KERBING AND / OR ADJACENT PAVEMENT
- PROVIDE 10mm WIDE FULL DEPTH EXPANSION JOINTS (E.J.) BETWEEN BUILDINGS AND ALL CONCRETE
- ALL PEDESTRIAN FOOTPATH JOINTINGS AS FOLLOWS (U.N.O.).

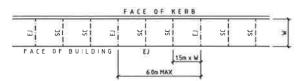

VEHICULAR PAVEMENT JOINTS

- ALL VEHICULAR PAVEMENTS TO BE JOINTED AS SHOWN ON DRAWINGS
- LONGITUDINAL WARPING JOINTS (LWJ) SHOULD GENERALLY BE LOCATED AT A MAXIMUM OF 3m TO 4.5m MAX CENTERS. ALL LW3's SHOULD BE TIED UP TO A MAXIMUM TOTAL WIDTH OF 30m
- TRANSVERSE CONTRACTION JOINTS (TCI) SHOULD GENERALLY BE LOCATED AT A MAXIMUM OF 8m TO 12m MAX CENTERS TCJ's CAN BE SPACED AT SUITABLE INTERVALS UP TO A RECOMMENDED MAXIMUM LENGTH OF 15m
- TRANSVERSE DOWELLED CONSTRUCTION JOINTS (DCJ) TO BE PROVIDED FOR PLANNED THANSVERSE LIMETELE DURN SHOULD JOINTS IDEA! TO BE PROVIDED FOR PLANNED INTERRUPTIONS SUCH AS AT THE END OF EACH DAY'S OPERATIONS (POUR BREAK), AT BLOCK OUTS FOR BRIDGES AND INTERSECTIONS OR FOR UNEXPECTED DELAYS WHEN THE SUSPENSION OF OPERATIONS IS LIKELY TO CREATE A JOINT,
- ISOLATION JOINTS WITH SUB-GRADE BEAM (IJ) TO BE PROVIDED AT INTERSECTIONS OR AT THE
- ALL VEHICULAR PAVEMENTS TO BE JOINTED IN ACCORDANCE WITH AUSTROADS AGPT02-12 GUIDE TO PAVEMENT TECHNOLOGY PART 2 STRUCTURAL PAVEMENT DESIGN AND SUPPLEMENT AP-T36-06 PAVEMENT DESIGN FOR LIGHT TRAFFIC
- VEHICULAR PAVEMENT JOINTING AS FOLLOWS (U.N.O.)

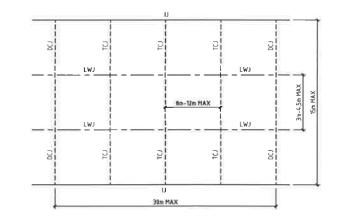


DRAWING REGISTER AND CONSTRUCTION NOTES

TWEED VALLEY HOSPITAL


DEVELOPMENT, KINGSCLIFF.

PRFI IMINARY NTS Drawing No Rev Date 3 10 2018 20 10748 01 C300

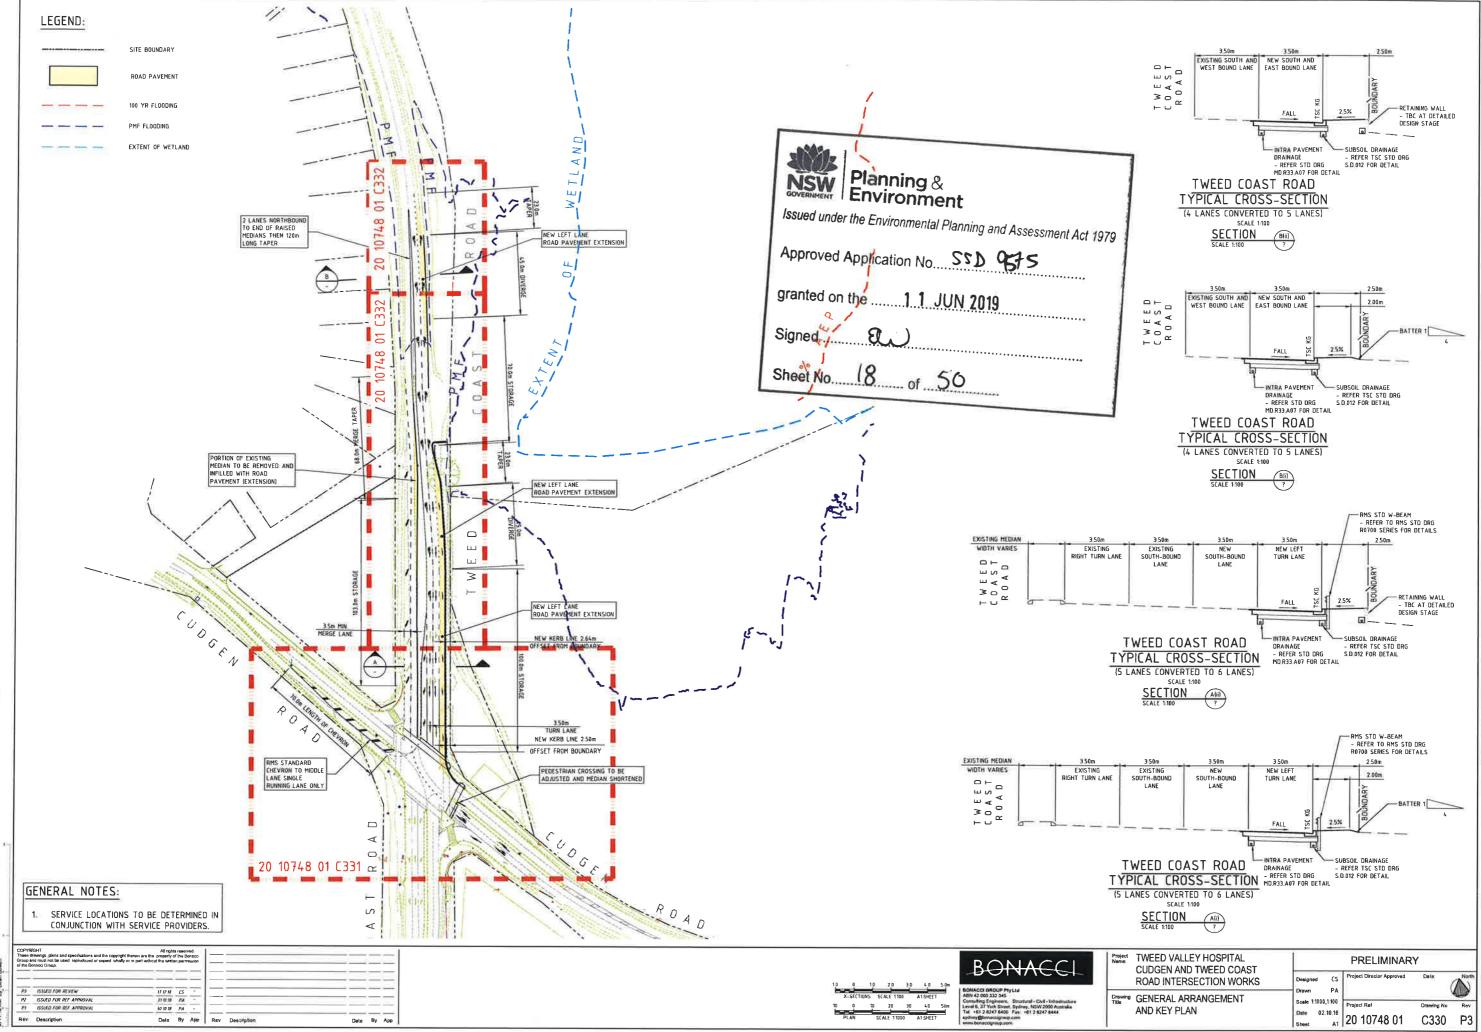


101 CAD'01 Autocad'300 Series - Tweed Coast Road intersection/10748C-C330 dwg Pio

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LANDSCAPE PROPOSAL

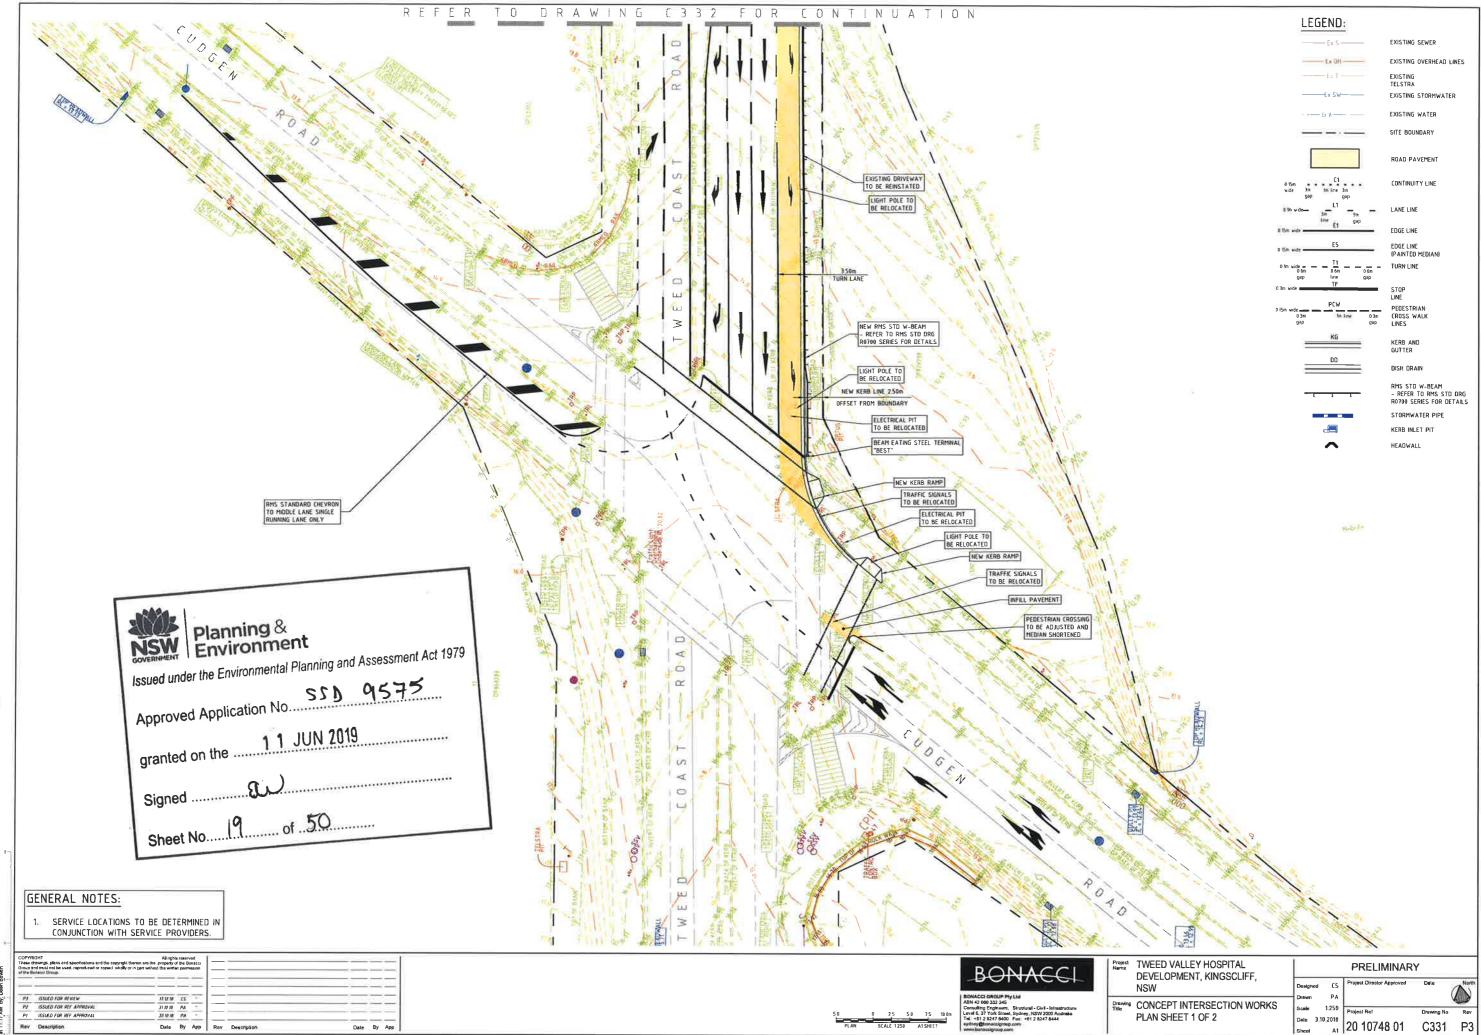LANDSCAPE ZONAL PLAN

LEGEND

APZ - Asset Protection Zone

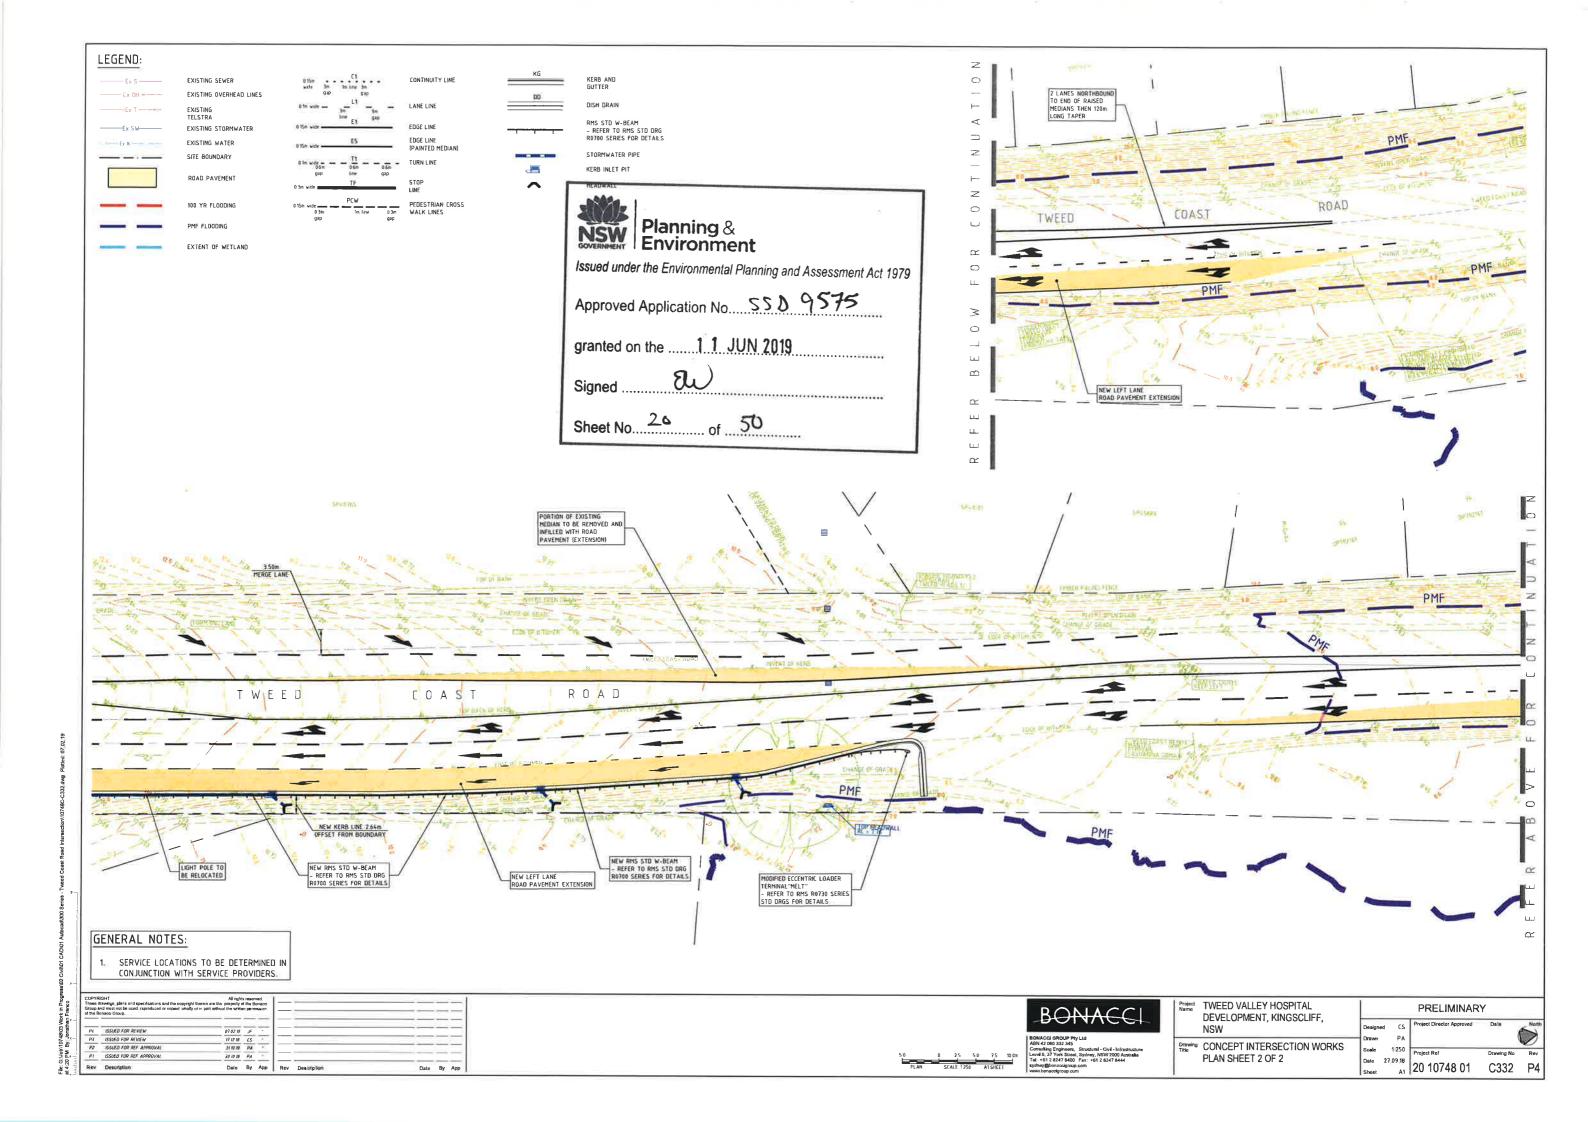PMF - Probable Maximum Flood

Retained undisturbed forest

2. Low Maintenance Native Landscape*. Includes sediment basins and buffer planting.

3. Hospital landscape + Green Spine. Character complementary to context. (Gardens, breakout spaces, open lawns, plazas and kitchen gardens)

4. Farm Landscape. Orchards, food crops and existing fruit tree orchard.

5. WSUD car park and roadway planting (trees and planting in rain gardens)

6. 10m wide vegetated buffer. Retain and augment existing boundary vegetation (selective removal to achieve required access and sight lines). Staged replacement of pine trees and understorey with native species.

7. 30m wide vegetated buffer. Retain and augment existing boundary vegetation (selective removal to achieve required access and sight lines). Staged replacement of pine trees and understorey with native species.

8. Landscaped courtyards within hospital envelope

9. Communal Food Garden. To be included as part of the hospital development, size and location to be determined.

*Note: All zones vegetated in accordance with Asset Protection Zone (APZ) guidelines where required refer to 'Bushfire Constraints Assessment'



Sediment basins RATHENT OF COASTAL WETLAND APZ (2006)-50m Existing High Value Tree Retained KINGSCLIFF TAFE Moderate Value Tree Retained (if possible) PRODUCE FARM

EIS APPENDIX - LANDSCAPE DRAWINGS

Prepared for: NSW Health Infrastructure

DWG L-EIS-2 | Rev E - 03.05.2019 Prepared by: Turf Design Studio





LANDSCAPE PROPOSAL

PATHWAY NETWORK

LEGEND

- Existing On-road Shared Path
- Existing Off-road Shared Path
- Proposed Off-road Shared Path
- Existing Crossing
- Proposed Crossing
- Cycle Route
- Main Pedestrian Route Drop-off + Bus Stop to Entry
- Secondary Pedestrian Route Car Parking to Entry
- N Pedestrian Route Street to Entry
- Connector Pedestrian Route Connections between paths to form loops
- 🚳 Pedestrian Through Route
- Informal Pedestrian Trail
- Access from Car Parking
- Civic Spaces
- Gathering & Social Spaces
- Cycle End of Trip Bike Storage
- Bus Stop



EIS APPENDIX - LANDSCAPE DRAWINGS TWEED VALLEY HOSPITAL

Dwg. L-EIS-3 | Rev C - 18.04.2019



