




DA000	Cover Sheet
DA001	Masterplan
DA002	Lot Plan
DA003	Site Plan
DA011	Ground Floor Plan
DA012	Roof Plan
DA013	Office Plan
DA015	Equipment Layout
DA021	Building Elevations


DA022	Building Elevations 2
DA023	Office Elevations
DA031	Planning & Building Sections
	
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Approved Application No.....9429.....	
granted on the5/4/19.....	
Signed 	
Sheet No.....1..... of33.....	


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
585-649 Mamre Road, Orchard Hills

Development Application
November 2018


AREA SCHEDULE	
TOT 5 TAIL DRAIN AREA	52,612 sq
POST 7 LATERAL AREA	51,715 sq
HIGH BAY WAREHOUSE	11,122 sq
NEW BAY WAREHOUSE	18,532 sq
OFFICE (2 level)	500 sq
TRUCK OFFICE (2 level)	1,300 sq
TOTAL	20,291 sq
RETIRED	3,956 sq
NEW DUTY (HANDS IN)	
Specialties pump and tank area	11,849 sq
HIGH DUTY (CAR PARKING)	2,614 sq
CARS REQUIRED (RMS)	114 CARS
CARS PROVIDED	114 CARS



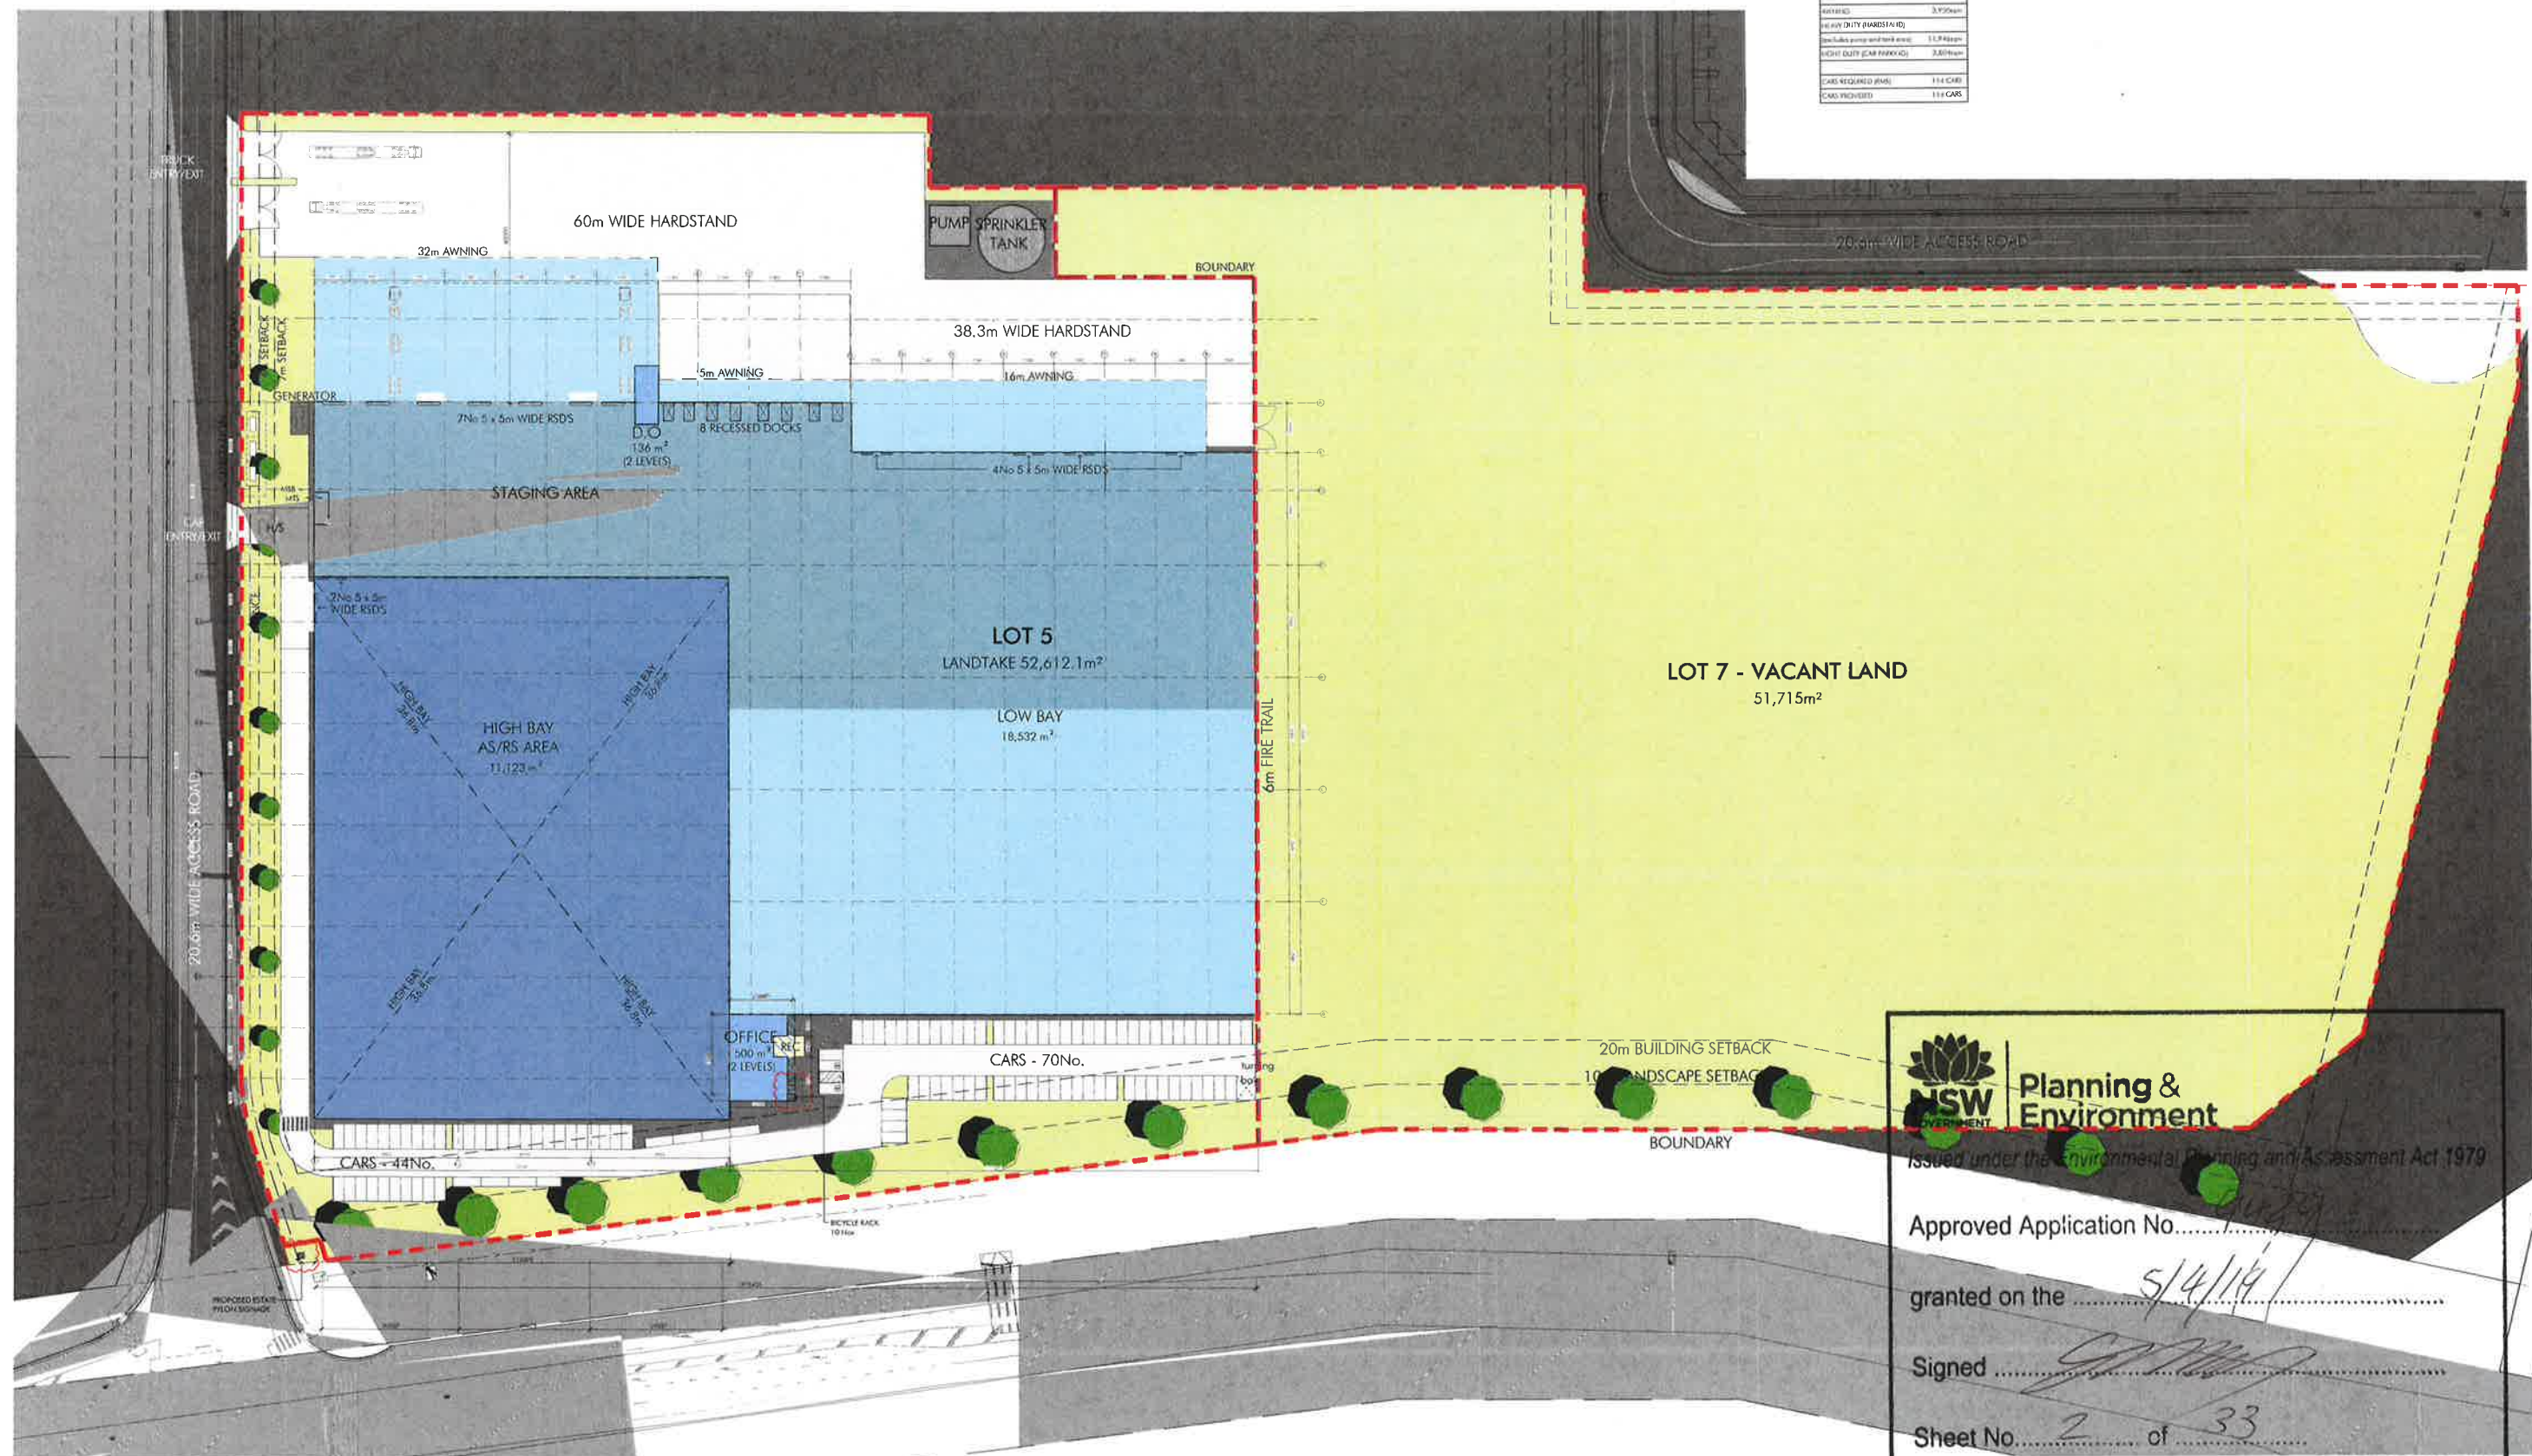

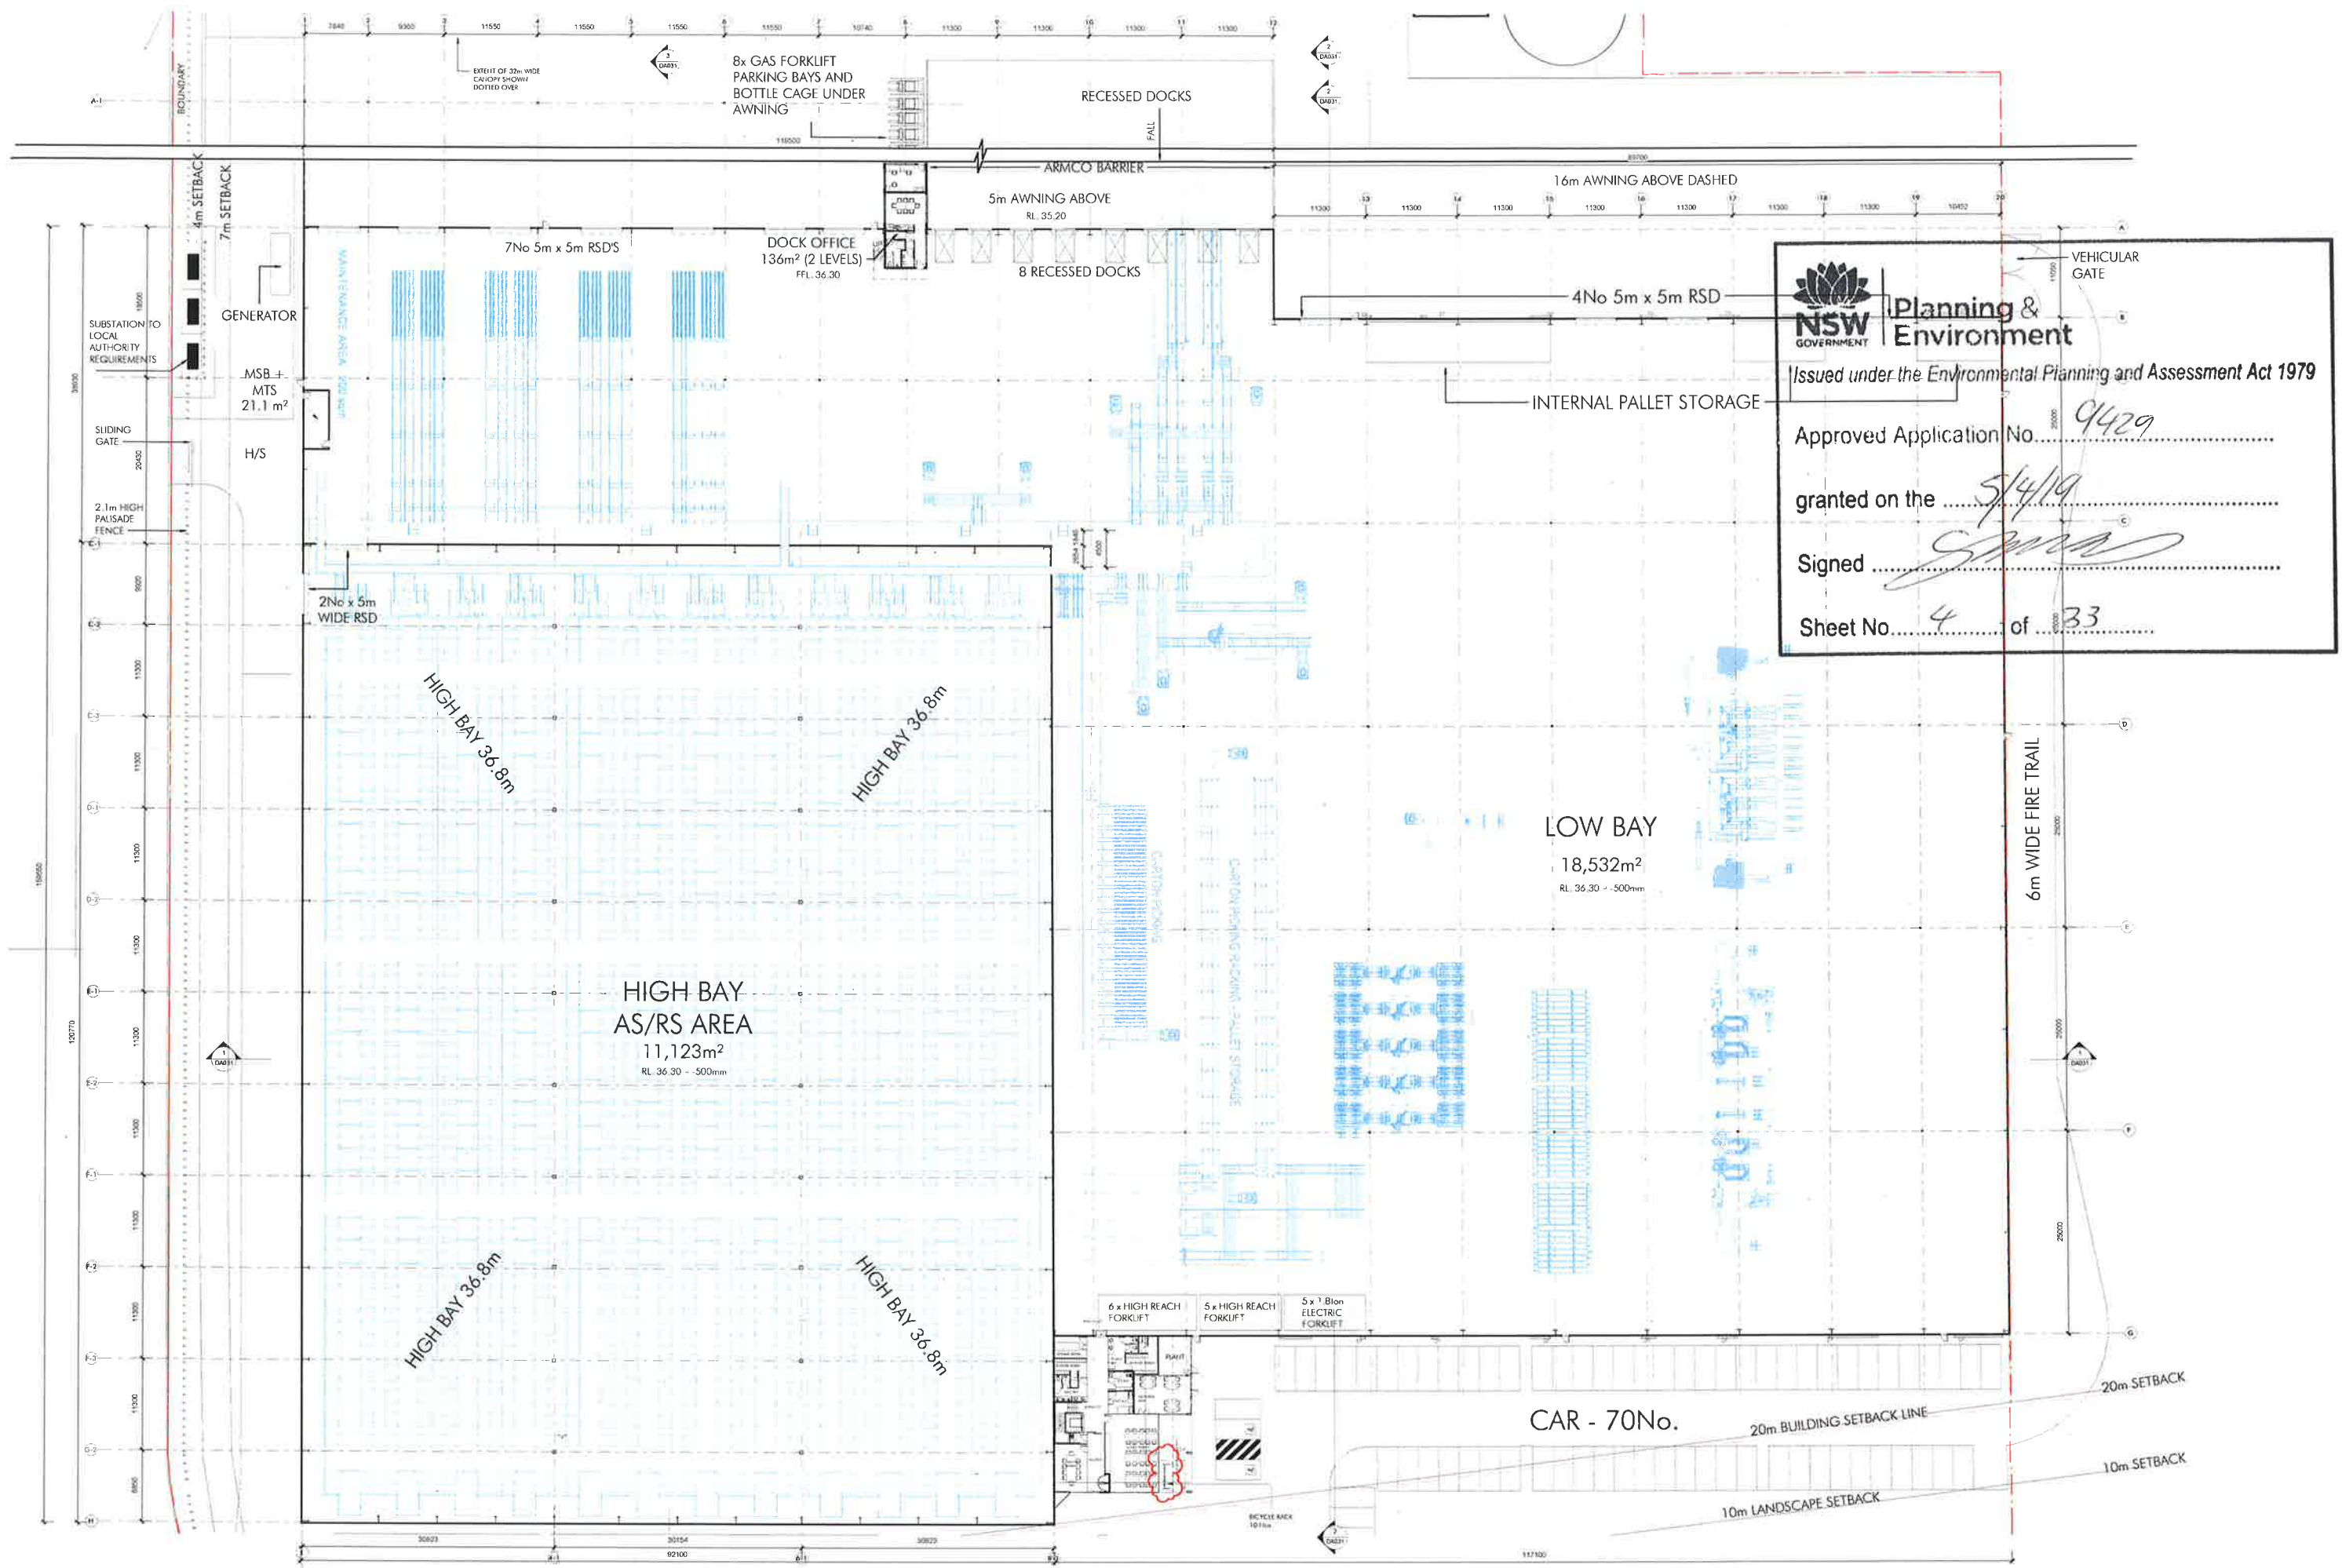

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Sheet No. 4 of 33

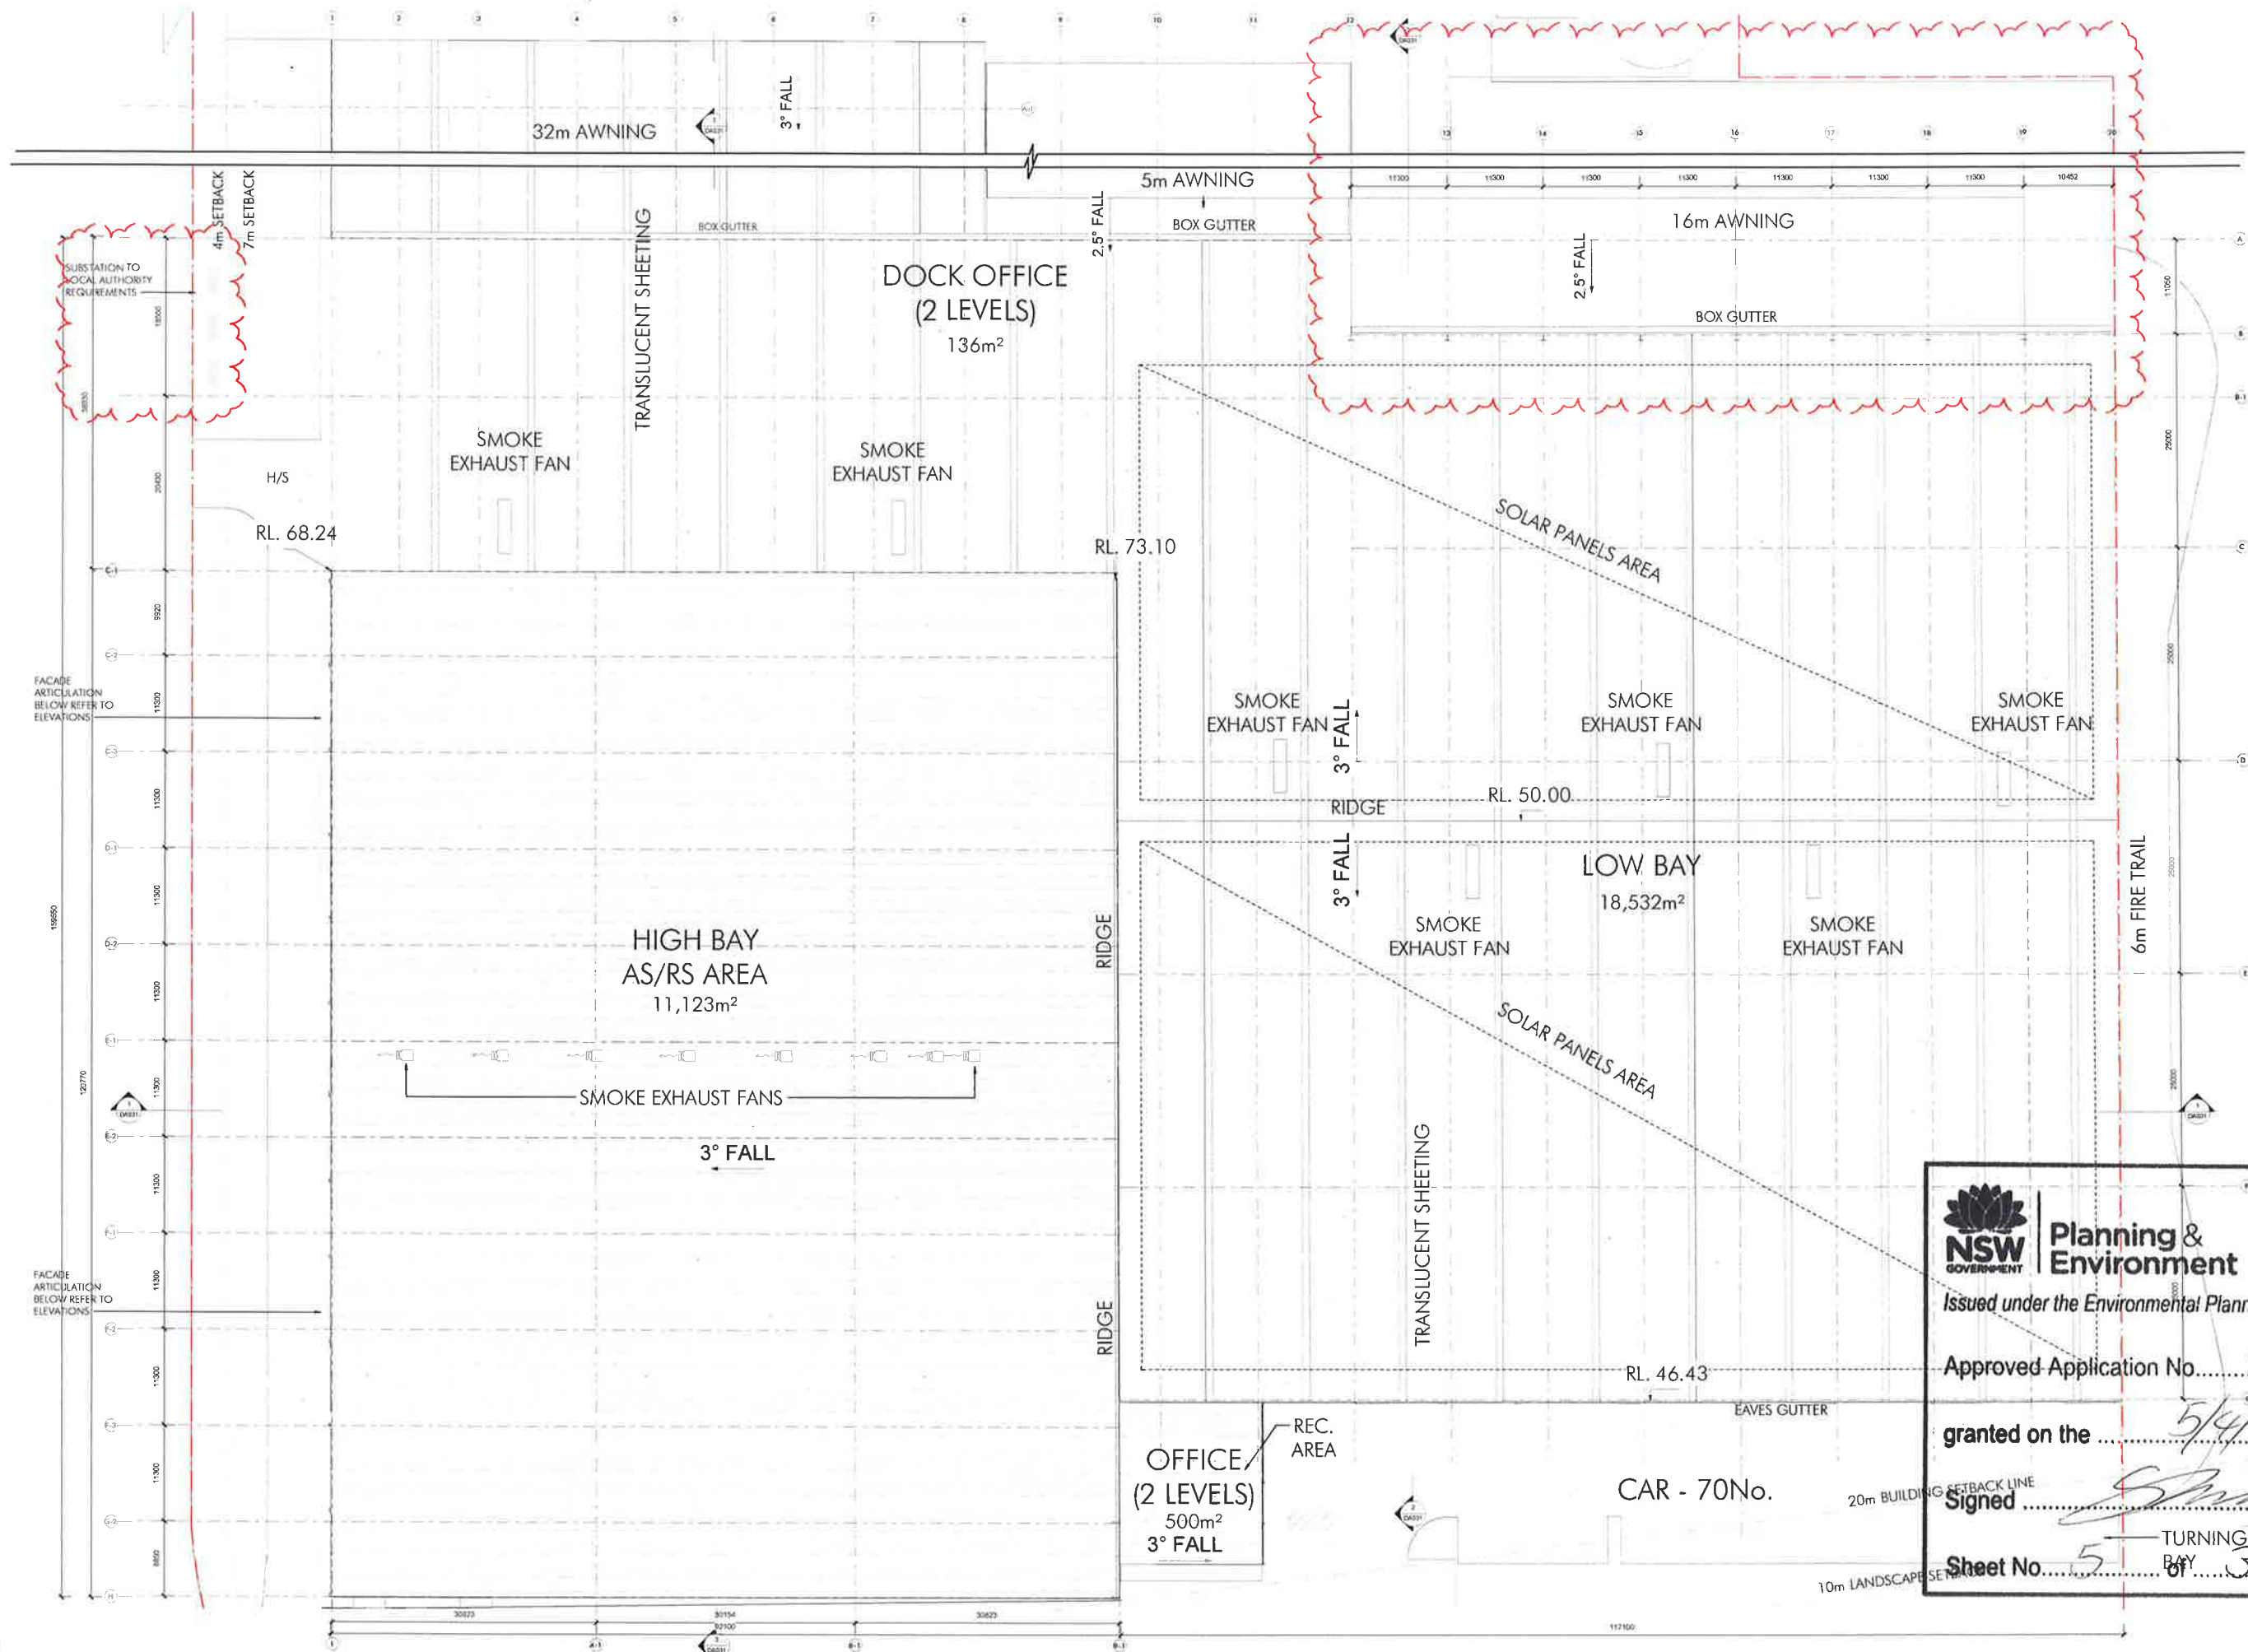

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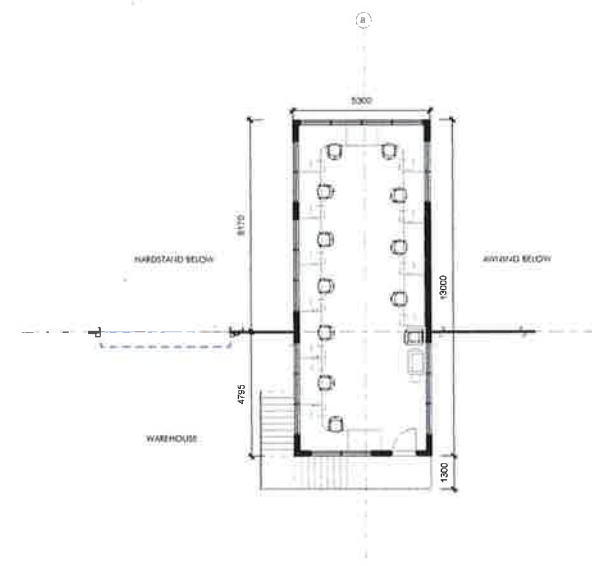
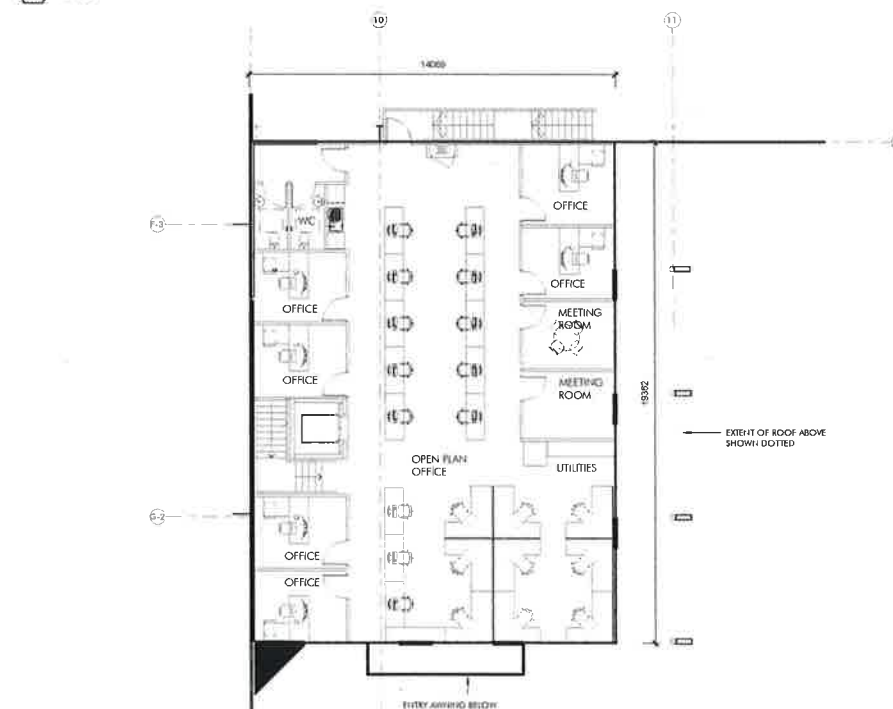
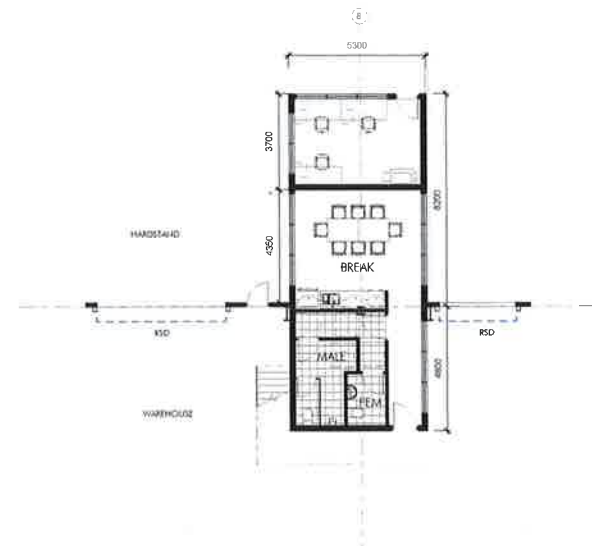
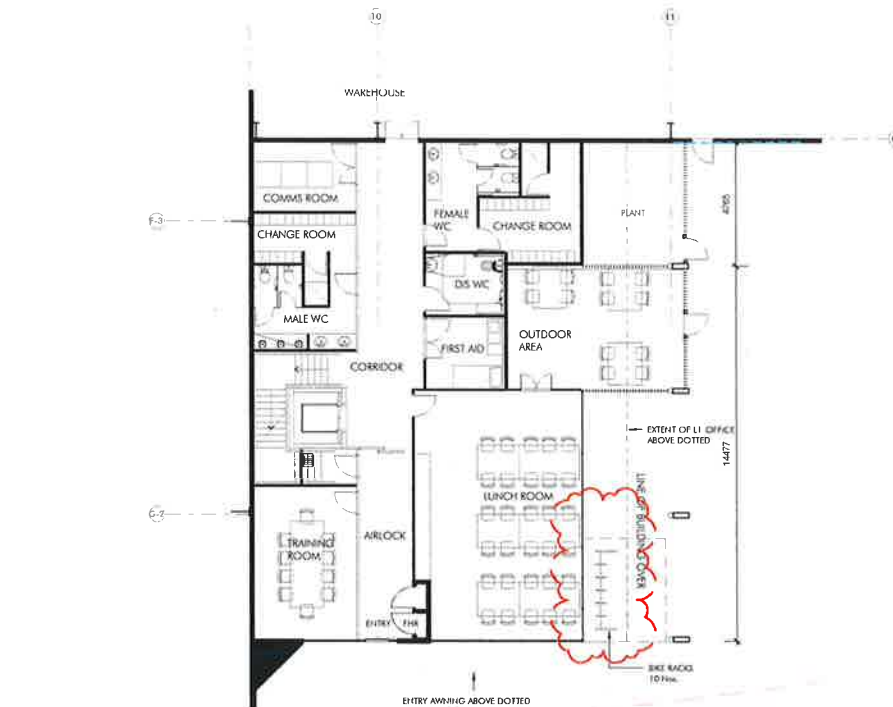
Approved Application No. 9429

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Sheet No. 5 of 33

TURNING BAY



NSW GOVERNMENT | **Planning & Environment**

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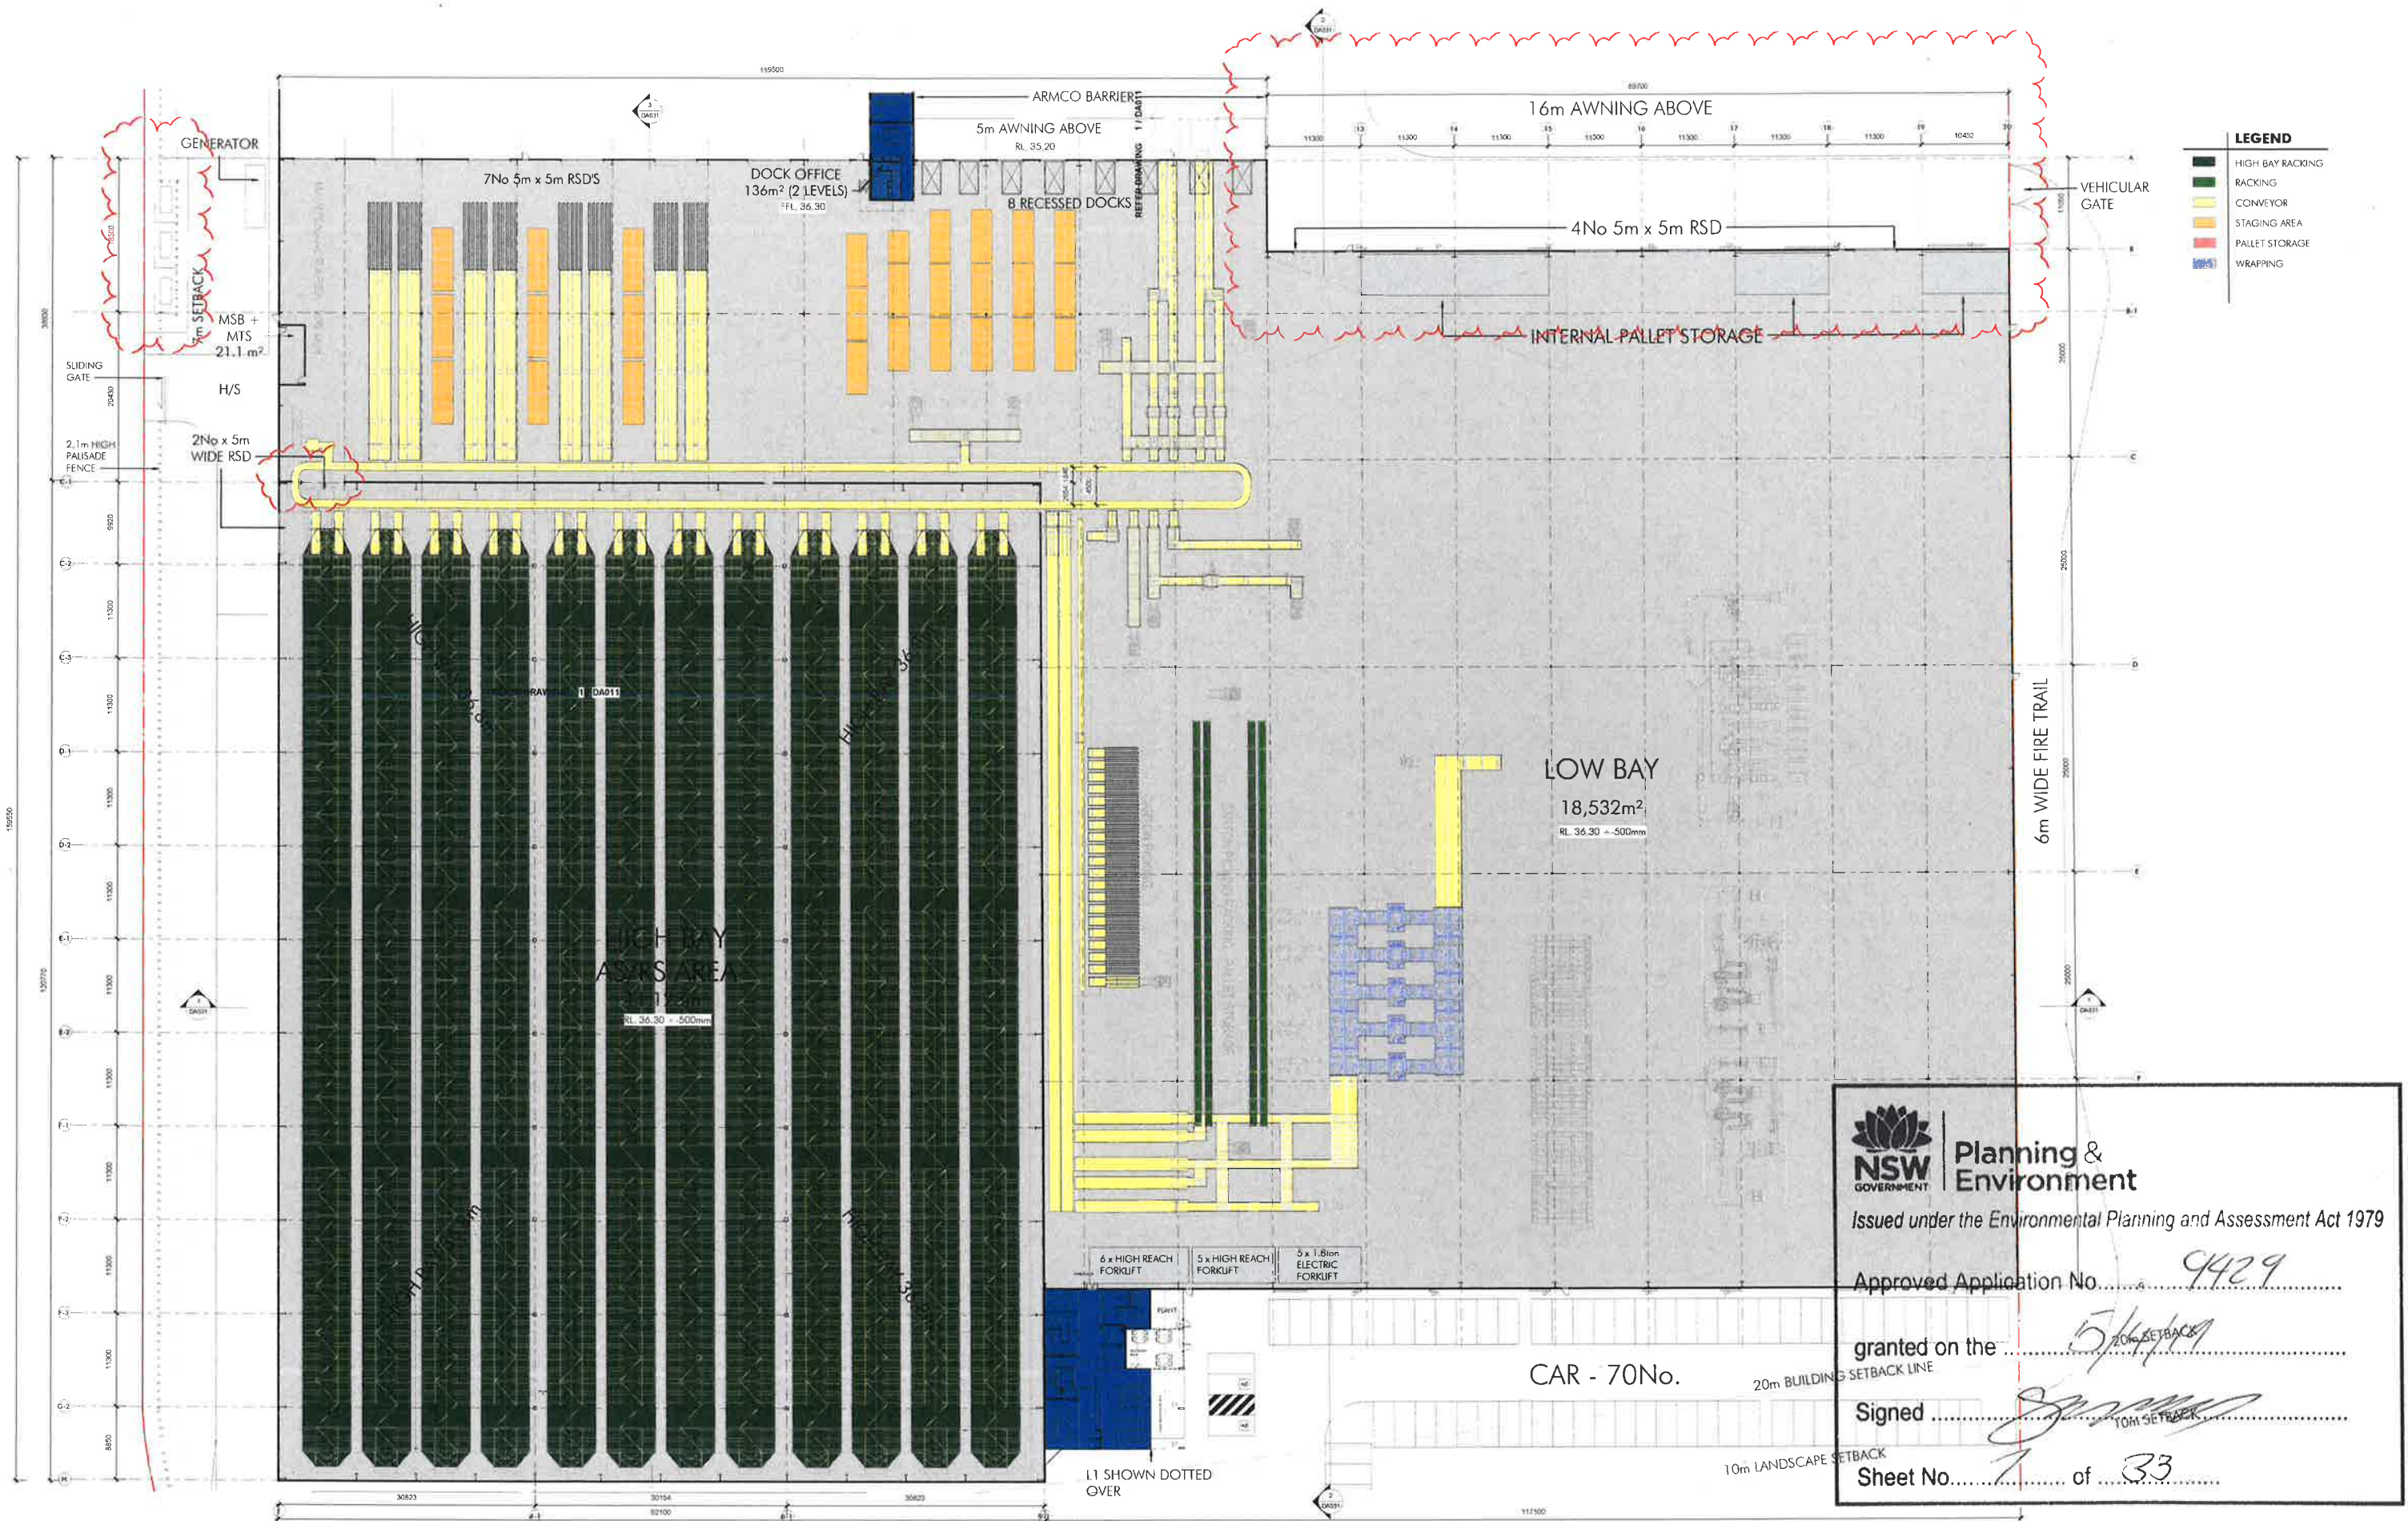
Approved Application No. 9429

granted on the 5/4/19

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Sheet No. 6 of 33

Rev	Description	Date
1	Issue for tender	10/10/18
2	Issue for construction	10/10/18



NSW GOVERNMENT | **Planning & Environment**



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Approved Application No. 9429

granted on the 15/11/19

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Sheet No. 1 of 33



WAREHOUSE

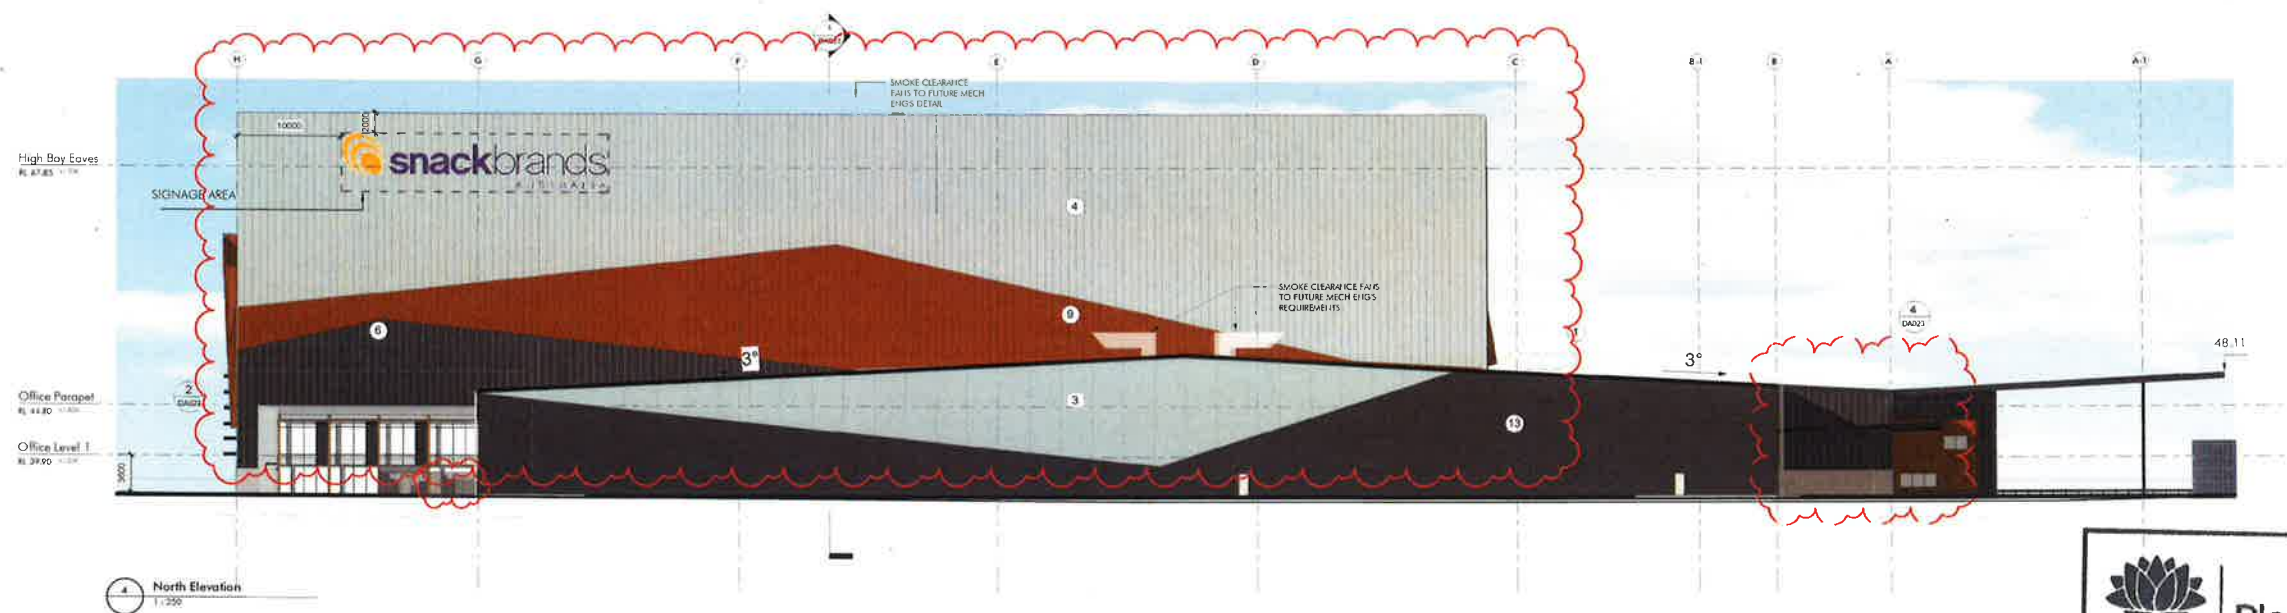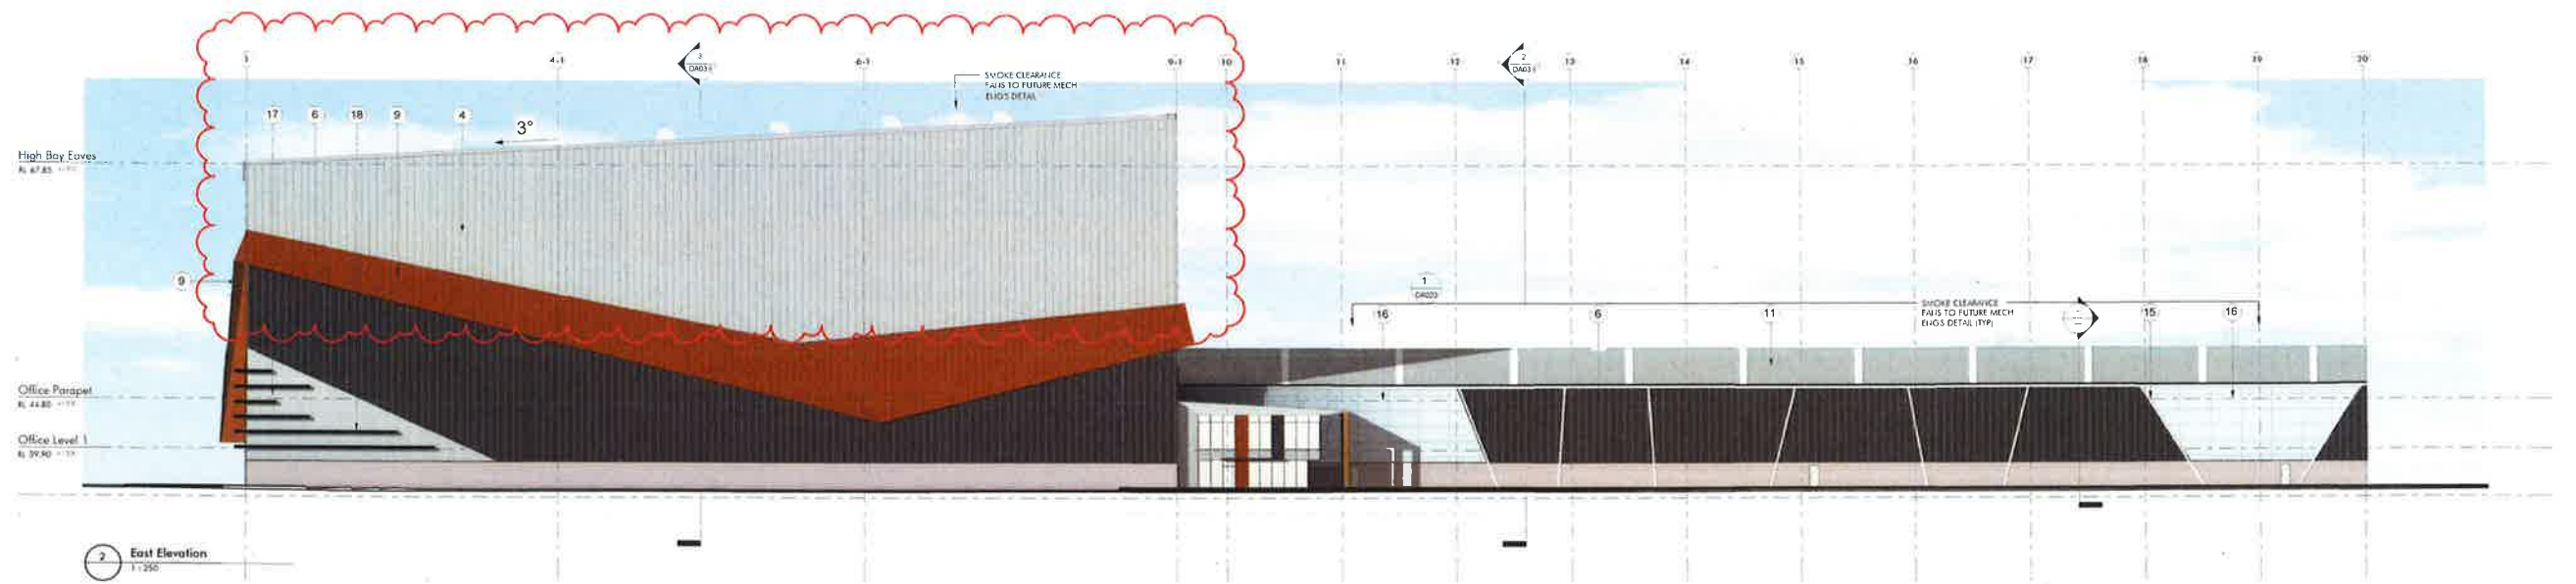- | | | | | |
|--|--|--|---|---|
| 1. PAINTED PRECAST PANEL - LIGHT GREY | 2. TO MATCH COLORBOND MONUMENT | 3. PAINTED PRECAST PANEL LIGHT GREY | 4. PROFILE METAL WALL SHEETING - COLORBOND SHALE GREY | 5. LOUVERS MONUMENT |
| 6. PROFILE METAL WALL SHEETING - COLORBOND MONUMENT MATT | 7. ROOF ACCESSORIES - SHALE GREY | 8. ROLLER SHUTTER DOOR - POWDERCOATED SHALE GREY | 9. PROFILE METAL SHEETING COLORBOND TERRAIN | 10. PAINTED DOOR & DOOR FRAMES LIGHT GREY |
| 11. ROOF SHEETING - ZINCALUME | 12. TRANSLUCENT PROFILED ROOF SHEETING | 13. PRECAST PANEL PAINT MONUMENT | 14. TOEMOULD MONUMENT | 15. COLORBOND SHALE GREY GUTTERS, ROOF FASCIA, AND DOWNPIPE |
| 16. DANPALON ICE | 17. BRUSHED STAINLESS STEEL PANELS | | | |



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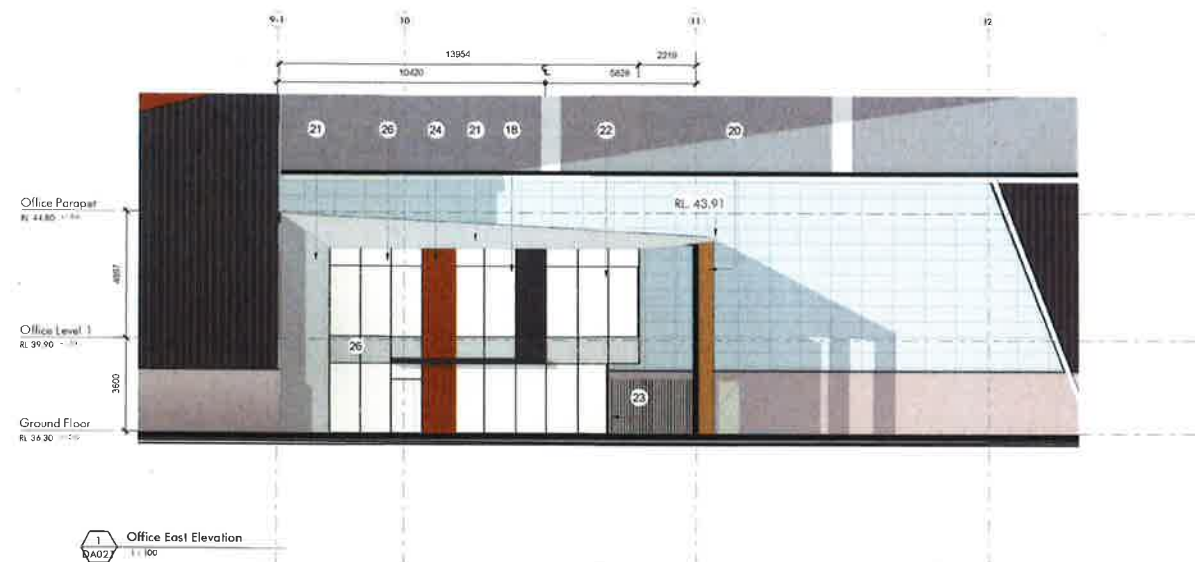
Issued under the Environmental Planning and Assessment Act 1979

Approved Application No. 9429

granted on the 6/4/19

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Sheet No. 10 of 33




1 Office East Elevation
1:100




2 Office North Elevation
1:100



3 Dock Office West Elevation
1:100

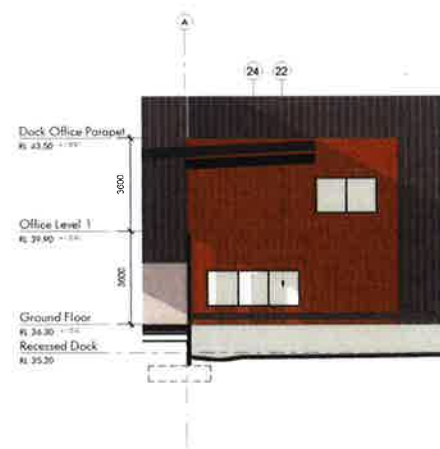

4 Dock Office North Elevation
1:100

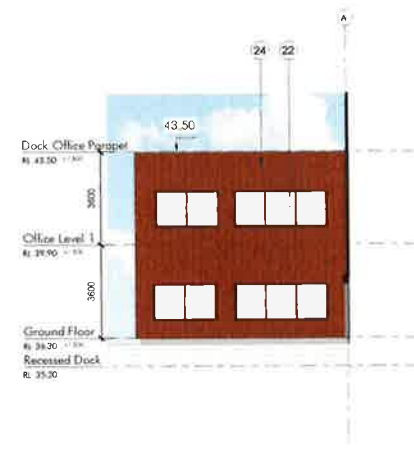


5 Dock Office South Elevation
1:100

OFFICE

- | | | | | |
|---|--|--|--|-------------------------------|
| 18. PREFINISHED COMPOSITE METAL PANEL "MONUMENT" OR SIMILAR | 20. TIMBER LOOKING BLADES | 22. OFFICE WINDOW GLAZING TYPE 1 "GREY VISION" | 24. METAL SHEETING COLORBOND "TERRAIN" | 26. "WHITE" GLAZING SPANDRELL |
| 19. POWDERCOATED ALUMINIUM WINDOW FRAME BLACK | 21. CONCRETE LOOK FC PANEL "BARESTONE" | 23. PAINTED FINISH TO COLUMN MONUMENT | 25. "SHALE GREY" GLAZING SPANDRELL | 27. TIMBER BATTENS SCREEN |



1 TRUCK ENTRY FROM DISTRIBUTION DRIVE

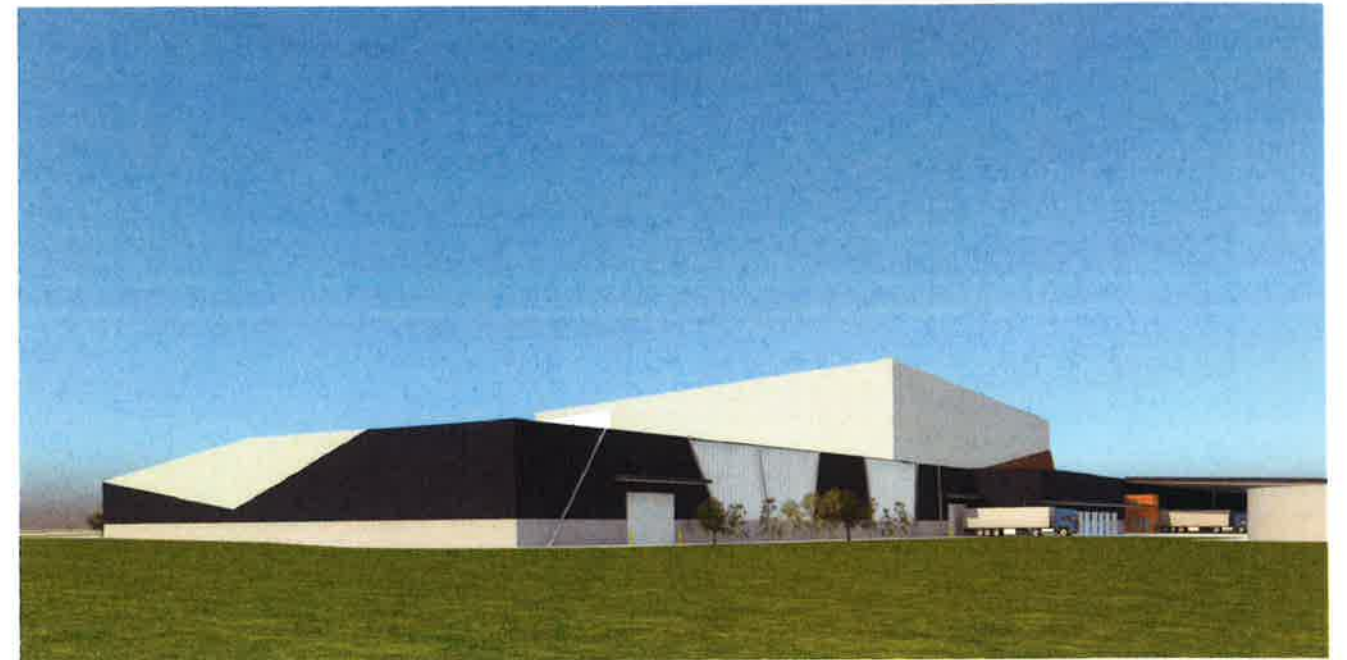

2 NORTH-WEST PERSPECTIVE ACROSS HARDLAND



3 CORNER OF MAMRE ROAD & DISTRIBUTION DRIVE



4 CORNER PERSPECTIVE

NSW GOVERNMENT Planning & Environment
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 Approved Application No. 10736_DA051
 granted on the 15/4/16
 Signed *[Signature]*
 Sheet No. 12 of 33

Item	Description	Value
1	Design & Development Fee	10,000,000
2	Construction Fee	10,000,000
3	Operational Fee	10,000,000
4	Other Fees	10,000,000
5	Total	40,000,000

bio retention basin

LANDTAKE 5B
50,746m²

BUILDING 5A
AVAILABLE AS A PRELEASE
FUTURE WAREHOUSE 5A
26,570m²

not developable

BUILDING 2
DATS
WAREHOUSE
14,942m²

BUILDING 1
FRNSW TRAINING ACADEMY

BUILDING 3A
WAREHOUSE 3A1
7,000m²

BUILDING 3B
WAREHOUSE 3B2
11,334m²

BUILDING 4B
IMCD
WAREHOUSE 4B2
5,500m²

BUILDING 4A
AVAILABLE AS SHOWN
UNDER DEVELOPMENT
WAREHOUSE 4A1
11,720m²

BUILDING 6C
PROJECT BLUE
WAREHOUSE 6C
13,856m²

BUILDING 6B
AVAILABLE AS SHOWN
UNDER DEVELOPMENT
4,514m²

BUILDING 6A
VOESTALPINE
5,000m²

BUILDING 7
WAREHOUSE 7
29,655m²


FUTURE RETAIL PRECINCT

MAMRE ROAD

NSW GOVERNMENT
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Approved Application No. 7/12/19
granted on the 5/4/19
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Sheet No. 33 of 33

585 - 649 Mamre Road, Orchard Hills NSW 2748

Landscape Documentation for State Significant Development Approval - Stage 1 - SSD 18_9429

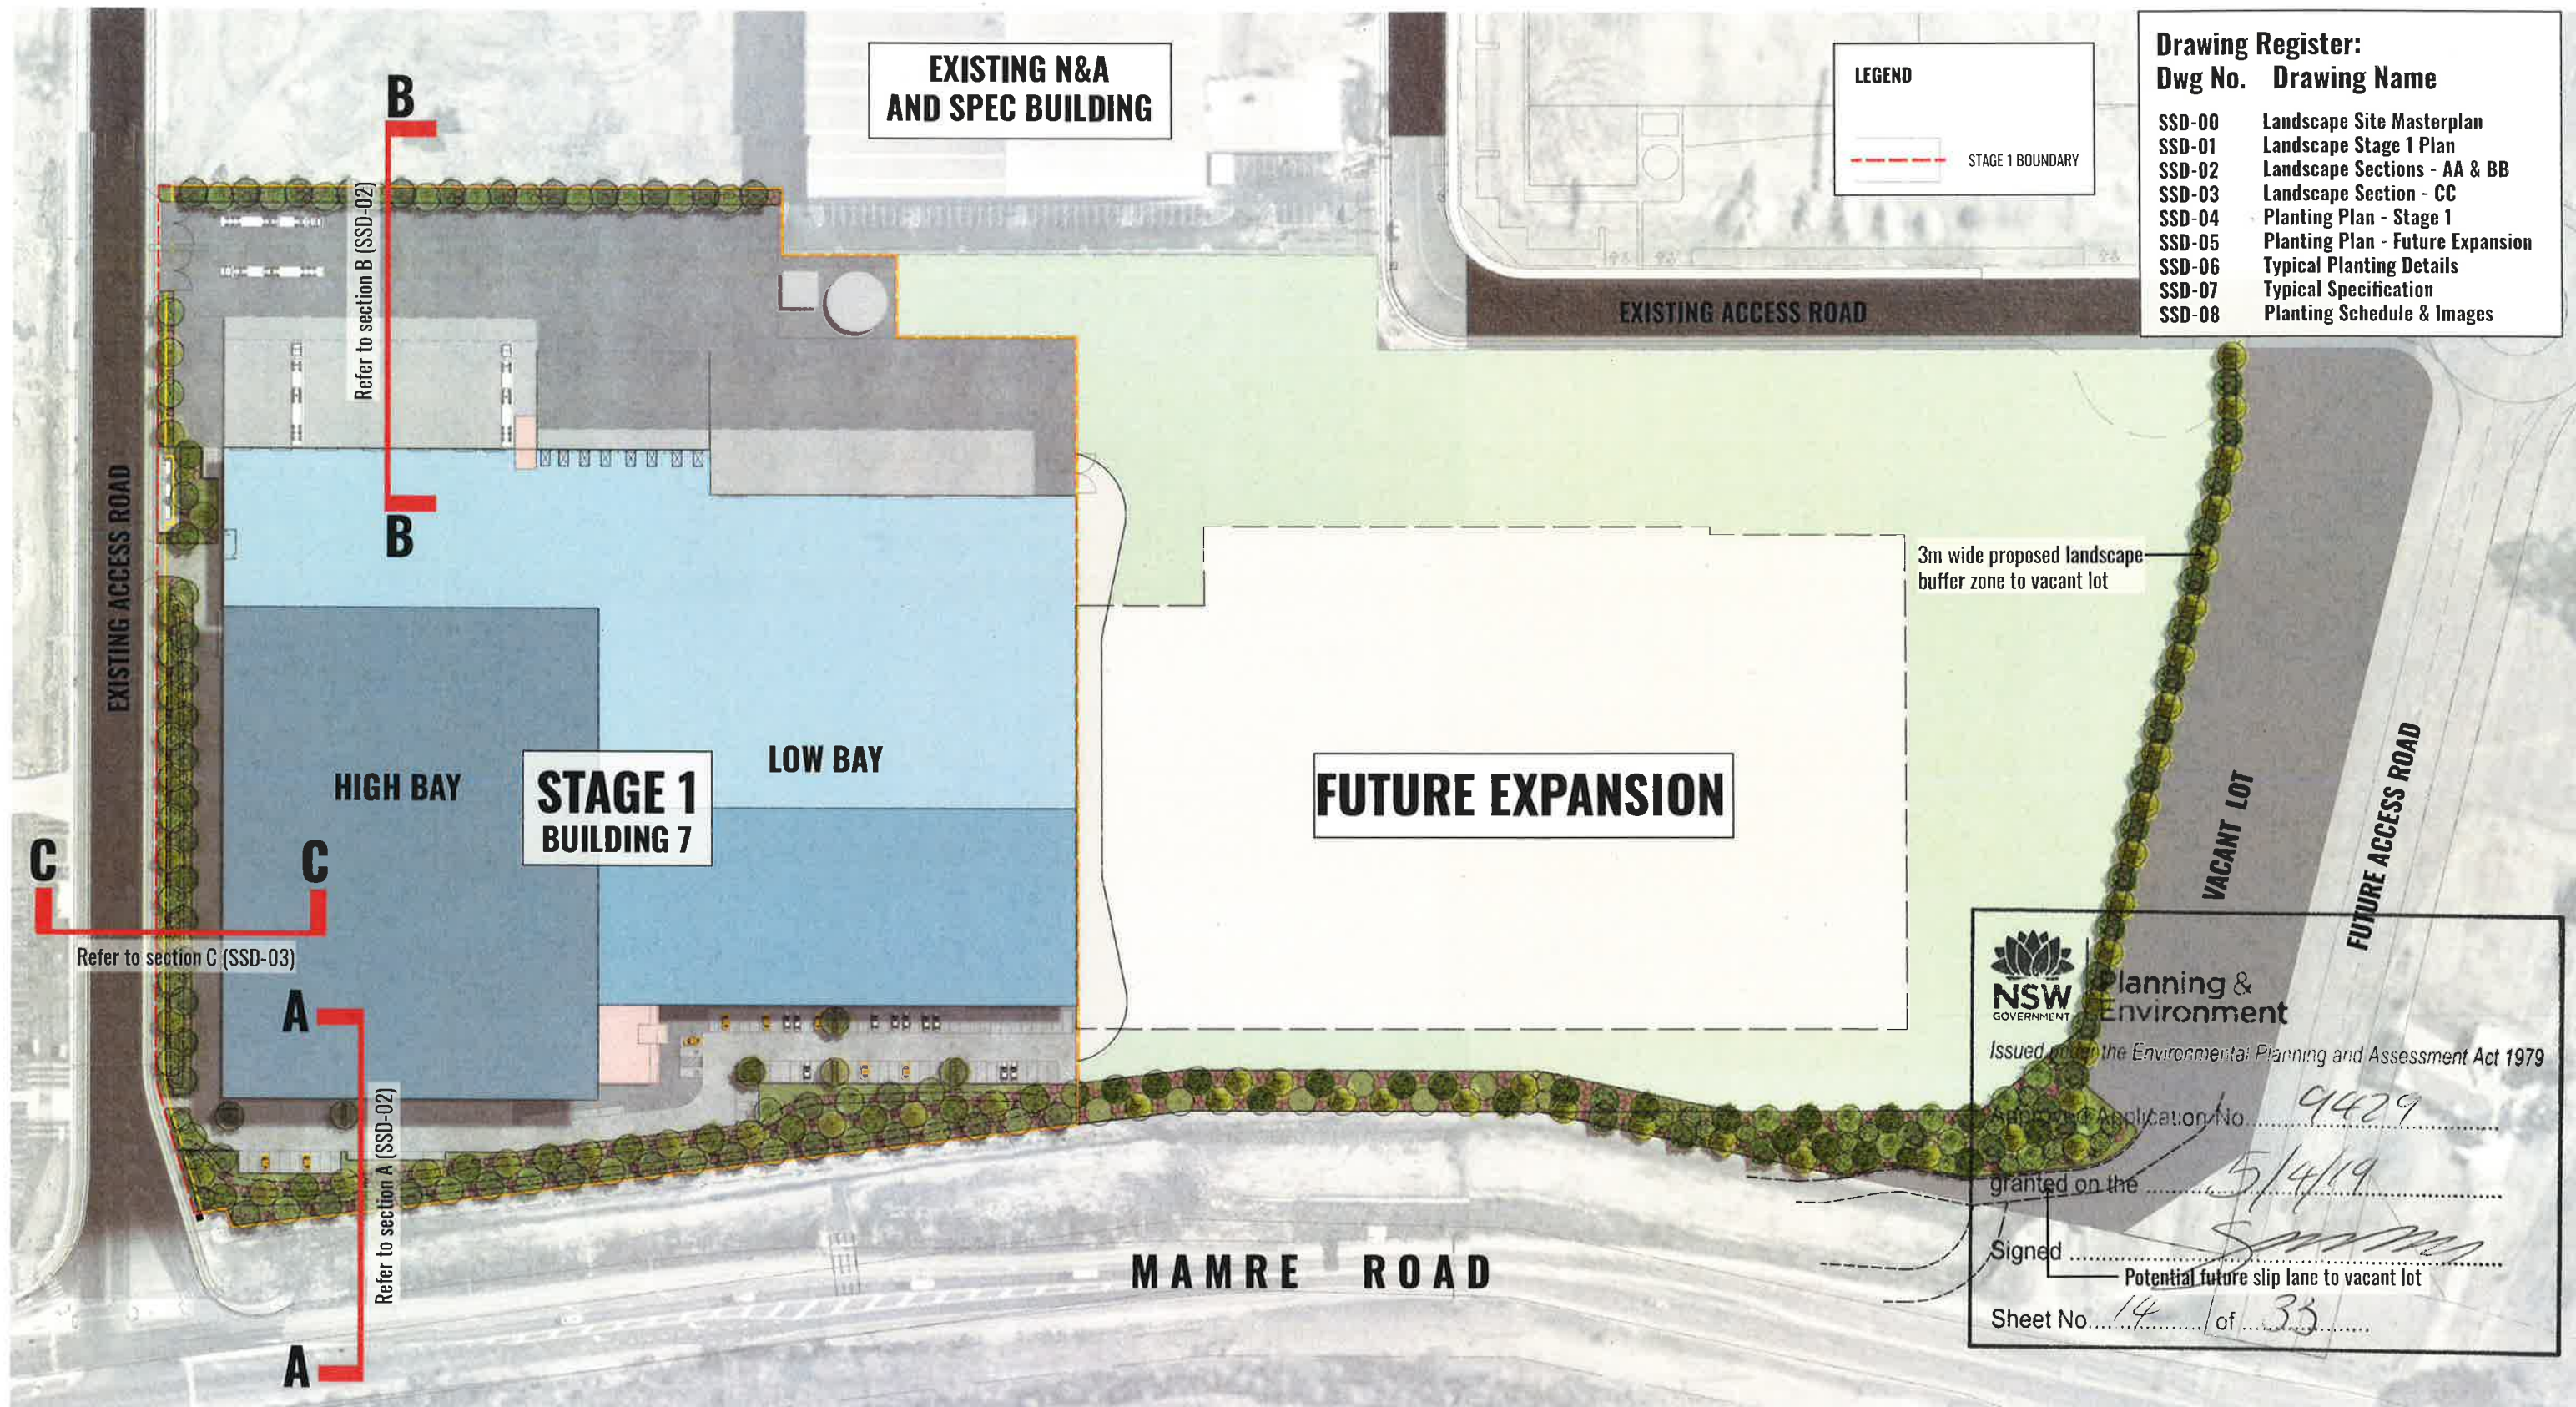


Drawing Title:
Landscape Site Masterplan
DWG No:
SSD-00

GEO SCAPES
LANDSCAPE ARCHITECTS
Suite 215, 284 Victoria Av, Chatswood NSW 2067 Ph. (02) 9411 1485
www.geoscapes.com.au
ABN 84 620 205 781 ACN 620 205 781

Architect:
nettleontribe
architecture

Client:
ALTIS
PROPERTY PARTNERS

Scale:	Date:	Job Number:	North:	FOR STATE SIGNIFICANT DEVELOPMENT					
1:750 @ A1 1:1500 @ A3	30.11.18	180607		Revision	Rev	Date	Description	Drawn	Checked
Project:	585-649 Marmre Road - Stage 1 Orchard Hills NSW 2748			A	13/11/18	SSD (RM 1)		JT	BG
				B	21/11/18	FOR SSD		JT	BG
				C	31/11/18	FOR SSD		JT	BG
				D	06/12/18	FOR SSD		JT	BG
				E	19/12/18	FOR SSD		JT	BG
				F	30/11/18	FOR SSD		CC	BG

LEGEND

STAGE 1 BOUNDARY

2.1m HIGH SECURITY FENCE

NATIVE ENDEMIC CANOPY TREE PLANTING WITHIN LANDSCAPE BUFFER ZONES AND TO INTERNAL ESTATE

MIX OF NATIVE SHRUB PLANTING

MIX OF NATIVE GRASSES AND GROUNDCOVERS

MOUNDED PLANTING WITHIN THE BUFFER ZONE

The diagram illustrates the landscape plan for Stage 1 of a development. Key features include:

- STAGE 1 BUILDING 7**: Consists of a **HIGH BAY** (PAD RL:36.6) and a **LOW BAY** (PAD RL:36.6).
- STAGING AREA**: Located between the building and the parking area, featuring a **Generator**, **Office**, **Substation**, and **MSB + MTS**.
- PARKING**: Includes **PARKING - 43No.** and **PARKING - 70No.**
- Access and Roads**: **EXISTING ACCESS ROAD** on the left, **TRUCK ENTRY/EXIT** at the top, and **CAR PARK ENTRY/EXIT** on the left side. **MAMRE ROAD** is at the bottom.
- Landscaping**: Extensive planting of native trees, shrubs, and groundcover is shown along the access roads and around the building. A **60M WIDE HARDSTAND** is at the top.
- Future Expansion**: Indicated by a dashed line representing a future expansion building.
- Other Features**: **Recreational Area**, **Office**, **SPRINKLER TANK**, and **PUMP** are also labeled.

Drawing Title:
Landscape Stage 1 Plan
DWG No:

SSD-01

GEOSCAPES

LANDSCAPE ARCHITECTS

Suite 215, 284 Victoria Av, Chatswood NSW 2067 Ph. (02) 9411 1485

www.geoscapes.com.au

ABN 84 620 205 781 ACN 620 205 781

Architect:

nettleontribe

architecture

Client:

ALTIS

PROPERTY PARTNERS

Scale: 1:500 @ A1
1:1000 @ A3

Date: 30.11.18

Job Number: 180607

North:

Project: 585-649 Marmre Road - Stage 1
Orchard Hills NSW 2748

Revision		FOR STATE SIGNIFICANT DEVELOPMENT			
Rev	Date	Description	Drawn	Checked	
A	12.01.18	ISSUED	JT	BG	
B	27.07.18	FOR SSD	JT	BG	
C	31.07.18	FOR SSD	JT	BG	
D	06.08.18	FOR SSD	JT	BG	
E	29.08.18	FOR SSD	JT	BG	
F	30.11.18	FOR SSD	CC	BG	

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Sheet No. 15 of 33



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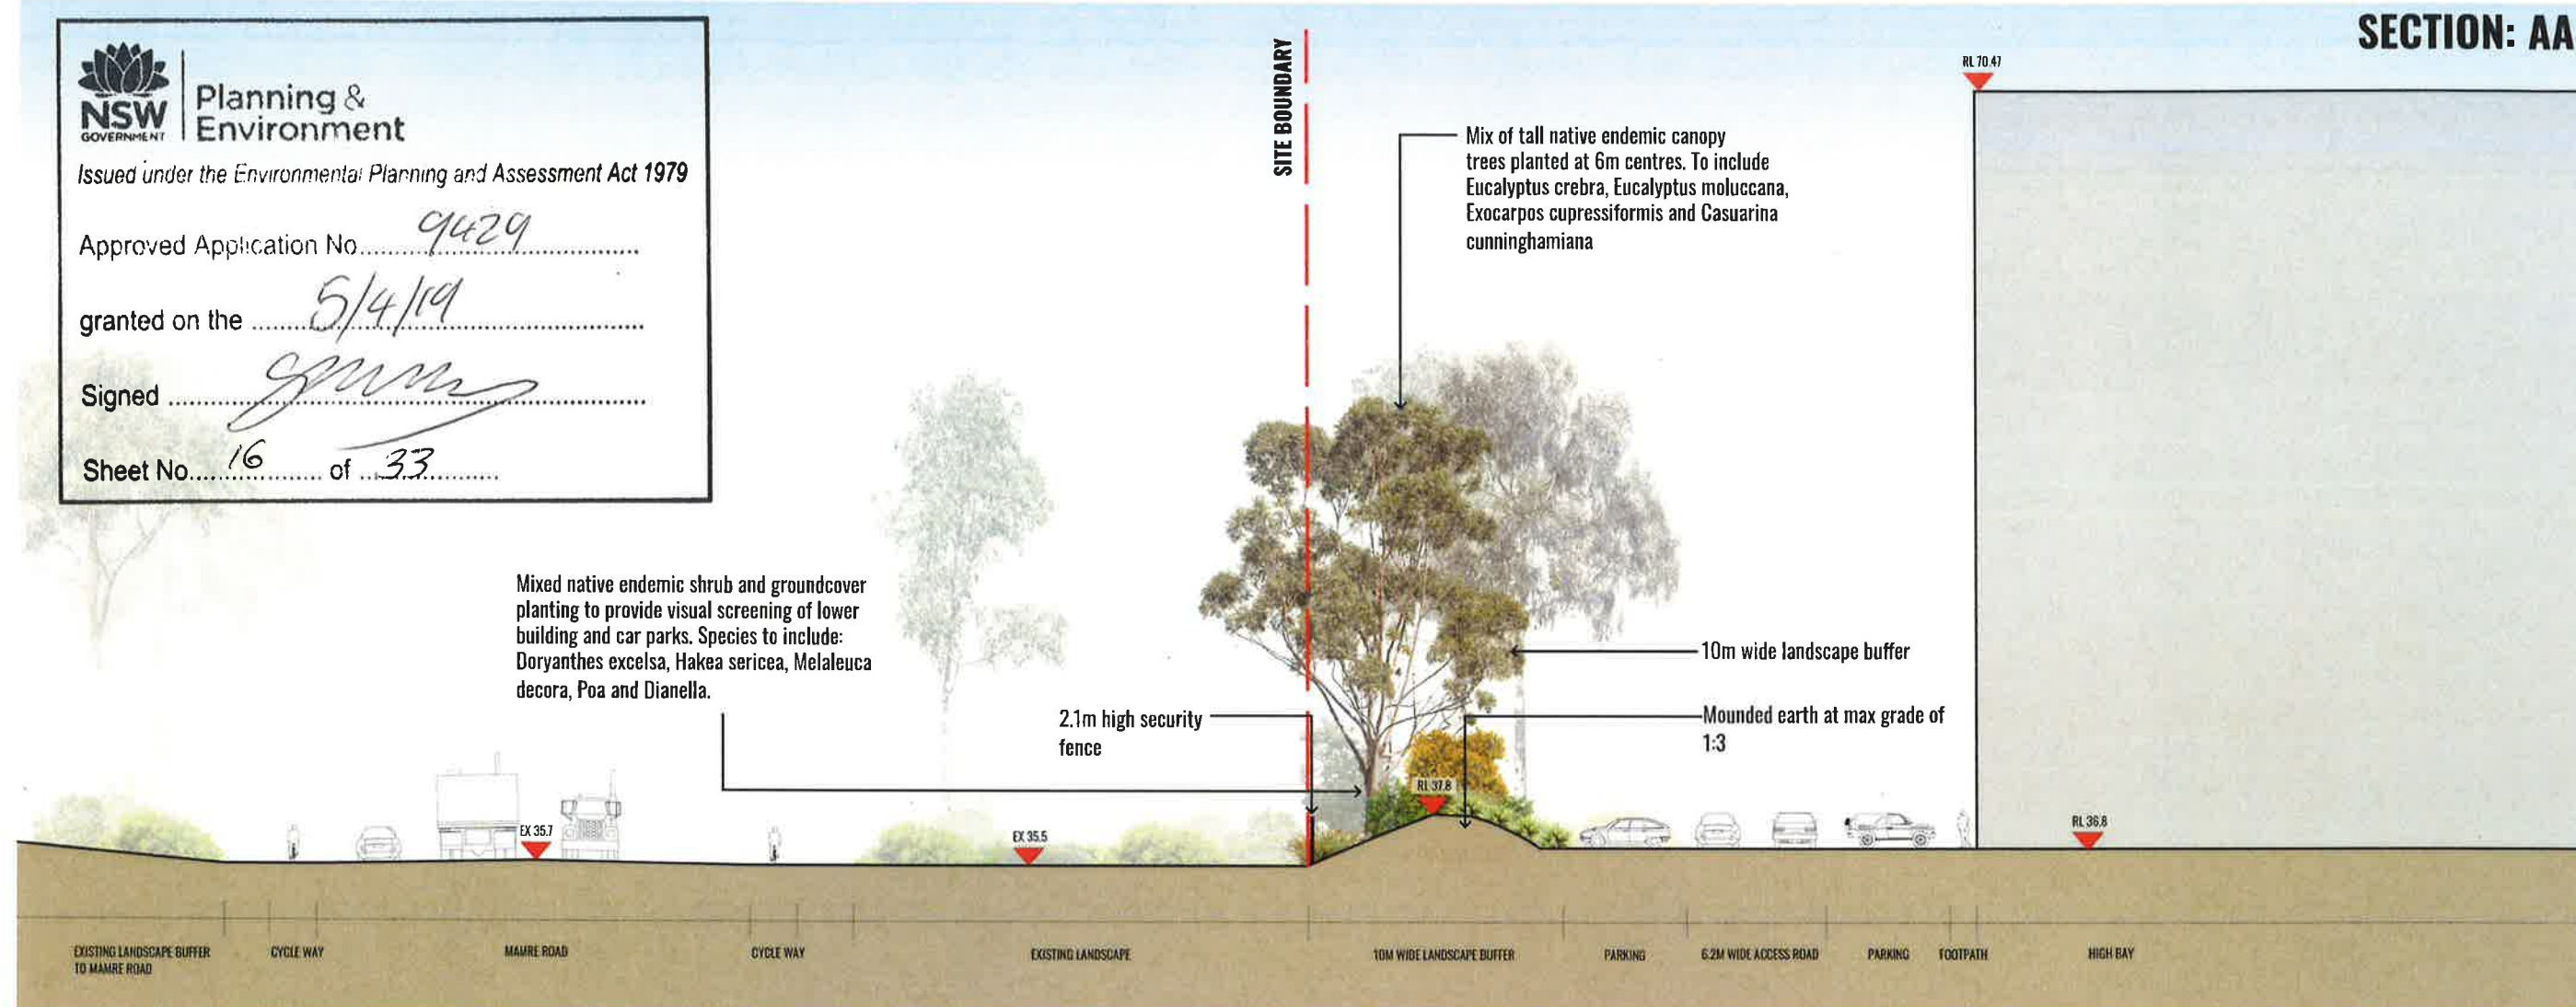
Approved Application No. 9429

granted on the 5/4/19


Signed [Signature]

Sheet No. 16 of 33

SECTION: AA



SECTION: BB

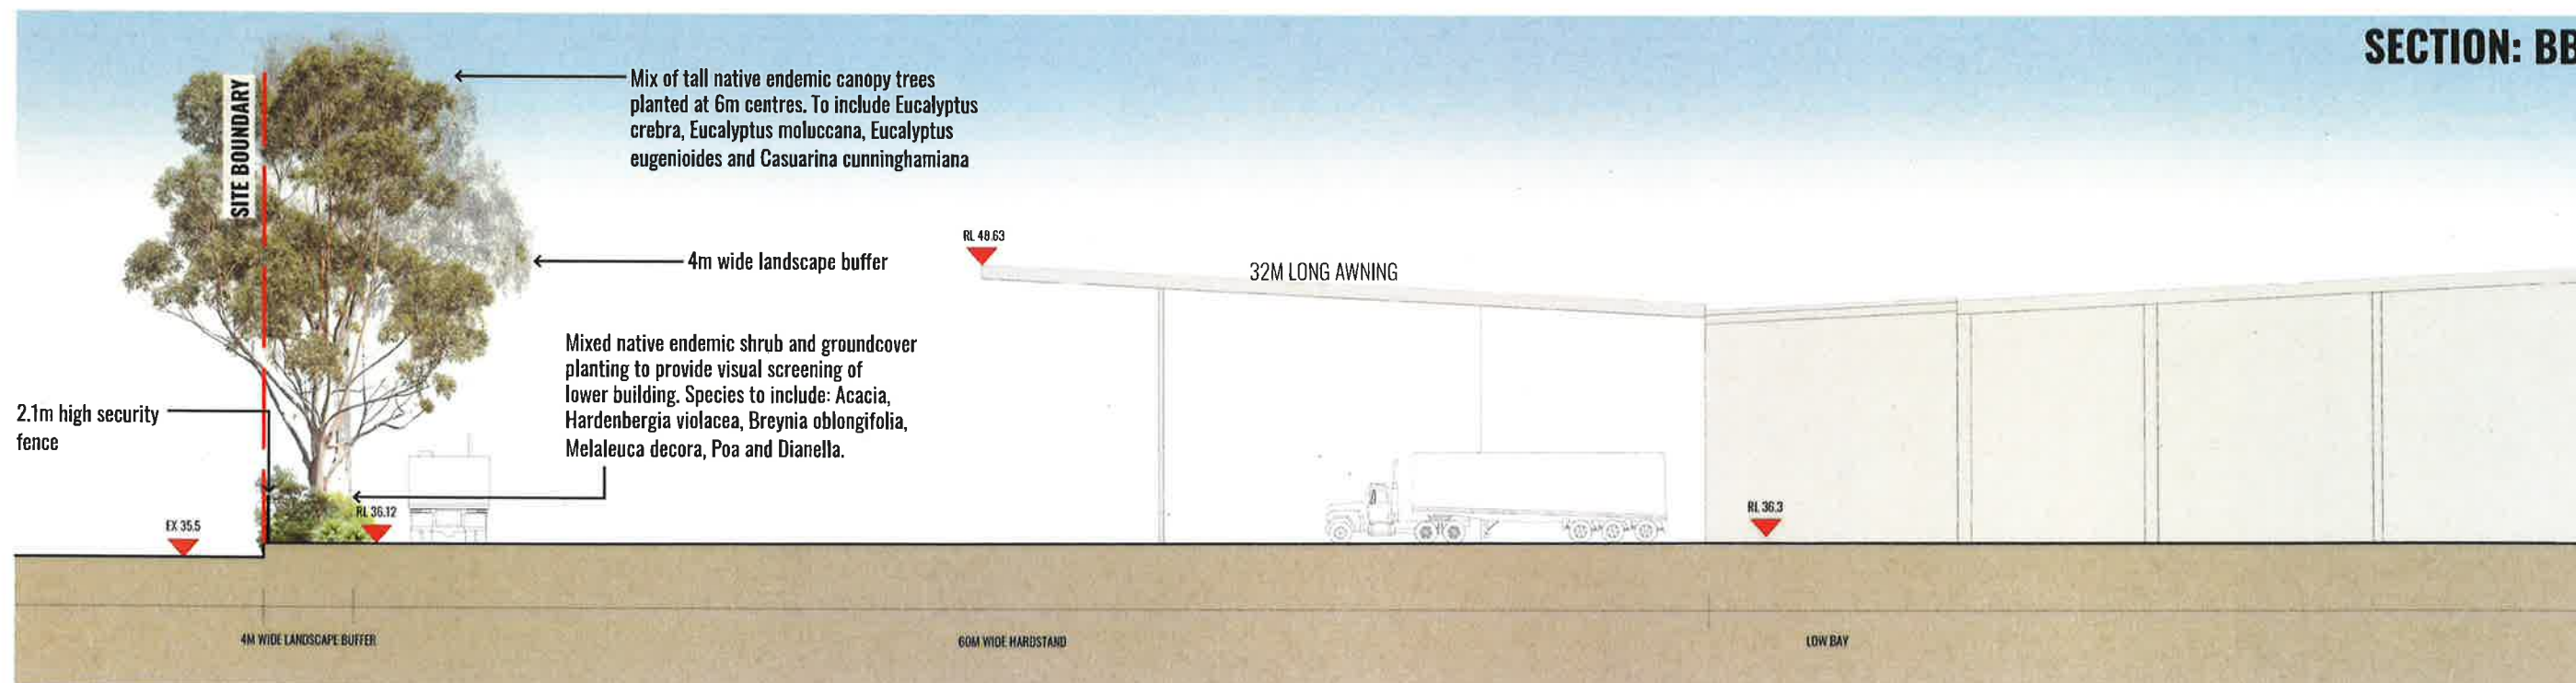

Drawing Title:

Landscape Sections - AA & BB

DWG No:

SSD-02

GEOSCAPES
LANDSCAPE ARCHITECTS

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ABN 84 620 205 781 ACN 620 205 781

Architect:

nettletontribe
architecture

Client:

ALTIS
PROPERTY PARTNERS

Scale:

1:150 @ A1
1:300 @ A3

Date:

30.11.18

Job Number:

180607

North:

N/A

Project:

585-649 Marmre Road - Stage 1
Orchard Hills NSW 2748

FOR STATE SIGNIFICANT DEVELOPMENT					
Rev	Date	Description	Drawn	Checked	
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B	21.07.18	FOR SSD	JT	BG	
C	31.07.18	FOR SSD	JT	BG	
D	05.08.18	FOR SSD	JT	BG	
E	09.08.18	FOR SSD	JT	BG	
F	30.11.18	FOR SSD	CC	BG	



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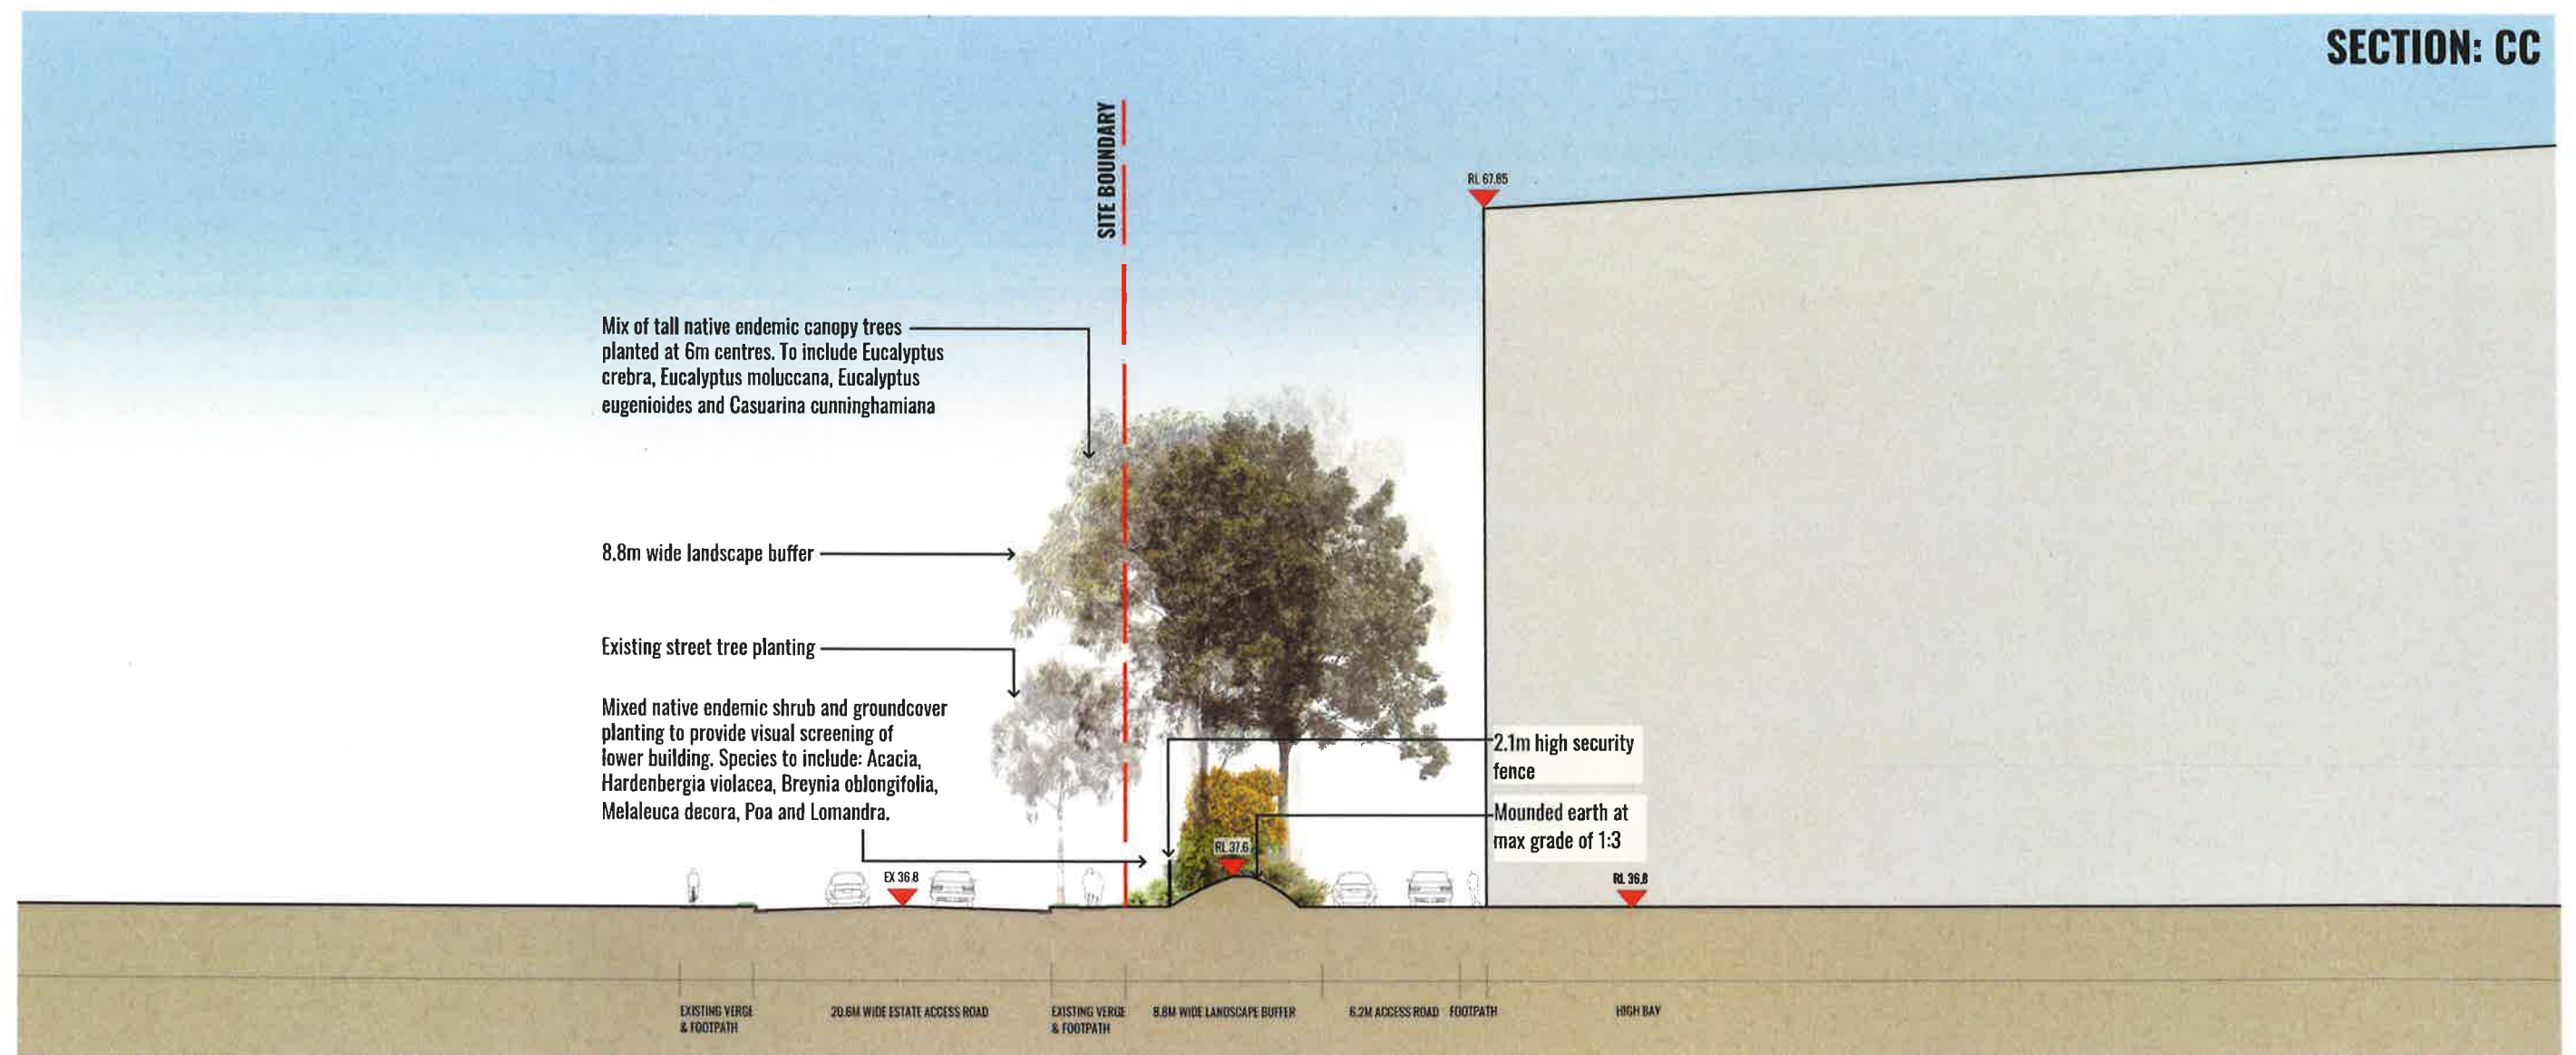
Approved Application No. 9429

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Sheet No. 17 of 33

SECTION: CC



Drawing Title:
Landscape Section - CC
DWG No:

SSD-03

GEOSCAPES
LANDSCAPE ARCHITECTS
Suite 215, 284 Victoria Av, Chatswood NSW 2067 Ph. (02) 9411 1485
www.geoscapes.com.au
ABN 84 620 205 781 ACN 620 205 781

Architect:

nettletontribe
architecture

Client:

ALTIS
PROPERTY PARTNERS

Scale:
1:150 @ A1
1:300 @ A3

Date:
30.11.18


Job Number:
180607

North:
N/A

Project:

585-649 Marmre Road - Stage 1
Orchard Hills NSW 2748

Revision		FOR STATE SIGNIFICANT DEVELOPMENT			
Rev	Date	Description	Drawn	Checked	
A	13.01.18	SSD (MAY 1)	JT	BG	
B	27.01.18	FOR SSD	JT	BG	
C	31.01.18	FOR SSD	JT	BG	
D	06.08.18	FOR SSD	JT	BG	
E	07.08.18	FOR SSD	JT	BG	
F	30.11.18	FOR SSD	CC	BG	

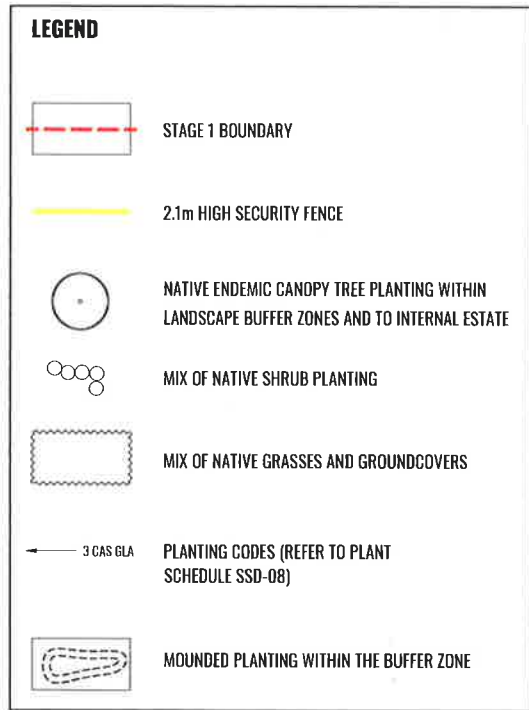

SOUTHERN BUFFER ZONE A
GRASSES & GROUNDCOVERS : Mix of 243 MIC sti, 136 SCA aem, 643 LOM fil, 643 LOM lon, 343 LOM mul, 205 CAR app, 188 POA lab

SOUTHERN BUFFER ZONE
REFER TO SSD-06

SOUTHERN BUFFER ZONE B
SHRUBS : Mix of 12 DOR exc, 24 MEL dec, 12 DIL jun, 24 HAR vio, 6 BUR spi, 9 DAV uli, 9 CAL sal

SOUTHERN BUFFER ZONE B
GRASSES & GROUNDCOVERS : Mix of 1100 MIC sti, 1004 SCA aem, 1057 LOM fil, 1057 LOM lon, 1057 LOM mul, 1153 CAR app, 1321 POA lab

SOUTHERN BUFFER ZONE
REFER TO SSD-06

EASTERN BUFFER ZONE
REFER TO SSD-06

EASTERN BUFFER ZONE
GRASSES & GROUNDCOVERS : Mix of 525 POA lab, 525 VIO hed, 655 DIA lon, 450 DIA rev, 560 CAR app, 670 THE aus, 480 DIC rep, 545 DIC mic

EASTERN BUFFER ZONE
SHRUBS : Mix of 9 ACA bin, 9 HAR vio, 8 BRE obl, 8 MEL dec, 9 HAK ser, 9 BUR spi

32M AWING ABOVE

SOUTHERN BUFFER ZONE A
SHRUBS : Mix of 4 DOR exc, 4 MEL dec, 6 DIL jun, 3 HAR vio, 5 BUR spi, 4 DAV uli

5M AWING ABOVE

FUTURE EXPANSION LANDSCAPING

STAGE 1 BUILDING 7

LOW BAY

HIGH BAY

WESTERN BUFFER ZONE
SHRUBS : Mix of 69 DOR exc, 85 BRE obl, 85 ACA par, 85 HAK ser, 32 ACA bin, 32 DAV uli, 28 MEL dec, 28 DIL jun, 32 BUR spi, 13 CAL sal

OFFICE

6M WIDE FIRE TRAIL

WESTERN BUFFER ZONE
REFER TO SSD-06



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granted on the 5/4/19

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Sheet No. 18 of 33

Drawing Title:
Planting Plan - Stage 1

DWG No:

SSD-04

GEOSCAPES

Suite 215, 284 Victoria Av, Chatswood NSW 2067 Ph. (02) 9411 1485
www.geoscapes.com.au
ABN 84 620 205 781 ACN 620 205 781

Architect:

nettleontribe
architecture

Client:

ALTIS
PROPERTY PARTNERS

Scale:
1:500 @ A1
1:1000 @ A3

Date:
30.11.18

Job Number:
180607

North:
[North Arrow]

Project:

585-649 Marmre Road - Stage 1
Orchard Hills NSW 2748

FOR STATE SIGNIFICANT DEVELOPMENT					
Rev	Date	Description	Drawn	Checked	
A	15/12/18	SSD-04	JT	BG	
B	27/07/18	FOR SSD	JT	BG	
C	31/07/18	FOR SSD	JT	BG	
D	06/08/18	FOR SSD	JT	BG	
E	09/09/18	FOR SSD	JT	BG	
F	30/11/18	FOR SSD	CC	BG	

LEGEND

- STAGE 1 BOUNDARY
- NATIVE ENDEMIC CANOPY TREE PLANTING WITHIN LANDSCAPE BUFFER ZONES AND TO INTERNAL ESTATE
- MIX OF NATIVE SHRUB PLANTING
- MIX OF NATIVE GRASSES AND GROUNDCOVERS
- PLANTING CODES (REFER TO PLANT SCHEDULE SSD-08)

NOTE:

This planting plan has been included in this SSD submission to demonstrate that a buffer zone will be incorporated to the northern boundary. Final details of buffer zone to be submitted as part of Future Expansion and associated vacant lot works.



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granted on the 5/9/19

Signed [Signature]

Sheet No. 19 of 33

FUTURE EXPANSION LANDSCAPING

FUTURE EXPANSION

FUTURE VACANT LOT

NORTHERN FUTURE BUFFER ZONE REFER TO SSD-06

NORTHERN FUTURE BUFFER ZONE GRASSES & GROUNDCOVERS : Mix of 2491 MIC sti, 899 SCA aem, 1044 LOM fil, 1044 LOM lon, 1044 LOM mul, 2127 CAR app, 1680 POA lab

NORTHERN FUTURE BUFFER ZONE SHRUBS : Mix of 10 BRE obl, 10 BUR spi, 9 DIL jun, 10 DAV uli

WESTERN BUFFER ZONE GRASSES & GROUNDCOVERS : Mix of 1783 POA lab, 2746VIO hed, 1920 DIA lon, 1920 DIA rev, 2403 CAR app, 2403 THE aus, 2403 DIC rep, 2195 DIC mic

WESTERN BUFFER ZONE REFER TO SSD-06

Potential future slip lane to vacant lot

Drawing Title:
Planting Plan - Future Expansion
DWG No: **SSD-05**


GEO SCAPES
Suite 215, 284 Victoria Av, Chatswood NSW 2067 Ph. (02) 9411 1485
www.geoscapes.com.au
ABN 84 620 205 781 ACN 620 205 781

Architect:
nettletontribe
architecture


Client:
ALTIS
PROPERTY PARTNERS

Scale: 1:500 @ A1
1:1000 @ A3
Date: 30.11.18
Job Number: 180607
Project: 585-649 Marmre Road - Stage 1
Orchard Hills NSW 2748


FOR STATE SIGNIFICANT DEVELOPMENT			
Rev	Date	Description	Checked
A	13/07/18	SSD DRAFT	JH BG
B	27/07/18	FOR SSD	JH BG
C	28/07/18	FOR SSD	JH BG
D	08/08/18	FOR SSD	JH BG
E	09/08/18	FOR SSD	JH BG
F	30/11/18	FOR SSD	CC BG

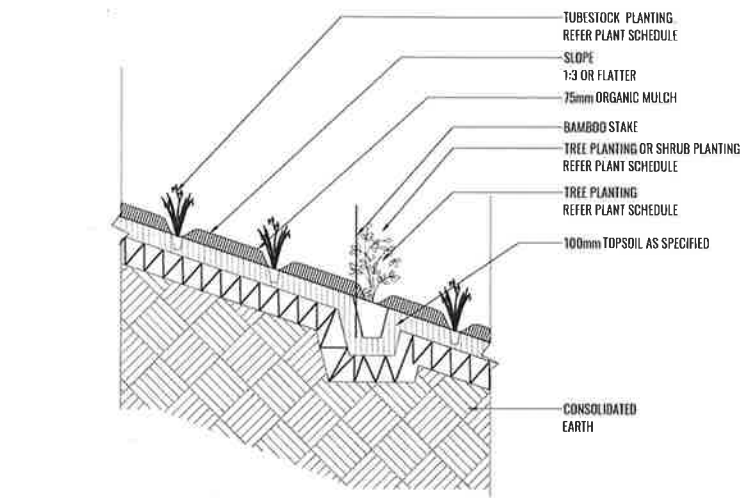


1 TYPICAL TUBESTOCK PLANTING DETAIL ON 1:30 GRADE OR FLATTER
SCALE 1:20

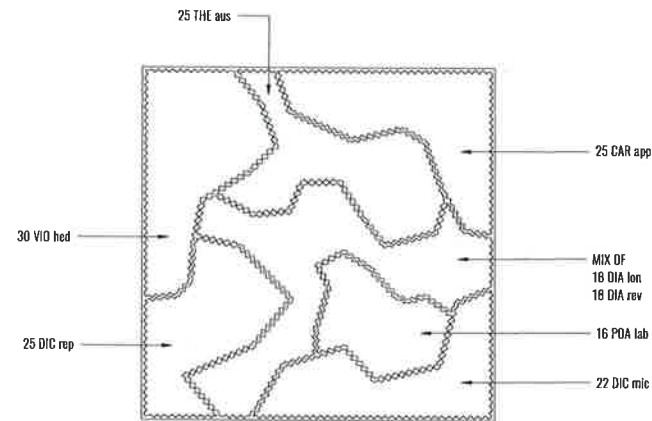


5 NATIVE GRASSES & GROUNDCOVERS MATRIX A
TYPICAL GRASSES & GROUNDCOVERS 5M X 5M
SCALE 1:50

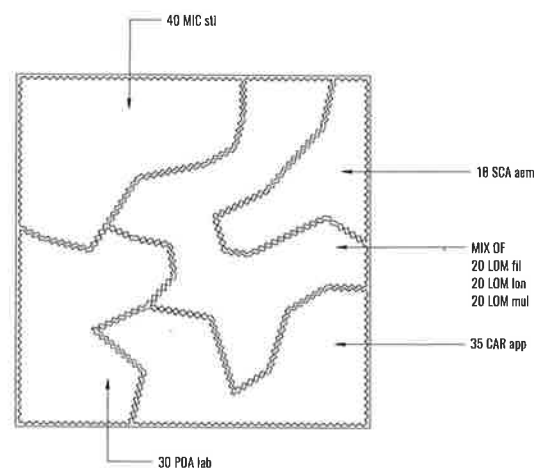


6 NATIVE GRASSES & GROUNDCOVERS MATRIX B
TYPICAL GRASSES & GROUNDCOVERS 5M X 5M
SCALE 1:50

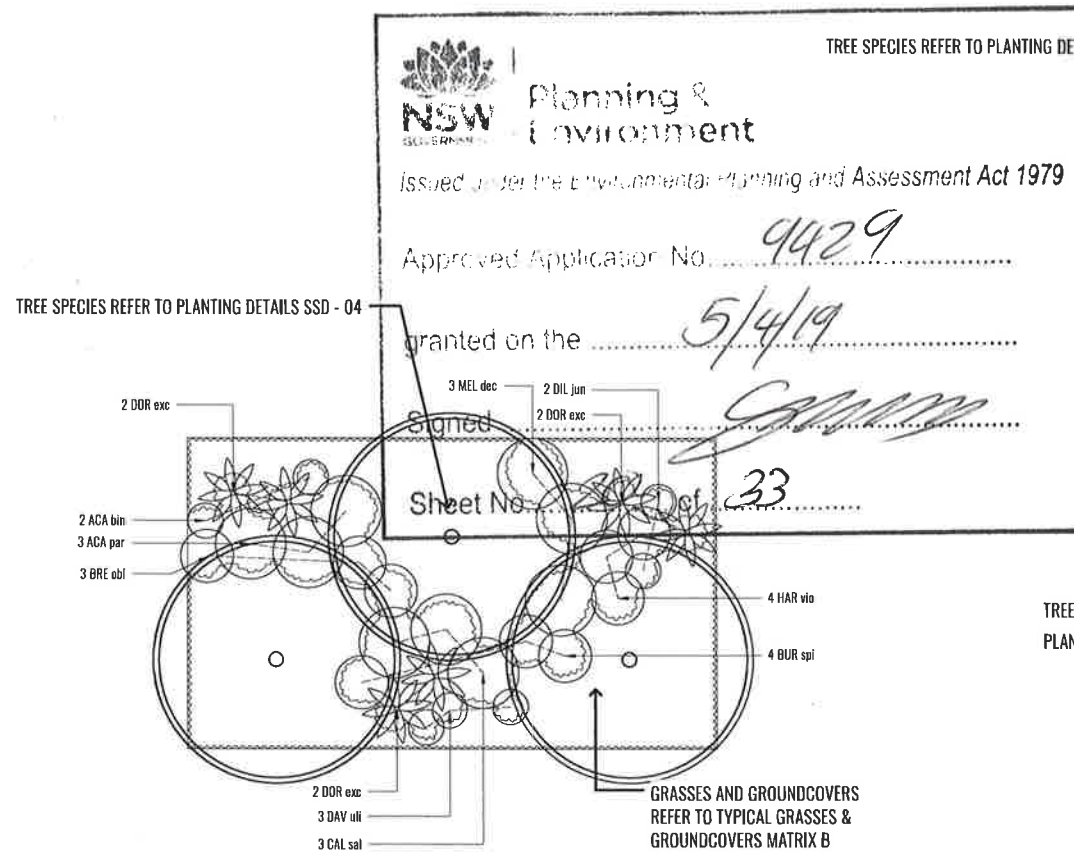


2 SOUTHERN BUFFER ZONE
TYPICAL BUFFER ZONE 8.8M X 15M
SCALE 1:100

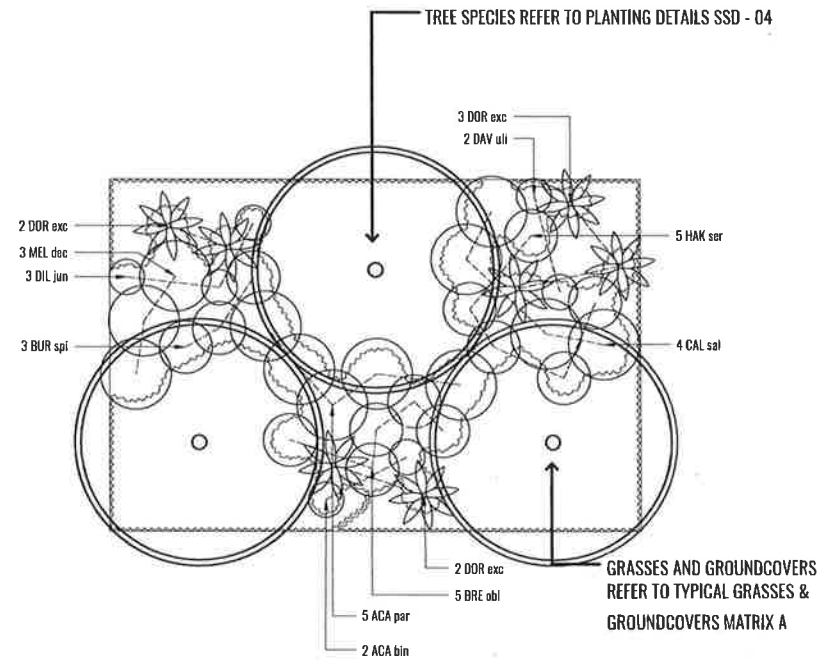

7 WESTERN BUFFER ZONE
TYPICAL BUFFER ZONE 10M X 15M
SCALE 1:100

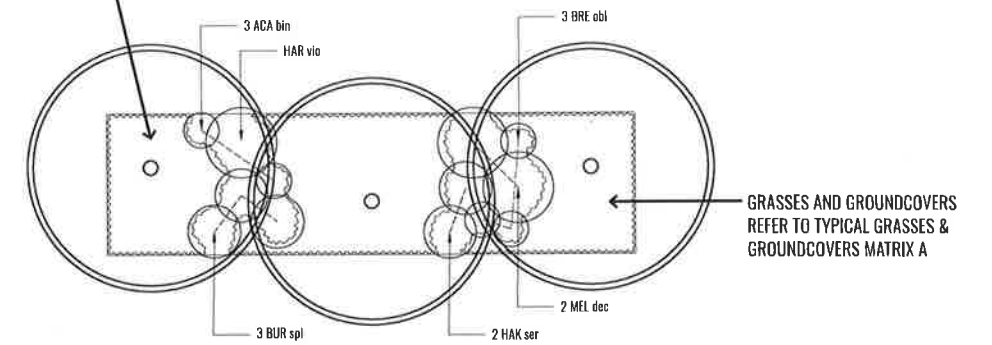


3 EASTERN BUFFER ZONE
TYPICAL BUFFER ZONE 4M X 15M
SCALE 1:100

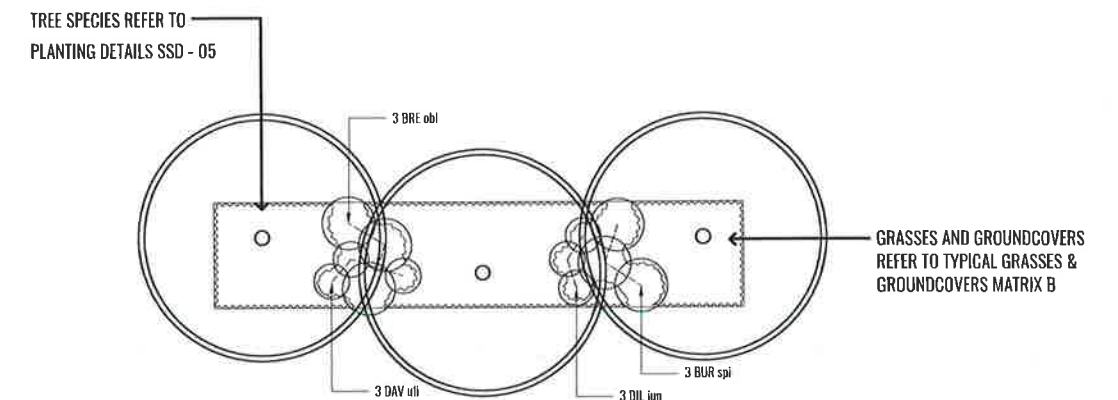

4 NORTHERN FUTURE BUFFER ZONE
TYPICAL BUFFER ZONE 3M X 15M
SCALE 1:100

TREE/SHRUB SIZE AND QUALITY TO BE TO NATSPEC STANDARD. SPECIES IS TO BE AS PER PLAN AND PLANT SCHEDULE. ENSURE ONLY HEALTHY AND VIGOROUS, DISEASE FREE, WELL MAINTAINED PLANTS ARE USED. TAKE CARE TO ENSURE FOLIAGE, BRANCHES, TRUNKS AND ROOT CROWNS ARE NOT DAMAGED BEFORE, DURING AND AFTER PLANTING. ENSURE OPTIMUM MAINTENANCE AND ESTABLISHMENT OF TREES/SHRUBS OCCURS AS SOON AS THEY ARE AT SITE.

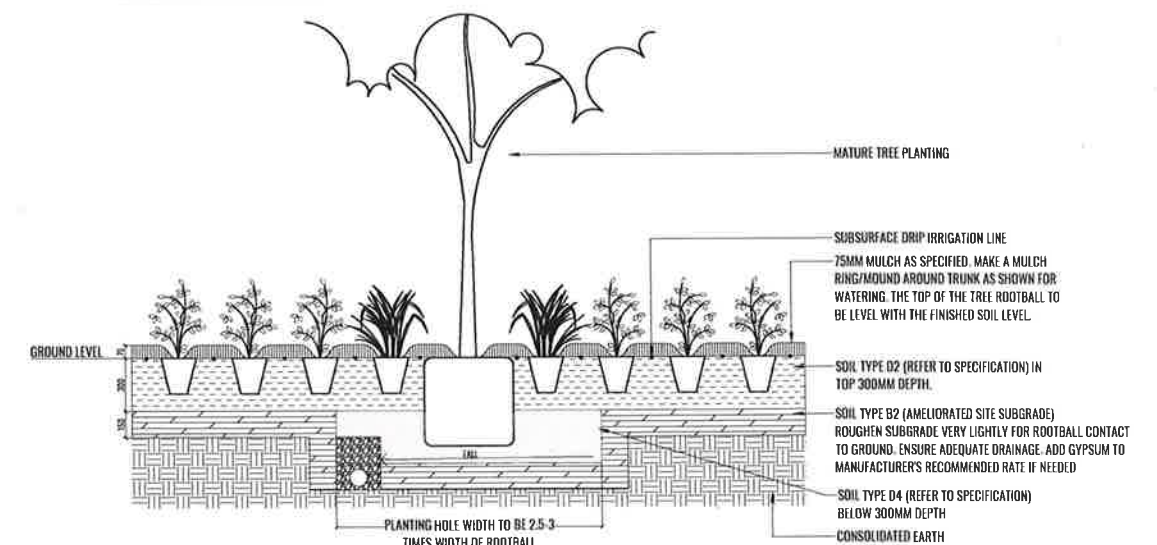

THOROUGHLY SOAK THE ROOTBALL OF TREE WITH FRESH WATER BEFORE TAKING OFF POT OR BAG. WHEN PLANTING HOLE IS COMPLETE USE A SHARP SPADE TO SHAVE OFF 20-50MM OF THE SIDES AND BASE OF ROOTBALL (TO ROOT PRUNE IT) BEFORE CAREFULLY PLACING INTO PLANTING HOLE. IF NORTH IS MARKED ON THE TREE, ENSURE ORIENTATION IS CORRECT WITH NORTH MARKING TO THE NORTH.

- REMOVE ANY STAKES, TIES AND LABELS. WATER ROOTBALL THOROUGHLY.
- TOP OF ROOTBALL TO FINISH FLUSH WITH TOP OF SOIL.

8 SEMI MATURE MASS PLANTING TYPICAL DETAIL
SCALE 1:20

Drawing Title:
Typical Planting Details
DWG No:

SSD-06

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ABN 84 620 205 781 ACN 620 205 781

Architect:

nettletontribe
architecture

Client:

ALTIS
PROPERTY PARTNERS

Scale: AS SHOWN Date: 30.11.18 Job Number: 180607 North: N/A
Project: 585-649 Marmre Road - Stage 1 Orchard Hills NSW 2748

Revision		FOR STATE SIGNIFICANT DEVELOPMENT			
Rev	Date	Description	Drawn	Checked	
A	15/01/18	SSD DRAFT	JT	BG	
B	27/01/18	FOR SSD	JT	BG	
C	31/01/18	FOR SSD	JT	BG	
D	06/08/18	FOR SSD	JT	BG	
E	05/09/18	FOR SSD	JT	BG	
F	30/11/18	FOR SSD	CC	BG	

General

Maintenance shall mean the care and maintenance of the landscape works by accepted horticultural practice as rectifying any defects that become apparent in the landscape works under normal use. The landscape contractor shall attend the site on a weekly basis to maintain the landscape works for the term of the maintenance period commencing from practical completion.

Standards

All grown or purchased plant stock must conform to all the conditions and requirements given in NATSPEC Guide: Specifying Trees. Soils to be in accordance with AS4419, mulching composts and conditioners to be in accordance with AS4454. Soils should conform to best practice specifications as listed in the Landscape Soils Handbook (Simon Leake & Elke Haege 2017).

Rubbish Removal

During the term of the maintenance period the Landscape Contractor shall undertake rubbish removal from the site on a weekly basis to ensure the site remains in tidy condition.

Weed Eradication

Weed growth that may occur in grassed, planted or mulched areas is to be removed using environmentally acceptable methods i.e. non-residual glyphosate herbicide (e.g. 'Roundup', applied in accordance with the manufacturer's directions).

Tree Replacement

Trees shall show signs of healthy vigorous growth and be free from disease and not exhibit signs of stress prior to handover to the client. Any trees or plant that die or fail to thrive, or are damaged or stolen will be replaced. Replacement material shall have the maintenance period extended in accordance with the landscape contract conditions. Trees and plant materials shall be equal to the minimum requirements of species specified and approved material delivered to site. Should the condition decline from the approved sample the Superintendent reserves the right to reject the tree / plants.
Frequency: as required.

Stakes

Adjust and/or replace stakes and ties where required. Remove staking and guying when instructed by the Superintendent

Pruning

Selective pruning may be required during the establishment period to promote a balanced canopy structure. These activities shall be carried out to the best horticultural and industry practice. All pruned material is to be removed from site.

Mulched Surfaces

All planter beds and garden areas shall have a minimum depth of 75mm Forest Fines mulch. All mulch is to be free of deleterious matter such as soil, weeds and sticks.
Mulched surfaces are to be kept clean and tidy and free of any deleterious material and foreign matter. Reinstate depths to a uniform level of 75mm with mulch as specified, mulch to be free of any wood material impregnated with CCA or similar toxic treatment. Top up mulch levels prior to handover to client.

Watering

Implement an appropriate hand watering regime in areas not irrigated in association with current watering programme to maintain plant health and vigour. The program shall reflect seasonal conditions and plant species.
Frequency: Weekly or as required.

Soil


Non-Australian native garden beds to have soil installed consisting of 50% existing site topsoil and 50% new topsoil equal or equivalent to 'Organic Garden Mix' as supplied by Australian Native Landscapes. Australian native garden beds to have soil installed consisting of 50% existing site topsoil and 50% new topsoil equal or equivalent to 'Native Low 'P' Mix' as supplied by Australian Native Landscapes. All garden bed areas to have minimum 300mm depth topsoil, 100mm depth to turf areas.

Pest and Disease Control

The Landscape Contractor shall spray for pests and disease infestations when the pest and fungal attack has been positively identified and when their populations have increased to a point that will become detrimental to plant growth. Apply all pesticides to manufacturer's directions.
Frequency: weekly inspection

Fertilising

Generally check for signs of nutrient deficiencies (yellowing of leaves, failure to thrive), and adapt fertiliser regime to suit. Fertiliser should be applied at the beginning and the end of the (summer) growing season.



NSW
GOVERNMENT


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to plant growth. Apply all pesticides to

Approved Application No. 9429

granted on the 5/4/19

Signed 

Sheet No. 21 of 33

Landscape Buffer Zone Planting						
CODE	BOTANICAL NAME	COMMON NAME	MATURE HEIGHT	NATIVE	ENDEMIC	*QUANTITY
Trees						
ACA IMP	<i>Acacia implexa</i>	Hickory Wattle	5-12m	✓	✓	17
BAC MYR	<i>Backhousia myrtifolia</i>	Grey Myrtle	7m	✓	✓	12
CAS CUN	<i>Casuarina cunninghamiana</i>	River She Oak	12-35m	✓	✓	33
CAS GLA	<i>Casuarina glauca</i>	Swamp Oak	10m	✓	✓	13
EUC CRE	<i>Eucalyptus crebra</i>	Narrow-leaved Ironbark	12-18m	✓	✓	24
EUC EUG	<i>Eucalyptus eugenoides</i>	Thin-leaved Stringybark	20-30m	✓	✓	25
EUC MOL	<i>Eucalyptus moluccana</i>	Grey Box	18-20m	✓	✓	28
EUC TER	<i>Eucalyptus tereticornis</i>	Forest Red Gum	20-30m	✓	✓	19
EXO CUP	<i>Exocarpos cupressiformis</i>	Native Cherry	8m	✓	✓	12
LEP POL	<i>Leptospermum polygalifolium</i>	Yellow Tea-tree	7m	✓	✓	12
PIT REV	<i>Pittosporum revolutum</i>	Rough Fruit Pittosporum	3m	✓	✓	24
Shrubs						
ACA bin	<i>Acacia binervia</i>	Coast Myall	2m	✓	✓	41
ACA par	<i>Acacia parramattensis</i>	Parramatta wattle	2-15m	✓	✓	85
BRE obl	<i>Breynia oblongifolia</i>	Common Breynia	3m			103
BUR spi	<i>Bursaria spinosa</i>	Boxthorn	4m	✓	✓	62
CAL sal	<i>Callistemon salignus</i>	Willow Bottlebrush	1-10m	✓	✓	22
DAV uli	<i>Daviesia ulicifolia</i>	Gorse Bitter-pea	2m	✓	✓	55
DIL jun	<i>Dillwynia juniperina</i>	Prickly parrot pea	0.5-2.5m	✓	✓	55
DOR exc	<i>Doryanthes excelsa</i>	Gynea Lily	3m	✓	✓	85
HAK ser	<i>Hakea sericea</i>	Hakea sericea	4-5m	✓	✓	94
HAR vio	<i>Hardenbergia violacea</i>	Hardenbergia	6m	✓	✓	36
MEL dec	<i>Melaleuca decora</i>	White Feather Honey Myrtle	7m	✓	✓	64
Grasses, Groundcovers and Herbs						
CAR app	<i>Carex appressa</i>	Tall Sedge	1m	✓	✓	7008
DIA lon	<i>Dianella longifolia</i>	Smooth flax lily	1m	✓	✓	2575
DIA rev	<i>Dianella revoluta</i>	Blue Flax-lily, Spreading Flax-lily	1m	✓	✓	2370
DIC mic	<i>Dichelachne micrantha</i>	Short-haired Plume Grass	1.2m	✓	✓	2740
DIC rep	<i>Dichondra repens</i>	Kidney-weed, Mercury Bay Weed	0.2m	✓	✓	2403
LOM fil	<i>Lomandra filiformis</i>	Wattle Mat Rush	0.5m	✓	✓	2744
LOM lon	<i>Lomandra longifolia</i>	Spiny Mat Rush	0.8m	✓	✓	2744
LOM mul	<i>Lomandra multiflora</i>	Many-flowered Mat-rush	0.9m	✓	✓	2444
MIC sti	<i>Microlaena stipoides</i>	Weeping Grass, Meadow Rice-grass	1m	✓	✓	3834
POA lab	<i>Poa labillardieri</i>	Tussock Poa	1.2m	✓	✓	5497
SCA aem	<i>Scaevola aemula</i>	Fan Flower	0.5m	✓	✓	2039
THE aus	<i>Themeda australis</i>	Kangaroo Grass	1m	✓	✓	3073
VIO hed	<i>Viola hederacea</i>	Ivy-leaved Violet	0.3m	✓	✓	3271

* Total final numbers to be determined at CC stage

Indicative Carpark and Internal Estate Schedule					
CODE	BOTANICAL NAME	COMMON NAME	MATURE HEIGHT	NATIVE	ENDEMIC
Trees					
EUC FIB	<i>Eucalyptus fibrosa</i>	Red Ironbark	12-18m	✓	✓
EUC MOL	<i>Eucalyptus moluccana</i>	Grey Box	12-18m	✓	✓
TRI LAU	<i>Tristanopsis laurina</i>	Water Gum	6-8m	✓	✓
Shrubs					
ACA dec	<i>Acacia decurrens</i>	Sydney Green Wattle	3-10m	✓	✓
ACA fal	<i>Acacia falcata</i>	Sickle Wattle	5m	✓	✓
ACM smi	<i>Acmena smithii</i>	Lilly-pilly	1.8m (Hedging)	✓	✓
BAN ser	<i>Banksia serrata</i>	Old Man Banksia	3m	✓	✓
CAL sal	<i>Callistemon salignus</i>	Willow Bottlebrush	1m	✓	✓
CAL sp	<i>Callistemon sp.</i>	Scarlet Bottlebrush	4m	✓	✓
DOR exc	<i>Doryanthes excelsa</i>	Gynea Lily	3m	✓	✓
GRE jun	<i>Grevillea juniperina</i>	Grevillea	1.5m	✓	✓
PIT rev	<i>Pittosporum revolutum</i>	Rough Fruit Pittosporum	3m	✓	✓
WES fru	<i>Westringia fruticosa</i>	Coastal Rosemary	1.5m	✓	✓
Groundcovers					
DIA lon	<i>Dianella longifolia</i>	Flax-lily	1m	✓	✓
DIA rev	<i>Dianella revoluta</i>	Blue Flax-lily, Spreading Flax-lily	1m	✓	✓
DIC rep	<i>Dichondra repens</i>	Kidney-weed, Mercury Bay Weed	0.2m	✓	✓
HAR vio	<i>Hardenbergia violacea</i>	False Sarsaparilla	0.5m	✓	✓
LOM lon	<i>Lomandra longifolia</i>	Spiny-headed Mat-rush	1m	✓	✓
VIO hed	<i>Viola hederacea</i>	Native Violet	0.2m	✓	✓

granted on the 5/4/19

Signed [Signature]

Sheet No. 22 of 33



Eucalyptus moluccana



Eucalyptus tereticornis



Acacia implexa



Eucalyptus crebra



Eucalyptus eugenoides



Eucalyptus fibrosa



Casuarina glauca



Exocarpos cupressiformis



Backhousia myrtifolia



Acacia falcata



Acacia parramattensis



Daviesia ulicifolia



Casuarina cunninghamiana



Hardenbergia violacea



Bursaria spinosa



Breynia oblongifolia



Callistemon salignus



Dillwynia juniperina



Tristanopsis laurina



Acacia binervia



Hakea sericea



Melaleuca decora



Carex appressa



Dianella longifolia



Lomandra filiformis



Doryanthes excelsa



Dianella revoluta



Hibbertia diffusa



Lomandra longifolia



Lomandra multiflora



Microlaena stipoides



Dichondra repens



Poa labillardieri



Scaevola aemula



Viola hederacea



Dichelachne micrantha

Drawing Title:
Planting Schedule & Images

DWG No: **SSD-08**

GEOSCAPES
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Architect:

nettletontribe
architecture

Client:

ALTIS
PROPERTY PARTNERS

Scale:

N/A

Date:

30.11.18

Job Number:

180607

North:

N/A

Project:

585-649 Marmre Road - Stage 1
Orchard Hills NSW 2748

Revision

Rev	Date	Description	Drawn	Checked
A	13/07/18	SSD FORM 1	JT	BG
B	27/07/18	FOR SSD	JT	BG
C	31/07/18	FOR SSD	JT	BG
D	06/08/18	FOR SSD	JT	BG
E	09/08/18	FOR SSD	JT	BG
F	30/11/18	FOR SSD	CC	BG

FOR STATE SIGNIFICANT DEVELOPMENT

SNACKBRANDS, LOT 7, FIRST ESTATE, MAMRE ROAD, ORCHARD HILLS

CONCEPT STORMWATER MANAGEMENT

SITE WORKS - GENERAL

1. ALL WORKS ARE TO BE UNDERTAKEN IN ACCORDANCE WITH LOCAL COUNCIL, AUSTRALIAN AND AUTHORITY STANDARDS.
2. ALL TRENCHING WORKS ARE TO BE RESTORED TO ORIGINAL CONDITION.
3. THE INTEGRITY OF ALL EXISTING AND NEW SERVICES IS TO BE MAINTAINED THROUGHOUT THE CONSTRUCTION PERIOD.
4. ALL PLANS ARE TO BE READ IN CONJUNCTION WITH APPROVED ARCHITECTS, STRUCTURAL ENGINEERS AND OTHER CONSULTANT'S PLANS. ANY DISCREPANCIES ARE TO BE NOTIFIED TO THE ENGINEER FOR CLARIFICATION.

SEDIMENT AND EROSION CONTROL

1. THE CONTRACTOR SHALL INSTIGATE ALL SEDIMENT AND EROSION CONTROL MEASURES IN ACCORDANCE WITH PENRITH CITY COUNCIL REQUIREMENTS AND THE "BLUE BOOK" (MANAGING URBAN STORMWATER SOILS AND CONSTRUCTION, PRODUCED BY THE DEPARTMENT OF HOUSING). THESE MEASURES ARE TO BE REGULARLY INSPECTED AND MAINTAINED.
2. THE SEDIMENT & EROSION CONTROL PLAN PRESENTS CONCEPTS ONLY. THE CONTRACTOR SHALL AT ALL TIMES BE RESPONSIBLE FOR THE ESTABLISHMENT & MANAGEMENT OF A DETAILED SCHEME MEETING COUNCIL'S DESIGN, AND ALL OTHER REGULATORY AUTHORITY REQUIREMENTS.
3. WHERE PRACTICAL, THE SOIL EROSION HAZARD ON THE SITE SHALL BE KEPT AS LOW AS POSSIBLE. TO THIS END, WORKS SHOULD BE UNDERTAKEN IN THE FOLLOWING SEQUENCE:
 - a. INSTALL ALL TEMPORARY SEDIMENT FENCES AND BARRIER FENCES WHERE FENCES ARE ADJACENT TO EACH OTHER THE SEDIMENT FENCE CAN BE INCORPORATED INTO THE BARRIER FENCE.
 - b. CONSTRUCT TEMPORARY STABILISED SITE ACCESS, INCLUDING SHAKE DOWN AND WASH PAD.
 - c. INSTALL SEDIMENT CONTROL MEASURES AS OUTLINED ON THESE SEDIMENT AND CONTROL PLANS (ONCE APPROVED).
4. THE CONTRACTOR SHALL UNDERTAKE SITE DEVELOPMENT WORKS SO THAT LAND DISTURBANCE IS CONFINED TO AREAS OF MINIMUM WORKABLE SIZE.
5. AT ALL TIMES AND IN PARTICULAR DURING WINDY AND DRY WEATHER, LARGE, UNPROTECTED AREAS WILL BE KEPT MOIST (NOT WET) BY SPRINKLING WITH WATER TO KEEP DUST UNDER CONTROL. TACIFIERS MAY BE USED TO CONTROL DUST DURING EXTENDED PERIODS OF DRY WEATHER.
6. ANY SAND USED IN THE CONCRETE CURING PROCESS (SPREAD OVER THE SURFACE) SHALL BE REMOVED AS SOON AS POSSIBLE AND WITHIN 10 WORKING DAYS FROM PLACEMENT.
7. WATER SHALL BE PREVENTED FROM ENTERING THE PERMANENT DRAINAGE SYSTEM UNLESS THE CATCHMENT AREA HAS BEEN STABILISED AND/OR ANY LIKELY SEDIMENT HAS BEEN FILTERED OUT.
8. TEMPORARY SOIL AND WATER MANAGEMENT STRUCTURES SHALL BE REMOVED ONLY AFTER THE LANDS THEY ARE PROTECTING ARE STABILISED / REHABILITATED.
9. THE CONTRACTOR SHALL ALLOW FOR THE ESTABLISHMENT OF ANY OTHER EROSION PROTECTION MEASURES (IF APPLICABLE).
10. THE CONTRACTOR SHALL REGULARLY INSPECT (MINIMUM TWICE PER WEEK) ALL EROSION AND SEDIMENT CONTROL MEASURES TO ENSURE THEY ARE OPERATING EFFECTIVELY, REPAIRS AND/OR MAINTENANCE SHALL BE UNDERTAKEN REGULARLY AND AS REQUIRED, PARTICULARLY FOLLOWING STORM EVENTS.
11. ACCEPTABLE RECEPTORS SHALL BE USED FOR CONCRETE AND MORTAR SLURRIES, PAINTS, ACID WASHINGS, LIGHT-WEIGHT WASTE MATERIALS AND LITTER. WASTE FROM THESE RECEPTORS SHALL BE DISPOSED OF IN ACCORDANCE WITH REGULATORY AUTHORITY REQUIREMENTS. PAY ALL FEES AND PROVIDE EVIDENCE OF SAFE DISPOSAL.

SITE WORKS - ACCESS AND SAFETY

1. ALL WORKS ARE TO BE UNDERTAKEN IN A SAFE MANNER IN ACCORDANCE WITH ALL STATUTORY AND INDUSTRIAL RELATION REQUIREMENTS.
2. ACCESS TO ADJACENT BUILDINGS AND PROPERTIES SHALL BE MAINTAINED AT ALL TIMES.
3. WHERE NECESSARY SAFE PASSAGE SHALL BE PROVIDED FOR VEHICLES AND PEDESTRIANS THROUGH OR ADJACENT TO THE SITE.

STORMWATER

1. ALL WORKS ARE TO BE UNDERTAKEN IN ACCORDANCE WITH THE FOLLOWING AUSTRALIAN STANDARDS AS2032, AS3500 AND AS3725 AS A MINIMUM.
2. ALL PIPES LESS THAN OR EQUAL TO Ø300mm IN SIZE ARE TO BE SOLVENT WELD-JOINTED UPVC CLASS SNG U.N.O.
3. ALL PIPES Ø375mm OR GREATER IN SIZE ARE TO BE MIN. CLASS 2 REINFORCED CONCRETE PIPE (RCP) WITH SPIGGOT AND SOCKETED JOINT OR VANTAGE PIPE PLUS (VPIPE-) FIBRE REINFORCED CONCRETE (FRC) WITH VANTAGE PIPE PLUS JOINT U.N.O.
4. ALL PIPES ARE TO BE LAID AT MIN. 1.0% GRADE U.N.O.
5. PIPE BEDDING IS TO BE H52 UNDER ROADS AND TRAFFICKED AREAS AND SHALL BE H2 IN LANDSCAPED AND PEDESTRIAN TRAFFICKED AREAS U.N.O.
6. ALL PIPE BENDS AND JUNCTIONS ARE TO BE MADE WITH EITHER PURPOSE MADE FITTINGS OR STORMWATER DRAINAGE PITS.
7. MINIMUM COVER FROM THE OVERTOP OF THE STORMWATER PIPE OF 300mm IS TO BE PROVIDED IN LANDSCAPED AREAS AND 600mm IN VEHICULAR TRAFFICKED AREAS U.N.O.
8. WHERE MINIMUM COVER CANNOT BE ACHIEVED CONCRETE ENCASEMENT OF THE AFFECTED PIPE IS MAY BE UNDERTAKEN WITH 70MPa CONCRETE WITH A MIN. COVER OF 150mm TO ALL SIDES OF THE PIPE. THE CONTRACTOR SHALL CONFIRM THIS REQUIREMENT WITH THE ENGINEER OR SUPERINTENDENT.
9. LAID PIPELINES ARE TO HAVE THE FOLLOWING CONSTRUCTED TOLERANCES:
 - a. HORIZONTAL-1:300 ANGULAR DEVIATION FROM REQUIRED ALIGNMENT;
 - b. VERTICAL-1:300 ANGULAR DEVIATION FROM REQUIRED ALIGNMENT.
10. ALL DRAINAGE PITS ARE TO BE CAST IN-SITU, PRECAST DRAINAGE PITS MAY BE USED WITH APPROVAL FROM THE ENGINEER. THE CONTRACTOR SHALL SUBMIT A PRECAST PIT INSTALLATION WORK METHOD STATEMENT FOR ASSESSMENT BY THE ENGINEER FOR APPROVAL.
11. DRAINAGE PIT COVERS ARE TO BE EITHER GALVANISED STEEL OR CAST IRON CLASS 'B' IN LANDSCAPED AND PEDESTRIAN TRAFFICKED AREAS AND CLASS 'D' IN ALL VEHICULAR TRAFFICKED AREAS U.N.O.
12. DRAINAGE PIT COVERS ARE TO BE 'HEELSAFE' TYPE IN ALL PEDESTRIAN TRAFFICKED AREAS U.N.O.
13. EXISTING STORMWATER PIT LOCATIONS AND INVERT LEVELS TO BE CONFIRMED PRIOR TO COMMENCING WORK.
14. PROVIDE CLEANING EYES (RODDING POINTS) AT ALL CORNERS AND T-JUNCTIONS WHERE NO PITS ARE PROVIDED AT GROUND LEVEL.
15. DOWN PIPES CONNECTED DIRECT TO PIPES TO BE CONNECTED TO THE FLOW DIRECTION WITH A CLEANING EYE PROVIDED AT GROUND LEVEL.

FINISHED LEVELS

1. LEVELS BASED ON ESTATE INFRASTRUCTURE PLANS PREPARED BY COSTINROE CONSULTING, Ref: 12042.00 & SURVEY PREPARED BY BOXALL SURVEYORS Ref: 10116. THE CONTRACTOR SHALL VERIFY LEVELS PRIOR TO CONSTRUCTION COMMENCEMENT, ANY DISCREPANCIES SHALL BE NOTIFIED TO THE ENGINEER OR SUPERINTENDENT FOR CLARIFICATION.
2. FINISHED LEVELS SHOWN ARE CONCEPTUAL ONLY AND SUBJECT TO DETAILED DESIGN PRIOR TO CONSTRUCTION CERTIFICATE APPLICATION. FINAL FINISHED LEVELS TO BE +/- 0.5m FROM LEVELS SHOWN.
3. CARPARK & SERVICE AREA LAYOUT AND GRADES TO COMPLY WITH AS2890.
4. DRIVEWAY LAYOUT AND DESIGN TO COMPLY WITH PENRITH CITY COUNCIL ACCESS DRIVEWAY DESIGN AND CONSTRUCTION SPECIFICATION.
5. ALL CONTOUR LINES & SPOT LEVELS INDICATE FINISHED PAVEMENT LEVELS U.N.O. ON PLAN.
6. PERMANENT BATTER SLOPES ARE TO HAVE A MAXIMUM GRADE OF 1V:3H.
7. ALL FOOTPATHS ARE TO FALL AWAY FROM THE BUILDING AT 2.5% NOMINAL GRADE.
8. ALL PAVEMENTS ARE TO BE SET AT 50mm BELOW THE FINISHED FLOOR LEVEL OF THE WAREHOUSE AND OFFICE AREAS.



LOCALITY PLAN

NOT TO SCALE - SOURCE: NEARMAP

DRAWING SCHEDULE

- DA1.01 COVER SHEET, LOCALITY PLAN AND DRAWING SCHEDULE
- DA2.01 CONCEPT SEDIMENT AND EROSION CONTROL MANAGEMENT PLAN
- DA2.02 CONCEPT SEDIMENT AND EROSION CONTROL DETAILS
- DA4.01 CONCEPT PAVEMENT GRADING & STORMWATER DRAINAGE PLAN SHEET 1
- DA4.02 CONCEPT PAVEMENT GRADING & STORMWATER DRAINAGE PLAN SHEET 2
- DA4.03 CONCEPT PAVEMENT GRADING & STORMWATER DRAINAGE PLAN SHEET 3
- DA4.04 CONCEPT PAVEMENT GRADING & STORMWATER DRAINAGE PLAN SHEET 4
- DA4.05 CONCEPT PAVEMENT GRADING & STORMWATER DRAINAGE PLAN SHEET 5
- DA5.11 CONCEPT TYPICAL SECTIONS SHEET 1
- DA5.12 CONCEPT TYPICAL SECTIONS SHEET 2

NSW Planning & Environment
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Issued under the Environmental Planning and Assessment Act 1979

Approved Application No. 9429

granted on the 5/4/19


Signed [Signature]

Sheet No. 23 of 33

1. DO NOT SCALE OFF THIS DRAWING. USE DIMENSIONS & ARCHITECTURAL DRAWING ONLY.	CHECKED DATE	NORTH POINT	DATE No AMENDMENT	INIT REV	DATE No AMENDMENT	INIT REV	BUILDER	CLIENT	PROJECT
2. DRAWINGS TO BE READ IN CONJUNCTION WITH SPECIFICATION.	APPROVED DATE		31.07.18	SK 1					SNACKBRANDS, LOT 7, FIRST ESTATE, MAMRE ROAD, ORCHARD HILLS
3. LEVELS ARE INDICATIVE ONLY AND ARE TO BE CHECKED PRIOR TO COMMENCEMENT OF ANY WORKS.	PAGE PLOT DATE								
4. AUTHORISED SIGNING AND/OR EXISTING SERVICES ARE TO BE LOCATED AND CHECKED PRIOR TO COMMENCEMENT OF ANY WORKS.	A1 July 31, 2018								
5. COMPLETION OF THE QUALITY RECORD IS EVIDENCE THAT THE DESIGN AND DRAWING HAVE BEEN REVIEWED.	SCALE								
6. VERIFICATION	NOT TO SCALE								
7. COMPLETION OF THE QUALITY RECORD IS EVIDENCE THAT THE DESIGN HAS BEEN VERIFIED AS CONFORMING TO THE REQUIREMENTS OF THE PROJECT QUALITY PLAN.									
8. DRAWING STATUS									
9. FOR INFORMATION ONLY									
10. FOR CLIENT APPROVAL									
11. FOR SIGNATURE									
12. FOR CONSTRUCTION									

DEVELOPER	ARCHITECT	PROJECT
ALTIS Property Partners	hansen yuncken	SSD APPLICATION
		COVER SHEET, LOCALITY PLAN AND DRAWING SCHEDULE

DATE	SCALE	100 No	18146	DA1.01	1
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LEGEND

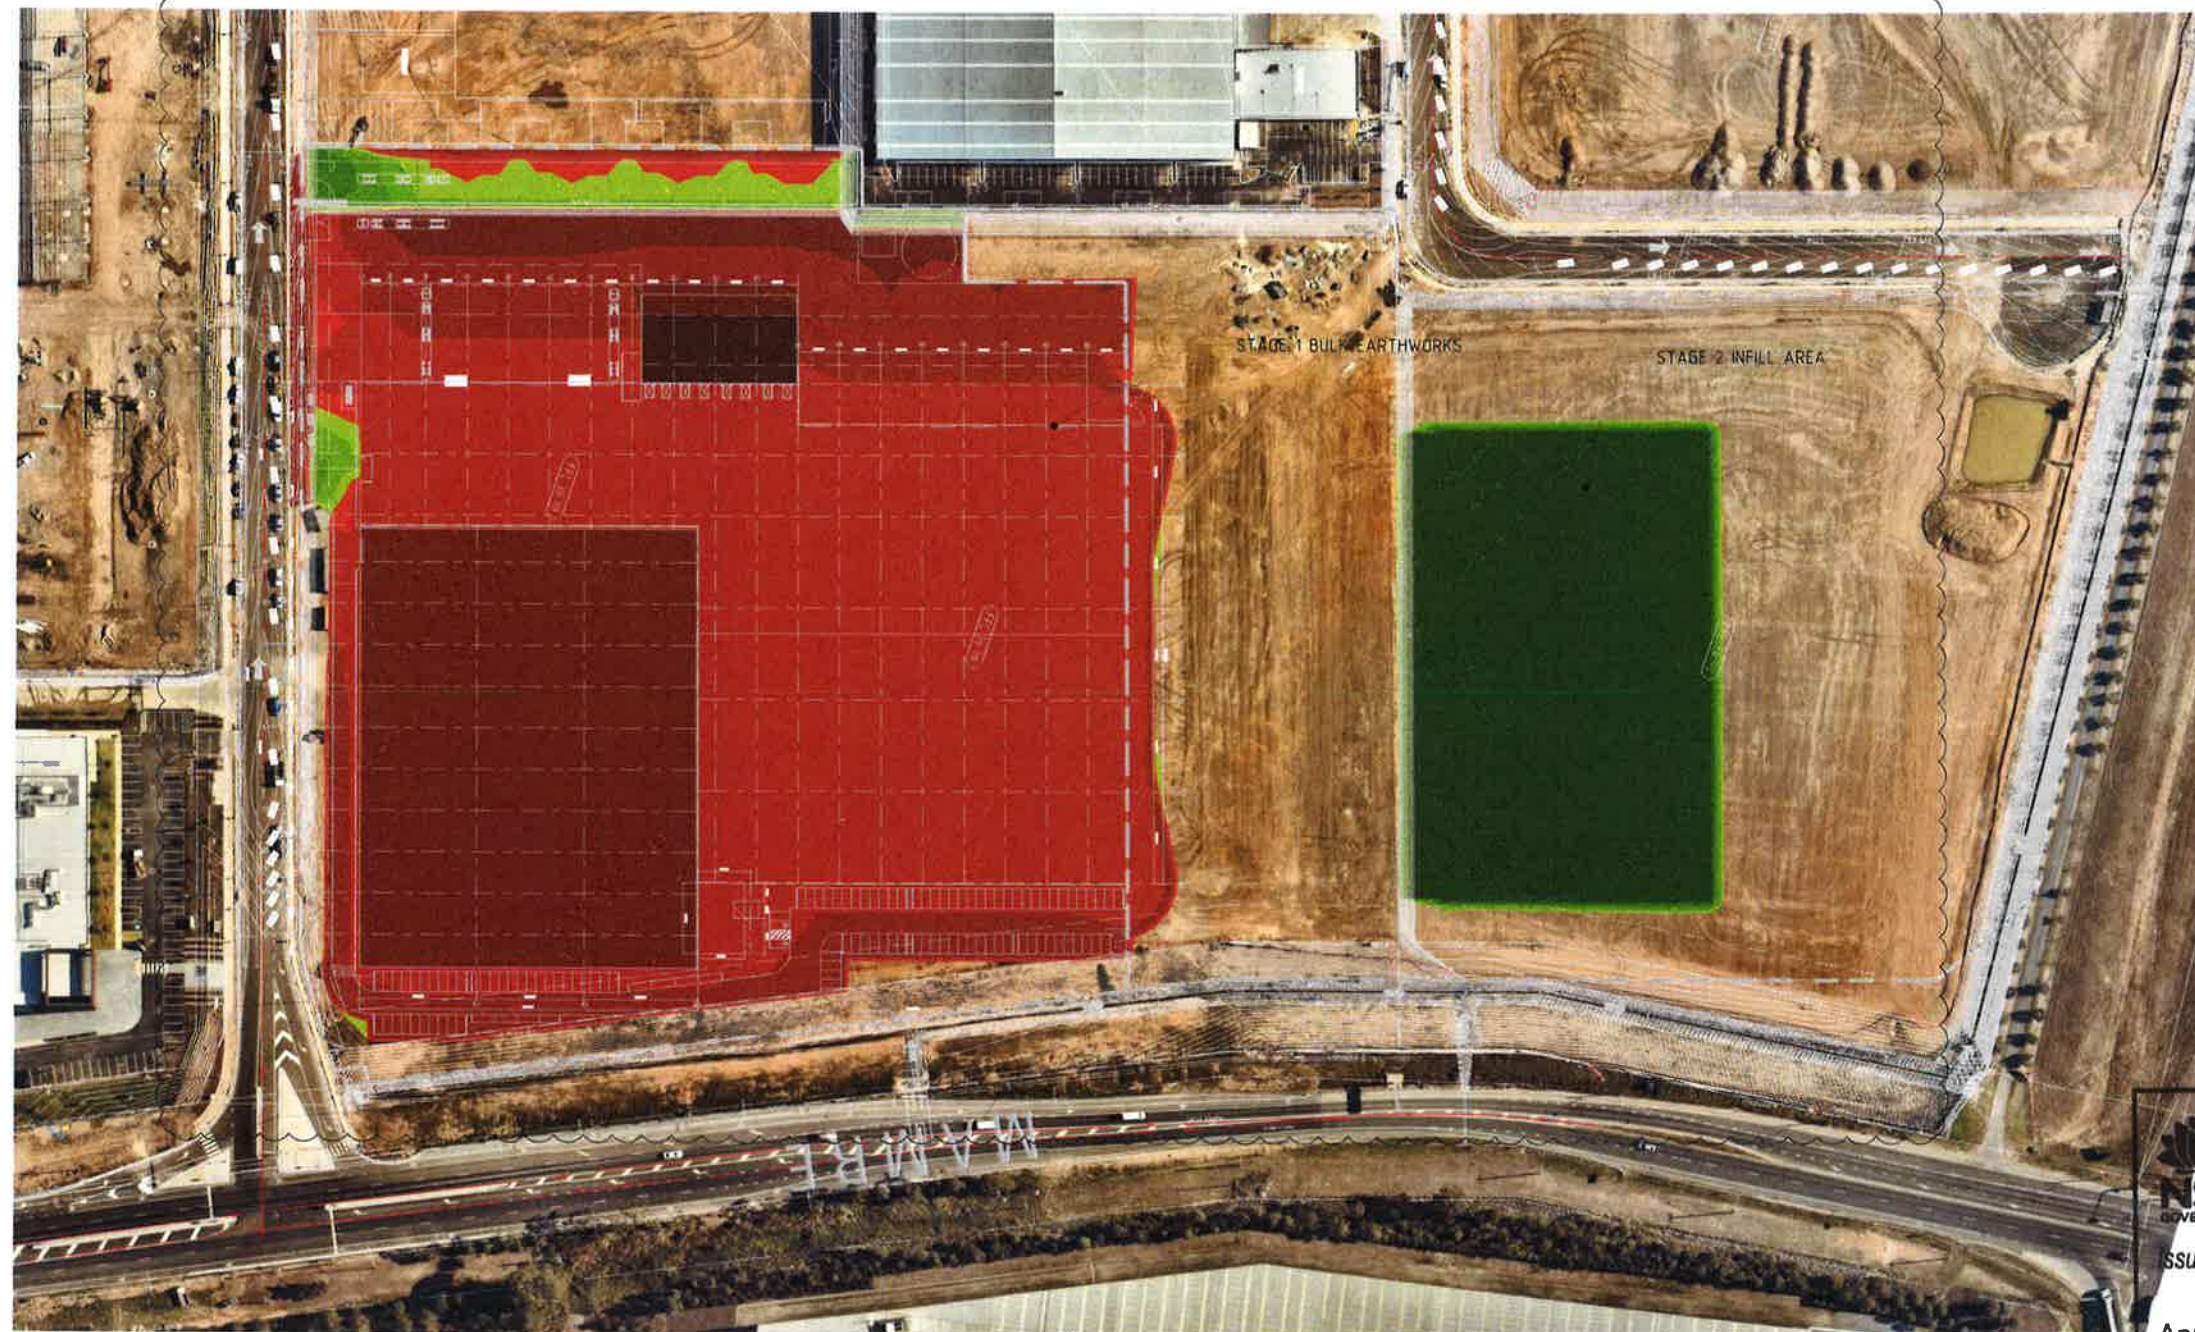CUT:		FILL:	
-5.0 TO -2.5m		0.0 TO 0.1m	
-2.5 TO -1.5m		0.1 TO 0.25m	
-1.5 TO -1.0m		0.25 TO 0.5m	
-1.0 TO -0.75m		0.5 TO 0.75m	
-0.75 TO -0.5m		0.75 TO 1.0m	
-0.5 TO -0.25m		1.0 TO 1.5m	
-0.25 TO -0.1m		1.5 TO 2.5m	
-0.1 TO 0.0m		2.5 TO 5.0m	

NOTES

- CUT TO FILL DEPTHS SHOWN ARE CONCEPTUAL ONLY AND BASED ON LEVELS SHOWN ON ESTATE INFRASTRUCTURE PLANS APPROVED UNDER SSD 15_7173 AS PREPARED BY COSTINROE CONSULTING, REF: 12042.00.
- VOLUMES DETAILED BELOW DO NOT TAKE INTO ACCOUNT BULKING & COMPACTION OF THE MATERIAL, DETAILED EXCAVATION FOR SERVICES TRENCHING & FOUNDATIONS AND BACKFILL FOR RETAINING WALL CONSTRUCTION.

STAGE 1:

CUT - 16,230m³

FILL - 430m³

EXPORT - 15,800m³

STAGE 2:

EXPORT OF 15,800m³ FROM STAGE 1 WORKS TO BE PLACED WITHIN STAGE 2 AREA
- VOLUMES BASED ON THE FOLLOWING PAVEMENT THICKNESSES TAKEN FROM FINISHED SURFACE AS SHOWN ON DA4.01-DA4.05 PLANS.

HARDSTAND PAVEMENT AND SUBBASE = 280mm

CARPARKING PAVEMENT AND SUBBASE = 280mm

BUILDING SLAB AND SUBBASE = 260mm

HIGH BAY BUILDING PAD = 800mm



Planning & Environment

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granted on the 5/9/19

Signed [Signature]


Sheet No. 24 of 33

SSD APPLICATION

1. VERIFY THAT THE DRAWING IS THE LATEST EDITION OF THE DRAWING. 2. DRAWINGS TO BE REVISIONS ONLY AND ARE TO BE CHECKED PRIOR TO COMMENCEMENT OF ANY WORK. 3. LEVELS ARE INDICATED ONLY AND ARE TO BE CHECKED PRIOR TO COMMENCEMENT OF ANY WORK. 4. AUTHORISED MARK AND/OR EXISTING SERVICES ARE TO BE LOCATED AND CHECKED PRIOR TO COMMENCEMENT OF ANY WORK. 5. COMPLETION OF THE QUALITY RECORD IS EVIDENCE THAT THE DESIGN AND DRAWING HAVE BEEN VERIFIED.				CHECKED: _____ DATE: _____ APPROVED: _____ DATE: _____ PAGE: A1 PLOT DATE: October 12, 2018				NORTH POINT 				DATE: 17.08.18 NO: _____ AMENDMENT: ISSUED FOR SSD APPLICATION INIT: MW REV: 1 DATE: 12.10.18 NO: _____ AMENDMENT: ISSUED FOR SSD APPLICATION INIT: SK REV: 2				DATE: _____ NO: _____ AMENDMENT: _____ INIT: _____ REV: _____				DEVELOPER: ALTIS Property Partners				CLIENT: hansen yuncken BUILDING VALUE				PROJECT: SNACKBRANDS, LOT 7, FIRST ESTATE, MAMRE ROAD, ORCHARD HILLS				SPARKS+PARTNERS CONSULTING ENGINEERS HYDRAULIC/CIVIL/FIRE 14/16 1/11 George Street, Parramatta NSW 2150 P 02 9891 5033 F 02 9891 3895 E info@sparkspartners.com.au			
VERIFICATION COMPLETION OF THE QUALITY RECORD IS EVIDENCE THAT THE DESIGN AND DRAWING HAVE BEEN VERIFIED AS COMPLYING TO THE REQUIREMENTS OF THE PROJECT QUALITY PLAN.				THE INFORMATION ON THIS DRAWING REMAINS THE PROPERTY OF SPARKS+PARTNERS CONSULTING ENGINEERS. NO REPRODUCTION OF THE DRAWING OR PART OF THE DRAWING IS PERMITTED WITHOUT THE WRITTEN PERMISSION OF SPARKS+PARTNERS.				SCALE: 1:500 @ A1 0 10 20 30 40 50 60 70 80 METERS				ARCHITECT: nettelton				DRAWING TITLE: SSD APPLICATION CONCEPT BULK EARTHWORKS CUT TO FILL DEPTH PLAN				DATE: _____ DESIGNED: _____ DRAWN: _____ CHECKED: _____ JOB NO: 18146 DWG NO: DA3.05 OF 2															

REFER DA4.02 FOR CONTINUATION

REFER DA4.04 FOR CONTINUATION

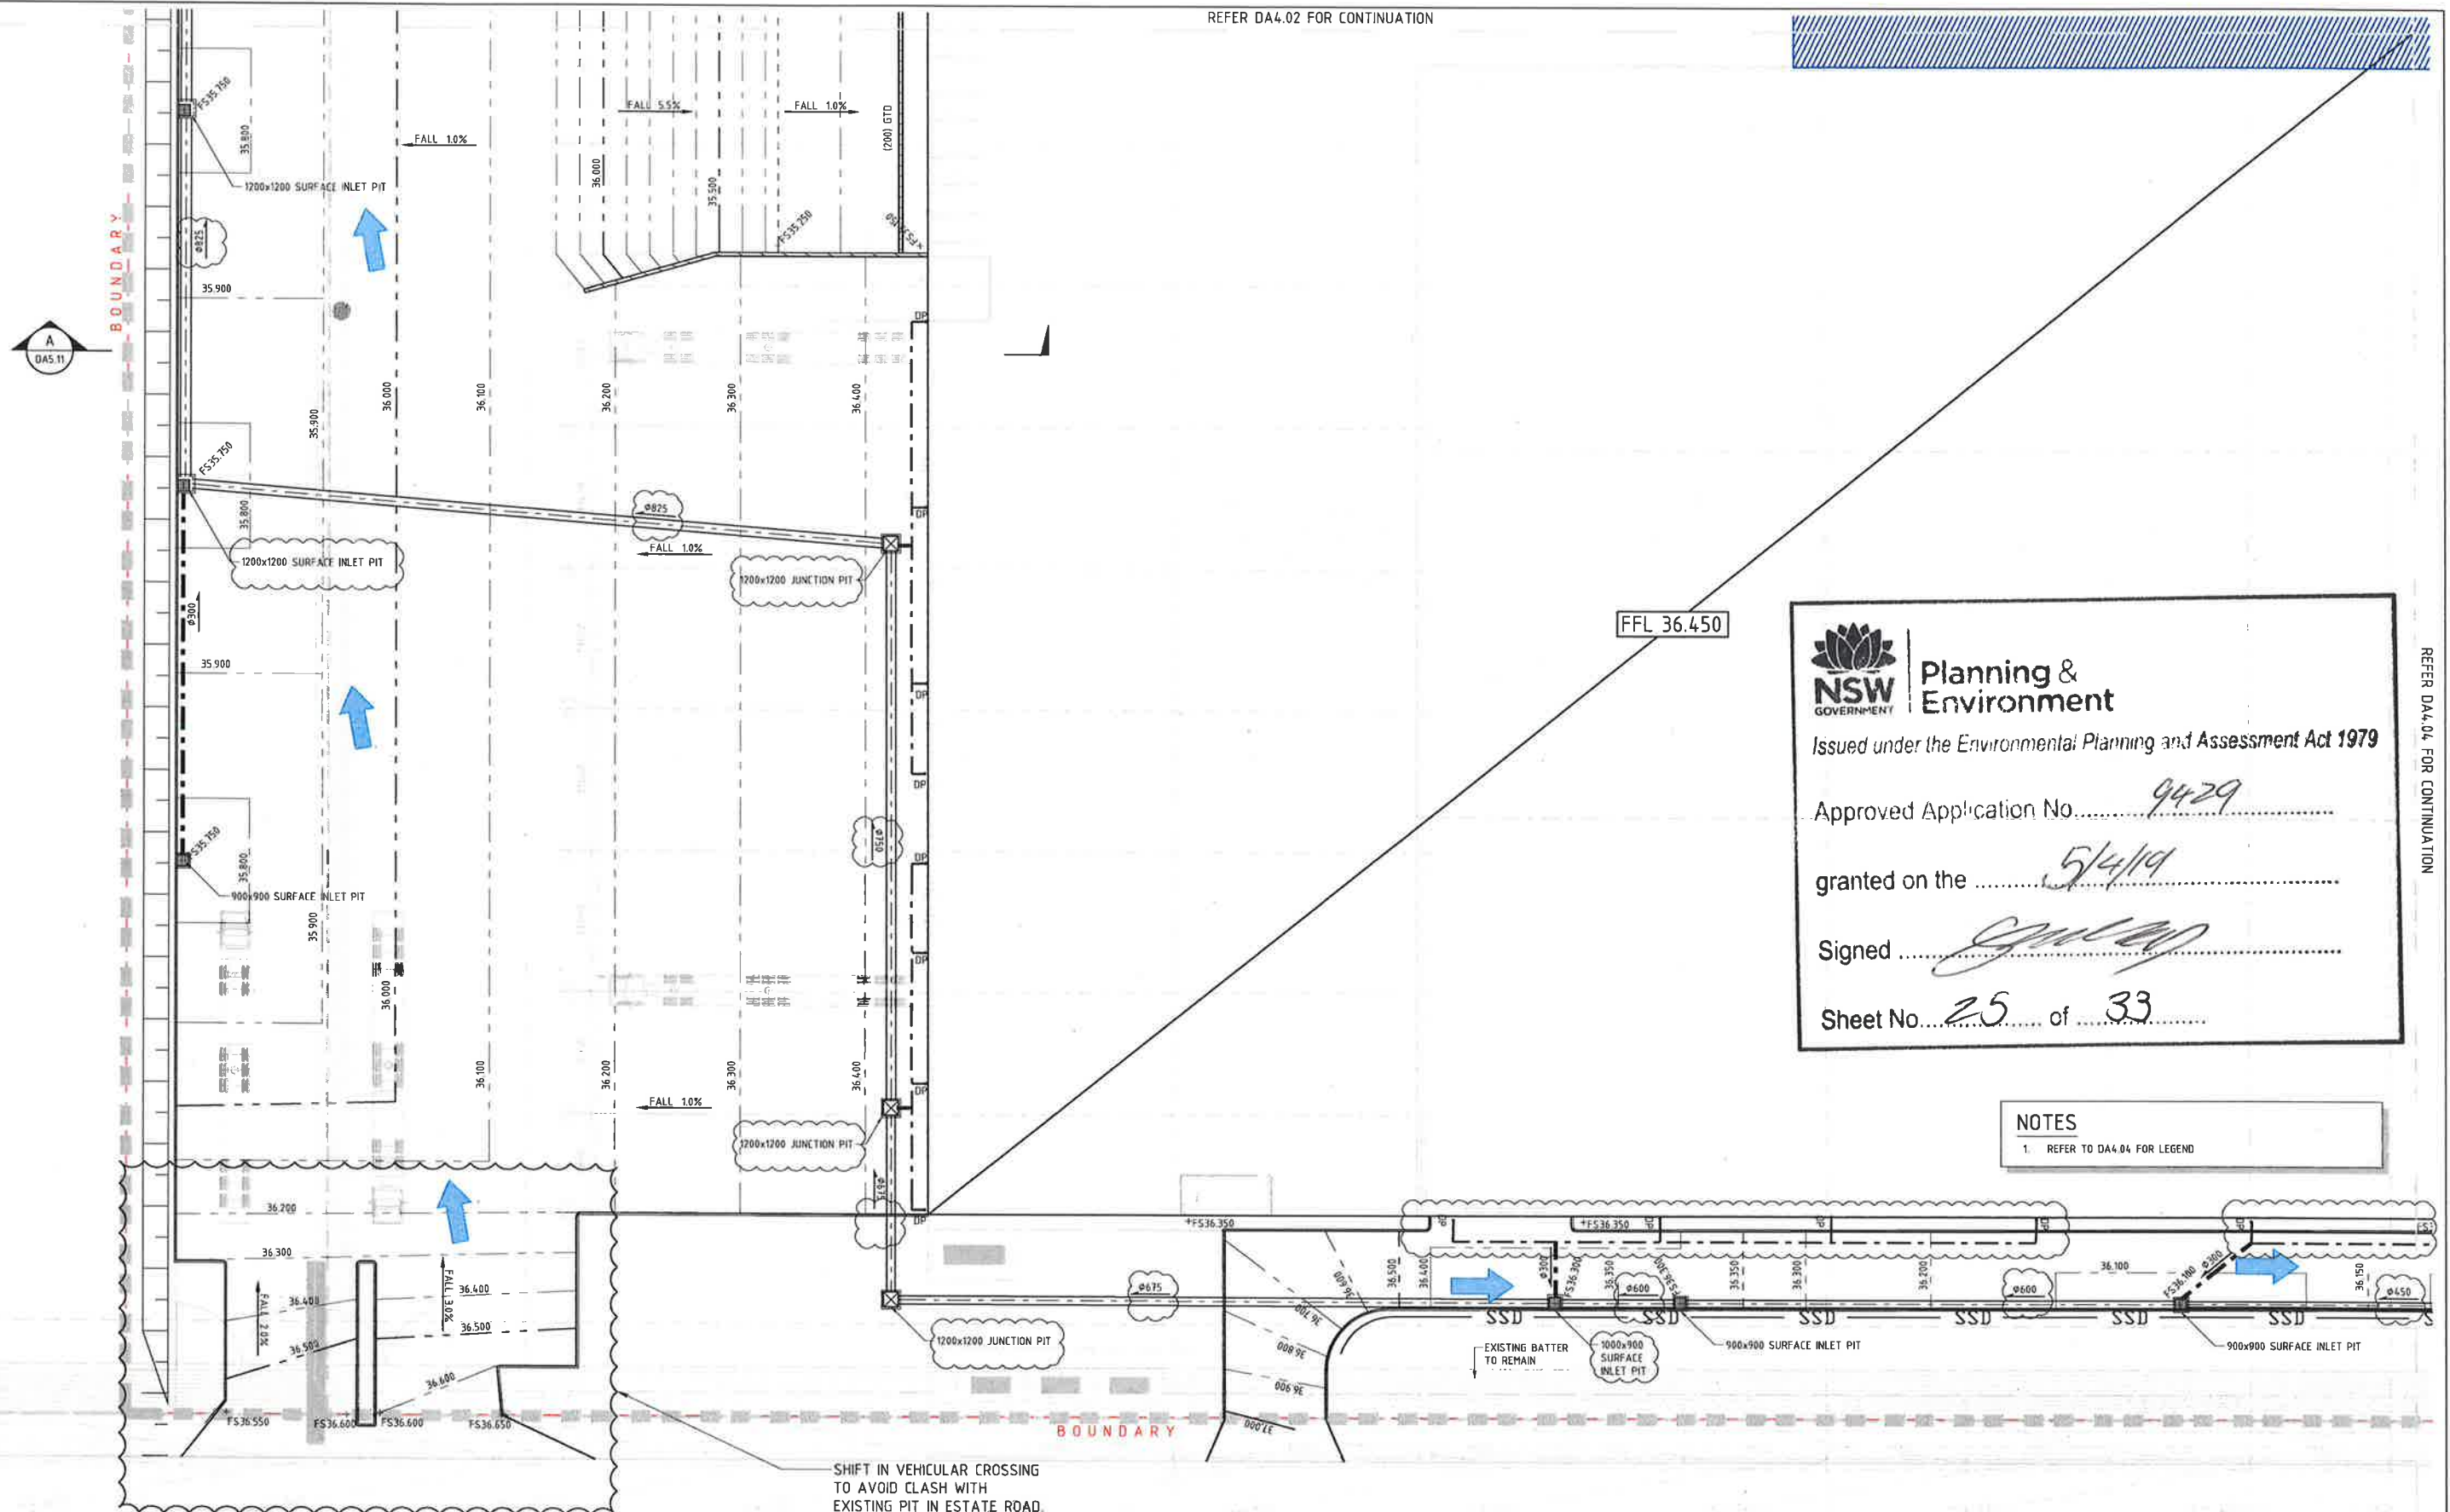

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Signed [Signature]

Sheet No. 25 of 33

NOTES
 1. REFER TO DA4.04 FOR LEGEND


SHIFT IN VEHICULAR CROSSING
 TO AVOID CLASH WITH
 EXISTING PIT IN ESTATE ROAD.
 FINAL VEHICULAR CROSSING
 LOCATION TO BE COORDINATED

SSD APPLICATION

1. DO NOT SCALE OFF THIS DRAWING. USE DIMENSIONS & ARCHITECTURAL DRAWINGS ONLY. 2. DRAWINGS TO BE READ IN CONJUNCTION WITH SPECIFICATION. 3. LEVELS ARE INDICATIVE ONLY AND ARE TO BE CHECKED PRIOR TO COMMENCEMENT OF ANY WORKS. 4. AUTOMATED MEASUREMENT SERVICES ARE TO BE LOCATED AND CHECKED PRIOR TO COMMENCEMENT OF ANY WORKS. 5. COMPLETION OF THE QUALITY RECORD IS EVIDENCE THAT THE DESIGN AND DRAWING HAVE BEEN VERIFIED.		CHECKED: [Signature] DATE: [Date] APPROVED: [Signature] DATE: [Date] PAID: [Date] October 12, 2018		NORTH POINT: [North Arrow]		DATE: [Date] No: [Number] AMENDMENT: [Text] 18.07.18 [Number] ISSUED FOR COORDINATION MW 1 31.07.18 [Number] ISSUE FOR SSD APPLICATION SK 2 12.10.18 [Number] ISSUE FOR SSD APPLICATION SK 3		DATE: [Date] No: [Number] AMENDMENT: [Text] INT REV: [Number]		DEVELOPER: ALTIS Property Partners		CLIENT: hansen yuncken		PROJECT: SNACKBRANDS, LOT 7, FIRST ESTATE, MAMRE ROAD, ORCHARD HILLS		DRAWING TITLE: SSD APPLICATION CONCEPT PAVEMENT GRADING & STORMWATER DRAINAGE PLAN SHEET 1		SCALE: 1:250 JOB No: 18146 DA4.01 OF 3	
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NOTES

1. REFER TO DA4.04 FOR LEGEND

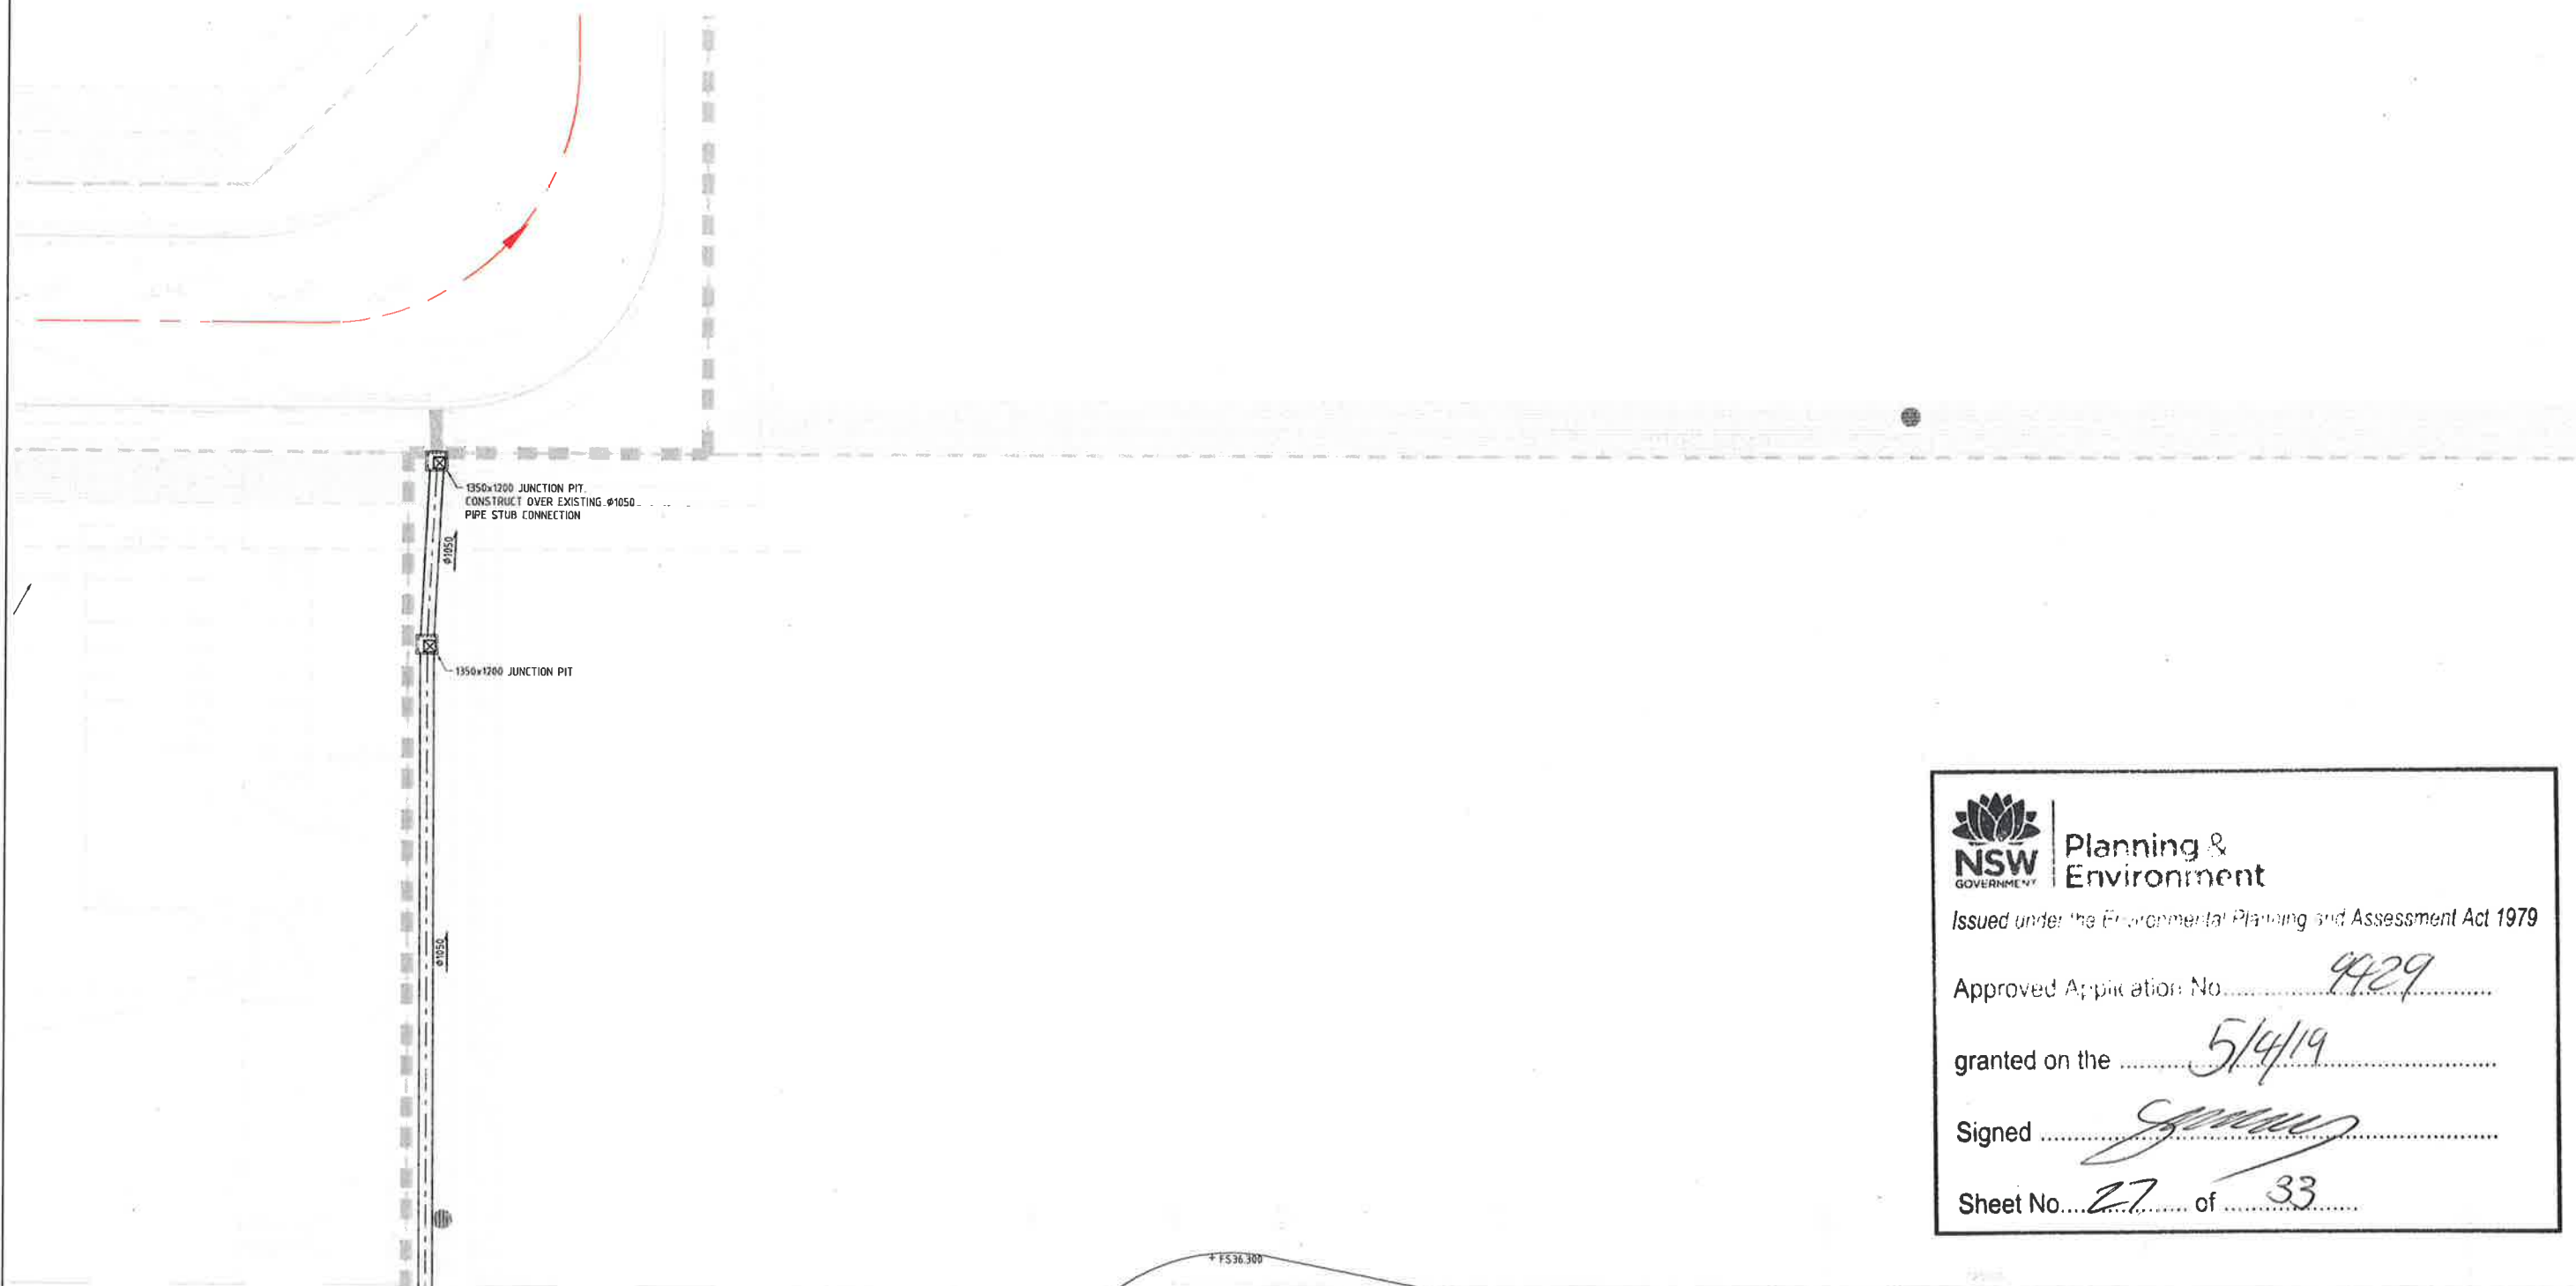

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granted on the 5/4/19

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Sheet No. 27 of 33

1. DO NOT SCALE OFF THIS DRAWING USE DIMENSIONS & ARCHITECTURAL DIMENSIONS ONLY
2. DIMENSIONS TO BE READ IN CONJUNCTION WITH SPECIFICATION
3. LEVELS ARE INDICATIVE ONLY AND ARE TO BE CHECKED PRIOR TO COMMENCEMENT OF ANY WORKS
4. AUTHORITY'S MARKS AND/OR EXISTING SERVICES ARE TO BE LOCATED AND CHECKED PRIOR TO COMMENCEMENT OF ANY WORKS
5. COMPLETION OF THE QUALITY RECORD IS EVIDENCE THAT THE DESIGN AND DRAWING HAVE BEEN VERIFIED

VERIFICATION
COMPLETION OF THE QUALITY RECORD IS EVIDENCE THAT THE DESIGN HAS BEEN VERIFIED AS CONFORMING TO THE REQUIREMENTS OF THE PROJECT QUALITY PLAN

DRAWING STATUS
DATE
INITIALS

FOR APPROVAL ONLY
FOR ILD/ST APPROVAL
FOR TENDER
FOR CONSTRUCTION

CHECKED DATE NORTH POINT

APPROVED DATE

PAGE PLOT DATE
A1 October 12, 2018

FOR INFORMATION ON THIS DRAWING REMAINS THE PROPERTY OF SPARKS & PARTNERS CONSULTING ENGINEERS. NO PART OF THIS DOCUMENT IS TO BE REPRODUCED OR TRANSMITTED IN ANY FORM OR BY ANY MEANS, ELECTRONIC OR MECHANICAL, INCLUDING PHOTOCOPYING, RECORDING, OR BY ANY INFORMATION STORAGE AND RETRIEVAL SYSTEM, WITHOUT PERMISSION IN WRITING FROM SPARKS & PARTNERS CONSULTING ENGINEERS.

SCALE
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METERS

DATE	No	AMENDMENT	INIT	REV
18.07.18		ISSUED FOR COORDINATION	MW	1
31.07.18		ISSUE FOR SSD APPLICATION	SK	2
12.10.18		ISSUE FOR SSD APPLICATION	SK	3

DATE	No	AMENDMENT	INIT	REV

DEVELOPER
ALTIS
Property Partners

CLIENT
hansen yuncken
BUILDING VALUE

ARCHITECT
netteloni

PROJECT
SNACKBRANDS, LOT 7, FIRST ESTATE,
MAMRE ROAD, ORCHARD HILLS

DRAWING TITLE
SSD APPLICATION
CONCEPT PAVEMENT GRADING &
STORMWATER DRAINAGE PLAN
SHEET 3


SSD APPLICATION

SPARKS+PARTNERS
CONSULTING ENGINEERS
HYDRAULIC | CIVIL | FIRE

Level 7, 91 George Street, Parramatta NSW 2150
P: 02 9691 5333 | F: 02 9691 3898 | E: admin@sparksandpartners.com.au

DATE
SCALE 1:250 @ A1
JOB NO 18146
DWG NO DA4.03
NO IN SET 3

AHSCA
REGISTERED
CONSULTING ENGINEER

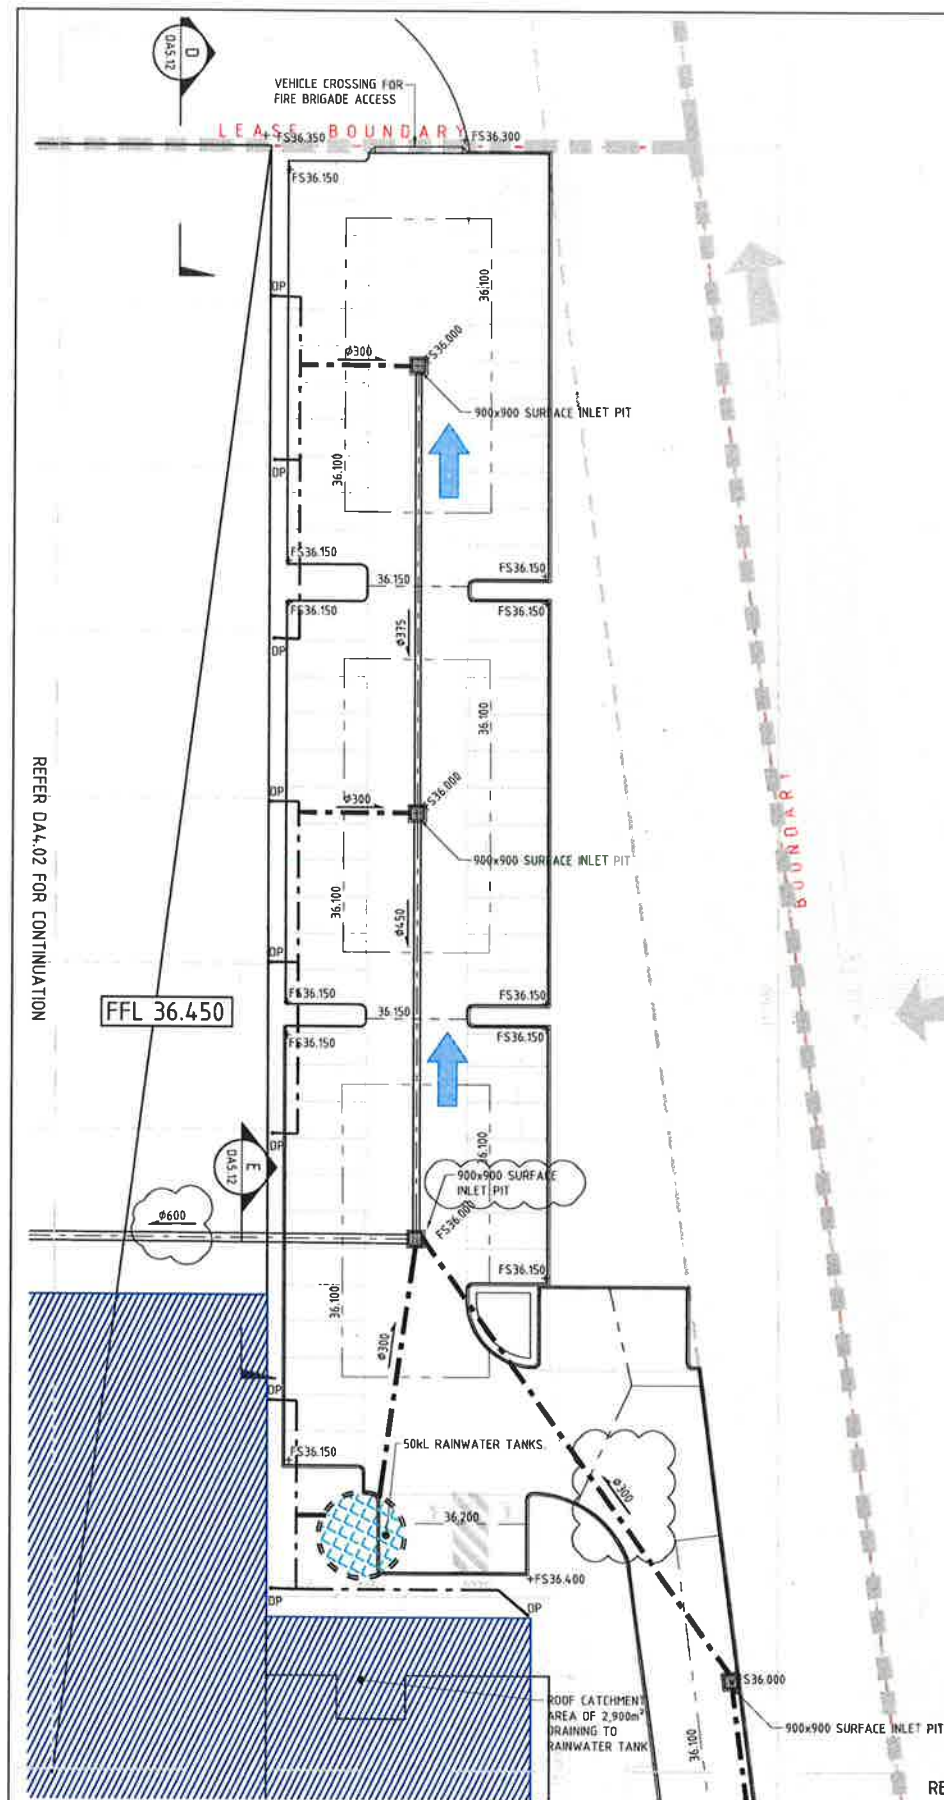

NOTES
1 REFER TO DA4.04 FOR LEGEND

MAMRE

NSW GOVERNMENT | **Planning & Environment**
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Approved Application No. 9429

granted on the 5/4/19

Signed [Signature]

Sheet No. 29 of 33

REFER DA4.04 FOR CONTINUATION

SSD APPLICATION

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 2. DRAWINGS TO BE READ IN CONJUNCTION WITH SPECIFICATION.
 3. LEVELS ARE INDICATED ONLY AND ARE TO BE CHECKED AGAINST THE COMMERCIALITY OF ANY WORKS.
 4. AUTHORIZED MAJOR AND/OR MINOR REVISIONS ARE TO BE LOCATED AND CHECKED FROM THE COMMERCIALITY OF ANY WORKS.
 5. COMPLETION OF THE QUALITY CHECKED IN EVIDENCE THAT THE DESIGN AND DRAWING HAVE BEEN VERIFIED.

VERIFICATION
 COMPLETION OF THE QUALITY CHECKED IN EVIDENCE THAT THE DESIGN AND DRAWING HAVE BEEN VERIFIED AS COMPLYING TO THE REQUIREMENTS OF THE PROJECT QUALITY PLAN.
 REVISIONS STATUS
 REVISION NO. DATE
 FOR INFORMATION ONLY
 FOR CLIENT APPROVAL
 FOR REVIEW
 FOR CONSTRUCTION

CHECKED DATE
 APPROVED DATE
 PAID BY DATE
 A1 October 12, 2018

SCALE
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 METERS

NORTH POINT

DATE	No	AMENDMENT	INIT	REV
18.07.18		ISSUED FOR COORDINATION	MW	1
31.07.18		ISSUE FOR SSD APPLICATION	SK	2
12.10.18		ISSUE FOR SSD APPLICATION	SK	3

DATE	No	AMENDMENT	INIT	REV

DEVELOPER
ALTIS
 Property Partners

CLIENT
hansen yuncken

ARCHITECT
netteloni

PROJECT
 SNACKBRANDS, LOT 7, FIRST ESTATE,
 MAMRE ROAD, ORCHARD HILLS

DRAWING TITLE
 SSD APPLICATION
 CONCEPT PAVEMENT GRADING &
 STORMWATER DRAINAGE PLAN
 SHEET 5

SPARKS+PARTNERS
 CONSULTING ENGINEERS
 (HYDRAULIC & CIVIL) FIRE

Level: 1, 91 George Street, Parramatta NSW 2150
 P: 02 9631 5433 F: 02 9631 3058 E: info@sparkspartners.com.au





DATE
 18/10/18

SCALE
 1:250

JOB No
 18146

DA4.05

REV
 3

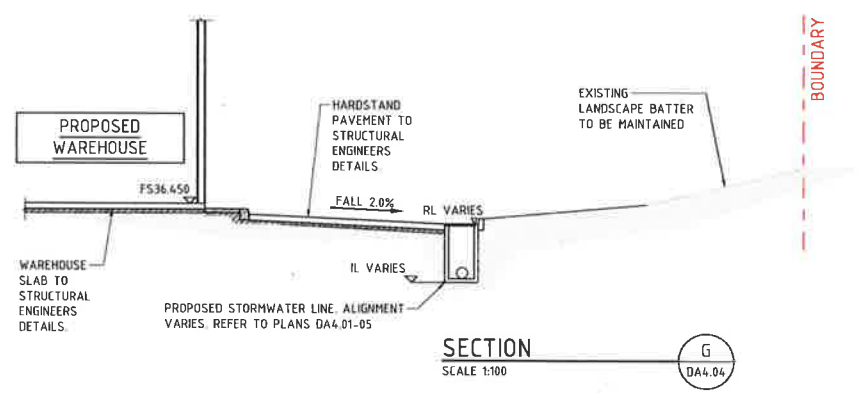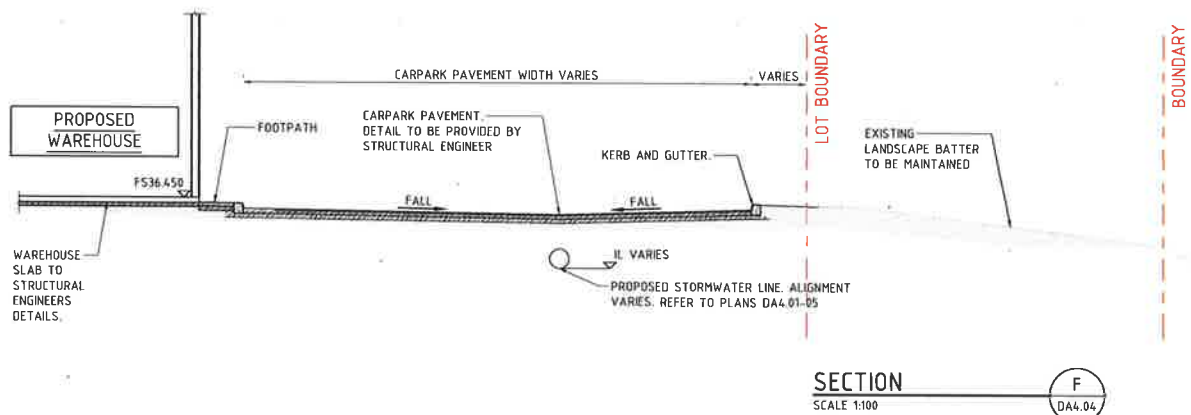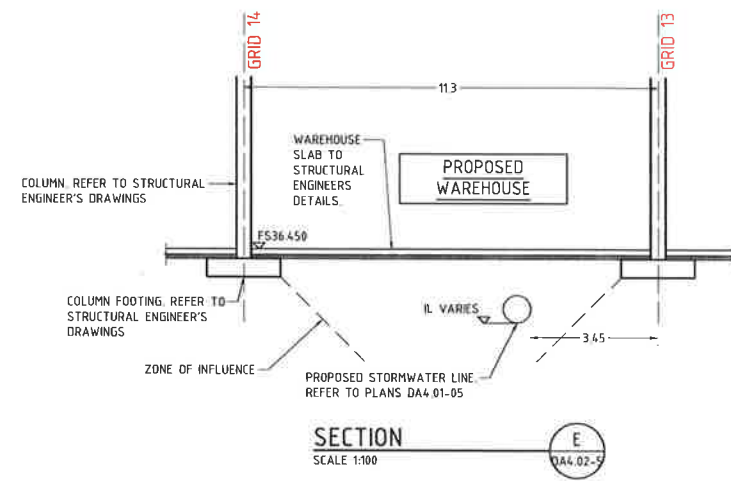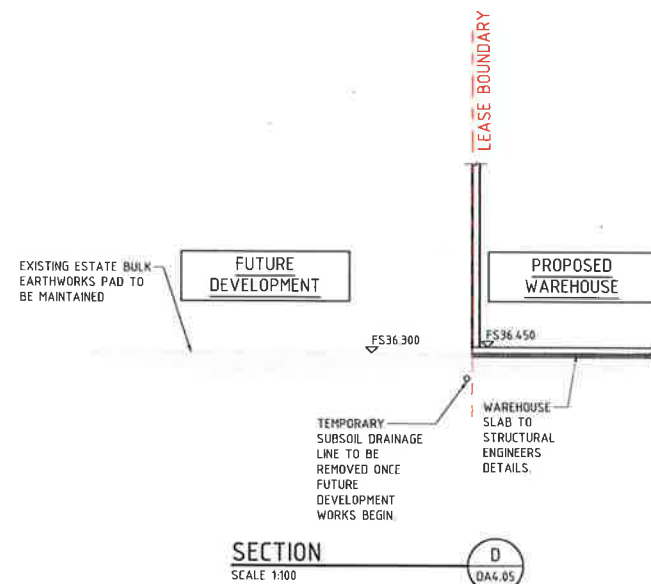

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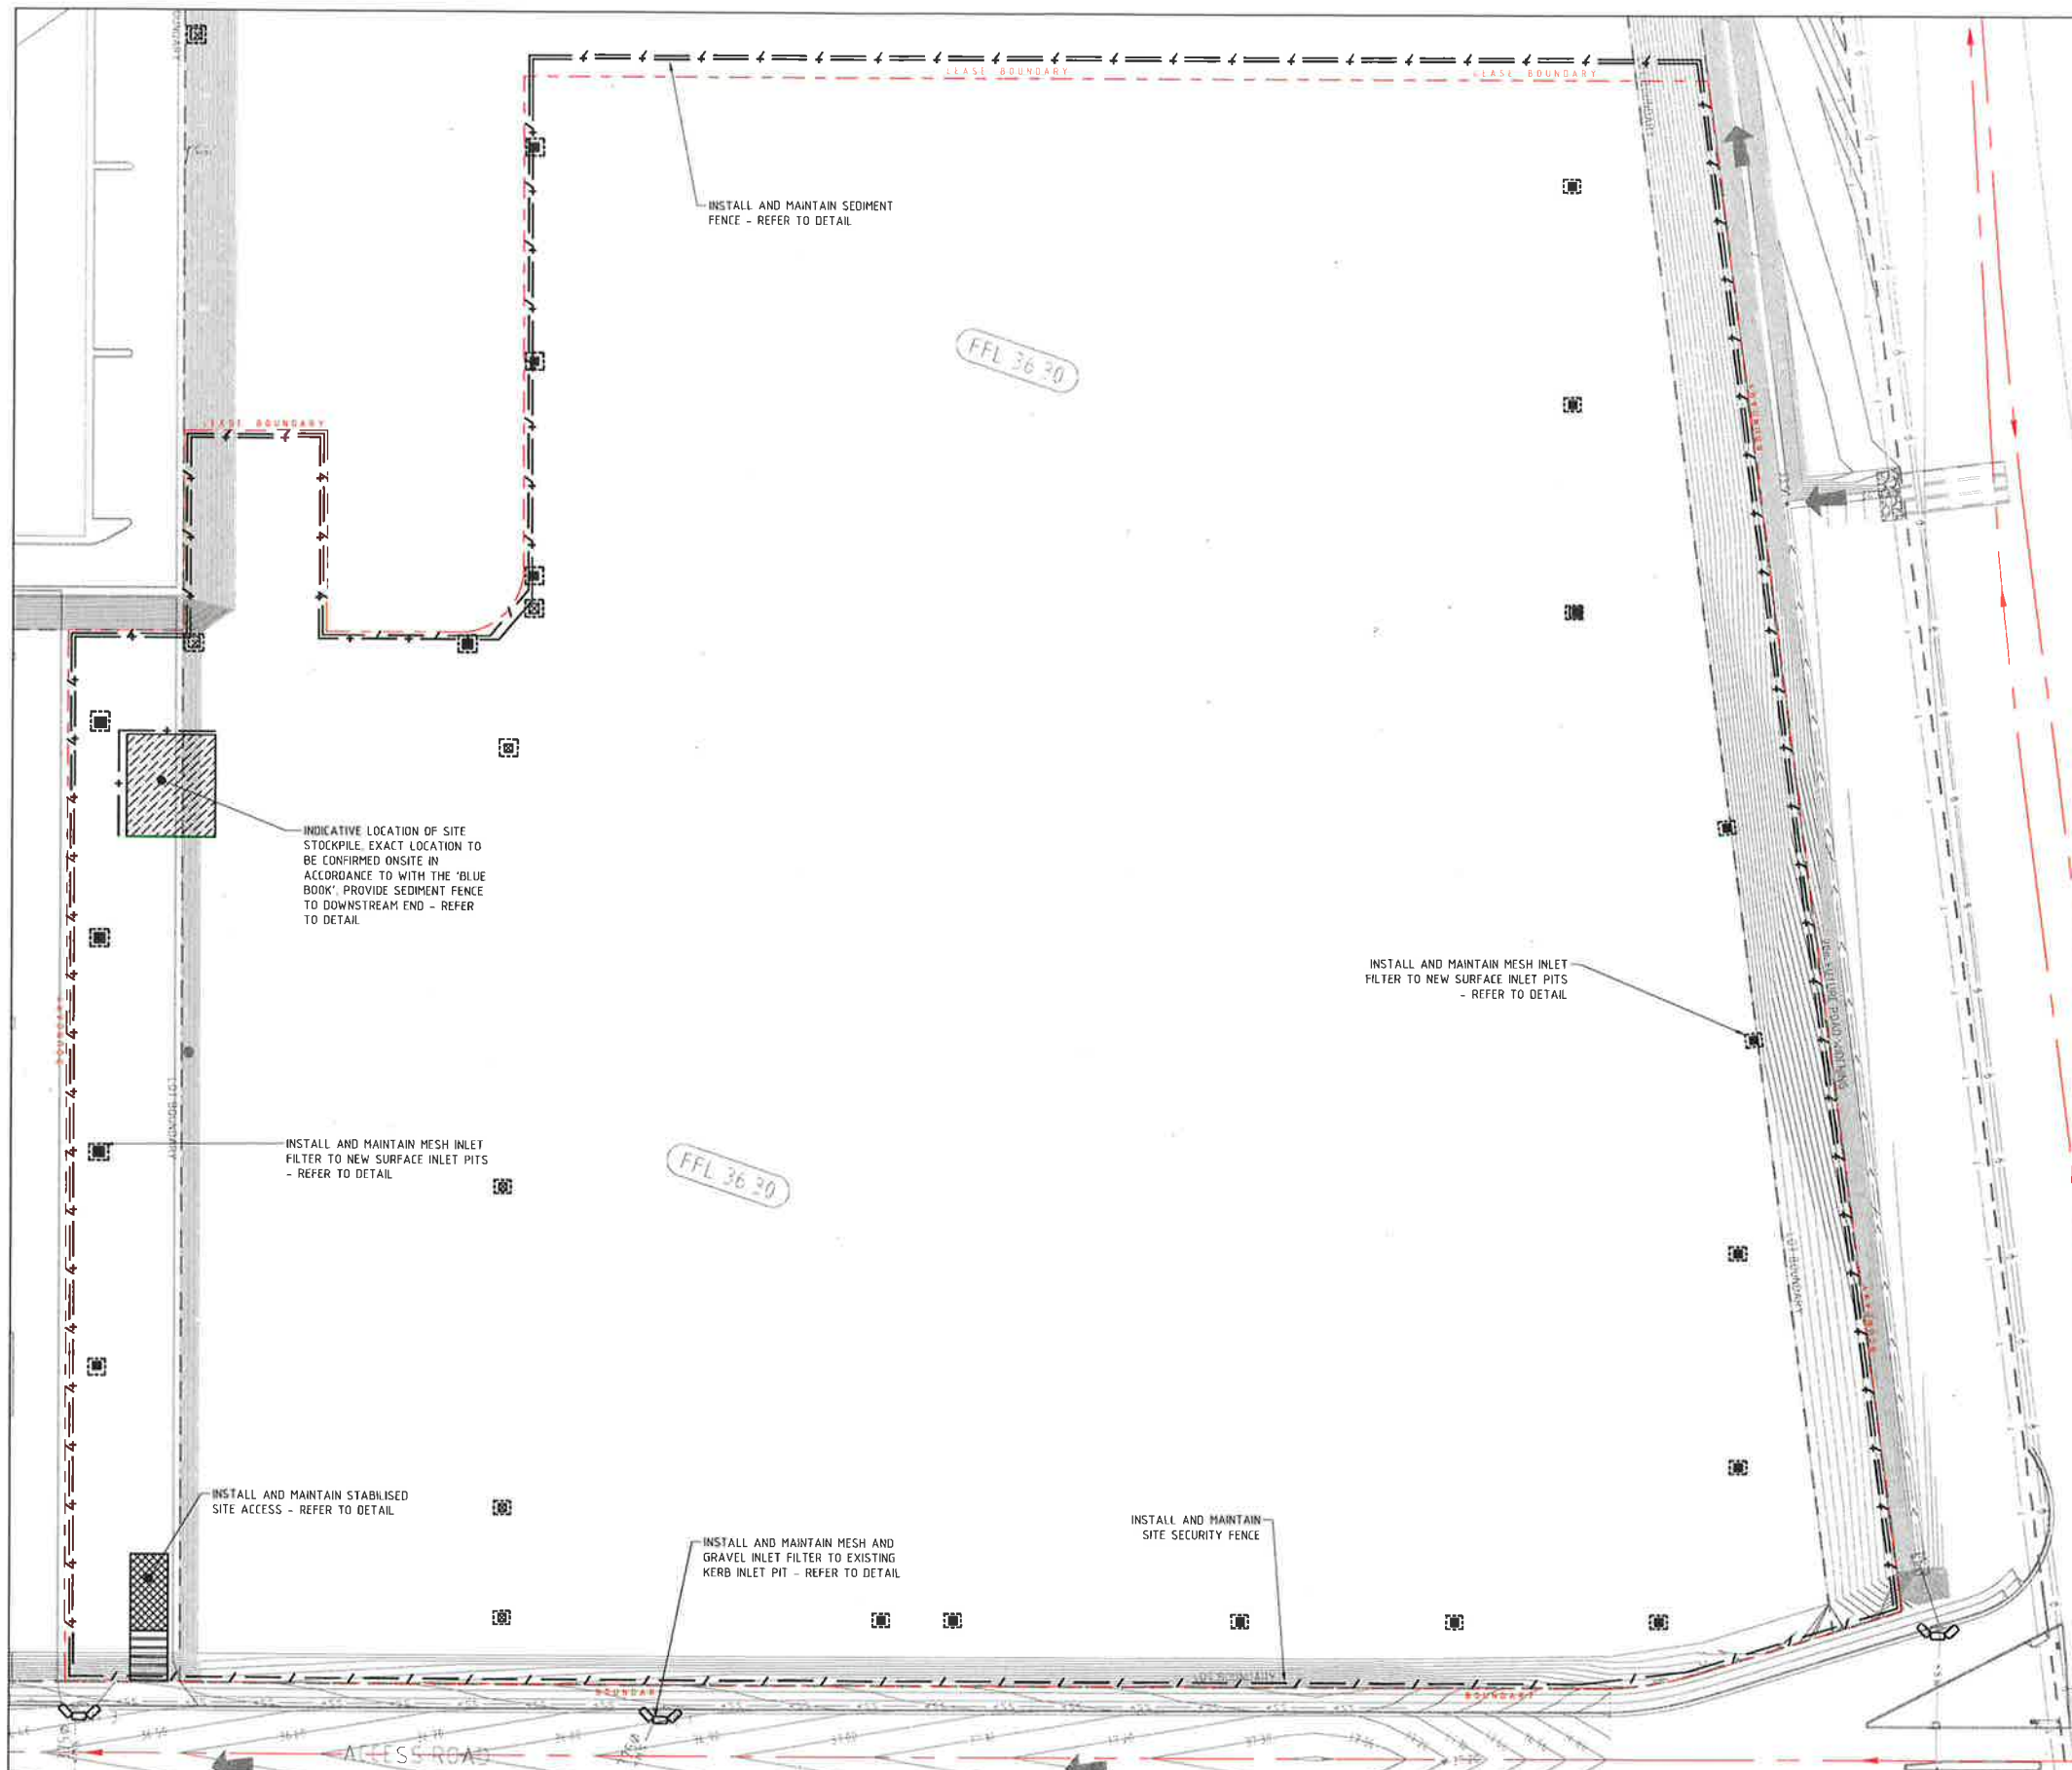
Approved Application No. 9479

granted on the 5/4/19

Signed [Signature]

Sheet No. 31 of 33

<p>1. DO NOT SCALE OFF THIS DRAWING USE DIMENSIONS & ARCHITECTURAL DRAWING ONLY.</p> <p>2. DRAWINGS TO BE READ IN CONJUNCTION WITH SPECIFICATION.</p> <p>3. LEVELS ARE INDICATIVE ONLY AND ARE TO BE CHECKED PRIOR TO COMMENCEMENT OF ANY WORKS.</p> <p>4. AUTHORIZED MAJOR AND/OR EXISTING SERVICES ARE TO BE LOCATED AND CHECKED PRIOR TO COMMENCEMENT OF ANY WORKS.</p> <p>5. COMPLETION OF THE QUALITY RECORD IS EVIDENCE THAT THE DESIGN AND DRAWING HAVE BEEN VERIFIED.</p> <p>VERIFICATION COMPLETION OF THE DRAWING STATUS IN EVIDENCE THAT THE DESIGN HAS BEEN VERIFIED AS CONFORMING TO THE REQUIREMENTS OF THE PROJECT QUALITY PLAN</p> <p>DRAWING STATUS DESIGNED BY: [Signature] DATE: [Date] CHECKED BY: [Signature] DATE: [Date] FOR APPROVAL ONLY FOR CLIENT APPROVAL FOR TENDER FOR CONSTRUCTION</p>				<p>DATE: 31.07.18</p> <p>AMENDMENT: ISSUE FOR SSD APPLICATION</p> <p>INIT: SK REV: 1</p>				<p>DATE: [Date]</p> <p>AMENDMENT: [Amendment]</p> <p>INIT: [Initials] REV: [Revision]</p>				<p>CLIENT: hansen yuncken</p> <p>DEVELOPER: ALTIS Property Partners</p> <p>ARCHITECT: nettleton</p>				<p>PROJECT: SNACKBRANDS, LOT 7, FIRST ESTATE, MAMRE ROAD, ORCHARD HILLS</p> <p>DRAWING TITLE: SSD APPLICATION CONCEPT TYPICAL SECTIONS SHEET 2</p>				<p>SPARKS+PARTNERS CONSULTING ENGINEERS HYDRAULIC CIVIL FIRE</p> <p>Level: 1, 91 George Street Parramatta NSW 2150 P 02 9891 5033 F 02 9891 3898 E admin@sparks-partners.com.au</p> <p>DATE: [Date] DESIGNED: [Signature] DRAWN: [Signature] SCALE: 1:100 @ A1 JOB No: 18146 DWG No: DA5.12 NO IN SET REV: 1</p>			
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LEGEND

- / — / — SITE SECURITY FENCE
- + — SEDIMENT FENCE
- ▨ STABILISED SITE ACCESS
- ▨ SITE STOCKPILE
- ▨ MESH AND GRAVEL INLET FILTER
- — — EARTH BANK DIVERSION MOUND
- GEOTEXTILE INLET FILTER

NOTES

1. REFER TO DA1.01 FOR GENERAL NOTES AND SPECIFICATIONS

NSW GOVERNMENT Planning & Environment
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Approved Application No. 9429

granted on the 5/4/19

Signed [Signature]

Sheet No. 32 of 33

SSD APPLICATION

SPARKS+PARTNERS
CONSULTING ENGINEERS
HYDRAULIC | CIVIL | FIRE

Level: 1, 91 George Street, Parramatta NSW 2150
P 02 9691 5033 F 02 9691 3698 E info@sparksandpartners.com.au

DATE: 15/07/18 DESIGNED: [Signature] DRAWN: [Signature] CHECKED: [Signature] APPROVED: [Signature]

SCALE: 1:500 @ A1

JOB NO: 18146 DWG NO: DA2.01 OF 1




DATE	No	AMENDMENT	INIT	REV
31.07.18		ISSUE FOR SSD APPLICATION	SK	1

ALTIS
Property Partners

hansen yuncken
BUILDING VALUE

rt
retention | ber


SSD APPLICATION
CONCEPT SEDIMENT AND EROSION
CONTROL MANAGEMENT PLAN

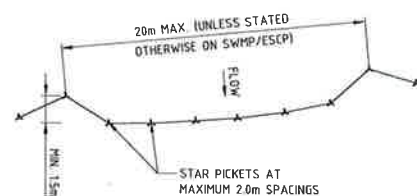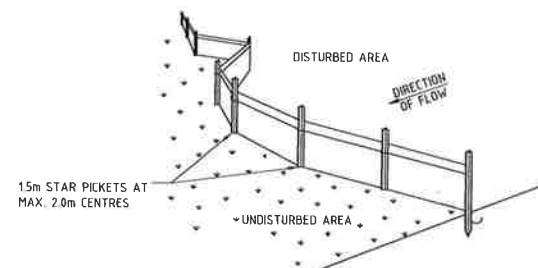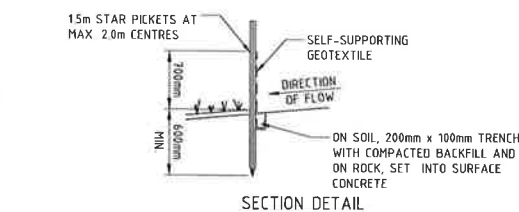

PLAN
SEDIMENT FENCE
NOT TO SCALE

NOTES:


1. CONSTRUCT SEDIMENT FENCES AS CLOSE AS POSSIBLE TO BEING PARALLEL TO THE CONTOURS OF THE SITE, BUT WITH SMALL RETURNS AS SHOWN IN THE DRAWING TO LIMIT THE CATCHMENT AREA OF ANY ONE SECTION. THE CATCHMENT AREA SHOULD BE SMALL ENOUGH TO LIMIT WATER FLOW IF CONCENTRATED AT ONE POINT TO 50L/s IN THE DESIGN STORM EVENT, USUALLY THE 10-YEAR EVENT.
2. CUT A 200mm DEEP TRENCH ALONG THE UPSLOPE LINE OF THE FENCE FOR THE BOTTOM OF THE FABRIC TO BE ENTRENCHED.
3. DRIVE 15m LONG STAR PICKETS INTO GROUND AT 2.0m INTERVALS (MAX) AT THE DOWNSLOPE EDGE OF THE TRENCH. ENSURE ANY STAR PICKETS ARE FITTED WITH SAFETY CAPS.
4. FIX SELF-SUPPORTING GEOTEXTILE TO THE UPSLOPE SIDE OF THE POSTS ENSURING IT GOES TO THE BASE OF THE TRENCH. FIX THE GEOTEXTILE WITH WIRE TIES OR AS RECOMMENDED BY THE MANUFACTURER. ONLY USE GEOTEXTILE SPECIFICALLY PRODUCED FOR SEDIMENT FENCING. THE USE OF SHADE CLOTH FOR THIS PURPOSE IS NOT SATISFACTORY.
5. JOIN SECTIONS OF FABRIC AT A SUPPORT POST WITH A 150mm OVFRI AP.
6. BACKFILL THE TRENCH OVER THE BASE OF THE FABRIC AND COMPACT IT THOROUGHLY OVER THE GEOTEXTILE.

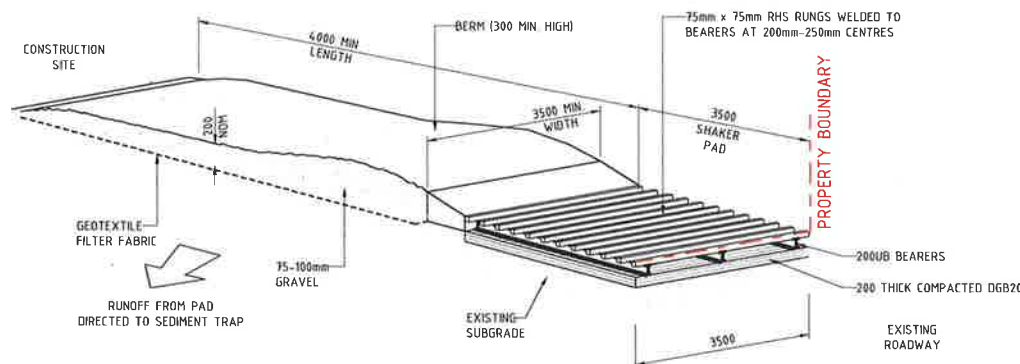

STABILISED SITE ACCESS
NOT TO SCALE

MAINTENANCE


- THE TEMPORARY ACCESS SHALL BE MAINTAINED IN A CONDITION THAT PREVENTS TRACKING OR FLOWING OF SEDIMENT ONTO PUBLIC RIGHTS OF WAY.
- THIS MAY REQUIRE PERIODIC TOP DRESSING WITH ADDITIONAL GRAVEL AS CONDITIONS DEMAND AND REPAIR AND/OR CLEANTOUT OF ANY MEASURES USED TO TRAP SEDIMENT.
- ALL SEDIMENT SPILLED, DROPPED, WASHED OR TRACKED ONTO PUBLIC RIGHTS OF WAY MUST BE REMOVED IMMEDIATELY.
- INSTALL BARRIER ON EITHER SIDE OF SHAKER PAD TO ENSURE VEHICLES ARE GUIDED ON TO THE PAD.
- INVERT OF SHAKER PAD TO BE DRAINED VIA AGRICULTURAL PIPE WRAPPED IN GEOTEXTILE FABRIC.

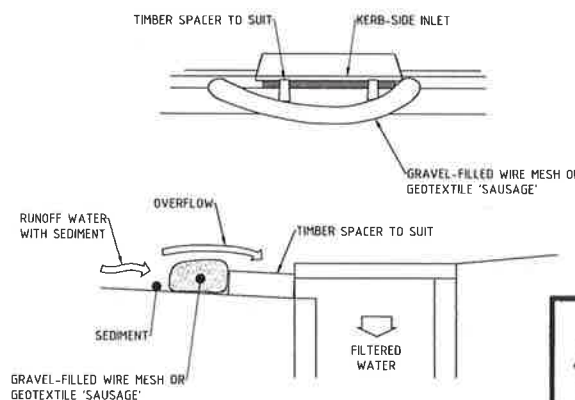

MESH AND GRAVEL INLET FILTER
NOT TO SCALE

NOTES:


1. THIS PRACTICE ONLY TO BE USED WHERE SPECIFIED IN AN APPROVED SWMP/ESCP.
2. INSTALL FILTERS TO KERB INLETS ONLY AT SAG POINTS.
3. FABRICATE A SLEEVE MADE FROM GEOTEXTILE OR WIRE MESH LONGER THAN THE LENGTH OF THE INLET PIT AND FILL IT WITH 25mm TO 50mm GRAVEL.
4. FORM AN ELLIPTICAL CROSS-SECTION ABOUT 150mm HIGH x 400mm WIDE.
5. PLACE THE FILTER AT THE OPENING LEAVING AT LEAST A 100-mm SPACE BETWEEN IT AND THE KERB INLET. MAINTAIN THE OPENING WITH SPACE BLOCKS.
6. FORM A SEAL WITH THE KERB TO PREVENT SEDIMENT BYPASSING THE FILTER.
7. SANDBAGS FILLED WITH GRAVEL CAN SUBSTITUTE FOR THE MESH OR GEOTEXTILE PROVIDING THEY ARE PLACED SO THAT THEY FIRMLY ABUT EACH OTHER AND SEDIMENT-LADEN WATERS CANNOT PASS BETWEEN.

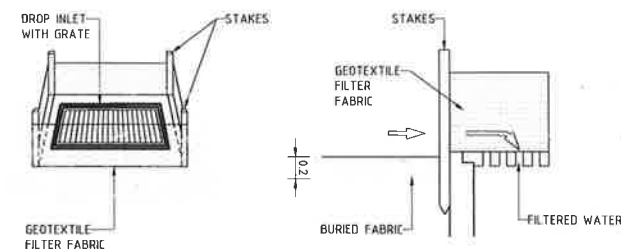

GEOTEXTILE INLET FILTER DROP INLET SEDIMENT TRAP
NOT TO SCALE

NOTES:

1. FABRICATE A SEDIMENT BARRIER MADE FROM GEOTEXTILE OR STRAW BALES.
2. CUT A 200mm DEEP TRENCH ALONG THE UPSLOPE LINE OF THE FENCE FOR THE BOTTOM OF THE FABRIC TO BE ENTRENCHED.
3. DRIVE 10m LONG STAR PICKETS INTO GROUND AT THE FOUR CORNERS OF PIT WALLS. ENSURE ANY STAR PICKETS ARE FITTED WITH SAFETY CAPS.
4. FIX SELF-SUPPORTING GEOTEXTILE TO THE UPSLOPE SIDE OF THE POSTS ENSURING IT GOES TO THE BASE OF THE TRENCH. FIX THE GEOTEXTILE WITH WIRE TIES OR AS RECOMMENDED BY THE MANUFACTURER. ONLY USE GEOTEXTILE SPECIFICALLY PRODUCED FOR SEDIMENT FENCING. THE USE OF SHADE CLOTH FOR THIS PURPOSE IS NOT SATISFACTORY.
5. JOIN SECTIONS OF FABRIC AT A SUPPORT POST WITH A 150mm OVERLAP.
6. BACKFILL THE TRENCH OVER THE BASE OF THE FABRIC AND COMPACT IT THOROUGHLY OVER THE GEOTEXTILE.

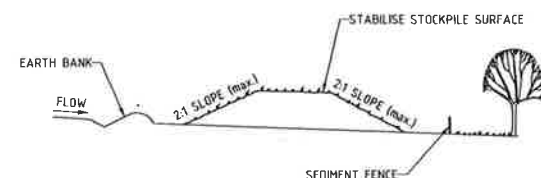

STOCKPILE
NOT TO SCALE

NOTES:

1. PLACE STOCKPILES MORE THAN 2 (PREFERABLY 5) METRES FROM EXISTING VEGETATION, CONCENTRATED WATER FLOW, ROADS AND HAZARD AREAS.
2. CONSTRUCT ON THE CONTOUR AS LOW, FLAT, ELONGATED MOUNDS.
3. WHERE THERE IS SUFFICIENT AREA, TOPSOIL STOCKPILES SHALL BE LESS THAN 2 METRES IN HEIGHT. 4. WHERE THEY ARE TO BE IN PLACE FOR MORE THAN 10 DAYS, STABILISE FOLLOWING THE APPROVED ESCP OR SWMP TO REDUCE THE C-FACTOR TO LESS THAN 0.10.
5. CONSTRUCT EARTH BANKS ON THE UPSLOPE SIDE TO DIVERT WATER AROUND STOCKPILES AND SEDIMENT FENCES 1 TO 2 METRES DOWNSLOPE.



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Approved Application No. 9429

granted on the 5/4/19

Signed [Signature]

Sheet No. 33 of 33

<p>1. DO NOT SCALE OFF THIS DRAWING. USE DIMENSIONS & ARCHITECTURAL CONVENTIONS ONLY.</p> <p>2. DIMENSIONS TO BE READ IN CONJUNCTION WITH SPECIFICATION.</p> <p>3. LEVELS AND INDICATIVE ONLY AND ARE TO BE CHECKED PRIOR TO COMMENCEMENT OF ANY WORKS.</p> <p>4. AUTHORIZED MEASUREMENT SERVICES ARE TO BE LOCATED AND CHECKED PRIOR TO COMMENCEMENT OF ANY WORKS.</p> <p>5. COMPLETION OF THE QUALITY RECORD IS EVIDENCE THAT THE DESIGN AND DRAWING HAVE BEEN VERIFIED.</p> <p>VERIFICATION COMPLETION OF THE QUALITY RECORD IS EVIDENCE THAT THE DESIGN HAS BEEN VERIFIED AND CONFORMS TO THE REQUIREMENTS OF THE PROJECT QUALITY PLAN.</p> <p>DRAWING STATUS PRELIMINARY FOR INFORMATION ONLY FOR TENDER APPROVAL FOR TENDER FOR CONSTRUCTION</p>	<p>CHECKED DATE APPROVED DATE PAGE PLOT DATE A1 July 31, 2018</p> <p>SCALE NOT TO SCALE</p>	<p>NORTH POINT</p> <p>DATE No AMENDMENT 31.07.18 ISSUE FOR SSD APPLICATION SK 1</p>	<p>INIT REV SK 1</p>	<p>DATE No AMENDMENT</p>	<p>INIT REV</p>	<p>BUILDER hansen yuncken</p>	<p>CLIENT ALTIS Property Partners</p>	<p>PROJECT SNACKBRANDS, LOT 7, FIRST ESTATE, MAMRE ROAD, ORCHARD HILLS</p> <p>DRAWING TITLE SSD APPLICATION CONCEPT SEDIMENT AND EROSION CONTROL DETAILS</p> <p>DATE 18146</p> <p>SCALE NTS</p> <p>JOB No DA2.02</p> <p>NO IN SET 1</p>
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SSD APPLICATION

SPARKS+PARTNERS
CONSULTING ENGINEERS
HYDRAULIC | CIVIL | FIRE

Level: 1, 91 George Street | Parramatta | NSW 2150
P 02 9861 9533 | F 02 9861 3898 | E admin@sparksandpartners.com.au

DATE
18146

SCALE
NTS

JOB No
DA2.02

NO IN SET
1