Appendix Y

Civil Engineering Drawings

DRAWING NUMBER TITLE

GENERAL PLANS **COVER SHEET** 60558549-SHT-CI-0001 60558549-SHT-CI-0003 GENERAL NOTES **DEDICATION PLAN** 60558549-SHT-CI-0010 60558549-SHT-CI-0011 **KEY PLAN**

PUBLIC DOMAIN PLANS

60558549-SHT-CI-0021

PUBLIC DOMAIN - PLAN - SHEET 01 60558549-SHT-CI-0101 PUBLIC DOMAIN - PLAN - SHEET 02 60558549-SHT-CI-0102 60558549-SHT-CI-0103 PUBLIC DOMAIN - PLAN - SHEET 03 60558549-SHT-CI-0104 PUBLIC DOMAIN - PLAN - SHEET 04

TYPICAL SITE SECTIONS

TYPICAL SITE SECTION - SHEET 01 60558549-SHT-CI-0121 TYPICAL SITE SECTION - SHEET 02 60558549-SHT-CI-0122 60558549-SHT-CI-0123 TYPICAL SITE SECTION - SHEET 03 60558549-SHT-CI-0124 TYPICAL SITE SECTION - SHEET 04 60558549-SHT-CI-0125 TYPICAL SITE SECTION - SHEET 05

LONGITUDINAL SECTIONS

PUBLIC DOMAIN LONGITUDINAL SECTIONS MC01 - SHEET 01 60558549-SHT-CI-0161 PUBLIC DOMAIN LONGITUDINAL SECTIONS MC01 - SHEET 02 60558549-SHT-CI-0162 PUBLIC DOMAIN LONGITUDINAL SECTIONS MC02 - SHEET 01 60558549-SHT-CI-0163 60558549-SHT-CI-0164 PUBLIC DOMAIN LONGITUDINAL SECTIONS MC02 - SHEET 02

GENERAL ARRANGEMENT

EROSION AND SEDIMENTATION CONTROL PLANS

60558549-SHT-CI-0201 EROSION AND SEDIMENTATION CONTROL - PLAN 60558549-SHT-CI-0221 **EROSION AND SEDIMENTATION CONTROL DETAIL** DRAINAGE PLANS

60558549-SHT-CI-0301 DRAINAGE - PLAN - SHEET 01 DRAINAGE - PLAN - SHEET 02 60558549-SHT-CI-0302 60558549-SHT-CI-0303 DRAINAGE - PLAN - SHEET 03 60558549-SHT-CI-0304 DRAINAGE - PLAN - SHEET 04 60558549-SHT-CI-0305 DRAINAGE - PLAN - SHEET 05

CATHMENT PLANS

60558549-SHT-CI-0321 DRAINAGE CATHMENT - PLAN

DRAINAGE LONGITUDINAL SECTIONS

DRAINAGE LONGITUDINAL SECTION - SHEET 01 60558549-SHT-CI-0401 60558549-SHT-CI-0402 DRAINAGE LONGITUDINAL SECTION - SHEET 02 60558549-SHT-CI-0403 DRAINAGE LONGITUDINAL SECTION - SHEET 03 60558549-SHT-CI-0404 DRAINAGE LONGITUDINAL SECTION - SHEET 04 DRAINAGE LONGITUDINAL SECTION - SHEET 05 60558549-SHT-CI-0405 DRAINAGE LONGITUDINAL SECTION - SHEET 06 60558549-SHT-CI-0406 DRAINAGE LONGITUDINAL SECTION - SHEET 07 60558549-SHT-CI-0407 60558549-SHT-CI-0408 DRAINAGE LONGITUDINAL SECTION - SHEET 08 60558549-SHT-CI-0409 DRAINAGE LONGITUDINAL SECTION - SHEET 09

SERVICES PLANS

60558549-SHT-CI-0501 COMBINED SERVICES - PLAN - SHEET 01 60558549-SHT-CI-0502 COMBINED SERVICES - PLAN - SHEET 02 60558549-SHT-CI-0503 COMBINED SERVICES - PLAN - SHEET 03 60558549-SHT-CI-0504 COMBINED SERVICES - PLAN - SHEET 04 60558549-SHT-CI-0505 COMBINED SERVICES - PLAN - SHEET 05

60558549-SHT-CI-0511 SEWER CONNECTION - PLAN

VEHICLE TRACKING PLAN

60558549-SHT-CI-0801 VEHICLE TRACKING - PLAN - SHEET 01 60558549-SHT-CI-0802 VEHICLE TRACKING - PLAN - SHEET 02 60558549-SHT-CI-0803 VEHICLE TRACKING - PLAN - SHEET 03 60558549-SHT-CI-0804 VEHICLE TRACKING - PLAN - SHEET 04 60558549-SHT-CI-0805 VEHICLE TRACKING - PLAN - SHEET 05

CUDGEGONG ROAD STATION PRECINCT TOWN CENTRE SOUTH CIVIL PACKAGE

CLIENT



CONSULTANT

AECOM Australia Pty Ltd A.B.N 20 093 846 925

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PRELIMINARY

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ISSUE/REVISION			

Α	18/05/2018	ISSUED FOR PRELIMINARY
I/R	DATE	DESCRIPTION

KEY PLAN

PROJECT NUMBER

60558549

SHEET TITLE

COVER SHEET

SHEET 01

SHEET NUMBER

GENERAL

- 1 THE INFORMATION CONTAINED IN THESE DRAWINGS PRODUCED BY AECOM IS SOLELY FOR THE USE OF LANDCOM FOR THE PURPOSE FOR WHICH IT HAS BEEN PREPARED. AECOM AUSTRALIA PTY LTD UNDERTAKES NO DUTY TO OR ACCEPTS NO RESPONSIBILITY TO ANY THIRD PARTY WHO MAY RELY UPON THIS DOCUMENT.
- 2 THESE DRAWINGS SHALL BE READ IN CONJUNCTION WITH ALL OTHER ENGINEERING AND PUBLIC DOMAIN DRAWINGS. THE SPECIFICATION, BCC STANDARD DRAWINGS, AND WITH SUCH OTHER WRITTEN INSTRUCTIONS, AS MAY BE ISSUED DURING THE COURSE OF THE CONTRACT.
- 3 ANY DISCREPANCIES BETWEEN THESE NOTES AND DRAWINGS, AND BCC SPECIFICATIONS AND DETAILS, THE DRAWINGS WILL TAKE PRECEDENCE.
- 4 ANY DISCREPANCIES OR OMISSIONS FROM THESE DOCUMENTS SHALL BE REFERRED TO THE SUPERINTENDENT FOR A DECISION BEFORE PRECEDING WITH THE WORK.
- 5 ALL WORKMANSHIP AND MATERIALS TO COMPLY WITH THE BUILDING CODE OF AUSTRALIA AS AMENDED AND THE
- APPROPRIATE AND CURRENT AUSTRALIAN STANDARDS OR LOCAL STATUTORY AUTHORITY GUIDELINES. 6 ALL DIMENSIONS ARE IN MILLIMETRES UNLESS NOTED OTHERWISE. ALL CHAINAGES AND LEVELS ARE IN METRES
- UNLESS NOTED OTHERWISE. 7 ALL DIMENSIONS RELEVANT TO SETTING OUT OR OFF-SITE WORK SHALL BE VERIFIED BY THE CONTRACTOR BEFORE
- CONSTRUCTION AND FABRICATION HAS COMMENCED
- 8 DO NOT SCALE FROM DRAWINGS.
- 9 ORIGIN OF LEVELS AHD
- COORDINATES TO MGA MAP GRID AUSTRALIA.
- 10 WHERE NOTED ON DRAWINGS THAT WORKS ARE TO BE CARRIED OUT BY OTHERS, THE CONTRACTOR WILL BE RESPONSIBLE FOR THE COORDINATION OF THESE WORKS AND THIS WORK WILL NOT QUALIFY FOR DELAY CLAIMS.
- 11 WHERE A PROPRIETARY ITEM (OR EQUIVALENT) IS SPECIFIED, AND AN EQUIVALENT ITEM IS PROPOSED, THE CONTRACTOR SHALL PROVIDE MANUFACTURERS SPECIFICATIONS FOR BOTH PRODUCTS TO THE SUPERINTENDENT
- FOR APPROVAL, AND DEMONSTRATE THAT THE PRODUCT PERFORMANCE IS EQUIVALENT OR BETTER, PRIOR TO USE. 12 ALL PROPRIETARY PRODUCTS ARE TO BE INSTALLED FIXED AND TESTED IN ACCORDANCE WITH MANUFACTURERS INSTRUCTIONS
- 13 DURING CONSTRUCTION, IT IS THE RESPONSIBILITY OF THE CONTRACTOR TO ENSURE THAT THE STRUCTURES AND EXCAVATIONS ARE MAINTAINED IN A SAFE AND STABLE CONDITION AT ALL TIME AND NO PART IS TO BE OVERSTRESSED. THE CONTRACTOR SHALL DEVELOP WORK METHOD STATEMENTS FOR ALL ERECTION OF STRUCTURAL STEEL/FORMWORK/ DEMOLITION/EXCAVATION/TILT PANELS ETC. AND PROVIDE TEMPORARY WORKS SUCH AS BRACING, PROPPING AND SHORING ETC. TO KEEP THE WORKS AND EXCAVATIONS STABLE AND FREE FROM WATER AT ALL TIMES. THE CONTRACTOR IS TO ENGAGE A STRUCTURAL ENGINEER TO DESIGN AND CERTIFY THE TEMPORARY WORKS.

SITEWORKS

- 1 THE CONTRACTOR TO MAKE SMOOTH CONNECTION TO ANY EXISTING WORKS.
- 2 ON COMPLETION OF THE WORKS, THE CONTRACTOR MUST RESTORE OR REINSTATE ANY AREAS, STRUCTURES PAVEMENTS OR UTILITY SERVICES DAMAGED OR DIRTIED DURING THE CONSTRUCTION, TO THE SATISFACTION OF THE SUPERINTENDENT OR THE ASSET OWNER.
- 3 ALL TRENCH BACKFILL MATERIAL SHALL BE COMPACTED TO THE SAME DENSITY AS THE ADJACENT MATERIAL
- 4 ALL SERVICE TRENCHES UNDER VEHICULAR PAVEMENTS SHALL BE BACKFILLED IN ACCORDANCE WITH BCC STANDARD DRAWINGS
- 5 PROVIDE EXPANSION JOINTS BETWEEN BUILDINGS AND ALL CONCRETE AND UNIT PAVEMENTS.
- 6 ASPHALTIC CONCRETE SHALL CONFORM TO RMS QA SPECIFICATION R116
- 7 ALL BASECOURSE MATERIAL SHALL BE IGNEOUS ROCK QUARRIED MATERIAL TO COMPLY WITH RMS QA SPECIFICATION 3051 - GRANULAR BASE AND SUBBASE MATERIALS FOR SURFACED ROAD PAVEMENTS, COMPACTED TO 98% MODIFIED DENSITY IN ACCORDANCE WITHAS1289 5.2.1. FREQUENCY OF COMPACTION TESTING TO BE NO LESS THAN 1 TEST PER 50m2 OF BASECOURSE MATERIAL PLACED.
- 8 ALL SUBBASECOURSE MATERIAL SHALL BE IGNEOUS ROCK QUARRIED MATERIAL TO COMPLY WITH RMS QA SPECIFICATION 3051 - GRANULAR BASE AND SUBBASE MATERIALS FOR SURFACED ROAD PAVEMENTS, COMPACTED TO 95% MODIFIED DENSITY IN ACCORDANCE WITHAS1289 5.2.1. FREQUENCY OF COMPACTION TESTING TO BE NO LESS THAN 1 TEST PER 50m2 OF BASECOURSE MATERIAL PLACED.
- 9 THE USE OF RECYCLED MATERIALS IS ENCOURAGED. IF THE CONTRACTOR INTENDS TO USE RECYCLED MATERIALS, A RECYCLED MATERIAL COMPLYING WITH RMS QA SPECIFICATION 3051 - GRANULAR BASE AND SUBBASE MATERIALS FOR SURFACED ROAD PAVEMENTS WILL BE CONSIDERED, SUBJECT TO MATERIAL SAMPLES AND APPROPRIATE CERTIFICATIONS BEING PROVIDED TO THE SATISFACTION OF THE PRINCIPAL'S REPRESENTITIVE.
- 10 THE CONTRACTOR IS TO CONTINUE TO PROVIDE CERTIFICATION FOR ALL RECYCLED MATERIALS DURING THE COUSE OF CONSTRUCTION, AND WHERE MATERIAL THAT DOES NOT COMPLY. THE CONTRACTOR WILL BE RESPONSIBLE FOR REMOVAL AND REPLACEMENT WITH A SUITABLY COMPLIANT MATERIAL AT THEIR OWN BCCT.
- 11 SHOULD THE CONTRACTOR WISH TO USE A RECYCLED PRODUCT, THE INTENT SHALL BE CLEARLY INDICATED IN THEIR TENDER AND THE PRICE DIFFERENCE BETWEEN AN IGNEOUS PRODUCT AND A RECYCLED PRODUCT SHALL BE CLEARLY NOTED.

BULK EARTHWORKS

- 1 REFER TO THE FOLLOWING DOCUMENTS
- A) 805 CUDGEGONG ROAD STAGE 3 REPORT BY NRT
- B) 806 CUDGEGONG ROAD STATION CARPARK CIVIL STAGE 3B REPORT BY NRT.
- 2 THE CONTRACTOR MUST FAMILIARISE THEMSELVES WITH THE RECOMMENDATIONS OF BOTH THE GEOTECHNICAL REPORTS AND THE SITE REMEDIATION.
- 3 THE RAP DEFINES THE LEVEL OF REMEDIATION WITHIN THE ROAD RESERVE THAT IS EXPECTED AT THE COMPLETION OF THIS CONTRACT.
- 4 ALL WORKS WITHIN THE ROAD RESERVES TO ACHIEVE THE LEVEL OF REMEDIATION, AS DEFINED IN THE RAP, WILL FORM PART OF THIS CONTRACT AND MUST BE INCLUDED WITHIN THE CONTRACTORS PRICE.
- 5 THE CONTRACTOR WILL BE RESPONSIBLE FOR THE SAFE EXCAVATION, CONTAMINATION MANAGEMENT AND DISPOSAL OF ALL CONTAMINATED MATERIALS FOUND WITHIN ANY EXCAVATION IN UNREMEDIATED LAND OR BELOW THE HDPE MARKER LAYER. THIS MAY INCLUDE EXCAVATION TO ACHIEVE A RECOMMENDED MINIMUM CLEAN LAYER THICKNESS BELOW ROAD AREAS AND TRENCH EXCAVATIONS TO COMPLY WITH THE REQUIREMENTS OF THE RAP.
- 6 MATERIALS USED IN FILL MUST BE CLEAN IMPORTED GRANULAR VENM. THIS MATERIAL CAN BE SOURCED FROM SITE ONLY IF PERMITTED BY THE RWP.
- 7 ALL EXCAVATED MATERIAL NOT CLASSED AS VENM AND NOT ABLE TO BE REUSED, MUST BE STOCKPILED AS DIRECTED
- BY SUPERINTENDENT AND AS REQUIRED BY THE RAP. 8 COMPACTION, TESTING, FILLING, STANDARD DRY DENSITIES AND MOISTURE CONTENTS TO BE IN ACCORDANCE WITH
- 9 ALL EARTHWORKS AREAS SHALL BE ROLLED EACH EVENING TO RESTRICT THE INGRESS FROM POTENTIAL WATER INGRESS.

SAFETY

ENVIRONMENT.

- 1 THE CONTRACTOR IS RESPONSIBE FOR SAFETY ONSITE.
- 2 THE CONTRACTOR IS RESPONSIBLE FOR MAINTAINING ALL EXCAVATION WORKS IN A STABLE CONDITION, AND ENSURING NO PART SHALL BE OVERSTRESSED DURING CONSTRUCTION ACTIVITIES. PROVISION OF TEMPORARY BRACING, SHORING AND BATTERING IS BY THE CONTRACTOR AS REQUIRED TO PROVIDE A SAFE WORKING
- 3 THE CONTRACTOR MUST MAKE PROVISION FOR THE SAFETY OF NORMAL VEHICULAR TRAFFIC AND PEDESTRIANS, AND OTHERS INCLUDING UNAUTHORISED INTRUDERS.
- 4 ALL PITS, MANHOLES, PUMPSTATIONS AND OTHER CONFINED SPACES MUST BE FITTED WITH A CONFINED SPACE WARNING SIGN TO THE APPROVAL OF THE SUPERINTENDENT.
- 5 ALL CONDITIONS OF WITH THE ENVIRONMENTAL ASSESSMENT MUST BE MET.

EROSION AND SEDIMENT CONTROLS - GENERAL INSTRUCTIONS

- 1 THE CONTRACTOR SHALL BE SOLELY RESPONSIBLE AND TAKE ALL STEPS NECESSARY TO PROTECT THE ENVIRONMENT DURING THE COURSE OF THEIR CONTRACT AND IN PARTICULAR IMPLEMENT THE NECESSARY MEASURES FOR THE CONTROL OF EROSION AND SEDIMENTATION TO THE SATISFACTION OF ALL ADMINISTERING BODIES INCLUDING BLACKTOWN CITY COUNCIL, NSW OFFICE OF WATER, SYDNEY WATER, RMS AND NSW ENVIRONMENT AND HERITAGE.
- 2 THE EROSION AND SEDIMENTATION CONTROLS SHOWN ON THE DRAWINGS SHALL ONLY BE USED AS A GUIDE BY THE CONTRACTOR AND SHALL REPRESENT THE MINIMUM REQUIREMENT ONLY
- 3 EROSION AND SEDIMENTATION MEASURES ARE TO BE PROVIDED BY THE CONTRACTOR PRIOR TO THE COMMENCEMENT OF WORKS, ADJUSTED TO SUIT STAGING AND MAINTAINED FOR THE LIFE OF THE CONTRACT.
- 4 ALL MEASURES ARE TO BE DESIGNED AND IMPLEMENTED IN ACCORDANCE WITH THE MOST RECENT EDITION OF THE "BLUE BOOK" - SOILS AND CONSTRUCTION AND BCC DCP, AND CONFIRMED AS A PART OF THEIR CONSTRUCTION MANAGEMENT OR QUALITY PLAN FOR THE SITE.
- 5 THE CONTRACTOR IS TO ARRANGE A PRE-CONSTRUCTION MEETING WITH BCC SOIL CONSERVATION CONSULTANT AND THE SUPERINTENDENT.
- 6 ALL MEASURES INCLUDING DIVERSION BANKS, CATCH AND DIVERSION DRAINS AND SILT FENCES SHALL BE COMPLETED PRIOR TO COMMENCEMENT OF CONTRACT WORKS
- 7 DURING WINDY WEATHER, LARGE UNPROTECTED AREAS WILL BE KEPT MOIST (NOT WET) BY SPRAYING WITH CLEAN WATER TO CONTROL DUST
- HAVE MEASURES APPLIED, SUCH AS SILT FENCING, TO PREVENT EROSION OF THE STOCKPILE. 9 CLEAN WATER IS TO BE DIVERTED AWAY FROM DISTURBED GROUND AND INTO THE DRAINAGE SYSTEM. ANY WATER

8 ALL STOCKPILES MUST NOT BE LOCATED IN AREAS SUBJECT TO LIKELY CONCENTRATIONS OF OVERLAND FLOWS, AND

ENTERING THE DRAINAGE SYSTEM MUST BE SEDIMENT FREE.

OTHER ENVIRONMENTAL NOTES

10 ACCEPTABLE RECEPTORS WILL BE PROVIDED FOR CONCRETE AND MORTAR SLURRIES, PAINTS, ACID WASHING, LIGHT WEIGHT MATERIALS AND LITTER.

STORMWATER DRAINAGE

- STORMWATER DESIGN CRITERIA ROAD DRAINAGE
- 20 YEAR ARI MINOR STORM EVENT 100 YEAR ARI - MAJOR STORM EVENT
- 2 PIPES 375mm DIA AND LARGER TO BE REINFORCED CONCRETE CLASS'4', 10/20 COVER, APPROVED SPIGGOT AND SOCKET WITH RUBBER RING JOINTS U.N.O. ALL PIPEWORK IS TO BE LAID WITH THE SOCKET FACING UPSTREAM. ALL WORKS ARE TO COMMENCE AT THE OUTLET END OF EACH LINE.
- 3 PIPES TO BE INSTALLED TO TYPE HS3 SUPPORT UNDER ROADS, PATHS AND DRIVEWAYS, AND TO TYPE HS2 ELSEWHERE, IN ACCORDANCE WITH AS3725. BACKFILLING AND MATERIALS IS TO BE IN ACCORDANCE WITH THE BACKFILLING SPECIFICATION.
- 4 PITS TO BE CONSTRUCTED IN ACCORDANCE WITH BCC STANDARD DETAILS. PRECAST PITS WILL NOT BE ACCEPTED UNLESS THROUGH EXPRESSED PERMISSION OF BCC.
- 5 CARE IS TO BE TAKEN WITH LEVELS OF STORMWATER LINES. GRADES SHOWN ARE NOT TO BE REDUCED WITHOUT APPROVAL.
- 6 GRATES AND COVERS SHALL CONFORM TO CITY OF SYDNEY SPECIFICATION (B10).
- 7 AT ALL TIMES DURING CONSTRUCTION, ADEQUATE SAFETY PROCEDURES SHALL BE TAKEN TO PREVENT PERSONNEL FROM FALLING INTO PITS AND OPEN TRENCHES.
- 8 ALL EXISTING STORMWATER DRAINAGE LINES AND PITS THAT ARE TO REMAIN, ARE TO BE INSPECTED AND CLEANED, AND ANY PART OF THAT SYSTEM IDENTIFIED AS WARRANTING REPAIR, SHALL BE REPORTED TO THE SUPERINTENDENT FOR FURTHER DIRECTION.
- 9 CONTRACTOR TO TAKE APPROPRIATE MEASURES TO PROTECT PIPES FROM DAMAGE DUE TO HEAVY CONSTRUCTION LOADING. CONTRACTOR TO UNDERTAKE PRE AND POST CONSTRUCTION CCTV INSPECTIONS FOR ALL PIPE LINES IMPACTED BY THE WORKS, TO BE PROVIDED TO LANDCOM FOR ACCEPTANCE PRIOR TO HAND-OVER.
- 10 THE CONTRACTOR IS TO MANAGE AND STAGE CONSTRUCTION WORKS, INCLUDING PROVIDING TEMPORARY DIVERSION WORKS IF NECESSARY, TO ENSURE ANY EXISTING DRAINAGE SYSTEM IS ABLE TO PERFORM TO ITS CURRENT STANDARD.
- 11 THE CONTRACTOR SHALL PROTECT THE WORKS IN PROGRESS. ANY DAMAGE TO THE WORKS IN PROGRESS, INCLUDING FROM STORMWATER FLOWS OR FLOODING, IS AT THE CONTRACTOR'S RISK.

SURVEY NOTES

THE SURVEY INFORMATION IS SHOWN TO PROVIDE A BASIS FOR DESIGN. AECOM DOES NOT GUARANTEE THE ACCURACY OR COMPLETENESS OF THE SURVEY BASE OR ITS SUITABILITY AS A BASIS FOR CONSTRUCTION DRAWINGS. SHOULD DISCREPANCIES BE ENCOUNTERED DURING CONSTRUCTION BETWEEN THE SURVEY DATA AND ACTUAL FIELD DATA, CONTACT THE SUPERINTENDENT.

UTILITY SERVICES

- 1 THIS DRAWING IS TO BE READ IN CONJUNCTION WITH ALL PUBLIC OR PRIVATE SERVICE PROVIDER DRAWING.,
- 2 EXISTING UTILITIES SHOWN ON DRAWINGS ARE INDICATIVE ONLY AND MAY NOT INCLUDE ALL SERVICES PRESENT.
- AECOM TAKES NO RESPONSIBILITY FOR THE UTILITY INFORMATION AS SHOWN ON THESE DRAWINGS. 3 IT IS THE CONTRACTORS RESPONSIBILITY TO LIAISE WITH EACH UTILITY SERVICE PROVIDER ON SITE, TO LOCATE AND IDENTIFY THE SIZE, POSITION, LINE AND LEVEL OF ALL UTILITY SERVICES IN BOTH PUBLIC AND PRIVATE LAND, PRIOR TO THE COMMENCEMENT OF ANY CONSTRUCTION ACTIVITIES.
- 4 THE CONTRACTOR MUST TAKE EVERY PRECAUTION TO PROTECT EXISTING AND NEW UTILITY SERVICES THROUGH THE COURSE OF THE CONTRACT.
- 5 THE EXECUTION OF ALL WORKS INVOLVING UTILITY SERVICES, EITHER NEW OR EXISTING, IS THE RESPONSIBILITY OF
- THE CONTRACTOR AND FORM PART OF THE CONTRACT PRICE, UNLESS SPECIFICALLY NOTED OTHERWISE. 6 ALL WORKS INVOLVING UTILITY SERVICES TO BE UNDERTAKEN TO THE SATISFACTION OF THE UTILITY SERVICE
- PROVIDER. THE CONTRACTOR WILL BE RESPONSIBLE FOR ENGAGING WITH THE UTILITY SERVICE PROVIDER, THE EXECUTION OF THE WORK TO THEIR REQUIREMENTS AND PROCUREMENT OF APPROVALS FOR WORKS UNDERTAKEN.
- 6 ALL WORKS INVOLVING UTILITY SERVICES MUST ONLY BE UNDERTAKEN USING PLANS APPROVED BY THE UTILITY SERVICE PROVIDER. 7 THE CONTRACTOR SHALL ALLOW IN THEIR CONTRACT PRICE FOR CONDUIT CROSSINGS UNDER THE PROPOSED ROADS
- AS SHOWN ON THE DRAWINGS. ALL UTILITY AUTHORITY REPRESENTATIVES TO INSPECT THEIR CONDUIT CROSSINGS PRIOR TO PAVEMENT SEALING.
- 8 THE CONTRACTOR IS TO COORDINATE THE INSTALLATION OF ELECTRICITY, GAS AND TELECOMMUNICATIONS SERVICES. ELECTRICITY, GAS AND TELECOMMUNICATIONS SERVICES ARE TO BE LAID FOLLOWING THE INSTALLATION OF STORMWATER, SEWER AND WATER SERVICES, AND KERB AND GUTTER.
- 9 ALL SERVICE PIT COVERS AND MARKERS ARE TO BE PLACED IN ACCORDANCE WITH THE LOCATIONS AS SHOWN ON THE PUBLIC DOMAIN DRAWINGS. AND IN ACCORDANCE WITH THE DRAWINGS AND SPECIFICATION.
- 10 ALL SERVICE PIT COVERS TO BE PLACED AT FINISHED SURFACE LEVELS TO MATCH THE PROPOSED LONGITUDINAL AND
- CROSS FALL GRADES OF THE FOOTPATH OR ROADWAY IT IS CONTAINED WITHIN. 11 NO PIPE OR TRENCH SHALL BE LOCATED WITHIN THE ZONE OF INFLUENCE (1V:2H) OF A FOOTING.
- 12 MINIMUM CLEARANCES BETWEEN SERVICES TO BE PROVIDED UNLESS DIRECTED BY THE SUPERINTENDENT. 13 "WORKS AS CONSTRUCTED" SURVEY ON ALL UTILITY WORK SHALL BE RECORDED PRIOR TO ANY BACKFILLING.

TELSTRA DUTY OF CARE

TELSTRA'S PLANS SHOW ONLY THE PRESENCE OF CABLES AND PLANT. THEY ONLY SHOW THEIR POSITION RELATIVE TO ROAD BOUNDARIES, PROPERTY FENCES ETC. AT THE TIME OF INSTALLATION AND TELSTRA DOES NOT WARRANT OR HOLD OUT THAT SUCH PLANS ARE ACCURATE THEREAFTER DUE TO CHANGES THAT MAY OCCUR OVER TIME. DO NOT ASSUME DEPTH OR ALIGNMENT OF CABLES OR PLANT AS THESE VARY SIGNIFICANTLY. THE CONTRACTOR HAS A DUTY OF CARE WHEN EXCAVATING NEAR TELSTRA CABLES AND PLANT. BEFORE USING MACHINE EXCAVATORS, TELSTRA PLANT MUST FIRST BE PHYSICALLY EXPOSED BY SOFT DIG POTHOLING TO IDENTIFY IT'S LOCATION. TELSTRA WILL SEEK COMPENSATION FOR DAMAGES CAUSED TO IT'S PROPERTY AND LOSSES CAUSED TO TELSTRA AND IT'S CUSTOMERS

KERB NOTES

JOINT LOCATIONS IN THE SLABS.

- 1 ALL CONCRETE FOR KERBS TO HAVE A MINIMUM COMPRESSIVE STRENGTH OF 25 MPa U.N.O. IN THE DRAWINGS.
- 2 ALL KERBS, GUTTERS AND CROSSINGS TO BE CONSTRUCTED ON 150mm (DGB20), COMPACTED TO MINIMUM 98%
- STANDARD MDD (AS1289 5.2.1) 3 EXPANSION JOINTS (E.J.) TO BE FORMED FROM 15mm COMPRESSIBLE CORK FILLER BOARD FOR THE FULL DEPTH OF SECTION AND CUT TO PROFILE. EXPANSION JOINTS TO BE LOCATED AT PITS, ON TANGENT POINTS OF CURVES, AND ELSEWHERE AT 12m CENTRES, EXCEPT FOR INTEGRAL KERBS WHERE THE EXPANSION JOINTS ARE TO MATCH THE
- 4 WEAKENED PLANE JOINTS TO BE 5mm WIDE AND LOCATED AT 3m CENTRES, EXCEPT FOR INTEGRAL KERBS WHERE THE WEAKENED PLANE JOINTS ARE TO MATCH THE JOINT LOCATIONS IN THE SLABS.
- 5 BROOMED FINISH TO ALL RAMPED AND VEHICULAR CROSSINGS. ALL OTHER KERBING OR DISH DRAINS TO BE STEEL
- 6 IN REPLACEMENT OF KERB AND GUTTER, THE EXISTING ROAD PAVEMENT IS TO BE SAWCUT AND REINSTATED IN ACCORDANCE WITH THE STANDARD DETAIL IN THESE DRAWINGS.
- 7 PRAM RAMPS SHALL BE IN ACCORDANCE WITH STANDARD DETAIL IN THESE DRAWINGS AND ALL LOCATIONS ARE TO BE VERIFIED ON SITE WITH THE SUPERINTENDENT PRIOR TO COMMENCEMENT OF CONSTRUCTION.



PROJECT

CUDGEGONG ROAD STATION PRECINCT TOWN CENTRE SOUTH CIVIL PACKAGE

CLIENT



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A | 18/05/2018 | ISSUED FOR PRELIMINARY DESCRIPTION I/R DATE

KEY PLAN


PROJECT NUMBER

60558549 **SHEET TITLE**

GENERAL NOTES

SHEET 01


SHEET NUMBER

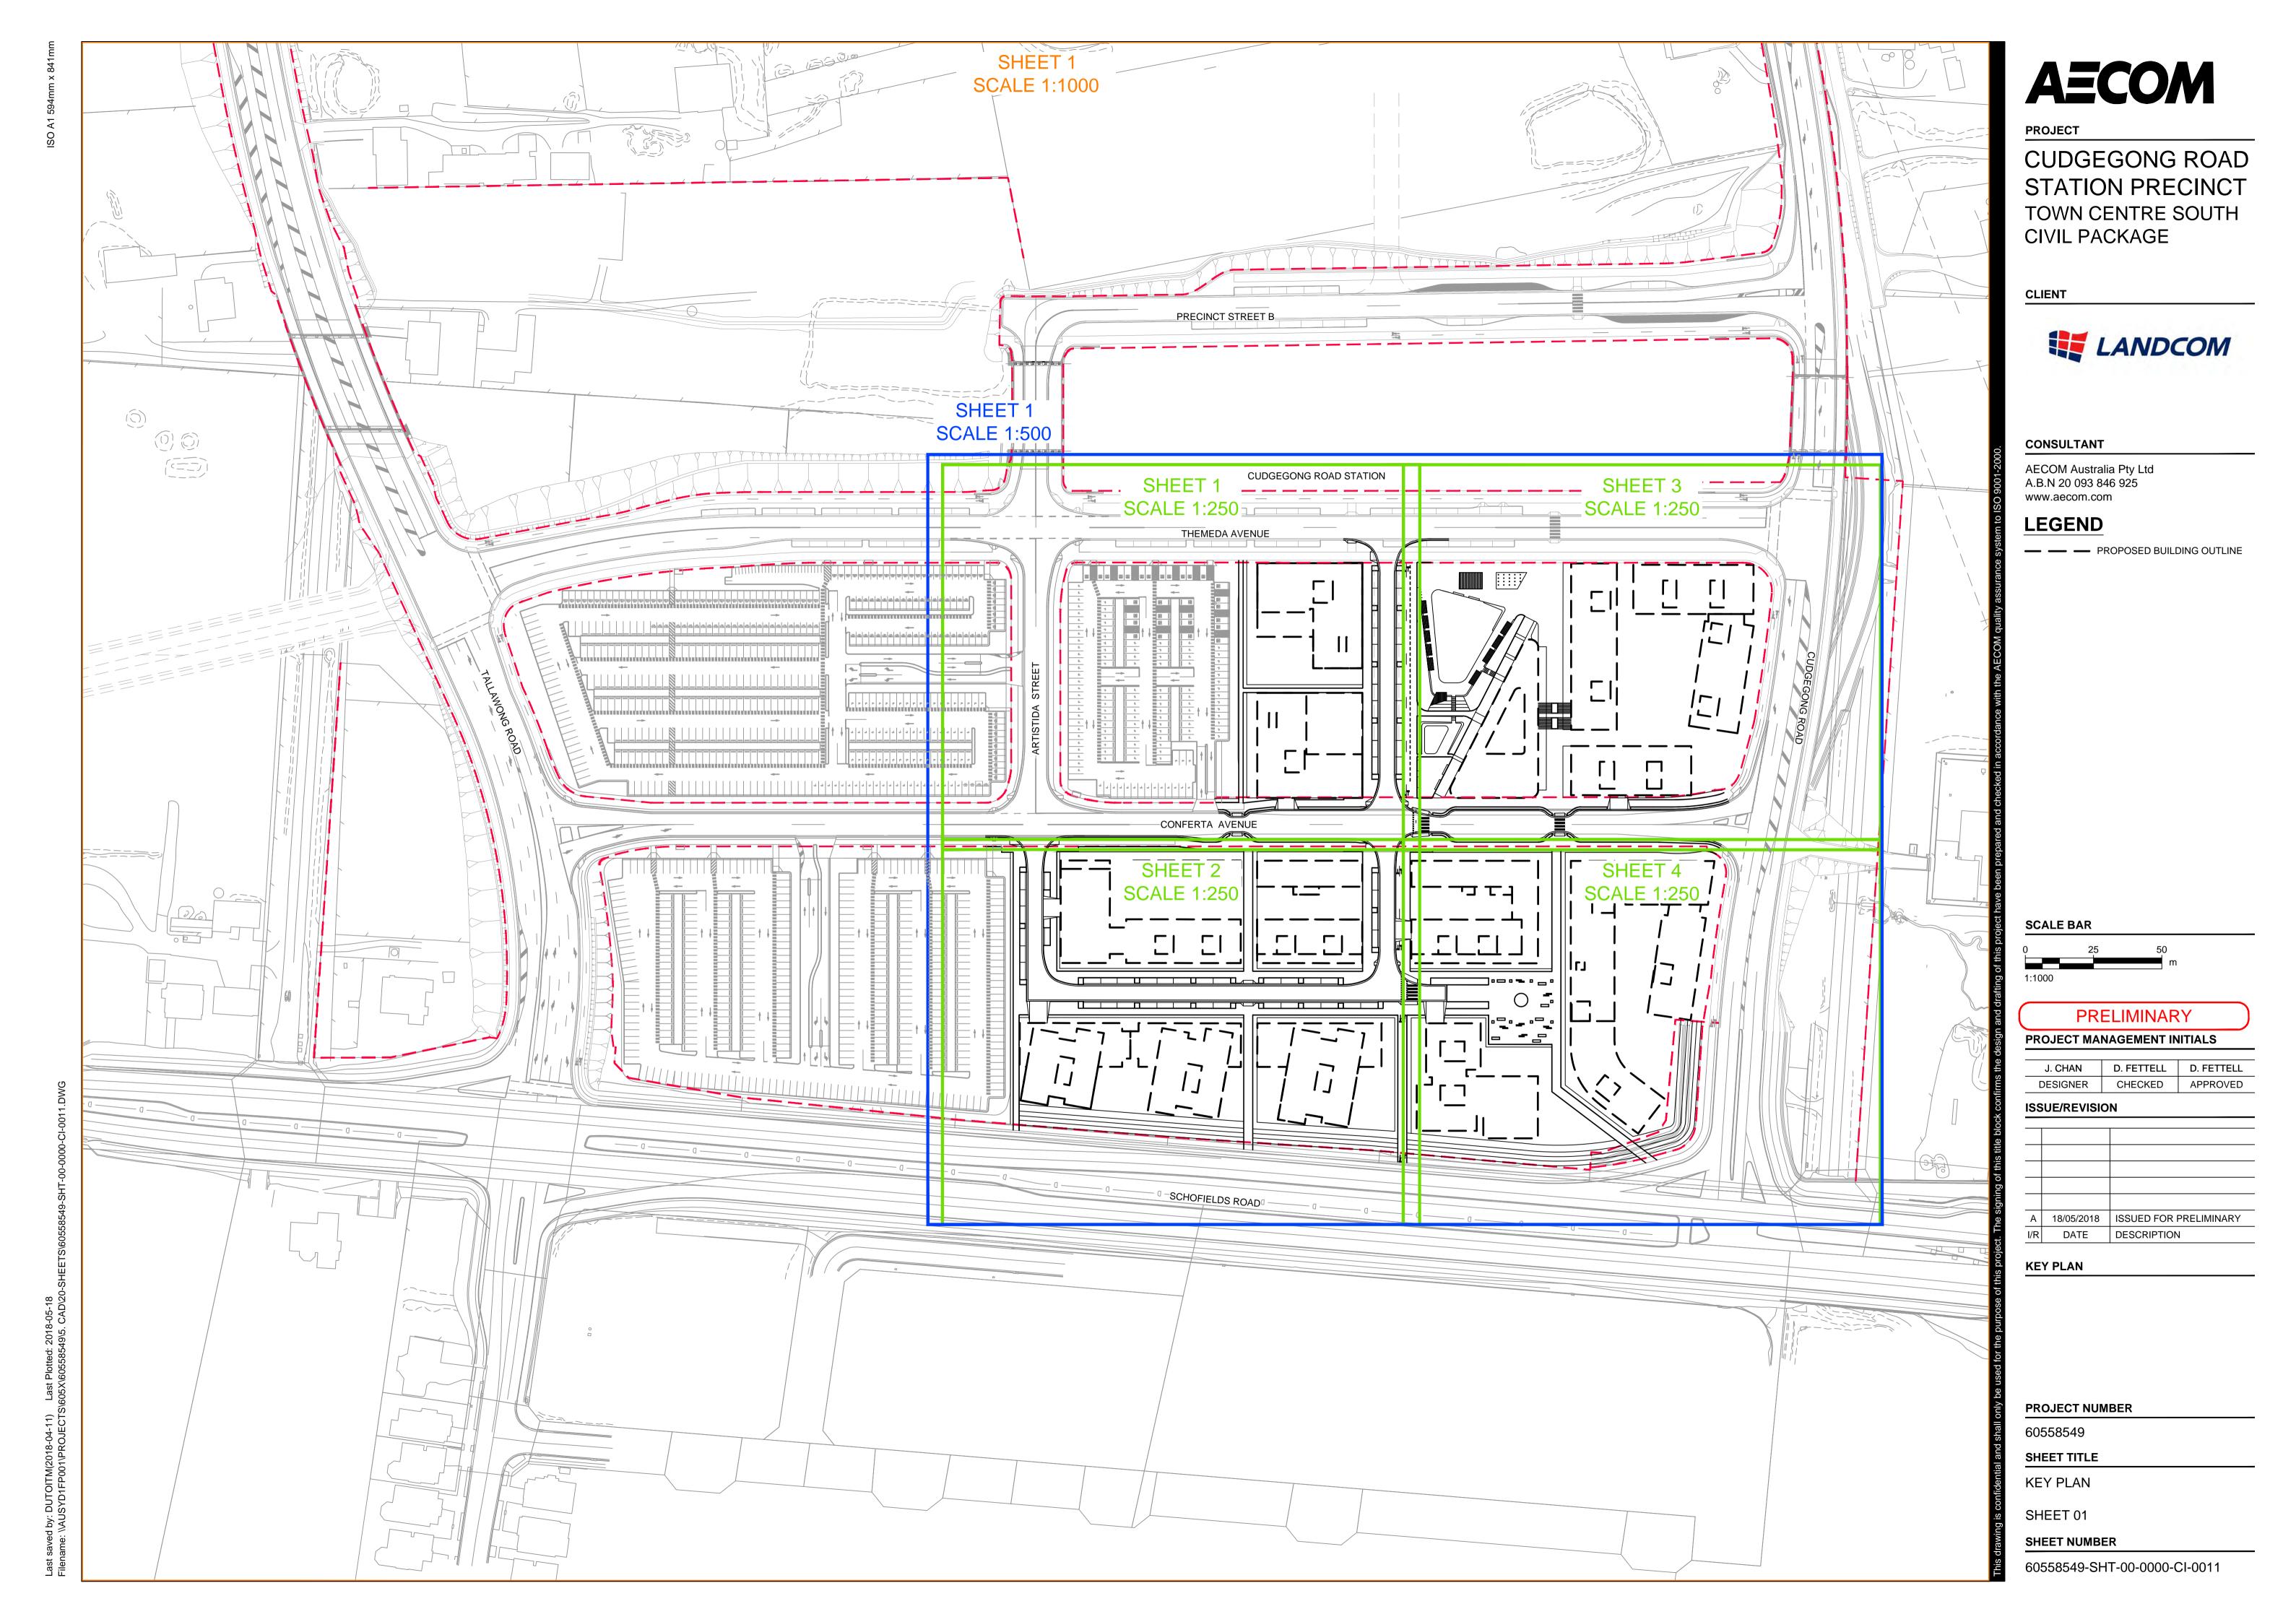

STATION PRECINCT TOWN CENTRE SOUTH

	DESIGNER	CHECKED	APPROVED		
ISS	ISSUE/REVISION				

SHEET NUMBER

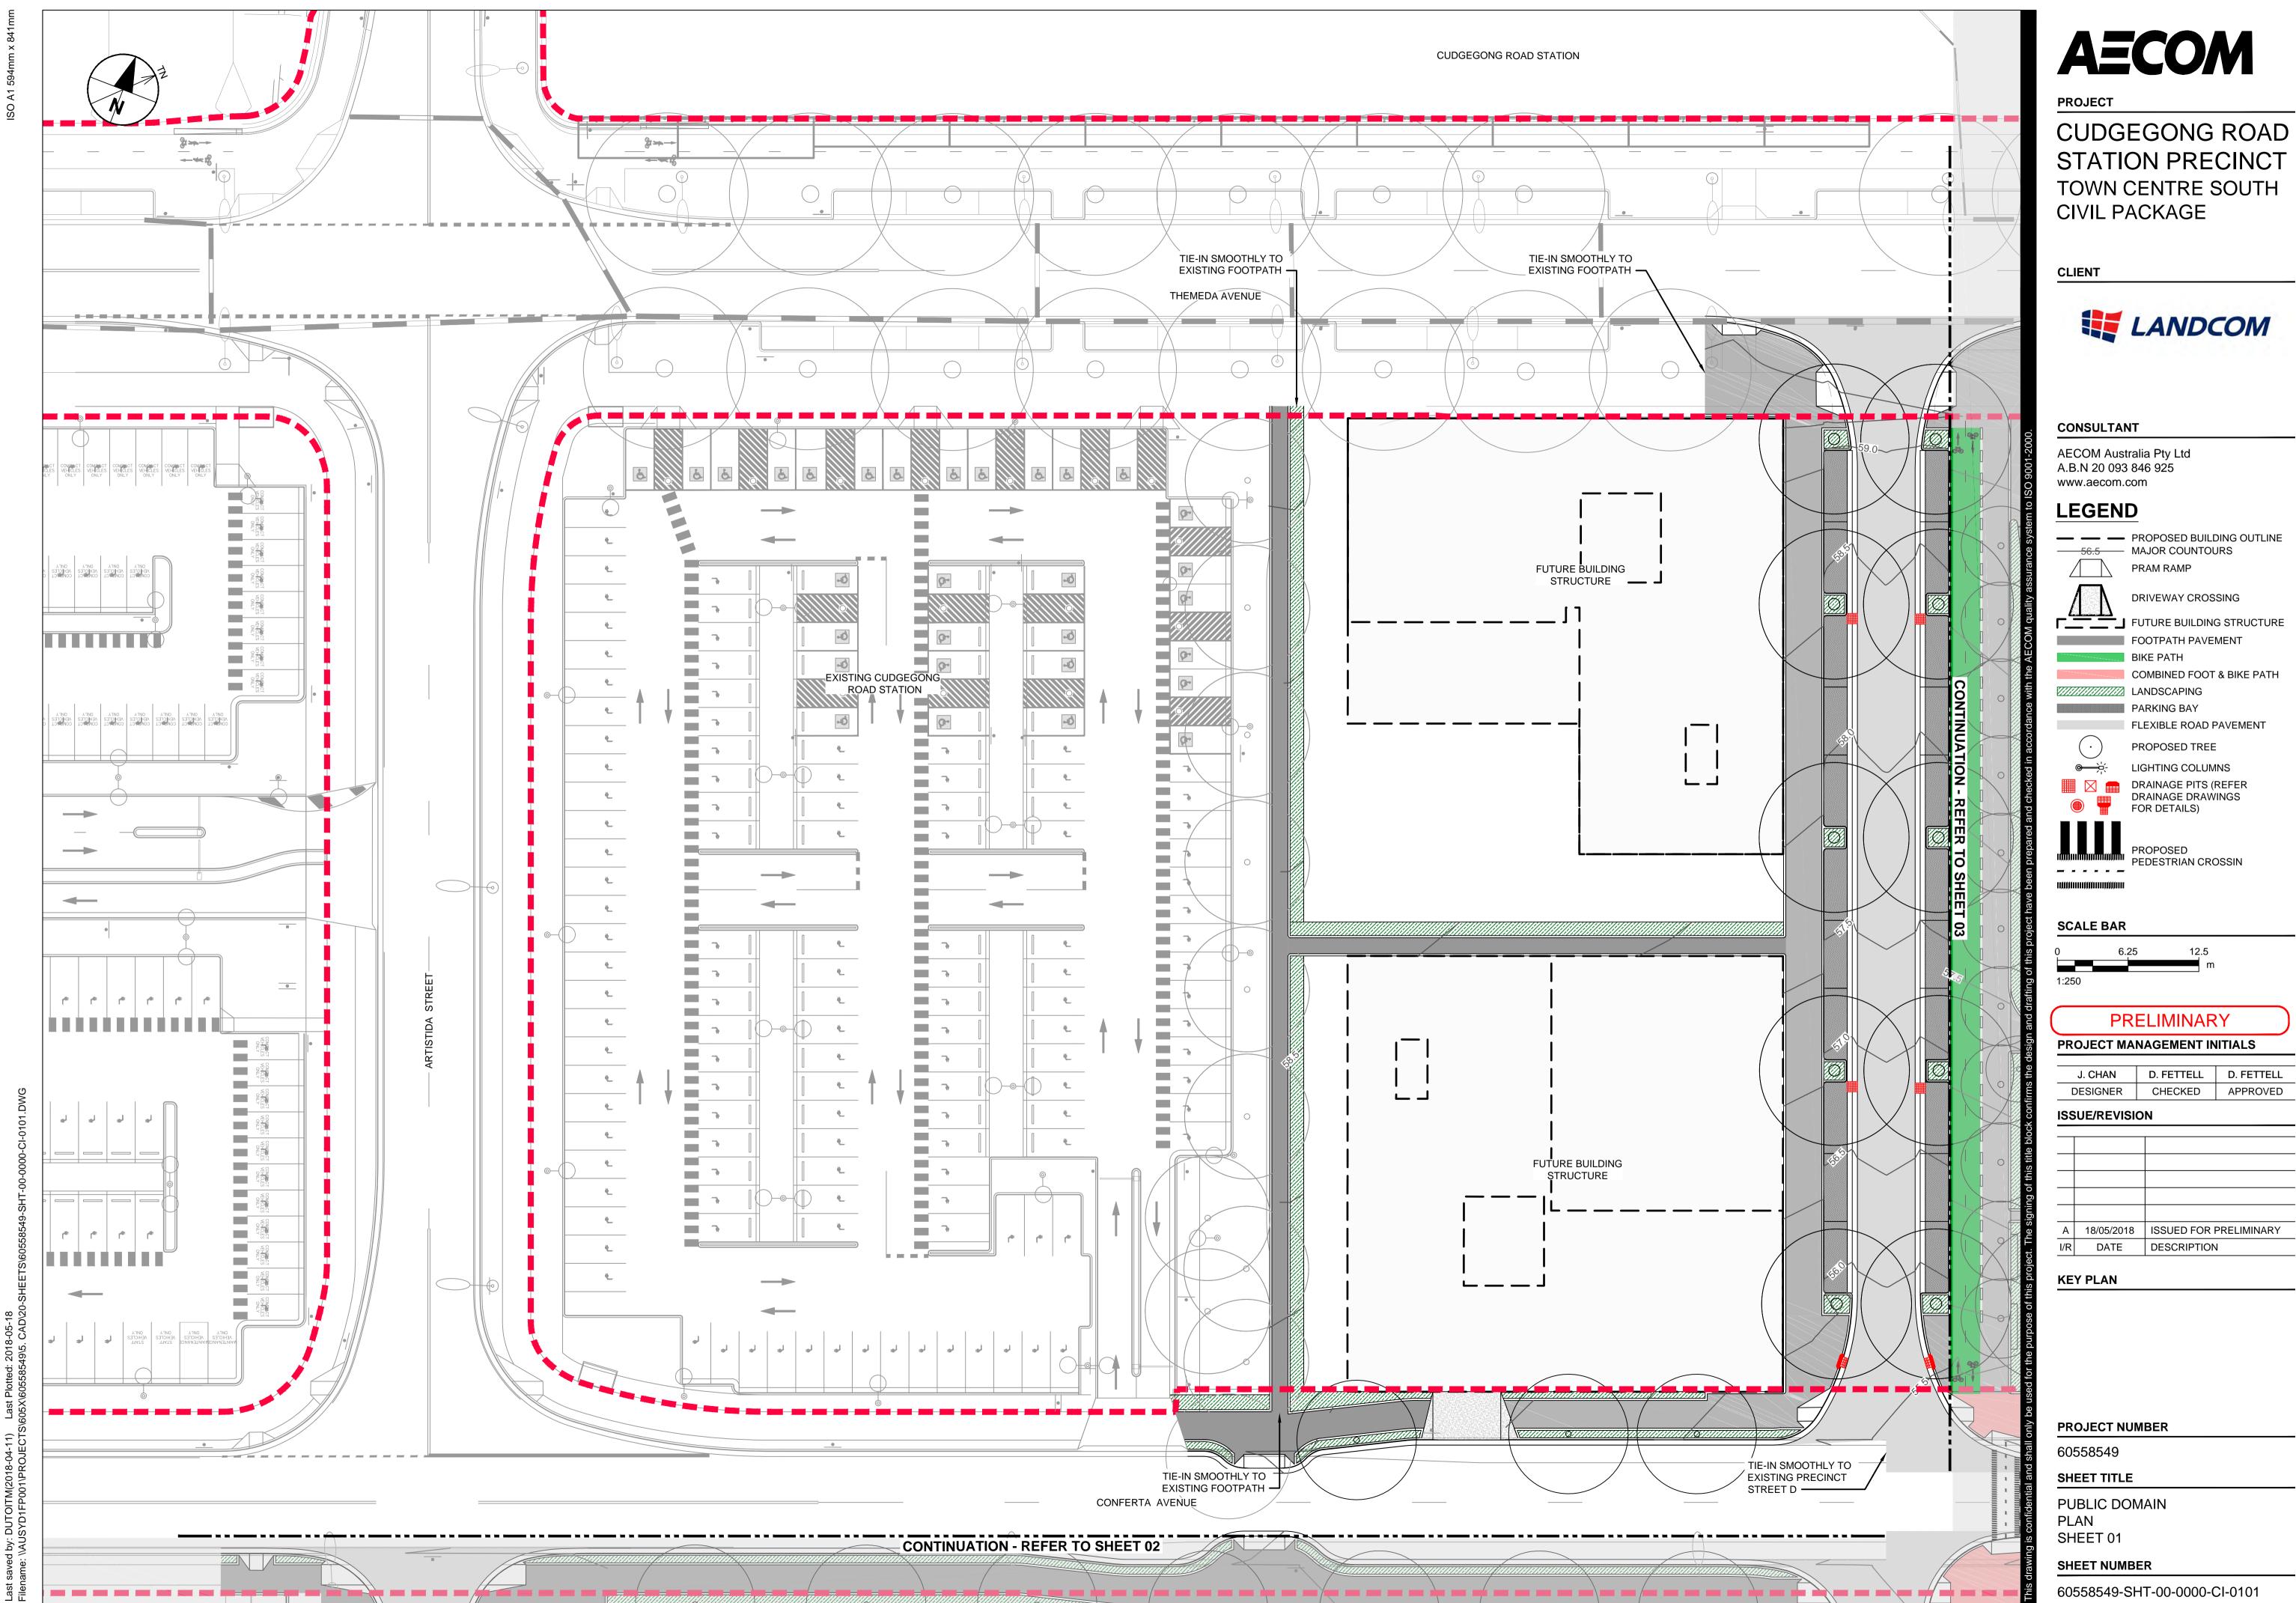

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DESIGNER	CHECKED	APPROVED	

AECOM

CUDGEGONG ROAD STATION PRECINCT TOWN CENTRE SOUTH CIVIL PACKAGE

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LEGEND

— — PROPOSED BUILDING OUTLINE PRAM RAMP

DRIVEWAY CROSSING FUTURE BUILDING STRUCTURE

> BIKE PATH COMBINED FOOT & BIKE PATH LANDSCAPING

> > PROPOSED TREE LIGHTING COLUMNS

PARKING BAY

DRAINAGE PITS (REFER DRAINAGE DRAWINGS FOR DETAILS)

PROPOSED PEDESTRIAN CROSSIN

SCALE BAR

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Α	18/05/2018	ISSUED FOR PRELIMINARY
I/R	DATE	DESCRIPTION

KEY PLAN

PROJECT NUMBER

60558549

SHEET TITLE

PUBLIC DOMAIN

SHEET 03

SHEET NUMBER 60558549-SHT-00-0000-CI-0103

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Α	18/05/2018	ISSUED FOR PRELIMINARY
I/R	DATE	DESCRIPTION


SHEET NUMBER


NOTES

1. REFER TO SCHEDULE FOR CUDGEGONG ROAD (AREA 20) PRECINCT DEVELOPMENT CONTROL PLAN AND BLACKTOWN CITY COUNCIL GROWTH CENTER PRECINCT DEVELOPMENT CONTROL PLAN FOR FURTHER DETAILS ON ROAD CROSS SECTIONS.

FURTHER DETAILS ON ROAD CROSS SECTIONS.

2. REFER TO BLACKTOWN CITY COUNCIL ENGINEERING GUIDE FOR DEVELOPMENT (2005) FOR FURTHER INFORMATION ON REQUIRED CRADING.

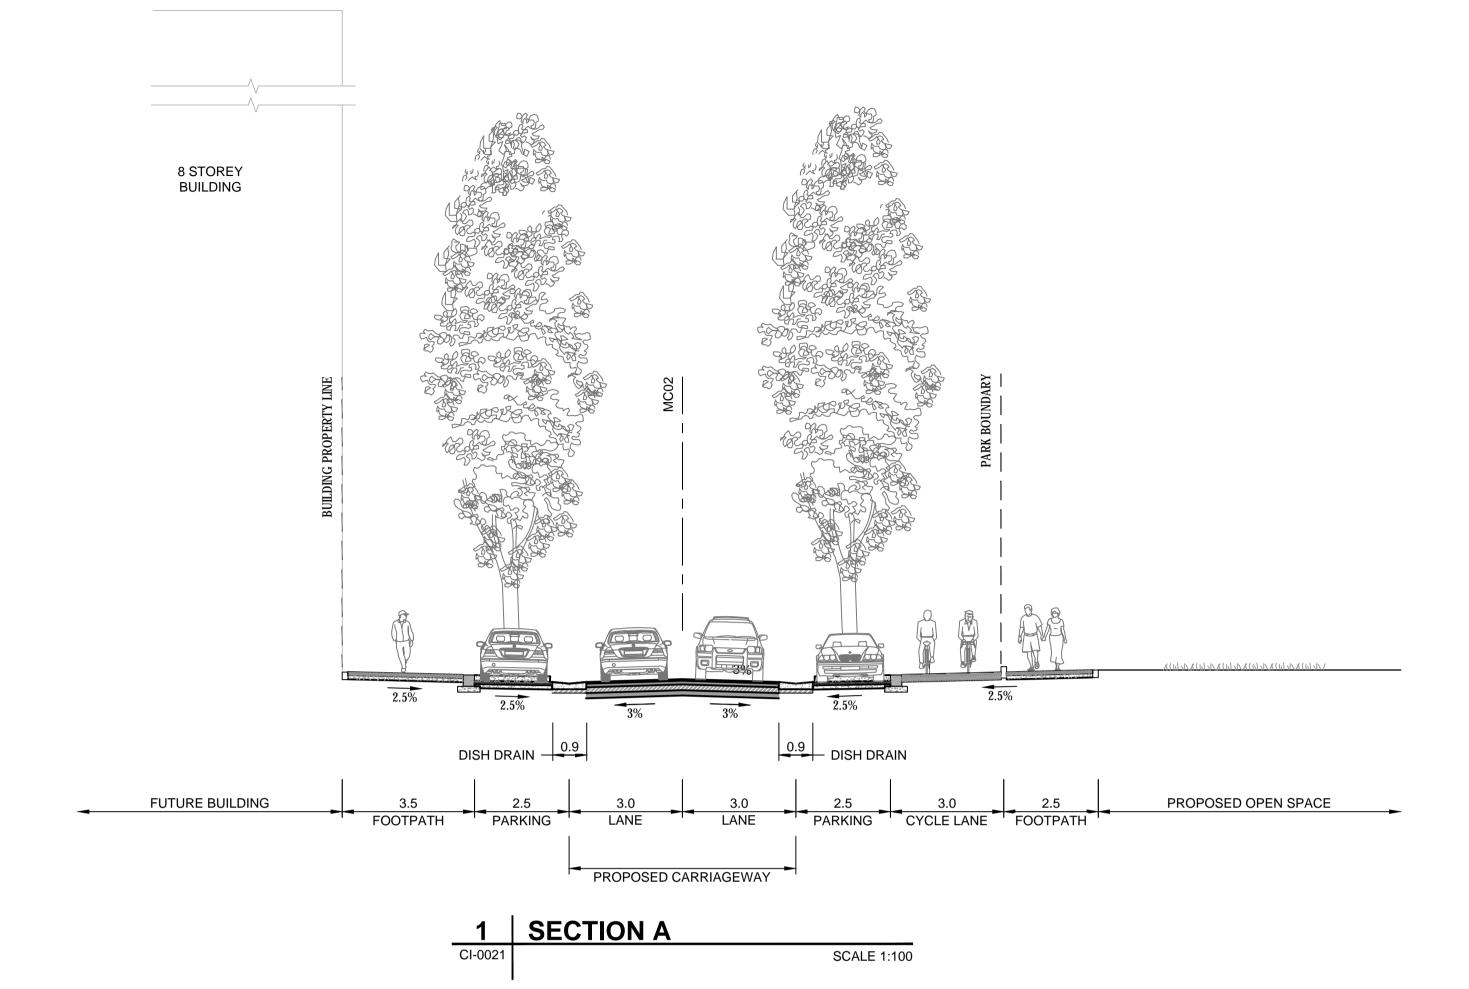

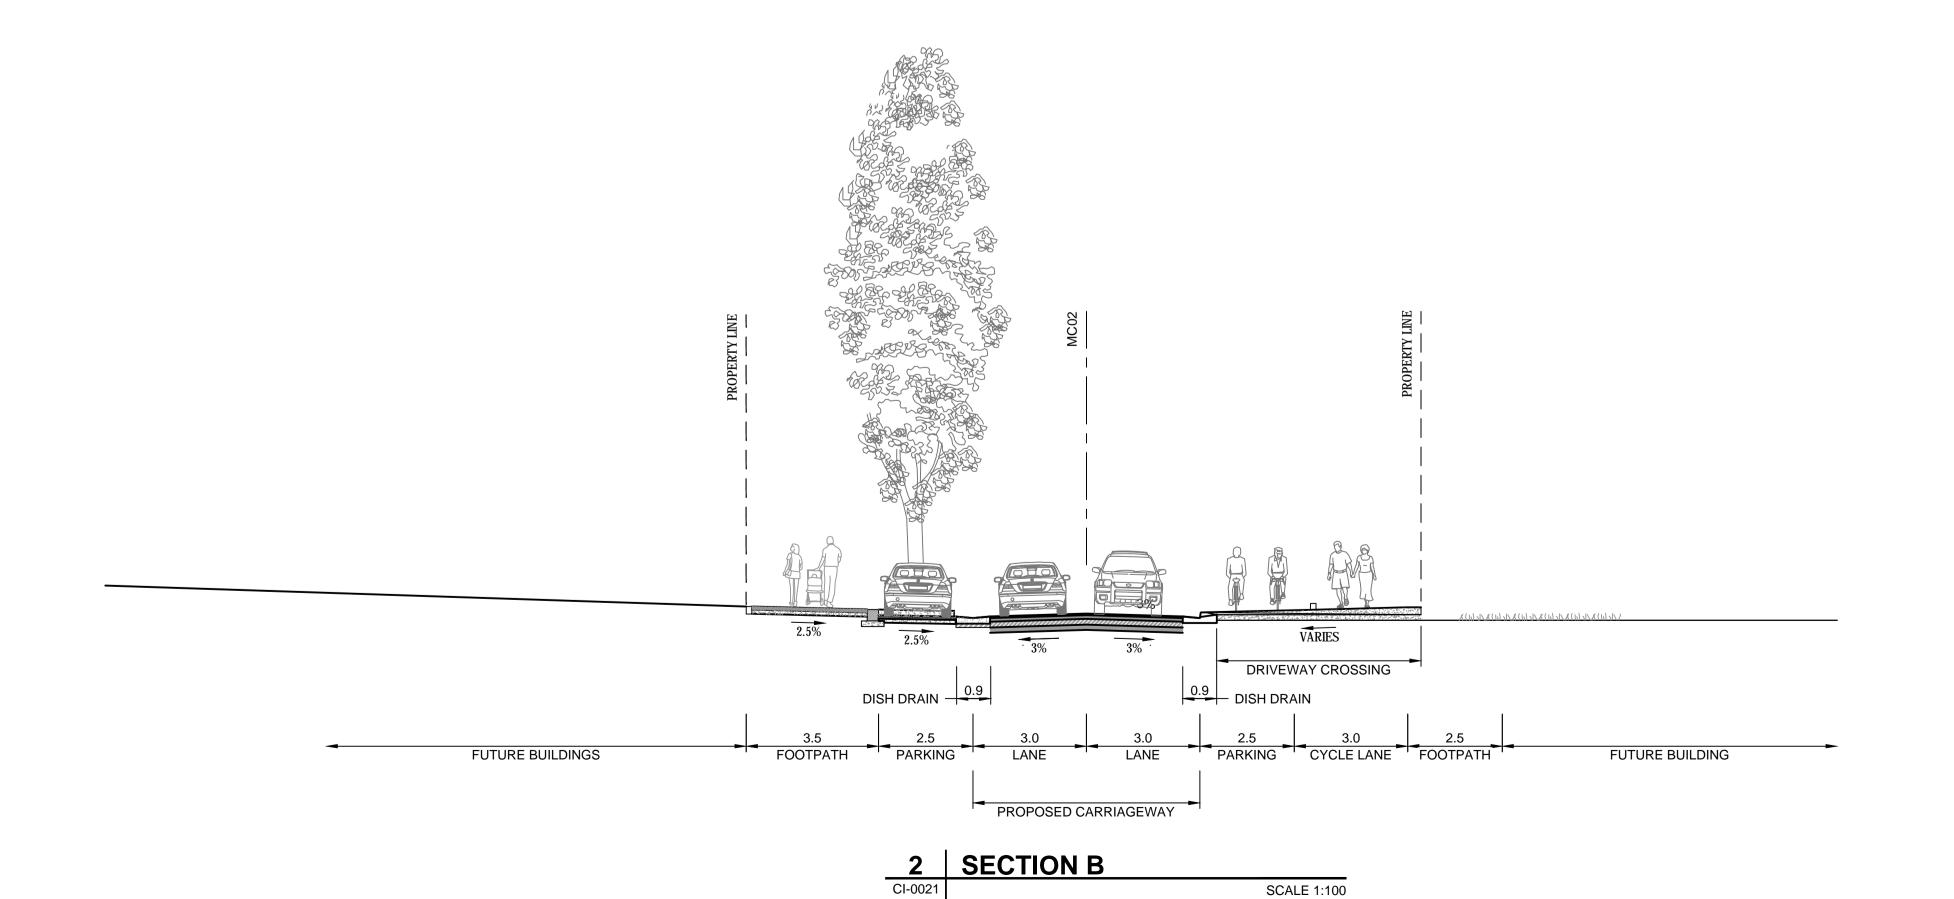

AECOM

PROJECT

CUDGEGONG ROAD STATION PRECINCT TOWN CENTRE SOUTH CIVIL PACKAGE


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KEY PLAN

PROJECT NUMBER

60558549

SHEET TITLE

TYPICAL SITE SECTION

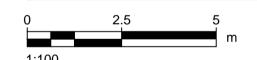
SHEET 01

SHEET NUMBER

1. REFER TO SCHEDULE FOR CUDGEGONG ROAD (AREA 20) PRECINCT DEVELOPMENT CONTROL PLAN AND BLACKTOWN CITY COUNCIL GROWTH CENTER PRECINCT DEVELOPMENT CONTROL PLAN FOR FURTHER DETAILS ON ROAD CROSS SECTIONS.

GROWTH CENTER PRECINCT DEVELOPMENT CONTROL PLAN FOR FURTHER DETAILS ON ROAD CROSS SECTIONS.

2. REFER TO BLACKTOWN CITY COUNCIL ENGINEERING GUIDE FOR DEVELOPMENT (2005) FOR FURTHER INFORMATION ON REQUIRED GRADING

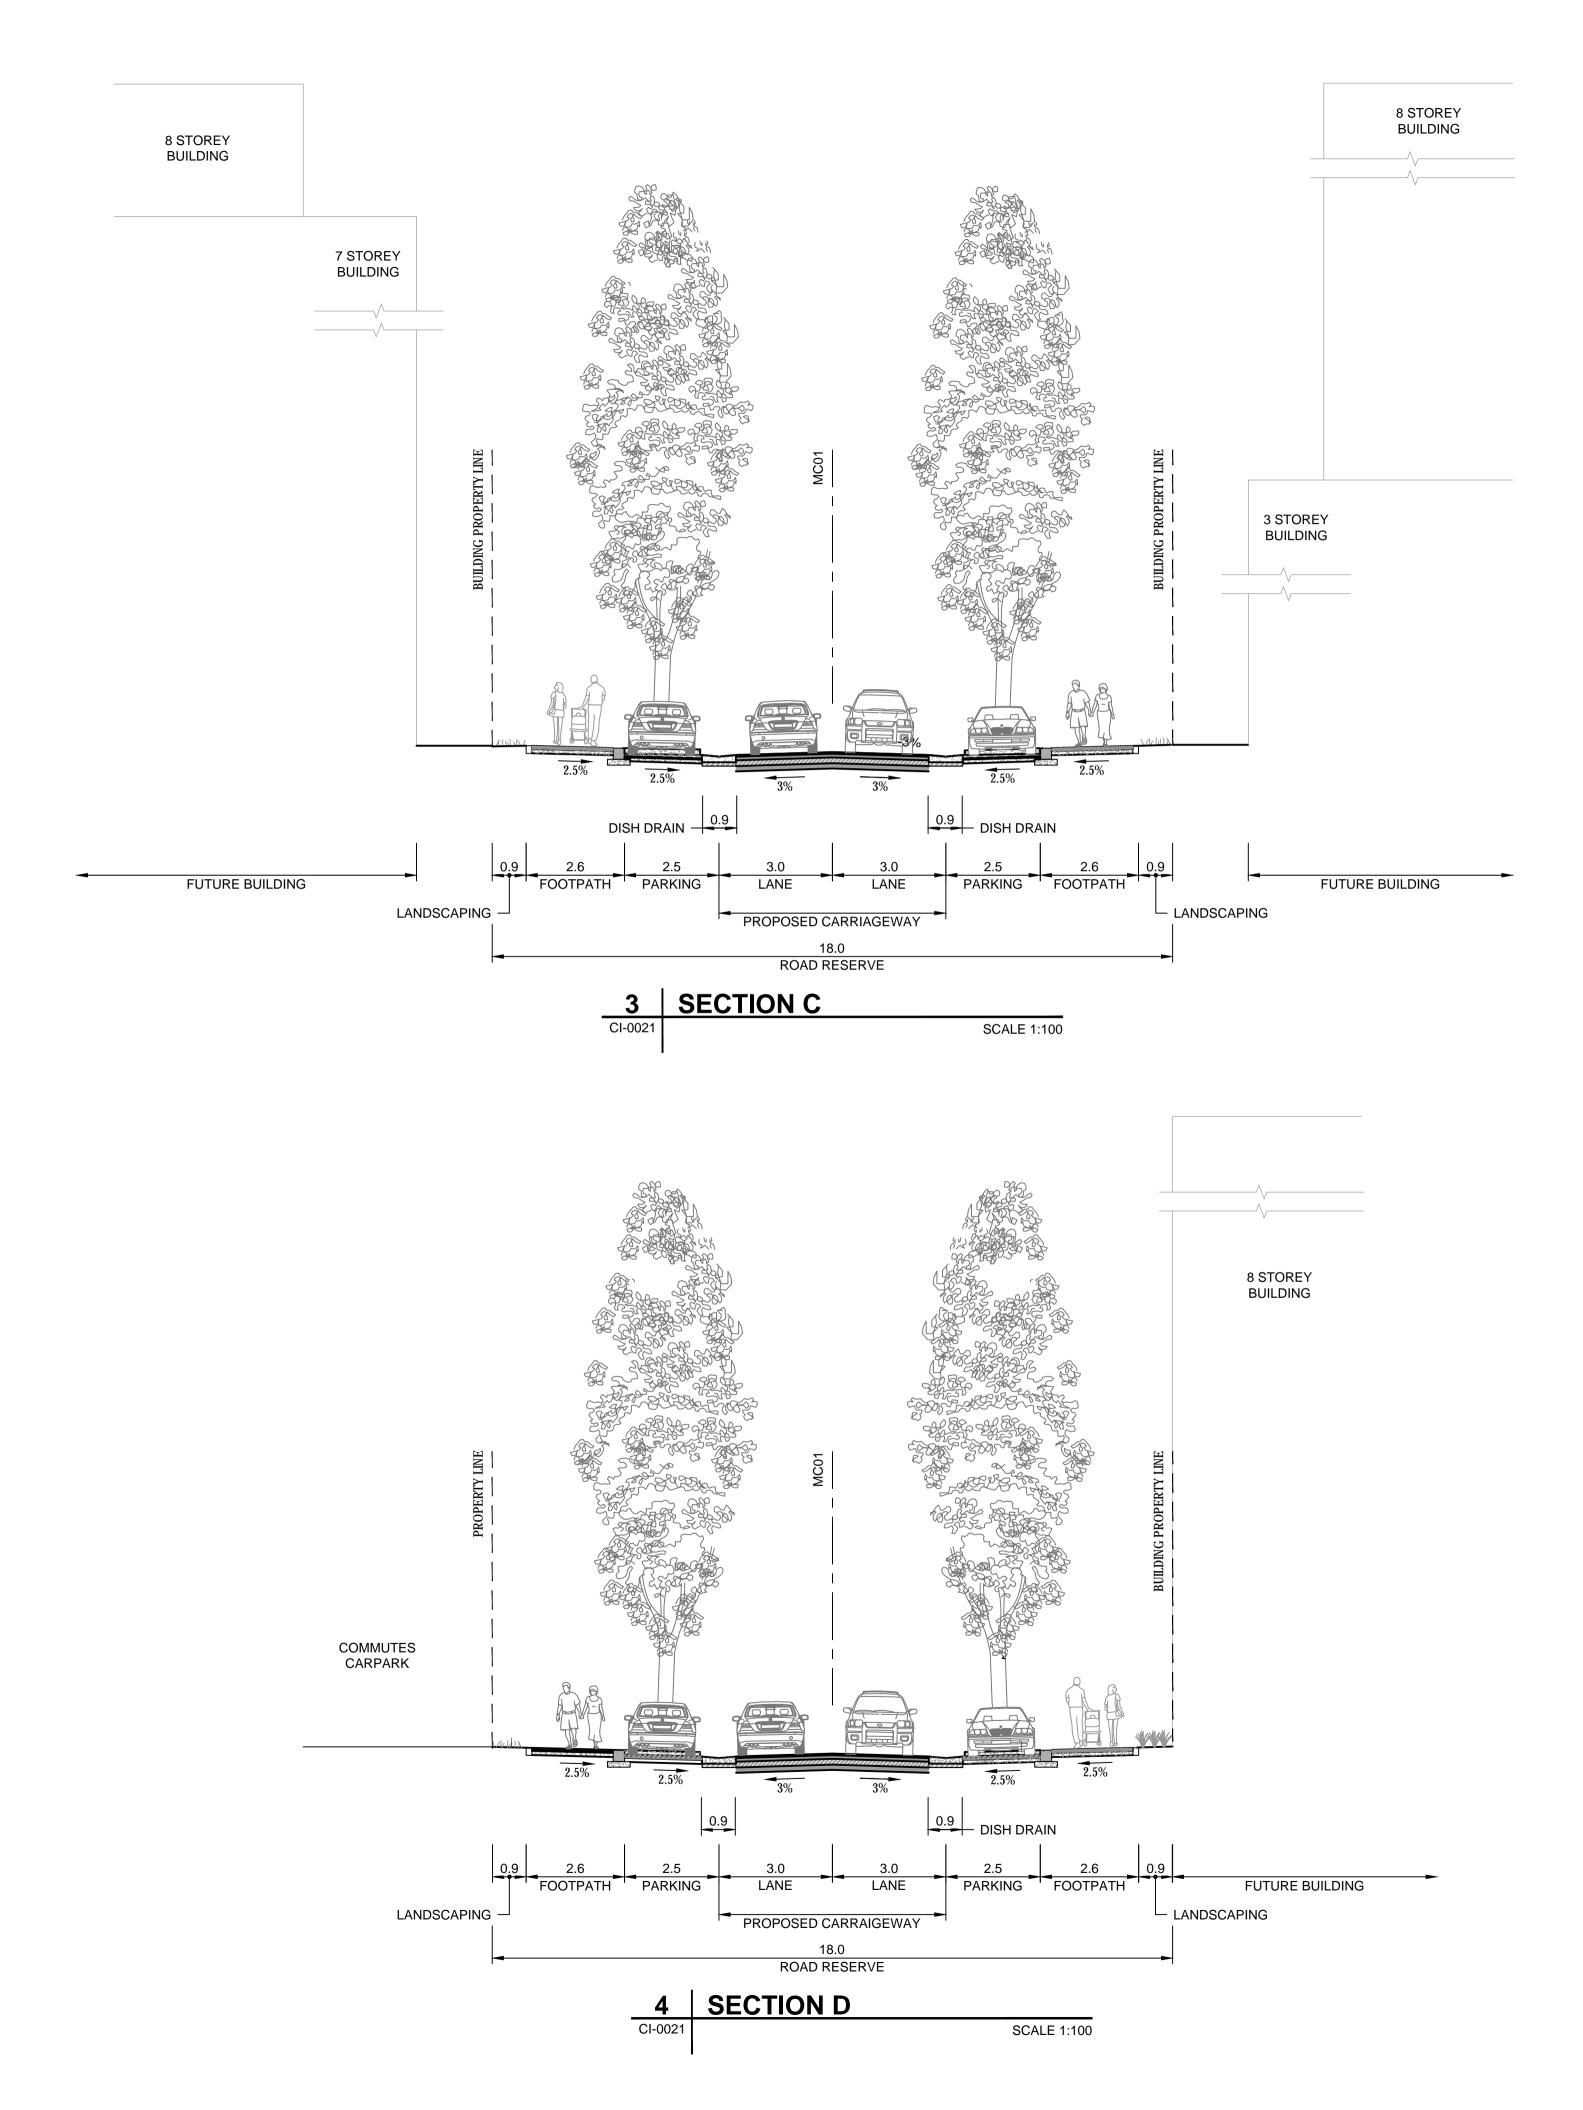



PROJECT

CUDGEGONG ROAD STATION PRECINCT TOWN CENTRE SOUTH CIVIL PACKAGE

CLIENT



CONSULTANT

AECOM Australia Pty Ltd A.B.N 20 093 846 925 www.aecom.com





PRELIMINARY

PROJECT MANAGEMENT INITIALS

J. CHAN D. FETTELL D. FETTELL

DESIGNER	CHECKED	APPROVED
ISSUE/REVISION	ON	

Α	18/05/2018	ISSUED FOR PRELIMINARY
I/R	DATE	DESCRIPTION

KEY PLAN

PROJECT NUMBER

60558549

SHEET TITLE

TYPICAL SITE SECTION

SHEET 02


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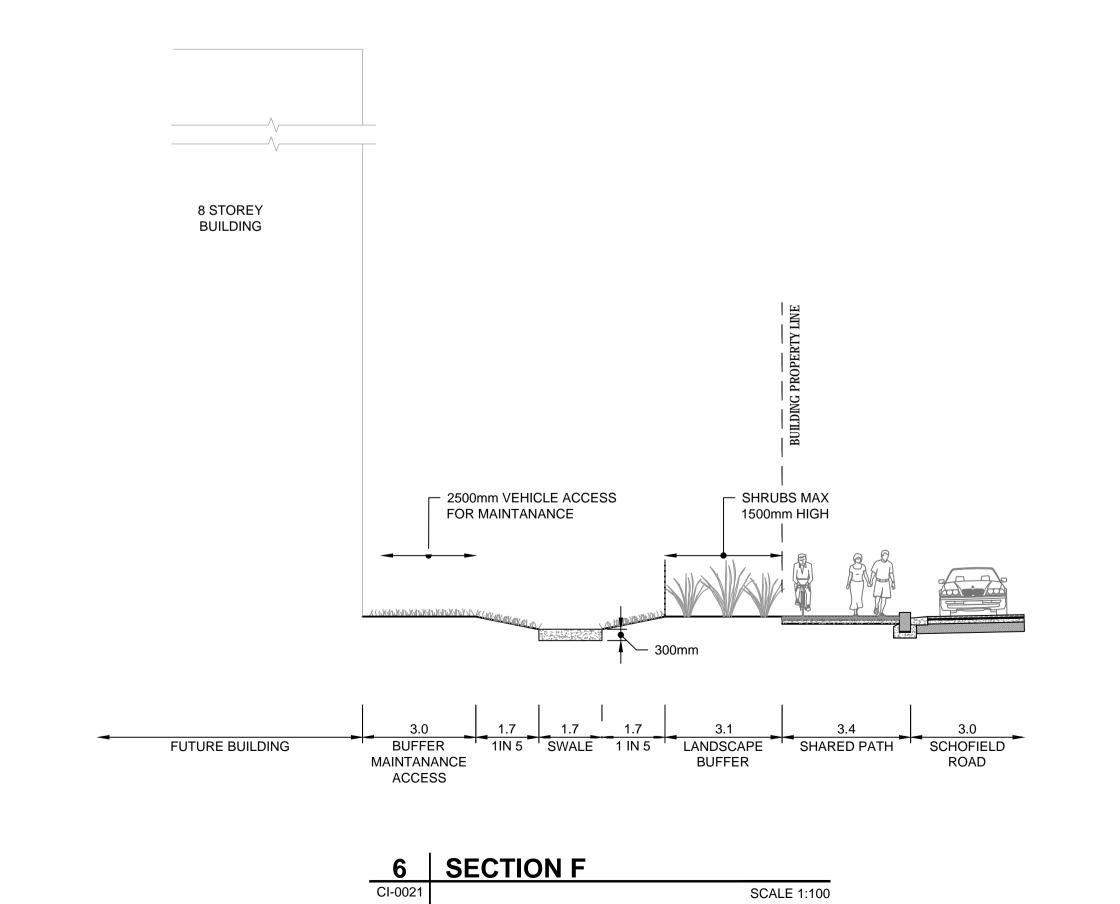
NOTES

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PROJECT

CUDGEGONG ROAD STATION PRECINCT TOWN CENTRE SOUTH CIVIL PACKAGE


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SCALE BAR

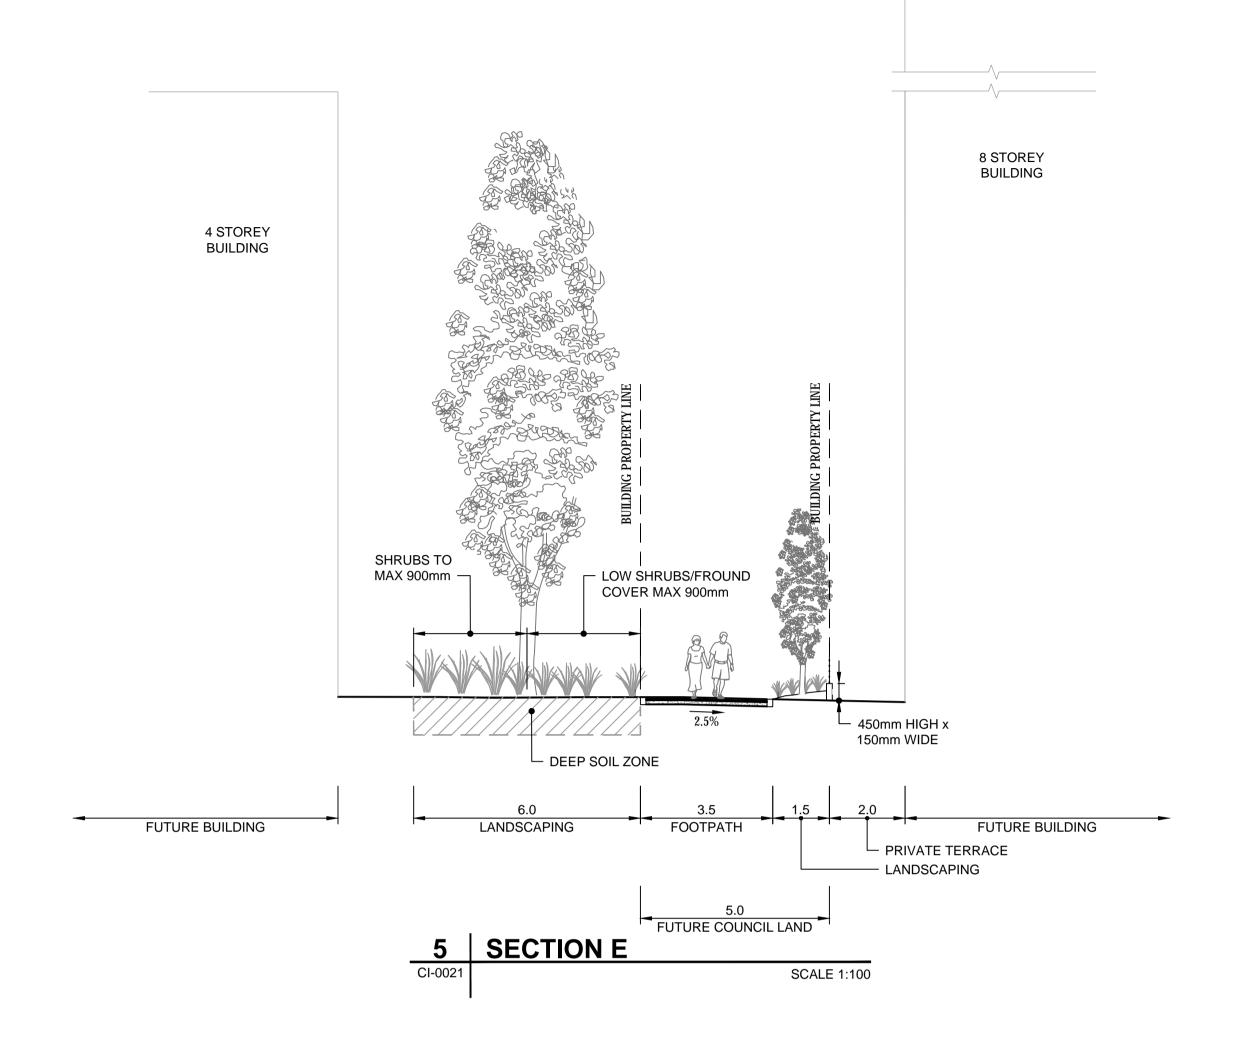

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SHEET TITLE

TYPICAL SITE SECTION


SHEET 03

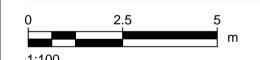SHEET NUMBER


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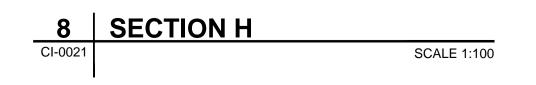
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SHEET TITLE

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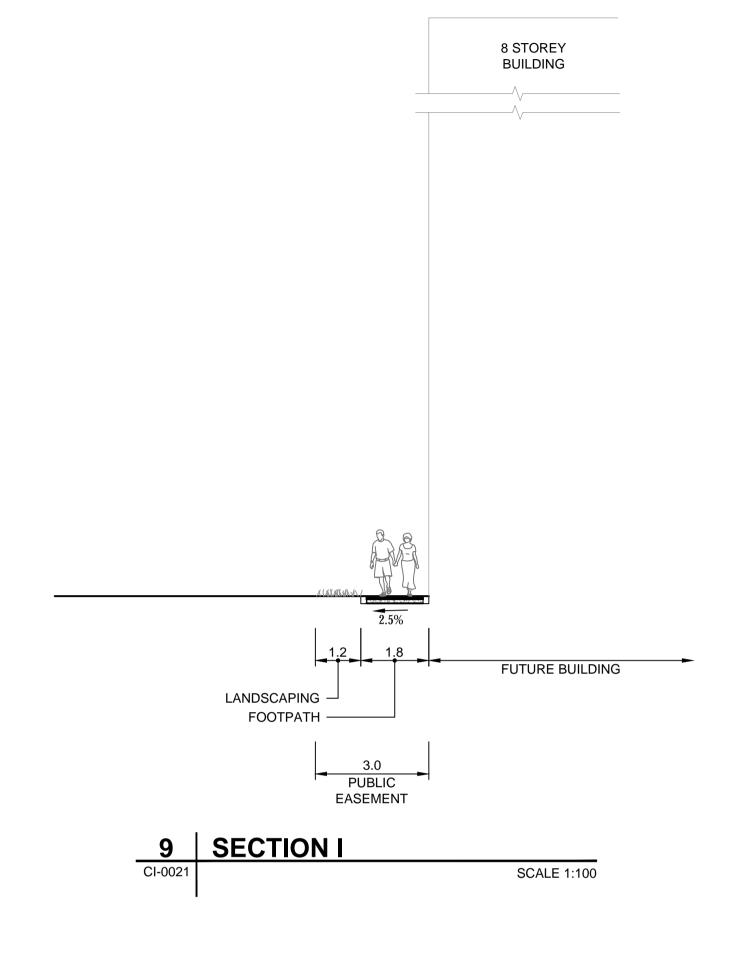
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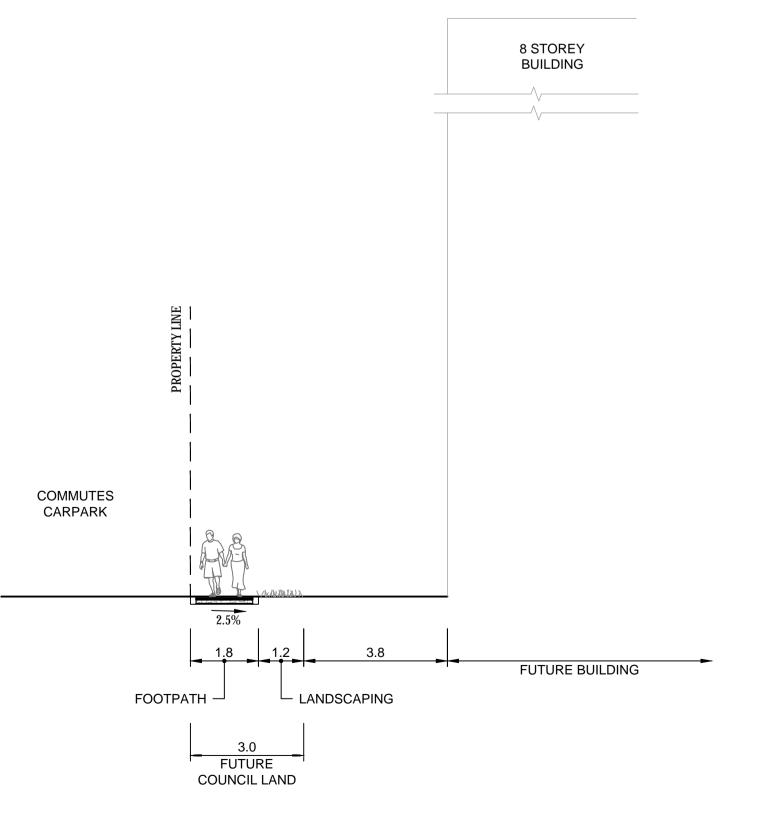
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10 SECTION J SCALE 1:100

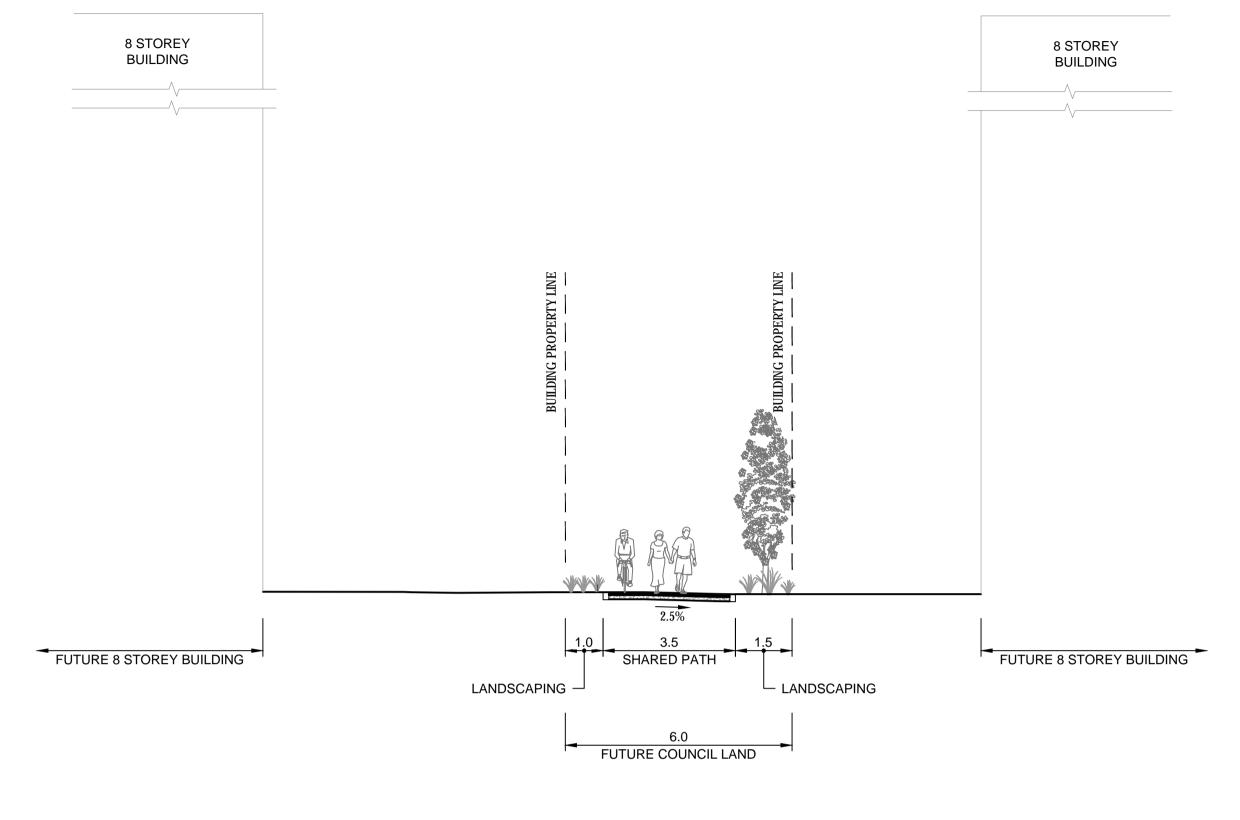

PROJECT

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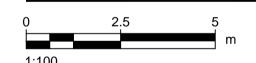
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ISSUE/REVISION
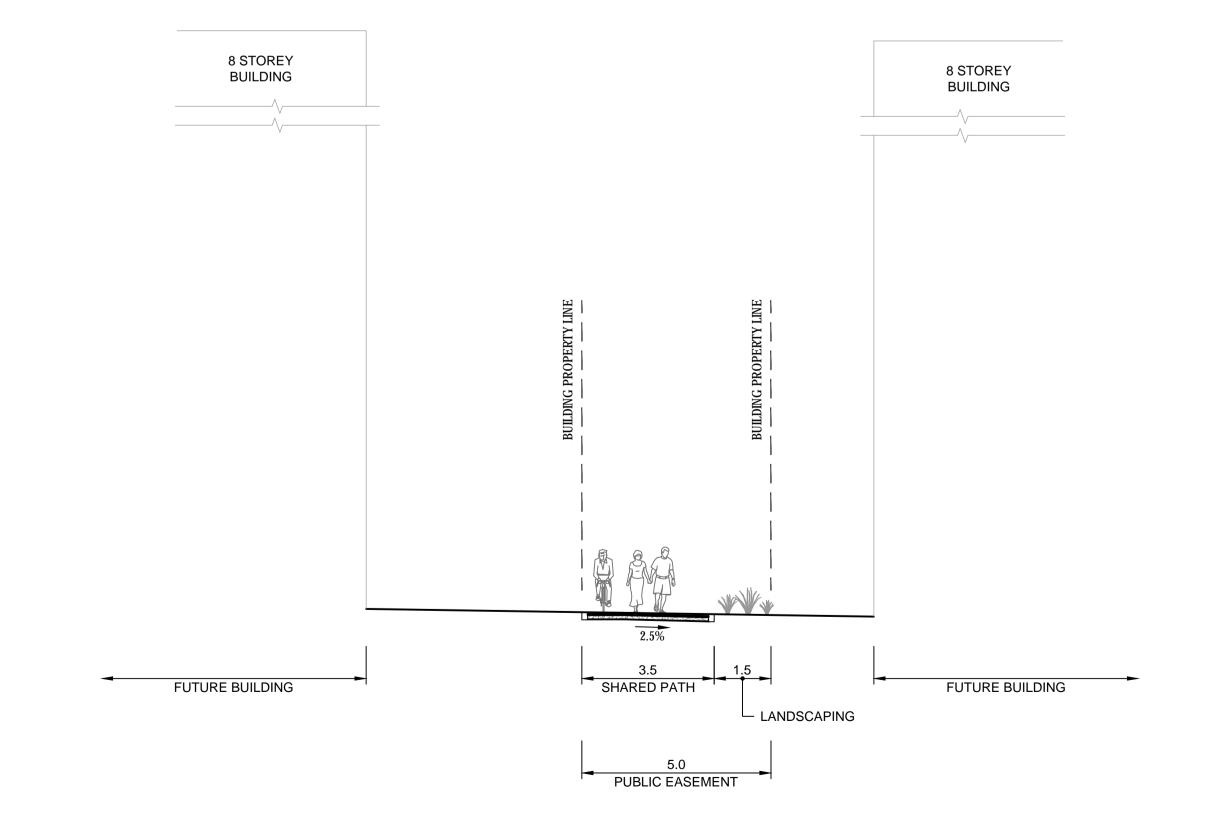
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PROJECT NUMBER


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SHEET TITLE

TYPICAL SITE SECTION

SHEET 05

SHEET NUMBER

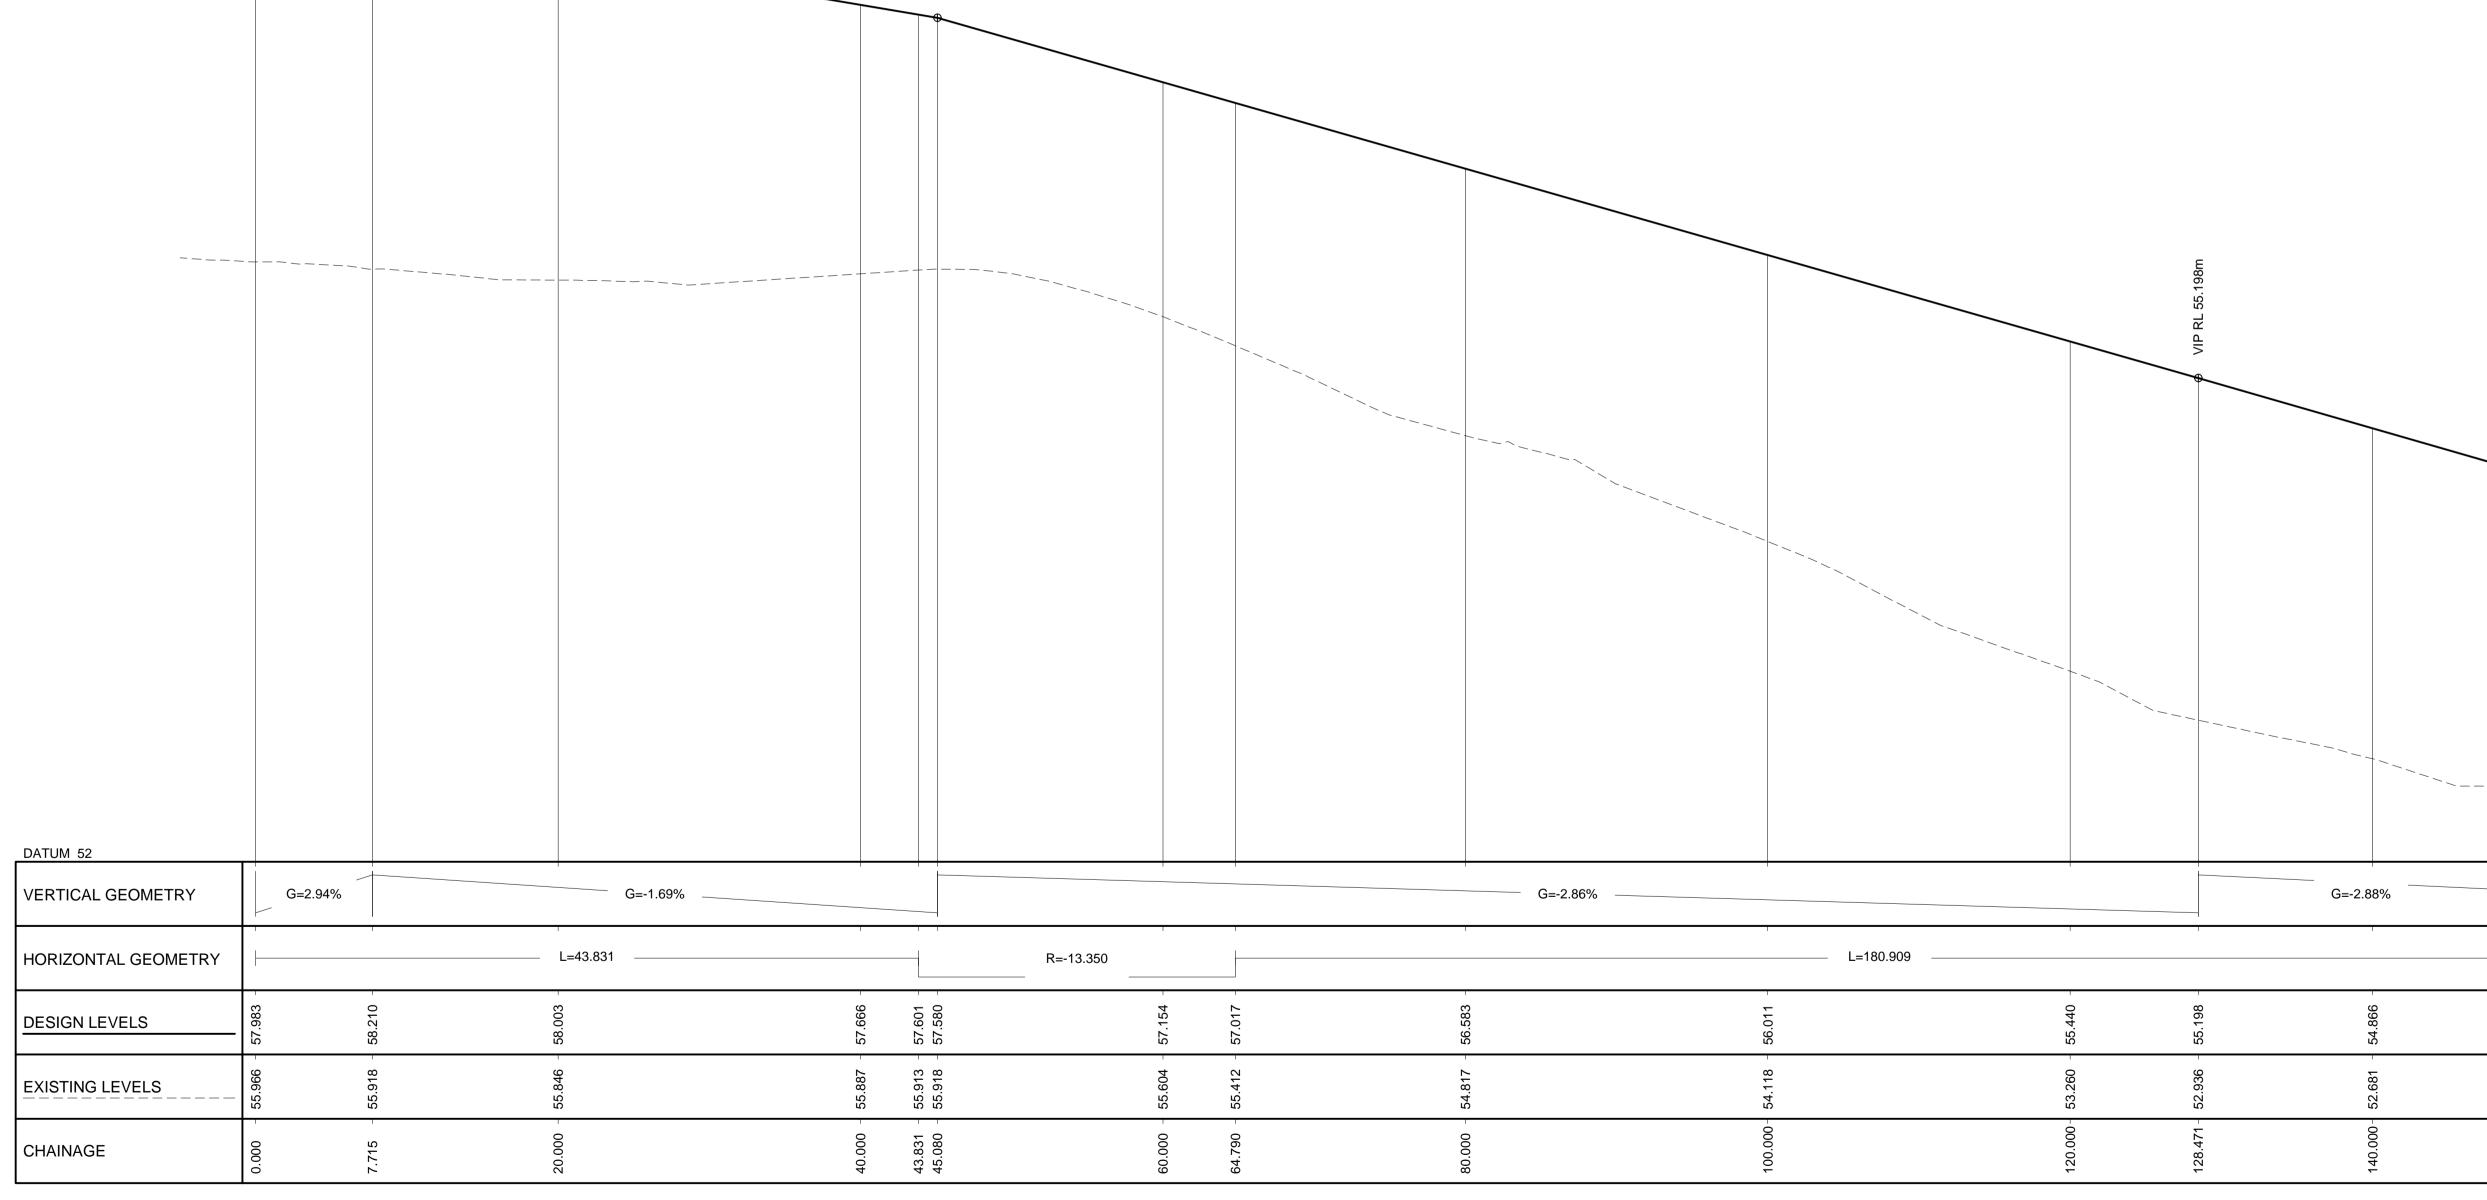

LONGITUDINAL SECTION - MC01

A1 HORIZONTAL SCALE 1:250
A1 VERTICAL SCALE 1:25

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DESIGNER	CHECKED	APPROVED		
ISSUE/REVISION				

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I/R	DATE	DESCRIPTION

KEY PLAN

PROJECT NUMBER

60558549

SHEET TITLE

PUBLIC DOMAIN LONGITUDINAL SECTION - MC01 SHEET 01

SHEET NUMBER

PROJECT

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PRELIMINARY PROJECT MANAGEMENT INITIALS

J. CHAN	D. FETTELL	D. FETTELL
DESIGNER	CHECKED	APPROVED

ISSUE/REVISION		N

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KEY PLAN

PROJECT NUMBER


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SHEET TITLE

PUBLIC DOMAIN LONGITUDINAL SECTION - MC01 SHEET 02

SHEET NUMBER

60558549-SHT-00-0000-CI-0162

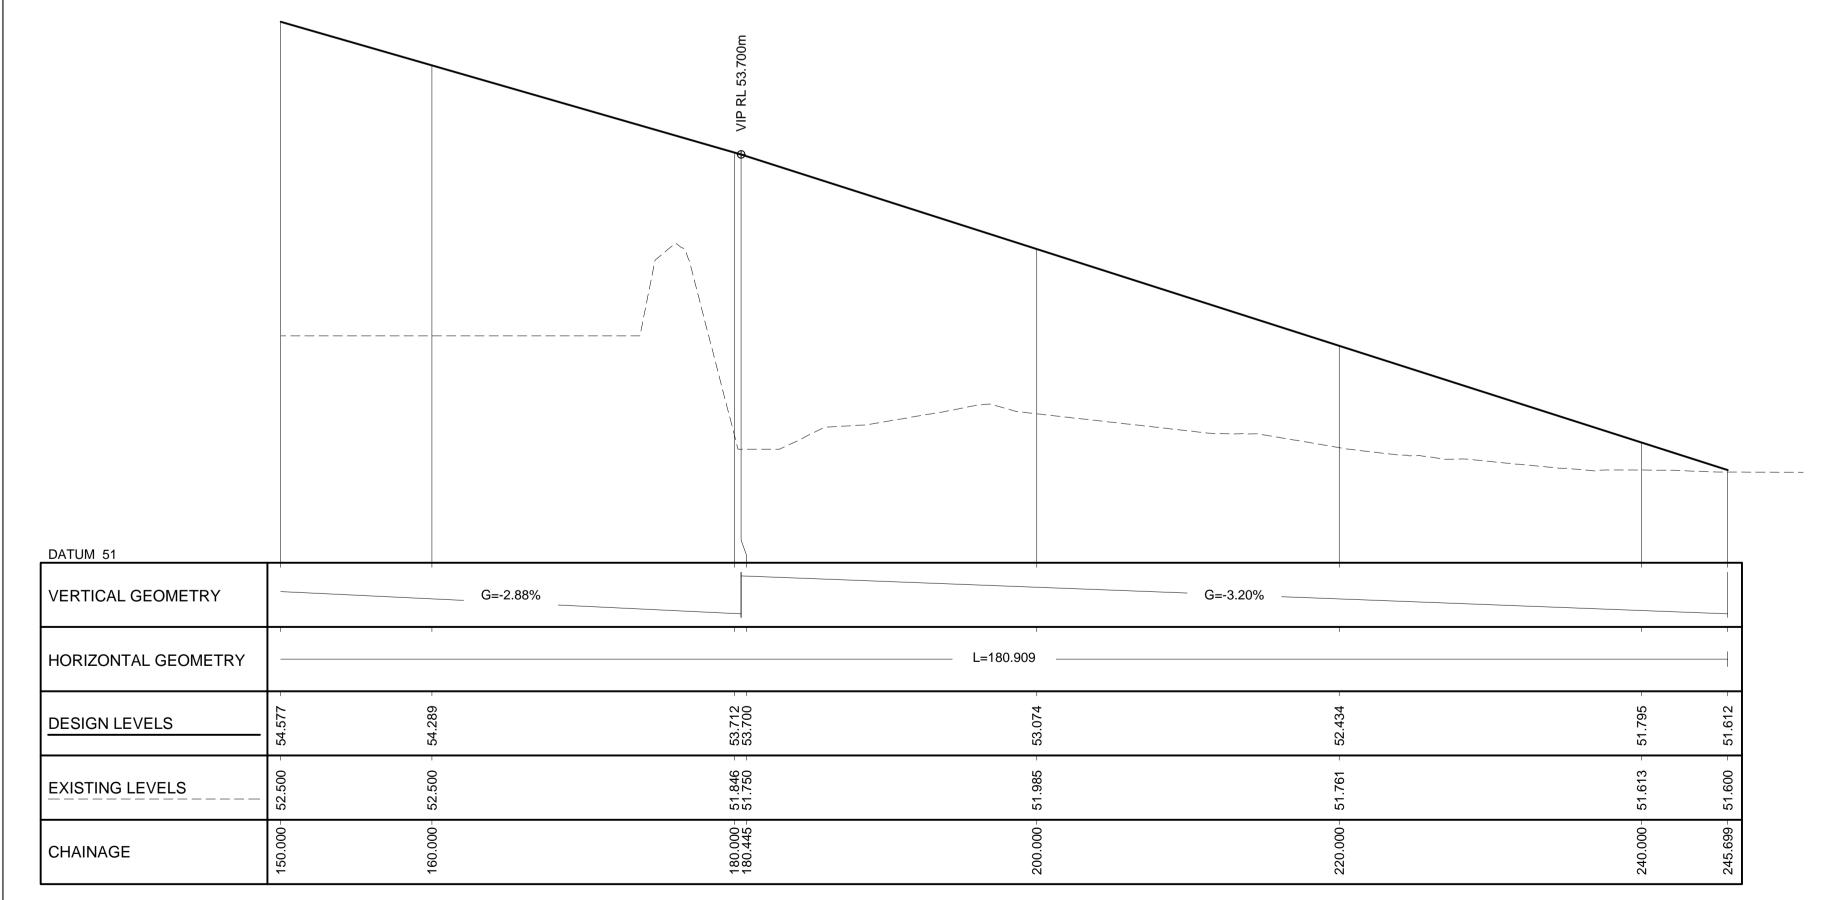

LONGITUDINAL SECTION - MC01 A1 HORIZONTAL SCALE 1:250 A1 VERTICAL SCALE 1:25

LONGITUDINAL SECTION - MC02

A1 HORIZONTAL SCALE 1:250
A1 VERTICAL SCALE 1:25

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ISS	ISSUE/REVISION				

J. CHAN D. FETTELL D. FETTELL

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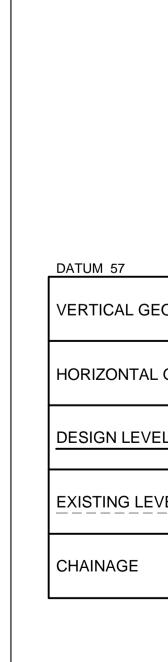
PROJECT NUMBER


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SHEET TITLE

PUBLIC DOMAIN LONGITUDINAL SECTION - MC02 SHEET 03

SHEET NUMBER



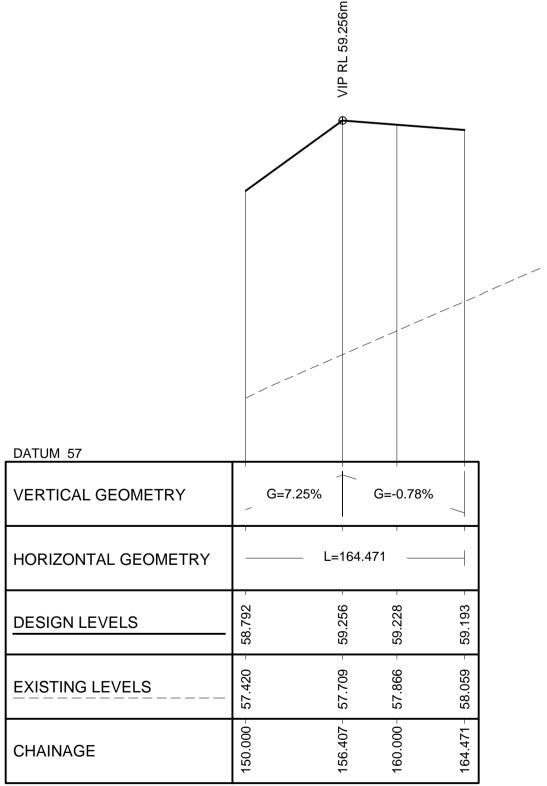

LONGITUDINAL SECTION - MC02 A1 HORIZONTAL SCALE 1:250 A1 VERTICAL SCALE 1:25

PROJECT

CUDGEGONG ROAD STATION PRECINCT TOWN CENTRE SOUTH CIVIL PACKAGE

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ISSUE/REVISION					

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KEY PLAN


PROJECT NUMBER

60558549

SHEET TITLE

PUBLIC DOMAIN LONGITUDINAL SECTION - MC02 SHEET 04

SHEET NUMBER

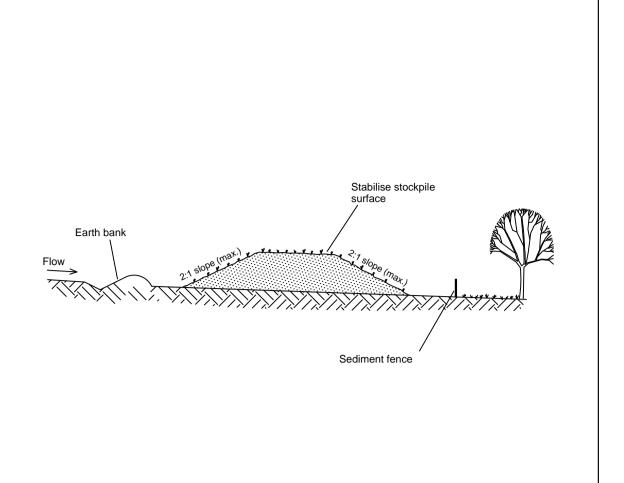

Runoff water with sediment মান্তির সৈতে করি জালা হয় নাই Filtered water Gravel-filled wire mesh

500 mm to 600 mr trench with compacted backfill and on rock, set SECTION DETAIL 1.5 m star pickets (unless stated otherwise on SWMP/ESCP) Star pickets at maximum **Construction Notes** Construct sediment fences as close as possible to being parallel to the contours of the site, but

with small returns as shown in the drawing to limit the catchment area of any one section. the

catchment area should be small enough to limit water flow if concentrated at one point to 50

Cut a 150-mm deep trench along the upslope line of the fence for the bottom of the fabric to be

Drive 1.5 metre long star pickets into ground at 2.5 metre intervals (max) at the downslope

4. Fix self-supporting geotextile to the upslope side of the posts ensuring it goes to the base of the

trench. fix the geotextile with wire ties or as recommended by the manufacturer. only use


6. Backfill the trench over the base of the fabric and compact it thoroughly over the geotextile.


geotextile specifically produced for sediment fencing. the use of shade cloth for this purpose is

litres per second in the design storm event, usually the 10-year event.

edge of the trench. ensure any star pickets are fitted with safety caps.

Join sections of fabric at a support post with a 150-mm overlap.

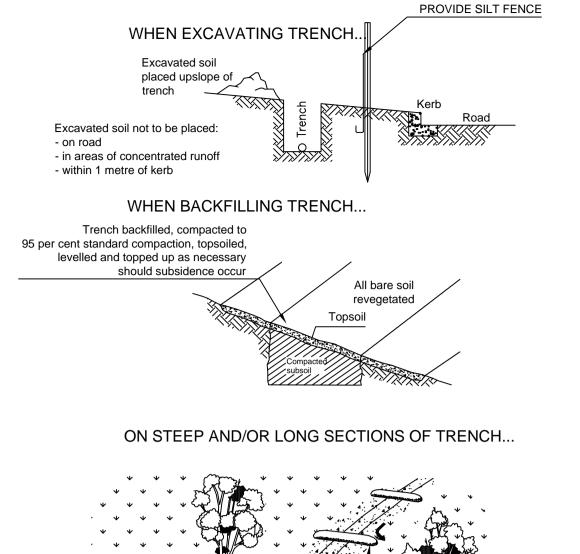

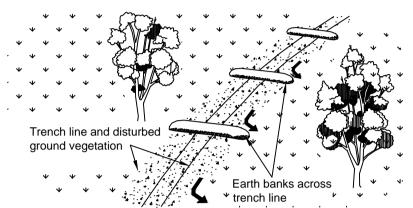

Construction Notes

- 1. Do not open any trench unless it is likely to be closed in three days.
- 2. Place excavated material upslope of trench.
- 3. Stockpile topsoil separately from subsoil.
- 4. Divert runoff from the line of the cut with diversions as directed by standard drawing 5-2.
- 5. Rehabilitate in accordance with specification.

Construction Notes

- 1. Place stockpiles more than 2 (preferably 5) metres from existing vegetation, concentrated water flow, roads and hazard areas.
- 2. Construct on the contour as low, flat, elongated mounds. 3. Where there is sufficient area, topsoil stockpiles shall be less than 2 metres in height.
- 4. Where they are to be in place for more than 10 days, stabilise following the approved ESCP or SWMP to reduce the C-factor to less than 0.10.
- 5. Construct earth banks on the upslope side to divert water around
- stockpiles and sediment fences 1 to 2 metres downslope.

STOCKPILE PROTECTION

Construction site

Construction Notes

1. Install filters to kerb inlets only at sag points. 2. Fabricate a sleeve made from geotextile or wire mesh longer than the length of the inlet

NOTE: This practice only to be used where specified in an approved SWMP/ESCP.

- pit and fill it with 25 mm to 50 mm gravel.
- 3. Form an elliptical cross-section about 150 mm high x 400 mm wide. 4. Place the filter at the opening leaving at least a 100-mm space between it and the kerb
- inlet. Maintain the opening with spacer blocks. 5. Form a seal with the kerb to prevent sediment bypassing the filter.
- 6. Sandbags filled with gravel can substitute for the mesh or geotextile providing they are placed so that they firmly abut each other and sediment-laden waters cannot pass between.

MESH AND GRAVEL INLET FILTER

SEDIMENT FENCE

150 mm min.

Existing roadway


entrenched.

SD 6-8

Self-supporting

UTILITY CONSTRUCTION

SD9-1

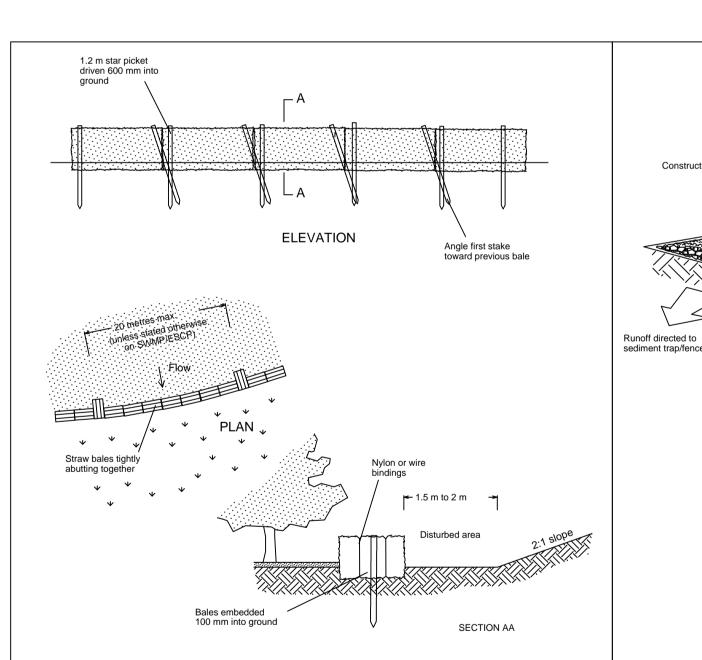

Construction Notes

- 1. Construct the straw bale filter as close as possible to being parallel to the contours of the site. 2. Place bales lengthwise in a row with ends tightly abutting. Use straw to fill any gaps between
- bales. Straws are to be placed parallel to ground. 3. Ensure that the maximum height of the filter is one bale.
- 4. Embed each bale in the ground 75 mm to 100 mm and anchor with two 1.2 metre star pickets or stakes. Angle the first star picket or stake in each bale towards the previously laid bale. Drive them 600 mm into the ground and, if possible, flush with the top of the bales. Where star pickets are used and they protrude above the bales, ensure they are fitted with safety caps.
- 5. Where a straw bale filter is constructed downslope from a disturbed batter, ensure the bales are placed 1 to 2 metres downslope from the toe.
- 6. Establish a maintenance program that ensures the integrity of the bales is retained they
- could require replacement each two to four months.

STRAW BALE FILTER

5. Where a sediment fence joins onto the stabilised access, construct a hump in the stabilised

Construction Notes

access to divert water to the sediment fence

2. Cover the area with needle-punched geotextile.

1. Strip the topsoil, level the site and compact the subgrade.

DGB 20 roadbase or 30 mm aggregate

Geotextile fabric designed to prevent intermixing of subgrade

and base materials and to maintai good properties of the sub-base layers. Geofabric may be a woven or needle-punched

burst strength (AS3706.4-90) of 2500 N

3. Construct a 200 mm thick pad over the geotextile using road base or 30 mm aggregate.

4. Ensure the structure is at least 15 metres long or to building alignment and at least 3 metres

STABILISED SITE ACCESS

1. Build with gradients between 1 percent and 5 percent.

Construction Notes

- 2. Avoid removing trees and shrubs if possible work around them.
- 3. Ensure the structures are free of projections or other irregularities that could
- 4. Build the drains with circular, parabolic or trapezoidal cross sections, not V

NOTE: Only to be used as temporary bank where maximum upslope length is 80 metres.

- shaped.
- 5. Ensure the banks are properly compacted to prevent failure.

6. Complete permanent or temporary stabilisation within 10 days of construction.

DIVERSION SWALE

EROSION AND SEDIMENTATION CONTROL NOTES

- 1. UPON COMPLETION OF FINAL EARTHWORKS OR AFTER WRITTEN DIRECTION PRINCIPAL AUTHORISED PERSON, IMMEDIATE SILT CONSERVATION TREATMENTS SHALL BE APPLIED SO AS TO RENDER AREAS THAT HAVE BEEN DISTURBED, EROSION PROOF WITHIN 14-DAYS;
- 2. ALL PERIMETER AND SILTATION CONTROL MEASURES ARE TO BE THE FIRST STEP IN CLEARING OR EARTHWORKS:
- 3. THE AREA OVER ALL STORMWATER AND SEWER LINES NOT IN STREETS IS TO BE MULCHED AND SEEDED AS
- SOON AS POSSIBLE BUT NO LATER THAN WITHIN 14-DAYS AFTER BACKFILL; 4. NO MORE THAN 150-METRES OF TRENCH IS TO BE OPEN AT ANY ONE TIME;
- 5. AREAS OVER ELECTRICITY POWER, TELEPHONE AND GAS SUPPLY TRENCHES ARE TO BE SEEDED AND MULCHED AS SOON AS POSSIBLE BUT NO LATER THAN WITHIN 14-DAYS AFTER BACKFILL;
- 6. ALL TEMPORARY EARTH BERMS, DIVERSION AND SEDIMENT BASIN EMBANKMENTS ARE TO BE TRACK ROLLED, SEEDED OR MULCHED FOR TEMPORARY VEGETATION COVER AS SOON AS THEY HAVE BEEN FORMED;
- 7. ALL FILLS ARE TO BE LEFT WITH A WINDROW AT LEAST 200 MM HIGH AT THE TOP OF THE SLOPE AT THE END OF EACH DAY'S EARTHWORKS, AND ALL EARTHWORK AREAS SHALL BE ROLLED EACH EVENING TO "SEAL" THE EARTHWORKS:
- 8. ALL FINAL EROSION PREVENTION MEASURES, INCLUDING ESTABLISHMENT OF GRASSING, ARE TO BE COMPLETED PRIOR TO THE SITE FINAL INSPECTION:
- 9. STABILISATION OF ALL CUT AND FILL SLOPES SHALL BE COMMENCED WITHIN 14-DAYS OF COMPLETION OF
- FORMATION:
- 10. A STRIP OF TURF IS TO BE PLACED IMMEDIATELY BEHIND THE KERB AND GUTTER ON ALL NEW ROADS AND AT ADDITIONAL LOCATIONS AS DETERMINED BY PRINCIPAL AUTHORISED PERSON;
- 11. ALL TOPSOIL IS TO BE STOCKPILED ON SITE (AWAY FROM TREES AND DRAINAGE LINES). MEASURES SHALL BE
- APPLIED TO PREVENT EROSION OF THE STOCKPILES AND
- 12. ESTABLISHMENT OF FIRE BREAKS SHALL BE CARRIED OUT IN CONSULTATION WITH A FIRE CONTROL OFFICER.

AECOM

PROJECT

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SHEET TITLE

EROSION AND SEDIMENTATION CONTROL DETAILS SHEET 01

SHEET NUMBER

