


ABBREVIATIONS	
AW1	AWNING - TYPE 1
AW2	AWNING - TYPE 2
AW3	AWNING - TYPE 3
AW4	AWNING - TYPE 4
COL1	COLUMN - TYPE 1
COL2	COLUMN - TYPE 2
CON1	CONCRETE - TYPE 1
CPP1	CONCRETE PRECAST PANEL - TYPE 1
DP1	DOWNSPIPE - TYPE 1
EG1	EAVES GUTTER - TYPE 1
LWC1	LIGHT WEIGHT CLADDING - TYPE 1
LWC2	LIGHT WEIGHT CLADDING - TYPE 2
MRS1	METAL ROOF SHEETING - TYPE 1
MRS2	METAL ROOF SHEETING - TYPE 2
PAV1	PAVING - TYPE 1
SB1	STEEL BEAM - TYPE 1

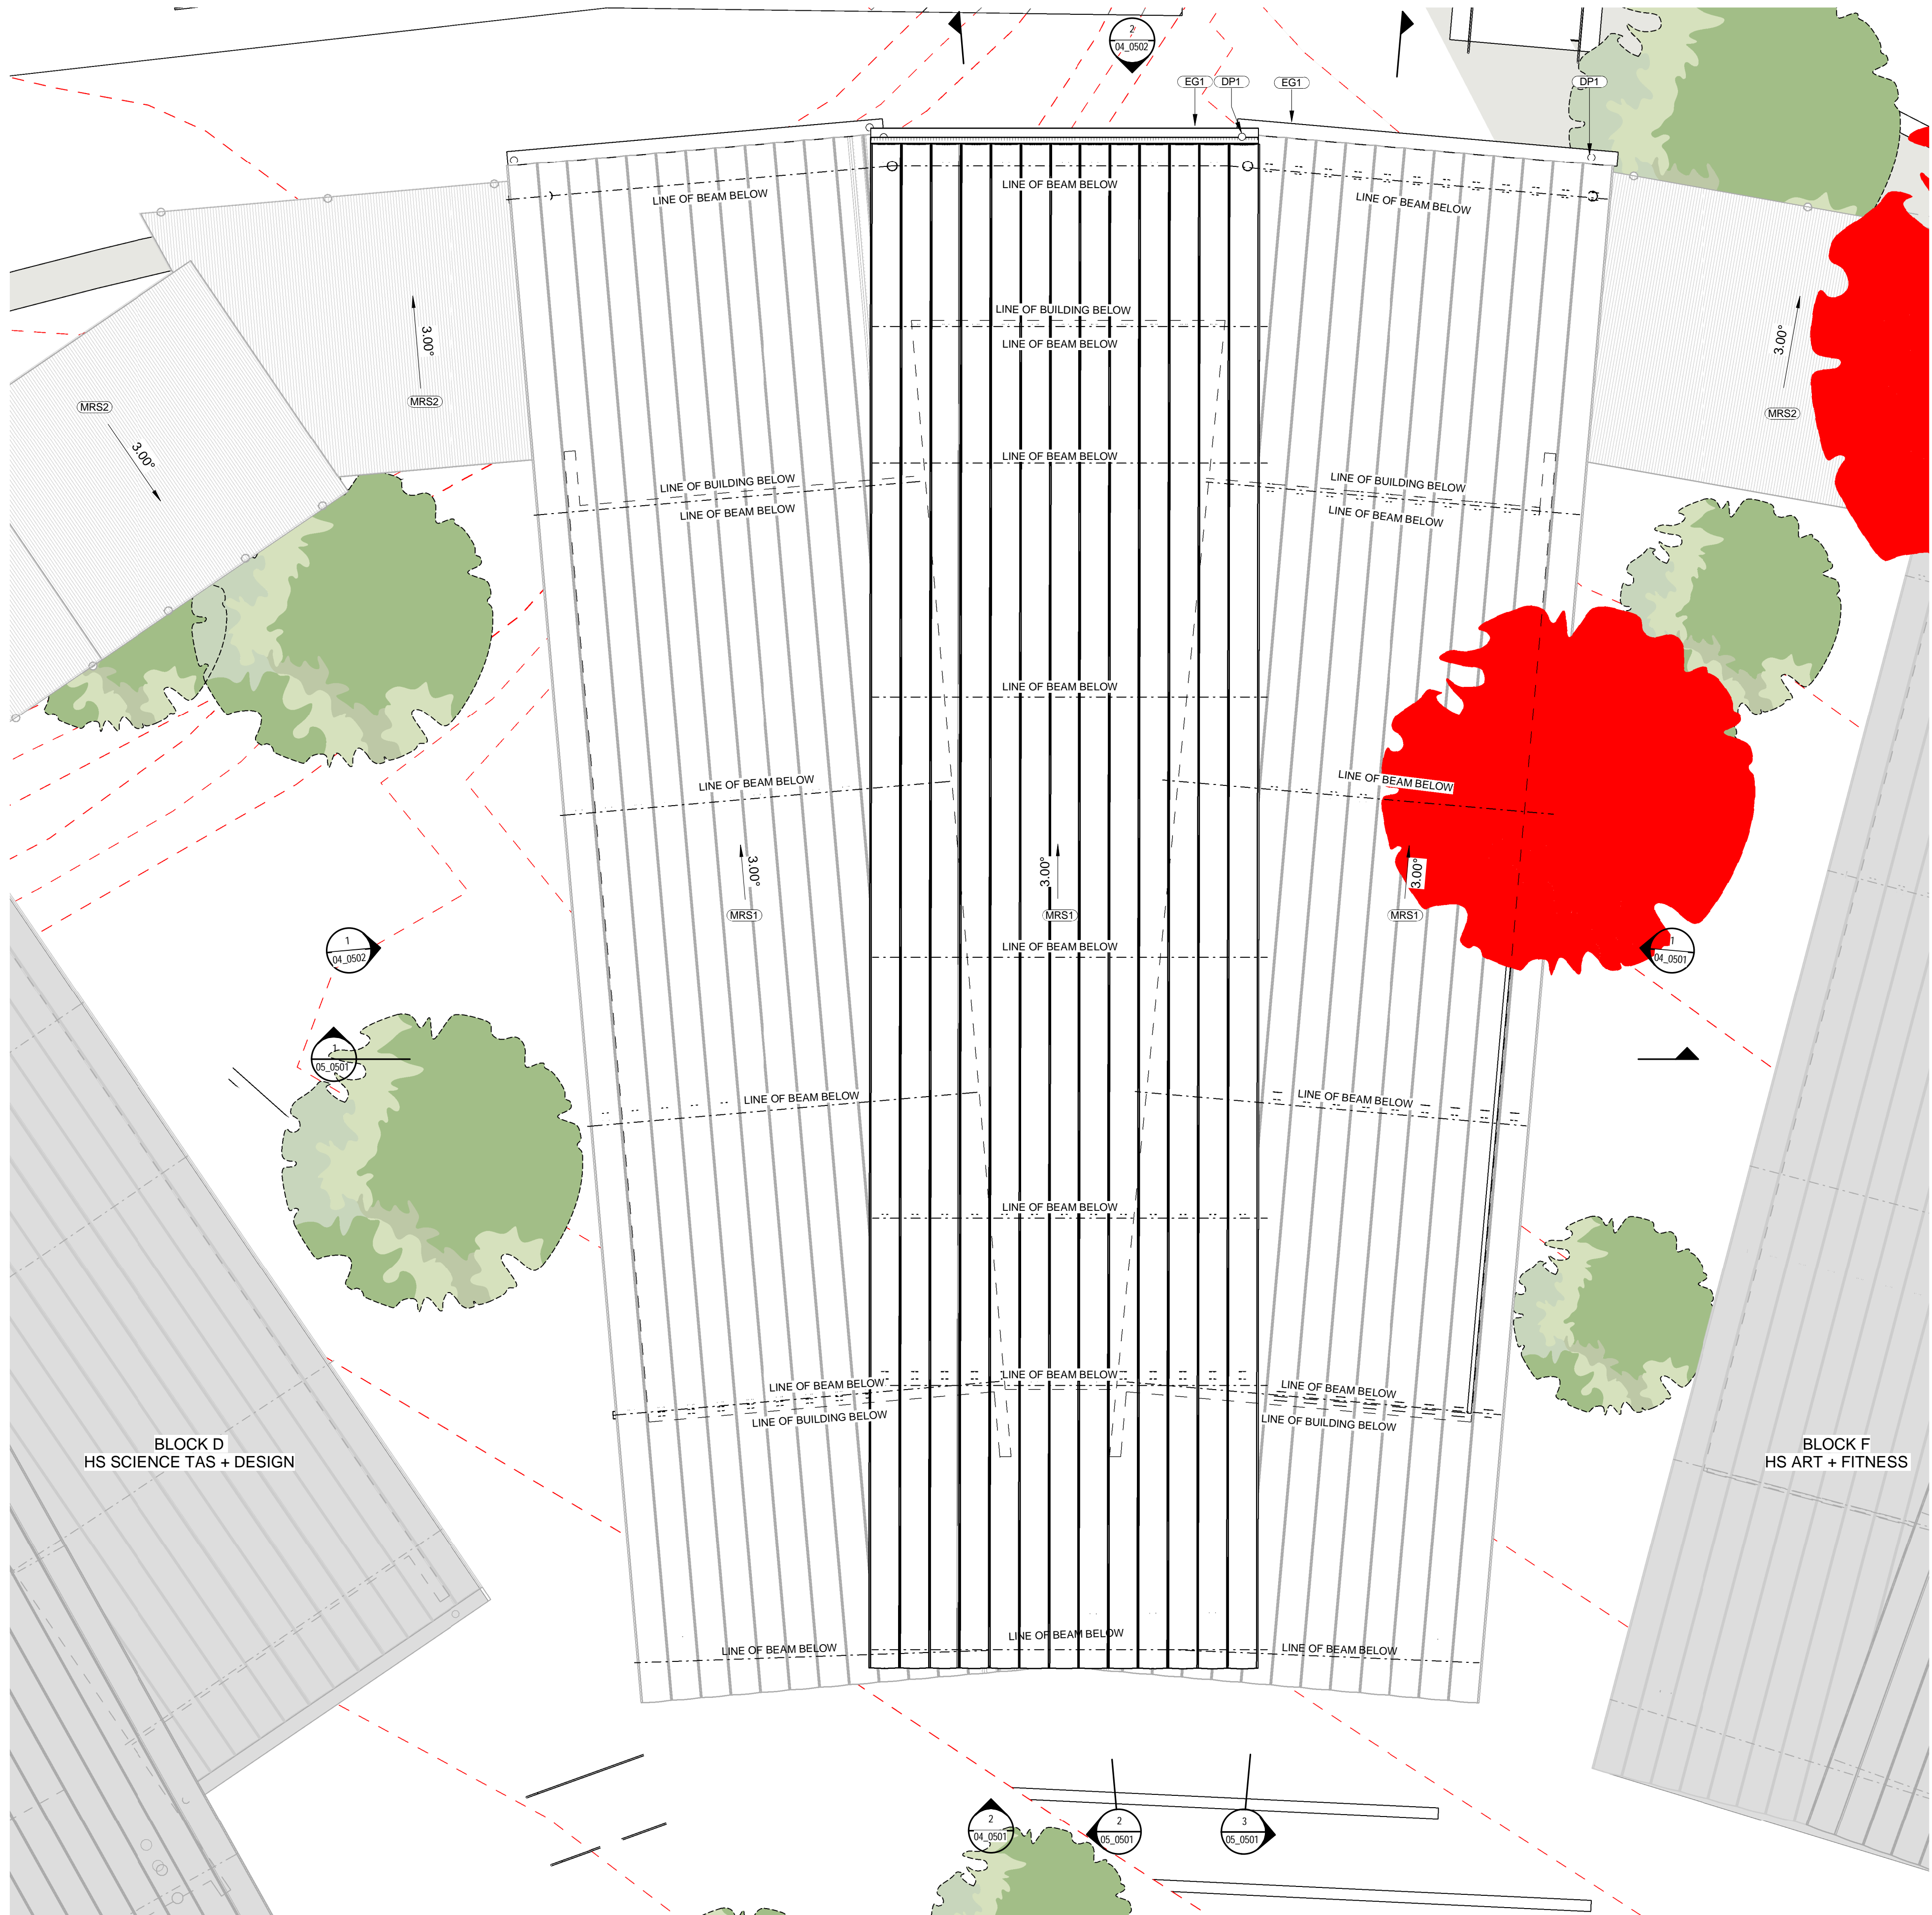

1 ROOF PLAN
04_0501 SCALE 1:100

REV	DATE	DESCRIPTION	BY	CHK
A	16.01.2018	FOR STAKEHOLDER MEETING	ME	
B	25.01.2018	DESIGN REVIEW	ME	
C	01.02.2018	CONSULTANT COORDINATION	CA	
D	16.02.2018	DEVELOPED DESIGN - 90%	ME	
E	09.03.2018	FOR DA	ME	
F	29.03.2018	FOR CLIENT APPROVAL	DP	TH
G	15.05.2018	FOR DEVELOPMENT APPROVAL	CH	

BUILDER TO CONFIRM ALL DETAILS, SETOUTS (TILE, ETC.), FALLS & CONNECTIONS ON SITE BEFORE CONSTRUCTION

PRINT DATE: 8/05/2018 3:51:02 PM

FILE PATH: C:\Users\chris.H\Documents\2544 Medowie_High_School_Block_E_-_TAS_chris.H\30BVG.nxd



webberarchitects
commercial and residential

Suite 3, Level 1 496 Hunter St Newcastle
1st fl + 612 4922 1978
newcastle@webberarchitects.com

PO Box 807 The Junction 2291
+61 8 9490 1188 + 61 8 9148 0000
www.webberarchitects.com

Director: Jon Webber (International Architect) AIA, NSW AIB NO. 5820
Associate Director: Sarah Hinchey, Karen Brooks
Associate: Tim Hayes
Associate: Luke Keating


ROOF PLAN - BLOCK E
HIGH SCHOOL TAS & DESIGN
CATHERINE MCAULEY CATHOLIC COLLEGE
507 MEDOWIE ROAD, MEDOWIE, NSW

ISSUED:
FOR DA APPROVAL
NOT FOR CONSTRUCTION


PROJECT COMMENCEMENT DATE: 01.05.2017

SCALE:
0 1000 2000 3000 4000 5000 mm
SCALE 1:100 @ A1

SHEET NUMBER: 2544_03_0503_G

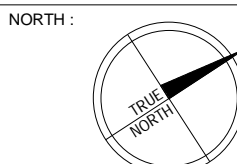

LOCATION PLAN

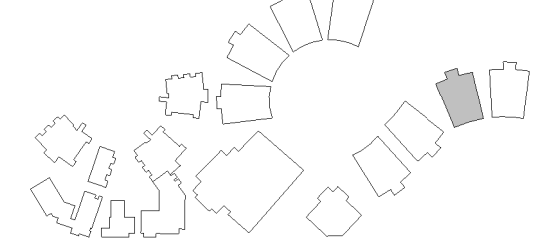

This drawing and the design expressed are copyright and remain the property of Webber Architects. In accordance with the commonwealth copyright act 1968 this drawing and design in whole or part may not be used unless licensed by Webber Architects. Verify all dimensions and falls on site before construction and do not scale from drawing.