


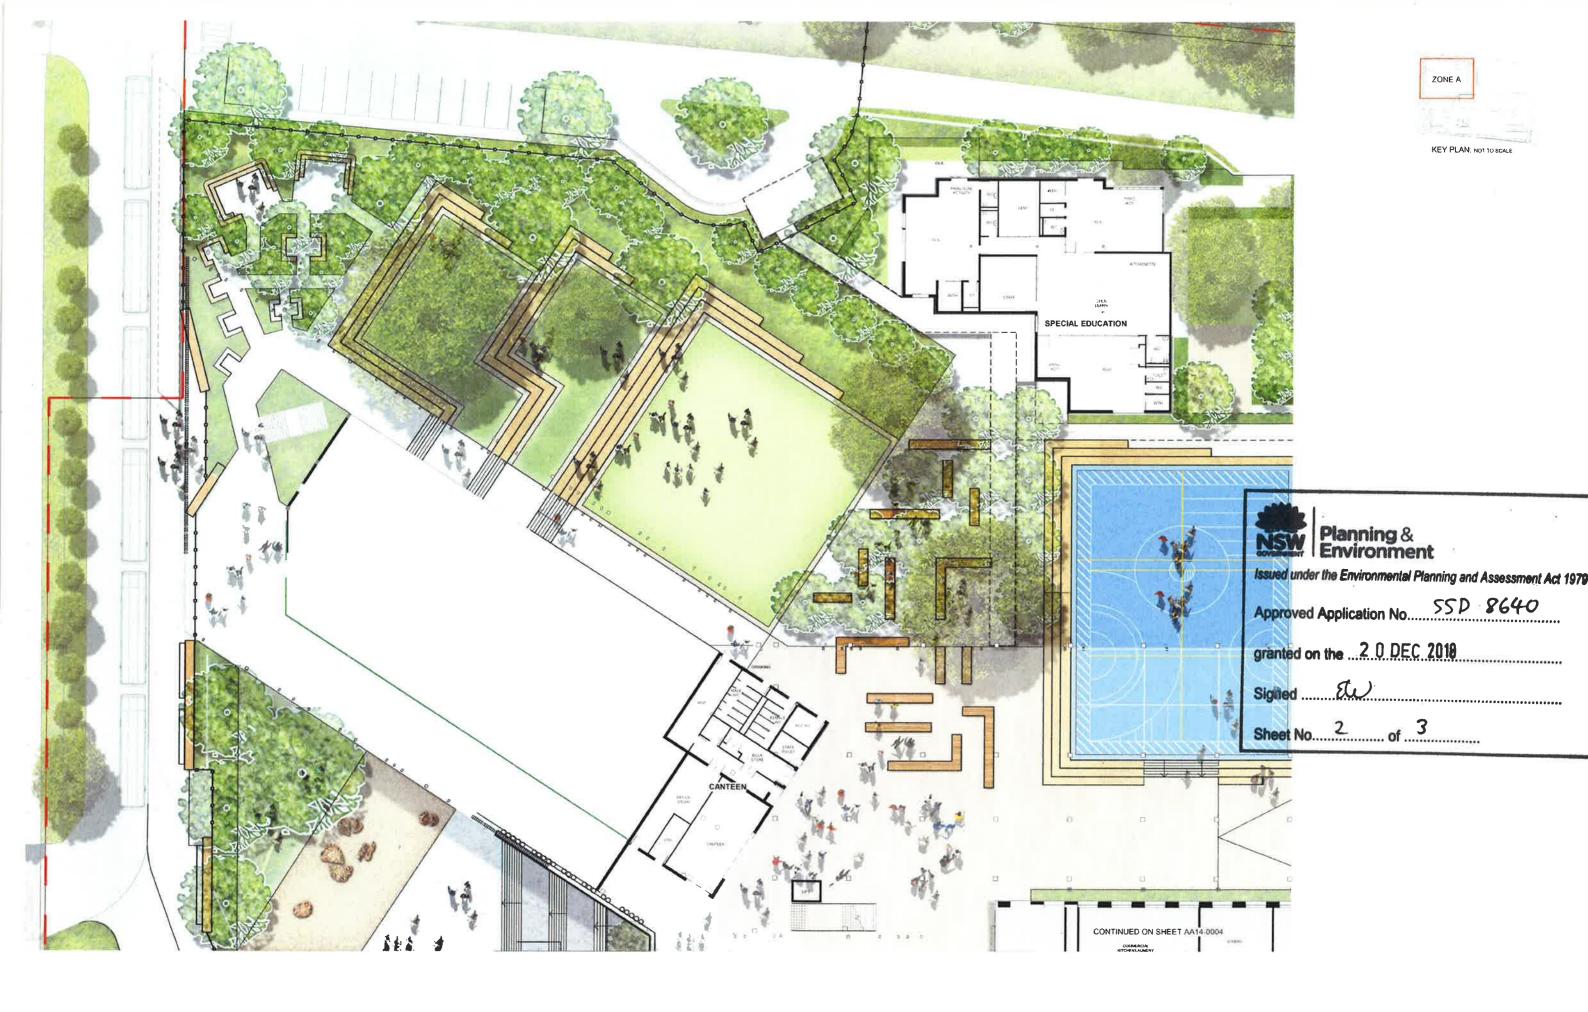



CLIENT DEPARTMENT OF EDUCATION

DATE 30/08/2018










KEY PLAN NO TO SCAUE

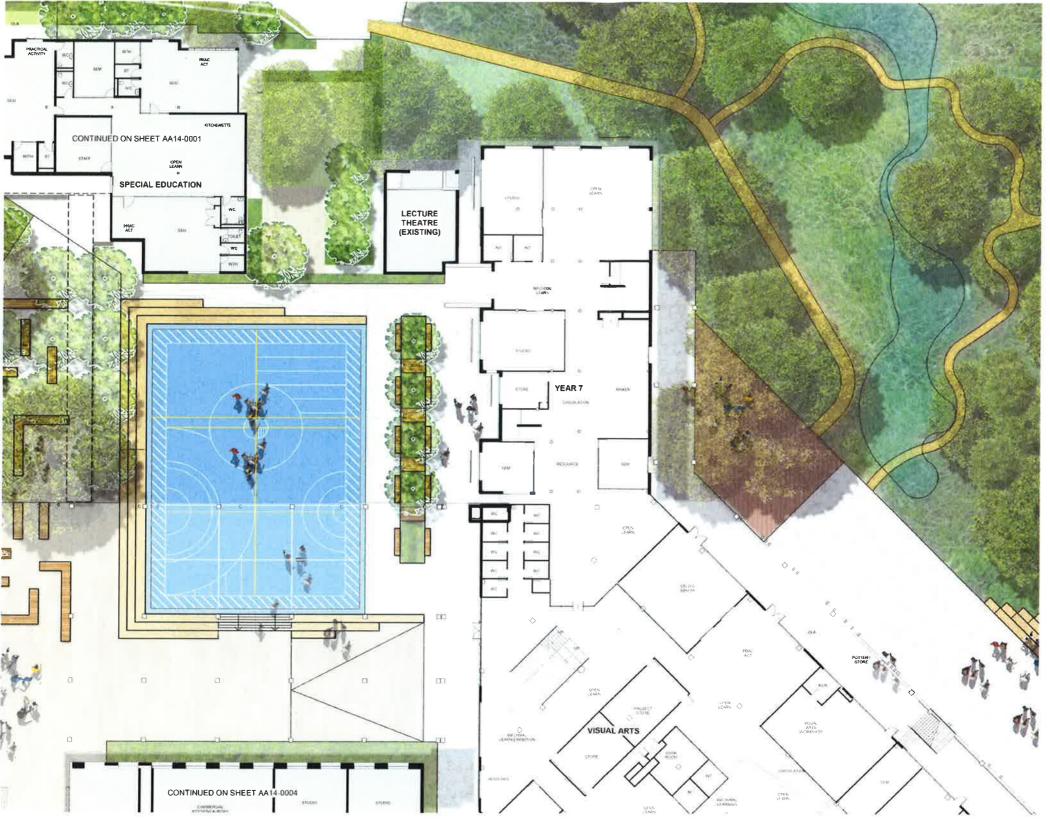

NSW Planning & Environment
Issued under the Environmental Planning and Assessment Act 197
Approved Application No. 550 8640
granted on the2 0 DEC 2019
Signed 20
Sheet No3 of39



GA - LOWER GROUND FLOOR PLAN - ZONE B









DEPARTMENT OF EDUCATION

PICTON HIGH SCHOOL REDEVELOPMENT

GA - LOWER GROUND FLOOR PLAN - ZONE C

Project No Scala 1 200⊕A1 Drawing No SSD AA10 0003



KEY PLAN NO TO SCALE











KEY PLAN NOT TO SCALE









KEY PLAN NOT TO SCALE










PARTMENT OF EDUCATION

PICTON HIGH SCHOOL REDEVELOPMENT

GA - GROUND FLOOR PLAN - ZONE B

Project No 17003 Scale 1 200@A1 Drawing No SSD - AA10.01



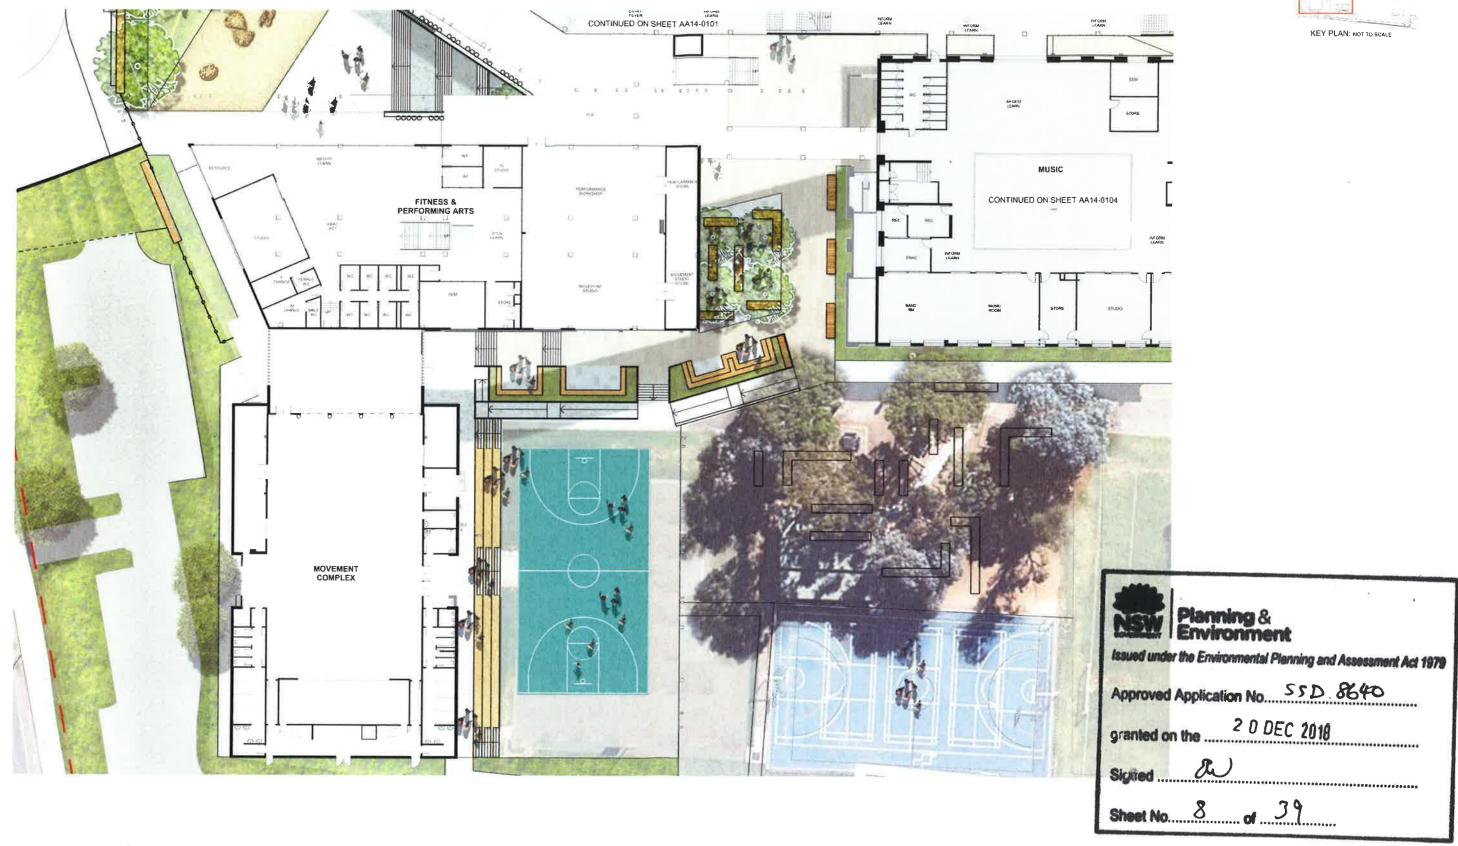






DEPARTMENT OF EDUCATION

PICTON HIGH SCHOOL REDEVELOPMENT GA - GROUND FLOOR PLAN - ZONE C



KEY PLAN; NOT TO SCALE




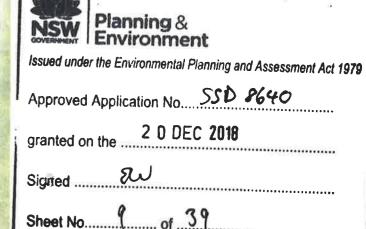





KEY PLAN, NOT TO SCALE

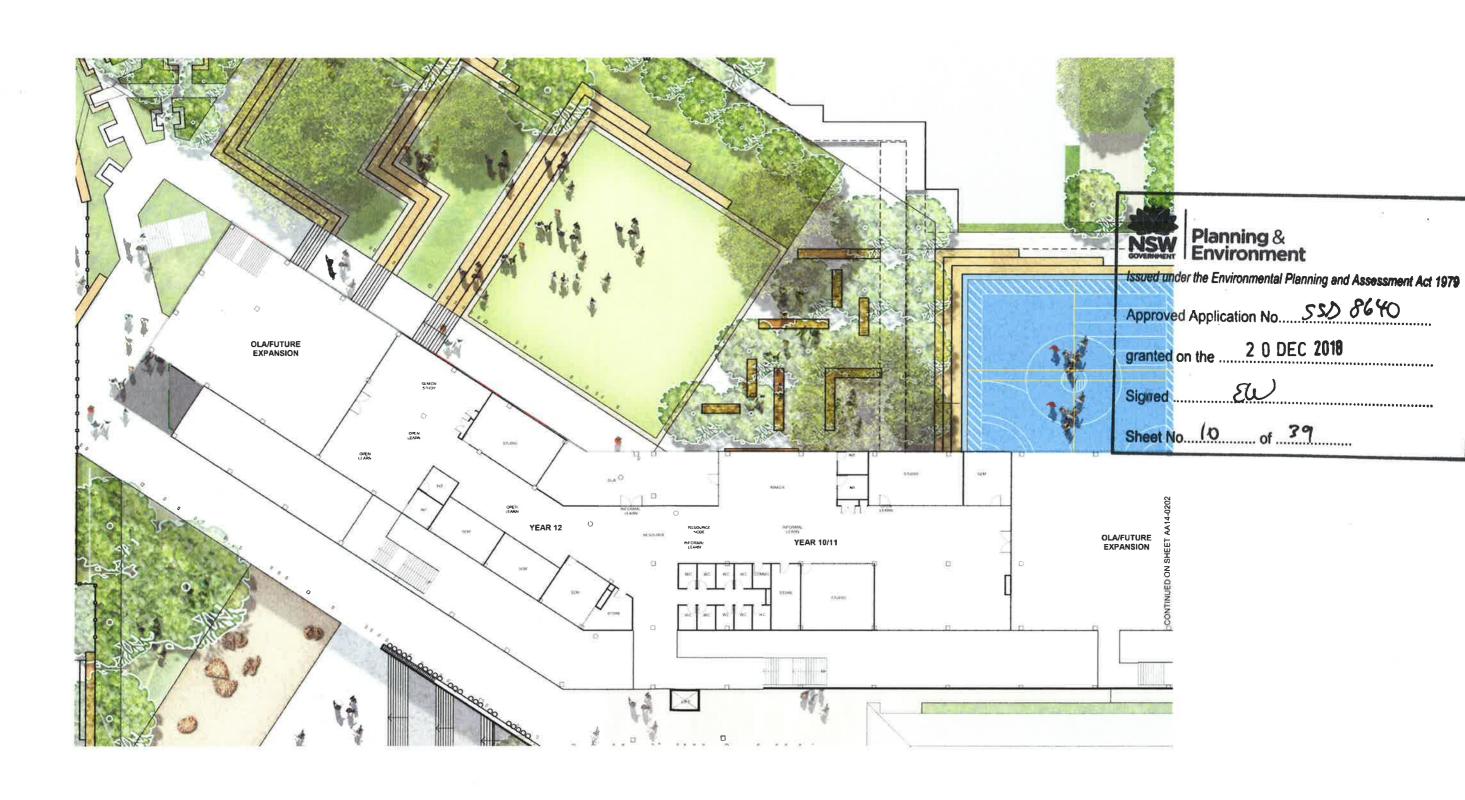






1200 N

DEPARTMENT OF EDUCATION
PICTON HIGH SCHOOL REDEVELOPMENT
GA - FIRST FLOOR PLAN - ZONE A

ZONE B

KEY PLAN NOT TO SCALL

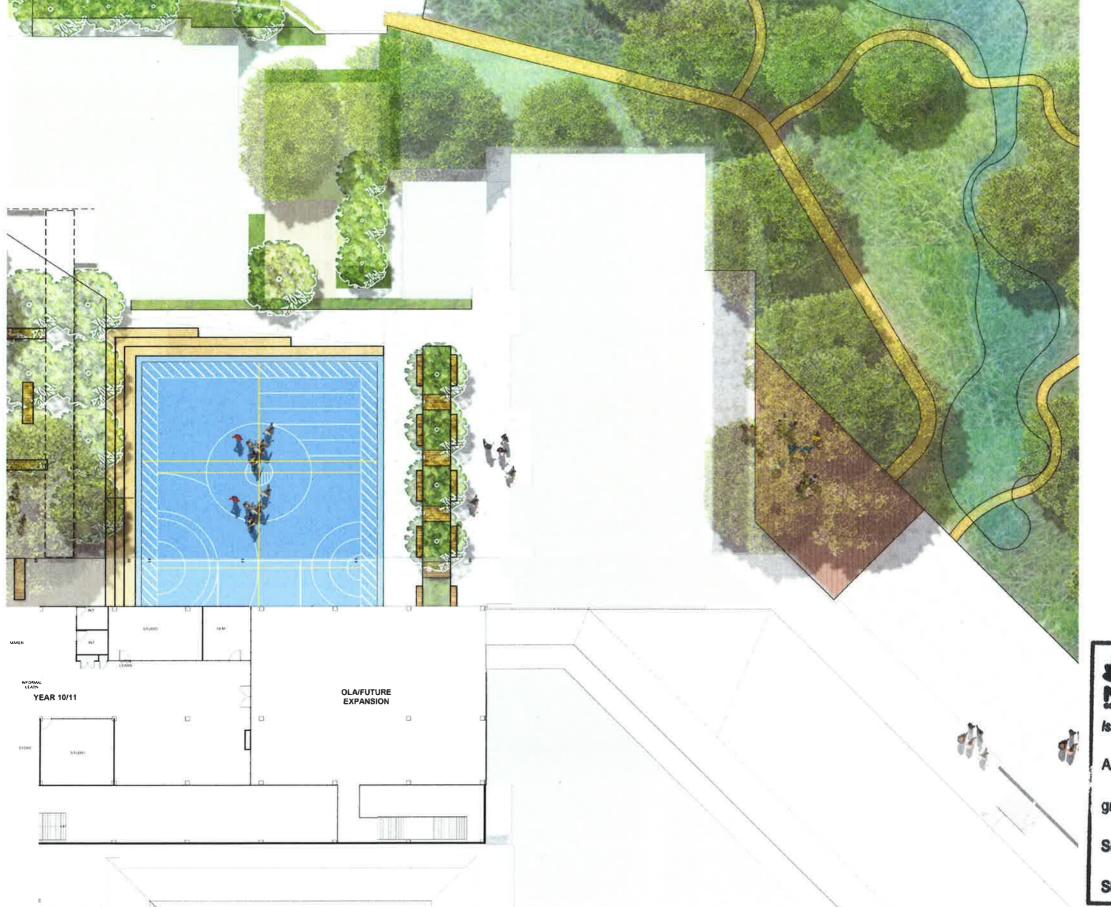

	1	
NSW	Planning & Environment	
Issued und	der the Environmental Planning and	Assessment Act 1979
Approve	nd Application No. SS \(\sum_{\text{SS}} \) 8	640
granted	on the 2.0 DEC 2019	******
Sigited .	W	J=41441835500046Tpoods
Sheet N	o(1	







0 2 4 6 10 1200 A


DEPARTMENT OF EDUCATION
PICTON HIGH SCHOOL REDEVELOPMENT
GA - FIRST FLOOR PLAN - ZONE B


Project No Ali00 Scale 1 200≨A1 Orawing No SSD - AA10 0202



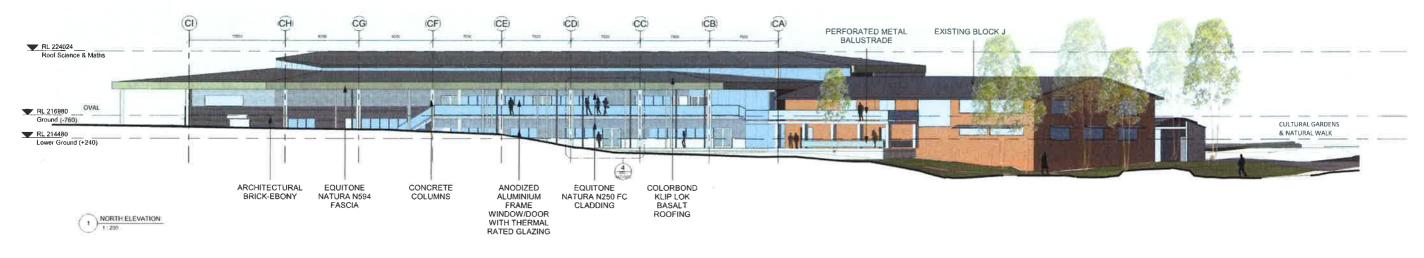

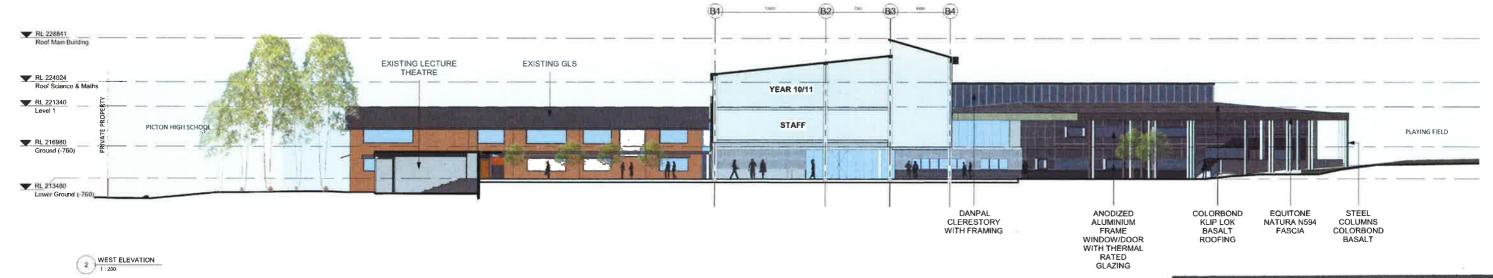

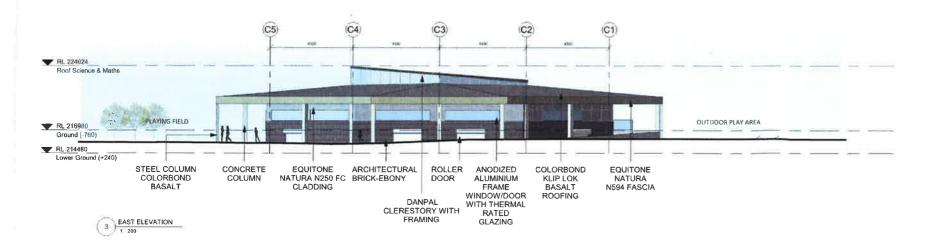

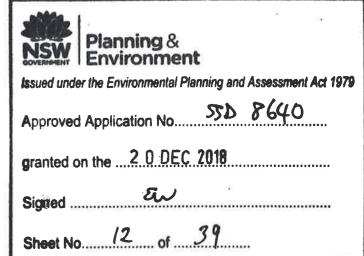





0 2 4 6 8 10


DEPARTMENT OF EDUCATION

PICTON HIGH SCHOOL REDEVELOPMENT

ELEVATIONS - GENERAL ARRANGMENT - SCIENCE & MATHS, VISUAL ARTS, DESIGN & TECHNOLOGY

Project No 17003 Scale 1:200@A1

Dale 27/07/18

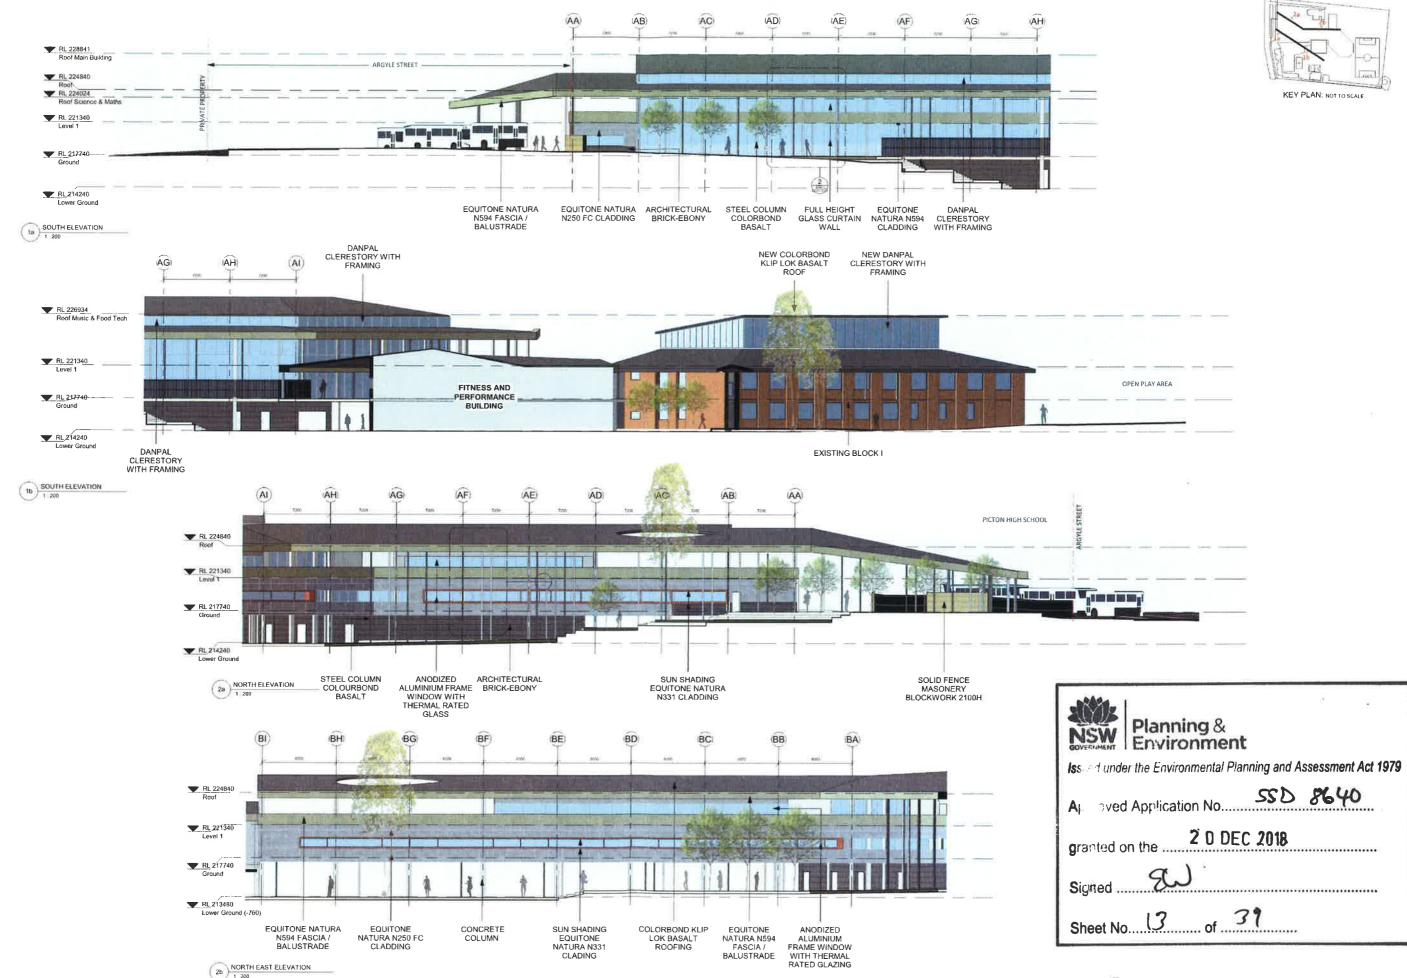





0 2 4 6 B 10

DEPARTMENT OF EDUCATION


PICTON HIGH SCHOOL REDEVELOPMENT


ELEVATIONS - GENERAL ARRANGEMENT - ADMIN & STUDENT HUB

Scale 1: 200@A1 Drawing No SSD - AA20-0002

Date 27/07/18



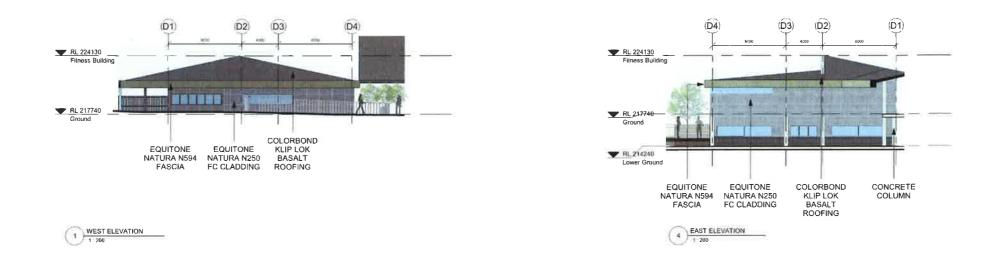

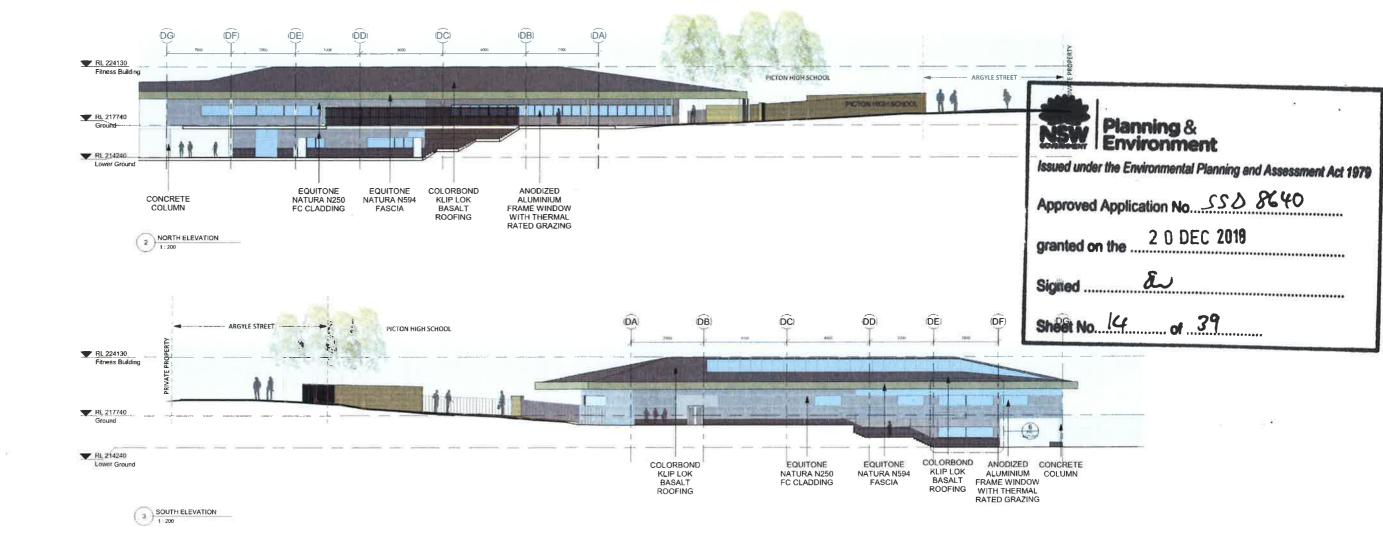







DEPARTMENT OF EDUCATION

PICTON HIGH SCHOOL REDEVELOPMENT


ELEVATIONS - GENERAL ARRANGEMENT -FITNESS & PERFORMANCE Project No. 17003
Scale 1 200@A1
Drawing No. SSD - AA20 0003
Date 27:07:18

VISION | LANDSCAPE MASTERPLAN



Copyright remains the property of **Arcadia**other required dimensions are to be referred in and supplied by the landscape architect. All discrepancies to be referred to the project manager and Arcadia Landscape Architecture Ply Ltd priot to construction. Ensure compliance with the Building Code of Australia and all relevant Australian Standards and Authorities.

VISION | CULTURAL + HERITAGE ITEMS

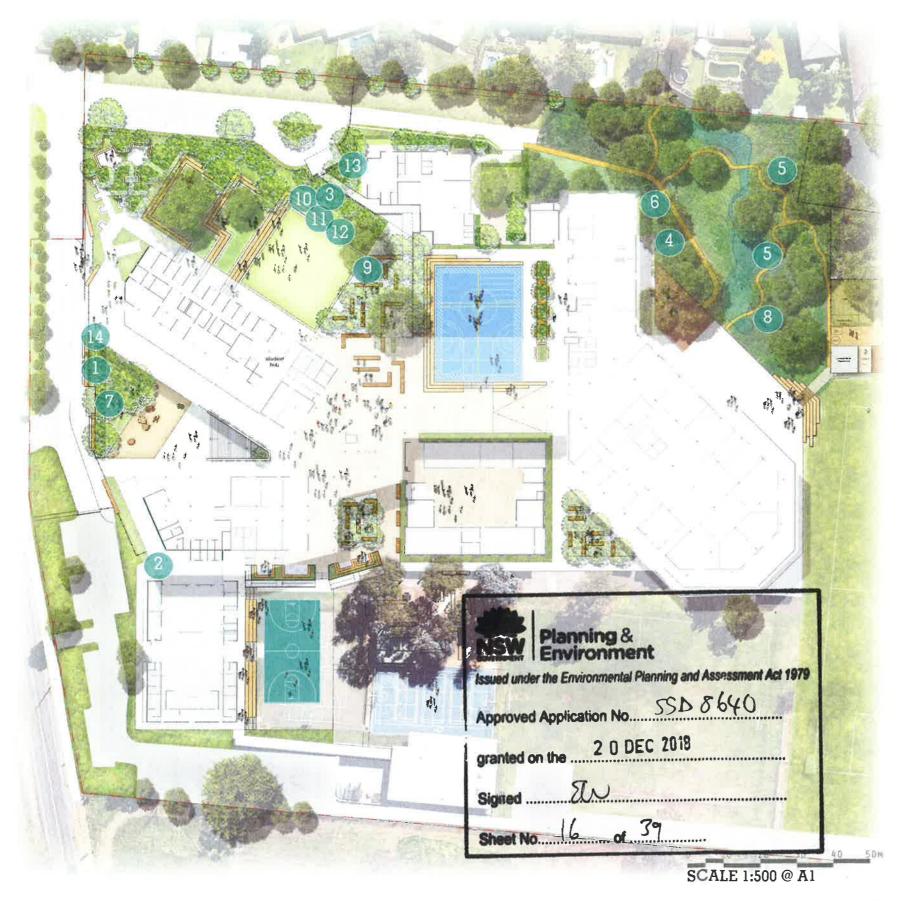

























PICTON HIGH SCHOOL LANDSCAPE DESIGN REPORT SSD




CLIENT

PREPARED BYArcadia Landscape ArchitectureDATEMay 2018CLIENTPicton High SchoolISSUEC Picton High School ARCHITECT Billard Leece

SCALE

VISION | LANDSCAPE SECTIONS

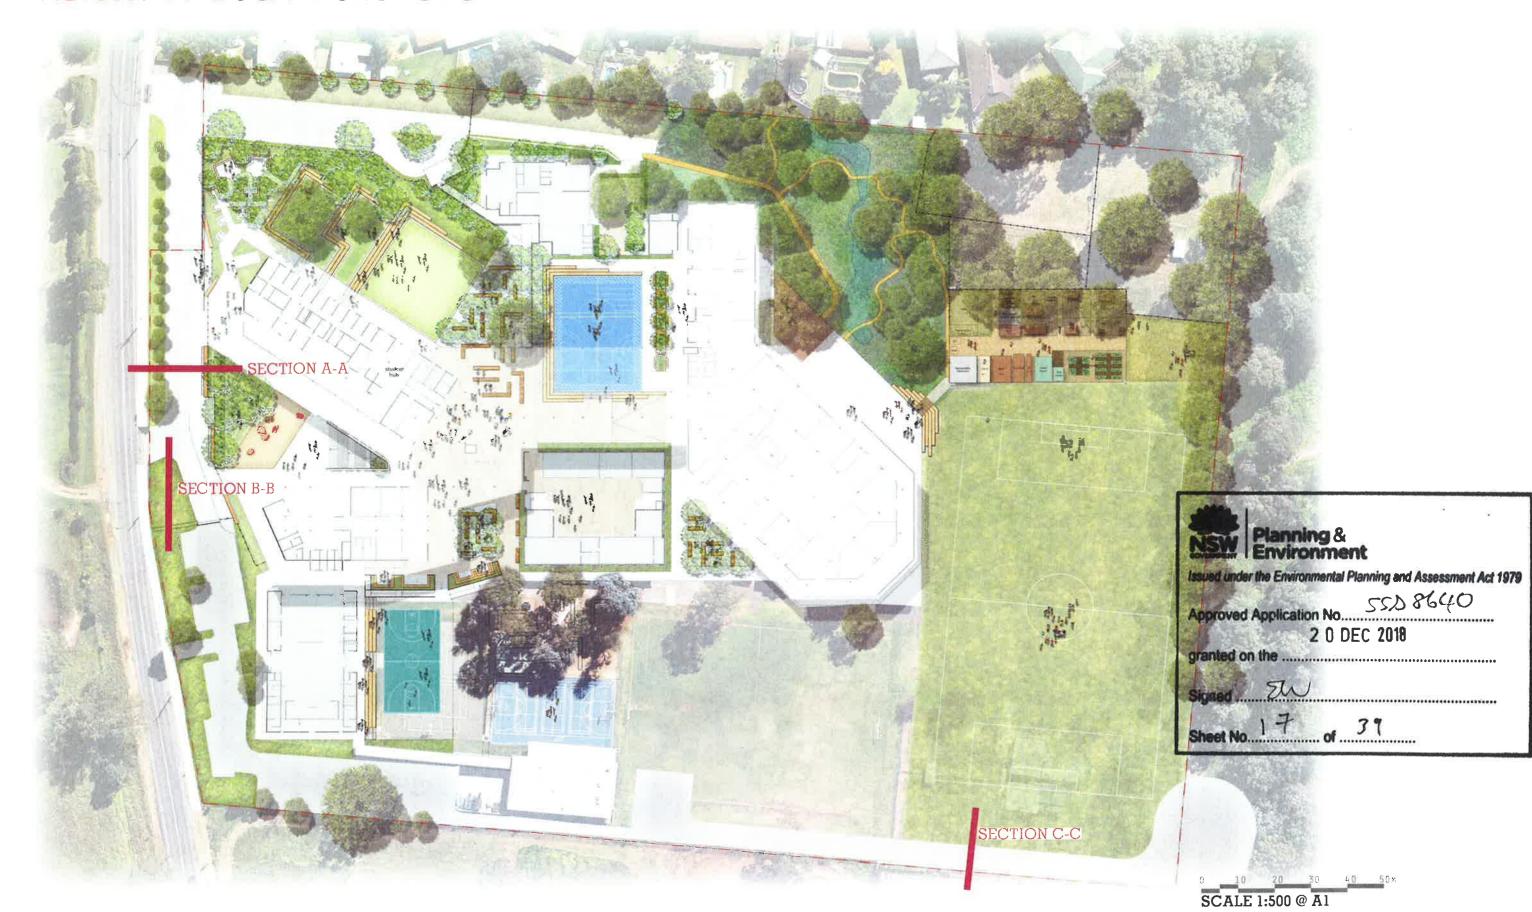



PICTON HIGH SCHOOL LANDSCAPE DESIGN REPORT SSD




ARCHITECT Billard Leece

PREPARED BYArcadia Landscape ArchitectureDATEMay 2018CLIENTPicton High SchoolISSUEC

SCALE

Copyright remains the property of Arcadia Landscape Architecture Pty Ltd. Use only figured dimensions. Any other required dimensions are to be reletired to and supplied by the landscape architect. All discrepatices to be referred to the project manager and Arcadia Landscape Architecture Pty Ltd prior to construction. Ensure compliance with the Building Code of Australia and all relevant Australian Standards and Authorities.

VISION | LANDSCAPE SECTIONS

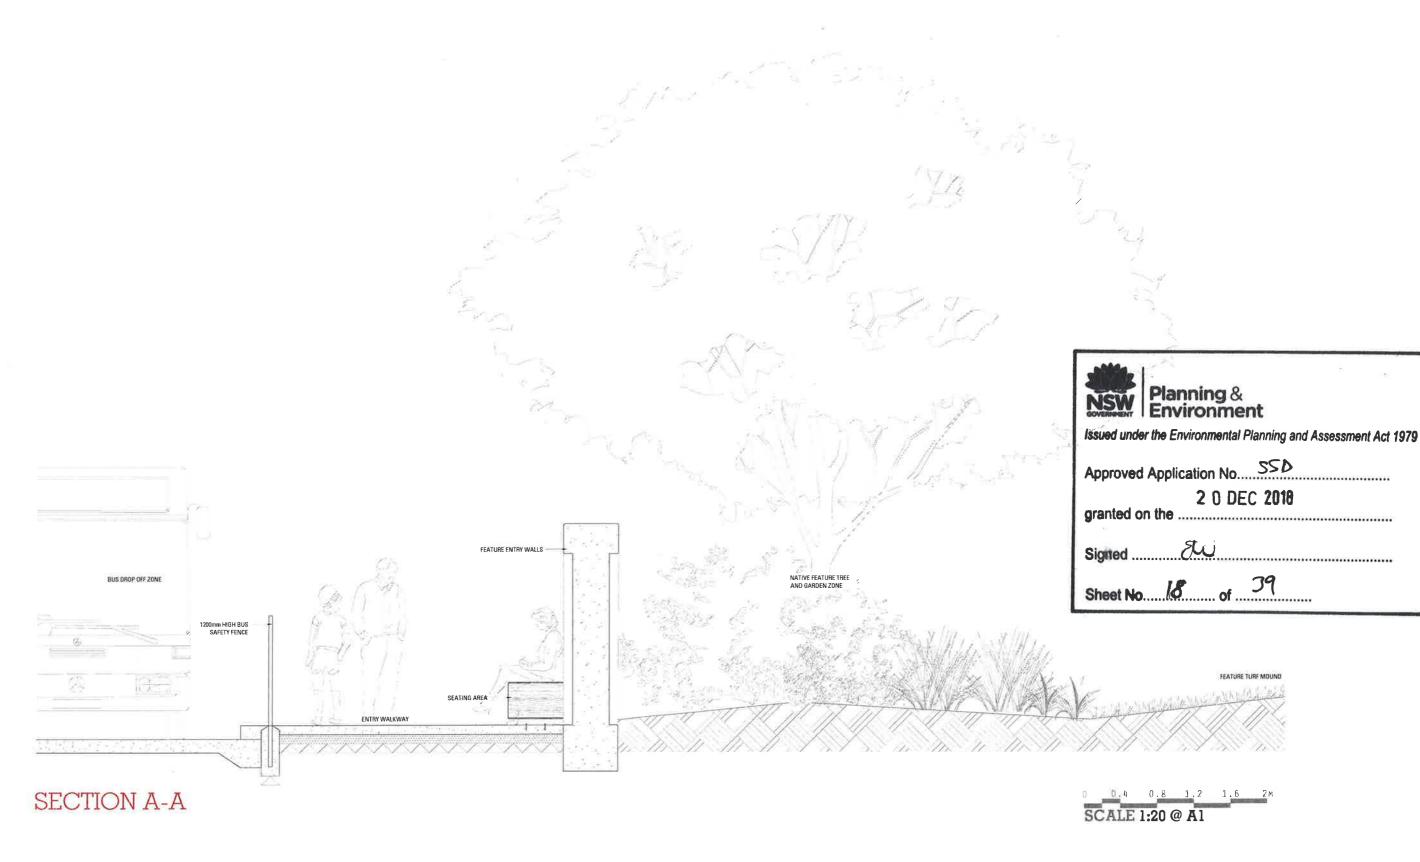



PICTON HIGH SCHOOL LANDSCAPE DESIGN REPORT SSD




CLIENT ARCHITECT Billard Leece


PREPARED BY Arcadia Landscape Architecture Picton High School

DATE May 2018
ISSUE C SCALE

Copyright remains the property of **Arcadia** Landscape Architecture Pty Ltd. Use only ligured dimensions. Any other required dimensions are to be referred to and supplied by the landscape architect. All discrepancies to be referred to the project manager and Arcadia Landscape Architecture Pty Ltd prior to constitution. Ensure compliance with the Building Code of Australia and all relevant Australian Standards and Authorities.

VISION LANDSCAPE SECTIONS

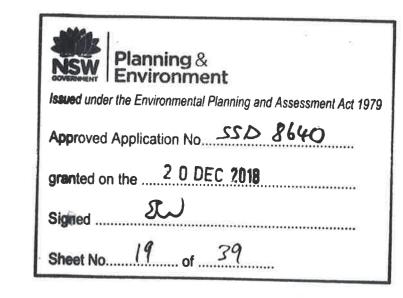

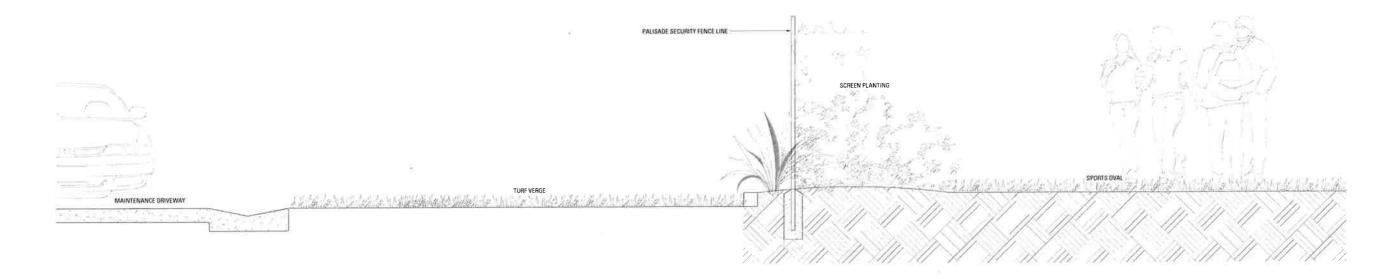

SECTION B-B



PICTON HIGH SCHOOL LANDSCAPE DESIGN REPORT SSD







CLIENT ARCHITECT Billard Leece

PREPARED BY Arcadia Landscape Architecture Picton High School

DATE May 2018
ISSUE C

VISION | LANDSCAPE SECTIONS

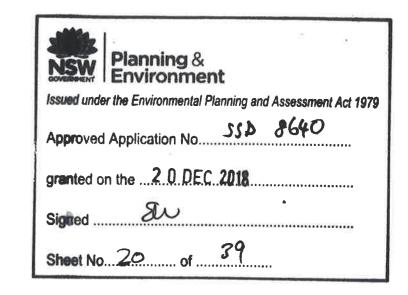

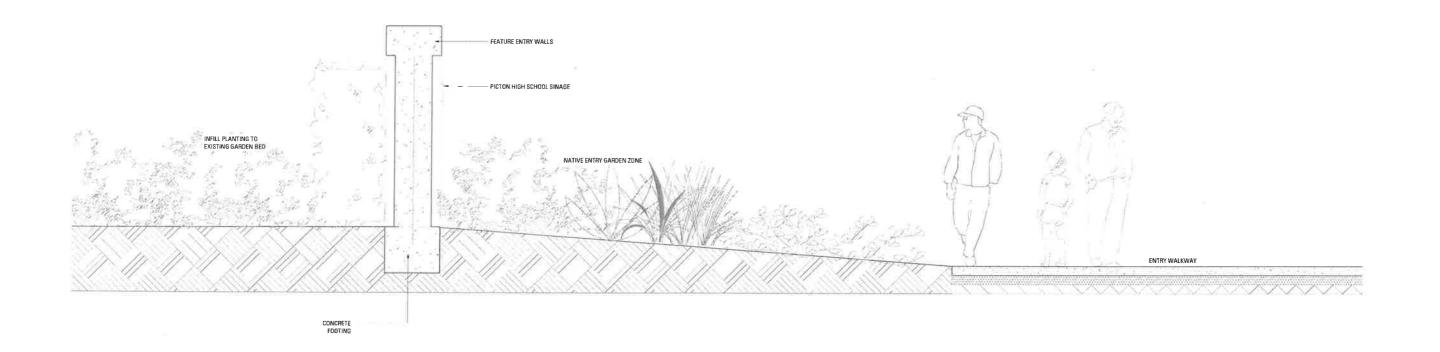

SECTION C-C



PICTON HIGH SCHOOL LANDSCAPE DESIGN REPORT SSD






PREPARED BYArcadia Landscape ArchitectureDATEMay 2018CLIENTPicton High SchoolISSUEC ARCHITECT Billard Leece

SCALE

MATERIALS | PAVEMENT


PAVEMENT TYPE 1

UNIT PAVEMENT

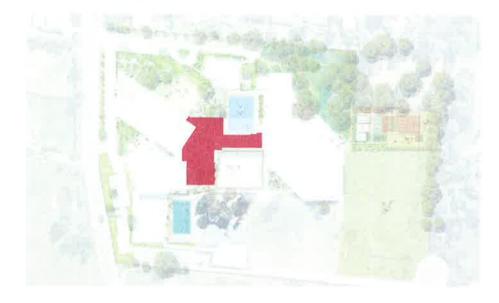

PAVEMENT TYPE 2

EXPOSED AGGREGATE COLOUR CONCRETE

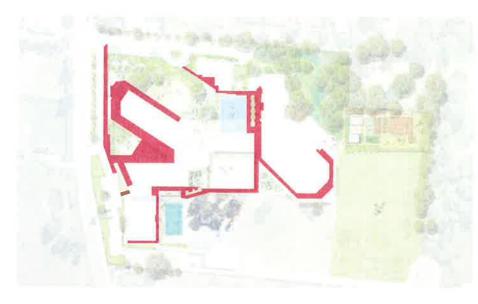

PAVEMENT TYPE 3

GRANITIC GRAVEL





DESIGN INTENT+ PERFORMANCE CRITERIA

- Mottled Neutrals
- Hard wearing and low maintenance

MATERIAL RESPONSE

- Exposed aggregate colour concrete unit pavers
- Sealed surface




DESIGN INTENT + PERFORMANCE CRITERIA

- Mottled Neutrals
- Hard wearing and low maintenance

MATERIAL RESPONSE

Exposed aggregate colour concrete poured insitu

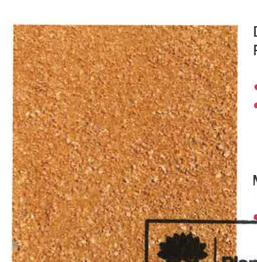

DESIGN INTENT+ PERFORMANCE CRITERIA

- Natural surface
- Permeable and low maintenance

MATERIAL RESPONSE

Granitic gravel



Approved Application No. 553 8640

granted on the 2 0 DEC 2018

Sheet No. 21 of 39



DATE Feb 2018

ISSUE B




PICTON HIGH SCHOOL LANDSCAPE DESIGN REPORT SSD




MATERIALS | PAVEMENT

PAVEMENT TYPE 4

ECOTRIHEX UNIT PAVEMENT

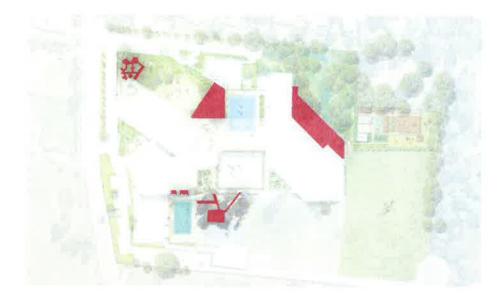

PAVEMENT TYPE 5
PLEXIPAVE ALLSPORT SURFACE

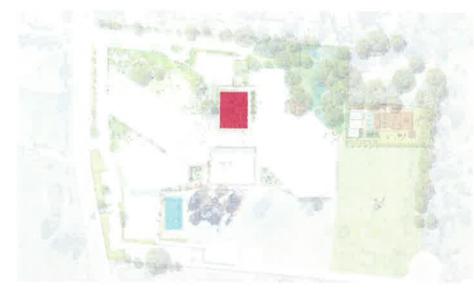

PAVEMENT TYPE 6 SYNTHETIC TURF





DESIGN INTENT + PERFORMANCE CRITERIA

- Mottled Neutrals
- Permeable, hard wearing and low maintenance

MATERIAL RESPONSE

Ecotrihex



DESIGN INTENT + PERFORMANCE CRITERIA

- Multi-court surface
- Hard wearing and low maintenance


MATERIAL RESPONSE

• Plexipave Allsport







PICTON HIGH SCHOOL LANDSCAPE DESIGN REPORT SSD

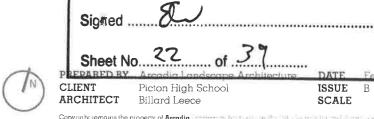

Copyright temains the property of **Arcadia** and the following the follow

DETAIL ENTRY FORECOURT

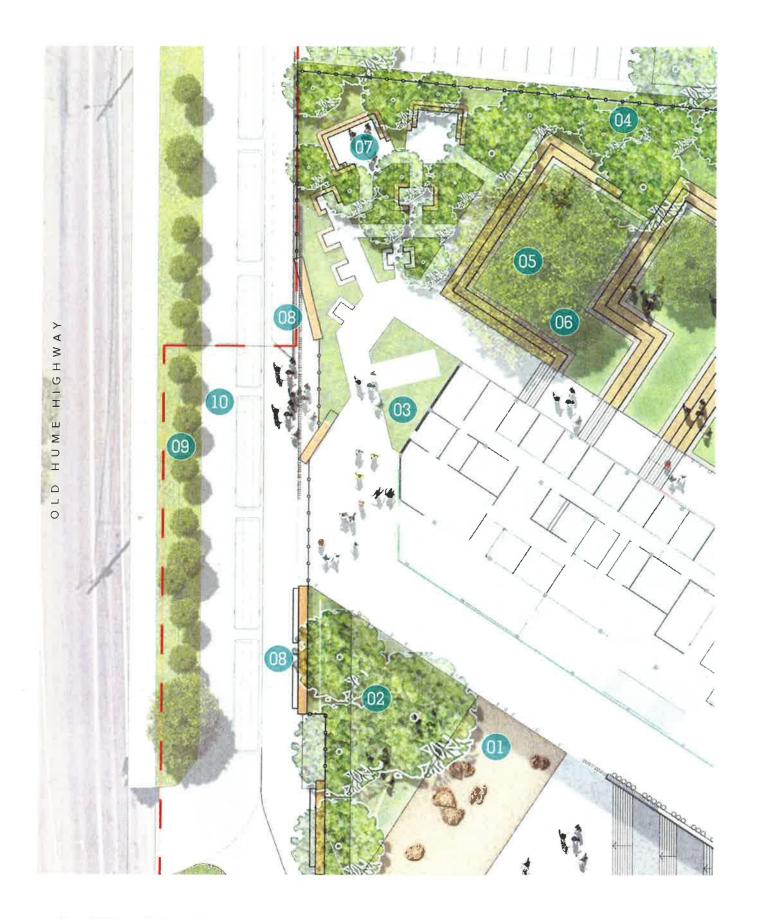

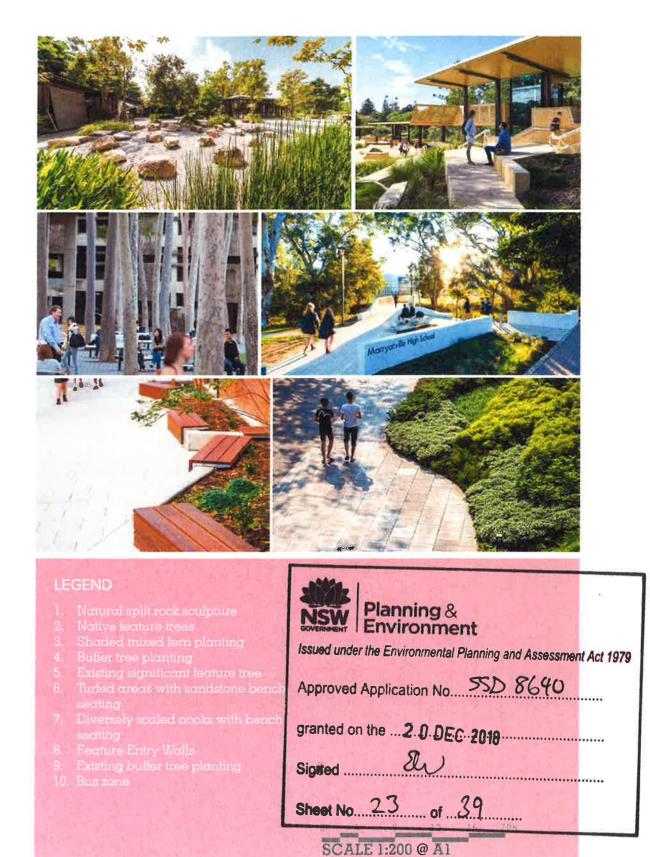



PICTON HIGH SCHOOL LANDSCAPE DESIGN REPORT SSD



CLIENT

PREPARED BY Arcadia Landscape Architecture DATE Feb 2018 Picton High School ARCHITECT Billard Leece

ISSUE B SCALE

MATERIALS | ENTRY FORECOURT





PICTON HIGH SCHOOL LANDSCAPE DESIGN REPORT SSD

WALL TYPE CONCRETE AND TIMBER SEATING WALL



WALL TYPE OFF-FORM CONCRETE WALL



STRUCTURE TYPE FEATURE ROCK BOULDER



DESIGN INTENT + PERFORMANCE CRITERIA

Classic and neutral character

 Hard wearing and low maintenance

MATERIAL RESPONSE

- Dressed hardwood timber
- Steel frame
- Formed concrete structural planter walls

DESIGN INTENT+ PERFORMANCE CRITERIA

- Textured feature wall
- Hard wearing and low maintenance

MATERIAL RESPONSE

• Off-form concr

NSW Environment

Issued under the Environmental Planning and Assessment Act 19

Approved Application No. 33 > 8640

granted on the 2.0 DEC 2019

DESIGN INTENT+

PERFORMANCE CRISION &

• Natural sculpture Sheet No. 24 of 79 • Hard wearing

maintenance

MATERIAL RESPONSE

Split sandstone boulder



CLIENT ARCHITECT Billard Leece

PREPARED BY Arcadia Landscape Architecture Picton High School

DATE Feb 2018 ISSUE B SCALE


Copyright remains the property of **Arcadia**The color required dimensions are to be referred to and supplied by the landscape architect. All discrepancies to be referred to the project manager and Arcadia Landscape Architecture Pty Ltd prior to construction. Ensure compliance with the Building Code of Austialia and all relevant Australian Standards and Authorities.

DETAIL TERRACED LAWNS





PICTON HIGH SCHOOL LANDSCAPE DESIGN REPORT SSD

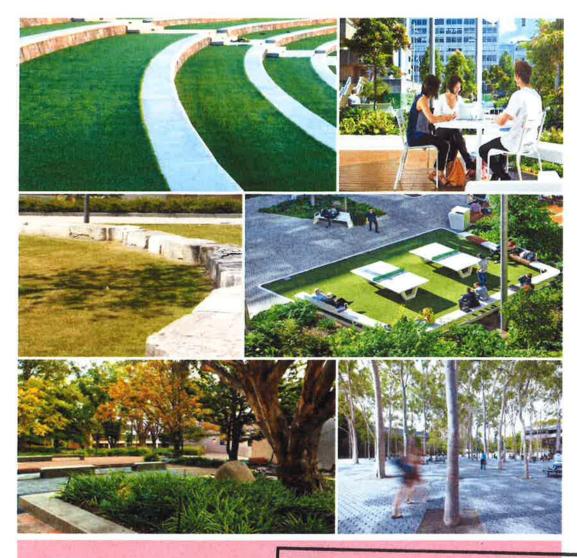



Issued under the Environmental Planning and Assessment Act 1979

Approved Application No. 55D8640

granted on the 2 0 DEC 2018

Sig#ed 7W

Sheet No. 2.5 of .39



ARCHITECT Billard Leece

PREPARED BYArcadia Landscape ArchitectureDATEFeb 2018CLIENTPicton High SchoolISSUEB

SCALE

Copyright remains the property of **Arcadia** and the property of the landscape architecture. It is a contractive and the property of the landscape architecture is a contractive and the contractive and the project amonger and Arcadia Landscape Architecture Pty Lid prior to construction. Ensure compliance with the Building Code of Australia and all relevant Australian Standards and Authorities.

MATERIALS | TERRACED LAWNS



WALL TYPE SANDSTONE BLOCK TERRACES



DESIGN INTENT + PERFORMANCE CRITERIA

- Natural character retaining structure
- Hard wearing and low maintenance

MATERIAL RESPONSE

Sandstone Blocks

STRUCTURE TYPE ROCK BOULDER



DESIGN INTENT + PERFORMANCE CRITERIA

- Retaining element with natural character
- Hard wearing and low maintenance

MATERIAL RESPONSE

• Granite re Planning & Environment

Issued under the Environmental Planning and Assessment Act 1979

Approved Application No. 550 8640

granted on the 2 0 DEC 2018

Sheet No. 76 of 39

PREPARED BY
CLIENT
Picton High School
ARCHITECT
Billard Leece

ISSUE B






Copyright remains the property of Arcadia Lordone, Arcadia Arcadia Lordone, Arcadia Arcadia Lordone, Architecture Pty Lid prior to construction. Ensure compliance with the Building Code of Australia and all relevant Australian Standards and Authorities

DETAIL | SOCIAL HUB





PICTON HIGH SCHOOL LANDSCAPE DESIGN REPORT SSD

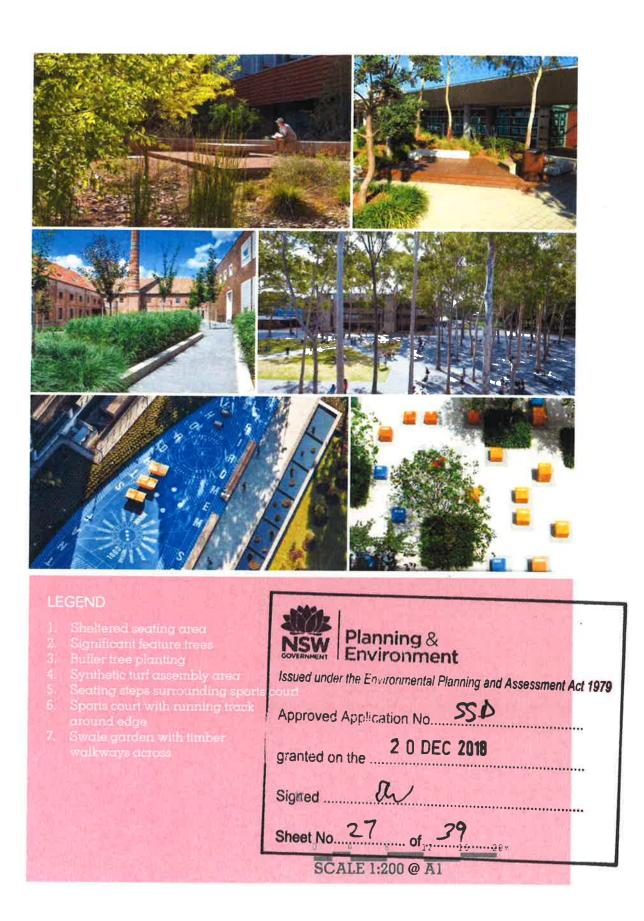




CLIENT

PREPARED BY Arcadia Landscape Architecture DATE Feb 2018 Picton High School ARCHITECT Billard Leece

ISSUE B SCALE

MATERIALS | SOCIAL HUB

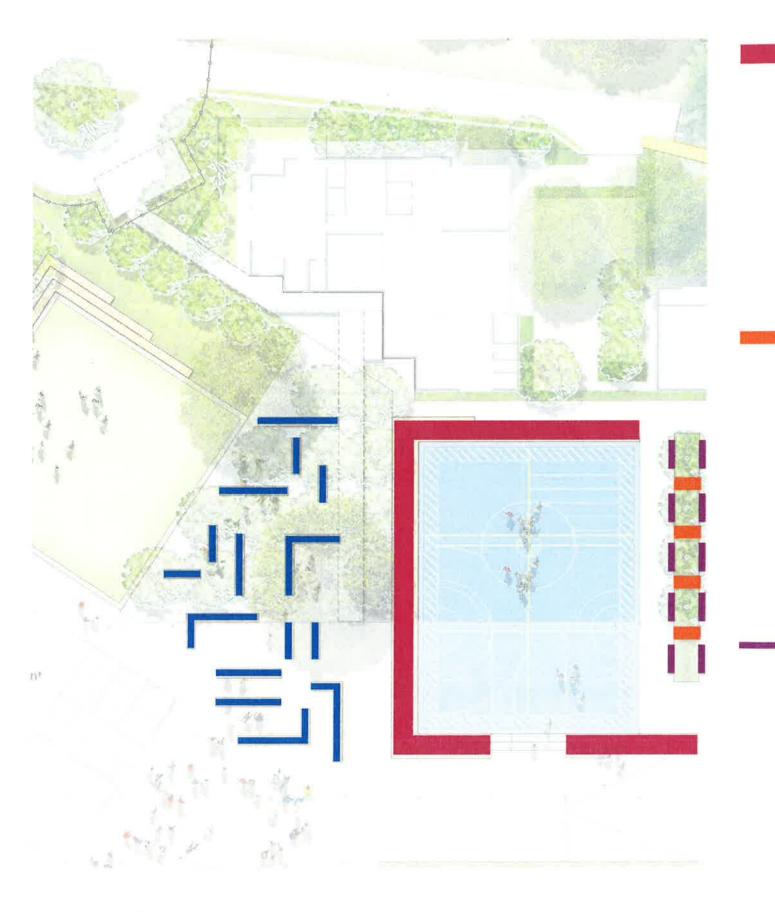

WALL TYPE CONCRETE SEATING STEPS



STRUCTURE TYPE WOOD COMPOSITE DECK



DESIGN INTENT + PERFORMANCE CRITERIA

- Classic character
- Hard wearing and low maintenance

MATERIAL RESPONSIVE Planning & Environment

• Insitu concretissued under the Environmental Planning and Assessment Act 1979

Approved Application No. 555 8640

granted on the 2.0 DEC 2018

DESIGN INTENT + FUNDAMENTAL PERFORMANCE CRITERIA

- Natural character No. 25 of 29
 Hard wearing and low
- maintenance

MATERIAL RESPONSE

• Timber Tech Terrain Decking

FURNITURE TYPE TIMBER BENCH SEATS



FURNITURE TYPE TABLES & BENCHES





PICTON HIGH SCHOOL LANDSCAPE DESIGN REPORT SSD



CLIENT

PREPARED BY Arcadia Landscape Architecture DATE Feb 2018 Picton High School ARCHITECT Billard Leece


ISSUE B SCALE

DETAIL | EDUCATIONAL TRAIL





PICTON HIGH SCHOOL LANDSCAPE DESIGN REPORT SSD

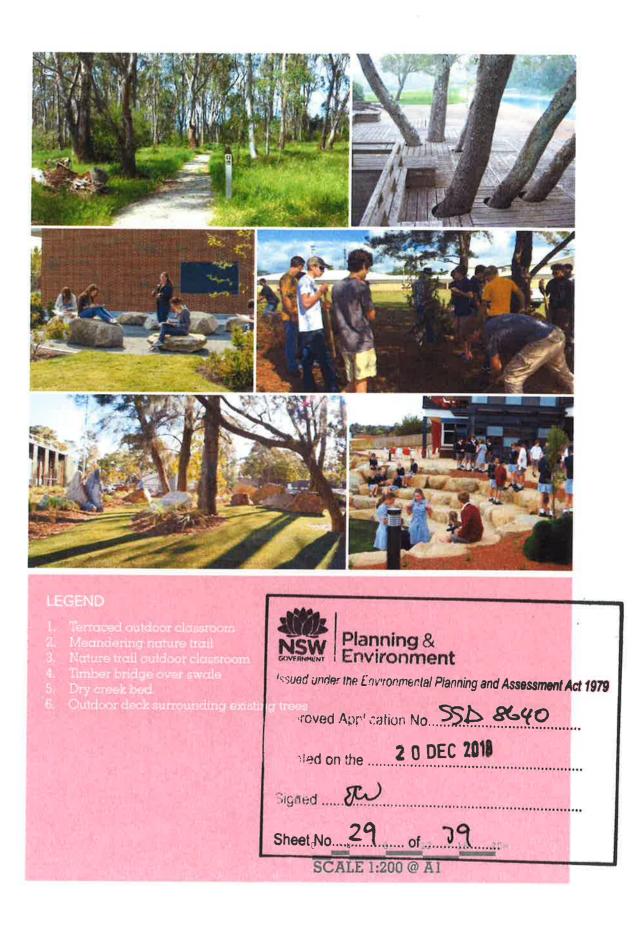



CLIENT

PREPARED BY Arcadia Landscape Architecture DATE Feb 2018 Picton High School ARCHITECT Billiard Leece

ISSUE B

MATERIALS | EDUCATIONAL TRAIL



WALL TYPE SANDSTONE BLOCK TERRACES



DESIGN INTENT + PERFORMANCE CRITERIA

- Natural character retaining structure
- Hard wearing and low maintenance

MATERIAL RESPONSE

• Sandstone Blocks

STRUCTURE TYPE



SANDSTONE AGGREGATES

SURFACE TYPE

DESIGN INTENT+ PERFORMANCE CRITERIA

- Natural character
- Hard wearing and low maintenance

MATERIAL RESPONSE

• Timber Tech Terrain Decking



Issued under the Environmental Planning and Assessment Act 1979

DESIGN INTENT + Approved Application No. 552 8640

PERFORMANCE CRITERIA 2 0 DEC 2018

 Natural character
 Hard wear n §igned low maintenance

Sheet No. 30 of 39

MATERIAL RESPONSE

• Sandstone aggregates





PREPARED BY Arcadia Landscape Architecture DATE Feb 2018 Picton High School ARCHITECT Billard Leece

ISSUE B

Copyright remains the property of Arcadia and a supplied by the landscape architect. All discrepancies to be referred to the architecture Pty Ltd prior to construction. Ensure compliance with the Building Code of Australia and all relevant Australia and Standards and Authorities.

DETAIL | AGRICULTURAL & ENVIRONMENTAL LEARNING











LEGEND 1. Existing paddock 2. Screening hedge 3. Existing trees to be retained 4. Adjacent sports field 5. Terraced outdoor classroom 6. Educational nature trail 0. 4. 5. 12. 15. 20x SCALE 1:200 @ A1

Planning & Environment

Issued under the Environmental Planning and Assessment Act 1979

Approved Application No. SSD 8640

granted on the 20 DEC 2018

Signed Signed Solution Solution Signed Solution Signed Solution Signed Solution Solut



PREP. CLIER ARCH

PREPARED BY Arcadia Landscape Architecture
CLIENT Picton High School
ARCHITECT Billard Leece


DATE Feb 20: ISSUE B SCALE

VISION | NATURE TRAIL



Issued under the Environmental Planning and Assessment Act 1979



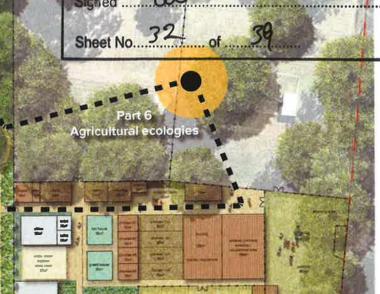



OLD HUME HIGHWAY













PART 1- TREES

The nature trail will help to introduce the students to a wider world of environmental awareness and stewardship.

They will begin by learning about endemic tree types and gain an appreciation for some of the endangered and significant species present.



Continuing along the trail the students will learn about the variety of flora that thrives in cooler parts of the local ecological system.

PART 3 - ESCARPMENT **ECOLOGIES**

Students can learn about the many grasses, drier groundcovers and their many uses as a food source and craft material such as the versitile lomandra longifolia.

PART 4 - SWALES AND **WATER MANAGEMENT**

Introduction and familiarisation with the processes of water and how that integrates with the land. This provides students a starting point in their relationship with water.

PART 5 - CUMBERLAND **PLAIN**

Introducting future stewards to the existing ecological typologies which make up the cumberland plain bioregion by showing those different planting groups at work and how they integrate with one another alongside providing habitat for the endemic fauna

(providing another layer of understanding for the students).

PART 6 - AGRICULTURAL **ECOLOGIES**

Prior parts of the trail will give students a basis for further learning about the cultivation of land, techniques (indigenous and modern), their outputs and impacts.

PART 7 - REFLECTIONS

Upon completion of the trail students will revise and review the lessons at each part as well as giving a platform for critical thought by students into how human impact and agriculture can be recultured, reconsidered and improved.



PICTON HIGH SCHOOL LANDSCAPE DESIGN REPORT SSD



CLIENT ARCHITECT

PREPARED BY Arcadia Landscape Architecture Picton High School Billard Leece

SCALE

DATE Feb 2018 ISSUE B

Copyright remains the property of Arcadia Levasca (E.E., n. 1813). In this cases of an include Arty other required dimensions are to be referred to and supplied by the landscape architect. All discrepancies to be referred to the project imanager and Arcadia Landscape Architecture Ply Lid prior to construction Ensure compliance with the Building Code of Australia and all relevant Australian Standards and Authorities

SOFTSCAPE | PLANTING CHARACTER



Issued under the Environmental Planning and Assessment Act 1979

Approved Application No. 5508640

2 D DEC 2018 TREES **SHRUBS**

GRASSES



GROUND COVERS







PICTON HIGH SCHOOL LANDSCAPE DESIGN REPORT SSD


CLIENT ARCHITECT Billard Leece

PREPARED BY Arcadia Landscape Architecture DATE Feb 2018 Picton High School

ISSUE B SCALE

Copyright remains the property of Arcadia
other required dimensions are to be referred to ano supplied by the landsque architect. All discrepances to
be referred to the propert managet and Arcadia Landscape Architecture Pty Ltd prior to construction. Ensure
compliance with the Building Code of Australia and all relevant Australian Standards and Authorities.

SOFTSCAPE | TREE SIZE SPECIFICATION & FORMAL SOFTSCAPE AREAS

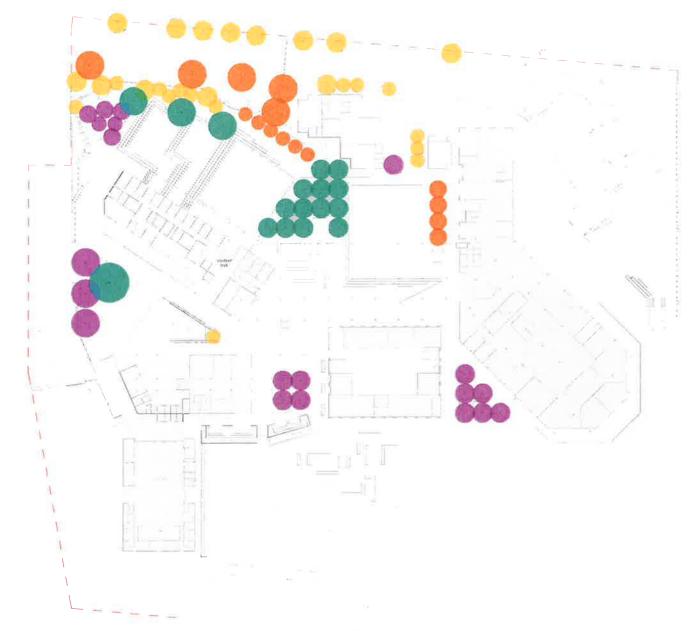


TOTAL NUMBER OF PROPOSED TREES 79

	POT SIZE	HEIGHT	QUANTITY
	75L	2 - 2.5m	26
	100L	2.5 - 3.5m	15
9	200L	3.5 - 4.5m	20
B	400L	4.5 - 6m	17



PICTON HIGH SCHOOL LANDSCAPE DESIGN REPORT SSD

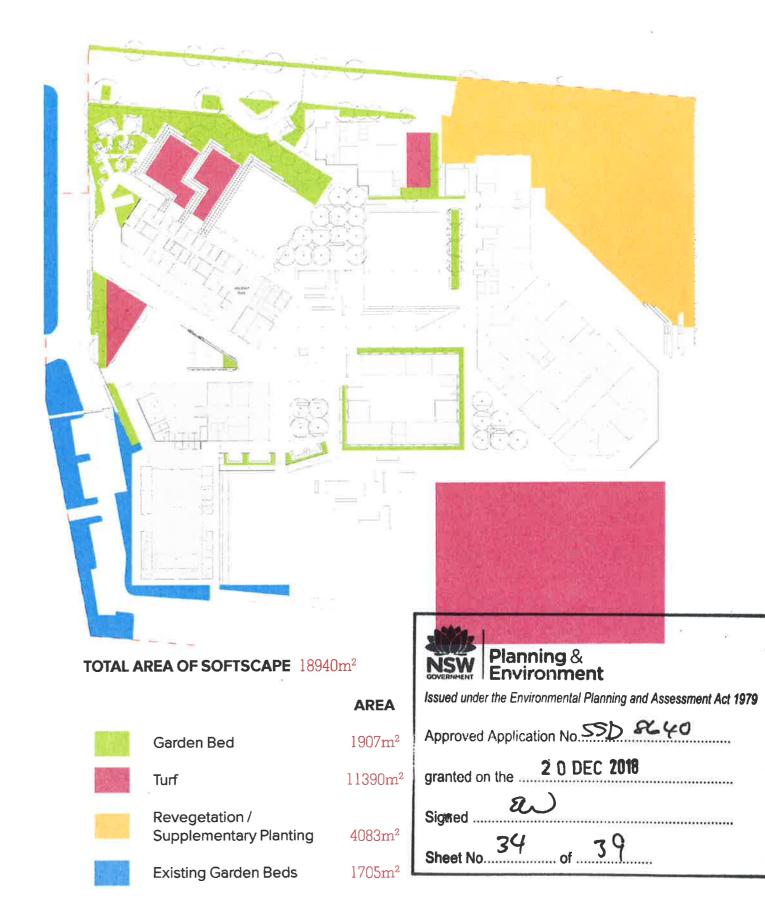




CLIENT ARCHITECT Billard Leece

PREPARED BY Arcadia Landscape Architecture Picton High School

DATE Feb 2018 ISSUE B SCALE

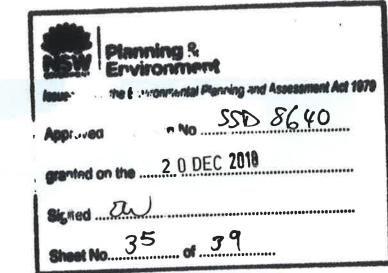



- 1 EXISTING FLAGPOLE TO BE RE-LOCATED
- 2 SOFT LANDSCAPING ALONG SECURITY FENCING
- 3 BUSHTUCKER GARDEN
- 4 COMMUNITY GARDEN

5 - MEMORIAL BRICKS TO BE RE-INSTATED






DEPARTMENT OF EDUCATION

PICTON HIGH SCHOOL REDEVELOPMENT

FRONT ENTRY - LANDSCAPING AND SECURITY FENCE

APPROACH | TREE RETENTION + REMOVAL STRATEGY

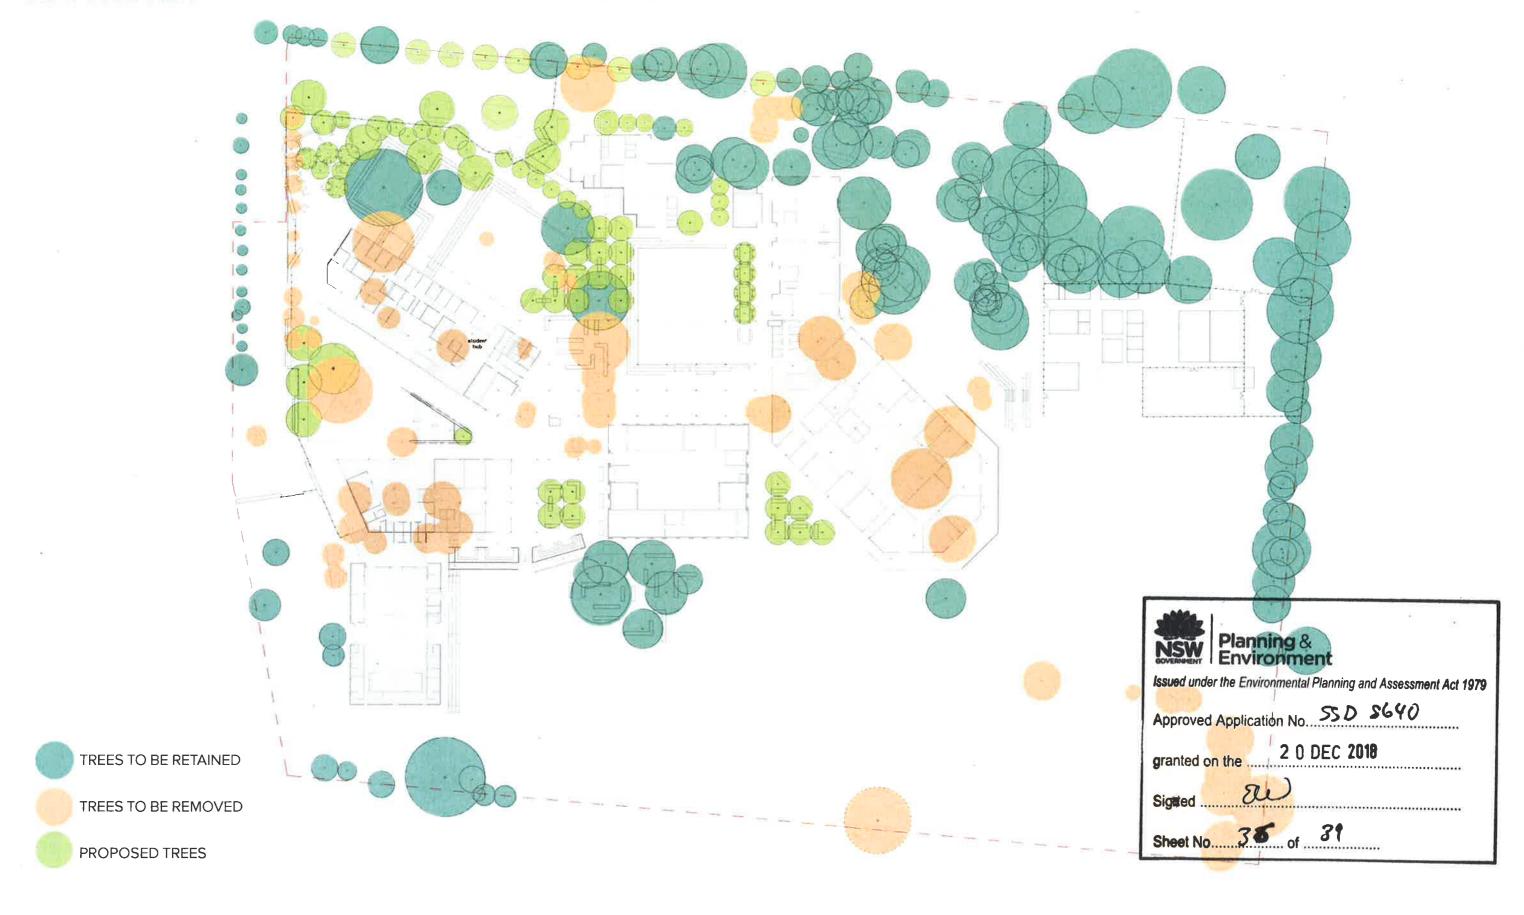



PICTON HIGH SCHOOL LANDSCAPE DESIGN REPORT SSD





CLIENT


PREPARED BY Arcadia Landscape Architecture DATE Oct 2018 Picton High School ARCHITECT Billard Leece

ISSUE D SCALE


Copyright remains the property of Atcadia Landscape Architecture Pty Ltd. Use only figured dimensions. Any other required dimensions are to be referred to and supplied by the landscape architect. All discrepancies to be referred to the project manager and Arcadia Landscape Architecture Pty-Ltd prior to construction. Ensure compliance with the Building Code of Australia and all relevant Australian Standards and Authorities.

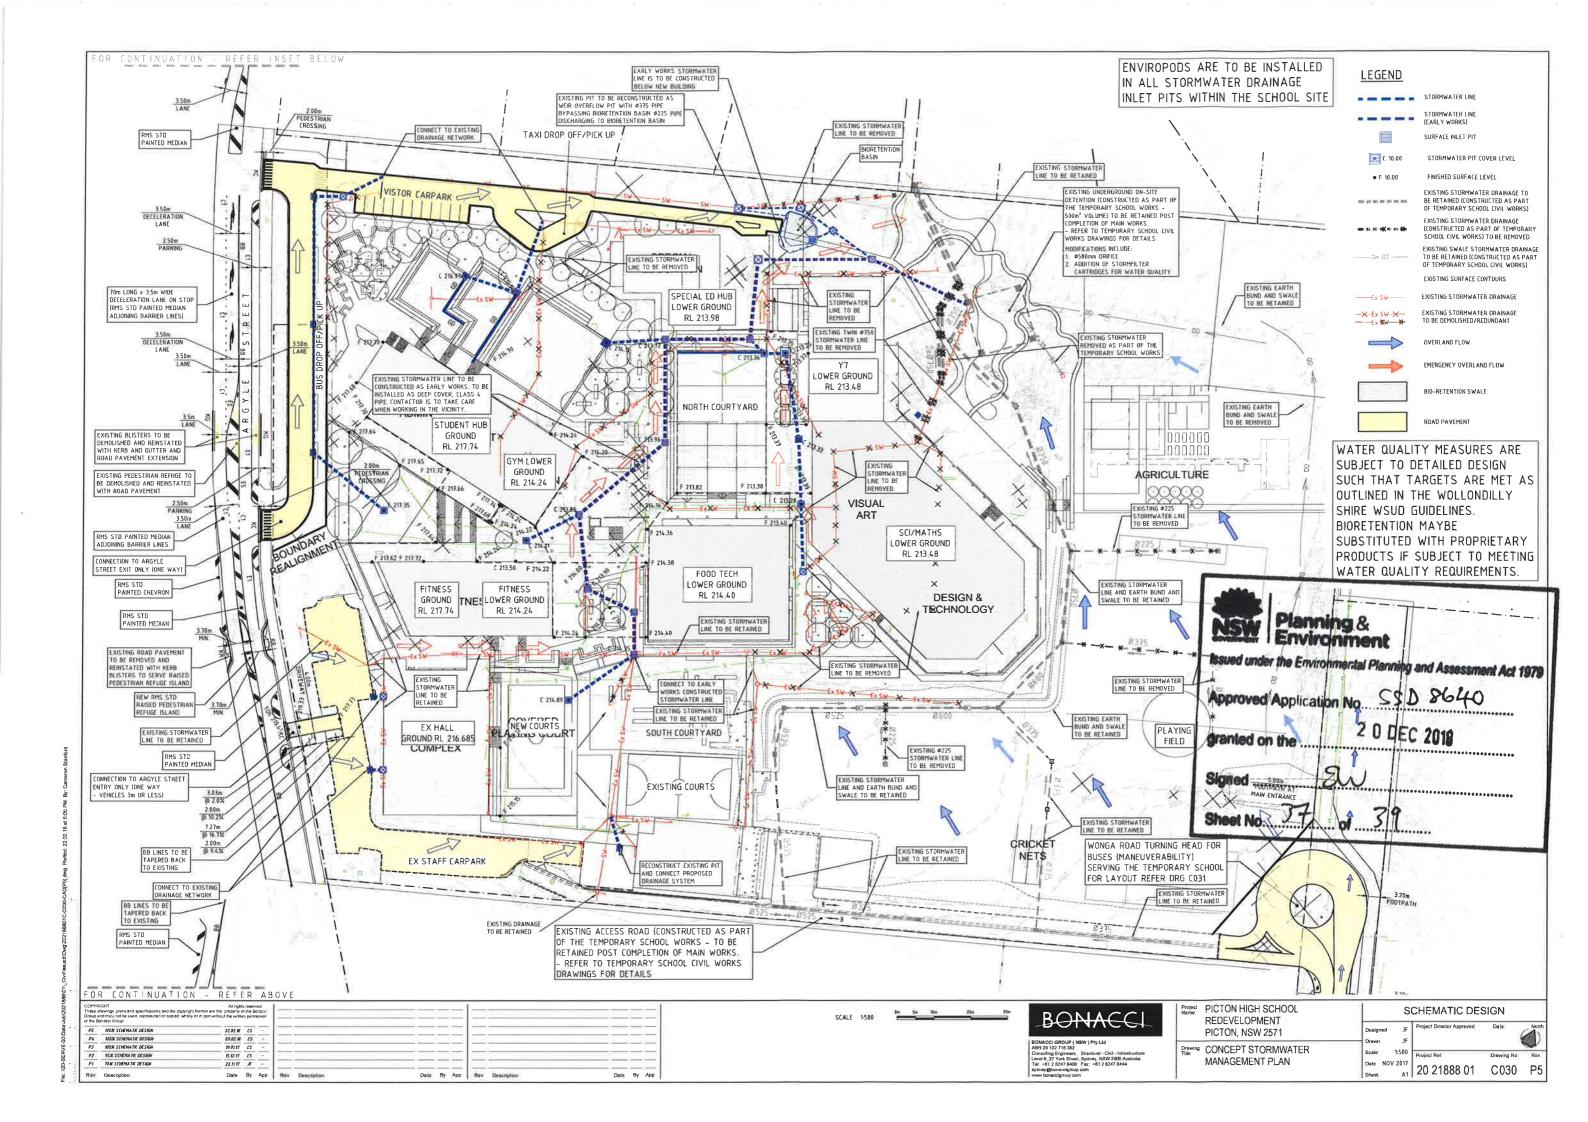

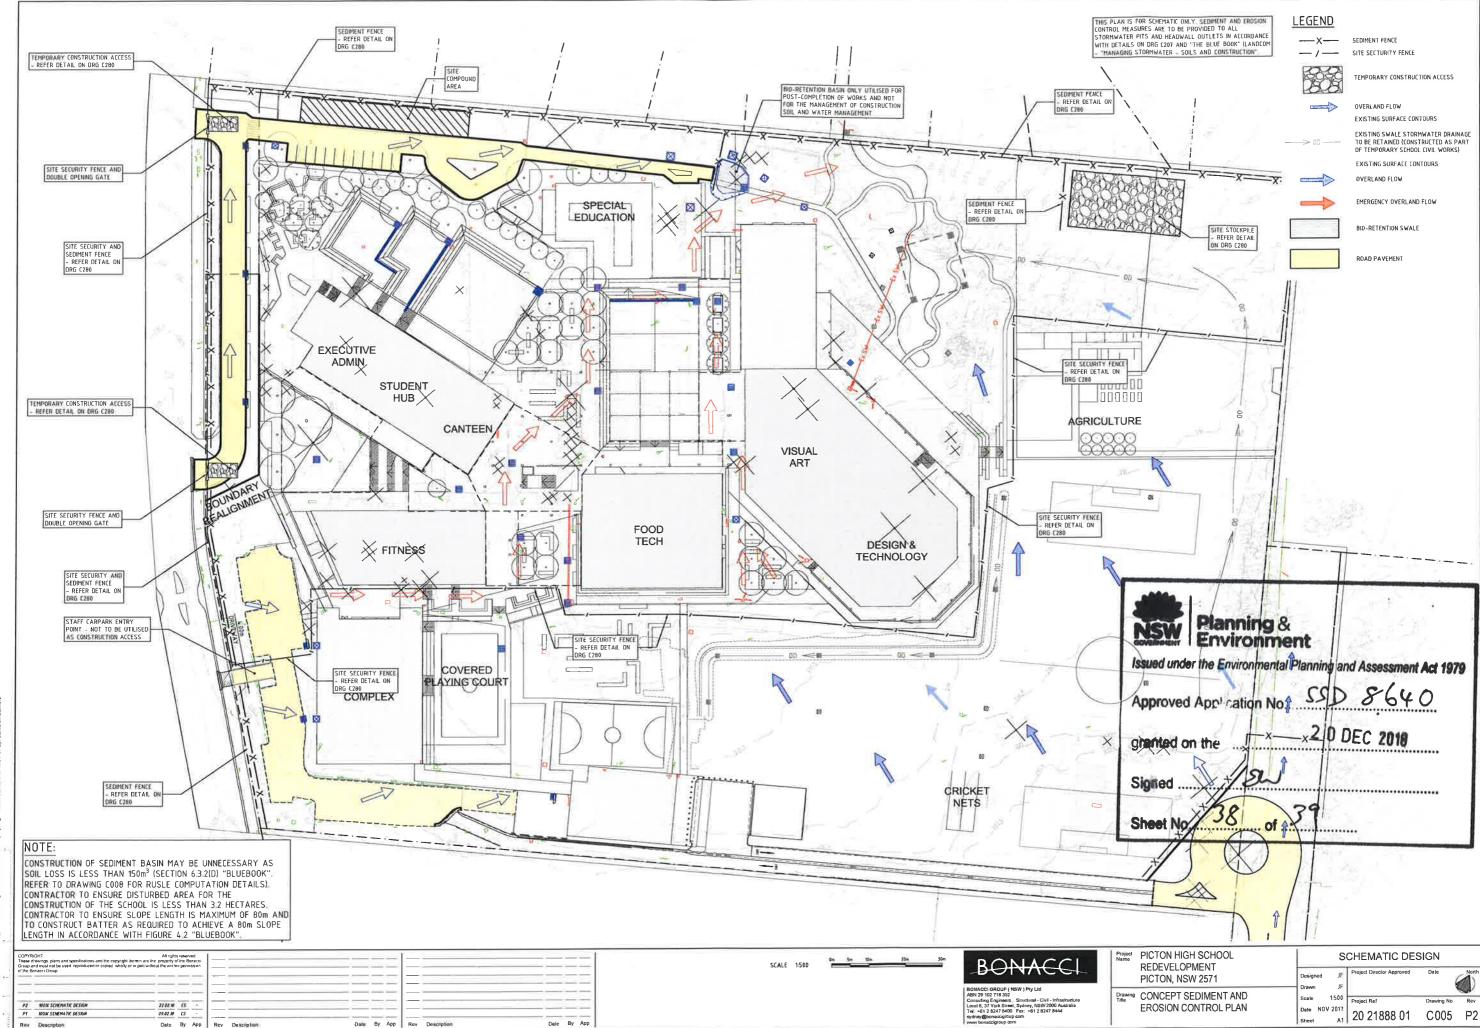

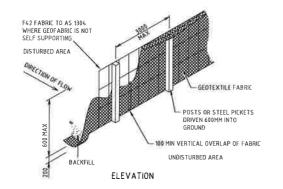


SEDIMENT FENCE

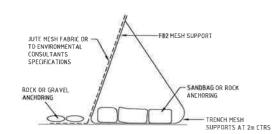

ALTERNATIVE SEDIMENT FENCE


ALTERNATIVE SEDIMENT FENCE NOTES

- 1. INSTALL THIS TYPE OF SEDIMENT FENCE WHEN USE OF SUPPORT POSTS IS NOT DESIRABLE OR NOT POSSIBLE. SUCH CONDITIONS MIGHT APPLY, FOR EXAMPLE, WHERE APPROVAL IS GRANTED FROM THE APPROVANTE AUTHORITIES TO PLACE THESE FENCES IN HIGHLY SENSITIVE ESTUARINE AREAS.
 2. USE BENT TRENCH MEST TO SUPPORT THE FEB WELDED MESH FACING AS SHOWN ON THE DRAWMO ABOVE. ATTACH THE JUTE MESH TO THE WELDED MESH FACING USING UV-RESISTANT CABLE TIES.
 3. STABILISE THE WHOLE STRUCTURE WITH SANDDBAG OR ROCK ANCHORING OVER THE TRENCH MESH AND THE LEADING EDGE OF THE JUTE MESH. THE ANCHORING SHOULD BE SUFFICIENTLY LARGE TO ENSURE STABILITY OF THE STRUCTURE IN THE DESIGN STORM EVENT, USUALLY THE 10 YEAR EVENT.

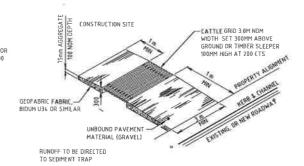


TEMPORARY CONSTRUCTION VEHICLE ENTRY/EXIT SEDIMENT TRAP

NOT TO SCALE

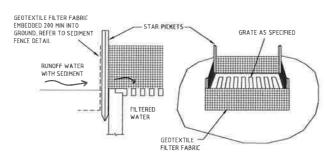


GEOTEXTILE PIT FILTER 1

NOT TO SCALE

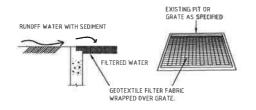



GEOTEXTILE PIT FILTER 2

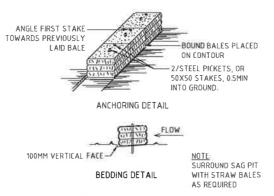


STRAW BALE BANK SEDIMENT CONTROL

NOT TO SCALE

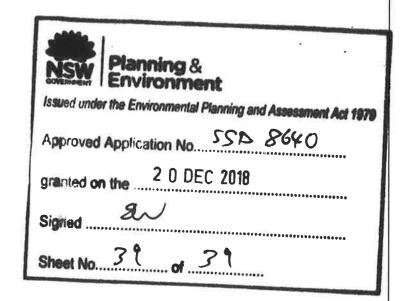

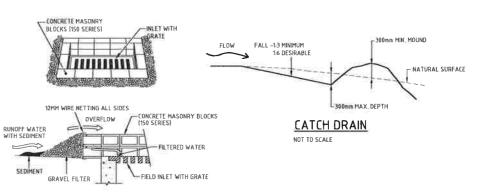


FIELD INLET SEDIMENT TRAP

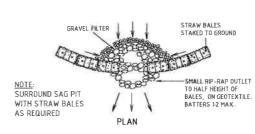

STRAW BALE AND STONE TRAP SEDIMENT CONTROL (CONCENTRATE FLOW)

NOT TO SCALE

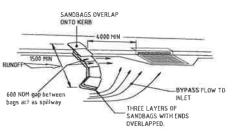

ON GRADE KERB INLET SEDIMENT TRAP

P4 NON STHEMATIC DE 09.02.18 (S -Date By App

BONACC

PICTON HIGH SCHOOL REDEVELOPMENT PICTON, NSW 2571 SEDIMENT AND EROSION CONTROL DETAILS

SCHEMATIC DESIGN NTS Project Ref Date DEC 2017 2017 20 21888 01 C007 P1