

**2 SECTION FACING SOUTH**  
 21-02 SCALE 1:200

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Rev	Description	By	Date
A	PRELIMINARY ISSUE	SPG	08.11.2017
B	FOR INFORMATION	SPG	15.11.2017
C	SSDA	SPG	31.01.2018

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Nominated Architects  
 Joe Agus no. 6491  
 Russell Lee no. 6367

Project

**THE UNIVERSITY OF SYDNEY ETP STAGE 1**

Electrical Engineering Building  
 University in Darlington, NSW 2008

Drawing Title

**SECTIONS - EAST TO WEST**

A1 DRAWING SHEET

Co-ordinated: Michael Grave

Project Architect: Michael Bradburn

Project Director: David Holm

Drawing Number:

**A-DA-4001**

Drawn: SPG


Scale: 1:200 @ A1

Date: 31/01/18

Revision: C

North:



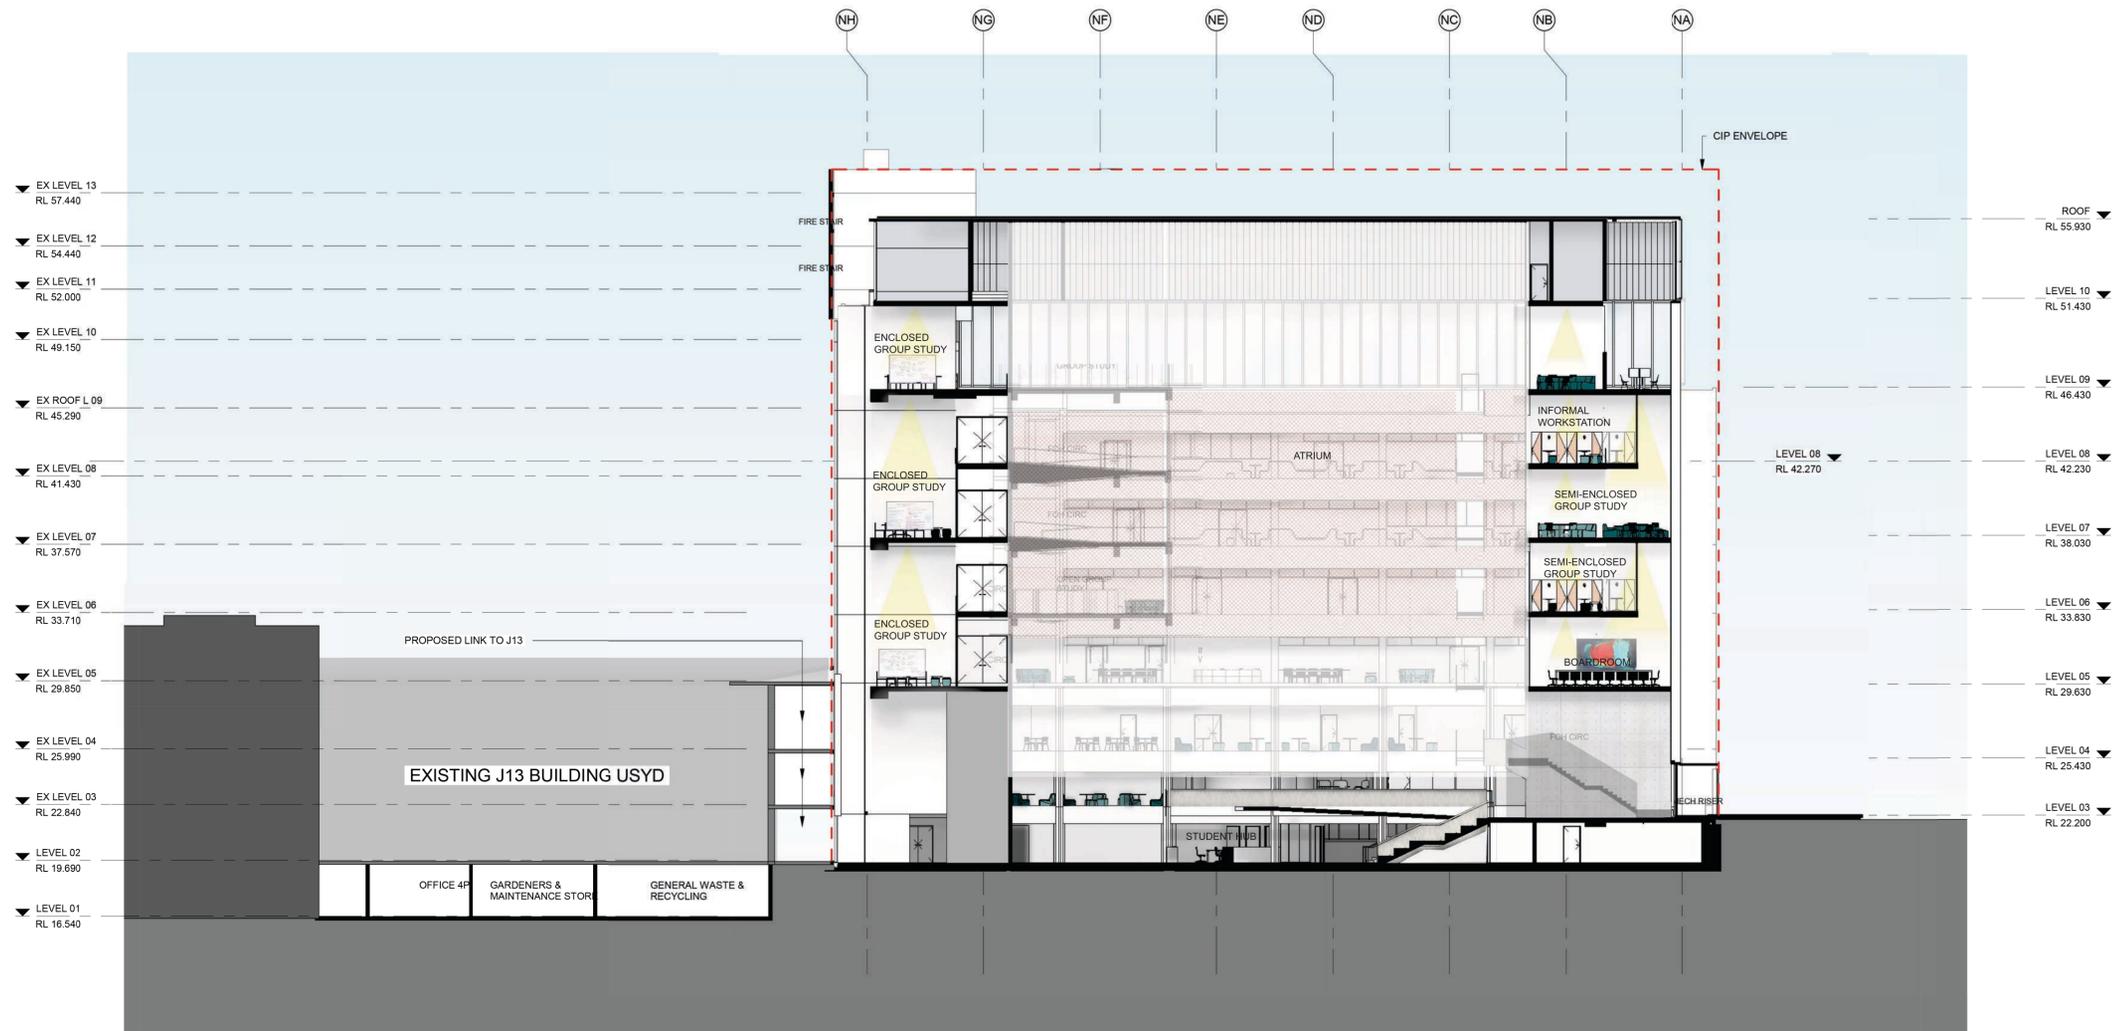

**2 SECTION FACING SOUTH**  
 21-02 SCALE 1:200

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Nominated Architects  
 Joe Agius no. 6491  
 Russell Lee no. 6367

Project

**THE UNIVERSITY OF SYDNEY ETP STAGE 1**

Electrical Engineering Building  
 University in Darlington, NSW 2008

Drawing Title

**SECTIONS - EAST TO WEST**

A1 DRAWING SHEET

Co-ordinated: Michael Grave

Project Architect: Michael Bradburn

Project Director: David Holm

Drawing Number: A-DA-4001

Drawn: SPG


Scale: 1:200 @ A1

Date: 31/01/18

Revision: C

North:

A-DA-4001

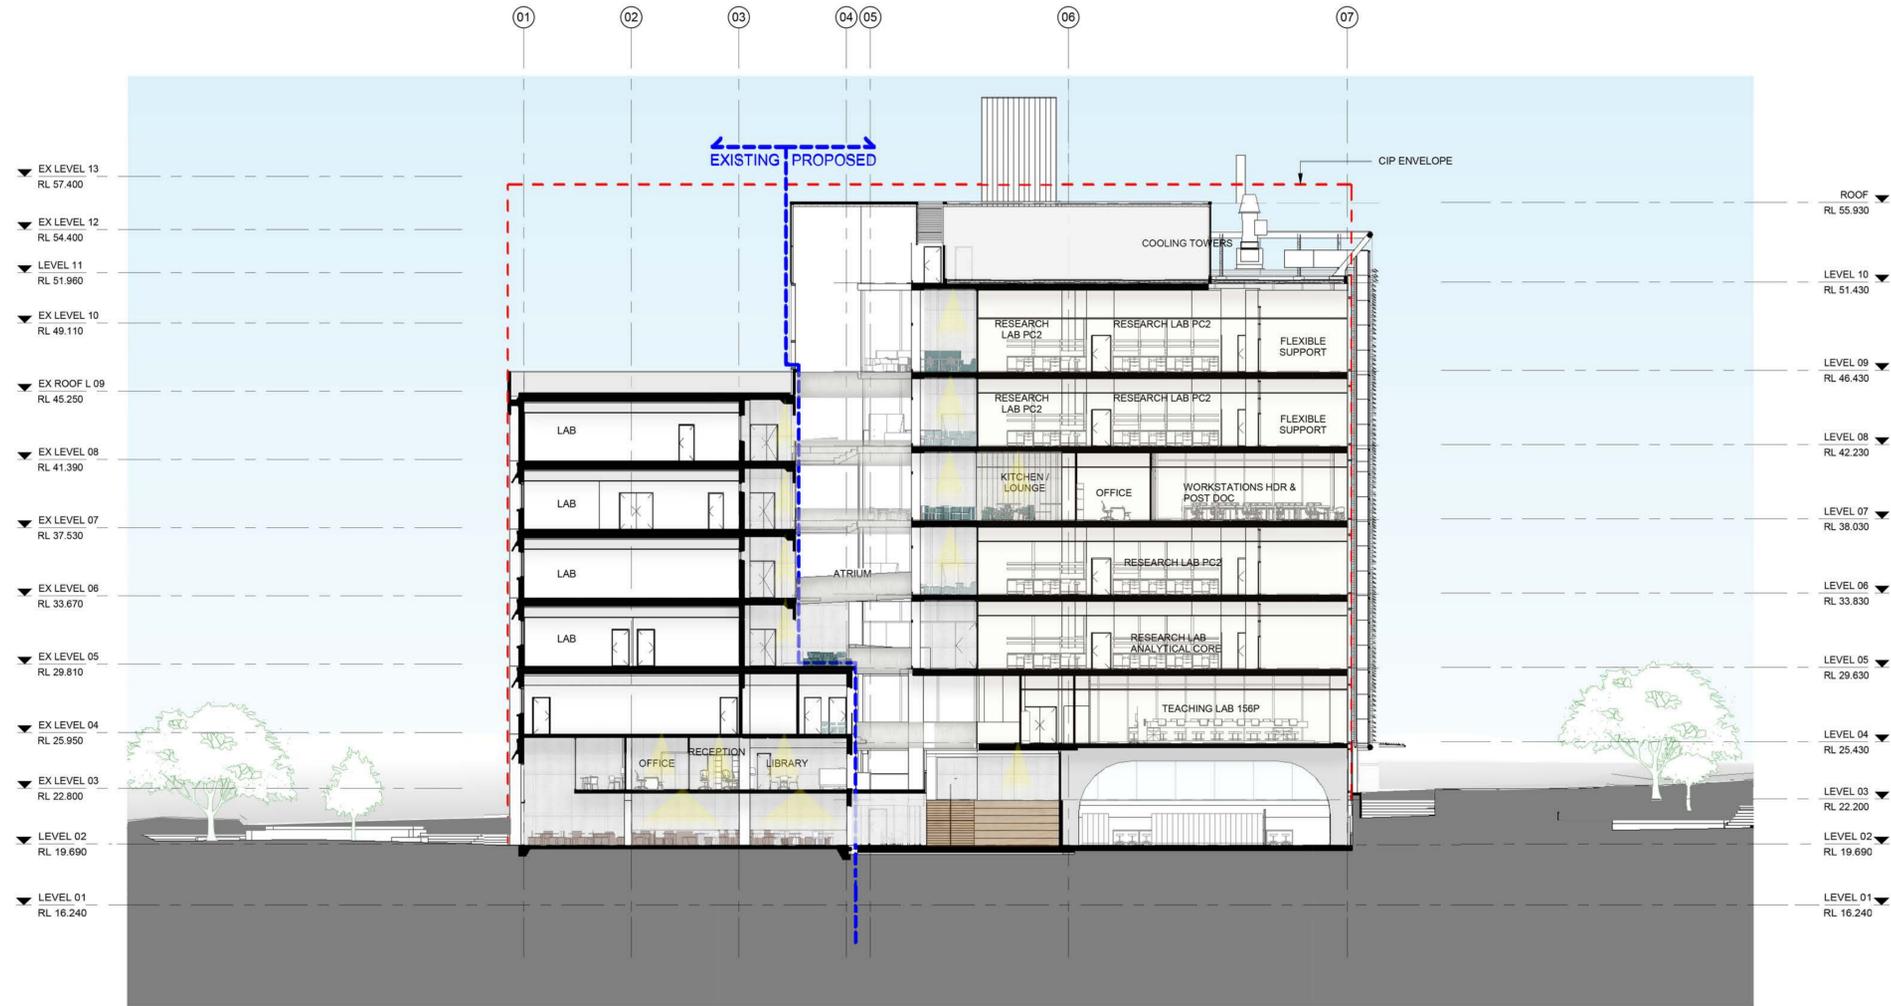

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Project

THE UNIVERSITY OF SYDNEY ETP STAGE 1

Electrical Engineering Building  
 University in Darlingtown, NSW 2008

Drawing Title

SECTIONS - NORTH TO SOUTH

A1 DRAWING SHEET

Co-ordinated: Michael Grave

Project Architect: Michael Bradburn

Project Director: David Holm

Drawing Number:

A-DA-4002

Drawn: SPG

Scale: 1:200 @ A1

Date: 31/01/18

Revision: C

North:




Cox Architecture Pty Ltd ACN 002 535 891

- GFA (EXISTING STRUCTURE)
- GFA (TO BE RECONFIGURED)


GFA (EXISTING STRUCTURE): 4596.82m<sup>2</sup>  
 GFA (TO BE RECONFIGURED): 2899.04m<sup>2</sup>  
**TOTAL:** 7495.86m<sup>2</sup>




**1** LEVEL 01 (SHEET 01 OF 02) - EXISTING AREA PLAN  
 SCALE 1:500  
 GFA (EXISTING STRUCTURE): N/A  
 GFA (TO BE RECONFIGURED): N/A

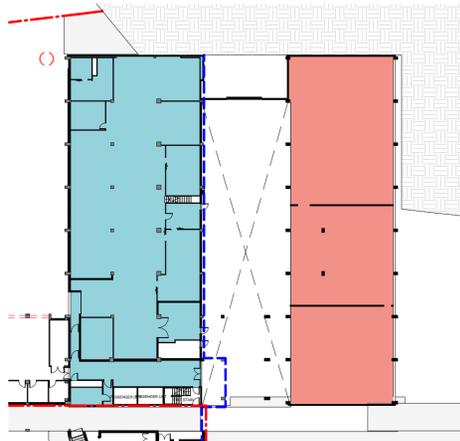


**2** LEVEL 02 - EXISTING AREA PLAN  
 SCALE 1:500  
 GFA (EXISTING STRUCTURE): 861.27m<sup>2</sup>  
 GFA (TO BE RECONFIGURED): 716.74m<sup>2</sup>

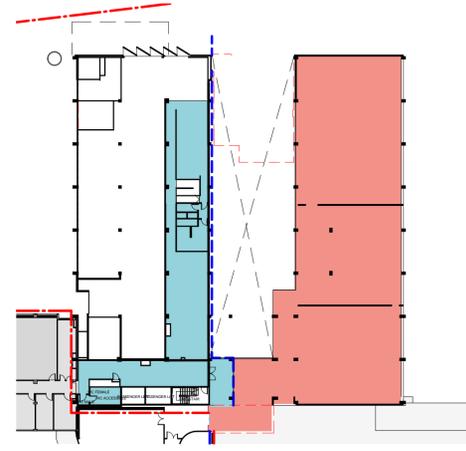

**3** LEVEL 03 - EXISTING AREA PLAN  
 SCALE 1:500  
 GFA (EXISTING STRUCTURE): 320.28m<sup>2</sup>  
 GFA (TO BE RECONFIGURED): 858.84m<sup>2</sup>

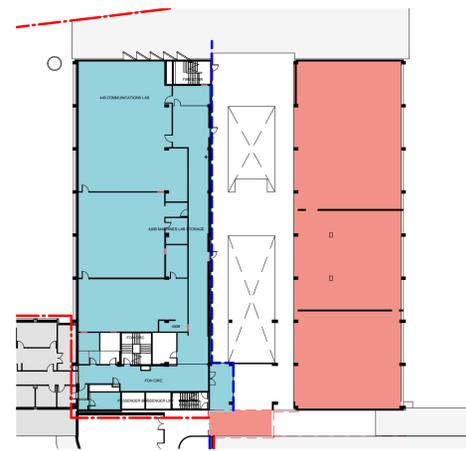


**4** LEVEL 04 - EXISTING AREA PLAN  
 SCALE 1:500  
 GFA (EXISTING STRUCTURE): 845.08m<sup>2</sup>  
 GFA (TO BE RECONFIGURED): 780.64m<sup>2</sup>

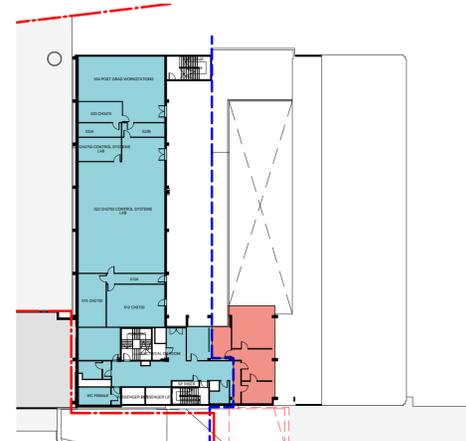


**5** LEVEL 05 - EXISTING AREA PLAN  
 SCALE 1:500  
 GFA (EXISTING STRUCTURE): 635.81m<sup>2</sup>  
 GFA (TO BE RECONFIGURED): 97.25m<sup>2</sup>




**6** LEVEL 06 - EXISTING AREA PLAN  
 SCALE 1:500  
 GFA (EXISTING STRUCTURE): 616.98m<sup>2</sup>  
 GFA (TO BE RECONFIGURED): 113.90m<sup>2</sup>

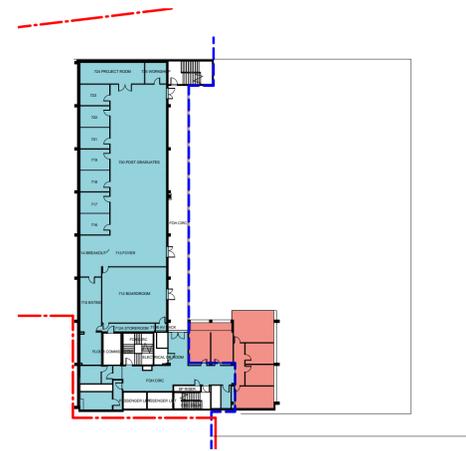


**7** LEVEL 07 - EXISTING AREA PLAN  
 SCALE 1:500  
 GFA (EXISTING STRUCTURE): 602.40m<sup>2</sup>  
 GFA (TO BE RECONFIGURED): 113.90m<sup>2</sup>

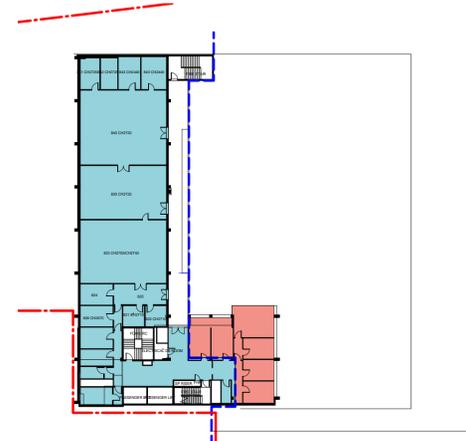


**8** LEVEL 08 - EXISTING AREA PLAN  
 SCALE 1:500  
 GFA (EXISTING STRUCTURE): 616.25m<sup>2</sup>  
 GFA (TO BE RECONFIGURED): 113.90m<sup>2</sup>

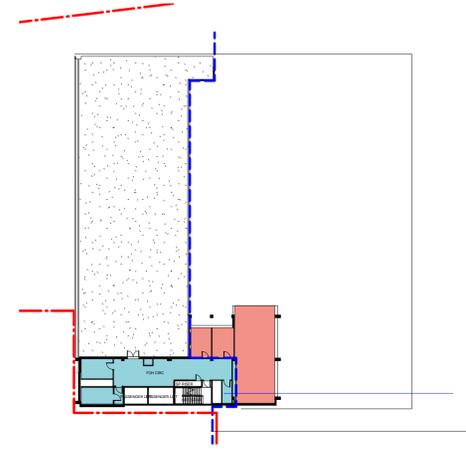

**9** LEVEL 09 - EXISTING AREA PLAN  
 SCALE 1:500  
 GFA (EXISTING STRUCTURE): 98.75m<sup>2</sup>  
 GFA (TO BE RECONFIGURED): 103.87m<sup>2</sup>

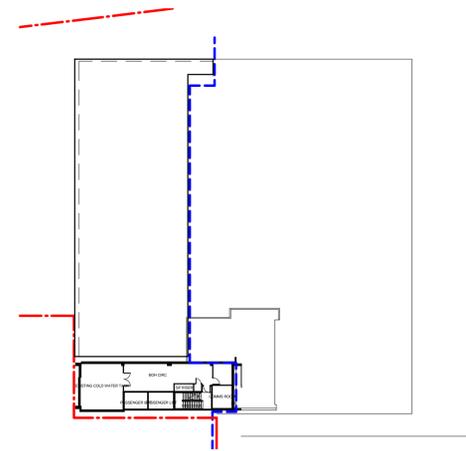

**10** LEVEL 10 - EXISTING AREA PLAN  
 SCALE 1:500  
 GFA (EXISTING STRUCTURE): N/A  
 GFA (TO BE RECONFIGURED): N/A

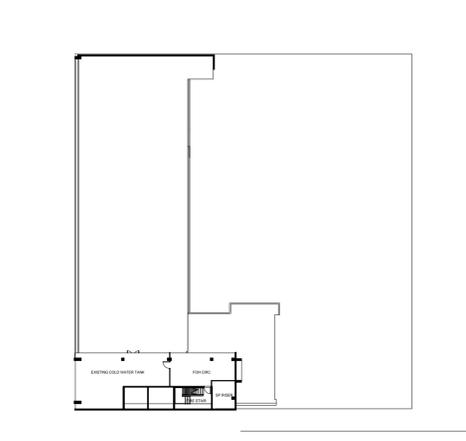

**11** LEVEL 11 - EXISTING AREA PLAN  
 SCALE 1:500  
 GFA (EXISTING STRUCTURE): N/A  
 GFA (TO BE RECONFIGURED): N/A

Rev	Description	By	Date
A	SSDA	SPG	31.01.2018

PLOT STAMP DATE: 29/03/2018 10:20:48 AM

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Nominated Architects  
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 Russell Lee no. 6367

Project

**THE UNIVERSITY OF SYDNEY ETP STAGE 1**  
 Electrical Engineering Building  
 University in Darlington, NSW 2008

Drawing Title

**GFA CALCULATION EXISTING**

AT DRAWING SHEET

Co-ordinated: Michael Grave  
 Project Architect: Michael Bradburn  
 Project Director: David Holm

Drawing Number:

**A-DA-7000**

Drawn: SPG

Scale: As indicated @ A1  
 Date: 31/01/18  
 Revision: A

North:




Cox Architecture Pty Ltd ACN 002 535 891

- GFA (EXISTING STRUCTURE)
- GFA (NEW STRUCTURE)


GFA (EXISTING STRUCTURE): 4657.55m<sup>2</sup>  
 GFA (NEW STRUCTURE): 8818 m<sup>2</sup>  
**TOTAL: 13475.55 m<sup>2</sup>**




**1** LEVEL 01 - AREA PLAN  
 SCALE 1:500  
 GFA (EXISTING STRUCTURE): N/A  
 GFA (NEW STRUCTURE): 375 m<sup>2</sup>

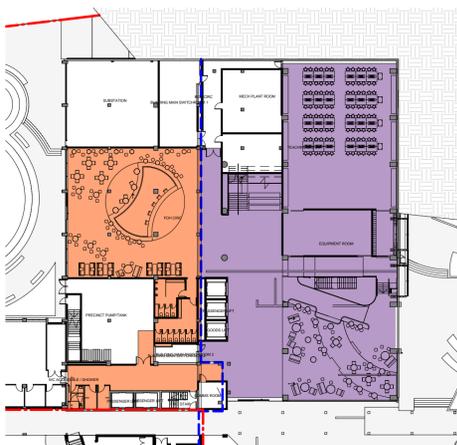


**3** LEVEL 02 - AREA PLAN  
 SCALE 1:500  
 GFA (EXISTING STRUCTURE): 525.08m<sup>2</sup>  
 GFA (NEW STRUCTURE): 1123 m<sup>2</sup>

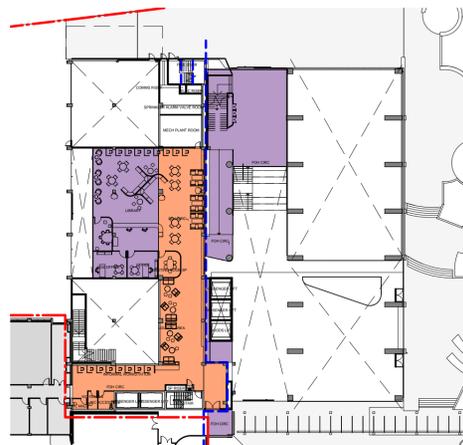


**4** LEVEL 03 - AREA PLAN  
 SCALE 1:500  
 GFA (EXISTING STRUCTURE): 307.71m<sup>2</sup>  
 GFA (NEW STRUCTURE): 406 m<sup>2</sup>

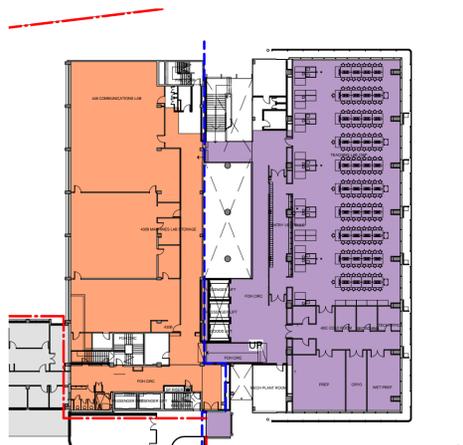


**5** LEVEL 04 - AREA PLAN  
 SCALE 1:500  
 GFA (EXISTING STRUCTURE): 812.25m<sup>2</sup>  
 GFA (NEW STRUCTURE): 1039 m<sup>2</sup>

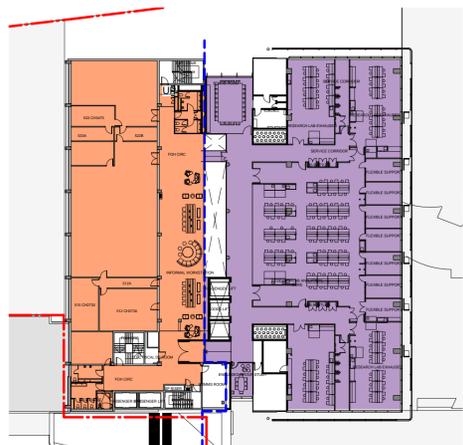


**6** LEVEL 05 - AREA PLAN  
 SCALE 1:500  
 GFA (EXISTING STRUCTURE): 839.43m<sup>2</sup>  
 GFA (NEW STRUCTURE): 1136 m<sup>2</sup>

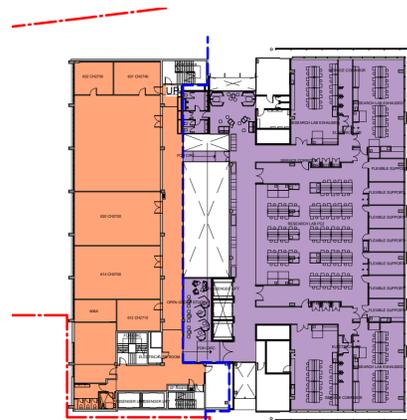


**7** LEVEL 06 - AREA PLAN  
 SCALE 1:500  
 GFA (EXISTING STRUCTURE): 703.46m<sup>2</sup>  
 GFA (NEW STRUCTURE): 1174 m<sup>2</sup>

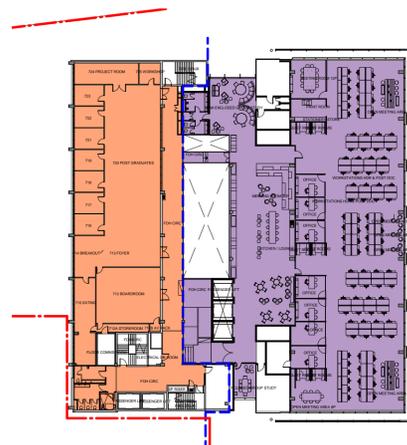


**8** LEVEL 07 - AREA PLAN  
 SCALE 1:500  
 GFA (EXISTING STRUCTURE): 691.21m<sup>2</sup>  
 GFA (NEW STRUCTURE): 1203 m<sup>2</sup>

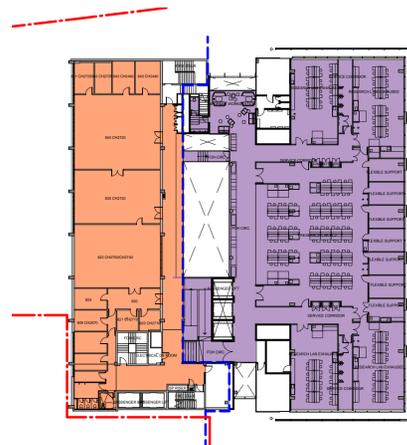


**9** LEVEL 08 - AREA PLAN  
 SCALE 1:500  
 GFA (EXISTING STRUCTURE): 687.45m<sup>2</sup>  
 GFA (NEW STRUCTURE): 1163 m<sup>2</sup>

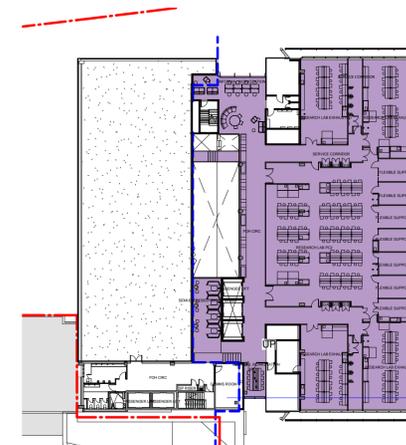

**10** LEVEL 09 - AREA PLAN  
 SCALE 1:500  
 GFA (EXISTING STRUCTURE): 90.96m<sup>2</sup>  
 GFA (NEW STRUCTURE): 1199 m<sup>2</sup>

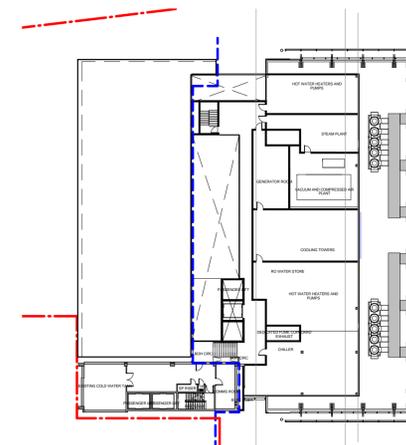

**11** LEVEL 10 - AREA PLAN  
 SCALE 1:500  
 GFA (EXISTING STRUCTURE): N/A  
 GFA (NEW STRUCTURE): N/A

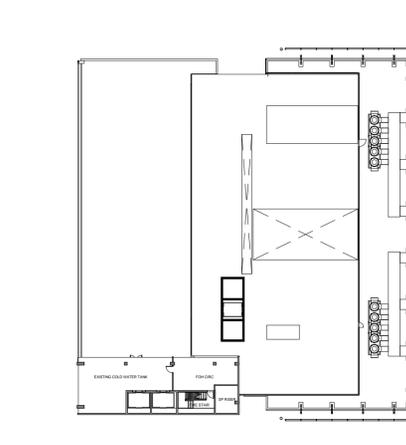

**12** LEVEL 11 - AREA PLAN  
 SCALE 1:500  
 GFA (EXISTING STRUCTURE): N/A  
 GFA (NEW STRUCTURE): N/A

Rev	Description	By	Date
A	SSDA	SPG	31.01.2018

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Principal



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Nominated Architects  
 Joe Agius no. 6491  
 Russell Lee no. 6367

Project

THE UNIVERSITY OF SYDNEY ETP STAGE 1

Electrical Engineering Building  
 University in Darlington, NSW 2008

Drawing Title

GFA CALCULATION PROPOSED

AT DRAWING SHEET

Drawn: SPG

Co-ordinated: Michael Grave Scale: As indicated @ A1


Project Architect: Michael Bradburn Date: 31/01/18

Project Director: David Holm Revision: A


Drawing Number: North

A-DA-7001


Cox Architecture Pty Ltd ACN 002 535 891

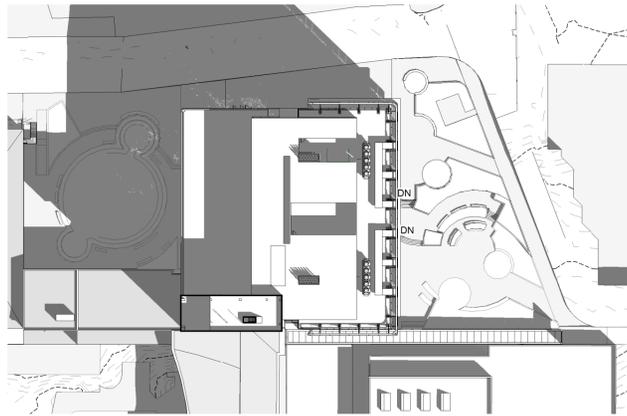


1 EQUINOX - 9AM  
30-01 SCALE 1 : 800

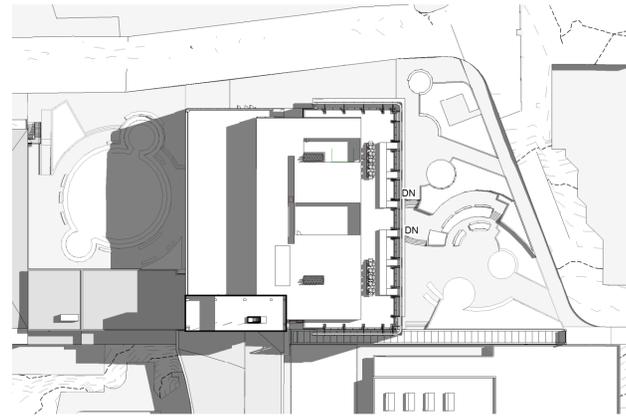


2 EQUINOX - 12PM  
30-01 SCALE 1 : 800

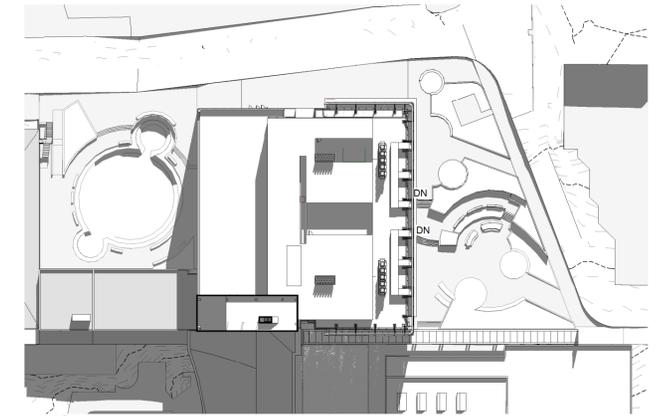


3 EQUINOX - 3PM  
30-01 SCALE 1 : 800

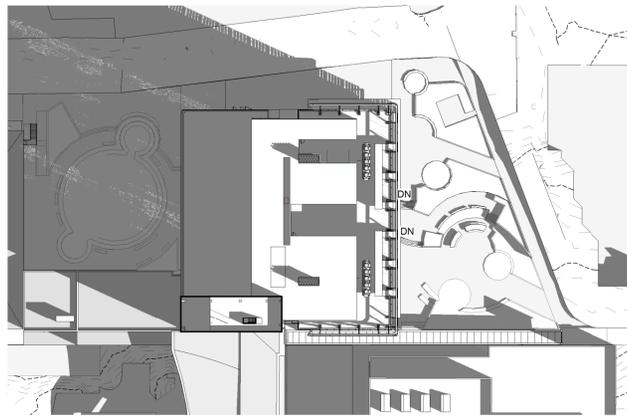


4 WINTER SOLSTICE - 9AM  
30-01 SCALE 1 : 800

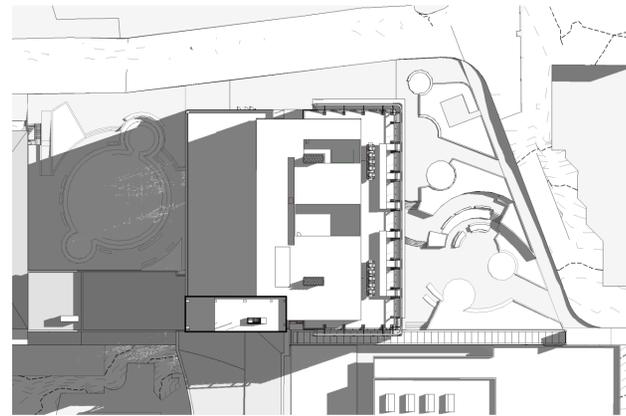


5 WINTER SOLSTICE - 12PM  
30-01 SCALE 1 : 800

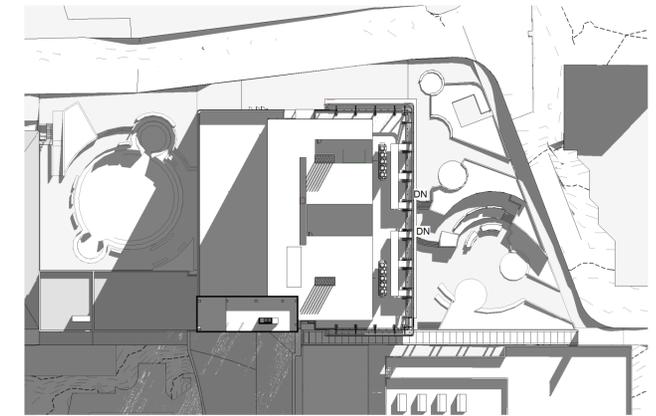

6 WINTER SOLSTICE - 3PM  
30-01 SCALE 1 : 800

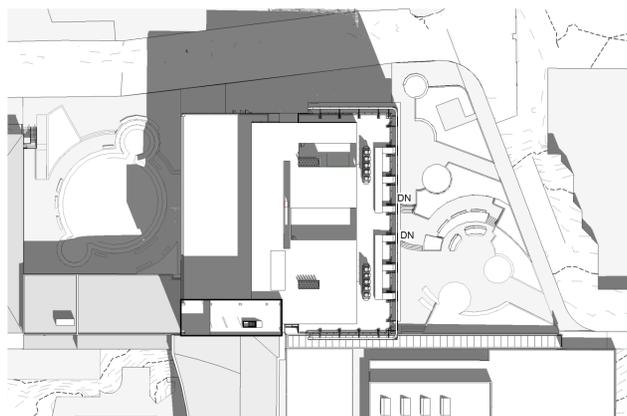

7 SUMMER SOLSTICE - 9AM  
30-01 SCALE 1 : 800

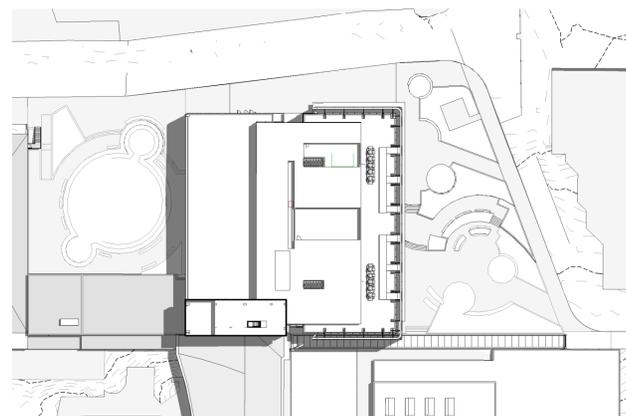

8 SUMMER SOLSTICE - 12PM  
30-01 SCALE 1 : 800



9 SUMMER SOLSTICE - 3PM  
30-01 SCALE 1 : 800

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Russell Lee no. 6367

Project

THE UNIVERSITY OF SYDNEY ETP STAGE 1

Electrical Engineering Building  
University in Darlington, NSW 2008

Drawing Title

SHADOW DIAGRAMS

AT DRAWING SHEET

Co-ordinated: Michael Grave

Project Architect: Michael Bradburn

Project Director: David Holm

Drawing Number:

A-DA-8003

Drawn: SPG

Scale: 1 : 800 @ A1

Date: 31/01/18


Revision: C

North:





**01**  
**LOCATION**  
 NORTH, EAST & WEST LAB FACADES  
**FINISH**  
 VISION GLASS

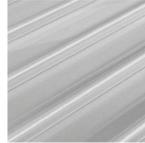

**09**  
**LOCATION**  
 ROOF PLANT FACADES  
**FINISH**  
 POLYCARBONATE PANEL



**17**  
**LOCATION**  
 WEST FACADE  
**FINISH**  
 PAINTED STEEL, ALUMINIUM



**02**  
**LOCATION**  
 NORTH, EAST & WEST LAB FACADES  
**FINISH**  
 ZINCALUME SPANDREL



**10**  
**LOCATION**  
 EAST, WEST & SOUTH FACADE  
**FINISH**  
 EXISTING CONCRETE FRAMES &  
 WALLS PAINT FINISH



**03**  
**LOCATION**  
 NORTH FACADE  
**FINISH**  
 STAINLESS STEEL EXTERNAL DUCT,  
 EXPOSED FANS



**11**  
**LOCATION**  
 EAST, WEST & SOUTH FACADE  
**FINISH**  
 EXISTING CONCRETE FRAMES &  
 WALLS PAINT FINISH



**04**  
**LOCATION**  
 NORTH FACADE  
**FINISH**  
 PAINTED STEEL 'EXO SKELETON'  
 FRAME TO DUCT



**12**  
**LOCATION**  
 EAST, WEST & SOUTH FACADE  
**FINISH**  
 WINDOW FRAMES, LOUVRES PAINT  
 FINISH



**05**  
**LOCATION**  
 NORTH, EAST & WEST LAB  
 FACADES  
**FINISH**  
 ALUMINIUM EXTERNAL LOUVRES



**13**  
**LOCATION**  
 ROOF PLANT FACADE  
**FINISH**  
 WEATHERPROOF LOUVRES,  
 2 STAGE



**06**  
**LOCATION**  
 NORTH, EAST & WEST FACADES  
**FINISH**  
 PAINTED STEEL, ALUMINIUM



**14**  
**LOCATION**  
 ROOF  
**FINISH**  
 METAL DECK ROOF



**07**  
**LOCATION**  
 EAST & WEST ATRIUM FACADES  
**FINISH**  
 FULL HEIGHT VISION GLASS



**15**  
**LOCATION**  
 EAST, WEST & SOUTH FACADE  
**FINISH**  
 EXISTING BRICK WALLS  
 PAINT FINISH



**08**  
**LOCATION**  
 SOUTH FACADES  
**FINISH**  
 VISION GLASS



**16**  
**LOCATION**  
 NORTH, EAST, WEST & SOUTH FACADE  
**FINISH**  
 PERFORATED FEATURE SCREEN

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 Russell Lee no. 6367

Project

THE UNIVERSITY OF SYDNEY ETP STAGE 1

Electrical Engineering Building  
 University in Darlington, NSW 2008

Drawing Title

MATERIALS LEGEND - EXTERIOR

AT DRAWING SHEET

Drawn: SPG

Co-ordinated: Michael Grave

Scale: 1 : 200 @ A1

Project Architect: Michael Bradburn

Date: 31/01/18

Project Director: David Holm


Revision: B

Drawing Number:

North:

A-DA-9001

Cox Architecture Pty Ltd ACN 002 535 891

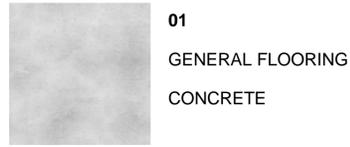

**01**  
GENERAL FLOORING  
CONCRETE



**02**  
TEA POINT  
WOVEN VINYL




**03**  
WORK SPACE  
CARPET TILE



**04**  
TEACHING LABS  
VINYL FLOORING



**05**  
HUB AND INFORMAL LEARNING  
SPACES  
LARGE FORMAT TIMBER FLOOR  
BOARDS

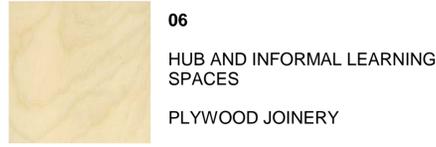

**06**  
HUB AND INFORMAL LEARNING  
SPACES  
PLYWOOD JOINERY



**07**  
CUSTOM JOINERY  
STAINLESS STEEL



**08**  
CUSTOM JOINERY  
TEMPERED STEEL



**09**  
LOOSE FURNITURE  
VINYL



**10**  
LOOSE FURNITURE  
VINYL



**11**  
LOOSE FURNITURE  
UPHOLSTERY




**12**  
LOOSE FURNITURE  
UPHOLSTERY



**13**  
LOOSE FURNITURE  
UPHOLSTERY



**14**  
LOOSE FURNITURE  
UPHOLSTERY

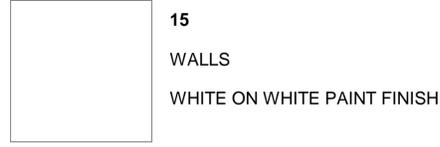

**15**  
WALLS  
WHITE ON WHITE PAINT FINISH

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Rev	Description	By	Date
A	SSDA	SPG	31.01.2018

Principal



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Nominated Architects  
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Project

THE UNIVERSITY OF SYDNEY ETP STAGE 1

Electrical Engineering Building  
University in Darlington, NSW 2008

Drawing Title

MATERIALS LEGEND - INTERIOR

AT DRAWING SHEET

Co-ordinated: Michael Grave Scale: 1 : 200 @ A1

Project Architect: Michael Bradburn Date: 31/01/18

Project Director: David Holm Revision: A

Drawing Number: North:

A-DA-9002

Cox Architecture Pty Ltd ACN 002 535 891