

2 SECTION SCALE 1:200 SECTION FACING SOUTH

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 Date

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 08.11.2017

 SPG
 15.11.2017

 SPG
 31.01.2018
 Rev Description
A PRELIMINARY ISSUE B FOR INFORMATION C SSDA

Principal

Contractor

Level 6, 155 Clarence Street, Sydney, NSW 2000, Australia T + 61 2 9267 9599 F + 61 2 9264 5844 www.coxarchitecture.com.au

Nominated Architects Joe Agius no. 6491 Russell Lee no. 6367

THE UNIVERSITY OF SYDNEY ETP STAGE 1 Electrical Engineering Building University in Darlington, NSW 2008

SECTIONS - EAST TO WEST

Drawing Number:

A1 DRAWING SHEET

A-DA-4001

Co-ordinated: Michael Grave

Project Director: David Holm

Project Architect: Michael Bradburn


Cox Architecture Pty Ltd ACN 002 535 891

Scale: 1: 200 @ A1

Date: 31/01/18

Revision:

LAING O'ROURKE

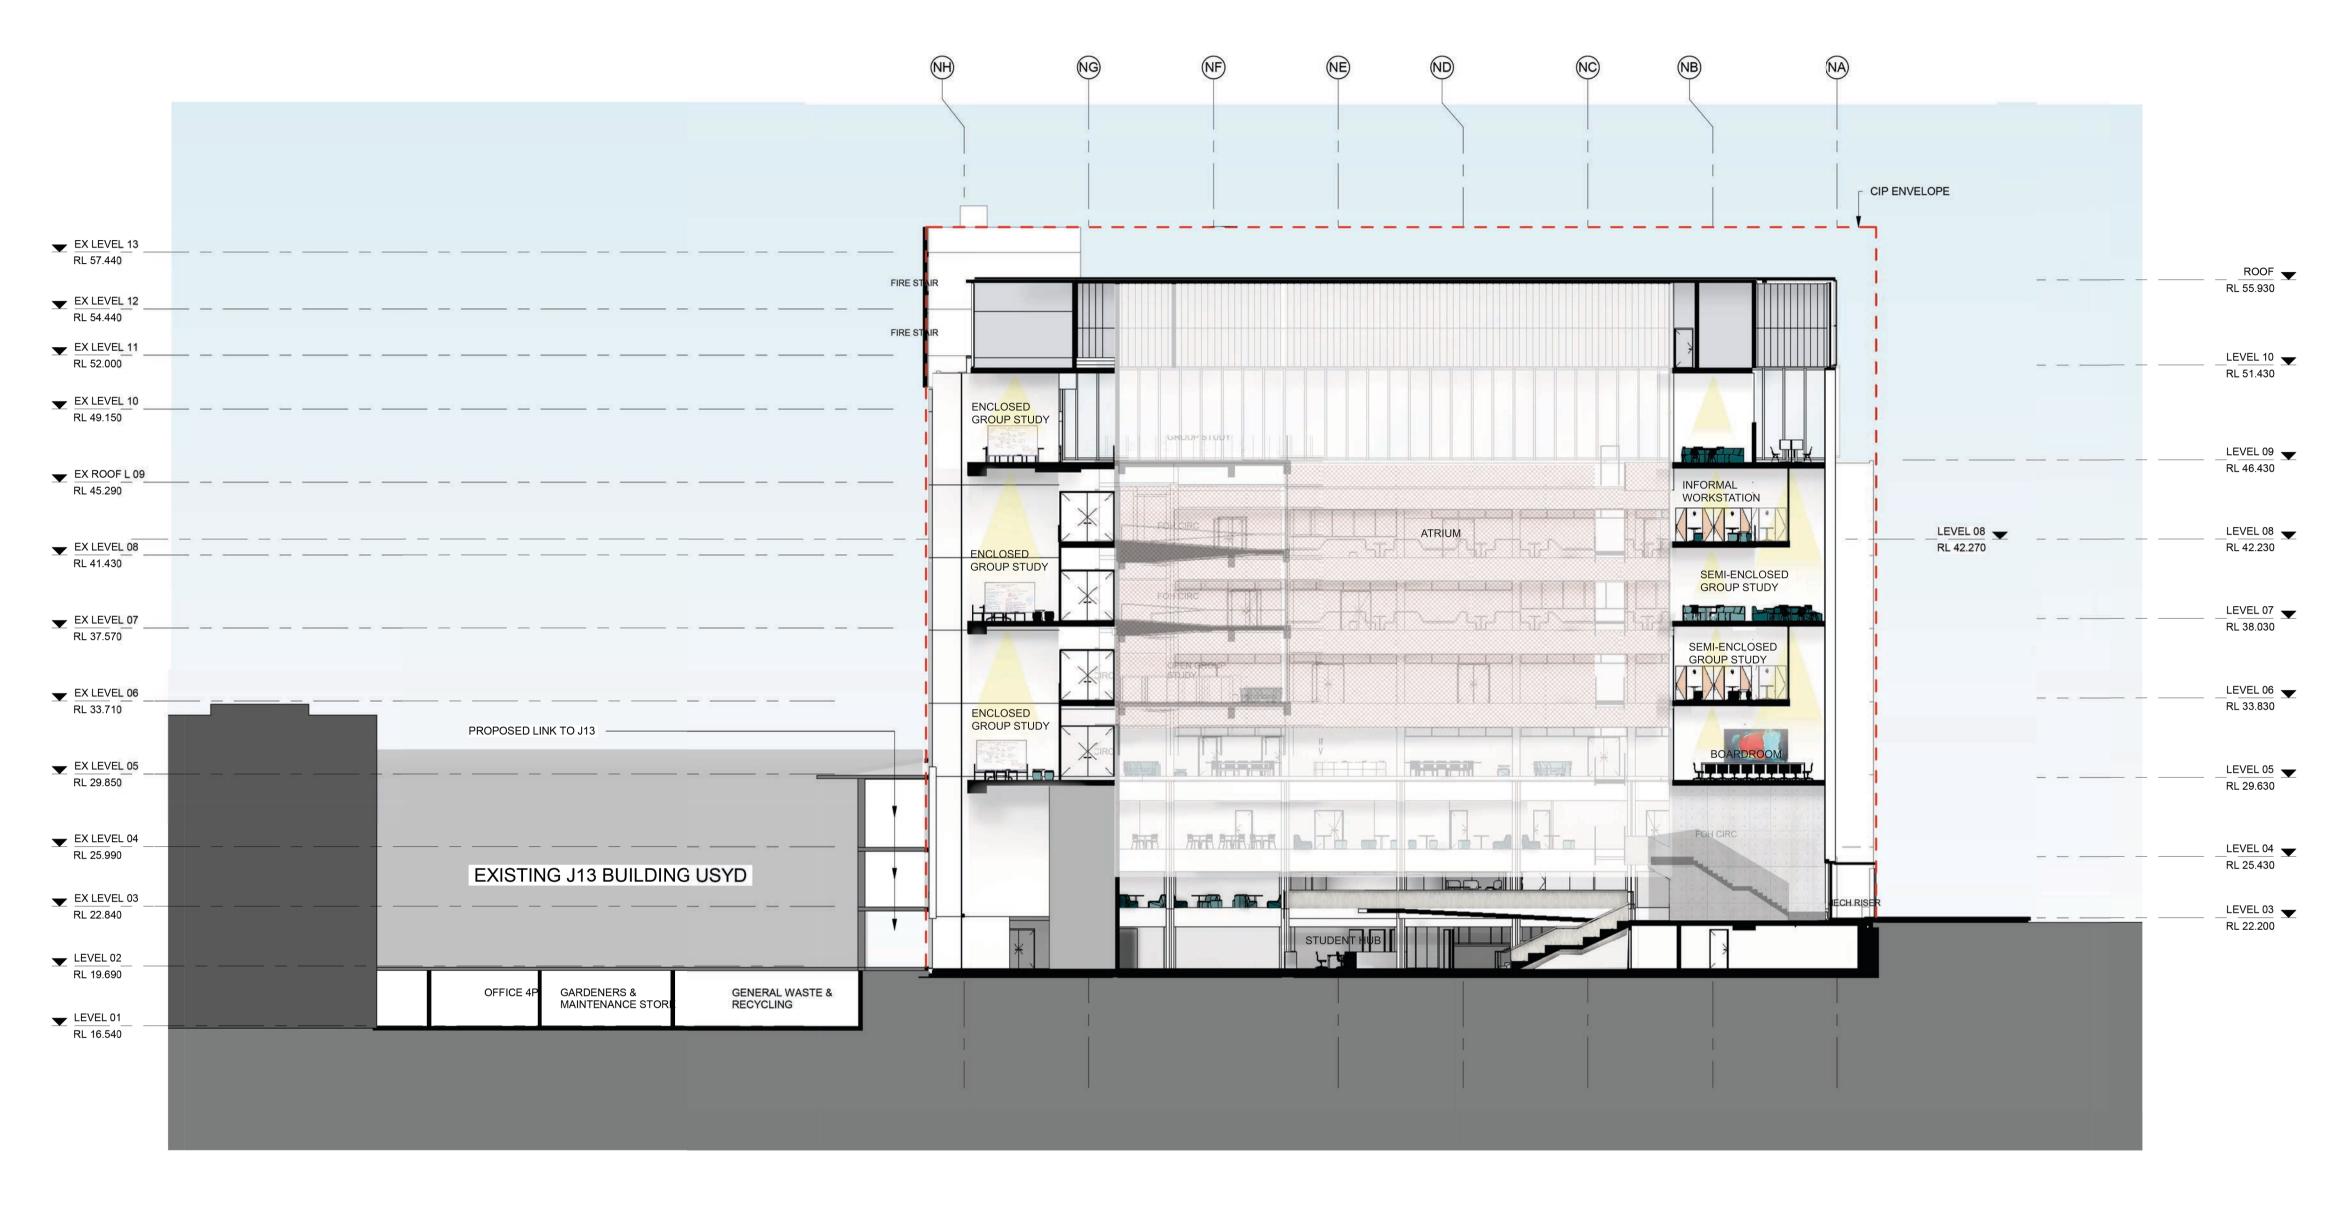

2 SECTION SCALE 1:200 SECTION FACING SOUTH

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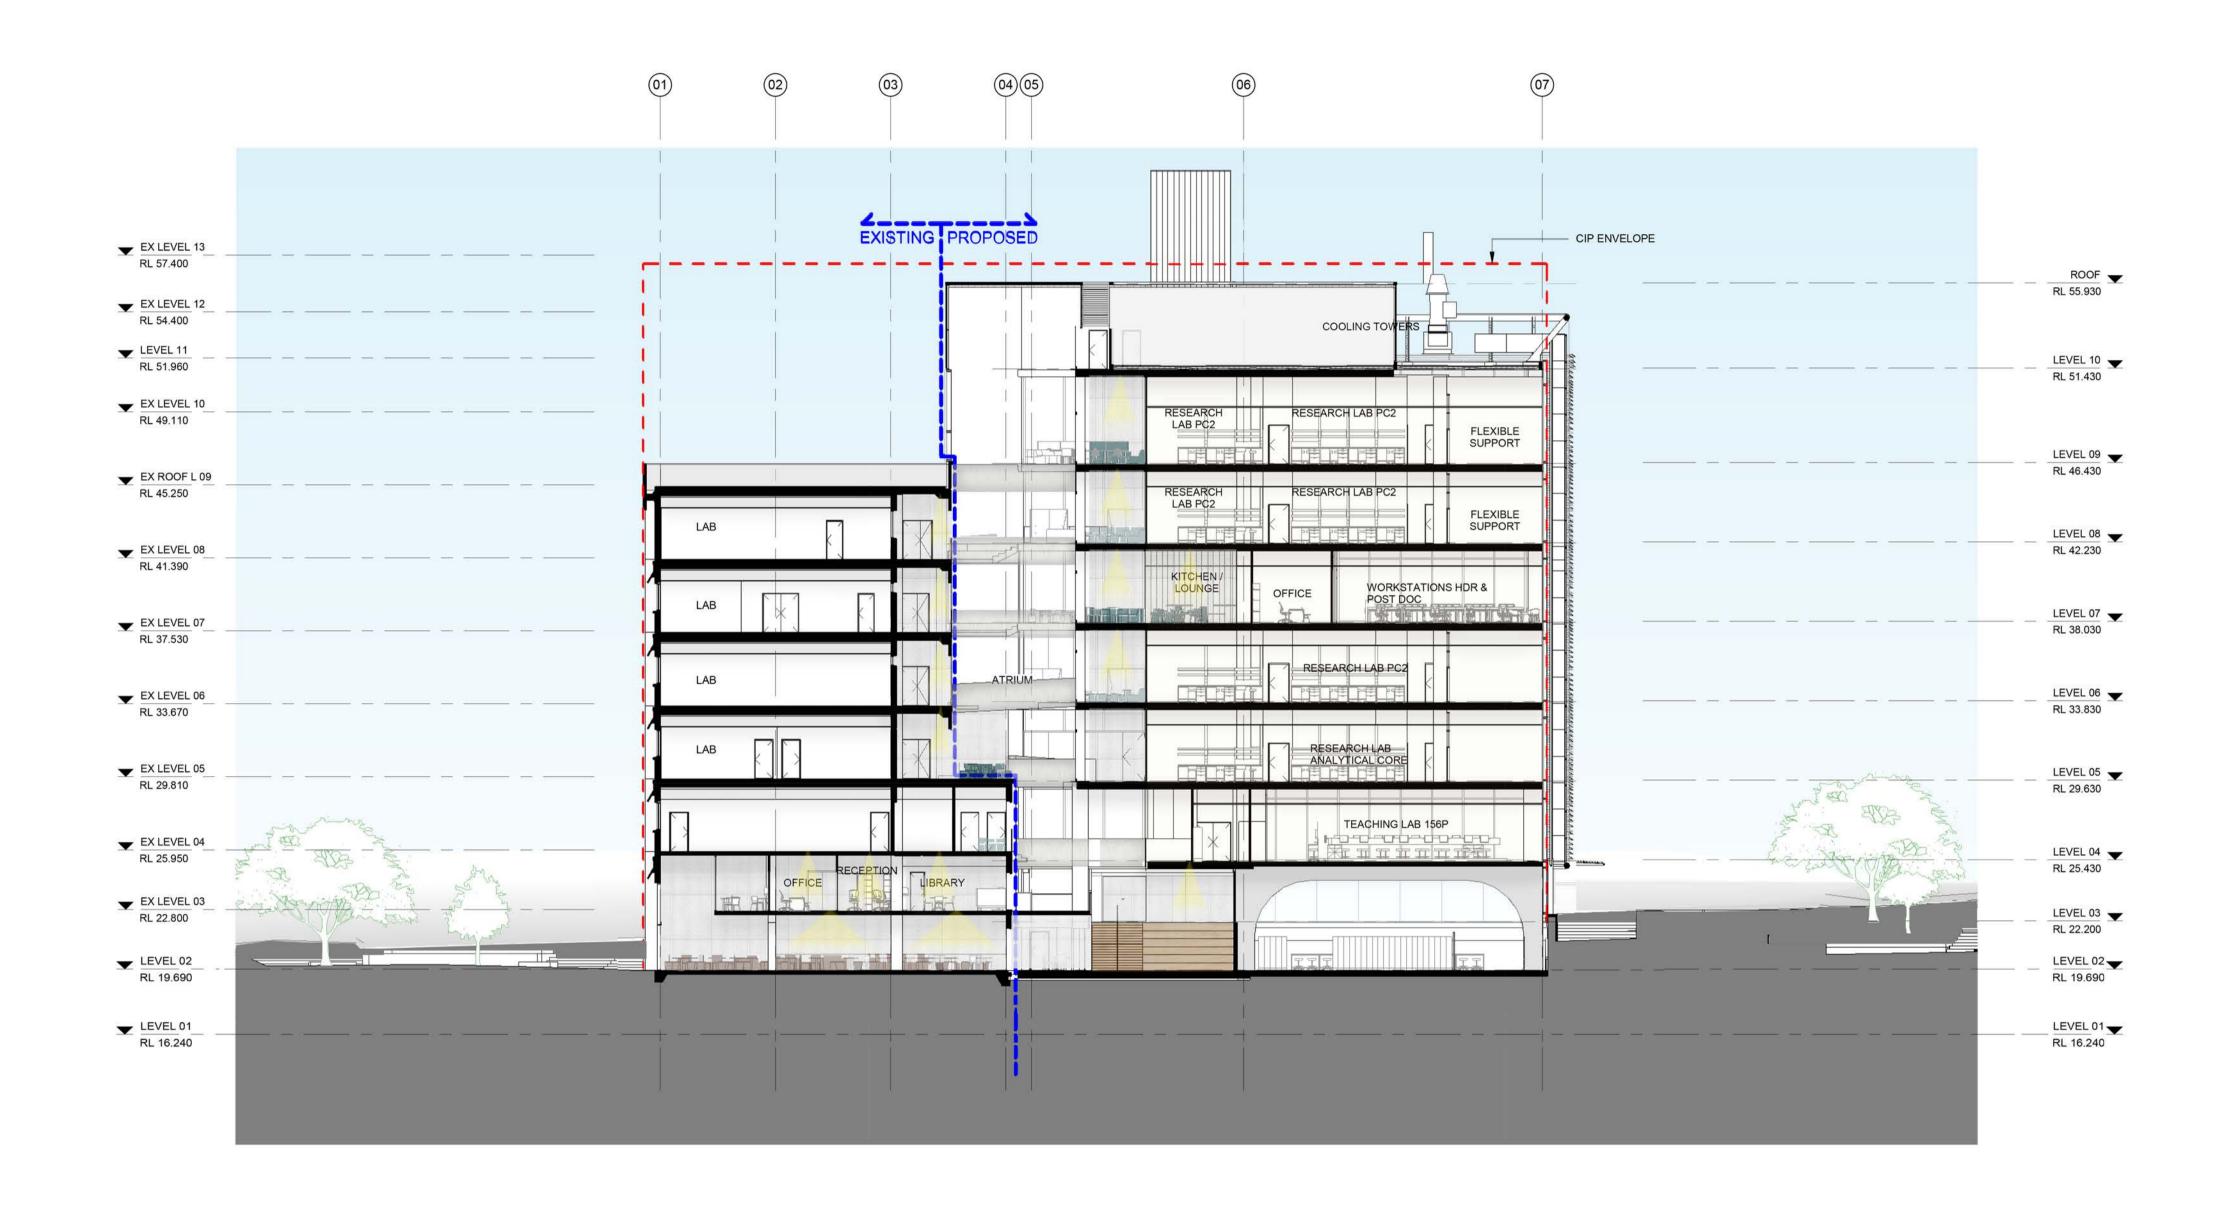
THE UNIVERSITY OF SYDNEY ETP STAGE 1 Electrical Engineering Building University in Darlington, NSW 2008

SECTIONS - EAST TO WEST

A1 DRAWING SHEET Co-ordinated: Michael Grave Scale: 1 : 200 @ A1 Project Architect: Michael Bradburn **Date:** 31/01/18 Project Director: David Holm Revision: **Drawing Number:**

A-DA-4001





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THE UNIVERSITY OF

Contractor

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Level 6, 155 Clarence Street, Sydney, NSW 2000, Australia T + 61 2 9267 9599 F + 61 2 9264 5844 www.coxarchitecture.com.au THE UNIVERSITY OF SYDNEY ETP STAGE 1

Electrical Engineering Building
University in Darlington, NSW 2008

Drawing Title

SECTIONS - NORTH TO SOUTH

A1 DRAWING SHEET

Co-ordinated: Michael Grave

Project Architect: Michael Bradburn

Project Director: David Holm

Drawn: SPG

Scale: 1 : 200 @ A1

Date: 31/01/18

Revision: C

North:

A-DA-4002

Cox Architecture Pty Ltd ACN 002 535 891

THE UNIVERSITY OF SYDNEY


Nominated Architects Joe Agius no. 6491 Russell Lee no. 6367

PLOT STAMP DATE: 31/01/2018 2:41:16 PM




GFA (TO BE RECONFIGURED)

GFA (EXISTING STRUCTURE): 4596.82m² GFA (TO BE RECONFIGURED): 2899.04m² 7495.86m²

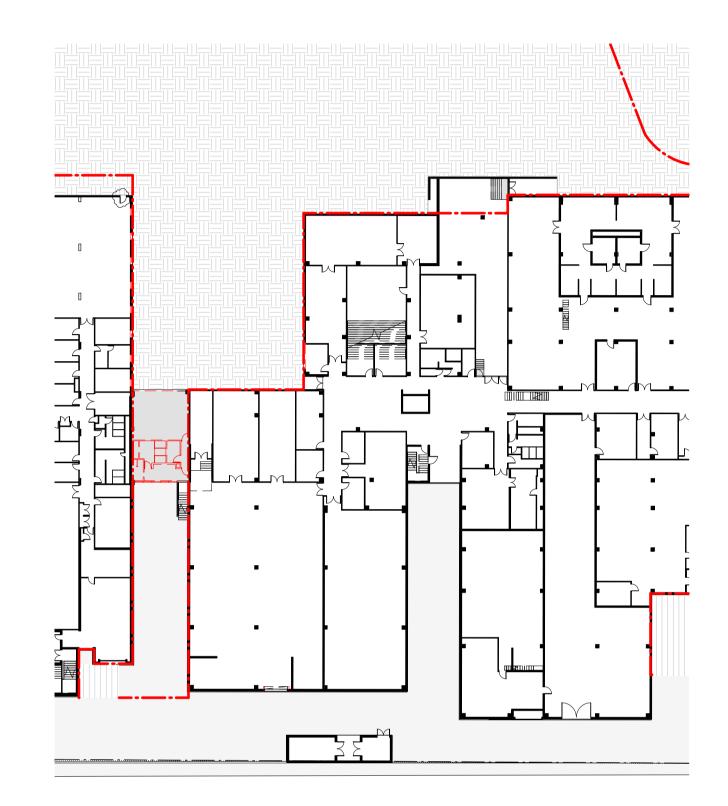

LEVEL 01 (SHEET 01 OF 02) - EXISTING AREA PLAN
SCALE 1:500 30-01

GFA (EXISTING STRUCTURE): N/A

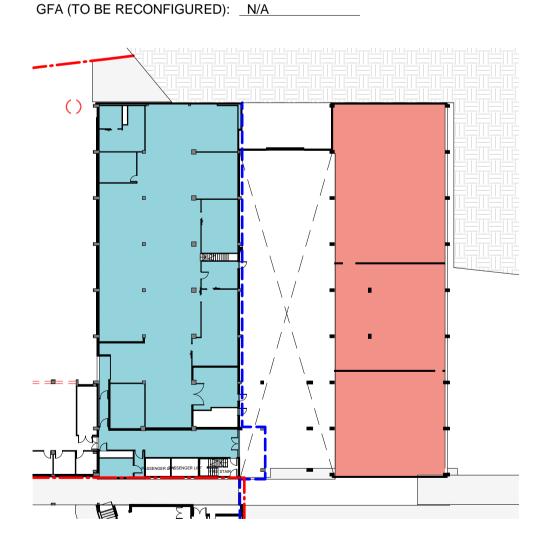


LEVEL 02 - EXISTING AREA PLAN 30-01 SCALE 1:500

GFA (EXISTING STRUCTURE): 861.27m²

GFA (TO BE RECONFIGURED): 716.74m²


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LEVEL 03 - EXISTING AREA PLAN
SCALE 1:500 GFA (EXISTING STRUCTURE): 320.28m²


GFA (TO BE RECONFIGURED): 858.84m²

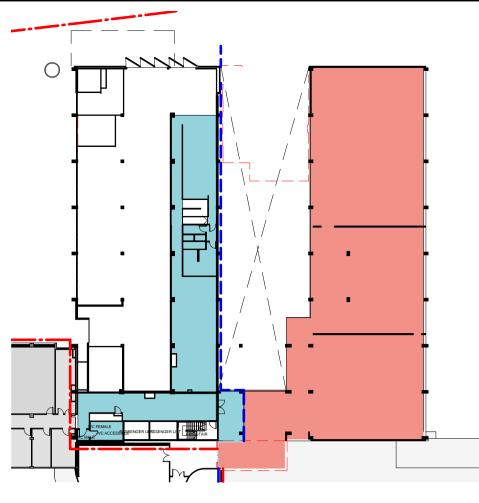

LEVEL 04 - EXISTING AREA PLAN
SCALE 1:500

GFA (EXISTING STRUCTURE): 845.08m²

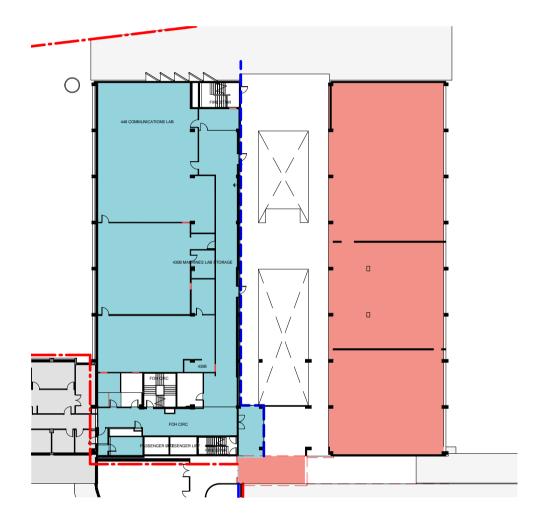GFA (TO BE RECONFIGURED): 780.64m²

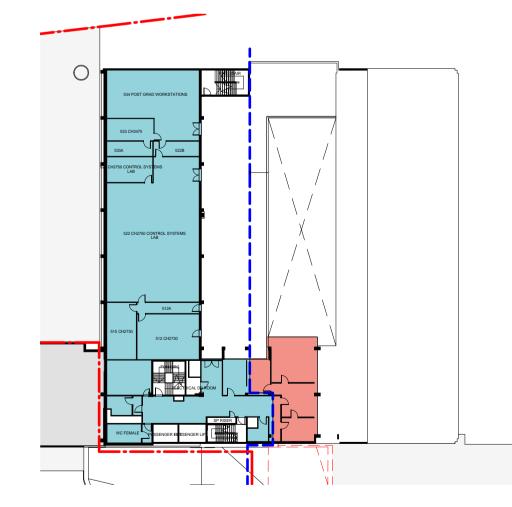

LEVEL 05 - EXISTING AREA PLAN 30-01 SCALE 1:500

GFA (EXISTING STRUCTURE): 635.81m² GFA (TO BE RECONFIGURED): 97.25m²



30-01

SCALE 1:500



LEVEL 08 - EXISTING AREA PLAN

GFA (EXISTING STRUCTURE): 616.25m²

GFA (TO BE RECONFIGURED): 113.90m²

LEVEL 06 - EXISTING AREA PLAN

LEVEL 07 - EXISTING AREA PLAN
SCALE 1:500

GFA (EXISTING STRUCTURE): _602.40m²


GFA (TO BE RECONFIGURED): <u>113.90m²</u>

GFA (EXISTING STRUCTURE): 616.98m²

GFA (TO BE RECONFIGURED): 113.90m²


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LEVEL 09 - EXISTING AREA PLAN GFA (EXISTING STRUCTURE): 98.75m²

GFA (TO BE RECONFIGURED): 103.87m²

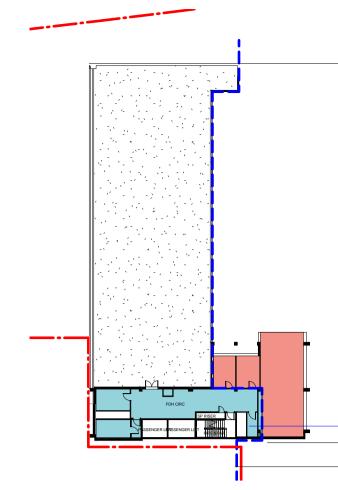

LEVEL 10 - EXISTING AREA PLAN

SCALE 1:500

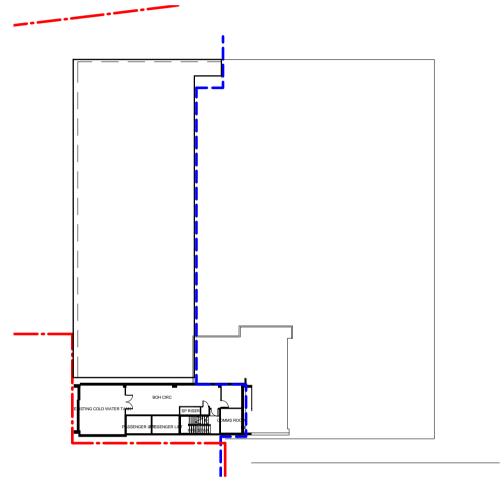30-01 GFA (EXISTING STRUCTURE): N/A

GFA (TO BE RECONFIGURED): N/A

LEVEL 11 - EXISTING AREA PLAN

∖ 30-01 *∫* GFA (EXISTING STRUCTURE): N/A

GFA (TO BE RECONFIGURED): N/A

THE UNIVERSITY OF SYDNEY ETP STAGE 1

SCALE 1:500

Electrical Engineering Building University in Darlington, NSW 2008

GFA CALCULATION EXISTING

Co-ordinated: Michael Grave Scale: As indicated Project Architect: Michael Bradburn **Date:** 31/01/18 Project Director: David Holm Revision: **Drawing Number:**

A-DA-7000

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■ GFA (NEW STRUCTURE)

GFA (EXISTING STRUCTURE): 4657.55m²


GFA (NEW STRUCTURE): 8818 m²

13475.55 m²

1 LEVEL 01 - AREA PLAN SCALE 1:500

GFA (EXISTING STRUCTURE): N/A

GFA (NEW STRUCTURE): 375 m²

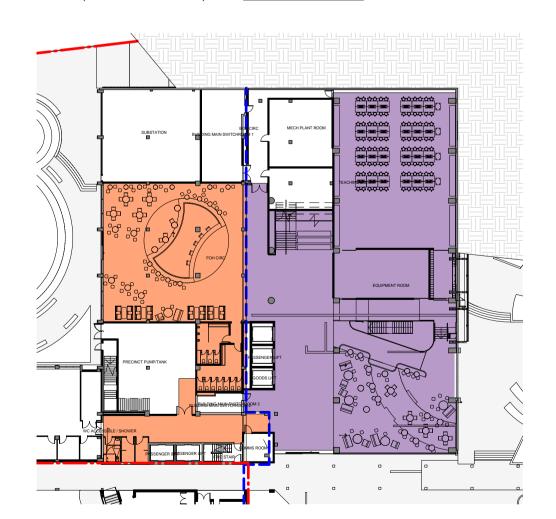



3 LEVEL 02 - AREA PLAN
SCALE 1:500

GFA (EXISTING STRUCTURE): 525.08m²

GFA (NEW STRUCTURE): 1123 m²

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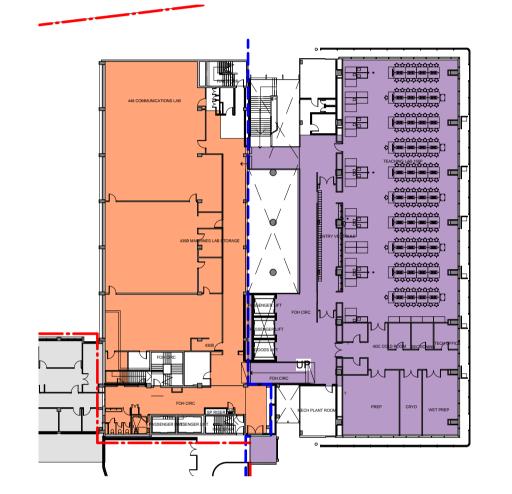


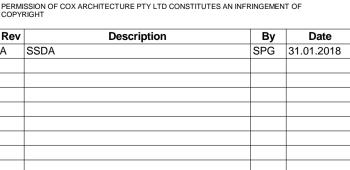

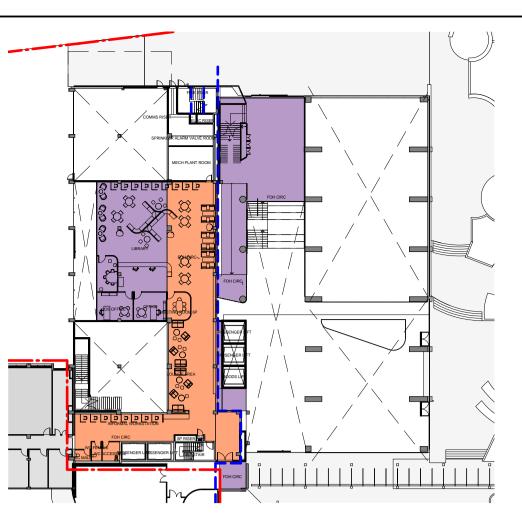4 LEVEL 03 - AREA PLAN

GFA (EXISTING STRUCTURE): _307.71m²


GFA (NEW STRUCTURE): 406 m²



5 30-01 SCALE 1:500

GFA (EXISTING STRUCTURE): 812.25m²

GFA (NEW STRUCTURE): 1039 m²

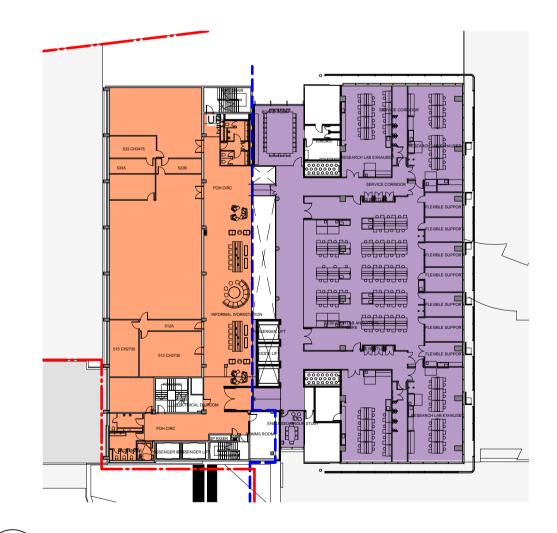


6 30-01 LEVEL 05 - AREA PLAN SCALE 1:500

GFA (EXISTING STRUCTURE): 839.43m²

GFA (NEW STRUCTURE): 1136 m²

Principal




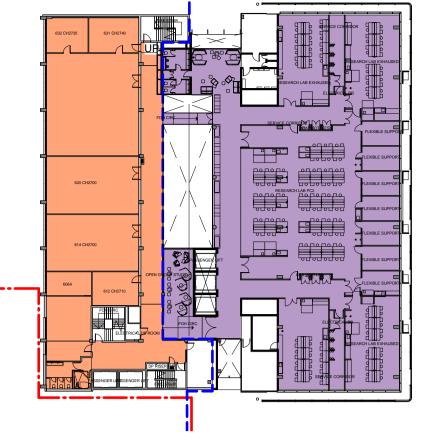

7 LEVEL 06 - AREA PLAN

GFA (EXISTING STRUCTURE): _703.46m²

GFA (NEW STRUCTURE): 1174 m²

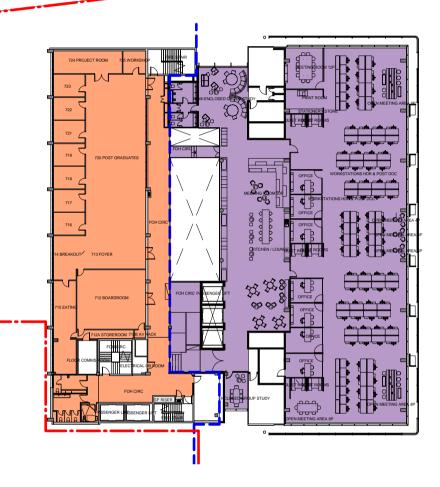


8 LEVEL 07 - AREA PLAN

SCALE 1:500

GFA (EXISTING STRUCTURE): 691.21m²

GFA (NEW STRUCTURE): 1203 m²

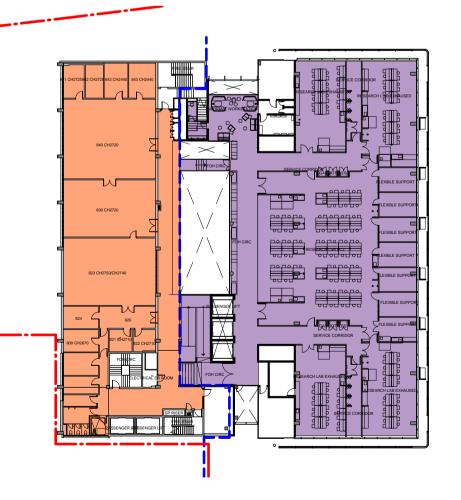

9 30-01 SCALE 1:500

GFA (EXISTING STRUCTURE): <u>687.45m²</u>

GFA (NEW STRUCTURE): __1163 m²

Contractor


Architect





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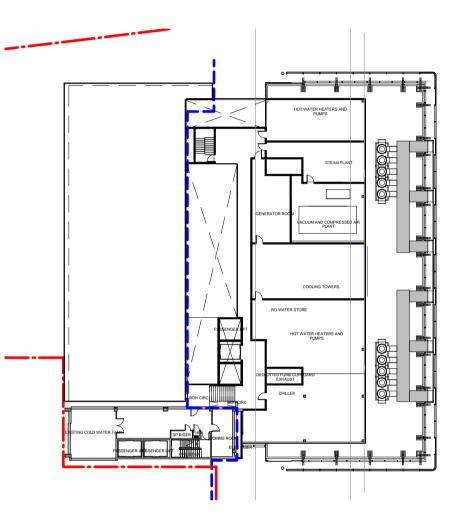
Nominated Architects Joe Agius no. 6491 Russell Lee no. 6367

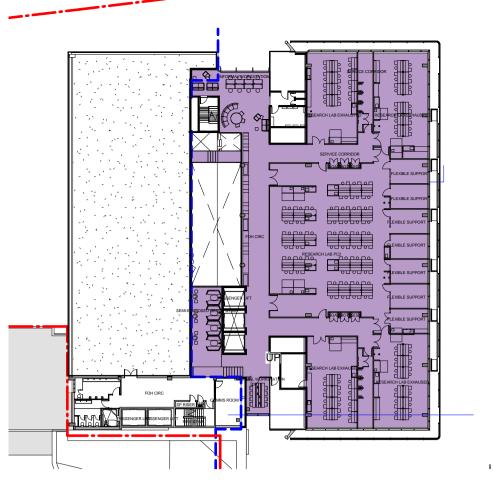

10 LEVEL 09 - AREA PLAN

GFA (EXISTING STRUCTURE): 90.96m²


GFA (NEW STRUCTURE): 1199 m²



11 LEVEL 10 - AREA PLAN
30-01 SCALE 1:500

GFA (EXISTING STRUCTURE): N/A

GFA (NEW STRUCTURE): N/A

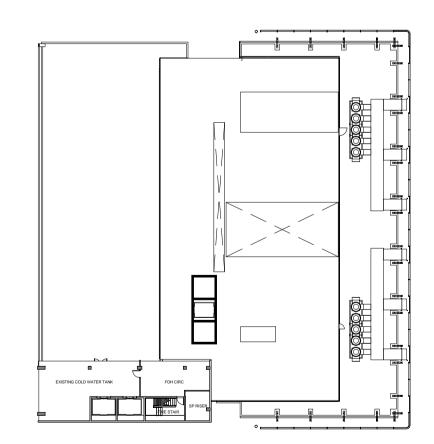

12 LEVEL 11 - AREA PLAN

SCALE 1:500

GFA (EXISTING STRUCTURE): N/A

GFA (NEW STRUCTURE): N/A

THE UNIVERSITY OF SYDNEY ETP STAGE 1

30-01

Electrical Engineering Building University in Darlington, NSW 2008

GFA CALCULATION PROPOSED

Co-ordinated: Michael Grave Scale: As indicated @ A1


Project Architect: Michael Bradburn Date: 31/01/18


Project Director: David Holm Revision: A

Drawing Number: North:


A-DA-7001



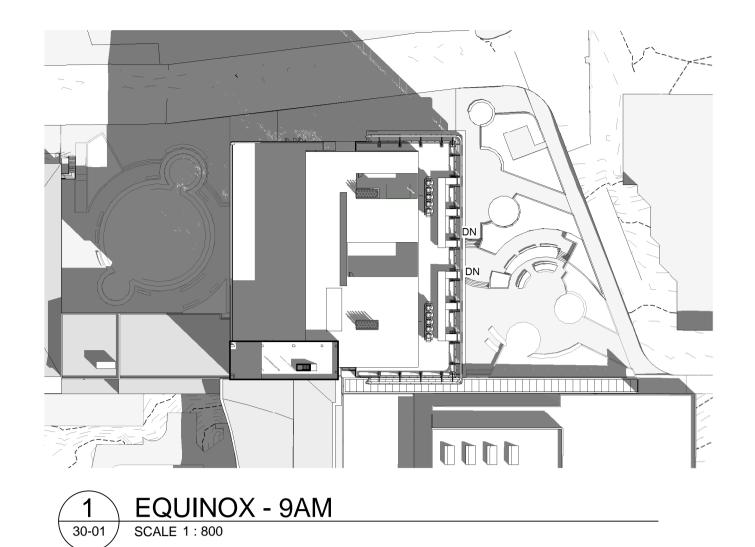

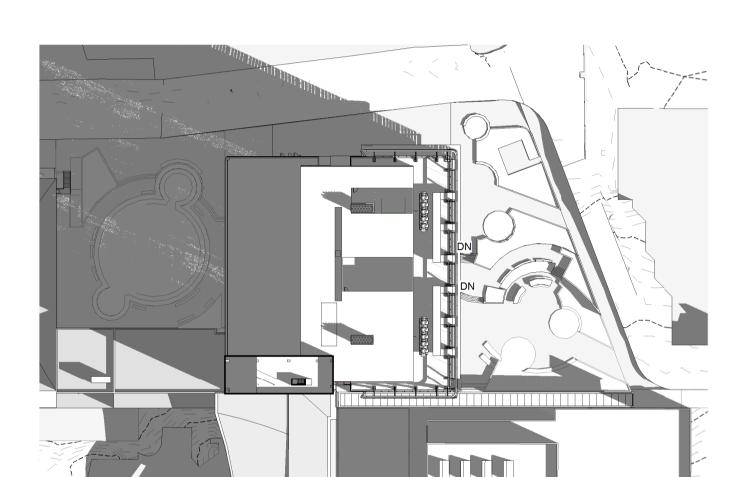

WINTER SOLSTICE - 9AM 30-01 SCALE 1:800

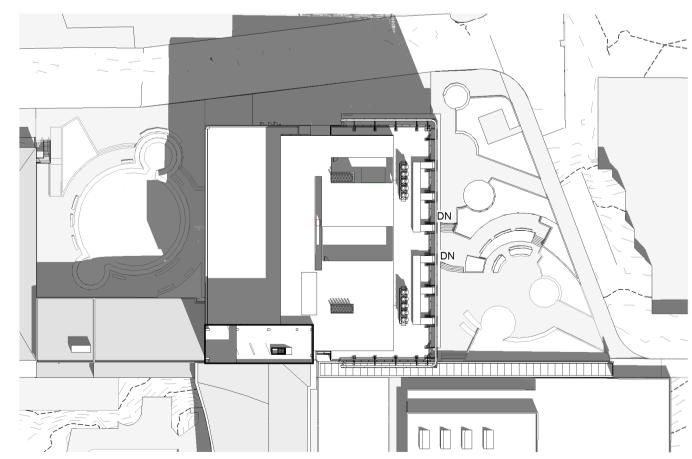

SUMMER SOLSTICE - 9AM 30-01 SCALE 1:800

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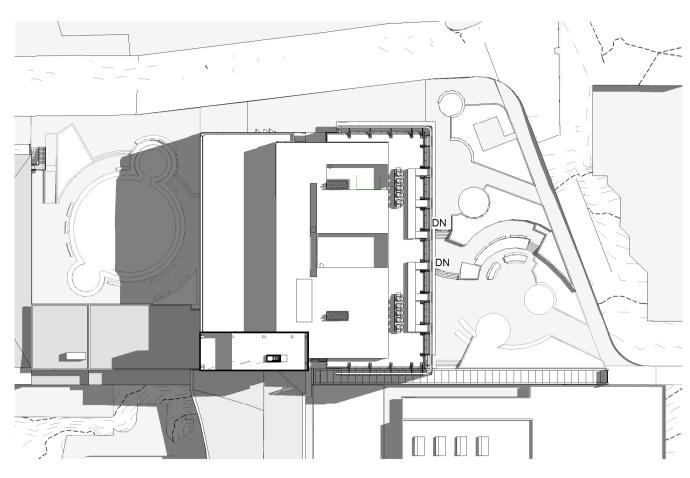
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 By
 Date


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 08.11.2017

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 15.11.2017


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2 EQUINOX - 12PM 30-01 SCALE 1:800



WINTER SOLSTICE - 12PM 30-01 SCALE 1:800

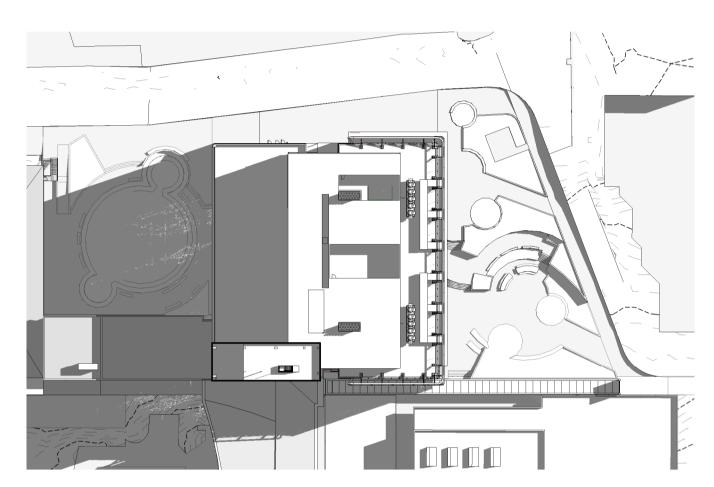

SUMMER SOLSTICE - 12PM 30-01 SCALE 1:800

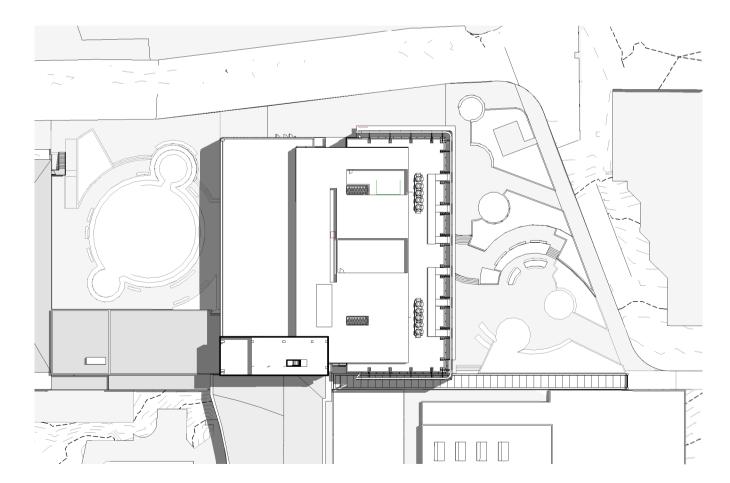THE UNIVERSITY OF SYDNEY

Contractor


LAING O'ROURKE

COX


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Nominated Architects Joe Agius no. 6491 Russell Lee no. 6367



3 EQUINOX - 3PM SCALE 1:800

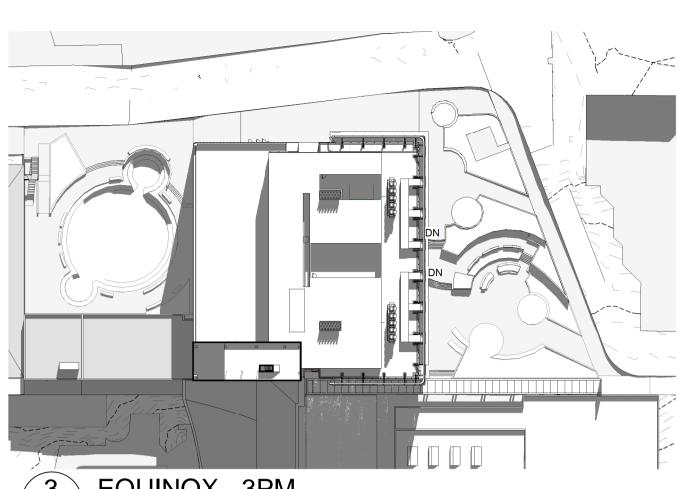

WINTER SOLSTICE - 3PM 30-01 SCALE 1:800

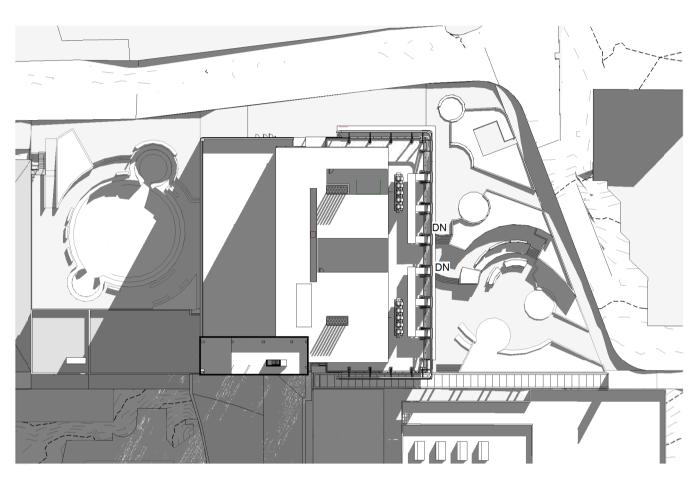

9 SUMMER SOLSTICE - 3PM 30-01 SCALE 1:800

THE UNIVERSITY OF SYDNEY ETP STAGE 1

Electrical Engineering Building University in Darlington, NSW 2008 Drawing Title

SHADOW DIAGRAMS

A1 DRAWING SHEET Co-ordinated: Michael Grave Scale: 1:800 @ A1 Project Architect: Michael Bradburn **Date:** 31/01/18 Project Director: David Holm Revision: Drawing Number:

A-DA-8003

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LOCATION NORTH, EAST & WEST LAB FACADES **VISION GLASS**



LOCATION

LOCATION **WEST FACADE** PAINTED STEEL, ALUMINIUM

<u>17</u>



<u>02</u> LOCATION NORTH, EAST & WEST LAB FACADES

ZINCALUME SPANDREL



<u>03</u>

LOCATION NORTH FACADE **FINISH** STAINLESS STEEL EXTERNAL DUCT, **EXPOSED FANS**



<u>04</u>

LOCATION NORTH FACADE **FINISH** PAINTED STEEL 'EXO SKELETON' FRAME TO DUCT



<u>05</u>

LOCATION NORTH, EAST & WEST LAB **FACADES FINISH** ALUMINIUM EXTERNAL LOUVRES



LOCATION NORTH, EAST & WEST FACADES PAINTED STEEL, ALUMINIUM




LOCATION EAST & WEST ATRIUM FACADES FULL HEIGHT VISION GLASS



<u>80</u>

LOCATION SOUTH FACADES **FINISH VISION GLASS**

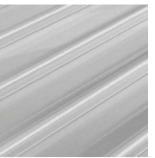

ROOF PLANT FACADES POLYCARBONATE PANEL

LOCATION EAST, WEST & SOUTH FACADE EXISTING CONCRETE FRAMES & WALLS PAINT FINISH



LOCATION EAST, WEST & SOUTH FACADE **FINISH** EXISTING CONCRETE FRAMES & WALLS PAINT FINISH



LOCATION EAST, WEST & SOUTH FACADE FINISH WINDOW FRAMES, LOUVRES PAINT **FINISH**



LOCATION ROOF PLANT FACADE **FINISH** WEATHERPROOF LOUVRES, 2 STAGE



LOCATION ROOF **FINISH** METAL DECK ROOF



LOCATION EAST, WEST & SOUTH FACADE **FINISH** EXISTING BRICK WALLS PAINT FINISH



LOCATION NORTH, EAST, WEST & SOUTH FACADE **FINISH** PERFORATED FEATURE SCREEN

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В	SSDA	SPG	31.01.2018

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Nominated Architects Joe Agius no. 6491 Russell Lee no. 6367

THE UNIVERSITY OF SYDNEY ETP STAGE 1

Electrical Engineering Building University in Darlington, NSW 2008

MATERIALS LEGEND - EXTERIOR

A1 DRAWING SHEET Co-ordinated: Michael Grave Scale: 1 : 200 @ A1 Project Architect: Michael Bradburn **Date:** 31/01/18 Project Director: David Holm Revision: **Drawing Number:**

A-DA-9001



GENERAL FLOORING CONCRETE



LOOSE FURNITURE VINYL



TEA POINT **WOVEN VINYL**



10 LOOSE FURNITURE



WORK SPACE CARPET TILE



11 LOOSE FURNITURE

UPHOLSTERY



TEACHING LABS VINYL FLOORING



12 LOOSE FURNITURE UPHOLSTERY



HUB AND INFORMAL LEARNING SPACES



LOOSE FURNITURE





UPHOLSTERY

13

14



06 HUB AND INFORMAL LEARNING SPACES




LOOSE FURNITURE UPHOLSTERY





15

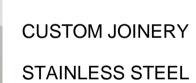

WALLS



WHITE ON WHITE PAINT FINISH



CUSTOM JOINERY

TEMPERED STEEL

inches 1 2 3 4 4 mm 10 20 30 40 50 60 70 60 90 190

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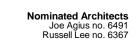
Rev	Description		Ву	Date
Α	SSDA	S	PG	31.01.2018

Contractor









THE UNIVERSITY OF SYDNEY ETP STAGE 1

Electrical Engineering Building University in Darlington, NSW 2008

MATERIALS LEGEND - INTERIOR

Drawing Number:		North:	
Project Director:	David Holm	Revision:	А
Project Architect:	Michael Bradburn	Date:	31/01/18
Co-ordinated:	Michael Grave	Scale: 1 : 2	00 @ A1
A1 DRAWING SHEET		Drawn:	SPG

A-DA-9002