

LEGEND:

- NEW GRATED TRENCH DRAIN
- NEW STORMWATER PIPE
- NEW STORMWATER PIT
- PIPE FLOW DIRECTION
- NEW DRAINAGE SWALE
- NEW SUBSOIL DRAINAGE
- NEW RAINWATER TANK
- NEW DOWNPIPE CONNECTION LINE Ø150 UPVC
- OVERLAND FLOW DIRECTION



NOTES:

- ALL STORMWATER PIPES TO HAVE A MINIMUM OF 1% SLOPE IN DIRECTION SHOWN. ALL PIPES TO BE MINIMUM 450mm COVER IN LANDSCAPED/FOOTPATH AREA AND 600mm COVER IN TRAFFICABLE AREA.
- ALL STORMWATER PIPES TO BE REINFORCED CONCRETE (RCP) CLASS 2 WITH RUBBER RING JOINT UNO.
- STORMWATER PIPES ARE TO BE INSTALLED IN ACCORDANCE WITH AS 3725. ALL BEDDING IS TO BE TYPE H2 UNLESS NOTED OTHERWISE.
- CARE IS TO BE TAKEN WITH LEVELS OF STORMWATER LINES. GRADE SHOWN ARE NOT TO BE REDUCED WITHOUT APPROVAL.
- STORMWATER MANHOLES/GRATED PITS AND COVERS/GRATES ARE TO BE CONSTRUCTED IN ACCORDANCE WITH THE DRAWINGS AND SPECIFICATIONS.
- GRATES AND COVERS SHALL CONFORM WITH AS 3996-1992.
- ALL WORKS SHALL BE CARRIED OUT IN ACCORDANCE WITH CURRENT STANDARDS AND CONSTRUCTION SPECIFICATIONS.
- THE CONTRACTOR SHALL VERIFY LOCATIONS OF EXISTING SERVICES WITH ALL RELEVANT AUTHORITIES BEFORE COMMENCING CONSTRUCTION.
- ALL STRUCTURES TO BE CONSTRUCTED TO NEW FINISHED SURFACE LEVELS.
- DATUM FOR LEVELS IS AHD.
- THE POSITION, SIZE, SURFACE LEVELS AND INVERT LEVELS OF EXISTING STORMWATER MANHOLES AND PITS ARE TAKEN FROM SURVEY DRAWING. THESE NEED TO BE VERIFIED BY THE CONTRACTOR PRIOR TO CONSTRUCTION.
- ALL STORMWATER PITS SHALL BE CONSTRUCTED USING CAST-IN-SITU CONCRETE OR HEAVY DUTY PRECAST PITS.
- CONNECTION TO EXISTING STORMWATER PITS TO BE CARRIED OUT BY THE CONTRACTOR IN ACCORDANCE WITH THE SPECIFICATION AND IN CONSULTANT OF THE ASSET OWNER (i.e. COUNCIL). MAKE REQUIRED OPENING INSIDE THE EXISTING STORMWATER PIT WALL AT THE CONNECTION POINT OF NEW LINE. REPAIR AND MAKE GOOD THE PIT WALL INCLUDING NECESSARY ADJUSTMENT OF THE PIT BENCHING TO MATCH NEW PIPE CONNECTIONS.
- GRATES, FRAMES AND COVERS IN ROADWAYS TO BE DURHAM OR RMS APPROVED HEAVY DUTY CLASS D.
- GRATES AND FRAMES NOT IN ROADWAYS TO BE DURHAM OR EQUIVALENT MEDIUM DUTY CLASS B.
- ALL GRATES TO BE HINGED AND LOCKABLE. PROVIDE HEEL SAFE GRATE AS PER AS 1428.1-7.5 IN ROADWAYS AND PARKING AREA (PEDESTRIAN TRAVERSING AREAS).

NORTH KELLYVILLE - STORMWATER DRAINAGE PLAN
SCALE 1:500


DEVELOPMENT APPLICATION

E	ISSUED FOR DEVELOPMENT APPLICATION		MR	CS*	SM*	29.08.17
D	ISSUED FOR SSD SUBMISSION		MR	CS*	SM*	09.08.17
C	TENDER ADDENDUM		MR	MD*	MW*	21.07.16
B	ISSUED FOR TENDER		MR	CS*	SM*	28.06.17
A	ISSUED FOR SSD DEVELOPMENT APPLICATION		MR	CS*	SM*	14.06.17
No	Revision	Note: * indicates signatures on original issue of drawing or last revision of drawing	Drawn	Job Manager	Project Director	Date

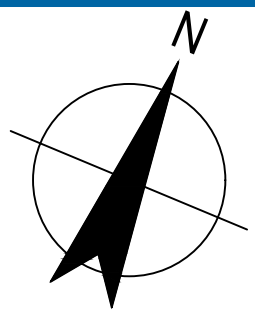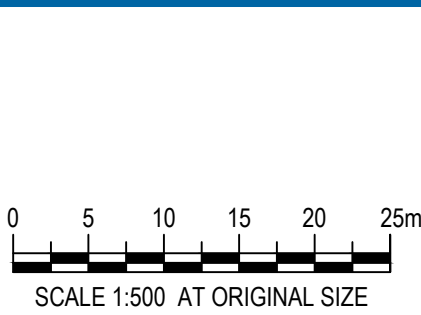

DO NOT SCALE	Drawn M.RANGWALA	Designer G.DE SWARDT
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	Approved (Project Director) Date	
	Scale 1:500	This Drawing must not be used for Construction unless signed as Approved

Client Project Title	NSW DEPARTMENT OF EDUCATION NORTH KELLYVILLE PUBLIC SCHOOL CIVIL OVERALL STORMWATER DRAINAGE PLAN
Original Size	A1
Drawing No:	2126108-NK-SD-CI-1010
Rev:	E

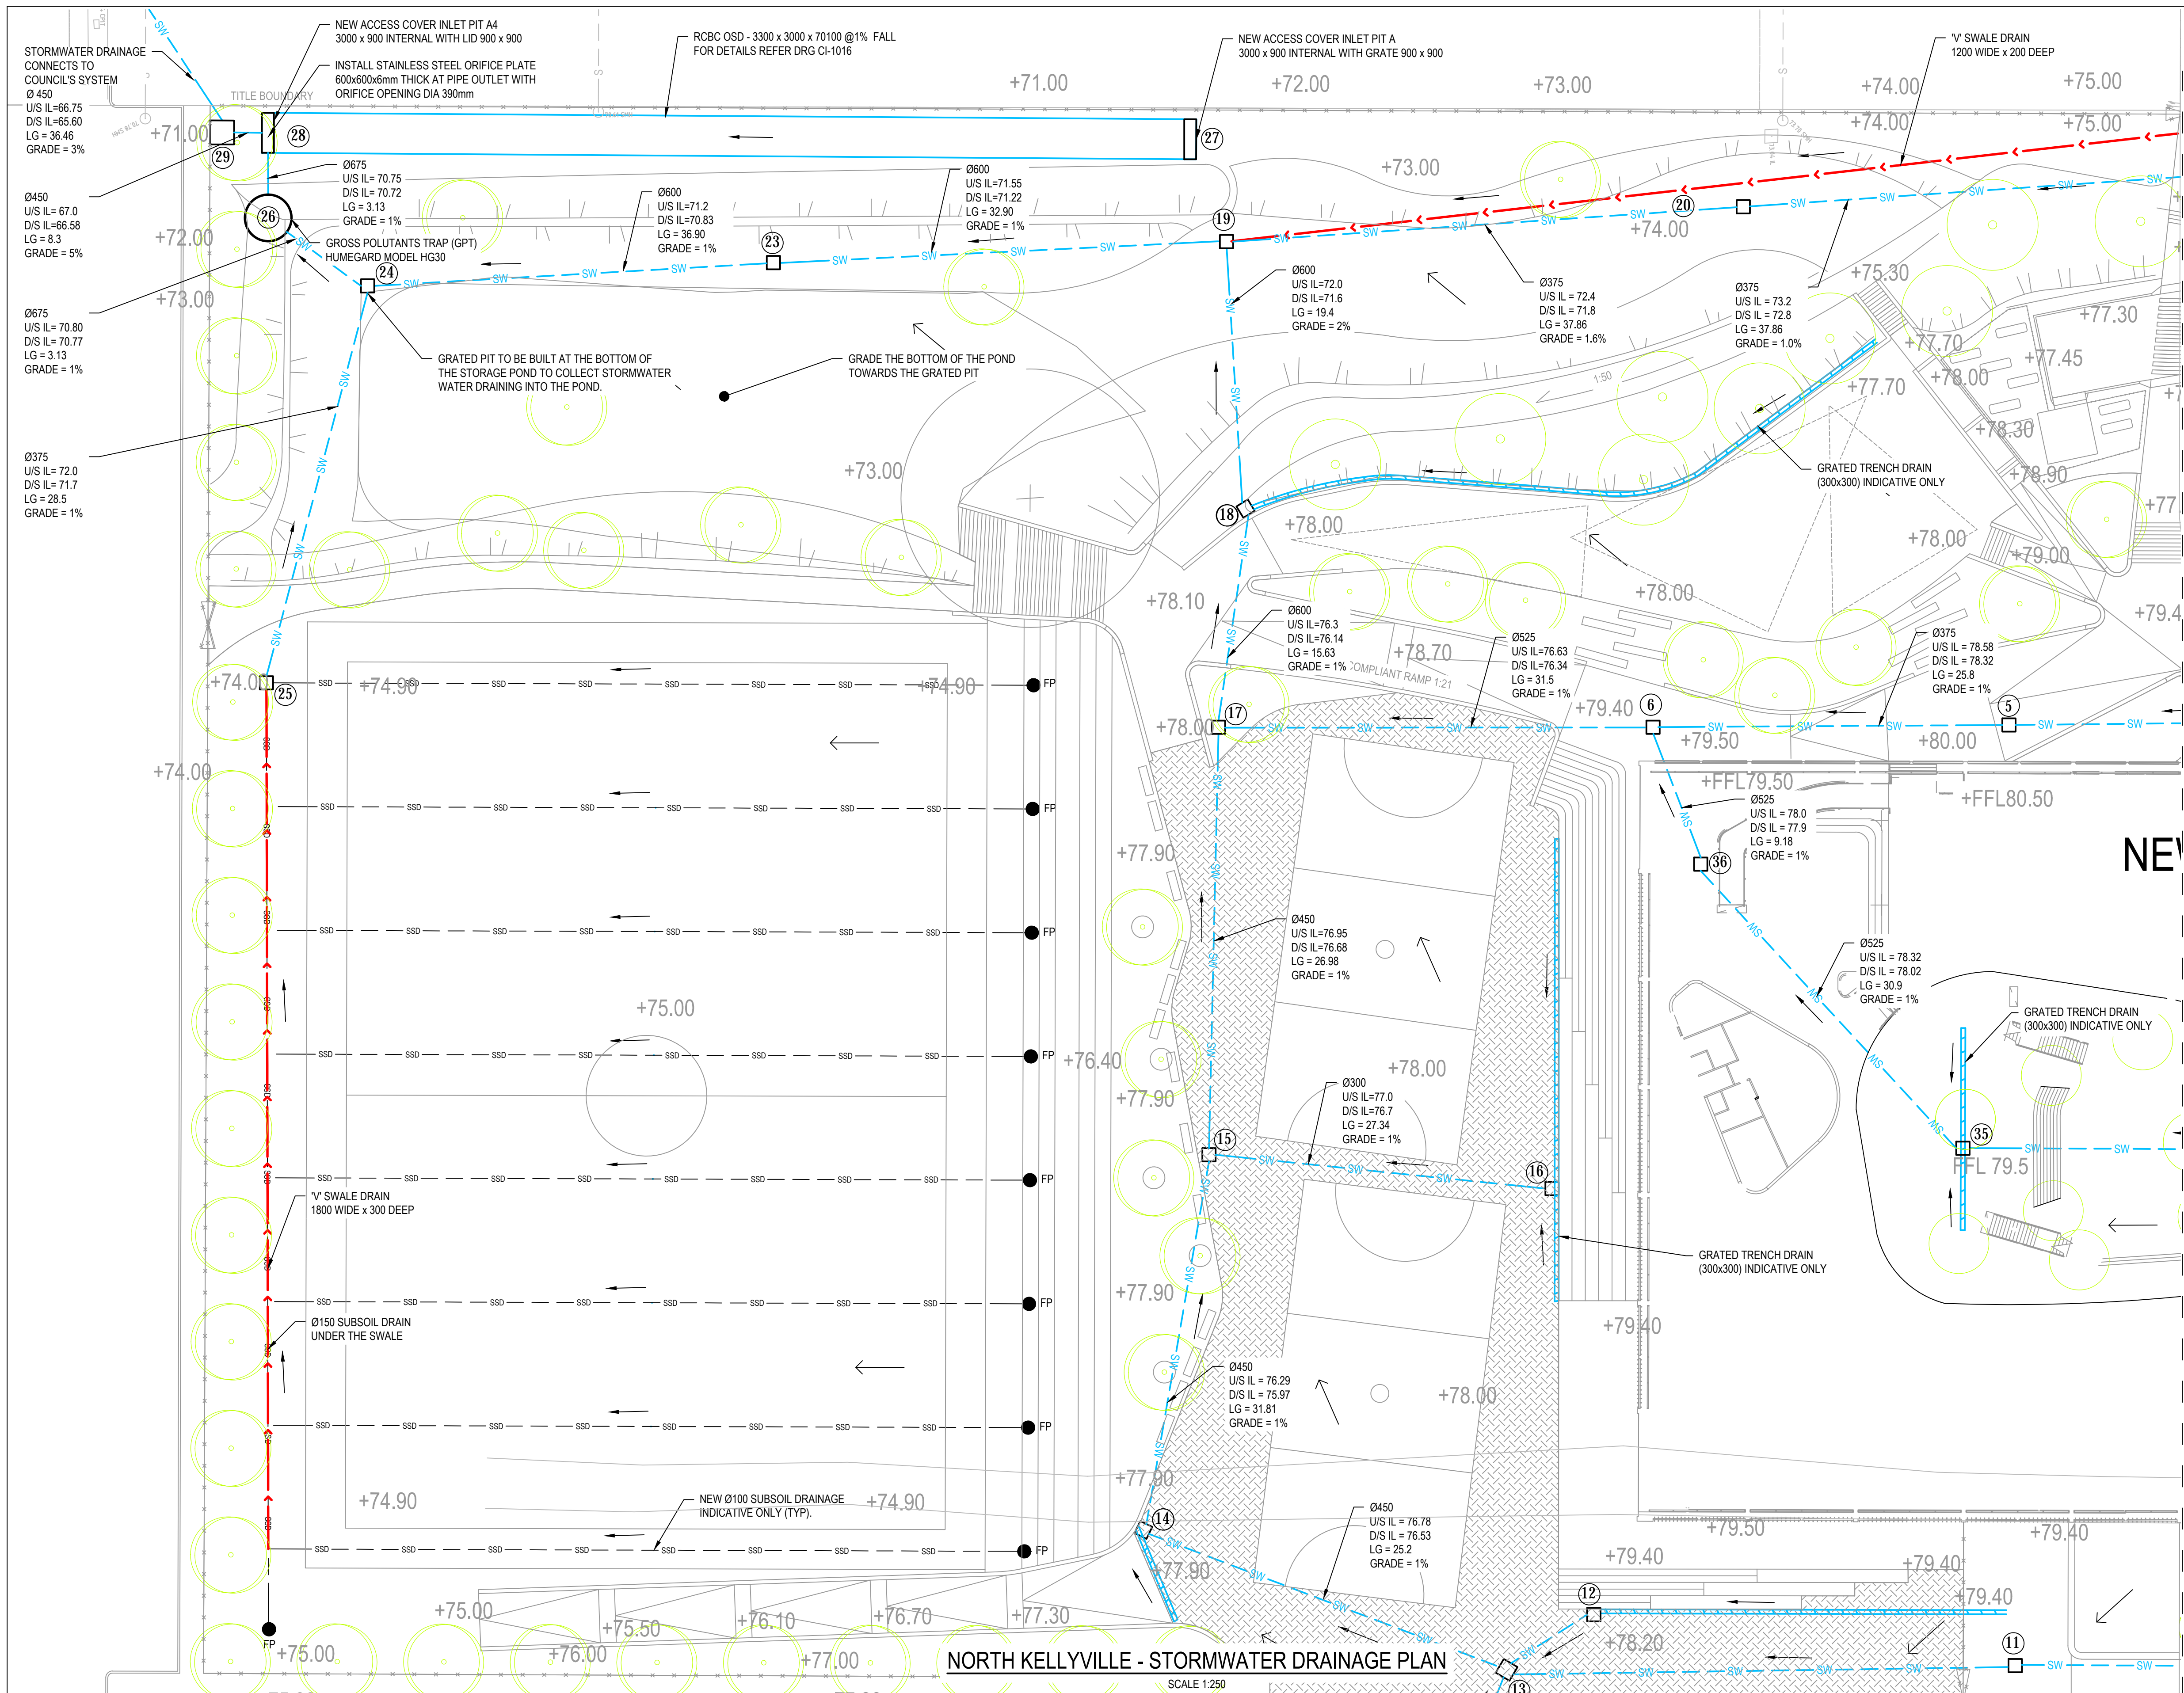


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NOTES:






- REFER TO DRG 21-26108-KN-SD-CI-1010 FOR DRAINAGE NOTES.

PIT SCHEDULE	
PIT NUMBER	PIT DETAILS
P1	900 x 900 GRATED INLET PIT
P2	900 x 900 GRATED INLET PIT
P3	900 x 900 GRATED INLET PIT
P4	900 x 900 GRATED INLET PIT
P5	900 x 900 GRATED INLET PIT
P6	1200 x 1200 DEEP DROP PIT
P7	900 x 900 GRATED INLET PIT
P8	900 x 900 GRATED INLET PIT
P9	900 x 900 GRATED INLET PIT
P10	900 x 900 GRATED INLET PIT
P11	900 x 900 GRATED INLET PIT
P12	900 x 900 GRATED INLET PIT
P13	900 x 900 GRATED INLET PIT
P14	900 x 900 GRATED INLET PIT
P15	600 x 600 GRATED INLET PIT
P16	900 x 900 GRATED INLET PIT
P17	600 x 600 GRATED INLET PIT
P18	1200 x 1200 DEEP DROP PIT
P19	900 x 900 GRATED INLET PIT
P20	900 x 900 GRATED INLET PIT
P21	900 x 900 GRATED INLET PIT
P22	900 x 900 GRATED INLET PIT
P23	900 x 900 GRATED INLET PIT
P24	900 x 900 GRATED INLET PIT
P25	900 x 900 GRATED INLET PIT
P26	GPT-HUMEGARD
P27	3000 x 900 IN-SITU ACCESS PIT
P28	3000 x 900 IN-SITU ACCESS PIT
P29	900 x 900 JUNCTION PIT ACCESS COVER
P30	900 x 900 GRATED INLET PIT
P31	900 x 900 GRATED INLET PIT
P32	900 x 900 GRATED INLET PIT
P33	900 x 900 GRATED INLET PIT
P34	900 x 900 GRATED INLET PIT
P35	900 x 900 GRATED INLET PIT
P36	900 x 900 GRATED INLET PIT

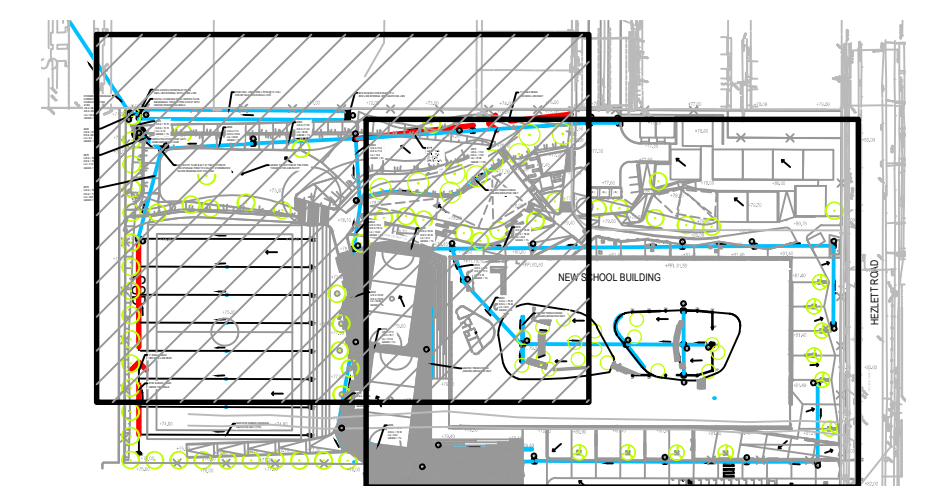


KEY PLAN
SCALE 1:2500

DEVELOPMENT APPLICATION

						 SCALE 1:2500 AT ORIGINAL SIZE				Education			Level 15, 133 Castlereagh Street, Sydney NSW 2000 Australia T 61 2 9239 7149 E sydmail@ghd.com W www.ghd.com	DO NOT SCALE		Drawn M.RANGWALA	Designer G.DE SWARDT	Client	NSW DEPARTMENT OF EDUCATION NORTH KELLYVILLE PUBLIC SCHOOL	
D	ISSUED FOR DEVELOPMENT APPLICATION				MR	CS*	SM*							29.08.17	Drafting Check A.MACLEAN*	Design Check A.RAHMAN*	Project			
C	ISSUED FOR SSD SUBMISSION				MR	CS*	SM*							09.08.17	Approved (Project Director)	Date	Title	CIVIL STORMWATER DRAINAGE PLAN-SHEET 1 OF 2		
B	TENDER ADDENDUM				MR	MD*	MW*							21.07.16	Scale 1:500	This Drawing must not be used for Construction unless signed as Approved	Original Size			Drawing No: 2126108-NK-SD-CI-1011 Rev: D
A	ISSUED FOR TENDER				MR	CS*	SM*	28.06.17												
No	Revision	Note: * indicates signatures on original issue of drawing or last revision of drawing	Drawn	Job Manager	Project Director	Date														

FOR CONTINUATION REF DRG 21-26108-NK-CI-2011

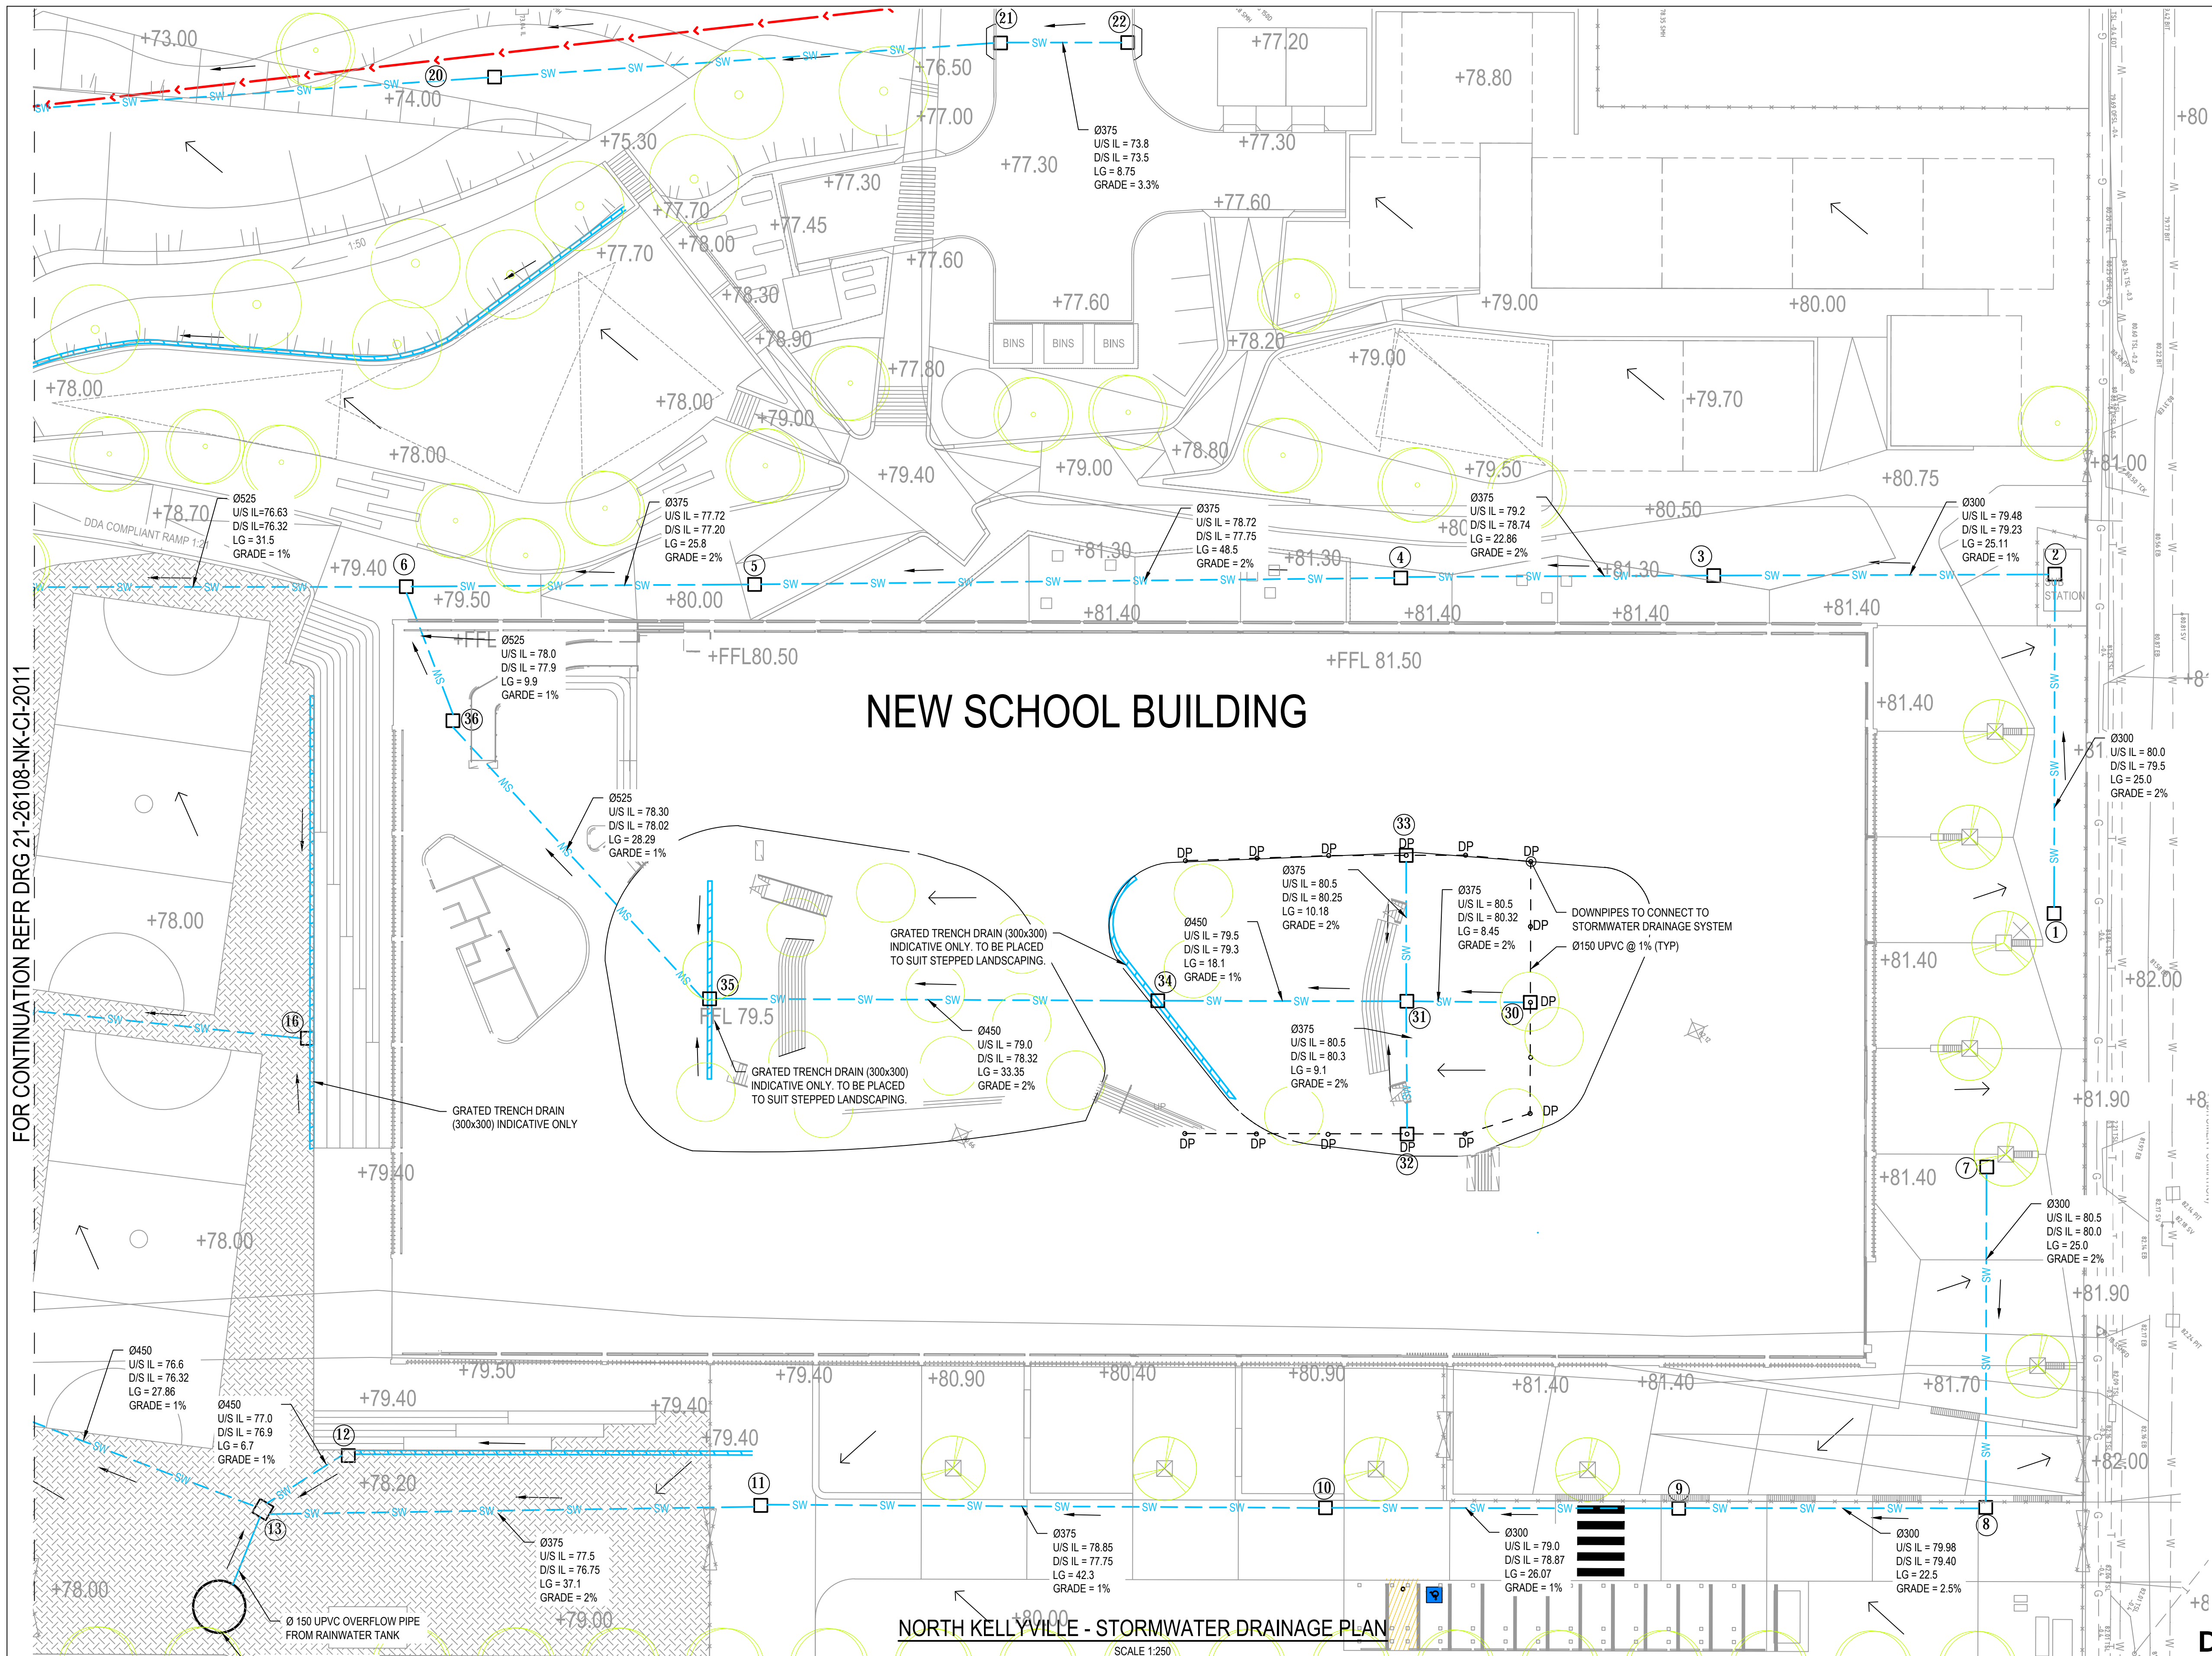


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





KEY PLAN

SCALE 1:2500

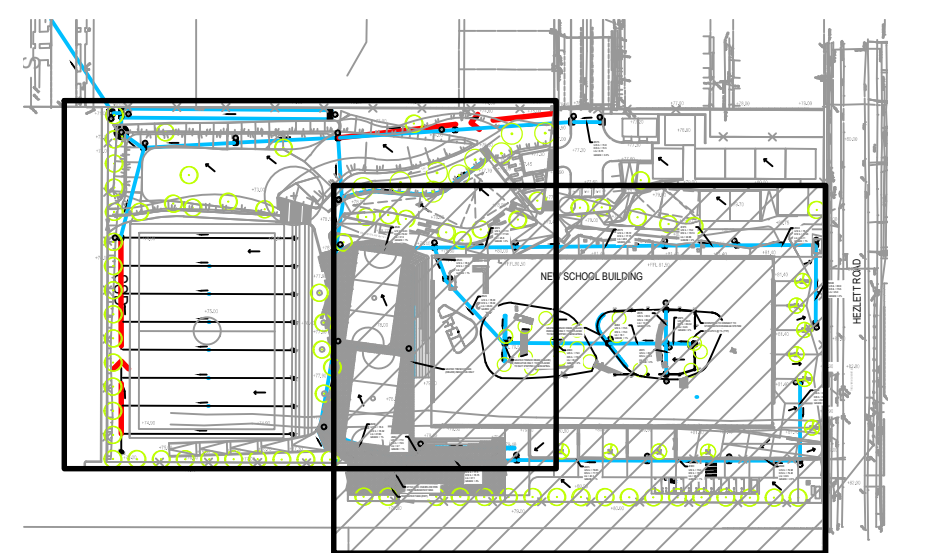NORTH KELLYVILLE - STORMWATER DRAINAGE PLAN


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DEVELOPMENT APPLICATION


						 SCALE 1:2500 AT ORIGINAL SIZE			 Education		 Level 15, 133 Castlereagh Street, Sydney NSW 2000 Australia T 61 2 9239 7100 F 61 2 9239 7199 E sydmail@ghd.com W www.ghd.com	DO NOT SCALE		Drawn M.RANGWALA	Designer G.DE SWARDT	Client	NSW DEPARTMENT OF EDUCATION NORTH KELLYVILLE PUBLIC SCHOOL		
D	ISSUED FOR DEVELOPMENT APPLICATION					MR	CS*					SM*	29.08.17	Drafting Check A.MACLEAN*	Design Check A.RAHMAN*	Project			
C	ISSUED FOR SSD SUBMISSION					MR	CS*					SM*	09.08.17	Approved (Project Director) Date		Title			
B	TENDER ADDENDUM					MR	MD*					MW*	21.07.16				CIVIL STORMWATER DRAINAGE PLAN-SHEET 2 OF 2		
A	ISSUED FOR TENDER					MR	CS*	SM*	28.06.17										
No	Revision	Note: * indicates signatures on original issue of drawing or last revision of drawing				Drawn	Job Manager	Project Director	Date	 SCALE 1:250 AT ORIGINAL SIZE		Scale 1:500		This Drawing must not be used for Construction unless signed as Approved		Original Size	A1	Drawing No: 2126108-NK-SD-CI-1012	Rev: D

Plot Date: 29 August 2017 5:49 PM Plotted by: Mona Rangwala









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- ### SUBSOIL IN PAVED AREAS

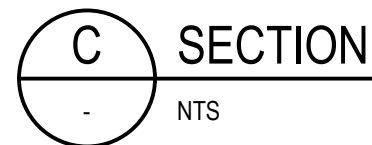

Original Size
A1 Drawing No: **21-26108-NK-SD-CI-1015** Rev: **D**

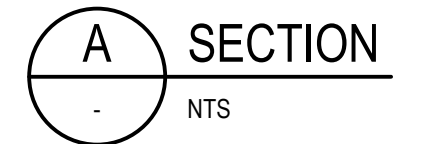


- NOTES:**
1. STRUCTURAL CONCRETE STRENGTH TO BE N32 AND BLINDING CONCRETE TO BE N10 IN ACCORDANCE WITH AS 1379 AND AS 3600.
 2. COVER TO REINFORCEMENT = 40mm UNLESS NOTED OTHERWISE.
 3. DESIGN LOAD - TYPE F LIGHT VEHICLE TO AS 1170.1
 4. EXPOSURE CLASSIFICATION - B1

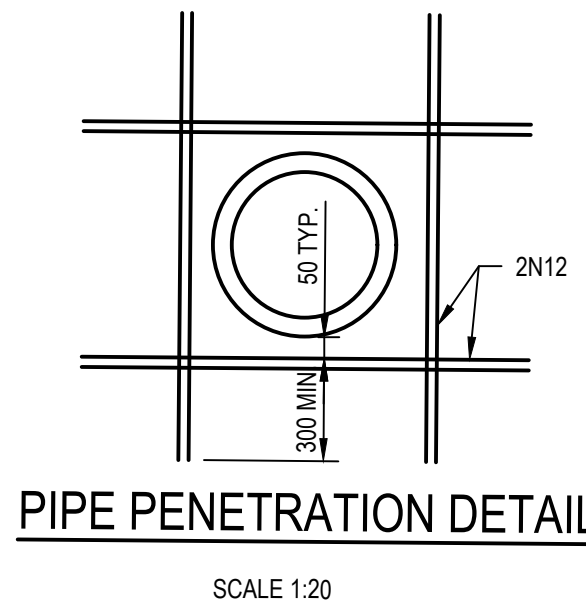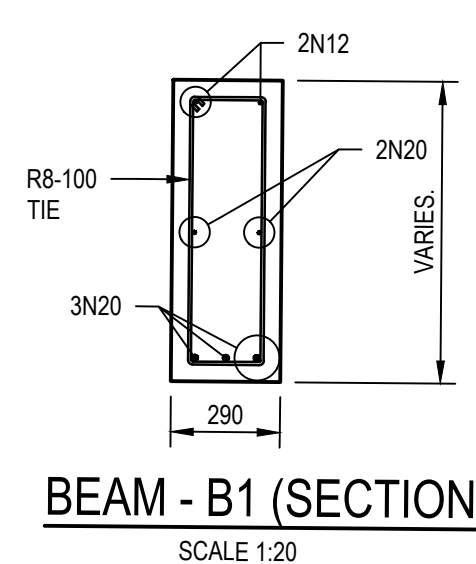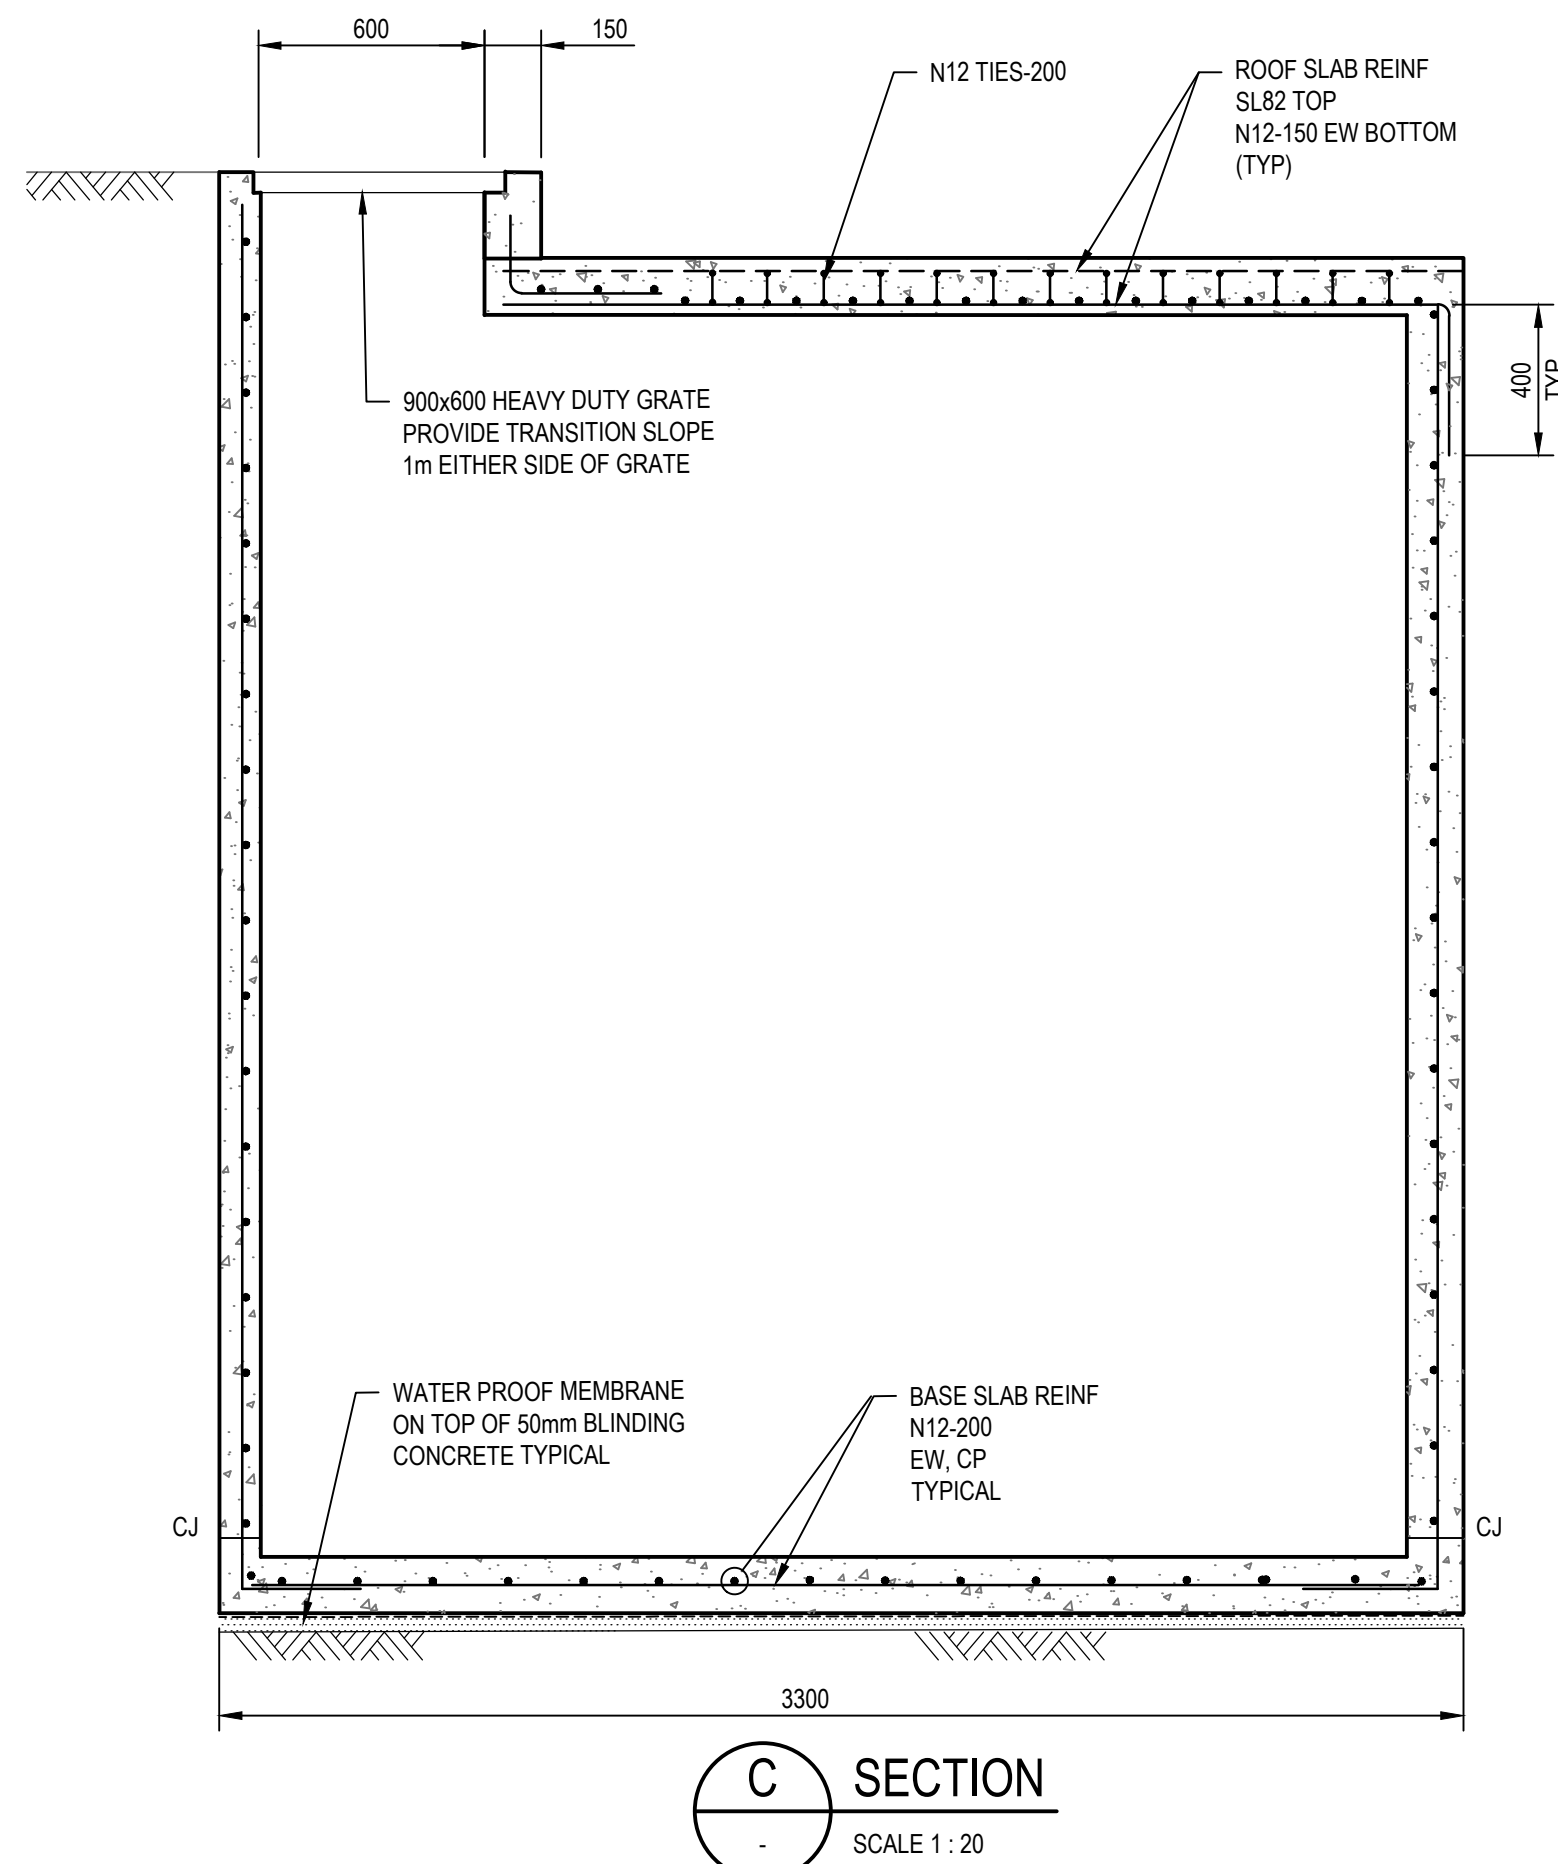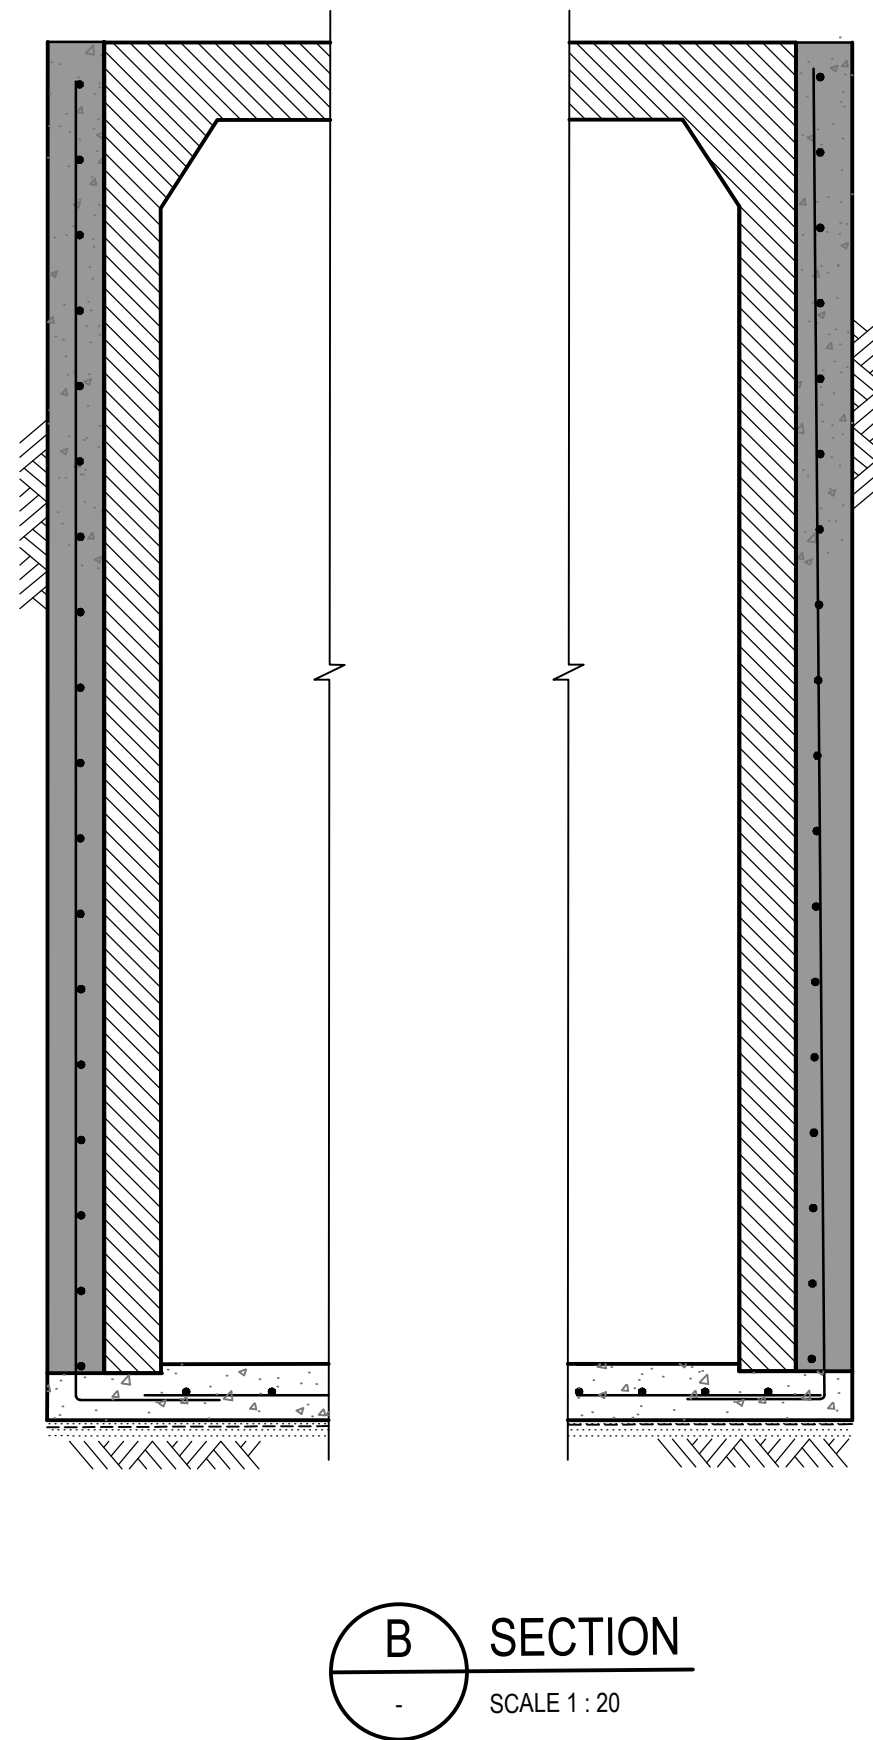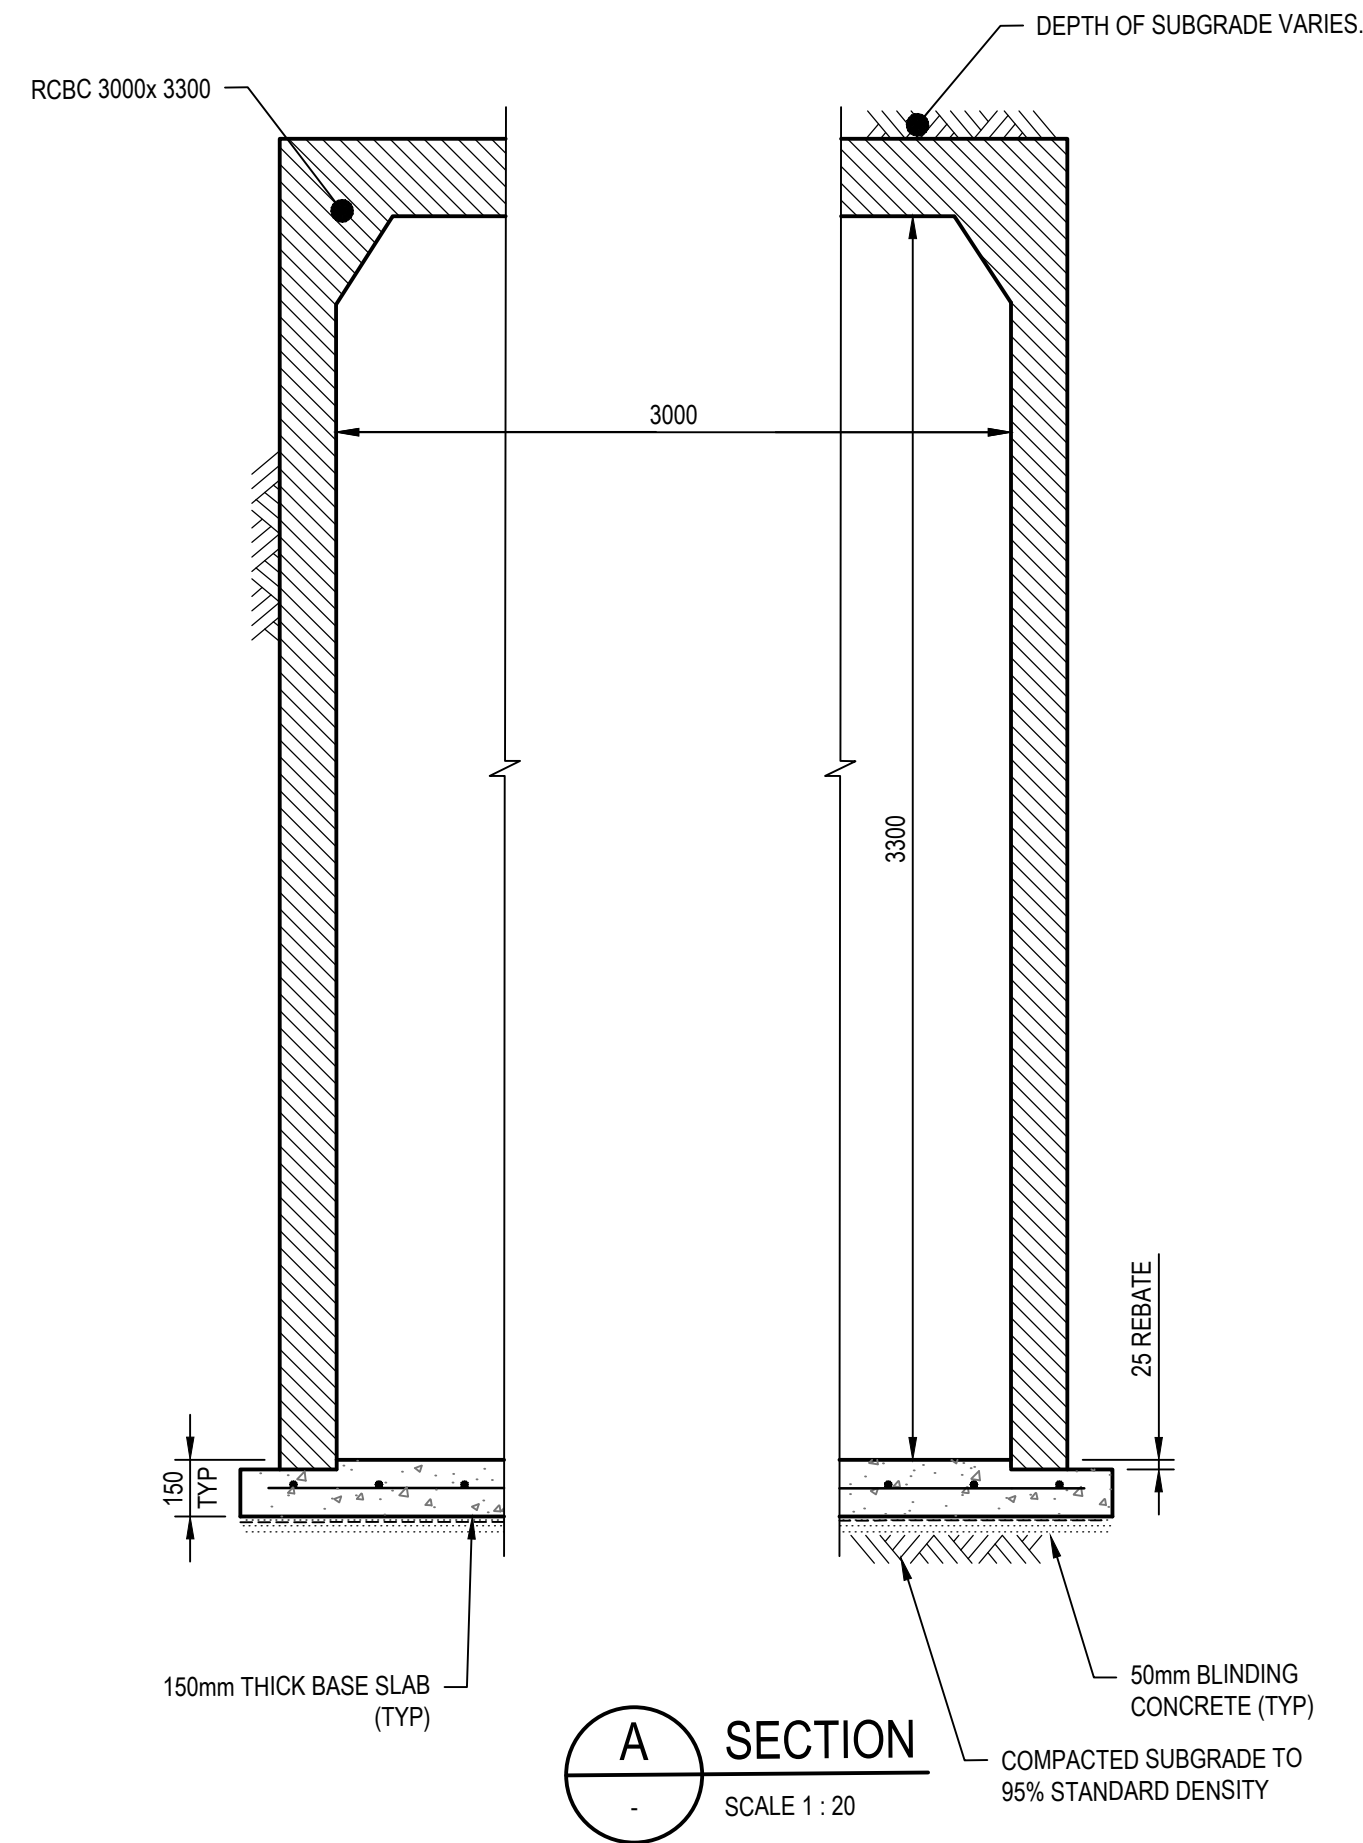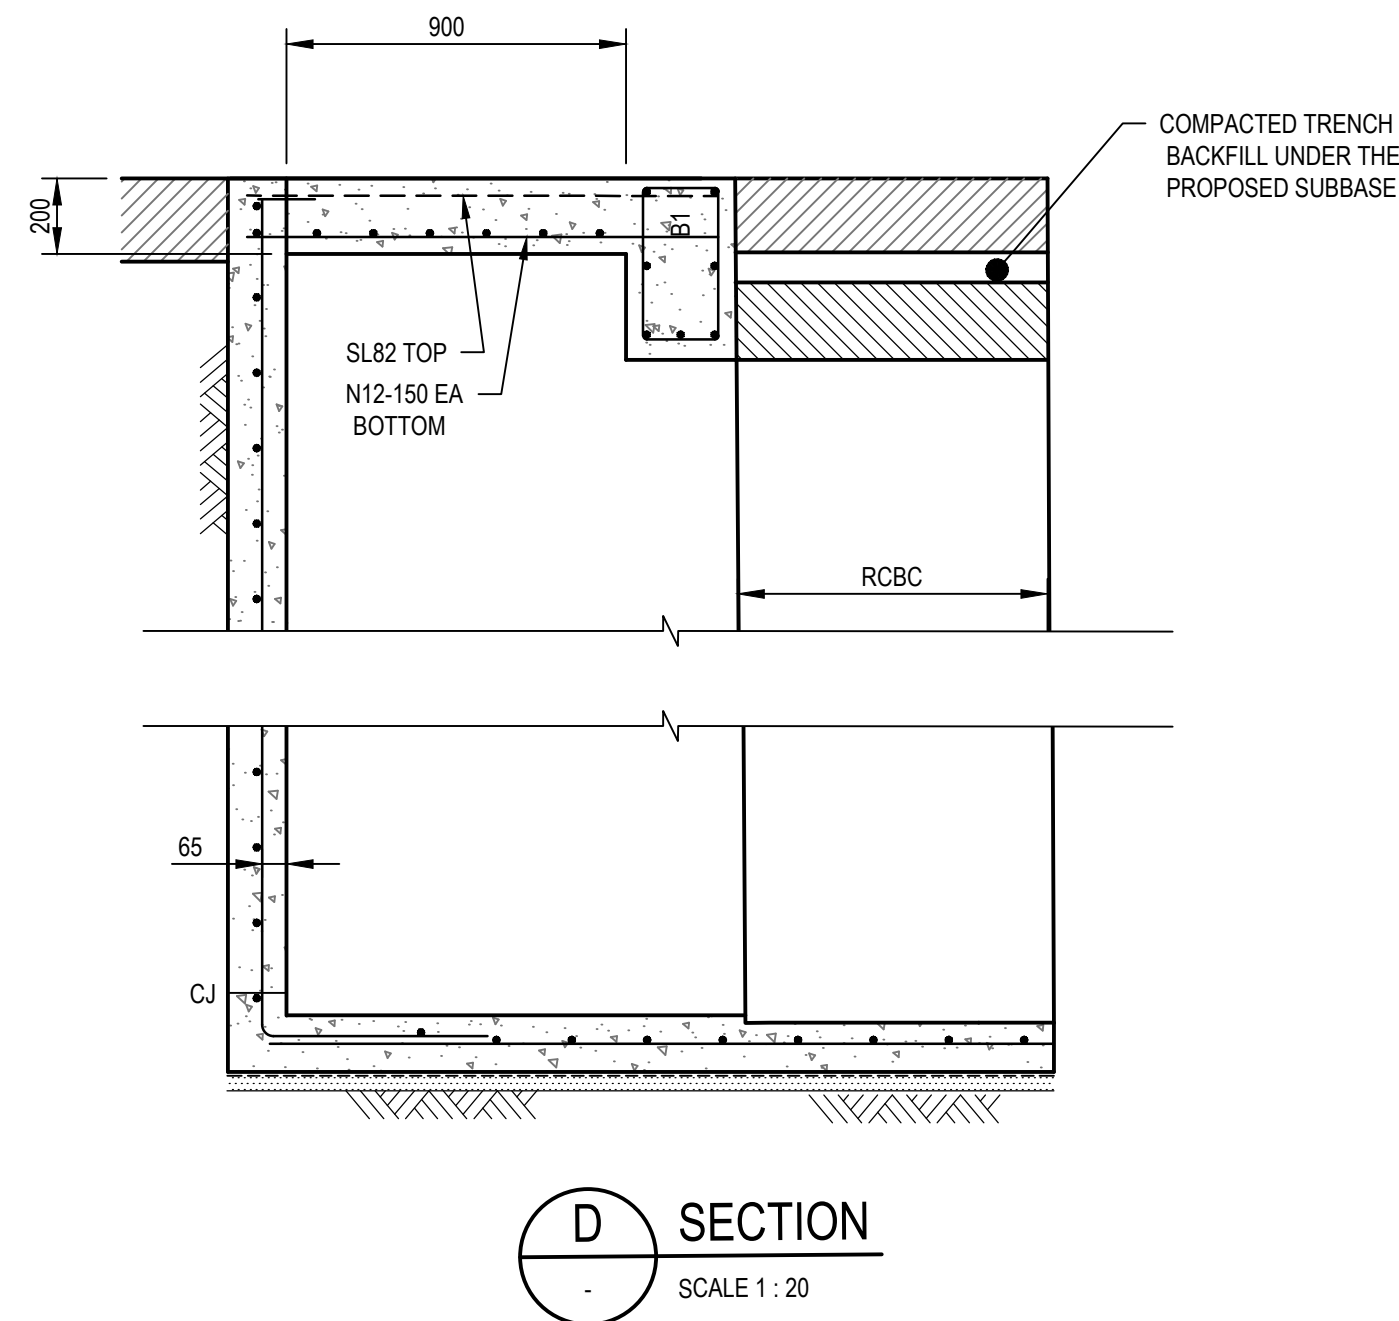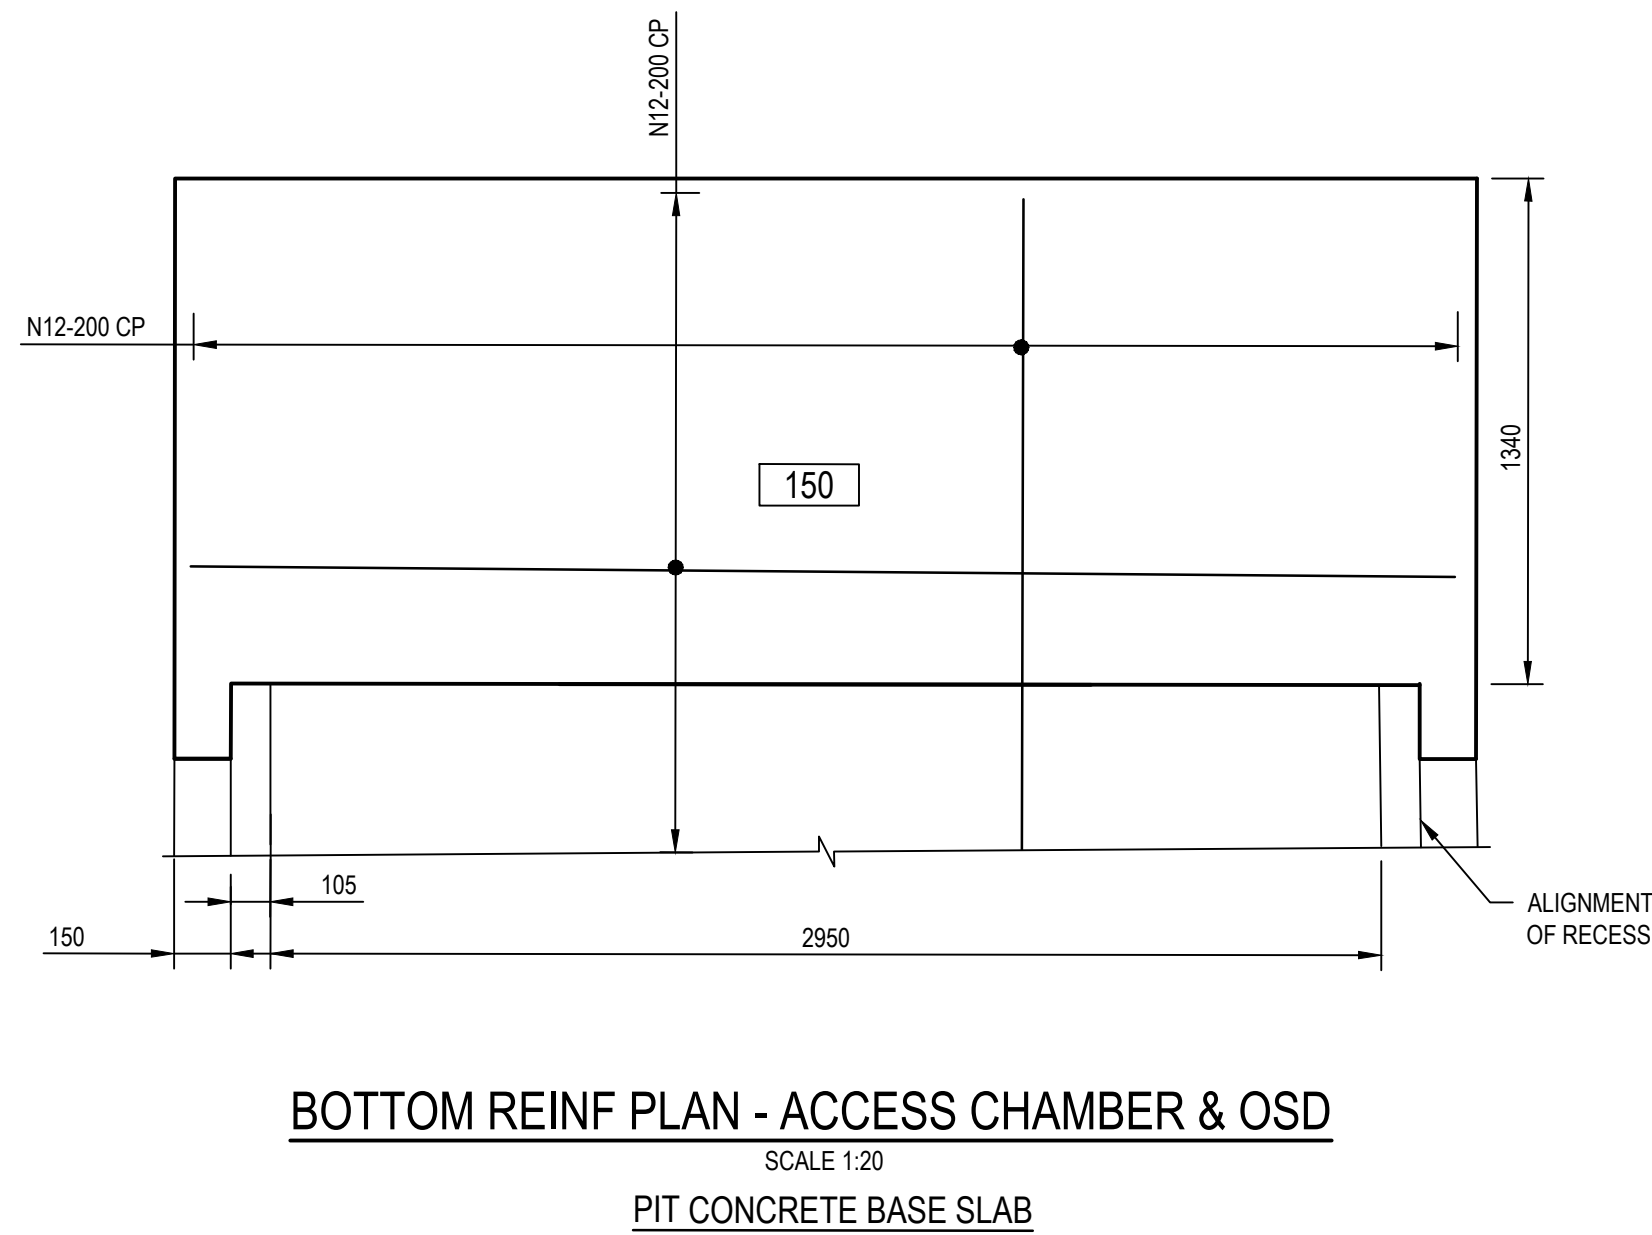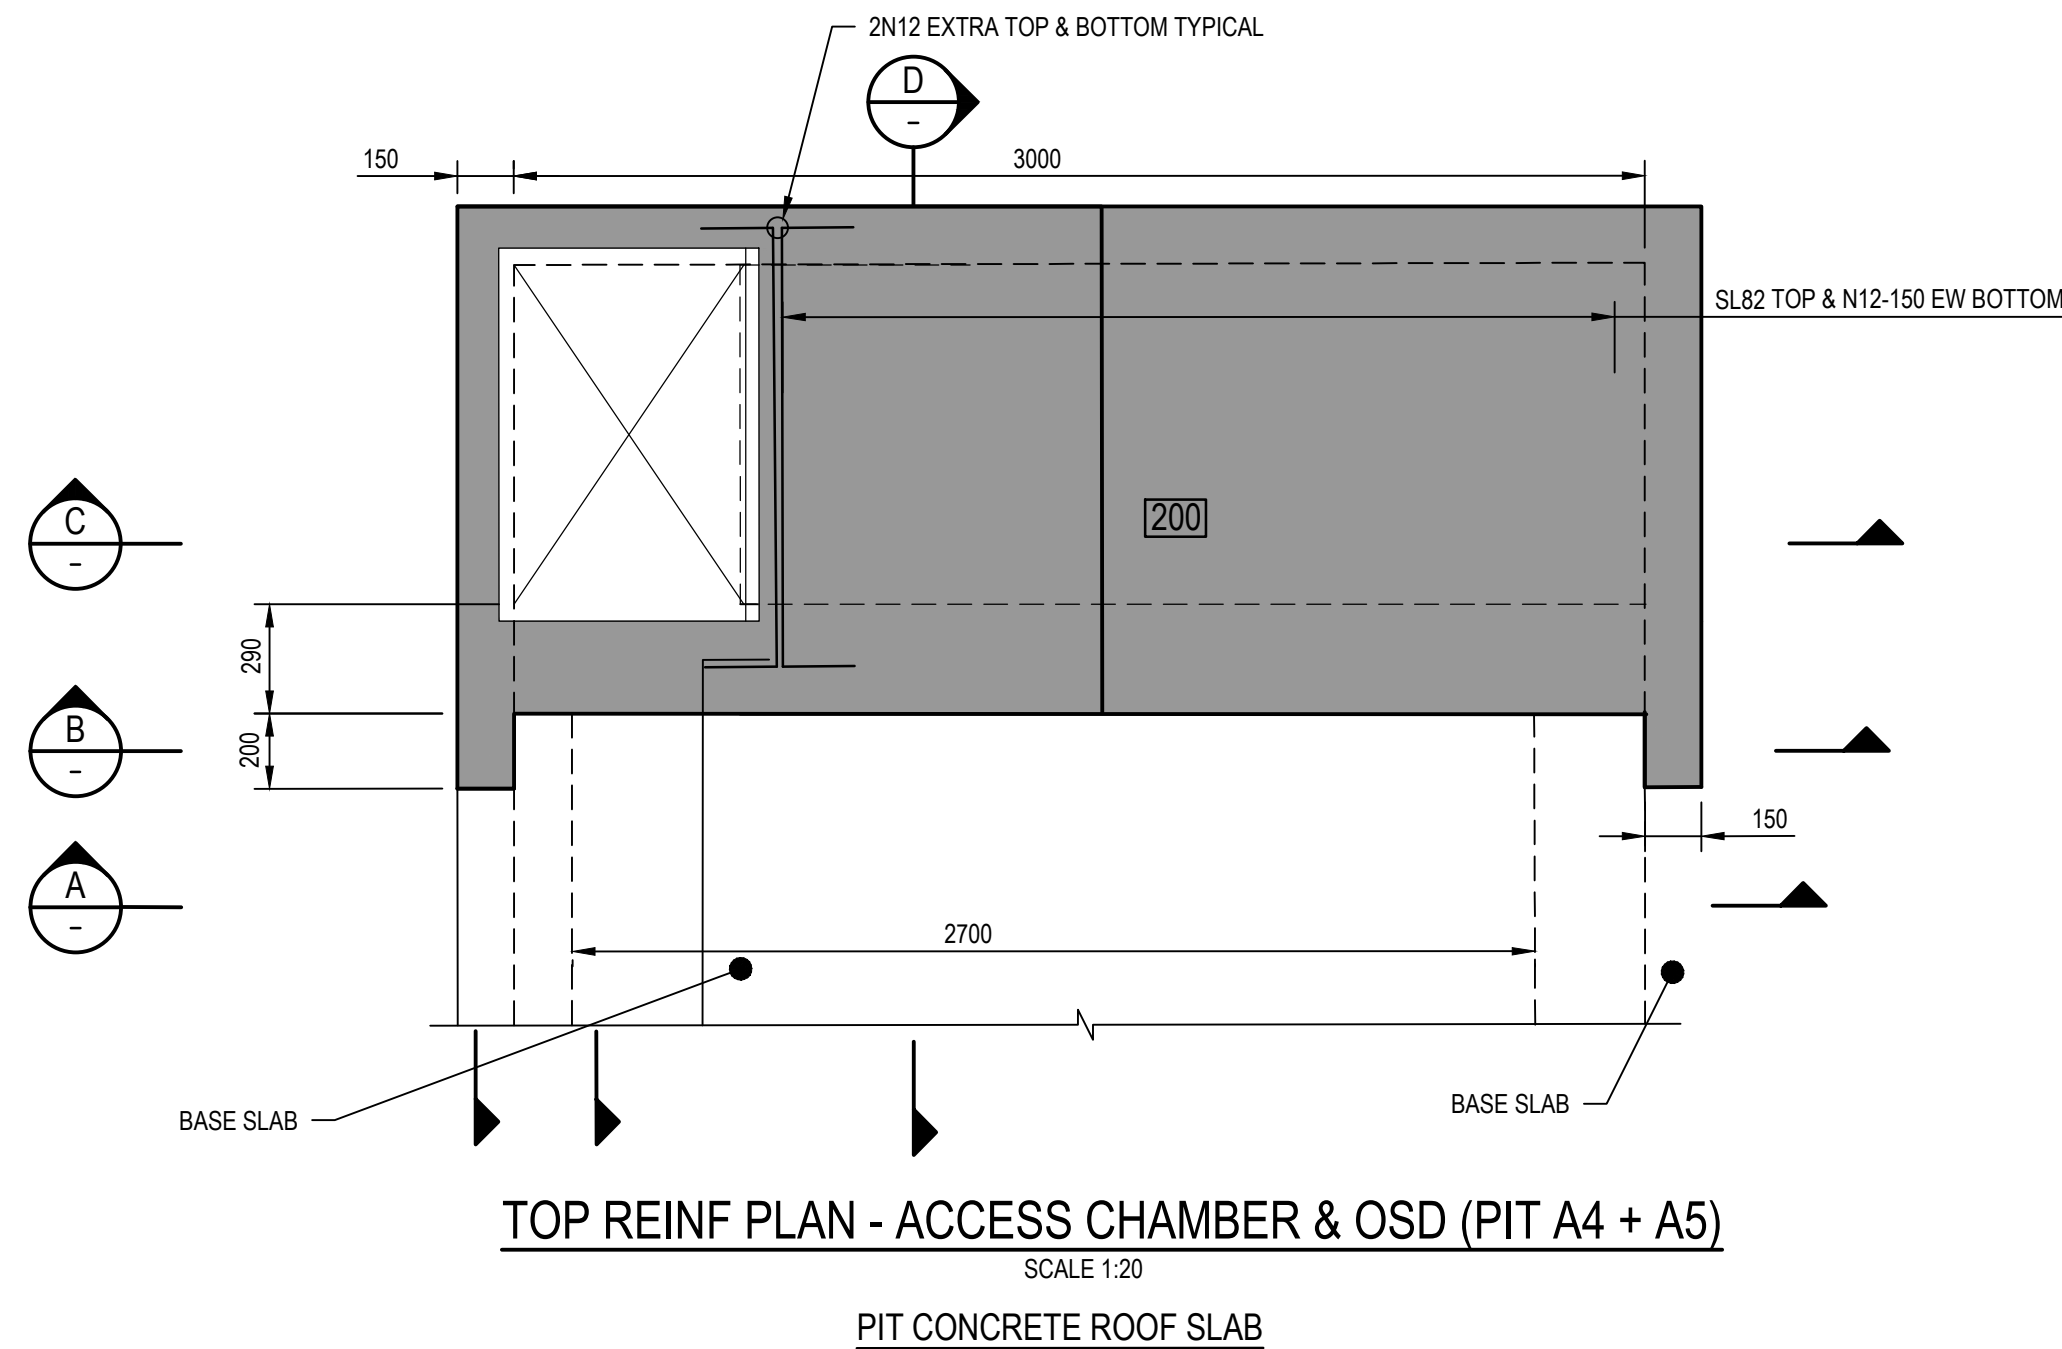ABBREVIATIONS
EW DENOTES EACH WAY
CP DENOTES CENTRALLY PLACED
CJ DENOTES CONSTRUCTION JOINT

DEVELOPMENT APPLICATION


B	ISSUED FOR DEVELOPMENT APPLICATION		MR	CS*	SM*	29.08.17
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No	Revision	Note: * indicates signatures on original issue of drawing or last revision of drawing	Drawn	Job Manager	Project Director	Date

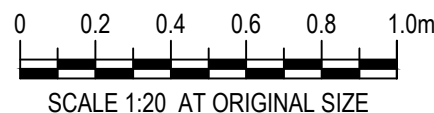

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Client NSW DEPARTMENT OF EDUCATION Project NORTH KELLYVILLE PUBLIC SCHOOL Title CIVIL STORMWATER DRAINAGE DETAILS-SHEET 2 OF 2	Original Size A1 Drawing No: 21-26108-NK-SD-CI-1016 Rev: B
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LEGEND:

- NEW CONCRETE PAVED AREA
- NEW BRICK PAVED AREA (NON-TRAFFICABLE)
- NEW ACCESS ROAD PAVED AREA (TRAFFICABLE)

NOTES:

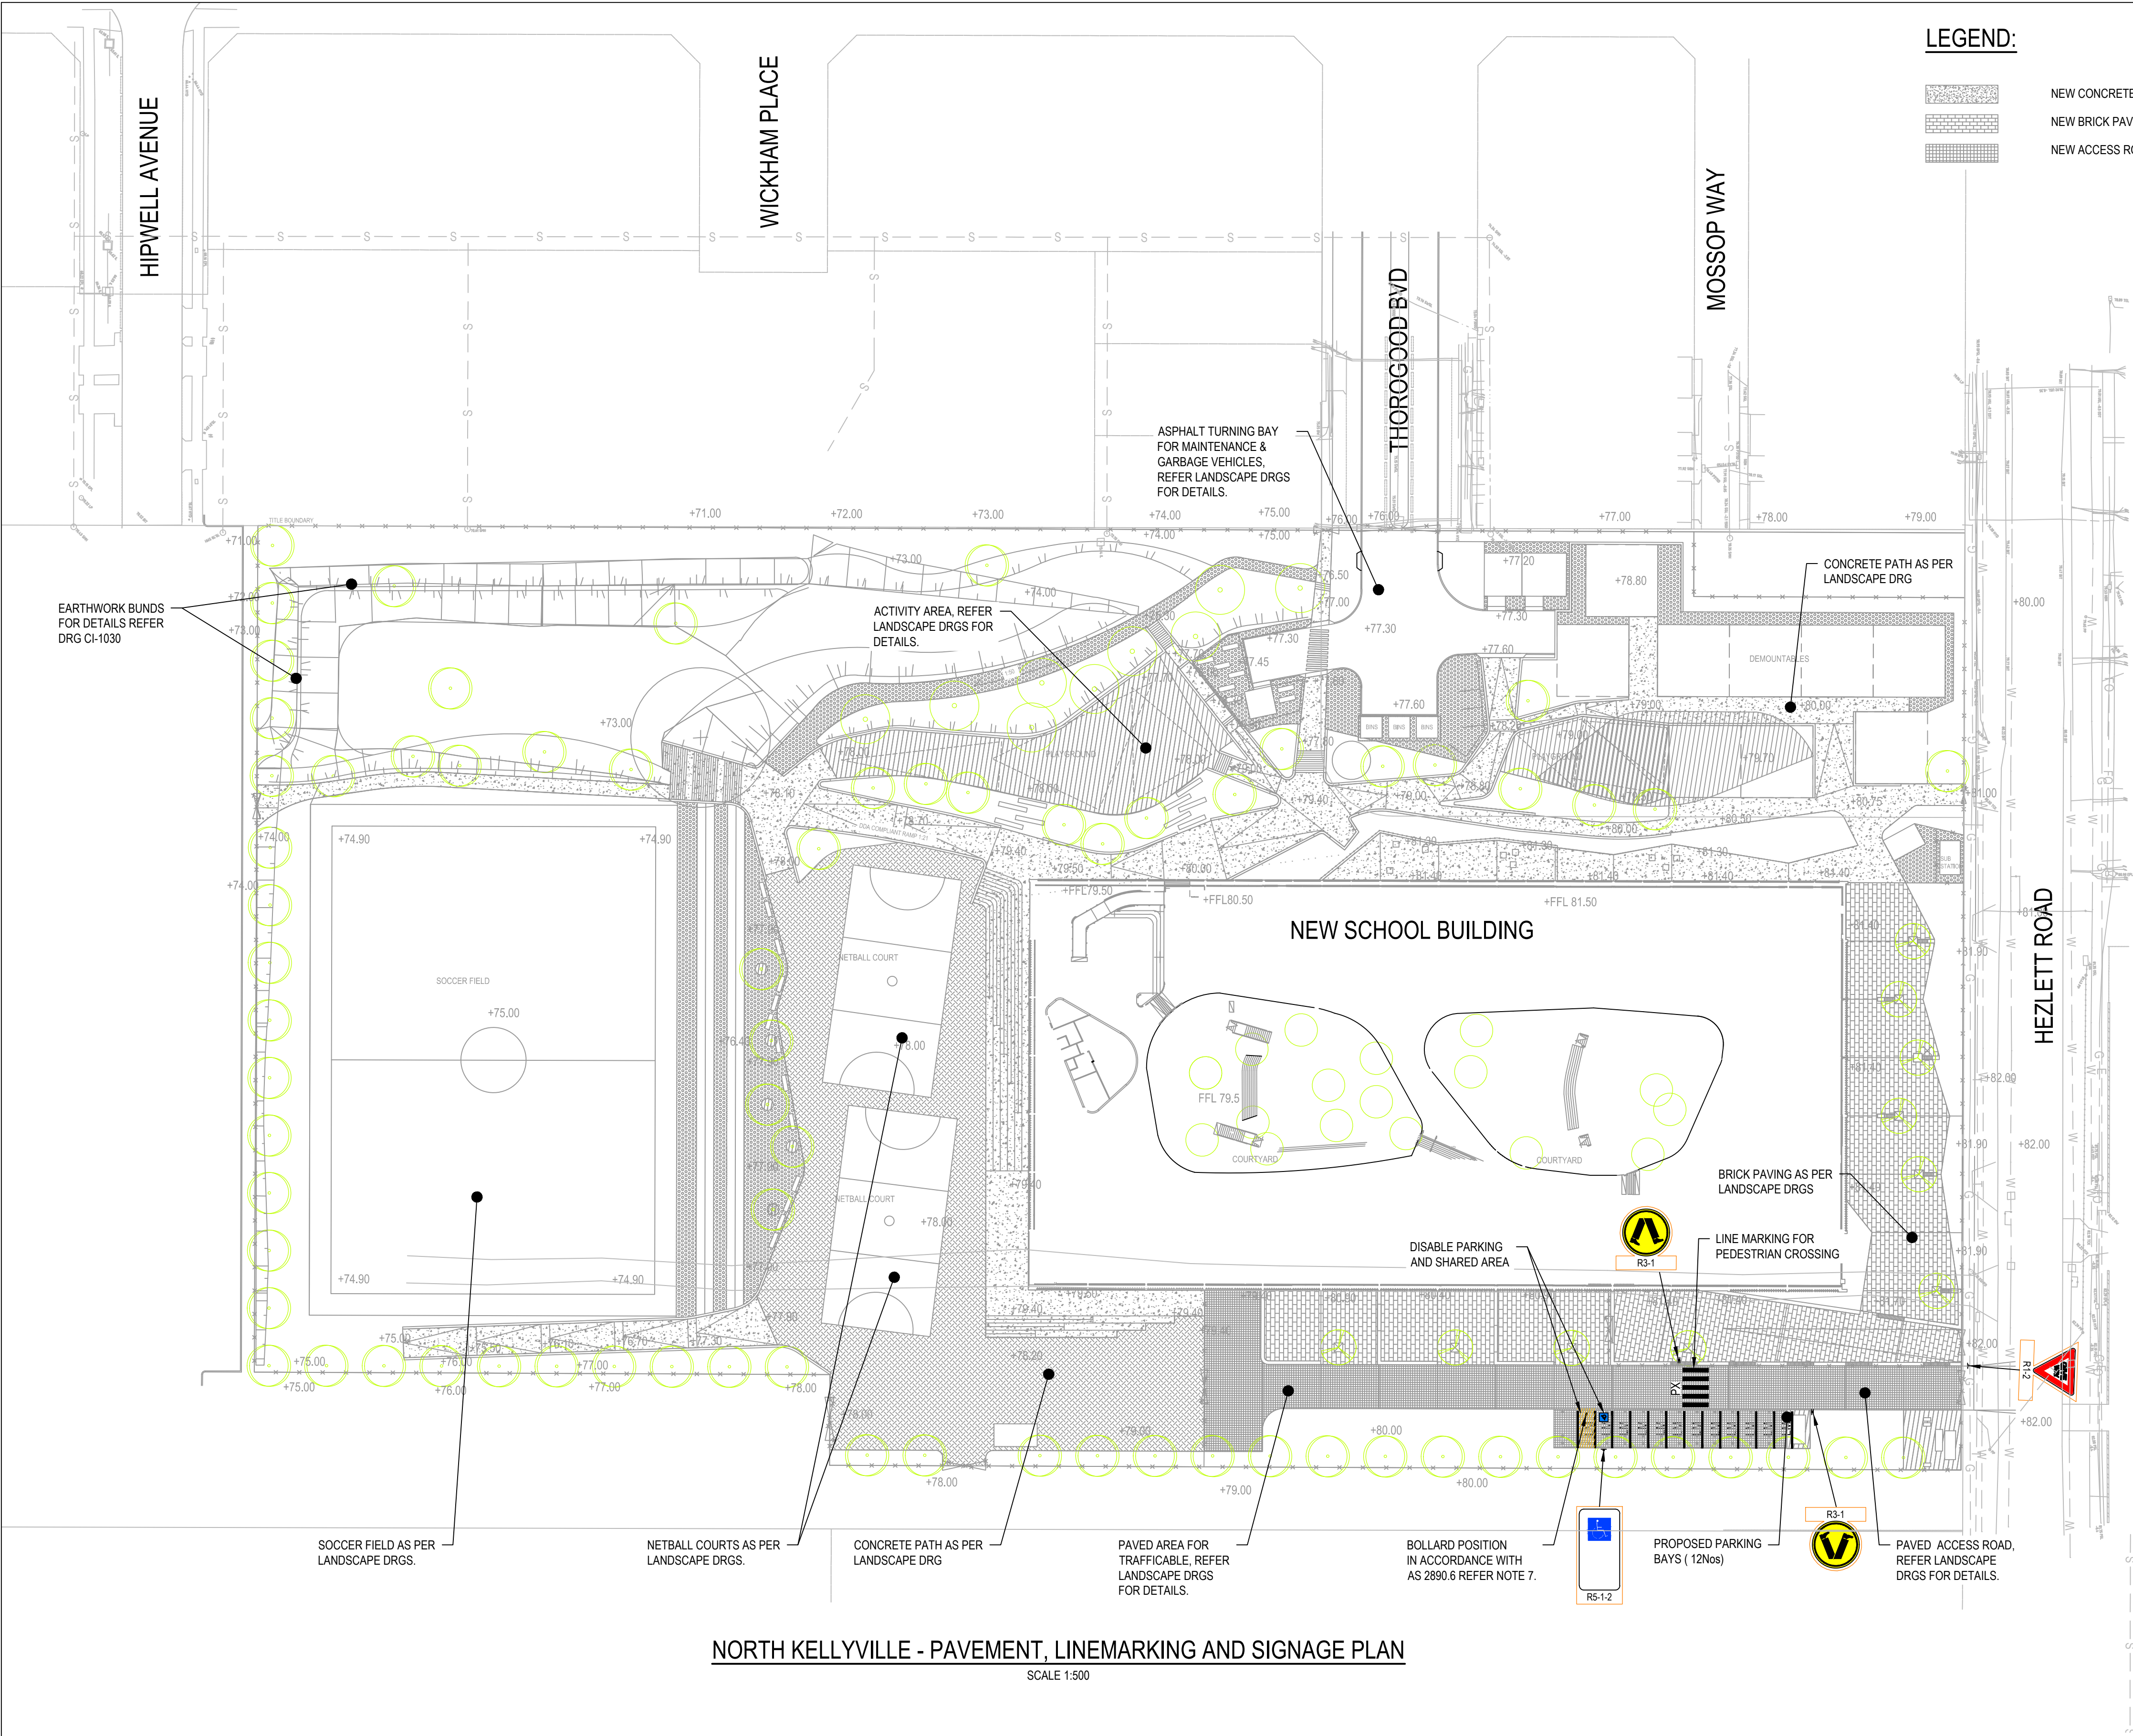
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LINE MARKING AND SIGNAGE NOTES:


- ALL LINE MARKINGS AND SIGNAGE IS APPLIED IN ACCORDANCE WITH THE REQUIREMENTS OF AS 2890 AND RMS STANDARDS, SPECIFICATIONS AND GUIDES.
- LINE MARKING IN PARKING BAYS: PAINT IS WATER BASED - COLOUR 'WHITE'. LINE SHALL BE 100mm WIDE UNBROKEN LINE FOR PARKING. LINE MARKING OTHER THAN PARKING BAYS: PAINT IS WATER BASED WITH REFLECTIVE GLASS BEADS - COLOUR 'WHITE'.
- LINE MARKING FOR DISABLED PARKING AREAS:
 - PAINT IS WATER BASED WITH REFLECTIVE BEADS.
 - COLOUR IS 'BLUE', 'YELLOW' AND 'WHITE' AS PER AS/NZS2890.6 (2009).
 - LINE MARKING AROUND THE DEDICATED DDA SPACES IS UNBROKEN 'YELLOW' LINES 100mm WIDE.
 - THE SYMBOL OF ACCESS (WHEELCHAIR) IS WHITE (800mm HIGH) ON A BLUE SQUARE (1200mm x 1200mm), SITTING 500mm BACK IN THE SPACE AND CENTRED.
 - THE SHARED SPACE OUTLINED WITH 'YELLOW' LINES 100mm WIDE ON ALL SIDES (EXCEPT ALONG KERB FACE) WITH 45° DIAGONAL STRIPES 150mm WIDE SPACED 300mm APART.
 - ALL SPACES DELINEATED IN ACCORDANCE WITH AS/NZS2890.6 (2009).
- ALL EXISTING SIGNS AFFECTED BY PROPOSED WORKS SHALL BE REINSTATED IF IN GOOD CONDITION, OTHERWISE THEY SHALL BE REPLACED.
- ALL SIGNS ARE TO BE ANTI-GRAFFITI COATED.
- ALL SIGNS ARE TO BE TYPE 'A' UNLESS NOTED OTHERWISE ON PLAN.
- BOLLARDS TO BE HEAVY DUTY GALVANISED STEEL 'SECURAPOST' FIXED BOLLARDS 125NB (1BR125B) BY LEDA SECURITY PRODUCTS OR APPROVED EQUIVALENT TO BE CONCRETED INTO THE GROUND. FINISH SHALL BE FACTORY POWDER COAT TO AS 3715 IN 'INDUSTRIAL YELLOW'. WALL THICKNESS TO BE NOM. 5.4mm. BOLLARD TO BE INSTALLED AS PER MANUFACTURER'S SPECIFICATIONS AND DETAILS.

LINEMARKING AND SIGNAGE ABBREVIATIONS

- LM PARKING LINE MARKING
- PX PEDESTRIAN CROSSING

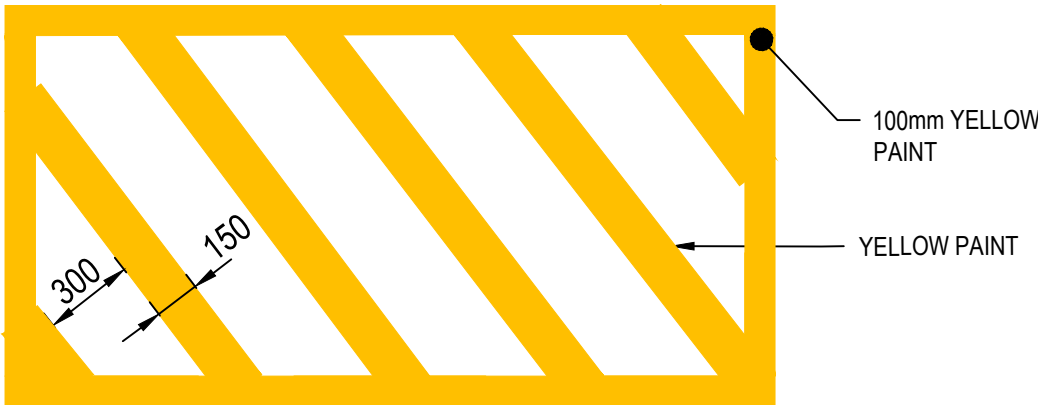

CHEVRON LINEMARKING (DISABLED PARKING/ SHARED SPACE)



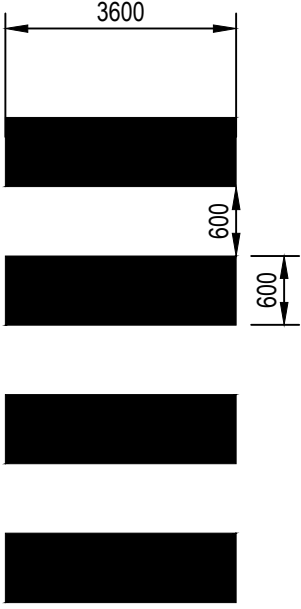


LINEMARKING FOR PEDESTRIAN CROSSING (PX)

NORTH KELLYVILLE - PAVEMENT, LINEMARKING AND SIGNAGE PLAN

SCALE 1:500

D	ISSUED FOR DEVELOPMENT APPLICATION	MR	CS*	SM*	29.08.17	
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B	ISSUED FOR TENDER	MR	CS*	SM*	28.06.17	
A	40% SCHEME/TENDER ISSUE	MR	CS*	SM*	16.06.17	
No	Revision	Note: * indicates signatures on original issue of drawing or last revision of drawing	Drawn	Job Manager	Project Director	Date

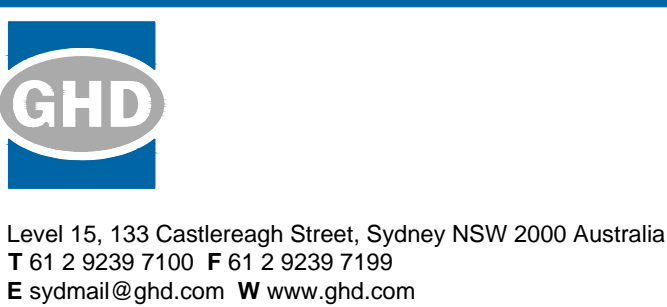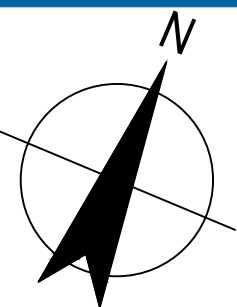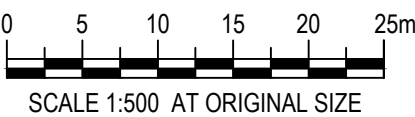

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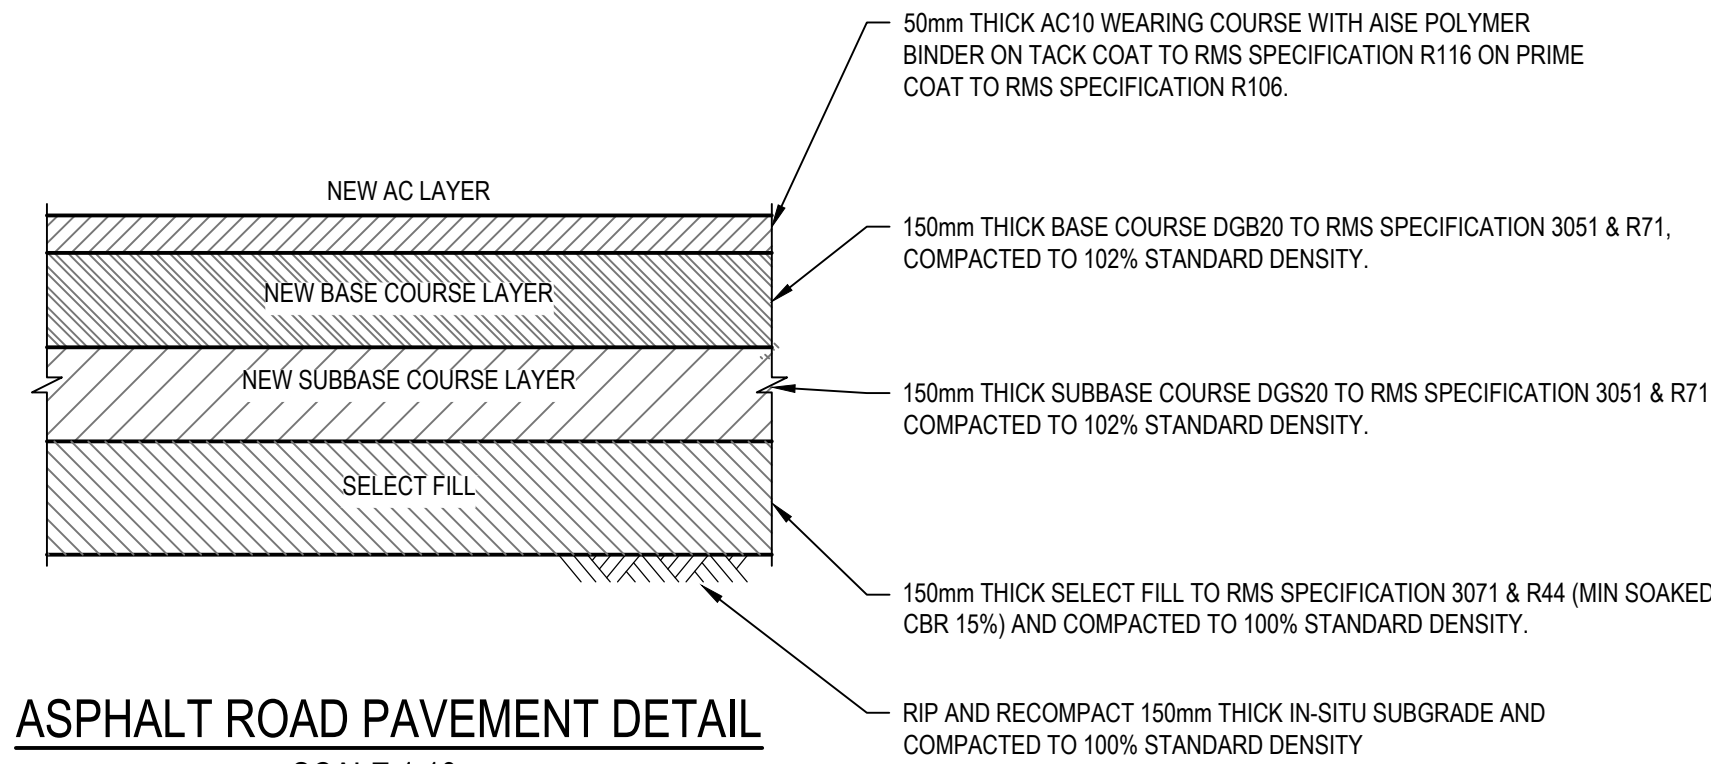
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Drafting Check	A.MACLEAN*	Design Check	A. RAHMAN*
Approved (Project Director)			
Date			
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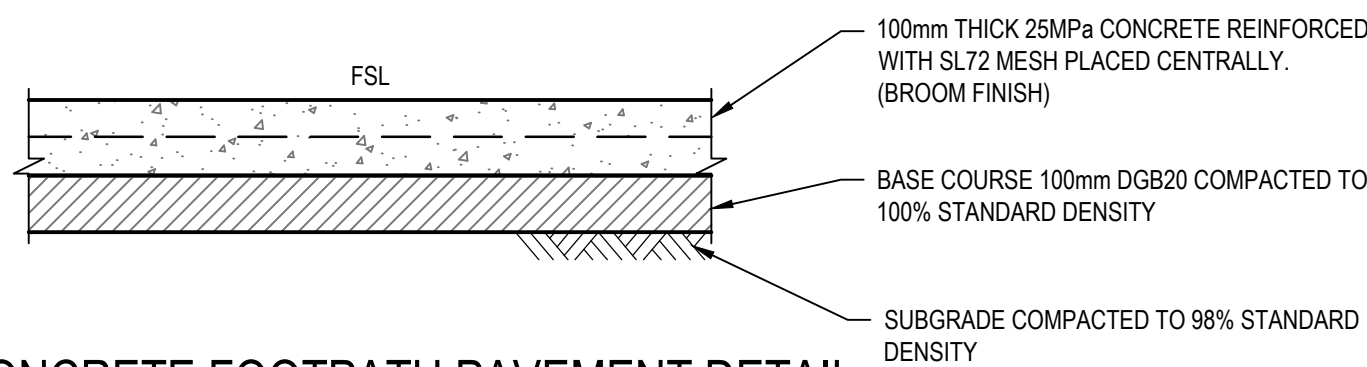
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DEVELOPMENT APPLICATION


Client	NSW DEPARTMENT OF EDUCATION
Project	NORTH KELLYVILLE PUBLIC SCHOOL
Title	CIVIL PAVEMENT, LINE MARKING & SIGNAGE PLAN
Original Size	A1
Drawing No:	2126108-NK-SD-CI-1020
Rev:	D




ASPHALT ROAD PAVEMENT DETAIL
SCALE 1:10




CONCRETE FOOTPATH PAVEMENT DETAIL
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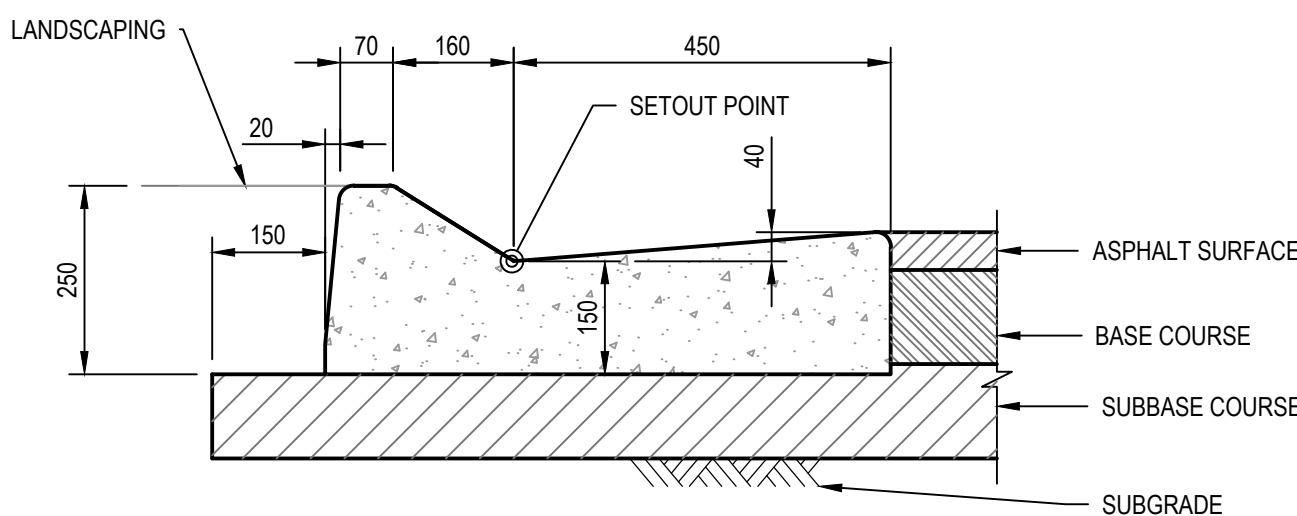
SIGNPOST FOOTING DETAIL
SCALE 1:10

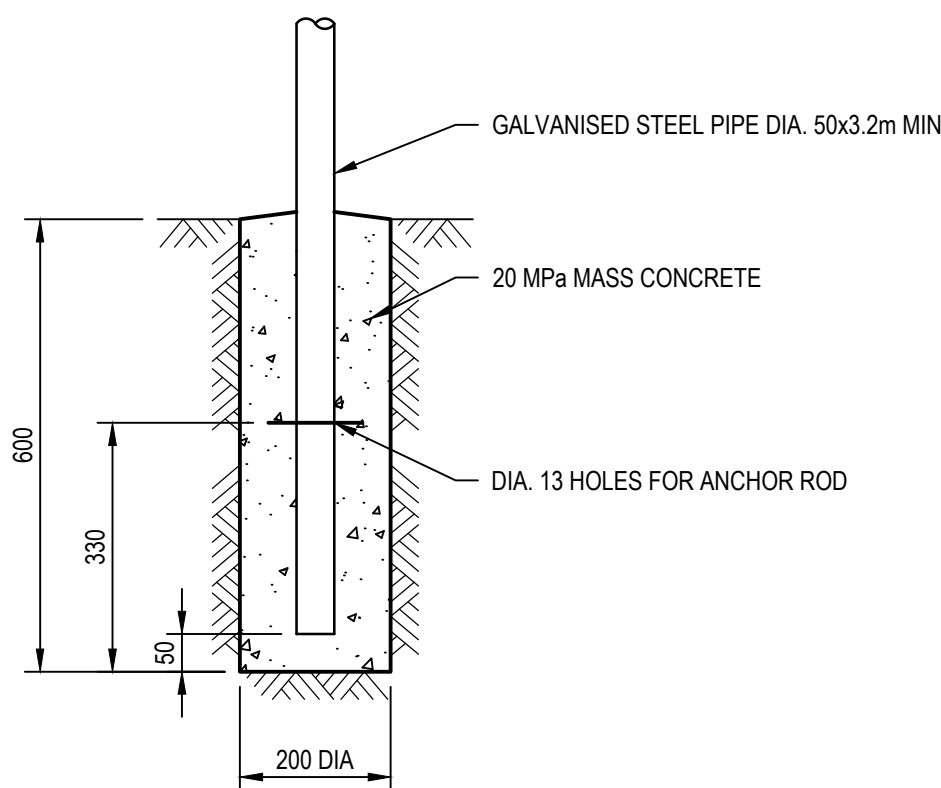




KERB ONLY (KO)
SCALE 1:10

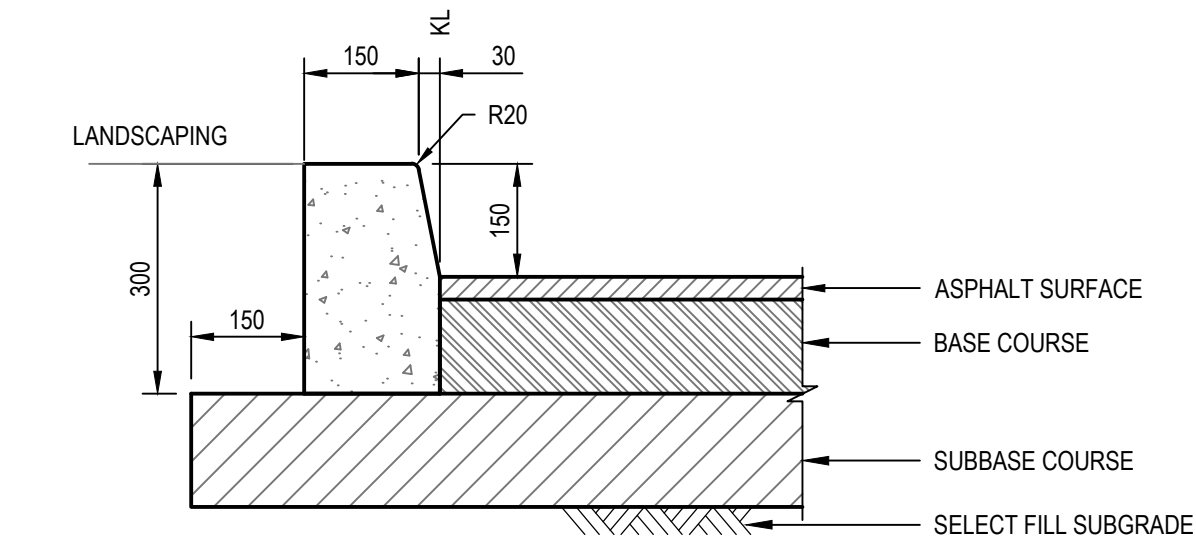

KERB & GUTTER (KG)
SCALE 1:10

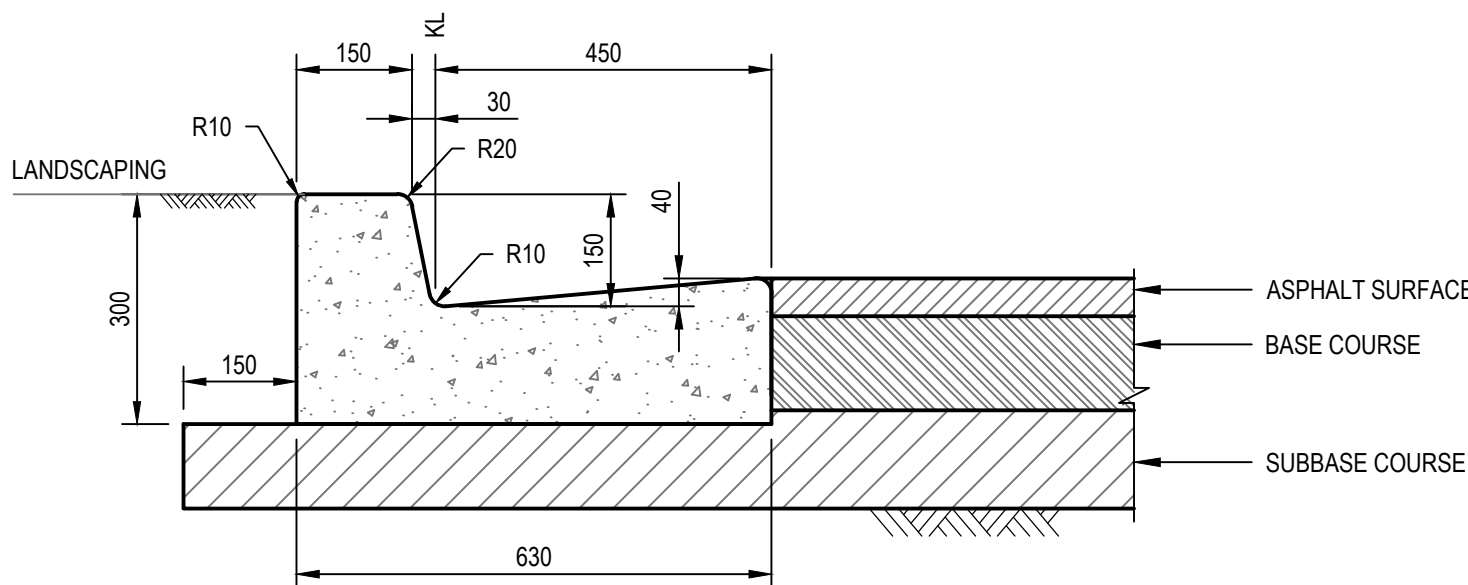

MOUNTABLE KERB & GUTTER (MK&G)
SCALE 1:10

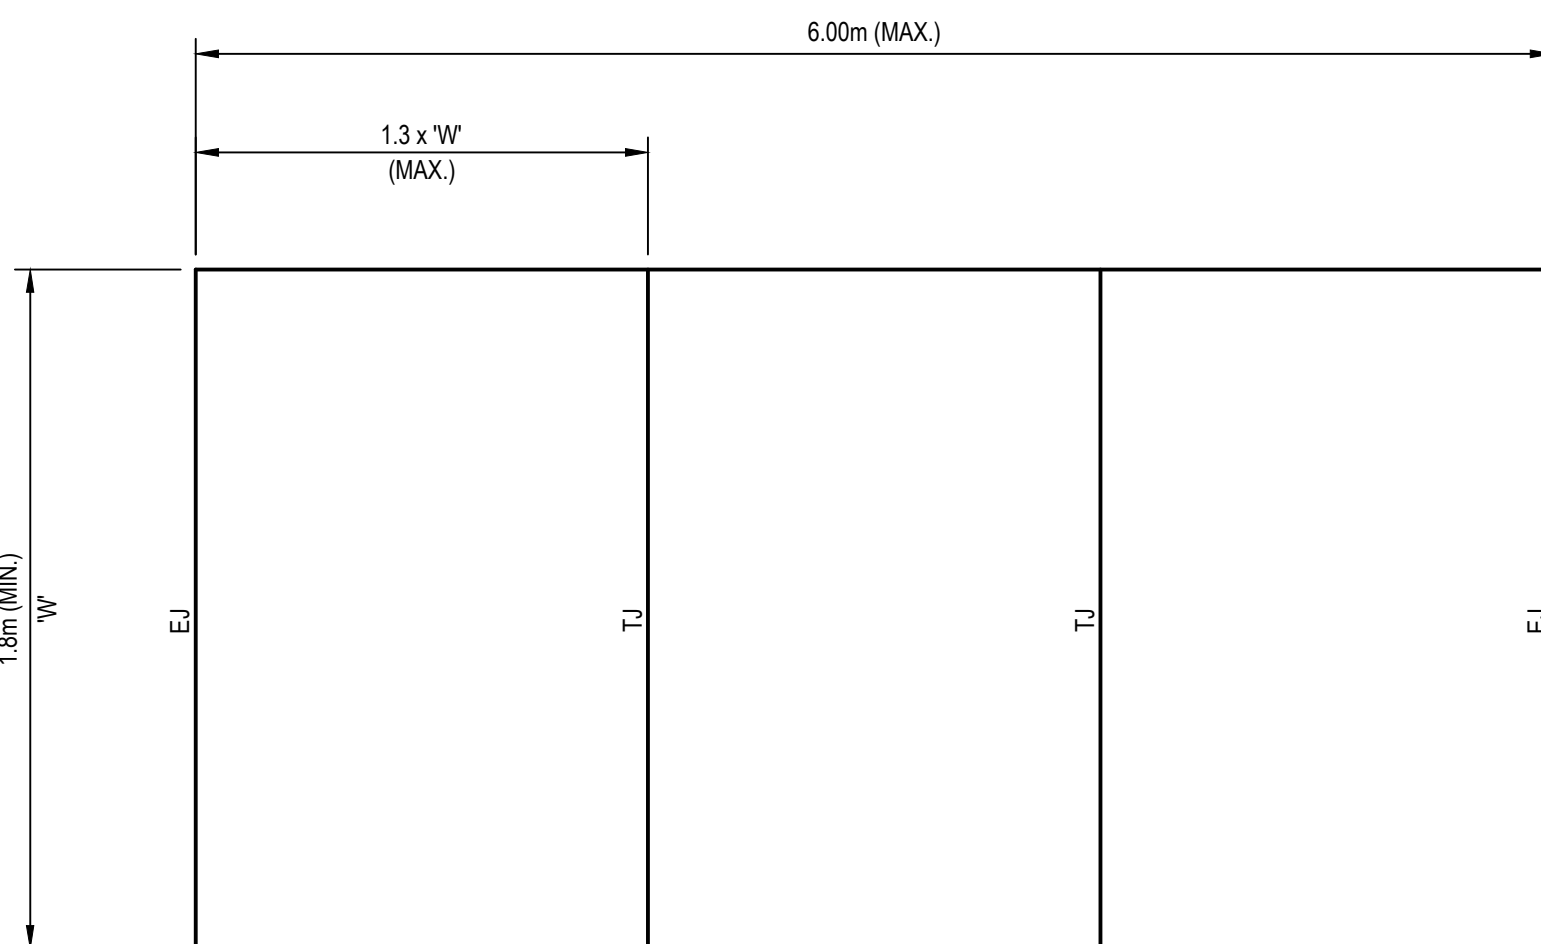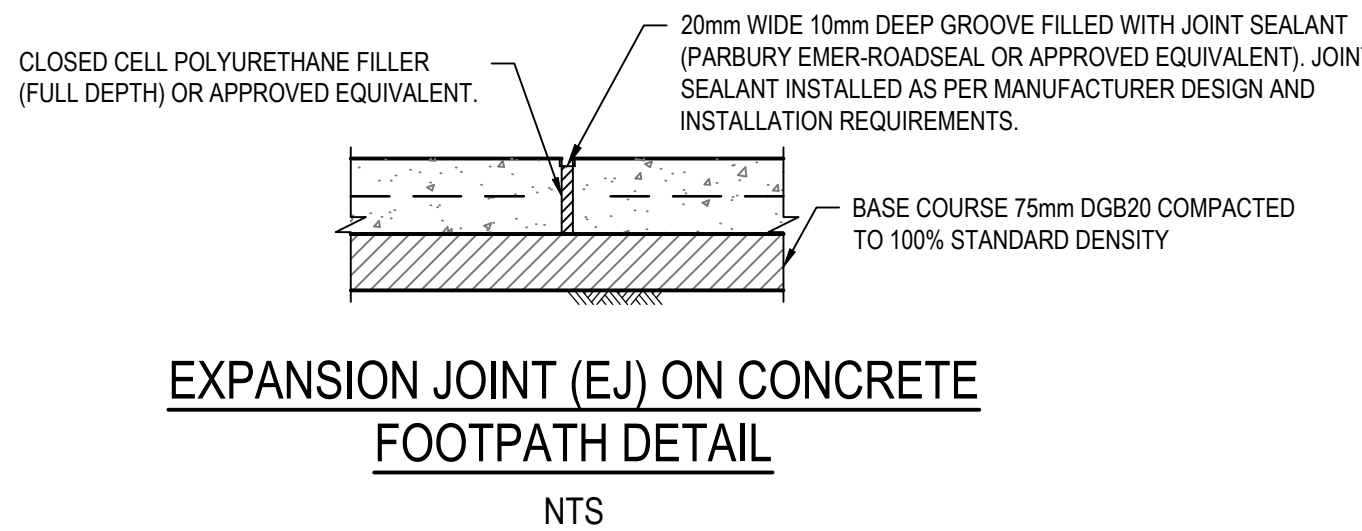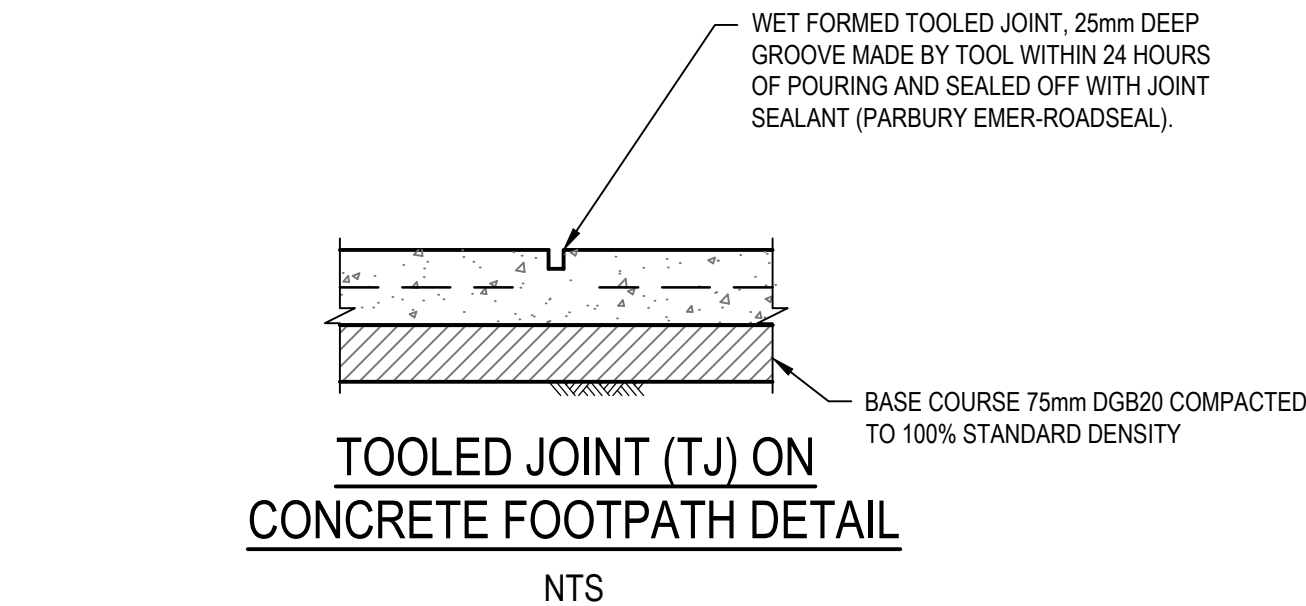


TJ: TOOL JOINT
EJ: EXPANSION JOINT

TYPICAL FOOTPATH JOINT DETAIL
NTS

DEVELOPMENT APPLICATION

D	ISSUED FOR DEVELOPMENT APPLICATION		MR	CS*	SM*	29.08.17
C	ISSUED FOR SSD SUBMISSION		MR	CS*	SM*	09.08.17
B	ISSUED FOR TENDER		MR	CS*	SM*	28.06.17
A	ISSUED FOR SSD DEVELOPMENT APPLICATION		MR	CS*	SM*	09.06.17
No	Revision	Note: * indicates signatures on original issue of drawing or last revision of drawing	Drawn	Job Manager	Project Director	Date

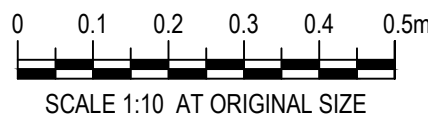


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DO NOT SCALE		Drawn	M.RANGWALA	Designer	G.DE SWARDT
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	Approved (Project Director)				
	Date				
Scale	AS SHOWN	This Drawing must not be used for Construction unless signed as Approved			

Client	NSW DEPARTMENT OF EDUCATION				
Project	NORTH KELLYVILLE PUBLIC SCHOOL				
Title	CIVIL CIVIL- ROAD WORKS DETAILS				
Original Size	A1	Drawing No:	21-26108-NK-SD-CI-1025		
		Rev:	D		



Surface Analysis: Elevation Ranges			
Number	Color	Minimum Elevation (m)	Maximum Elevation (m)
1		-3.000	-2.500
2		-2.500	-2.000
3		-2.000	-1.500
4		-1.500	-1.000
5		-1.000	-0.500
6		-0.500	0.000
7		0.000	0.500
8		0.500	1.000
9		1.000	1.500
10		1.500	2.000
11		2.000	2.500
12		2.500	3.000
13		3.000	3.500
14		3.500	4.000
15		4.000	4.500
16		4.500	5.000

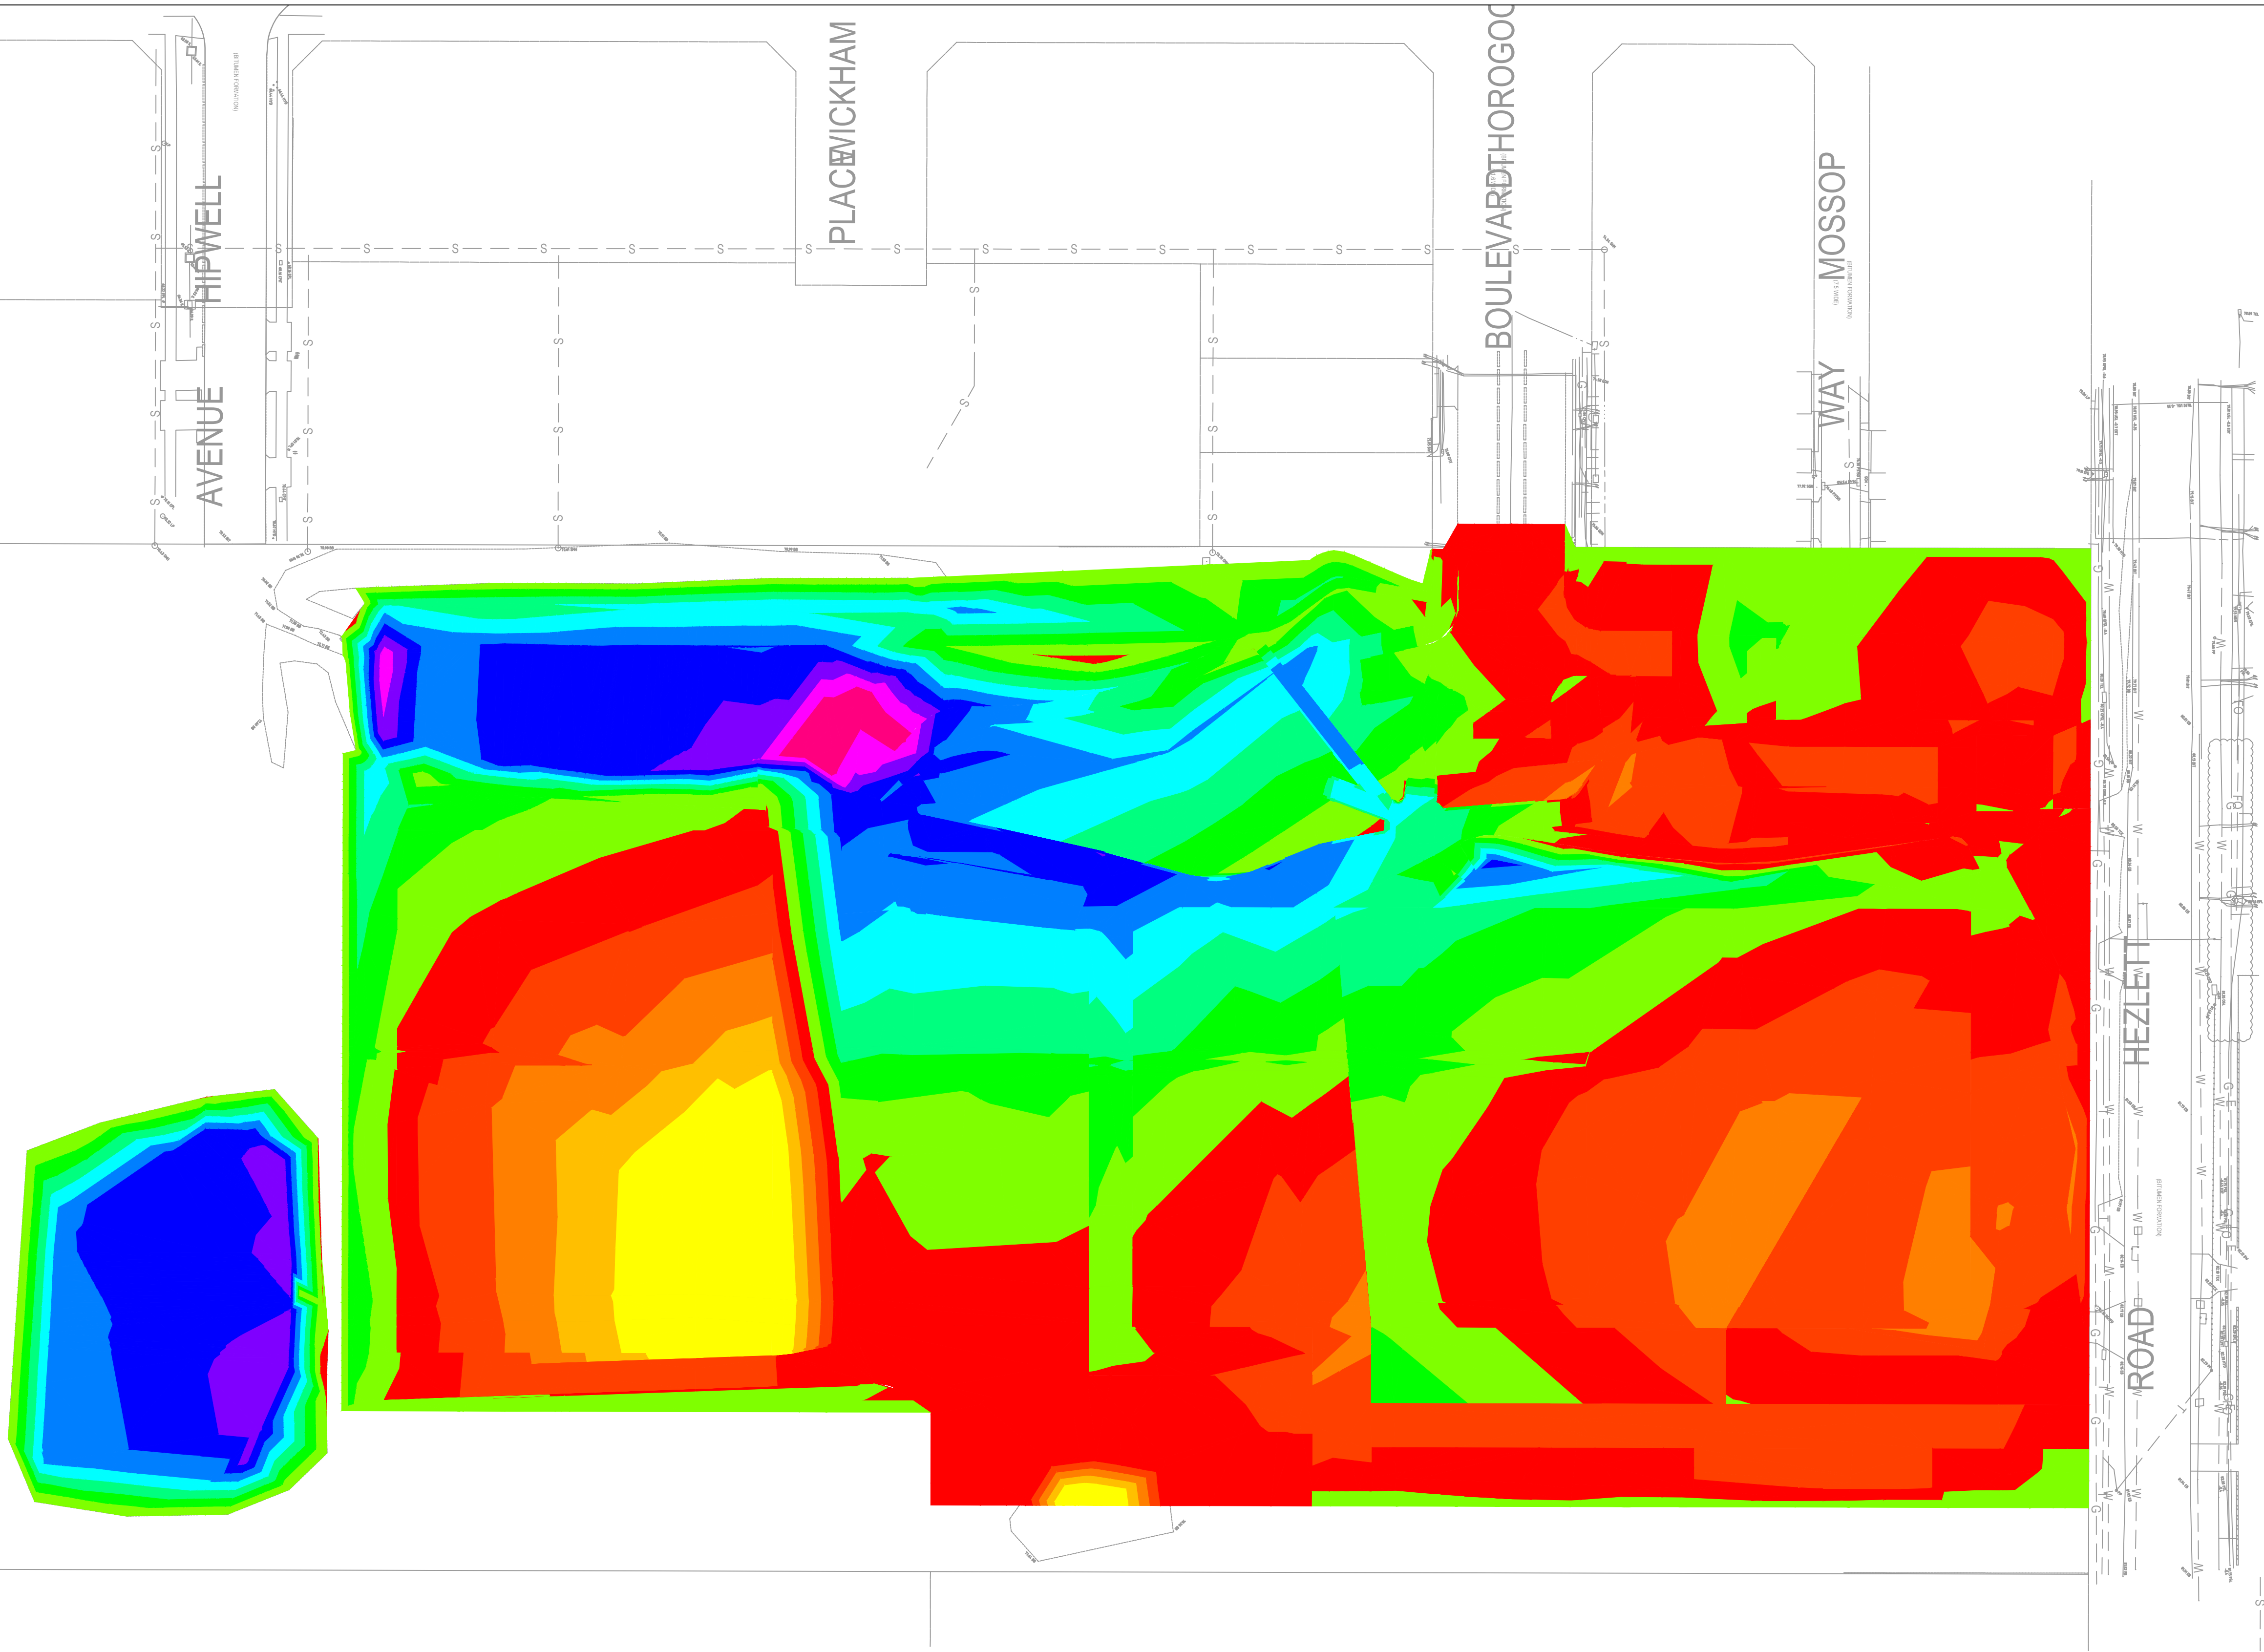APPROX. EARTHWORKS VOLUMES
CUT 10496m³ (Includes 2929m³ of 100mm Stripping Layer)
FILL 19309m³ (Includes 4590m³ to Fill South-western dam)
NET 8813m³ Fill required


NOTES:

- CUT AND FILL VOLUMES ARE INDICATIVE ONLY WITH FINAL DESIGN LEVELS YET TO BE CONFIRMED.
- CUT AND FILL VOLUMES DOES NOT ACCOUNT FOR CLEARING AND GRUBBING VOLUMES.
- CUT AND FILL VOLUMES ARE BASED ON AN AERIAL SURVEY.
- CUT AND FILL VOLUMES DOES NOT CONSIDER ANY GEOTECHNICAL REQUIREMENTS OF SOIL AT THIS STAGE.
- EARTHWORK LEVELS ARE GENERALLY LOWER THAN FINISHED LEVELS TO ALLOW FOR FINISHED SURFACE TREATMENTS. THE DIFFERENCE BETWEEN FINISHED SURFACE LEVELS AND EARTHWORKS LEVELS ARE APPROXIMATELY:
BUILDING SLAB = 350mm
CONCRETE FOOTPATH = 175mm
PAVER TYPE 1 (NON-TRAFFICABLE) = 190mm
PAVER TYPE 2 (TRAFFICABLE) = 350mm
COMPACTED TOPPING = 150mm
ROAD PAVEMENT = 340mm
SPORTSFIELD TURF = 200mm

NORTH KELLYVILLE - EARTHWORKS PLAN
SCALE 1:500

DEVELOPMENT APPLICATION

						 SCALE 1:500 AT ORIGINAL SIZE				 NSW GOVERNMENT		 TSA MANAGEMENT		 Education		 GHDWOODHEAD		Level 15, 133 Castlereagh Street, Sydney NSW 2000 Australia T 61 2 9239 7100 F 61 2 9239 7199 E sydmall@ghd.com W www.ghd.com		DO NOT SCALE		Drawn M.RANGWALA Designer G.DE SWARDT		Client NSW DEPARTMENT OF EDUCATION	
D ISSUED FOR DEVELOPMENT APPLICATION						MR		CS*		SM*		29.08.17						Drafting Check A.MACLEAN*		Design Check A.RAHMAN*		Project NORTH KELLYVILLE PUBLIC SCHOOL			
C ISSUED FOR SSD SUBMISSION						MR		CS*		SM*		09.08.17						Approved (Project Director)				Title CIVIL			
B ISSUED FOR TENDER						MR		CS*		SM*		28.06.17						Date				Original Size EARTHWORKS PLAN			
A ISSUED FOR SSD DEVELOPMENT APPLICATION						MR		CS*		SM*		14.06.17										Drawing No: 2126108-NK-SD-CI-1030			
No Revision Note: * indicates signatures on original issue of drawing or last revision of drawing						Drawn		Job Manager		Project Director		Date						Scale 1:500		This Drawing must not be used for Construction unless signed as Approved		Rev: D			

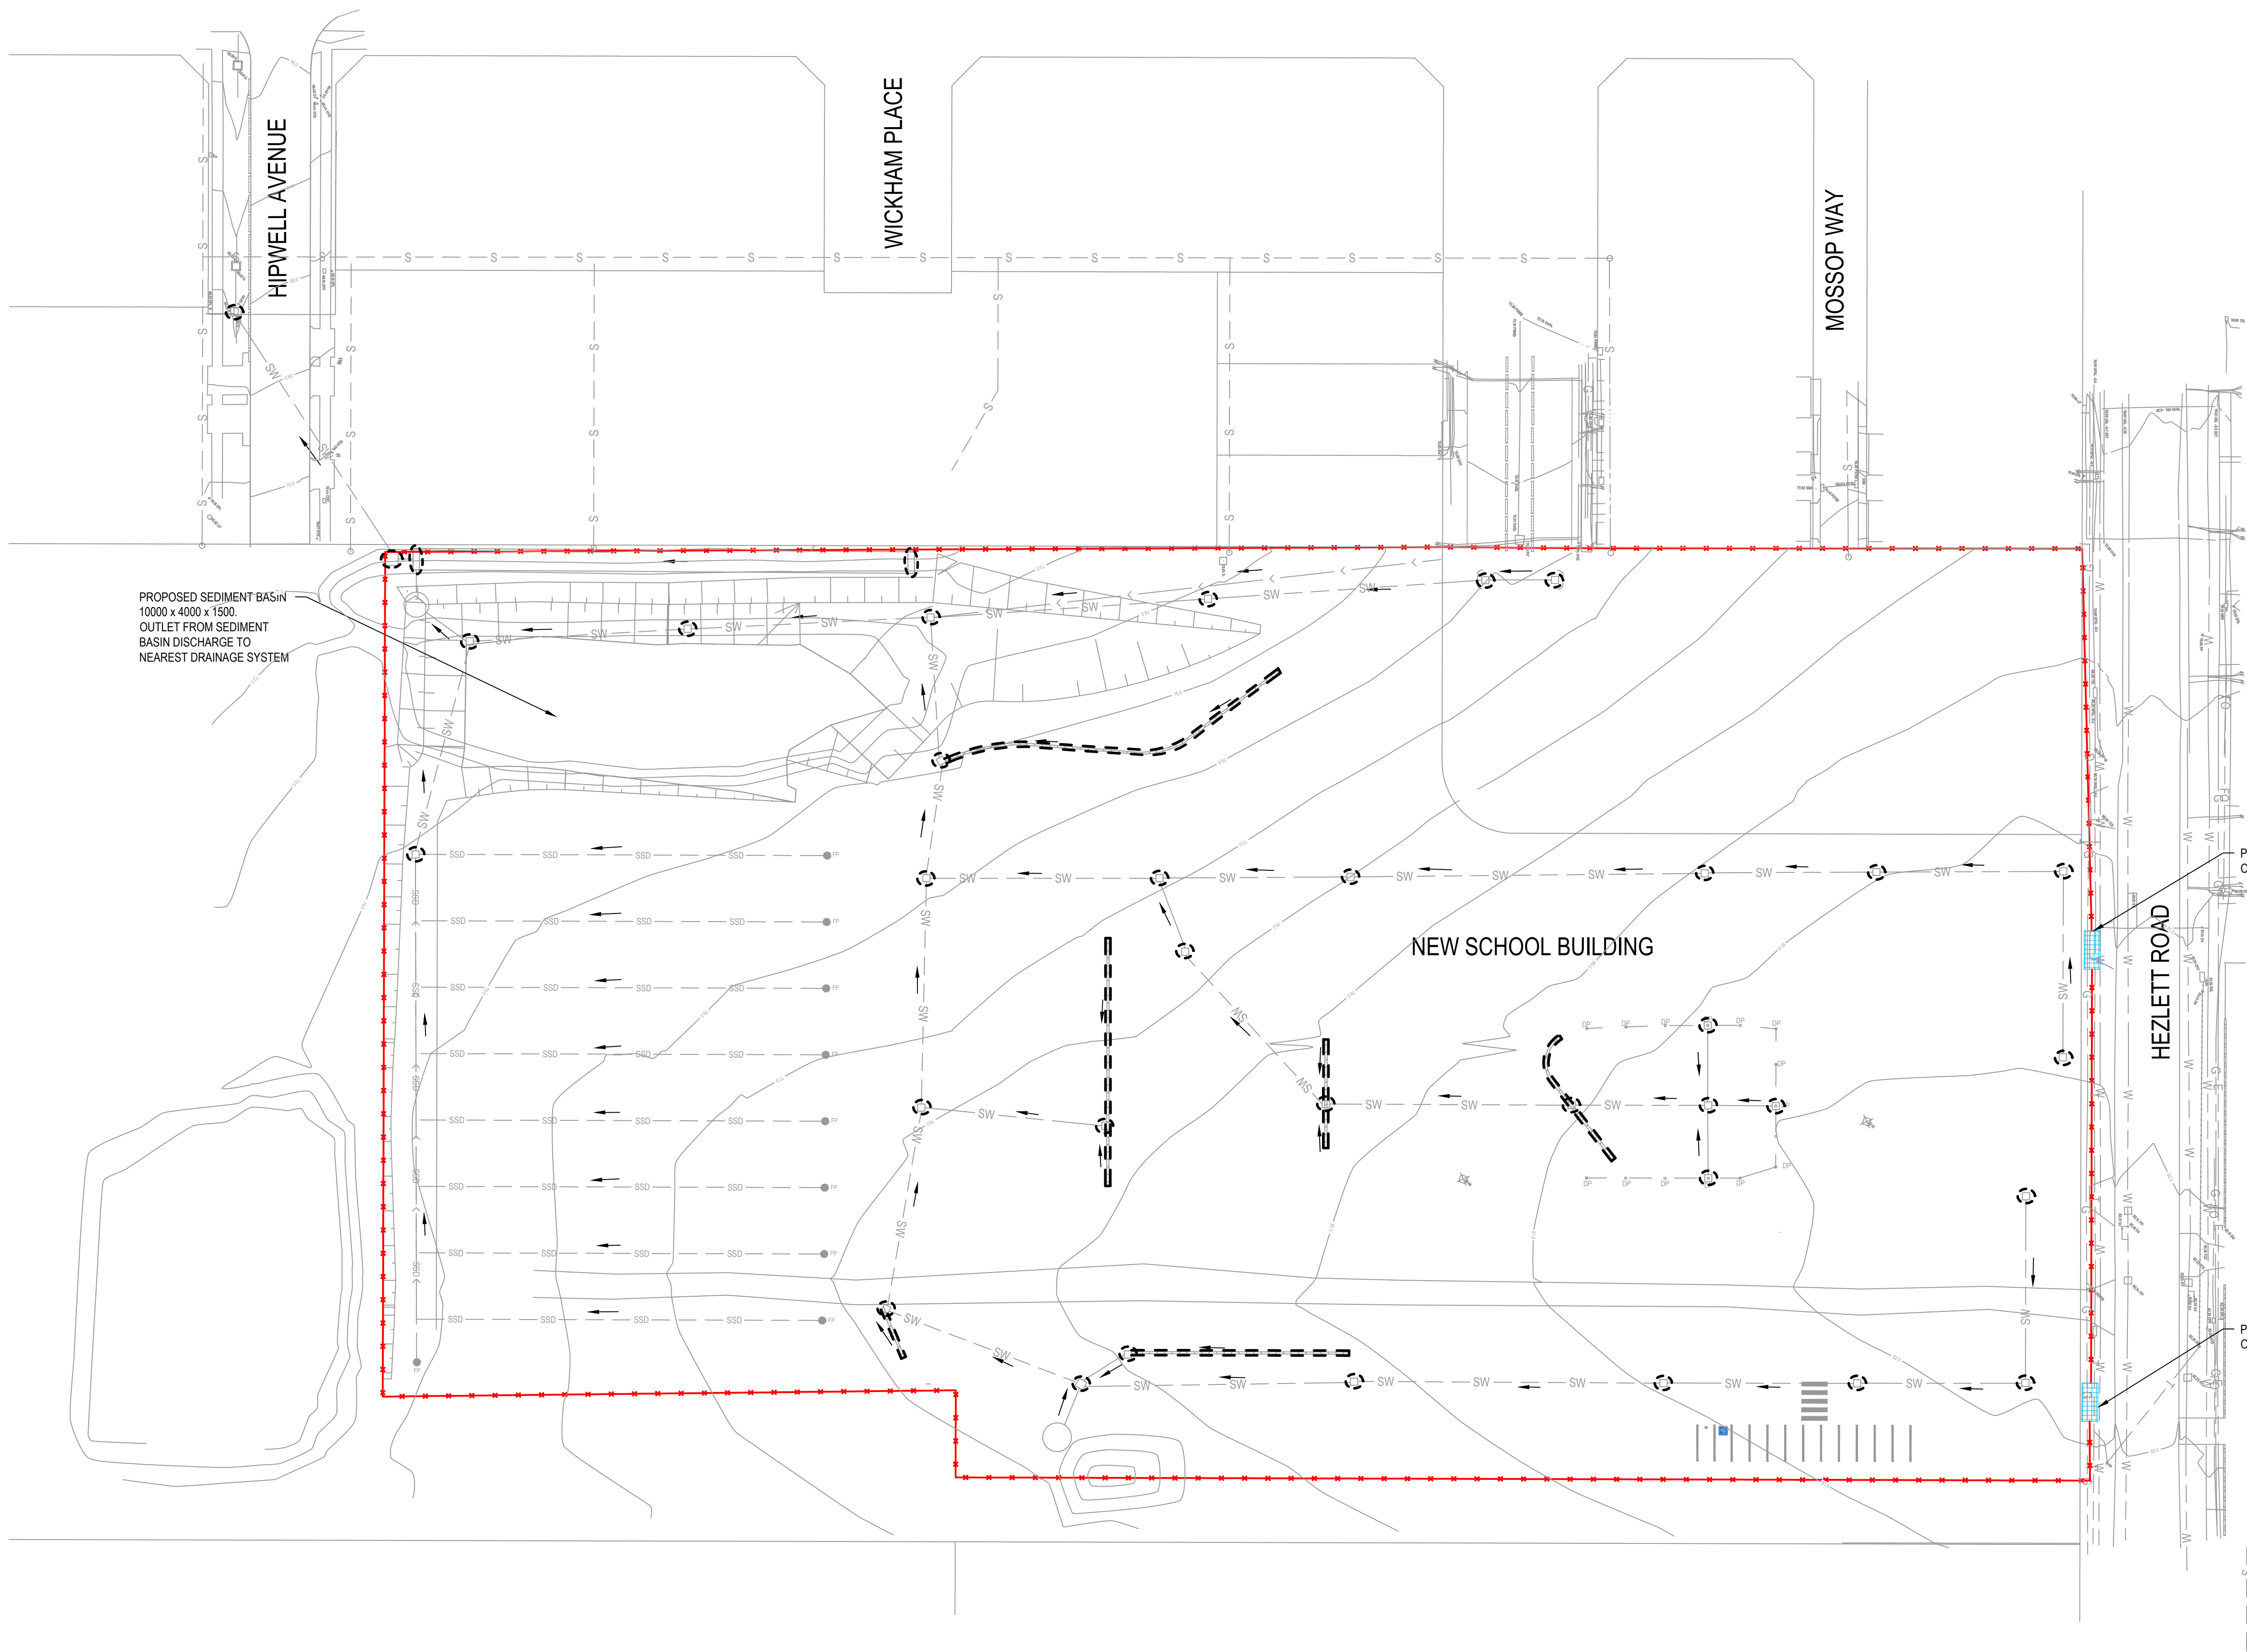

LEGEND:

- PROPOSED SEDIMENT FENCE
- PROPOSED GEOTEXTILE FILTER
- SHAKER GRID (TEMP ACCESS)

NOTES:

- ALL WORKS SHALL BE GENERALLY CARRIED OUT IN ACCORDANCE WITH:
(A) EPA - POLLUTION CONTROL MANUAL FOR URBAN STORMWATER.
(B) DEPARTMENT OF CONSERVATION AND LAND MANAGEMENT MANUAL - "URBAN EROSION & SEDIMENT CONTROL".
(C) SOIL AND CONSTRUCTION VOLUME 1, 4TH EDITION, MARCH 2004 - LANDCOM
- MAINTAIN ALL EROSION AND SEDIMENT CONTROL DEVICES TO THE SATISFACTION OF THE PRINCIPAL'S REPRESENTATIVE.
- MINIMISE THE AREA OF SITE BEING DISTURBED AT ANY ONE TIME.
- PROTECT ALL STOCKPILES OF MATERIALS FROM SCOUR AND EROSION. DO NOT STOCKPILE LOOSE MATERIAL IN ROADWAYS, NEAR DRAINAGE PITS OR IN WATERCOURSES.
- ALL SOIL AND WATER CONTROL MEASURES ARE TO BE PUT BACK IN PLACE AT THE END OF EACH WORKING DAY, AND MODIFIED TO BEST SUIT SITE CONDITIONS.
- CONTROL WATER FROM UPSTREAM OF THE SITE SUCH THAT IT DOES NOT ENTER THE DISTURBED SITE.
- ALL CONSTRUCTION VEHICLES SHALL ENTER & EXIT THE SITE VIA THE APPROVED CONSTRUCTION ENTRY/EXIT ROUTE.
- ALL VEHICLES LEAVING THE SITE SHALL BE CLEANED & INSPECTED BEFORE LEAVING.
- MAINTAIN ALL STORMWATER PIPES CLEAR OF DEBRIS & SEDIMENT. INSPECT STORMWATER SYSTEM & CLEAN OUT AFTER EACH STORM EVENT.
- CLEAN OUT ALL EROSION & SEDIMENT CONTROL DEVICES AFTER EACH STORM EVENT.
- SEDIMENT AND EROSION CONTROL PLAN IS INDICATIVE ONLY.
- STORMWATER ON THIS DRAWING IS INDICATIVE ONLY. ALL NEW STORMWATER PITS TO BE SURROUNDED BY GEOTEXTILE INLET FILTER.

KELLYVILLE NORTH - EROSION AND SEDIMENT CONTROL PLAN



SCALE 1:500

DEVELOPMENT APPLICATION

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No	Revision	Note: * indicates signatures on original issue of drawing or last revision of drawing	Drawn	Job Manager	Project Director	Date

Plot Date: 29 August 2017 - 5:51 PM Plotted by: Mona Rangwala

Cad File No: G:\21\26108\6. Kellyville North PS\03 Civil\CADD\Drawings\DA A ISSUED\21-26108-KN-DA-CI-1035.dwg

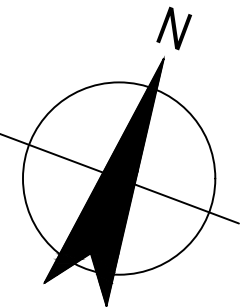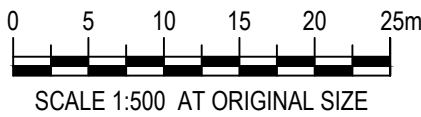

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Drafting Check	A.MACLEAN*	Design Check	A.RAHMAN*
Approved (Project Director)	Date		
Scale	1:500	This Drawing must not be used for Construction unless signed as Approved	

Client	NSW DEPARTMENT OF EDUCATION		
Project	NORTH KELLYVILLE PUBLIC SCHOOL		
Title	CIVIL EROSION AND SEDIMENT CONTROL PLAN		
Original Size	A1	Drawing No:	2126108-NK-SD-CI-1035 Rev: D

SEDIMENT FENCE PLAN
NTS

SEDIMENT FENCE SECTION
NTS

SEDIMENT FENCE
NTS

SILT FENCE CONSTRUCTION NOTES

1. CONSTRUCT SEDIMENT FENCE AS CLOSE AS POSSIBLE TO PARALLEL TO THE CONTOURS OF THE SITE.
2. DRIVE 1.5m LONG STAR PICKETS INTO GROUND, 3m APART.
3. DIG A 150mm DEEP TRENCH ALONG THE UPSLOPE LINE OF THE FENCE FOR THE BOTTOM OF THE FABRIC TO BE TRENCH.
4. BACKFILL TRENCH OVER BASE OF FABRIC.
5. FIX SELF-SUPPORTING GEOTEXTILE TO UPSLOPE SIDE OF POST WITH WIRE TIES OR AS RECOMMENDED BY GEOTEXTILE MANUFACTURER. JOIN SECTIONS OF FABRIC AT A SUPPORT POST WITH A 150mm OVERLAP.

GEOTEXTILE INLET FILTERS

GEOTEXTILE INLET FILTERS SECTION
NTS

GEOTEXTILE INLET FILTER PLAN
NTS

CONSTRUCTION NOTES

1. FABRICATE A SEDIMENT BARRIER MADE FROM GEOTEXTILE OR STRAW BALES.
2. SUPPORT GEOTEXTILE WITH MESH TIED TO POST AT 1m CENTRES
3. DO NOT COVER INLET WITH GEOTEXTILE.

KERB INLET FILTERS
NTS

HAY BALE AND GEOTEXTILE SEDIMENT FILTER

NOTE:
ONLY TO BE USED AS TEMPORARY BANK WHERE MAXIMUM
UPSLOPE LENGTH IS 80 METRES.

EARTH BANK (LOW FLOW)
NTS

EARTH BANK (LOW FLOW) CONSTRUCTION SEQUENCE

1. CONSTRUCT WITH GRADIENT OF 1% TO 5%.
2. AVOID REMOVING TREES AND SHRUBS IF POSSIBLE.
3. DRAINS TO BE OF CIRCULAR, PARABOLIC OR TRAPEZOIDAL CROSS SECTION NOT V-SHAPED.
4. EARTH BANKS TO BE ADEQUATELY COMPACTED IN ORDER TO PREVENT FAILURE.
5. PERMANENT OR TEMPORARY STABILISATION OF THE EARTH BANK TO BE COMPLETED WITHIN 10 DAYS OF CONSTRUCTION.
6. ALL OUTLETS FROM DISTURBED LANDS ARE TO BE FEED INTO A SEDIMENT BASIN OR SIMILAR.
7. DISCHARGE RUNOFF COLLECTED FROM UNDISTURBED LANDS ONTO EITHER A STABILISED OR AN UNDISTURBED DISPOSAL SITE WITHIN THE SAME SUBCATCHMENT AREA FROM WHICH THE WATER ORIGINATED.
8. COMPACTED BANK WITH A SUITABLE IMPLEMENT IN SITUATIONS WHERE THEY ARE REQUIRED TO FUNCTION FOR MORE THAN FIVE DAYS.
9. EARTH BANKS TO BE FREE OF PROJECTIONS OR OTHER IRREGULARITIES THAT WILL IMPEDE NORMAL FLOW.

GEOTEXTILE FABRIC DESIGNED TO PRE
INTERMIXING OF SUBGRADE AND BASE
MATERIALS AND TO MAINTAIN GOOD
PROPERTIES OF THE SUBBASE LAYERS.

STABILISED SITE ACCESS DETAIL

STABILISED SITE ACCESS CONSTRUCTION NOTES

1. STRIP TOPSOIL AND LEVEL SITE.
2. COMPACT SUBGRADE.
3. COVER AREA WITH NEEDLE - PUNCHED GEOTEXTILE.
4. CONSTRUCT 200mm THICK PAD OVER GEOTEXTILE USING ROAD BASE OR 30mm AGGREGATE. MINIMUM LENGTH 15 METRES OR TO BUILDING ALIGNMENT. MINIMUM WIDTH 3 METRES.
5. CONSTRUCT HUMP IMMEDIATELY WITHIN BOUNDARY TO DIVERT WATER TO A SEDIMENT FENCE OR OTHER SEDIMENT TRAP.

A cross-sectional diagram of a stockpile. On the left, a horizontal line with an arrow pointing right is labeled "FLOW". To the right of the flow is a small mound labeled "EARTH BANK". Further right is a large, trapezoidal mound labeled "STOCKPILE" with "NTS" (Not To Scale) below it. The top surface of the stockpile is stippled and labeled "STABILISE STOCKPILE SURFACE". The left slope of the stockpile is labeled "2:1 SLOPE (MAX)" and the right slope is also labeled "2:1 SLOPE (MAX)". To the right of the stockpile is a vertical line labeled "SEDIMENT FENCE". To the right of the fence is a tree.

STOCKPILE CONSTRUCTION

1. LOCATE STOCKPILE AT LEAST 5 METRES FROM EXISTING VEGETATION, CONCENTRATED WATER FLOWS, ROADS AND HAZARD AREAS.
2. CONSTRUCT ON THE CONTOUR AS A LOW, FAT, ELONGATED MOUND.
3. WHERE THERE IS SUFFICIENT AREA TOPSOIL STOCKPILES SHALL BE LESS THAN 2 METRES IN HEIGHT.
4. REHABILITATE IN ACCORDANCE WITH THE CONSTRUCTION ENVIRONMENT MANAGEMENT PLAN. CONSTRUCT EARTH BANK (STANDARD DRAWING 5-5) ON THE UPSLOPE SIDE TO DIVERT RUN OFF AROUND THE STOCKPILE AND A SEDIMENT FENCE (STANDARD DRAWING 6-8) 1 TO 2 METRES DOWNSLOPE OF STOCKPILE.

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