583 Darling Street, Rozelle NSW 2039 Telephone: 9555 7230 Facsimile: 9555 7239 Email: office@birzulisassociates.com

19 October 2017

Principal Certifying Authority c/- DesignInc Pty Ltd Attention Mr Robert Godfrey Level 12, 77 Pacific Highway NORTH SYDNEY 2060

ACN 003 797 911 ABN 99 003 797 911

Dear Sir,

RE: REPORT ON EXISTING DRAINAGE INFRASTRUCTURE AT 100 ETON ROAD, LINDFIELD

A walk over of the abovementioned building was carried out by this office on 04 July 2016. The object of our inspection was to carry out a visual inspection of the existing site drainage.

The inspection was visual only and we did not lift any pits or send any cameras to investigate the condition of the pipes. Based on our visual inspection, the existing infrastructure appears sound. At the time of the inspection several pits had accumulated leaves and other debris, this may have been flushed through the drainage system during the next rain event however the cause of the accumulation is likely due to the site not being occupied and consequently maintenance has not been carried out at regularly intervals.

There are no new buildings being proposed during the new works. The proposed development alters the internal space of the building and adds a number of COLA structures above the existing concrete roof of the building in zones 'D', 'K', and 'M' as shown in the Architectural drawings. A new ground COLA structure is also being added in zone 'N'/'R'. Several new downpipes are introduced around the structure in order to capture rainwater from the new COLA structures without introducing additional loads to the existing downpipes of the building. Other than the ground COLA structure in zone 'N'/'R', the new COLA structures in zones 'D', 'K', and 'M' do not increase the catchment area of the building. It is therefore proposed to keep the current drainage infrastructure in place with a recommendation as part of the main contracts works to carry out thorough maintenance of all pits and to carry out a photographic investigation of the main stormwater lines. In our opinion the proposed development will not increase the loads on the existing stormwater infrastructure.

In order to mitigate any additional loads from the 'GROUND COLA' into the existing stormwater infrastructure, the proposed development includes the addition of 4 x 1100L (4400L) rainwater tanks which will capture the rainwater from the 'GROUND COLA' structure (65sqm) and reuse the harvested rainwater for irrigation purposes - please refer to Hydraulic Engineer's drawings for details.

The aim of the policy document "Guidelines for developing adjoining land and water managed by DECCW" clause 2.2 Stormwater Runoff is "Nutrient levels are minimised, and stormwater flow regimes and patterns mimic natural levels before it reaches OEH land". We believe that the discharge from our site to DECWW land remains as per the status quo and no further action is required to meet this policy.

We also believe that the above also addresses the requirements of the SEARS report for water sensitive urban design (WSUD), since the existing stormwater drainage is not being altered thus the introduction of WSUD into the existing infrastructure should not be required.


We trust that this is acceptable for your purposes at this stage but should you require any further information or clarification please do not hesitate to contact the undersigned.

Yours faithfully

MICHAEL GROGAN

Director

Attachment: CI-2001_2, CI-2002_2, CI-2003_2, CI-2004_2, CI-2005_2, CI-2006_2

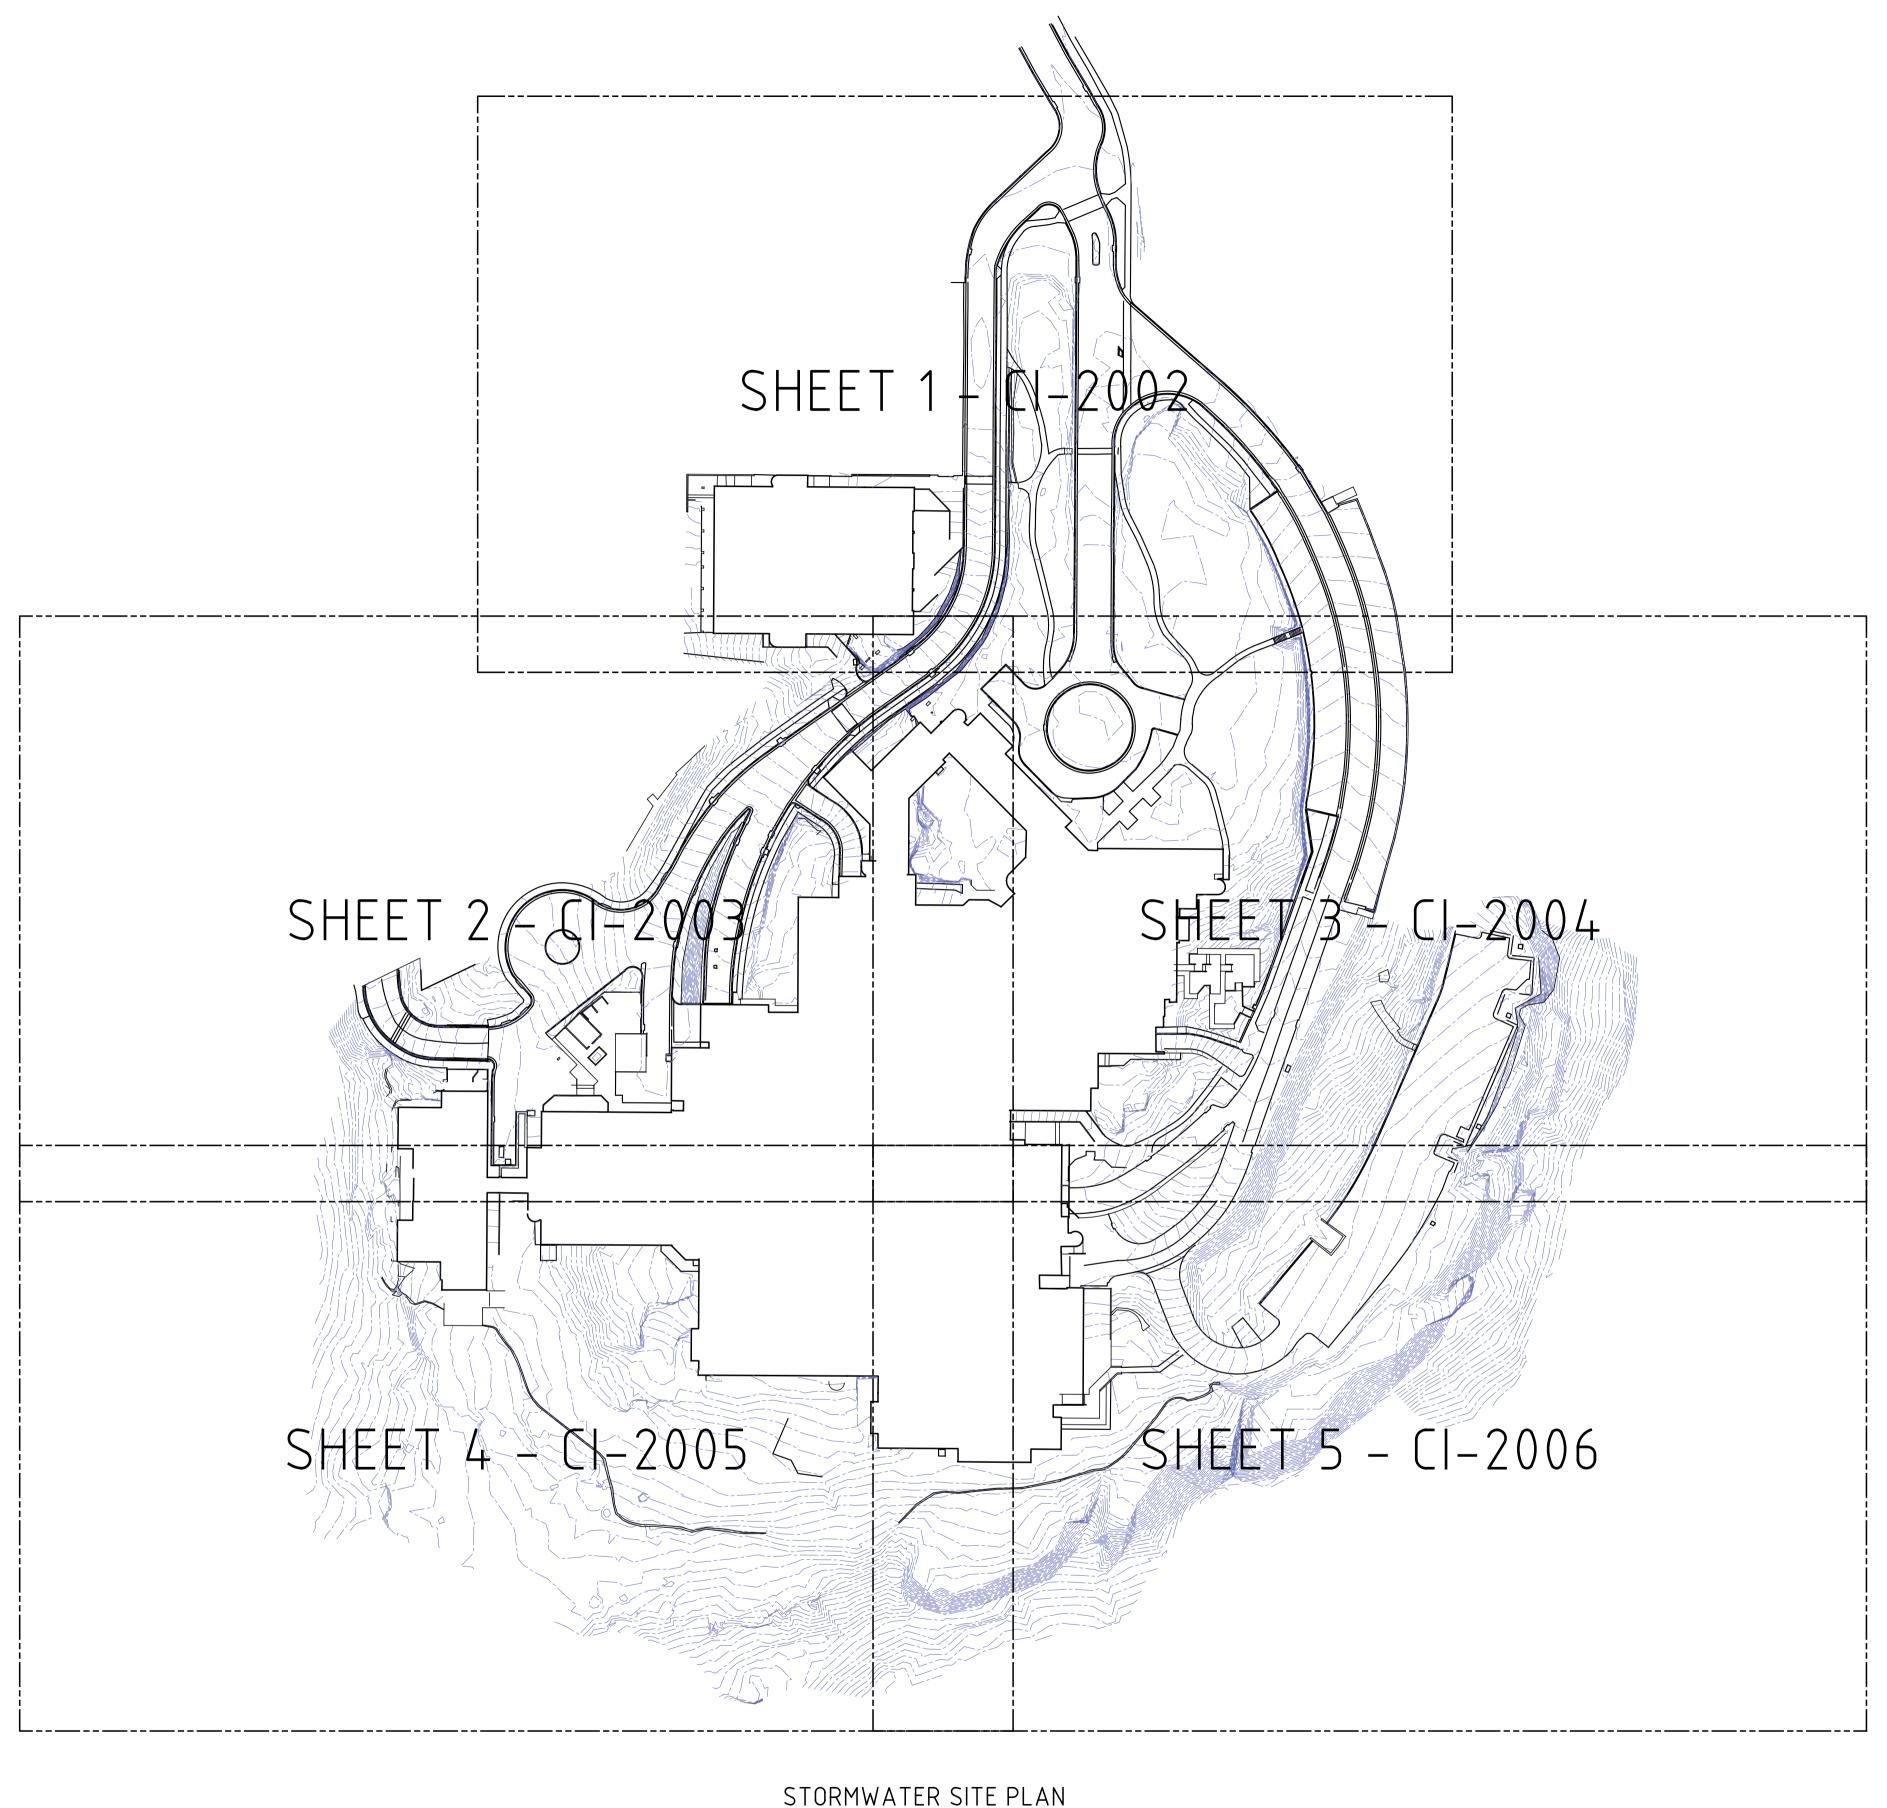


ABBREVIATIONS DIAMETER CALIFORNIA BEARING RATIO CHAINAGE CENTRE LINE CLEANING EYE/INSPECTION OUTLET CLEAR OUT DISH CROSSING DE J DISH DRAIN OUTLET DOWELLED EXPANSION JOINT DENSE GRADED BASECOURSE DENSE GRADED SUB-BASE DGB DGS DP DOWNPIPE EXISTING FINISHED FLOOR LEVEL GRATED TRENCH DRAIN GRATED SURFACE INLET PIT HYDRANT ISOLATING JOINT INTEGRAL KERB INVERT LEVEL INTERSECTION POINT KERB INLET PIT KERB ONLY K&G KERB & GUTTER KR KERB RETURN LONGITUDINAL SECTION NATURAL GROUND LEVEL OVERLAND FLOW PATH OFP ON-SITE DETENTION OSD RADIUS REINFORCED CONCRETE PIPE ROLL KERB & GUTTER REDUCED LEVEL RETAINING WALL RAINWATER TANK STRIP DRAIN SAWN CONTROL JOINT SEWER MAN HOLE SUBSOIL DRAINAGE STORMWATER STORMWATER PIT SWP SWRM STORMWATER RISING MAIN STORMWATER SUMP STOP VALVE TOK TOP OF KERB TOW TOP OF WALL TANGENT POINT UNPLASTICISED POLYVINYL CHRLORIDE
UNLESS NOTED OTHERWISE
WEAKENED PLANE JOINT UPVC UNO WPJ

STORMWATER SITE PLAN
SCALE 1:800 (A1), 1:1600 (A3)

PRELIMINARY ISSUE NOT FOR CONSTRUCTION

2	TENDER ISSUE		01-09-17								
1	TENDER ISSUE		08-08-17								
ISSUE	DESCRIPTION	APPROVED	DATE	ISSUE	DESCRIPTION	APPROVED	DATE	ISSUE	DESCRIPTION	APPROVED	DATE

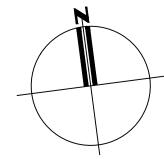

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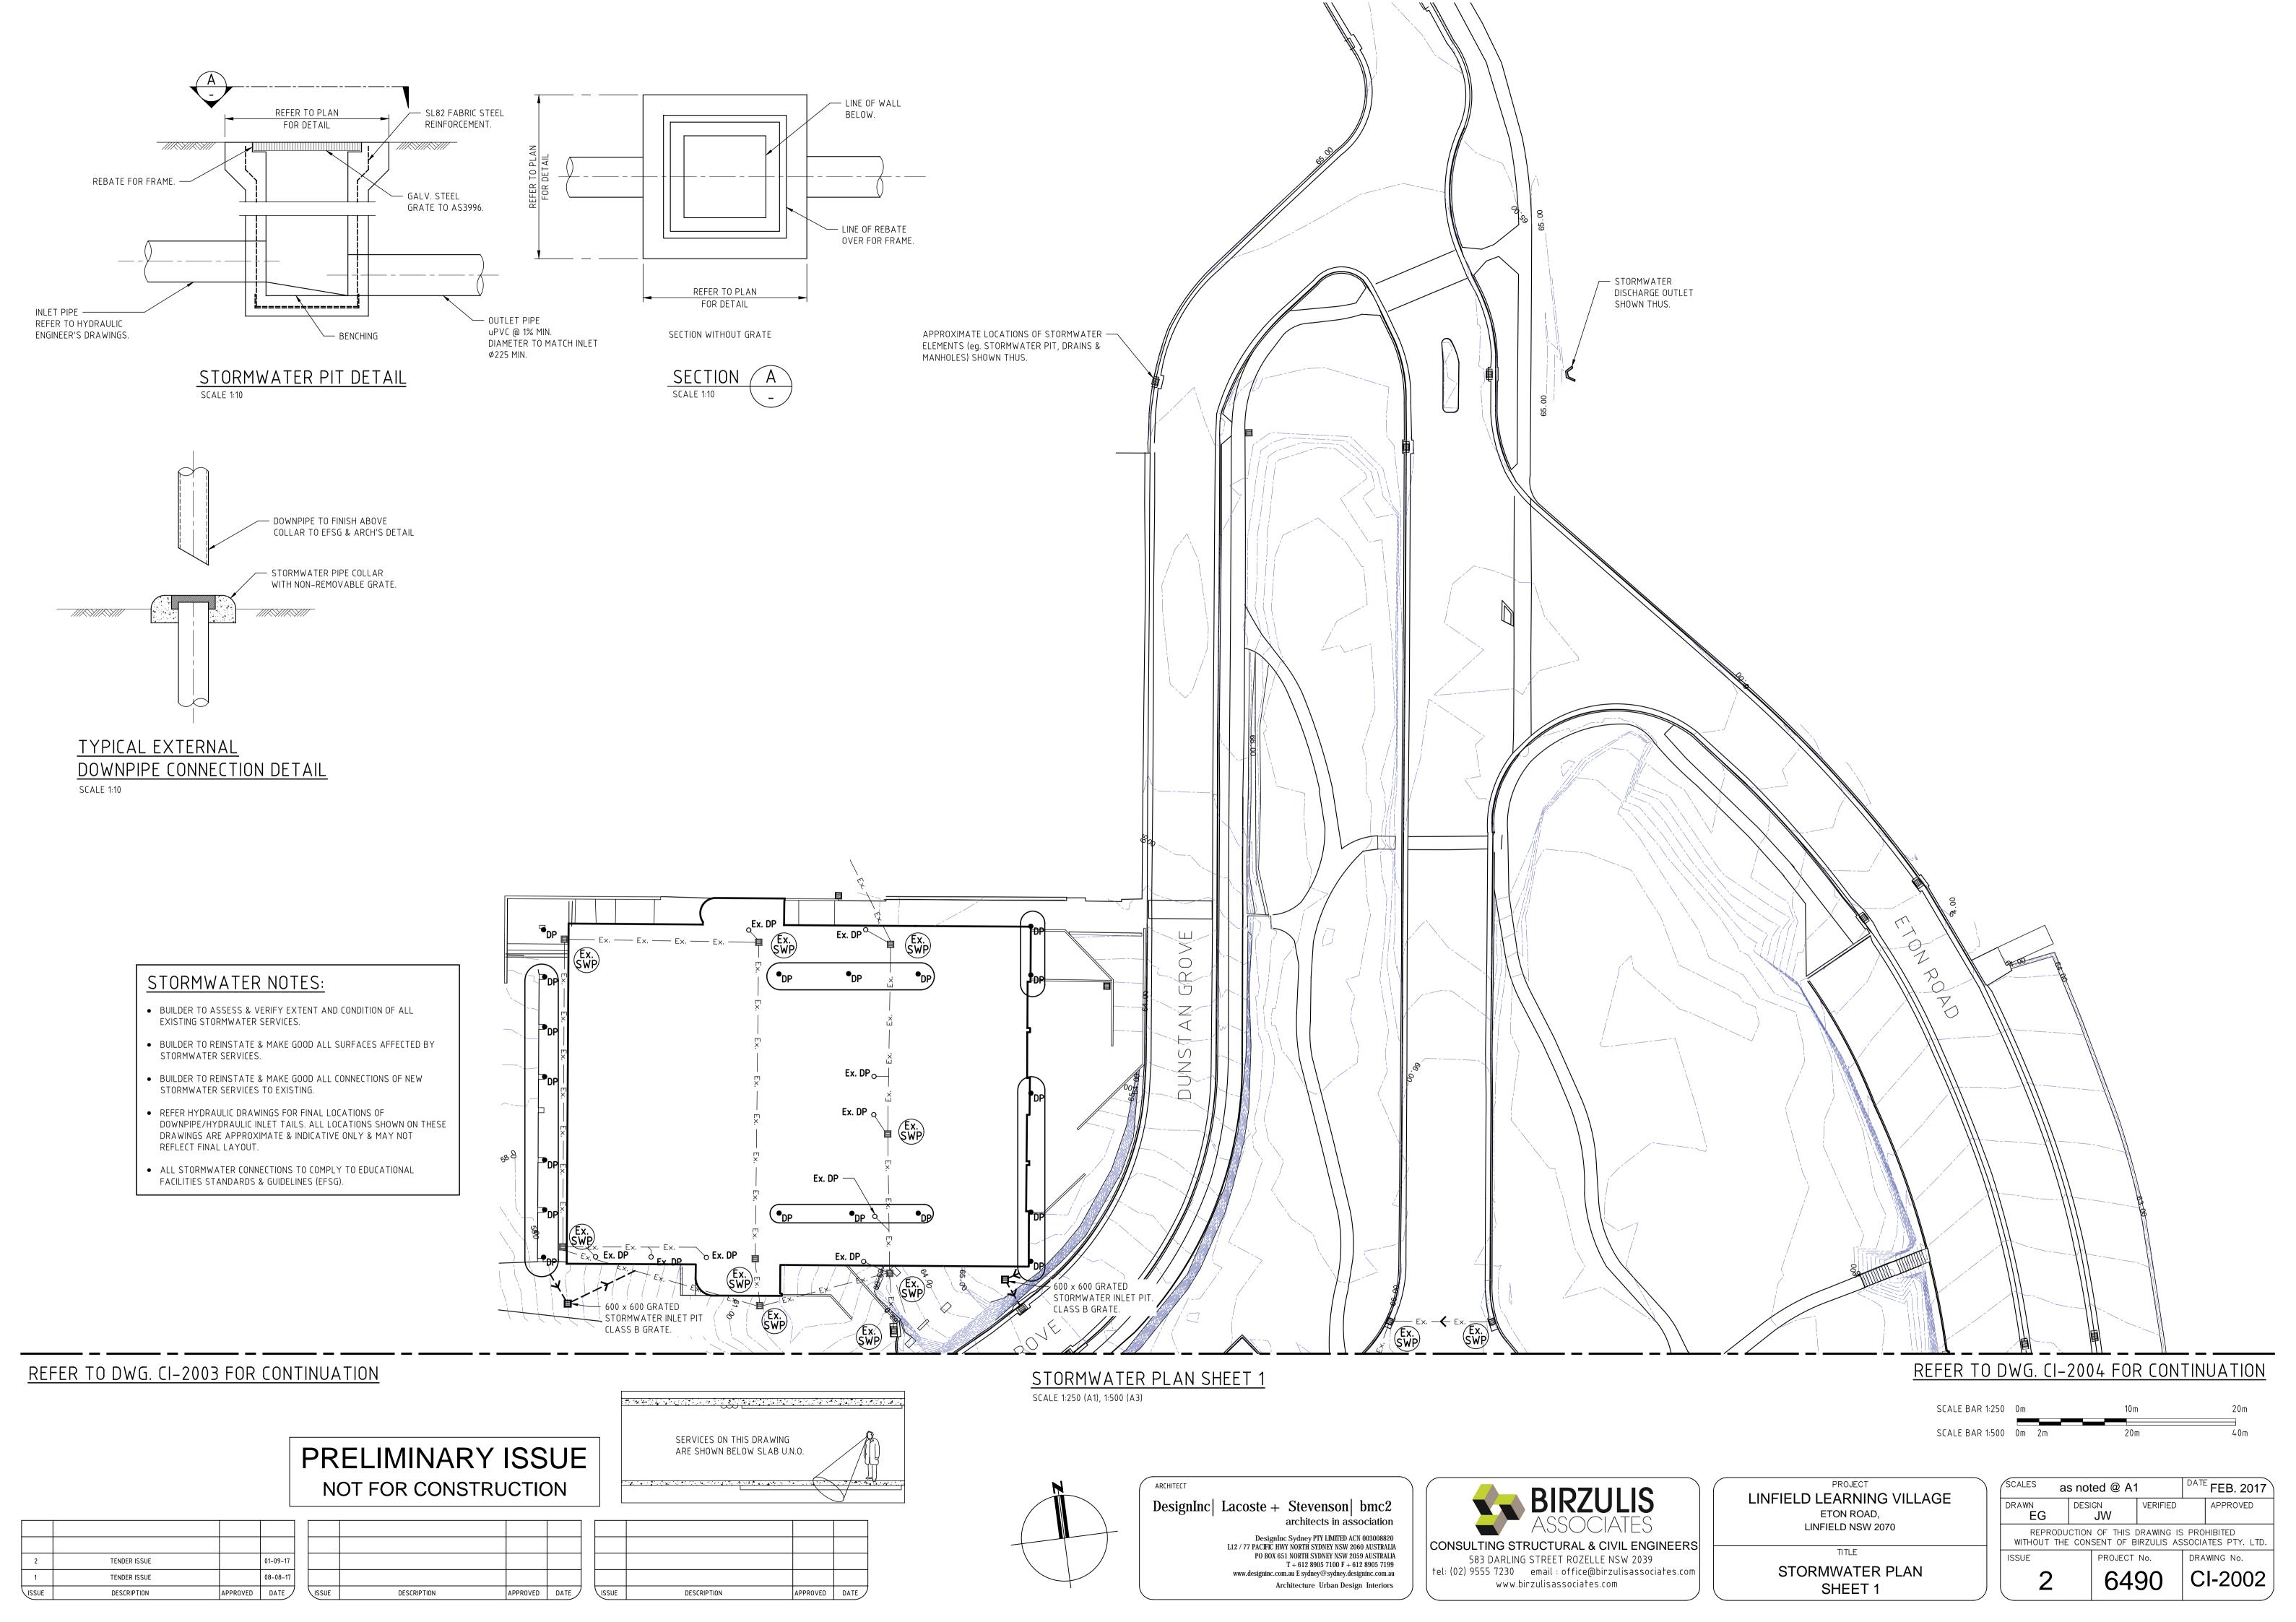
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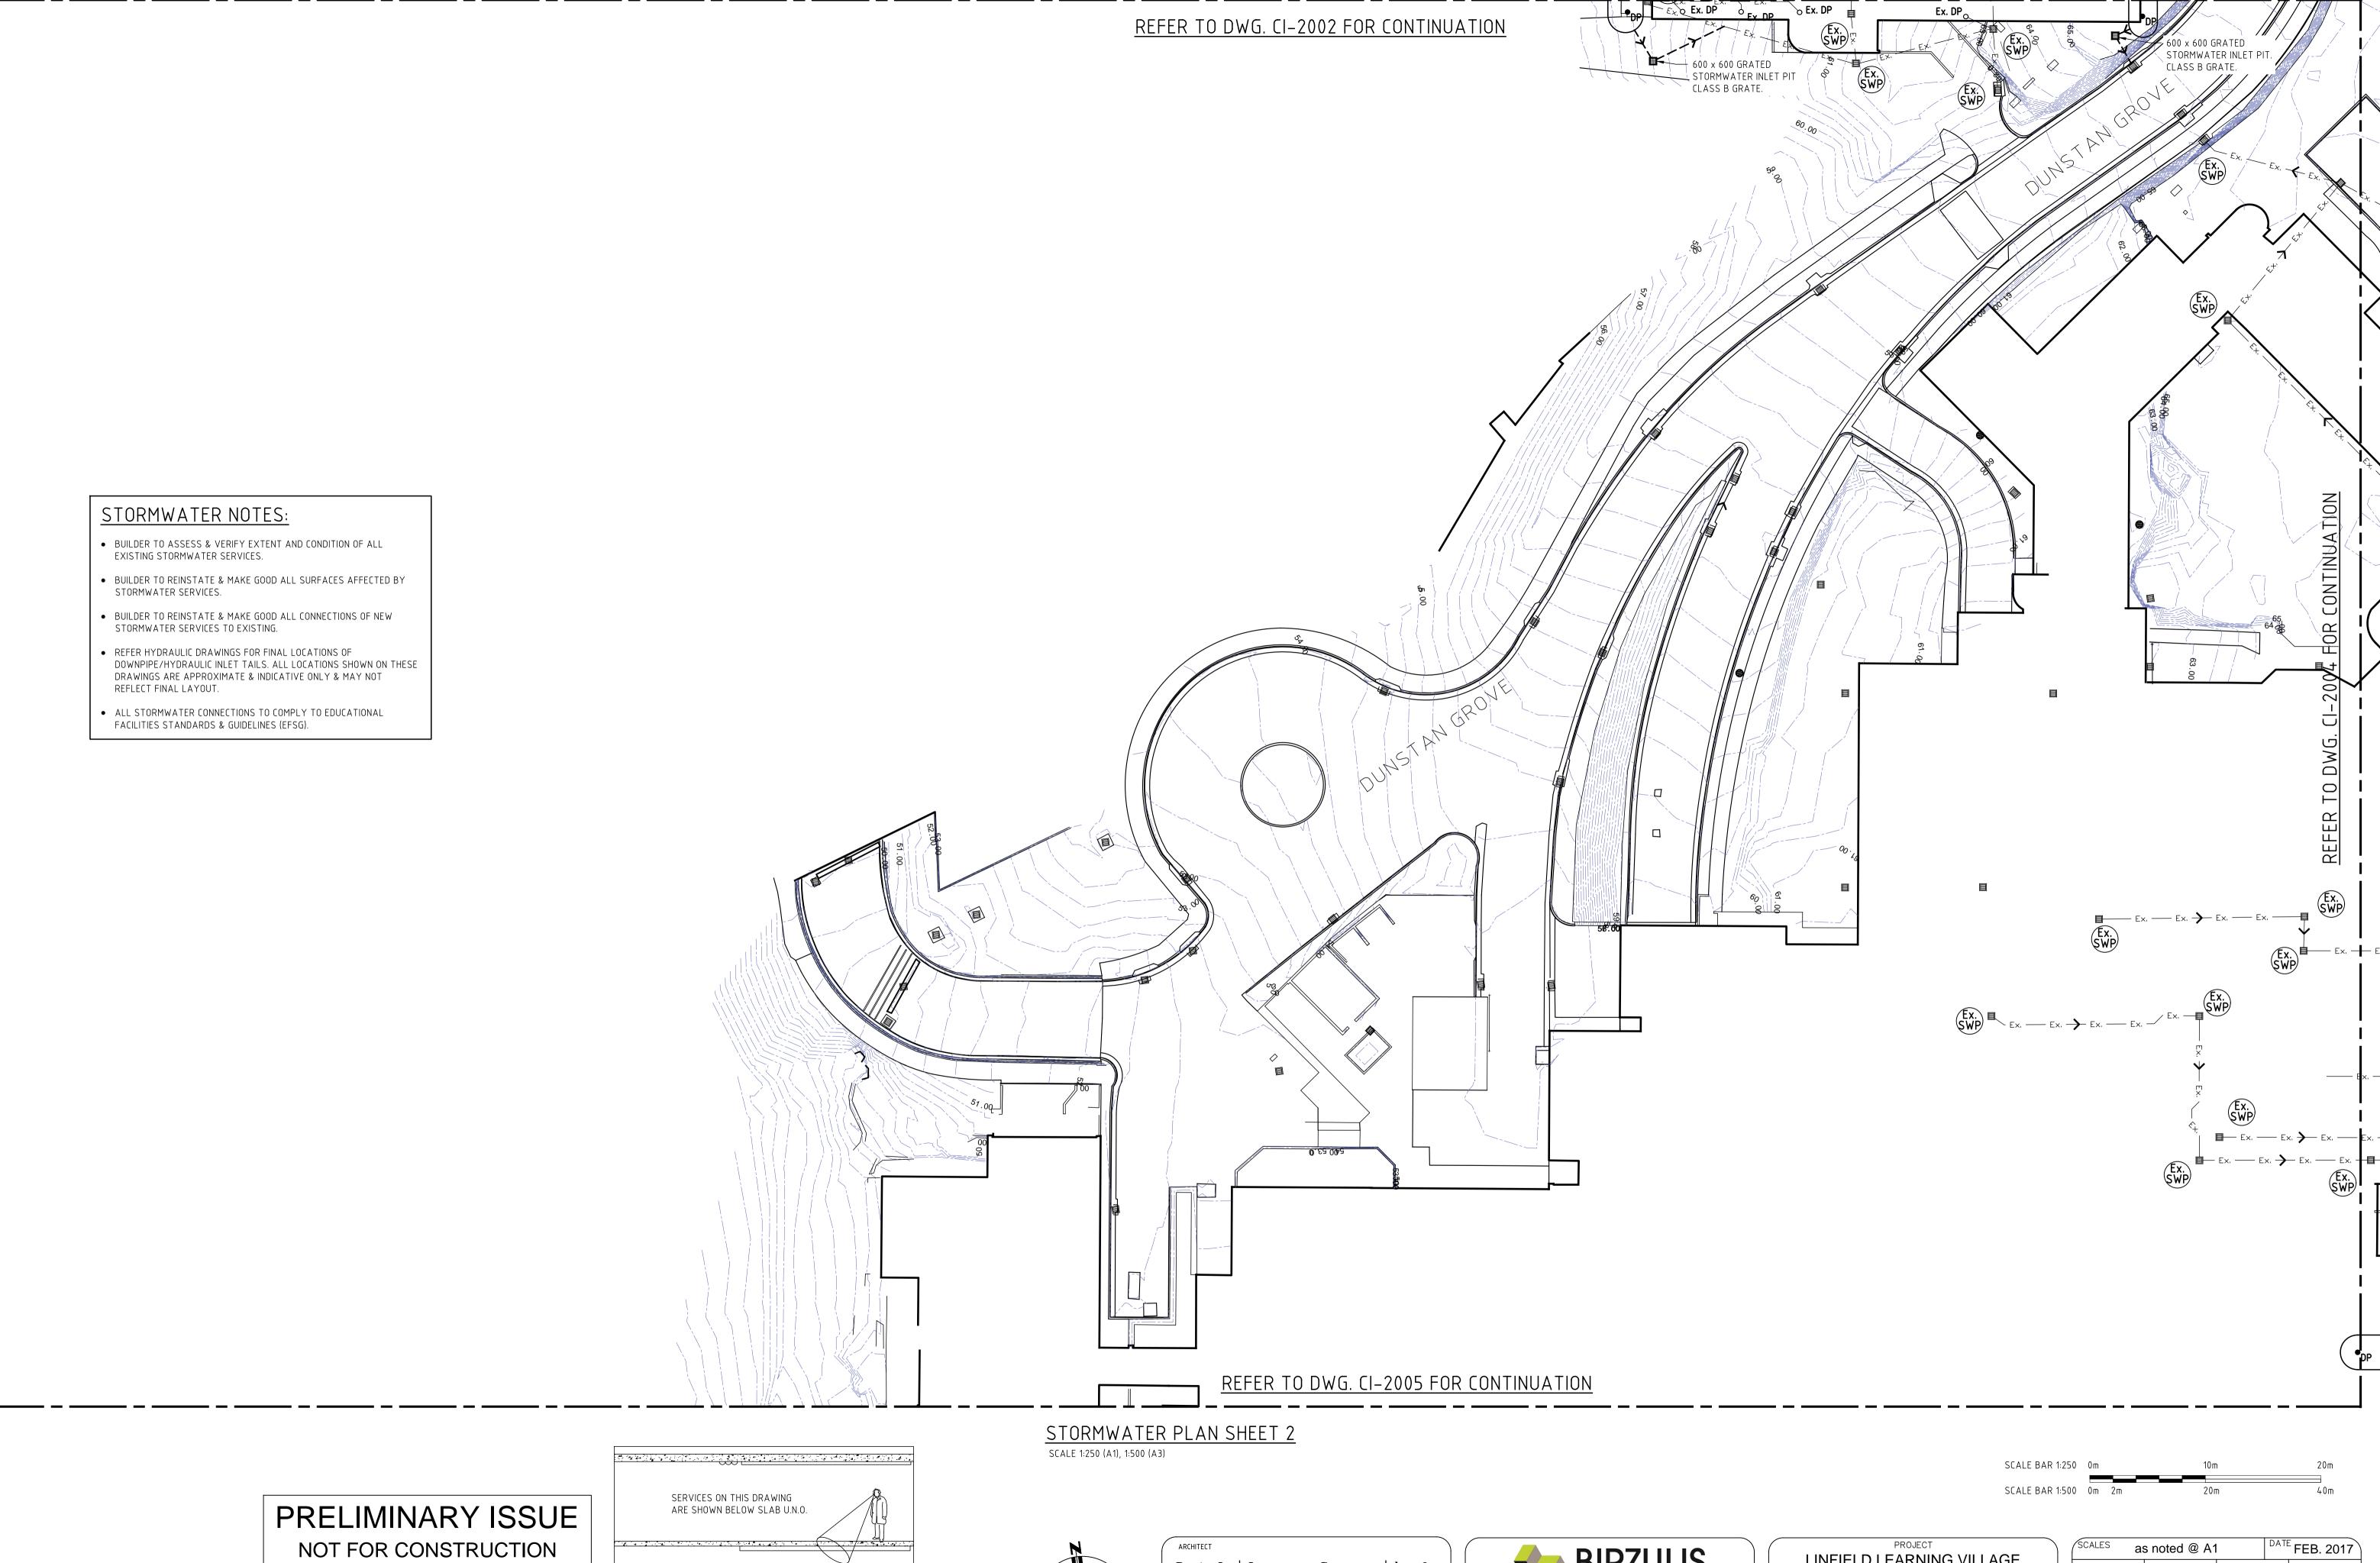



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	LINFIELD LEARNING VILLAGE										
	ETON ROAD,										
	LINFIELD NSW 2070										
	TITLE										
	STORMWATER SITE PLAN										

SCALES as	s not	ted @ A1		FEB. 2017			
DRAWN EG	DESI	GN JW	VERIFIED		APPROVED		
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ISSUE		PROJECT	No.	DRAWING No.			
2	64	90	CI-2001				





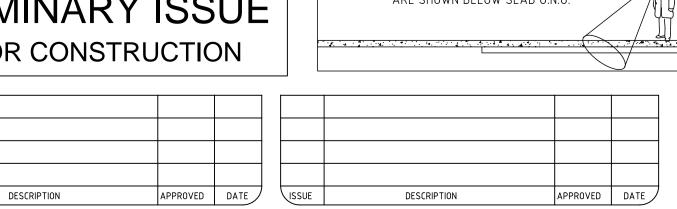


TENDER ISSUE

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APPROVED DATE



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architects in association

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PROJECT	
LINFIELD LEARNING VILLAGE	
ETON ROAD,	
LINFIELD NSW 2070	

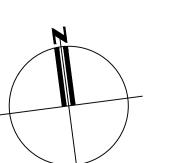STORMWATER PLAN

SHEET 2

١ .	SCALES a	DATE FEB. 2017						
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