
NSW GOVERNMENT Planning
Issued under the Environmental Planning and Assessment Act 1979
Approved Application No SSD 7917
granted on the 4/5/17
SignedTP
Sheet Noof3 I


TWO STAGED SPECULATIVE WAREHOUSE & INDUSTRIAL FACILITY


AT PROPOSED LOT 3 IN LOT 5 DP1212087, BURILDA CLOSE, WETHERILL PARK HORSLEY DRIVE BUSINESS PARK


SP4 - WSPT - DA - 000	Α	TITLE SHEET
SP4 - WSPT - DA - 001	Α	LOCATION PLAN
SP4 - WSPT - DA - 002	Α	SITE ANALYSIS
SP4 - WSPT - DA - 003	Α	SITE PLAN
SP4 - WSPT - DA - 004	Α	TRUCK TURNING DIAGRAMS - SHEET 1
SP4 - WSPT - DA - 005	Α	TRUCK TURNING DIAGRAMS - SHEET 2
SP4 - WSPT - DA - 006	Α	STAGING PLANS
SP4 - WSPT - DA - 100	Α	WAREHOUSE / INDUSTRIAL FACILITY PLAN
SP4 - WSPT - DA - 1,10	K B	OFFICE 01 - FLOOR PLANS
SP4 - WSPT - DA - 111	Α	OFFICE 02 - FLOOR PLANS
SP4 - WSPT - DA - 200	Α	ELEVATIONS
SP4 - WSPT - DA - 210	Α	SECTIONS
SP4 - WSPT - DA - 400	Α	LIGHTING PLAN
SP4 - WSPT - DA - 500	Α	COLOURED ELEVATIONS
SP4 - WSPT - DA - 600	Α	OFFICE 01 - PERSPECTIVE
SP4 - WSPT - DA - 610	Α	OFFICE 02 - PERSPECTIVE
SP4 - WSPT - DA - 620	Α	STREETSCAPE CONTEXT SKETCHES



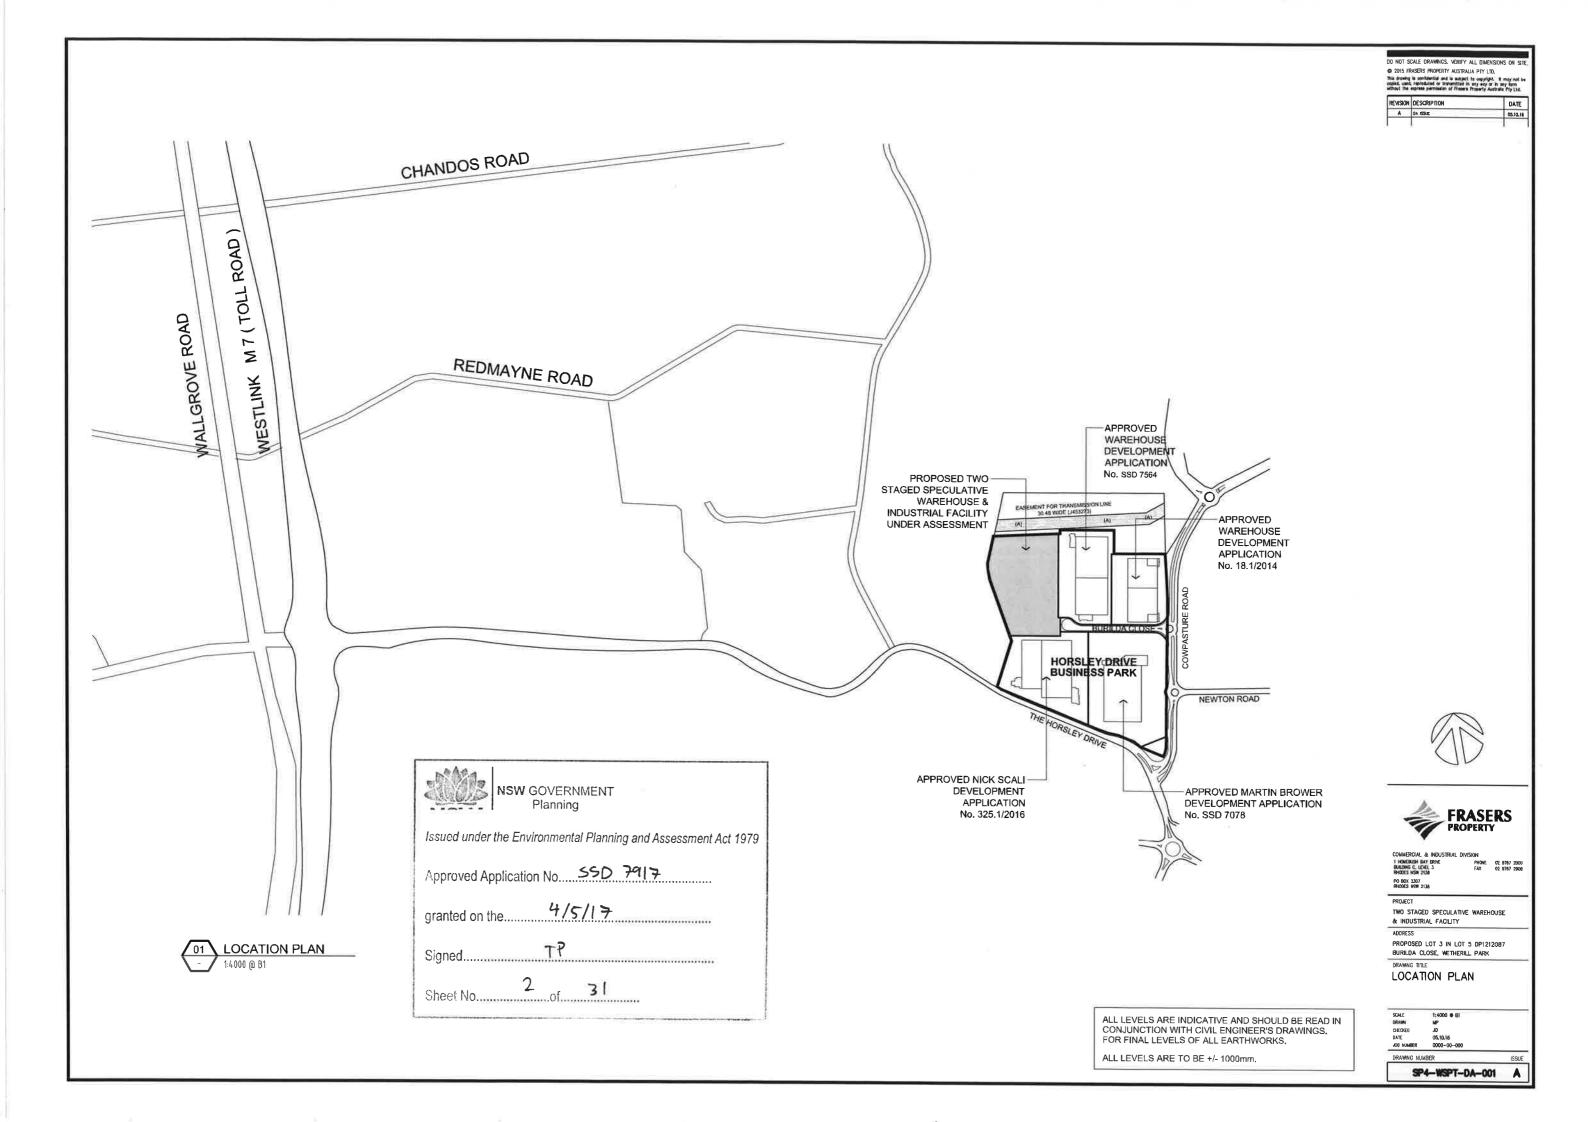

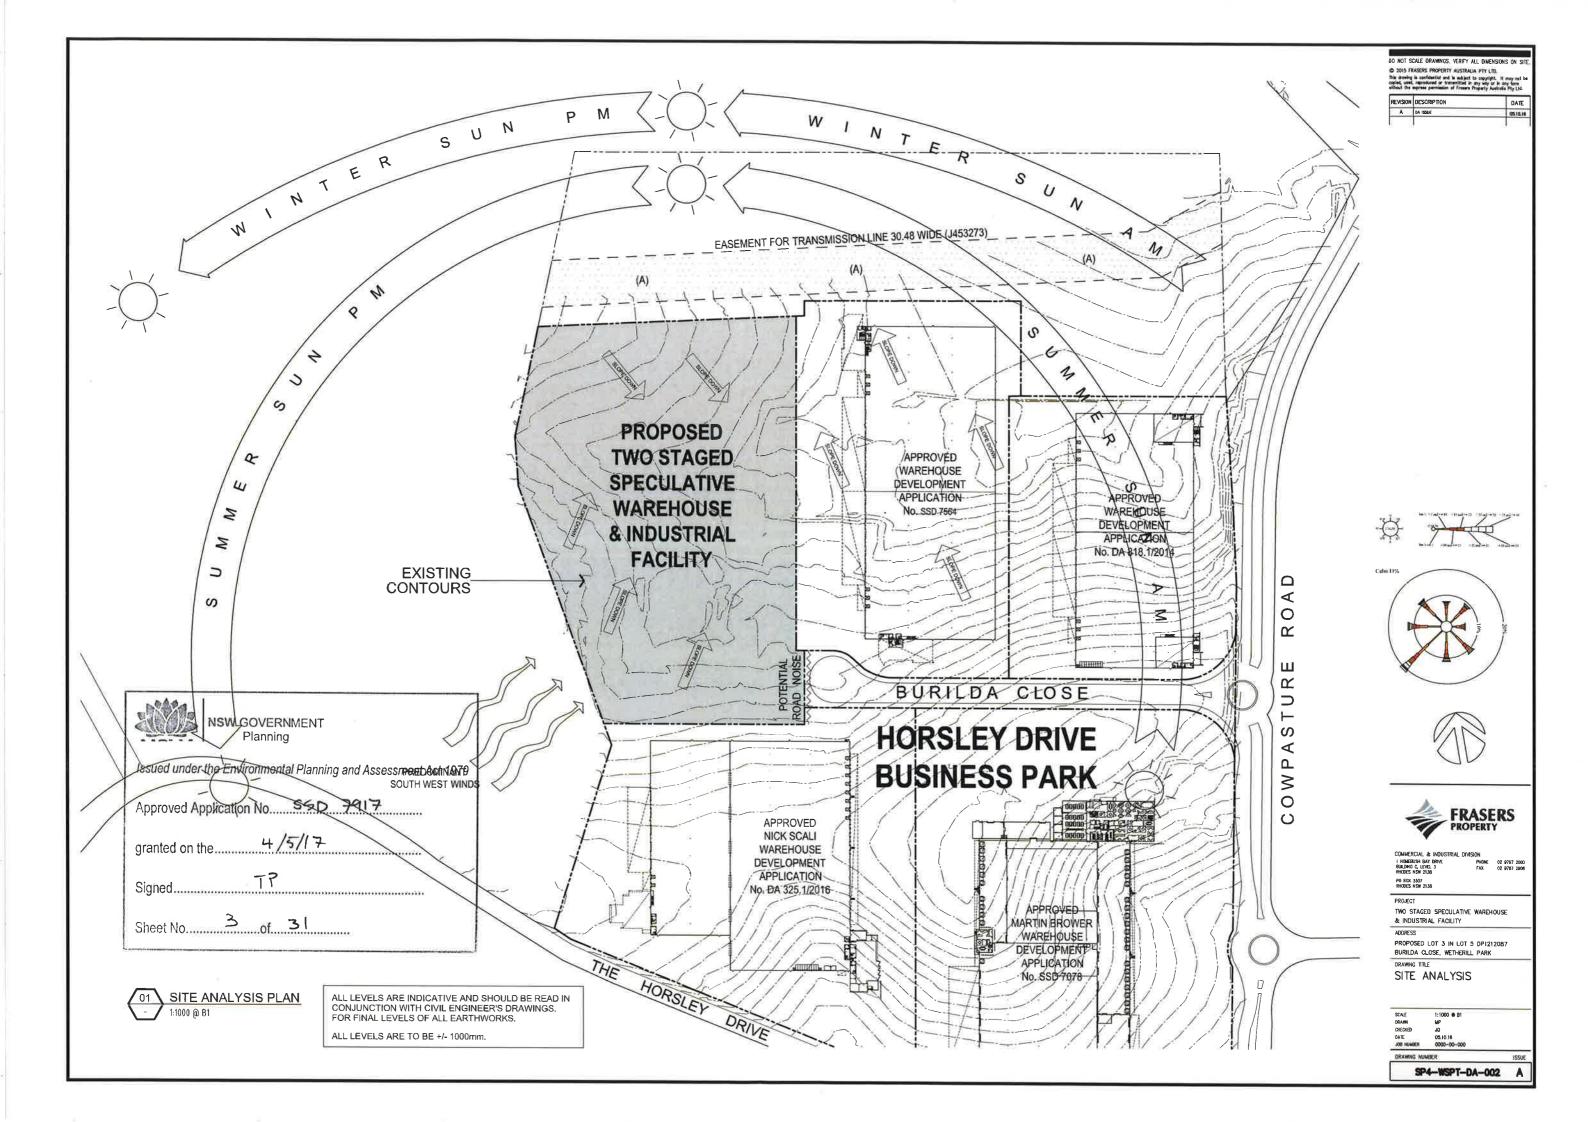

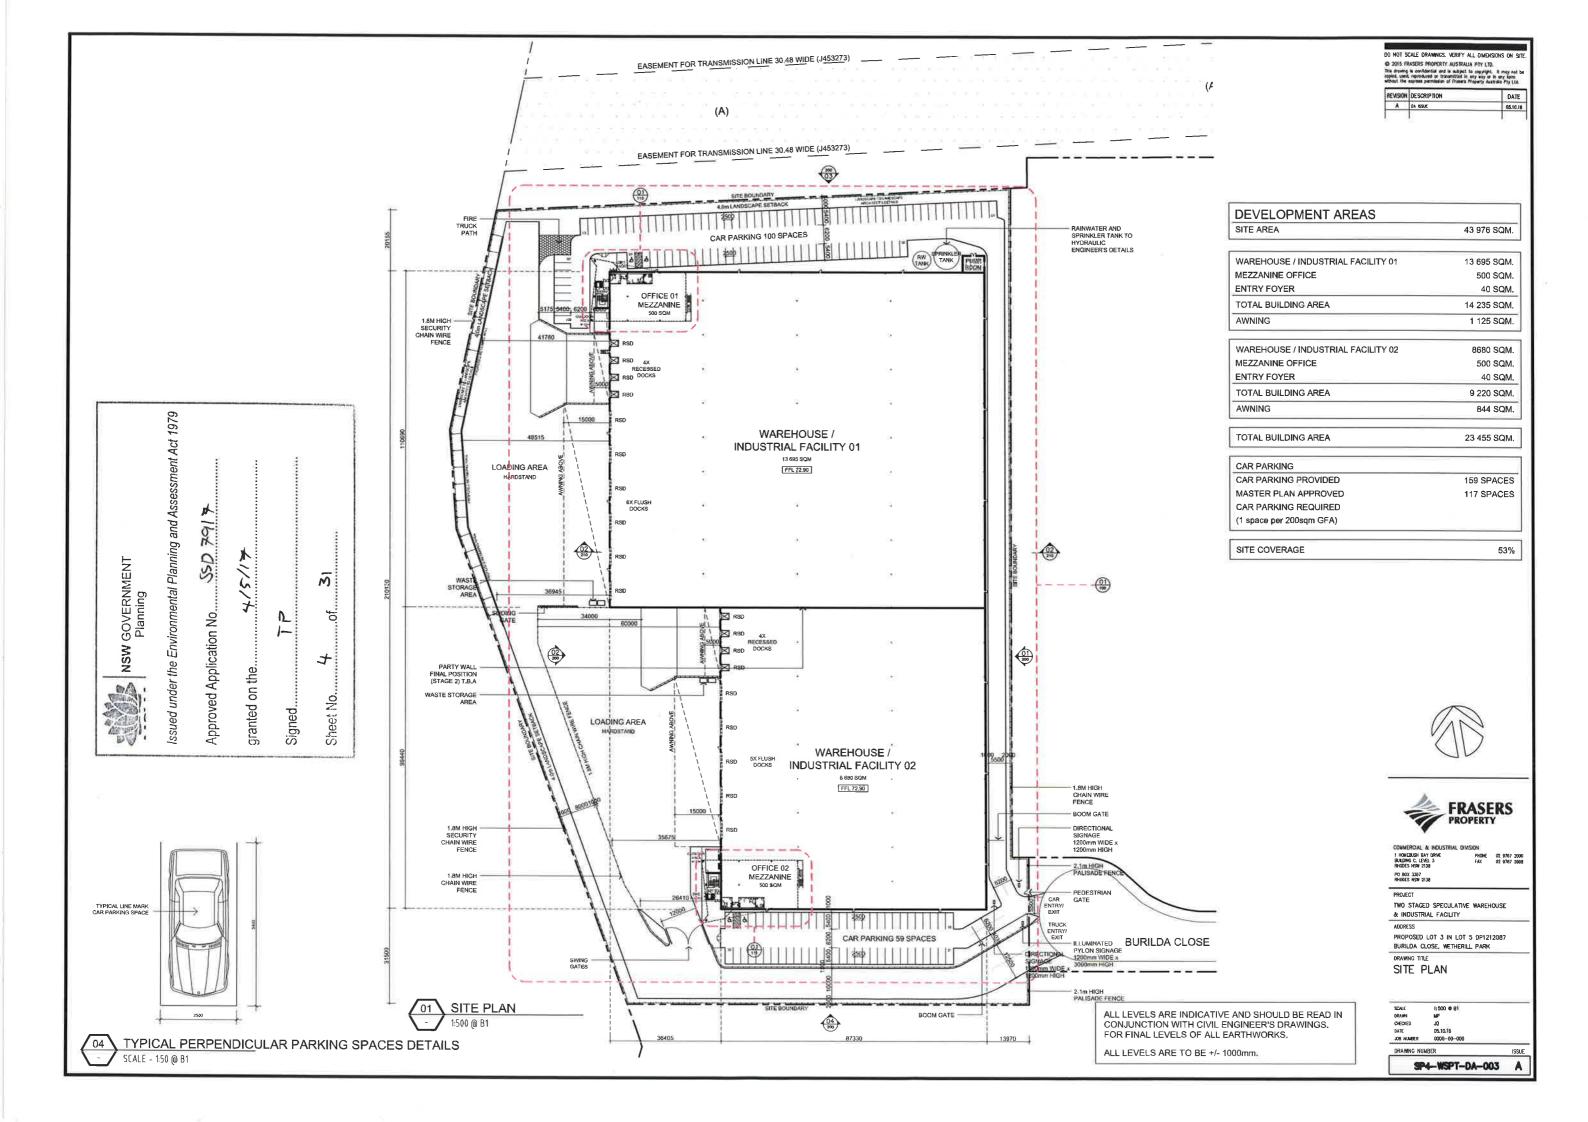

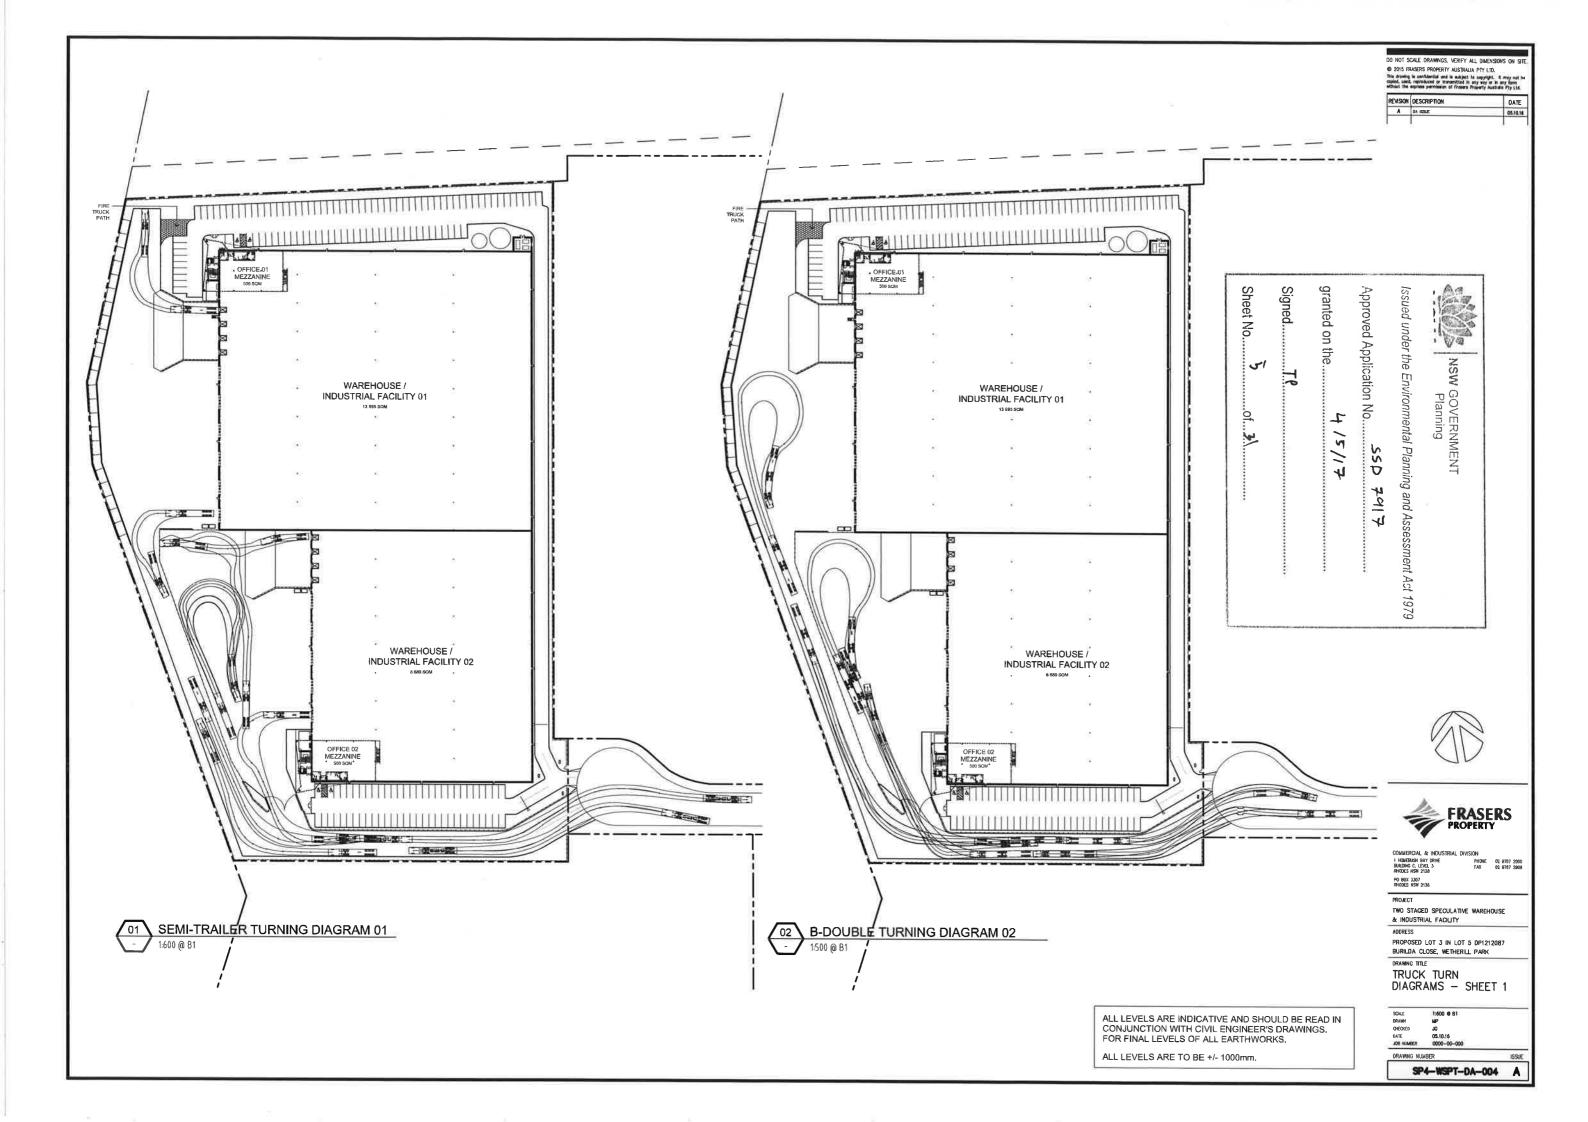

NSW GOVERNMENT Planning Issued under the Environmental Planning and Assessment Act 1979 Approved Application No. \$507917 WAREHOUSE / INDUSTRIAL FACILITY 01 4/5/17 granted on the.... Sheet No. 6 of 31 WAREHOUSE / INDUSTRIAL FACILITY 02 FIRE TRUCK TURNING DIAGRAM 03

2015 FRASERS PROPERTY AUSTRALIA PTY LTD. This drawing is confidential and is subject to copyright. It may not be copied, used: restricted or of transmitted in any says or in any form authors the expresse permission of fraces Property Australia Pty Lts.



PO BOX 3307 RHODES HSW 2138

TWO STAGED SPECULATIVE WAREHOUSE & INDUSTRIAL FACILITY

PROPOSED LOT J IN LOT 5 DP1212087 BURILDA CLOSE, WETHERILL PARK


DRAWING TITLE
TRUCK TURN
DIAGRAMS - SHEET 2


SCALE 1:600 @ B1
DRAWN MP
CHECKED JO
DATE 05.10.16
JOB NUMBER 0000-00-000


ALL LEVELS ARE INDICATIVE AND SHOULD BE READ IN CONJUNCTION WITH CIVIL ENGINEER'S DRAWINGS. FOR FINAL LEVELS OF ALL EARTHWORKS.


ALL LEVELS ARE TO BE +/- 1000mm.


SP4-WSPT-DA-005 A

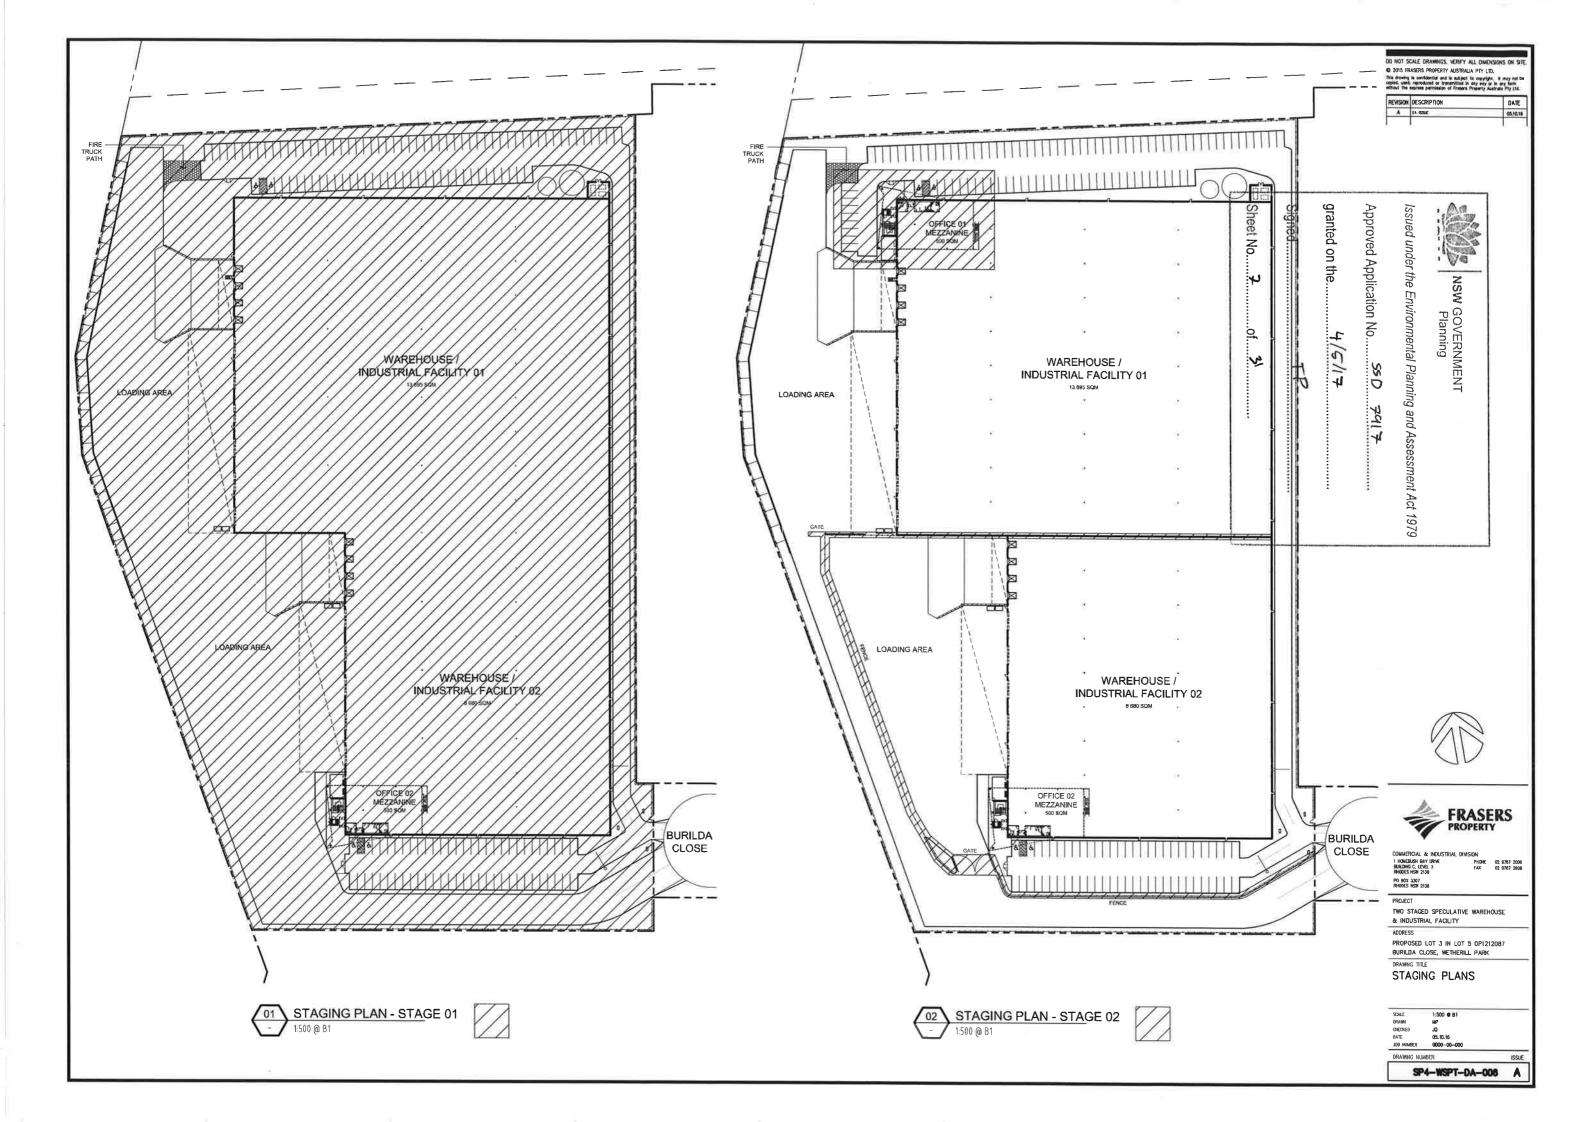

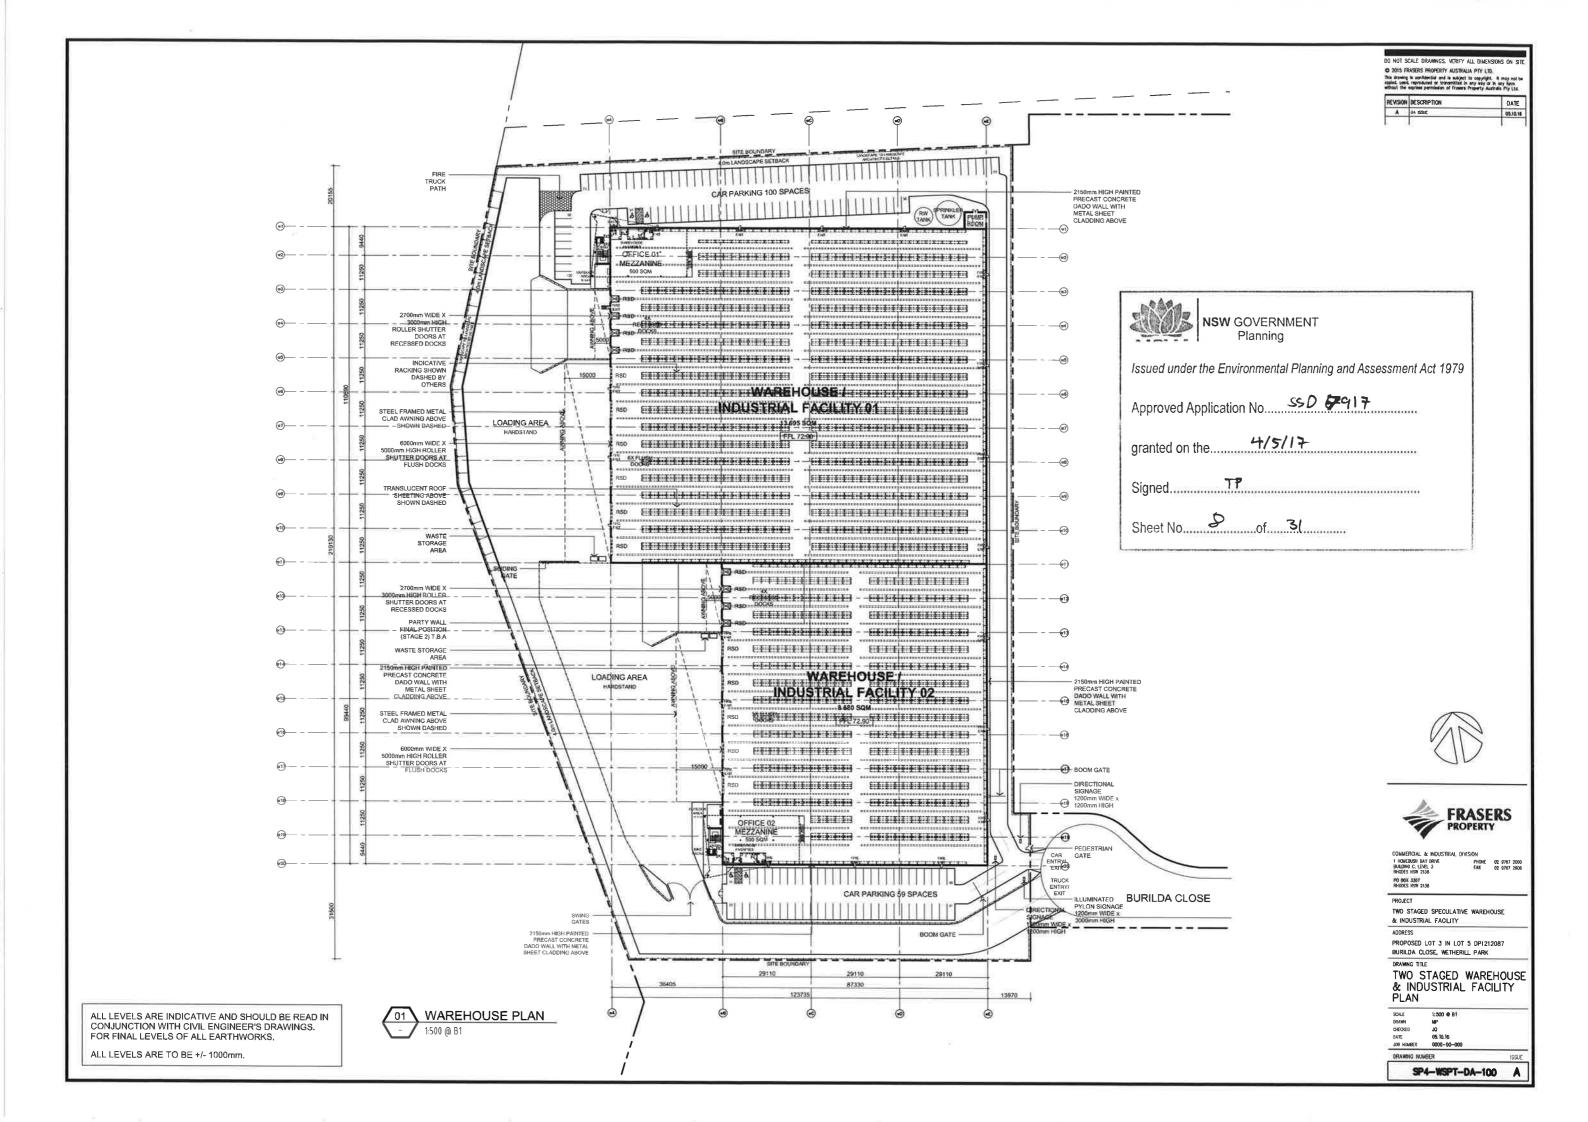

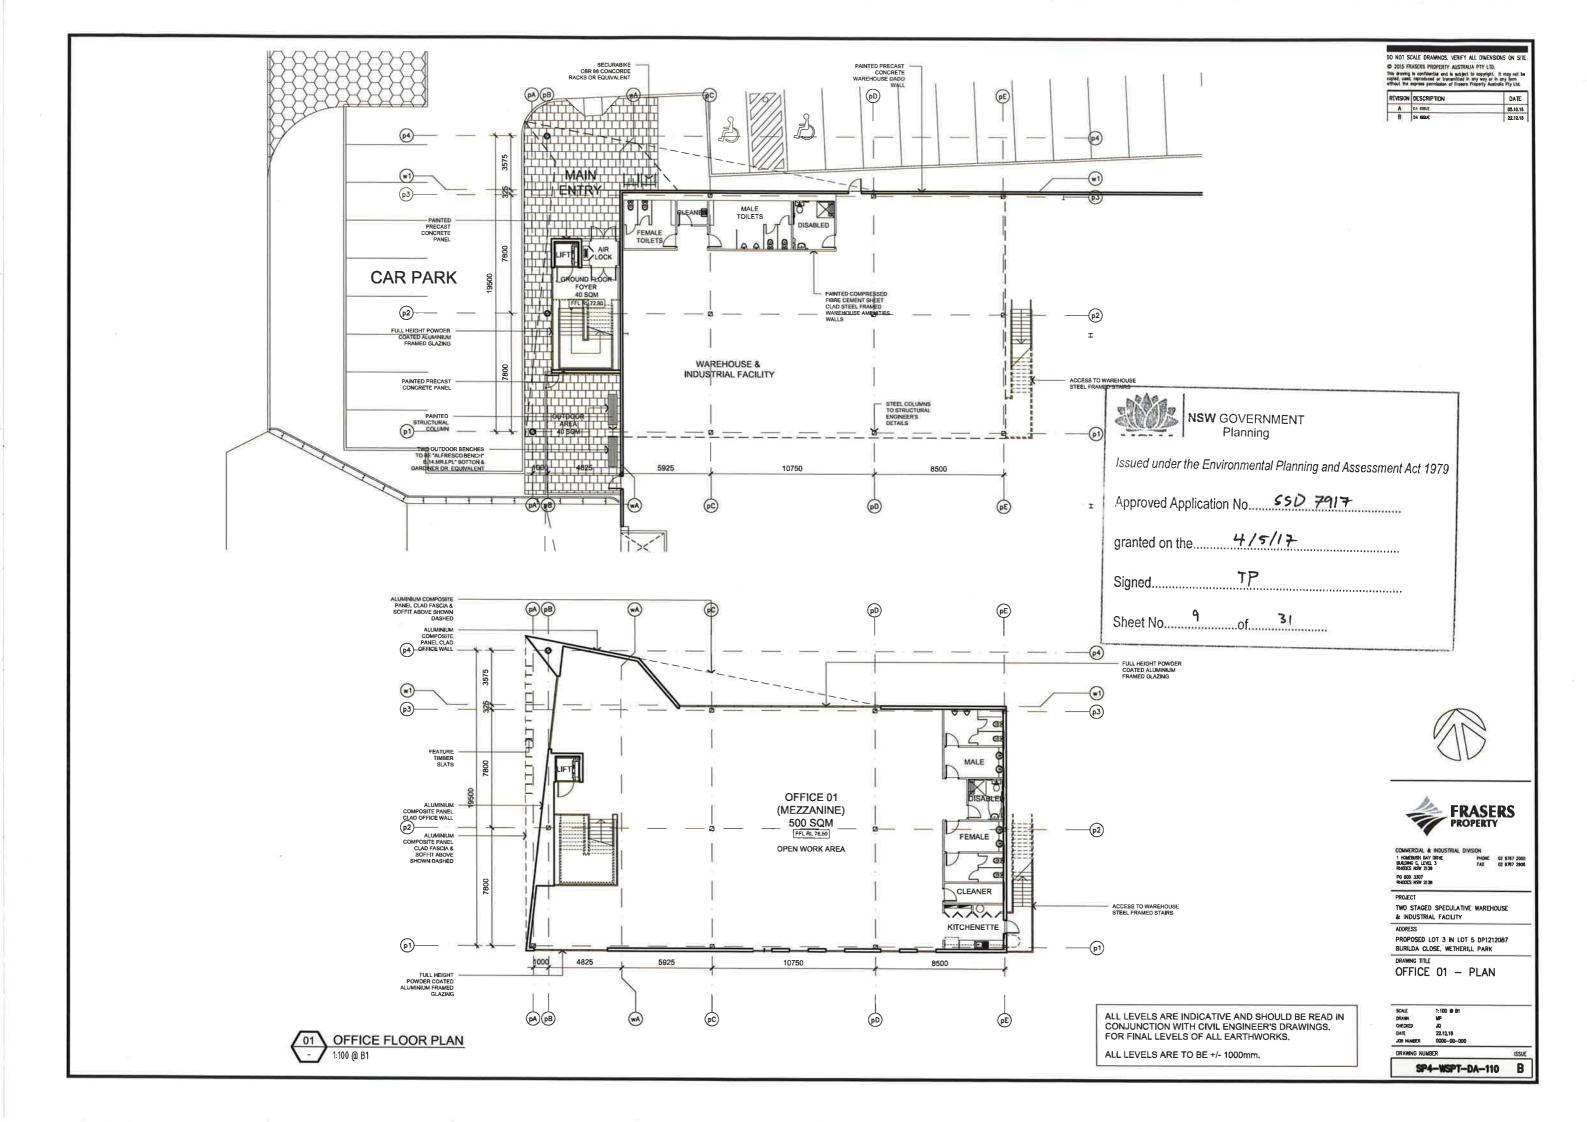


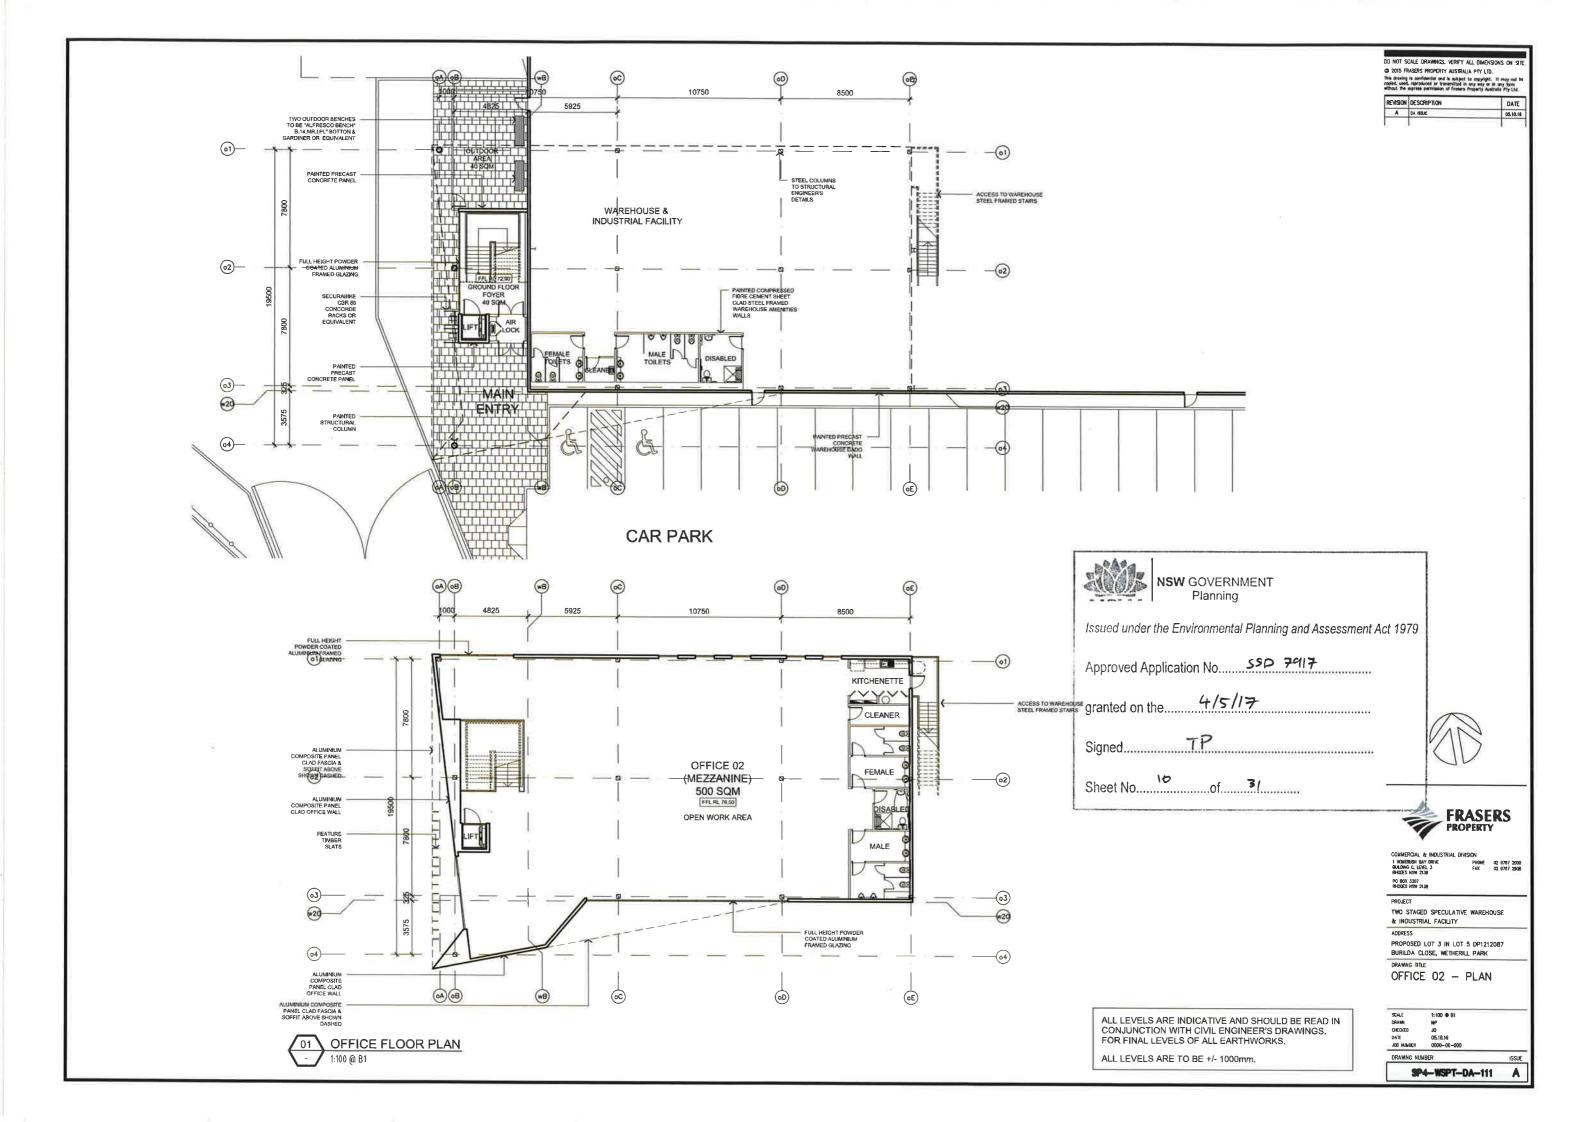

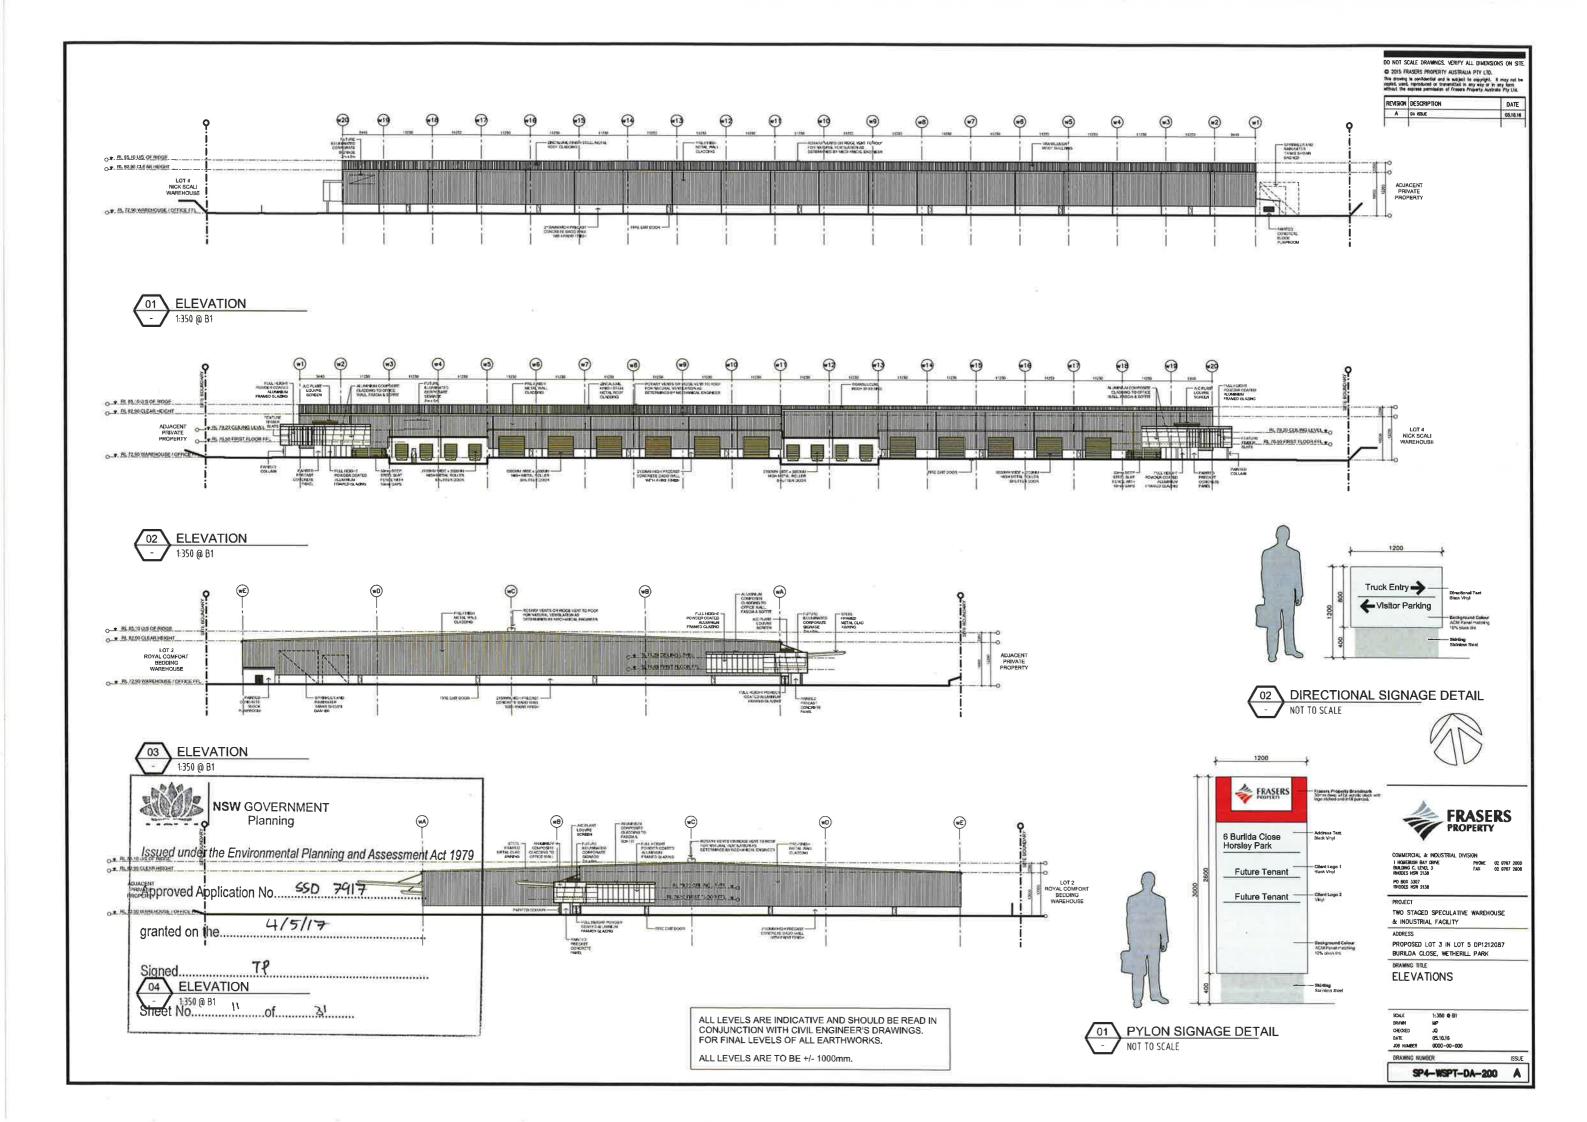


OO NOT SCALE DRAWINGS. VERIFY ALL DIMENSIONS ON SITE
© 2015 FRASERS PROPERTY AUSTRALIA PTY LTD.
This drawing is confidential and is subject to supplied. If may not be
copied, used, reproduced or transmitted in any way or it stry from
without the express pursuisant of Privace Thistophy Austrian Pty Ltd.

REVISION	DESCRIPTION	DATE
	DA STREE	05.10.16

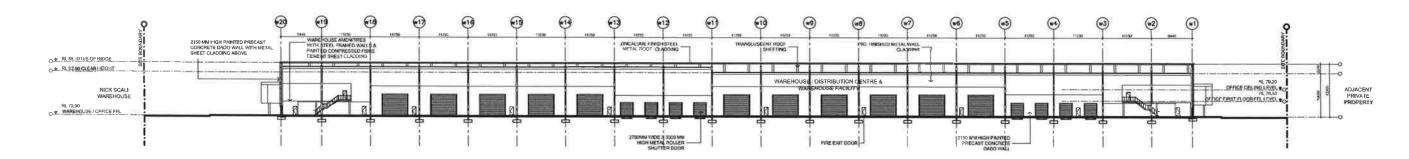


01 SECTION - 1:350 @ B1

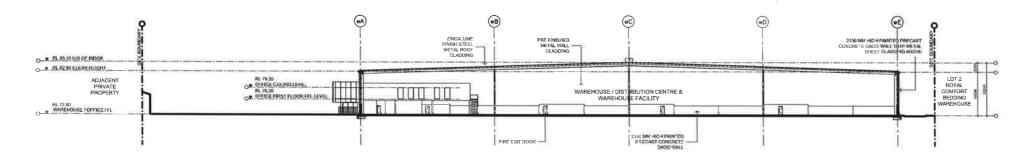





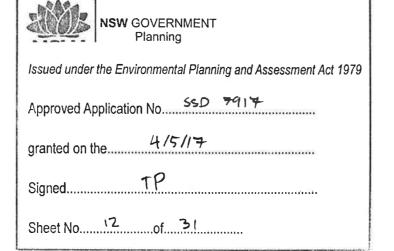



PO BOX 3337 RHOSES NOW 2138

PROJECT


TWO STAGED SPECULATIVE WAREHOUSE & INDUSTRIAL FACILITY


PROPOSED LOT 3 IN LOT 5 DP1212087 BURILDA CLOSE, WETHERILL PARK


DRAWING TITLE SECTIONS

SP4-WSPT-DA-210

ALL LEVELS ARE INDICATIVE AND SHOULD BE READ IN CONJUNCTION WITH CIVIL ENGINEER'S DRAWINGS. FOR FINAL LEVELS OF ALL EARTHWORKS, ALL LEVELS ARE TO BE +/- 1000mm.

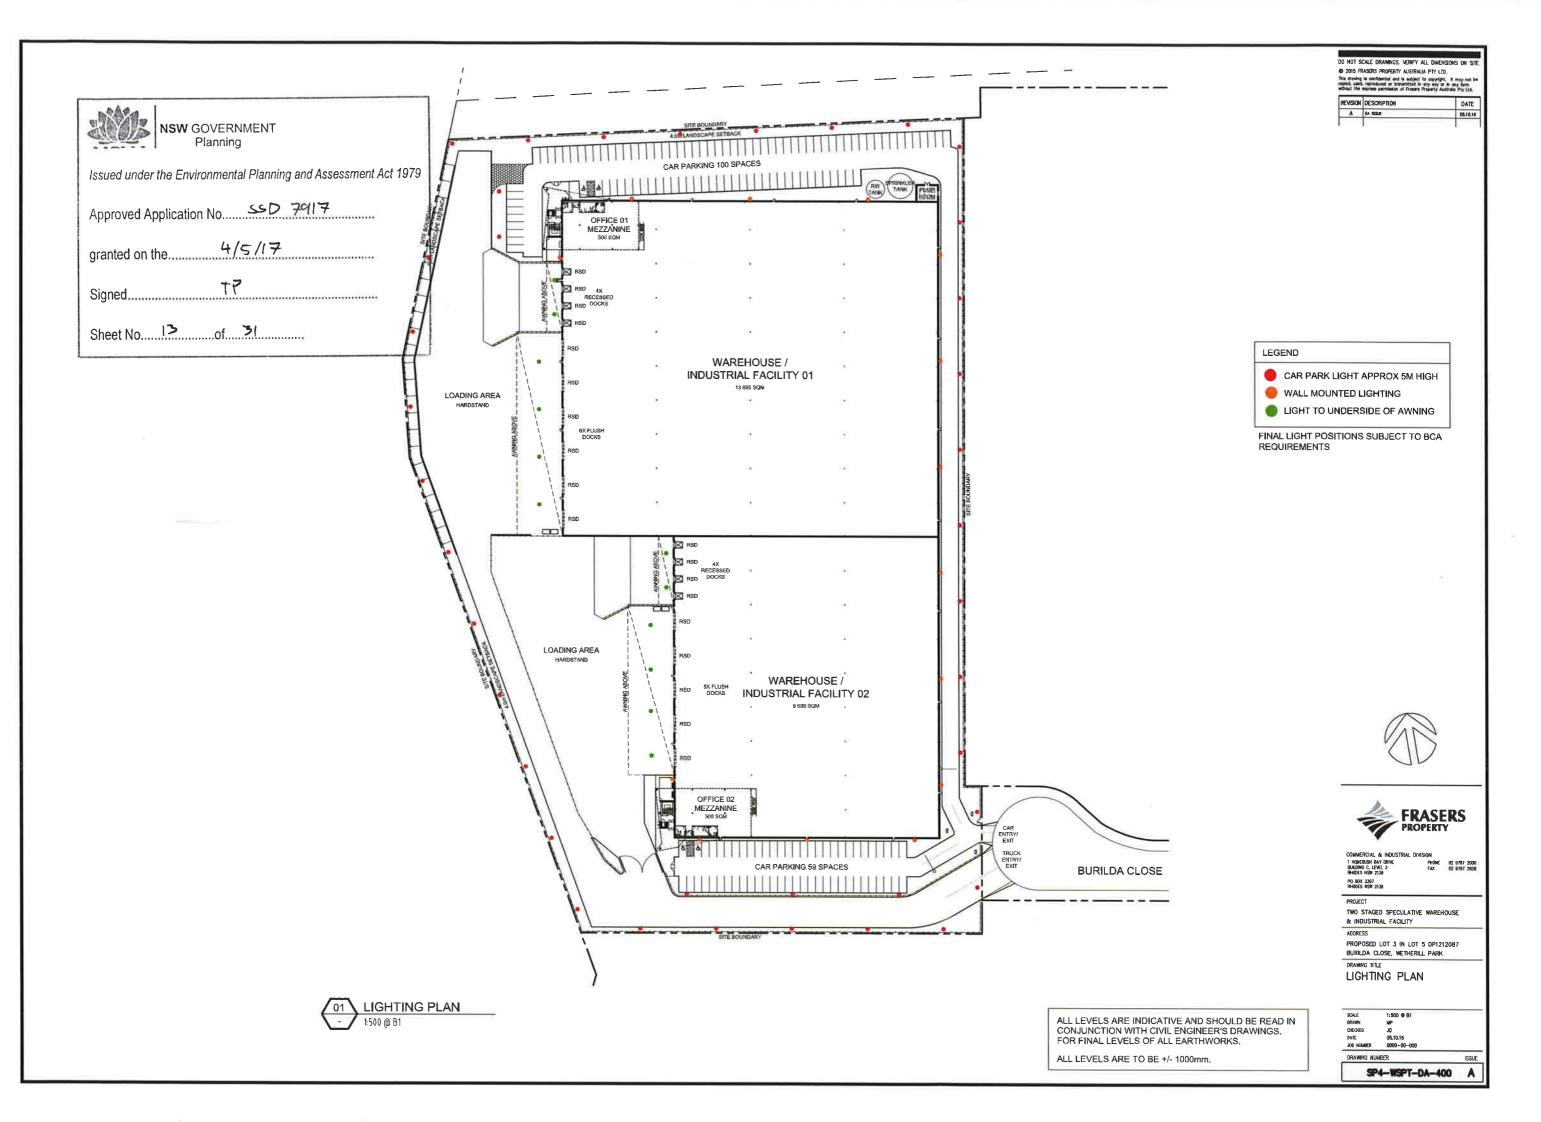

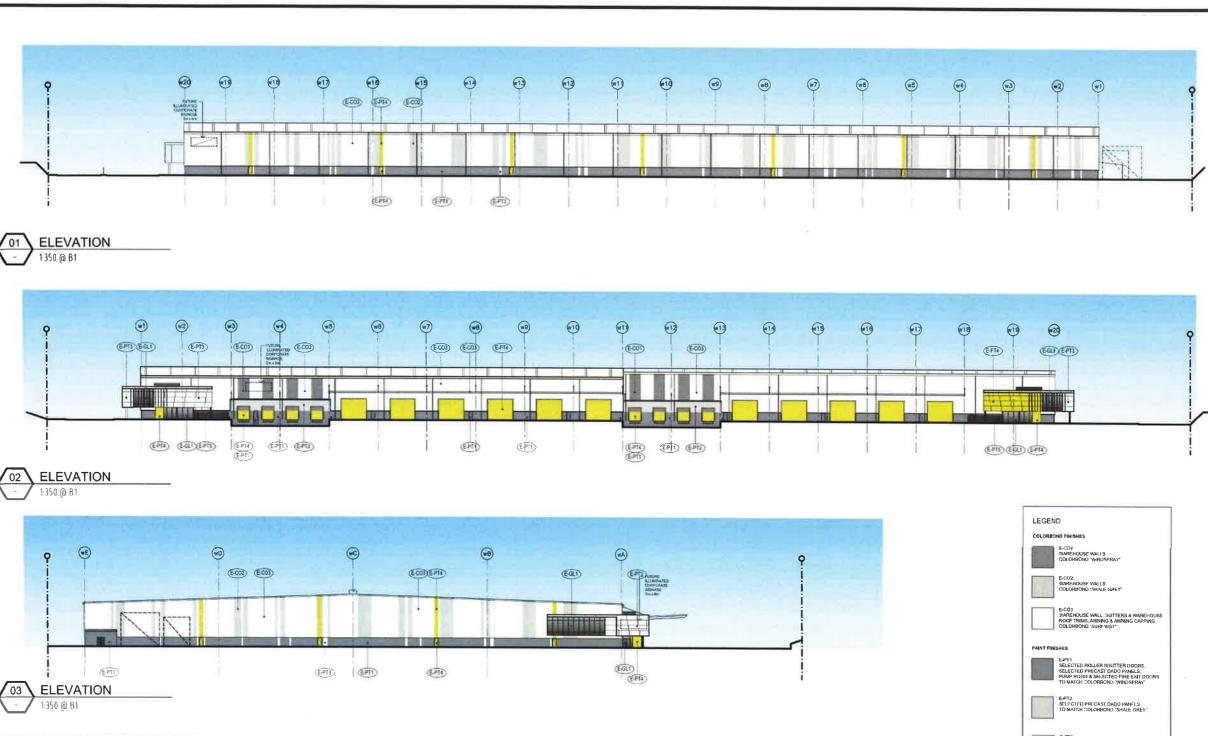

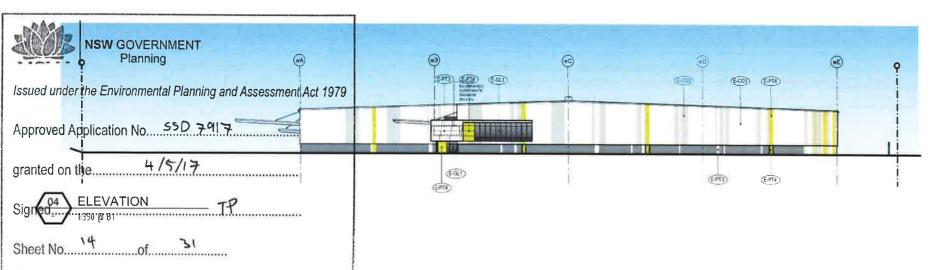

E RF1 ROOF, SPRINKLER TANKS ZINCALUME

ALL LEVELS ARE INDICATIVE AND SHOULD BE READ IN CONJUNCTION WITH CIVIL ENGINEER'S DRAWINGS. FOR FINAL LEVELS OF ALL EARTHWORKS,

ALL LEVELS ARE TO BE +/- 1000mm.

COLOUR SWATCHES SHOWN ON THIS DRAWING ARE INDICATIVE ONLY, FOR TRUE COLOUR REFERENCES, PLEASE REFER SAMPLE FROM

DO INCH SCALE URNAMICS VENIFI ALL DIMENSIONS ON SITE OF 2015 FRASERS PROPERTY AUSTRALIA PTY LTD.
The drawing is undiffered until a major the copylight. If may real to apply the copylight is the copylight of the

REVISION DESCRIPTION





COMMERCIAL & INDUSTRIAL DIVISION

1 HOMEGUSH BAY DRIVE PHONE 02 9767 2000
8JAJDHG C, LEYEL 3 FAX 02 9767 2006
HANDES HOW 2136

PO BOX 3307 RHODES NSW 2138

TWO STAGED SPECULATIVE WAREHOUSE & INDUSTRIAL FACILITY

ADDRESS

PROPOSED LOT 3 IN LOT 5 DP1212087 BURILDA CLOSE, WETHERILL PARK

COLOURED ELEVATIONS

SCALE DRAWN CHECKED DATE 1:350 @ BI MP JO DATE 05.10.16 JUB NUMBER 0000-00-000

DRAWING NUMBER


SP4-WSPT-DA-500 A


REVISION	DESCRIPTION	DATE
A	DA ESSLE	0510.16





KEY PLAN

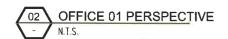

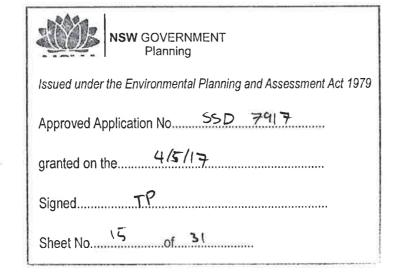





TWO STAGED SPECULATIVE WAREHOUSE & INDUSTRIAL FACILITY

PROPOSED LOT 3 IN LOT 5 0P1212087
BURILDA CLOSE, WETHERILL PARK

DRAWNG TITLE


OFFICE 01

PERSPECTIVE


SP4-WSPT-DA-600 A


REVISION	DESCRIPTION	DATE
A	DA ISSUE	05.10.16



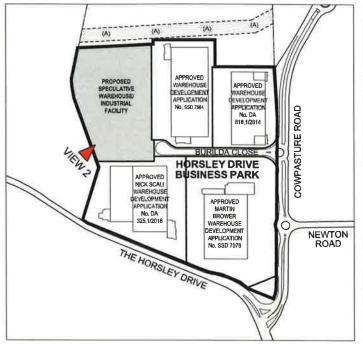

KEY PLAN

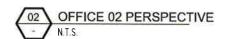

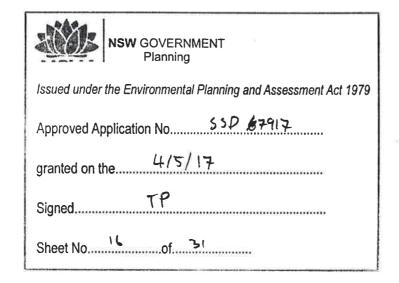





1 HOMEBUSH BAY DRI BUILDING C, LEVEL 3 RHODES NSW 2138 PO BOX 3307 RHODES NSW 2138

PROJECT

TWO STAGED SPECULATIVE WAREHOUSE & INDUSTRIAL FACILITY

PROPOSED LOT 3 IN LOT 5 DP1212087
BURILDA CLOSE, WETHERILL PARK

ORAWNG TITLE

OFFICE 02

PERSPECTIVE


SP4-WSPT-DA-610 A

PROPOSED BUILDING VIEWED FROM TRIVET ST.



VIEW 01 TRIVET ST.

PROPOSED BUILDING VIEWED FROM CHANDOS RD.

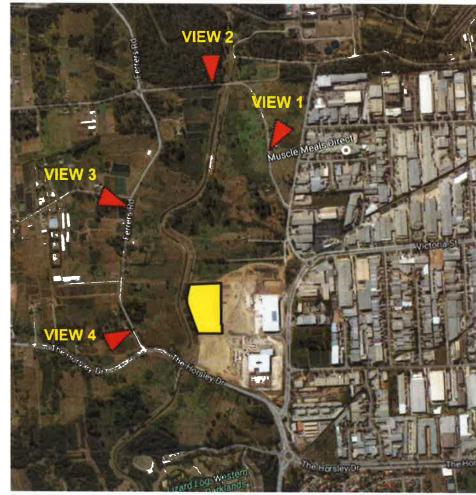

VIEW 02 CHANDOS RD.







VIEW 03 FERRERS RD.



NSW GOVERNMENT Planning

Issued under the Environmental Planning and Assessment Act 1979

SSD 7917 Approved Application No.

4/5/17 granted on the...

PROPOSED BUILDING VIEWED FROM FERRERS RD. NEAR THE HORSLEY DR

Sheet No.....17 of 31

VIEW 04

FERRERS RD. NEAR THE HORSLEY DR.






TWO STAGED SPECULATIVE WAREHOUSE & INDUSTRIAL FACILITY

PROPOSED LOT 3 IN LOT 5 DP1212087 BURILDA CLOSE, WETHERILL PARK

STRETSCAPE CONTEXT SKETCHES

SP4-WSPT-DA-620

DWG NO.	ISSUE	DRAWING TITLE	
LA-00	Α	COVER SHEET / LEGEND / PLANT SCHEDULE	
LA-01	Α	LANDSCAPE PLAN	
LA-02	Α	LANDSCAPE PLAN	
LA-03	Α	LANDSCAPE PLAN	

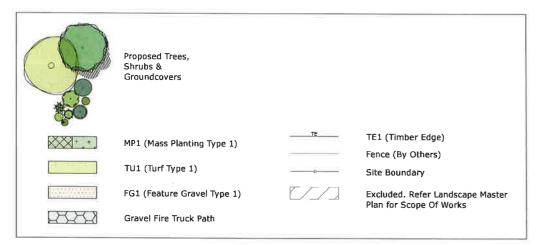

LEGEND

CODE	SPECIES	COMMON NAME	HEIGHT	POT SIZE	HATCH	TOTAL
	TREES	**				
CAN	Cupaniopsis anacaroides	Tuckeroo	12M	100L	as shown	23
ERT	Elaeocarpus reticulatus	Blueberry Ash	16M	100L	as shown	10
MEX	Magnolia 'Exmouth'	Exmouth	10M	200L	as shown	23
TLL	Tristaniopsis 'Luscious'	Water Gum	10M	100L	as shown	12
WFL	Waterhousia floribunda	Weeping Lily Pilly	6M	45L	as shown	33
	MIX TYPE 1	10.00				
Asb	Acmena 'Sublime'	Sublime	3M	300mm	as shown	2 / lin m
Sam	Syzigium 'Alyn Magic'	Alyn Magic	1.5M	300mm	as shown	3 / lin m
Vo	Viburnum oddotissorum	Sweet Viburnum	4M	300mm	as shown	3 / lin m
	MIX TYPE 2					
Вјр	Buxus japonica	Japanese Box	0.6M	200mm		3/m2
Clj	Callistemon 'Little John'	Little John	0.8M	140mm		4/m2
lvd	Lomandra 'Verday'	Verday	0.4M	140mm	B888888	4/m2
Ngs	Nandina 'Gulf Stream'	Gulf Stream	0.6M	200mm		3/m2
Pxn	Philodendron 'Xanadu'	Xanadu	1.2M	200mm	1911111	3/m2
Rsm	Rhapelepsis 'Snow Maiden'	Indian Hawthorne	0.8M	200mm		3/m2
Sam*	Syzigium 'Alyn Magic'	Alyn Magic	1.5M	200mm	THINING.	3/m2
tjm	Trachelospermum jasminoides	Star Jasmine	0.2M	140mm	********	4/m2
	MIX TYPE 3	111				
Ве	Banksia ericifolia	Heath-leaved Banksia	2M	200mm	11/1/1/1/1	1/2m2
De	Doryanthes excelsa	Gymea Lily	5M	200mm		1/2m2
Dv	Dodonaea viscosa	Hop Bush	3M	200mm	THE PROPERTY OF	1/2m2
Gsg	Grevillea 'Sandra Gordon'	Sandra Gordon	3.5M	200mm		1/2m2
сар	Carex appressa	Tall Sedge	0.8M	tube	13/1/1/1/	6/m2
dlr	Dianella 'Little Rev'	Little Rev	0.3M	tube		6/m2
dl	Dianella longifolia	Blue Berry Flax	1.2M	tube		6/m2
lkt	Lomandra 'Katrinus'	Katrinus	1.4M	tube		6/m2
lkb	Lomandra 'Katie Belles'	Katie Belles	1.2M	tube		6/m2

PLANT SCHEDULE

P1 160924 PRELIMINARY SC SC A 161002 FOR DEVELOPMENT APPLICATION SC SC

CONSULTANTS CLIENT

COSTIN ROE CONSULTING

FRASERS
PROPERTY

NORTH


HORSLEY DRIVE BUSINESS PARK SPECULATIVE FACILITY 3 DRAWING TITLE
COVER SHEET


PROJECT NO DRAWING NO
- 1623 LA-00


L A - 0 2

L A - 0 3

SITE LAYOUT

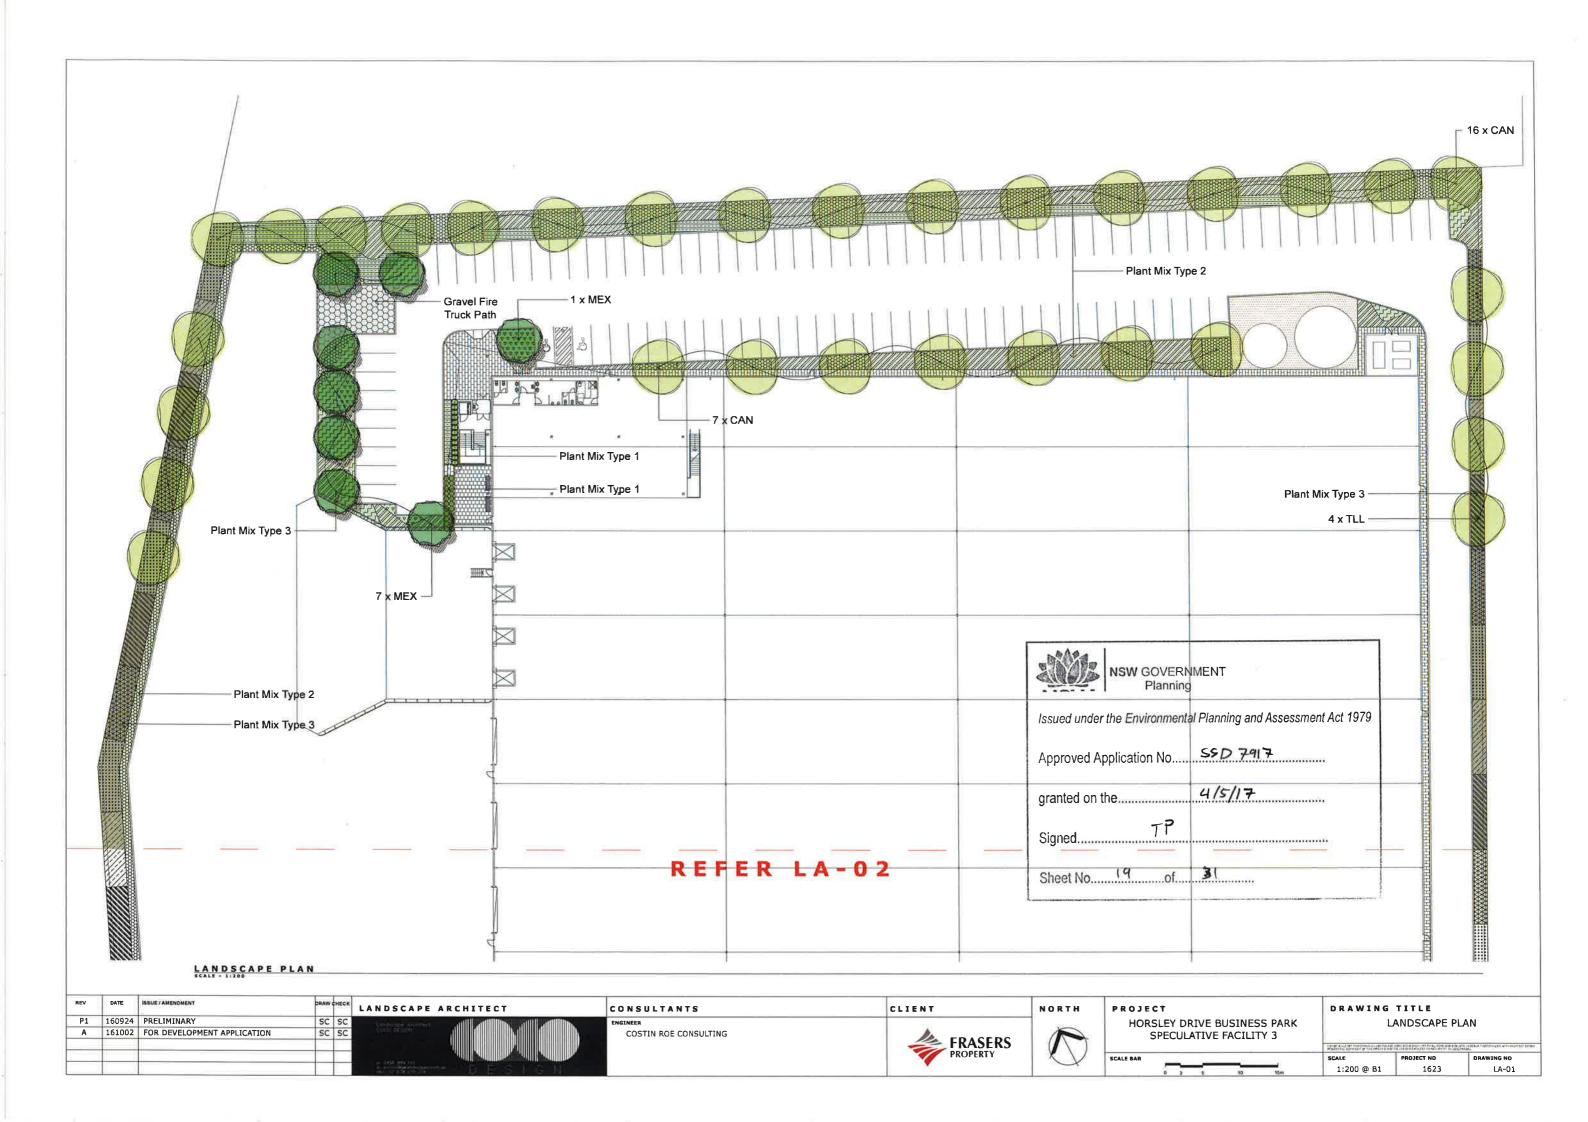

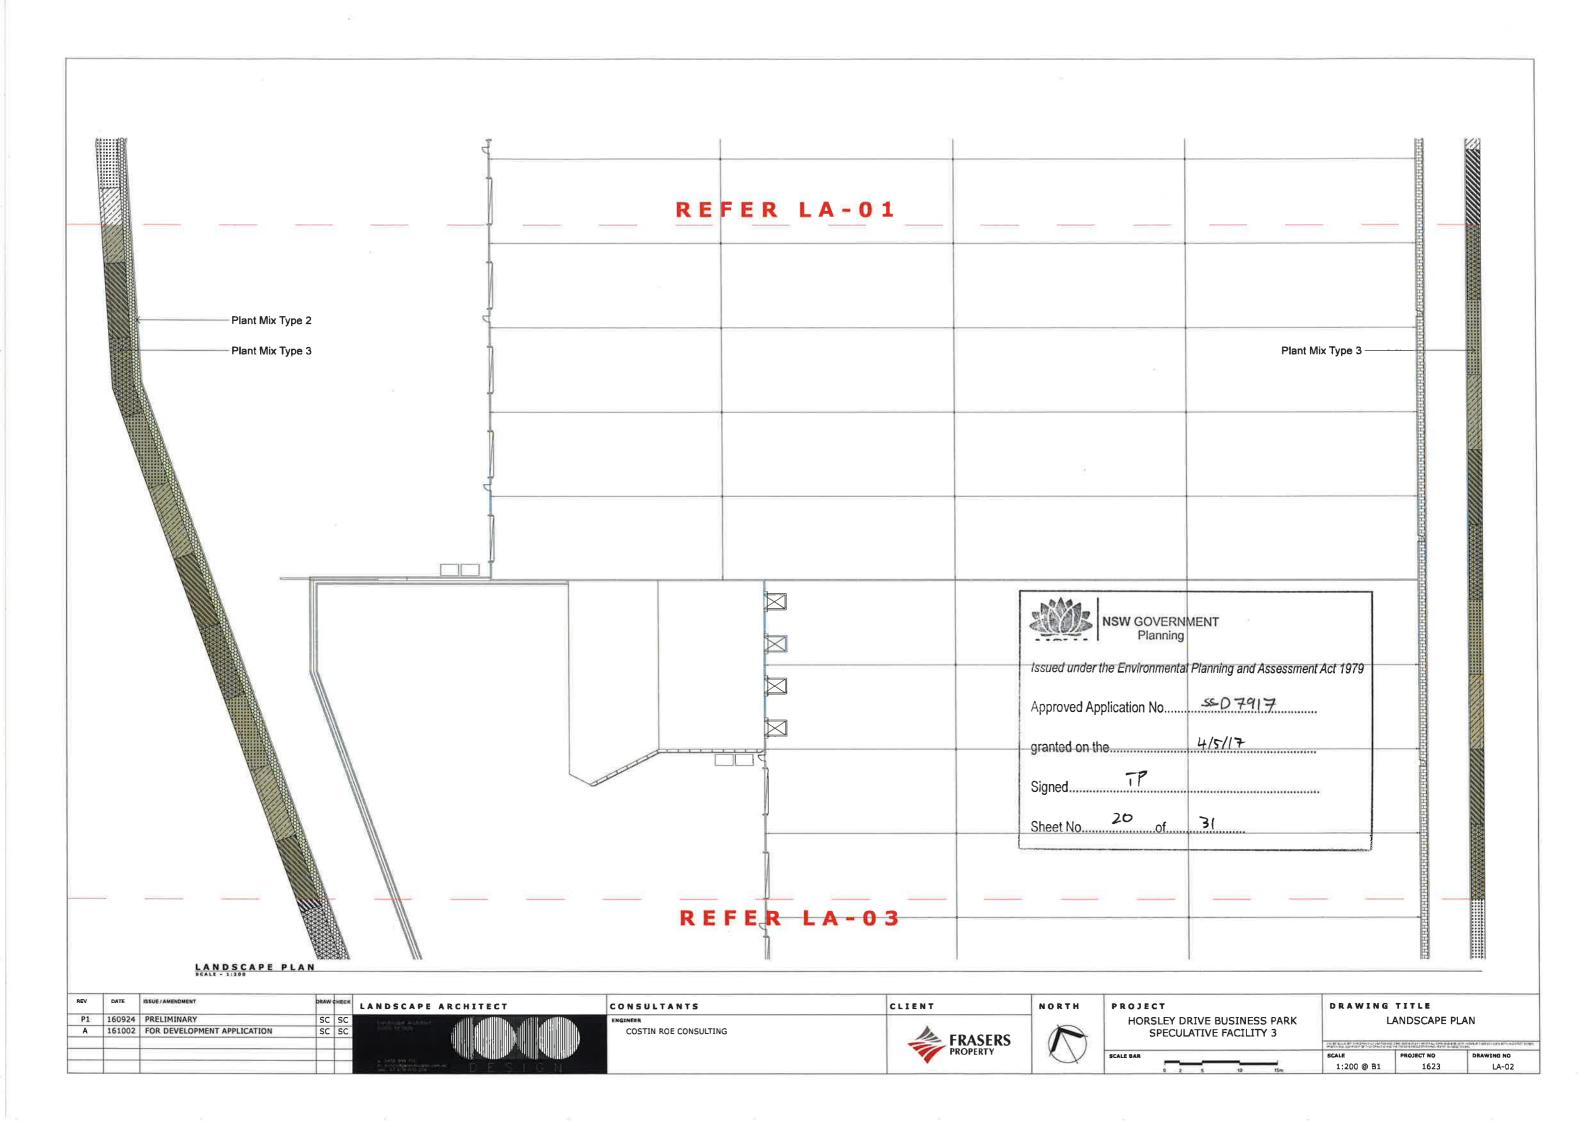

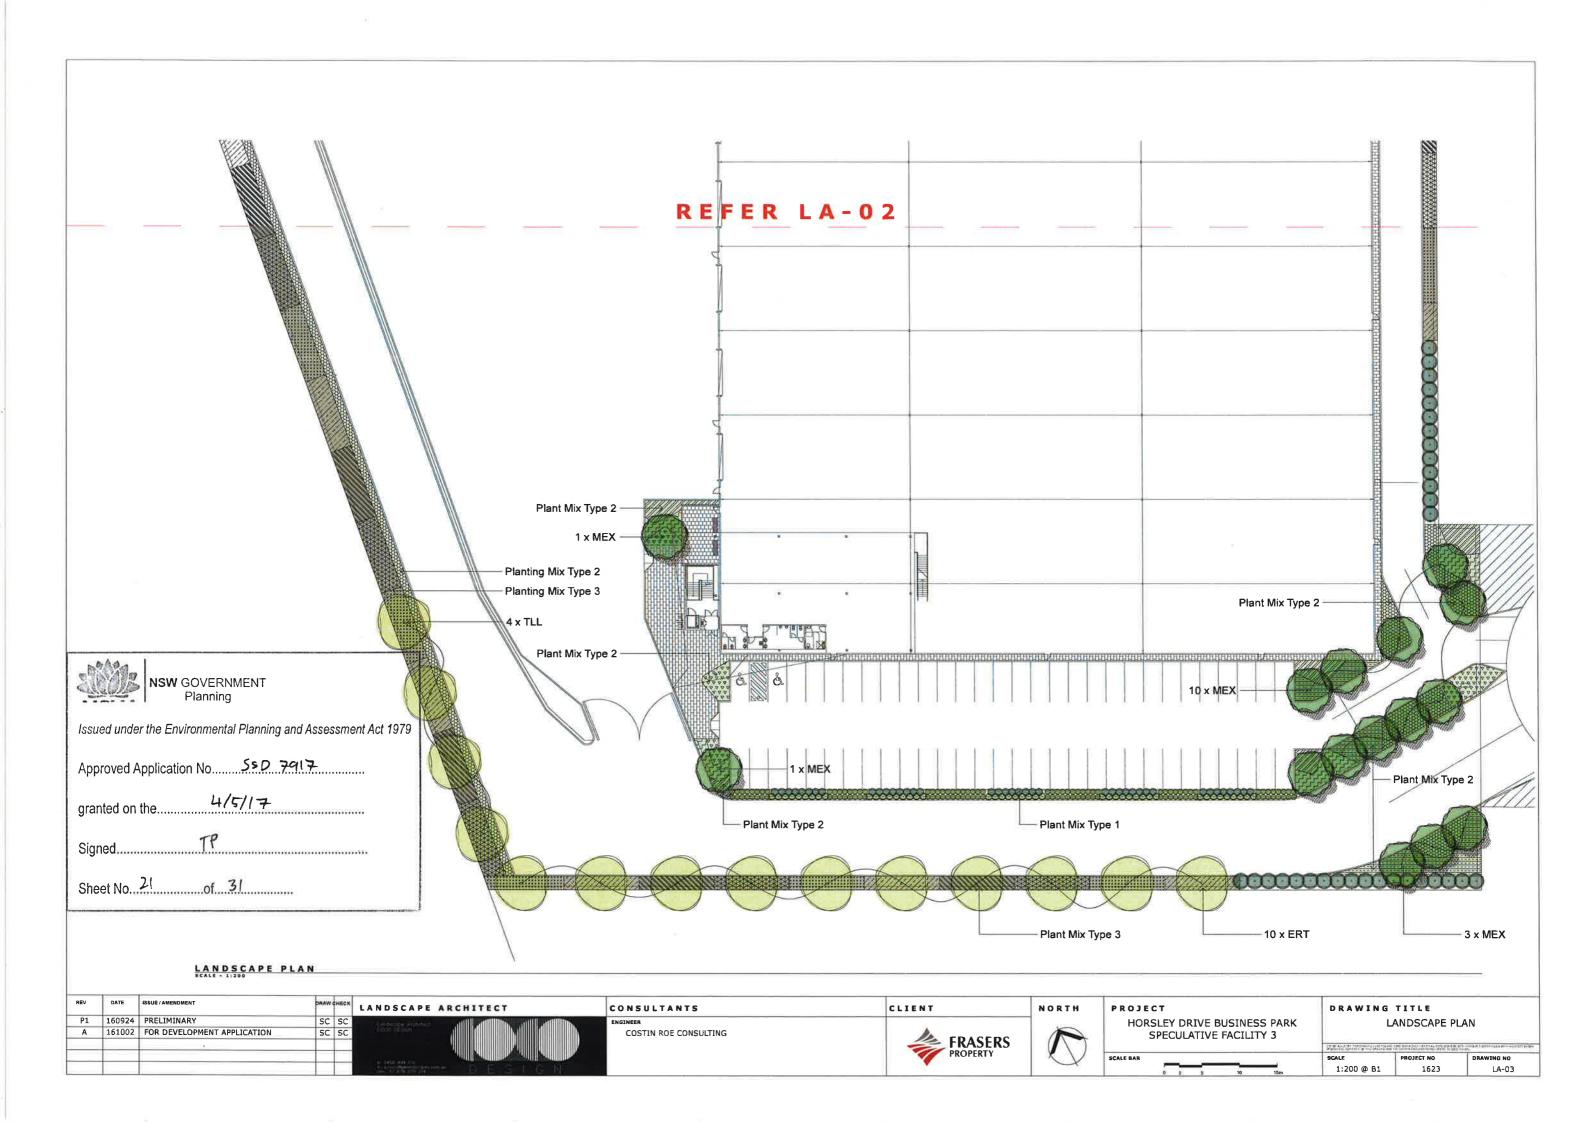



LOT 3 IN LOT 5 DP1212087, BURILDA CLOSE, WETHRILL PARK TWO STAGED SPECULATIVE WAREHOUSE/INDUSTRIAL FACILITY CIVIL ENGINEERING WORKS


GENERAL NOTES:

- 1... ALL WORK TO BE CARRIED OUT IN ACCORDANCE WITH FAIRFIELD CITY COUNCIL'S CONSTRUCTION SPECIFICATION, CONTRACTOR TO OBTAIN AND RETAIN A COPY ON SITE DURING THE COURSE OF THE WORKS.
- 2, ALL NEW WORKS ARE TO MAKE A SMOOTH JUNCTION WITH EXISTING CONDITIONS, AND MARRY IN A "WORKMAN LIKE" MANNER
- 3.0 THE CONTRACTOR IS TO VERIFY THE LOCATION OF ALL SERVICES WITH EACH RELEVANT AUTHORITY, ANY DAMAGE TO SERVICES SHALL BE RECTIFIED BY THE CONTRACTOR OR THE RELEVANT AUTHORITY AT THE CONTRACTOR'S EXPENSE, SERVICES SHOWN ON THESE PLANS ARE ONLY THOSE EVIDENT AT THE TIME OF SURVEY OR AS DETERMINED FROM SERVICE DIAGRAMS, HENRY AND HYMAS CONSULTING PTY, LTD, CANNOT GUARANTEE THE INFORMATION SHOWN NOR ACCEPT ANY RESPONSIBILITY FOR INACCURACIES OR INCOMPLETE DATA
- 4. SERVICES & ACCESSES TO THE EXISTING PROPERTIES ARE TO BE MAINTAINED IN WORKING ORDER AT ALL TIMES DURING CONSTRUCTION
- 5. ADJUST EXISTING SERVICE COVERS TO SUIT NEW FINISHED LEVELS TO RELEVANT AUTHORITY REQUIREMENTS
- REINSTATE AND STABILISE ALL DISTURBED LANDSCAPED AREAS IN ACCORDANCE WITH FAIRFIELD CITY COUNCH'S REQUIREMENTS.
- 7. MINIMUM GRADE OF SUBSOIL SHALL BE 0,5% (1:200) FALL TO OUTLETS.
- ALL TEMPORARY SEDIMENT AND EROSION CONTROL DEVICES ARE TO BE CONSTRUCTED, PLACED AND MAINTAINED IN ACCORDANCE WITH THE TECHNICAL SPECIFICATIONS, EROSION AND SEDIMENTATION CONTROL PLAN, ENVIRONMENTAL MANAGEMENT PLAN, AND BLACKTOWN CITY COUNCIL'S REQUIREMENTS WHERE APPLICAR IF.
- CONTRACTOR TO CHECK AND CONFIRM SITE DRAINAGE CONNECTIONS ACROSS THE VERGE PRIOR TO COMMENCEMENT OF STREET DRAINAGE WORKS.
- 10. PROPERTIES AFFECTED BY THE WORKS ARE TO BE NOTIFIED IN ADVANCE WHERE DISRUPTION TO EXISTING

SITEWORKS NOTES

- DATUM A.H.D.
- ORIGIN OF LEVELS, REFER TO BENCH OR STATE SURVEY MARKS WHERE SHOWN ON PLAN
- CONTRACTOR MUST VERIFY ALL DIMENSIONS AND EXISTING LEVELS ON SITE PRIOR TO COMMENCEMENT OF WORK
- ALL WORKS TO BE UNDERTAKEN IN ACCORDANCE WITH THE DETAILS SHOWN ON THE DRAWINGS & THE DIRECTIONS OF THE PURPORATE AND ALL.
- EXISTING SERVICES UNLESS SHOWN ON SURVEY PLAN HAVE BEEN PLOTTED FROM SERVICES SEARCH PLANS AND AS SUCH THEIR ACCURACY CANNOT BE GUARANTEED. IT IS THE RESPONSIBILITY OF THE CONTRACTOR TO ESTABLISH THE LOCATION AND LEVEL OF ALL EXISTING SERVICES PRIOR TO THE COMMENCEMENT OF ANY WORK, ANY DISCREPANCIES SHALL BE REPORTED TO THE SUPERINTENDENT, CLEARANCES SHALL BE OSTANIED FROM THE RELEVANT SERVICE AUTHORITY.
- WHERE NEW WORKS ABUT EXISTING THE CONTRACTOR SHALL ENSURE THAT A SMOOTH EVEN PROFILE, ERFE FROM ARRIPET CHANGES IS ACHIEVED.
- THE CONTRACTOR SHALL ARRANGE ALL SURVEY SETOUT TO BE CARRIED OUT BY A REGISTERED SURVEYOR.
- CARE IS TO BE TAKEN WHEN EXCAVATING NEAR EXISTING SERVICES, NO MECHANICAL EXCAVATION IS TO

 SELVINGENTAL OF THE PROPERTY OF THE PROPERTY
- CONTRACTOR TO OBTAIN AUTHORITY APPROVALS WHERE APPLICABLE
- MAKE SMOOTH TRANSITION TO EXISTING SURFACES AND MAKE GOOD
- THESE PLANS SHALL BE READ IN CONJUNCTION WITH APPROVED LANDSCAPE, ARCHITECTURAL, STRUCTURAL, HYDRAULIC AND INECHANICAL DRAWINGS AND SPECIFICATIONS OR WRITTEN INSTRUCTIONS THAT MAY BE ISSUED RELATING TO DEVELOPMENT AT THE SITE.
- TRENCHES THROUGH EXISTING ROAD AND CONCRETE PAVEMENTS SHALL BE SAWCUT TO FULL DEPTH OF CONCRETE AND A MINIMUM OF 50mm IN BITUMINOUS PAVING.
- ALL BRANCH GAS AND WATER SERVICES UNDER DRIVEWAYS AND BRICK PAVING SHALL BE LOCATED IN 8000 uPVC SEWER GRADE CONDUITS EXTENDING A MINIMUM OF 500mm BEYOND EDGE OF PAVING.
- GRADES TO PAVEMENTS TO BE AS IMPLIED BY RL'S ON PLAN GRADE EVENLY BETWEEN NOMINATED RL'S.
 AREAS EXHIBITING PONDING GREATER THAN 5/mm DEPTH WILL NOT BE ACCEPTED/UNLESS IN A
 DESIGNATED SAG POINT.
- ALL COVERS AND GRATES ETC TO EXISTING SERVICE UTILITIES ARE TO BE ADJUSTED TO SUIT NEW FINISHED SURFACE LEVELS WHERE APPLICABLE

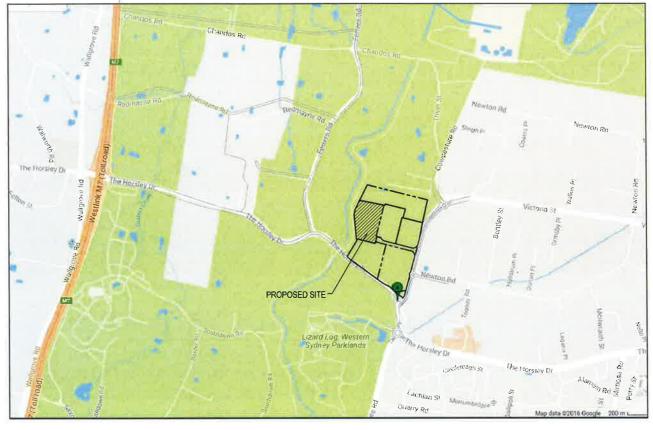


LOCALITY SKETCH

EXISTING SERVICES & FEATURES

- THE CONTRACTOR SHALL ALLOW FOR THE CAPPING OFF, EXCAVATION AND REMOVAL (IF REQUIRED) OF ALL EXISTING SERVICES IN
 AREAS AFFECTED BY WORKS WITHIN THE CONTRACT AREA OR AS SHOWN ON THE DRAWNINGS UNLESS DIRECTED OTHERWISE BY
 THE SUPPRINTENDENT,
- THE CONTRACTOR SHALL ENSURE THAT AT ALL TIMES SERVICES TO ALL BUILDINGS NOT AFFECTED BY THE WORKS ARE NOT DISDUSTED.
- CONSTRUCTION OF TEMPORARY SERVICES
- CONTRACTOR SHALL CONSTRUCT TEMPORARY SERVICES TO MAINTAIN SUPPLY TO EXISTING BUILDING REMAINING IN OPERATION DURING WORKS TO THE SATISFACTION AND APPROVAL OF THE SUPERINTENDENT, ONCE DIVERSION IS COMPLETE AND COMMISSIONED, THE CONTRACTOR SHALL REMOVE ALL SUCH TEMPORARY SERVICES AND MAKE GOOD TO THE SATISFACTION OF THE SUPERINTENDENT.
- INTERRUPTION TO SUPPLY OF EXISTING SERVICES SHALL BE DONE SO AS NOT TO CAUSE ANY INCONVENIENCE TO THE PRINCIPAL CONTRACTOR TO GAIN APPROVAL FROM THE SUPERINTENDENT FOR TIME OF INTERRUPTION.
- EXISTING SERVICES, BUILDINGS, EXTERNAL STRUCTURES AND TREES SHOWN ON THESE DRAWINGS ARE EXISTING FEATURES
 PRIOR TO ANY DEMOLITION WORKS.
- EXISTING SERVICES UNLESS SHOWN ON SURVEY PLAN HAVE BEEN PLOTTED FROM SERVICES SEARCH PLANS AND AS SUCH THEIR ACCURACY CANNOT BE GUARANTEED. IT IS THE RESPONSIBILITY OF THE CONTRACTOR TO COMMETER A DIAL BEFORE YOU DIG SEARCH AND TO ESTABLISH THE LOCATION AND LEVEL OF ALL EXISTING SERVICES PRIOR TO THE COMMENCEMENT OF ANY WORK, ANY DISCREPANCIES SHALL BE REPORTED TO THE SUPERINTENDENT, CLEARANCES SHALL BE OBTAINED FROM THE RELEVANT SERVICES THAT SHALL BE SERVICED.
- ALL BRANCH GAS AND WATER SERVICES UNDER DRIVEWAYS AND BRICK PAVING SHALL BE LOCATED IN Ø80 uPVC SEWER GRADE
 COMPUTER SYTEMPING A MINIMUM OF SOURCE BROWN BROWN BY AND BRICK PAVING.

	DRAWING SCHEDULE
16875_DA_C000	COVER SHEET, DRAWING SCHEDULE, NOTES & LOCALITY SKETCH
16875 DA C100	GENERAL ARRANGEMENT PLAN
16875_DA_C101	DETAIL PLAN, SHEET 1 OF 4
16875_DA_C102	DETAIL PLAN, SHEET 2 OF 4
16875_DA_C103	DETAIL PLAN, SHEET 3 OF 4
16875_DA_C104	OETAIL PLAN, SHEET 4 OF 4
16875_DA_C200	STORMWATER MISCELLANEOUS DETAILS & PIT LID SCHEDULE
16875_DA_C250	STORMWATER CATCHMENT PLAN
16875_DA_SE01	SEDIMENT & EROSION CONTROL PLAN
16875_DA_SE02	SEDIMENT & EROSION CONTROL TYPICAL DETAILS

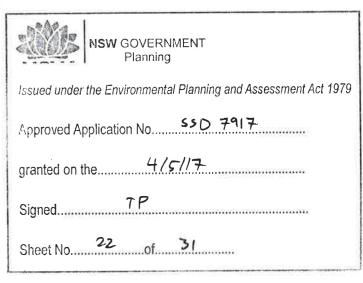


SURVEY NOTES


THE EXISTING SITE CONDITIONS SHOWN ON THE FOLLOWING DRAWINGS HAVE BEEN INVESTIGATED BY SURVEYOR SPECIFIED IN THE TITLE BLOCK, THE INFORMATION IS SHOWN TO PROVIDE A BASIS FOR DESIGN HENRY AND HYMAS PTY. LTD, DOES NOT GUARANTEE THE ACCURACY OR COMPLETENESS OF THE SURVEY BASE OR ITS SUITABILITY AS A BASIS FOR CONSTRUCTION DRAWINGS.


SHOULD DISCREPANCIES BE ENCOUNTERED DURING CONSTRUCTION BETWEEN THE SURVEY DATA AND ACTUAL FIELD DATA, CONTACT HENRY AND HYMAS PTY. LTD. THE FOLLOWING NOTES HAVE BEEN TAKEN DIRECTLY FROM ORIGINAL SURVEY DOCUMENTS.


FOR DA ONLY


										Clark		T		Project	free	See year	flare
SURVEY										FRASERS PROPERTY	Level 5, 79 Victoria Avenue	7alistrate +61 2 9417 8400		LOT 3 IN LOT 5 DP1212087, BURILDA CLOSE, WETHERILL PARK	J Liu	T Chan	SEP 2016
										T NASENS FROFERIT	Chatswood NSW 2067	Facalitation				Algorithm	Non
INFORMATION							-			Authorit		+61 2 9417 8337	##. ##	TWO STAGED SPECULATIVE WAREHOUSE/INDUSTRIAL FACILITY	T Dempsey	A Francis	NTS
SURVEYED BY CRAIG & RHODES										FRASERS PROPERTY	(A)	email@hheonsuit.com.au		Tie	Disease funder		Neces.
DATUM AHD										TRASERS PROPERTY	.W.	Web		COVER SHEET, DRAWING SCHEDULE,	40075		.00
ORIGIN OF LEVELS P M 31592 R.L. 3 621	àt	BALIED FOR DEVELOPMENT APPLICATION	A.	10	24152216					This drawing and design remains the property of Henry & Hymas and may not be		www.henryandhymas.com.su		· ·	16875	DA CO	00 01
				1000000	_	 1700-1110	-	1	2277.1	period is whole or in con without the programting program of Horney & Human	1		THE TYGOTYTHES	NOTES & LOCALITY SKETCH			

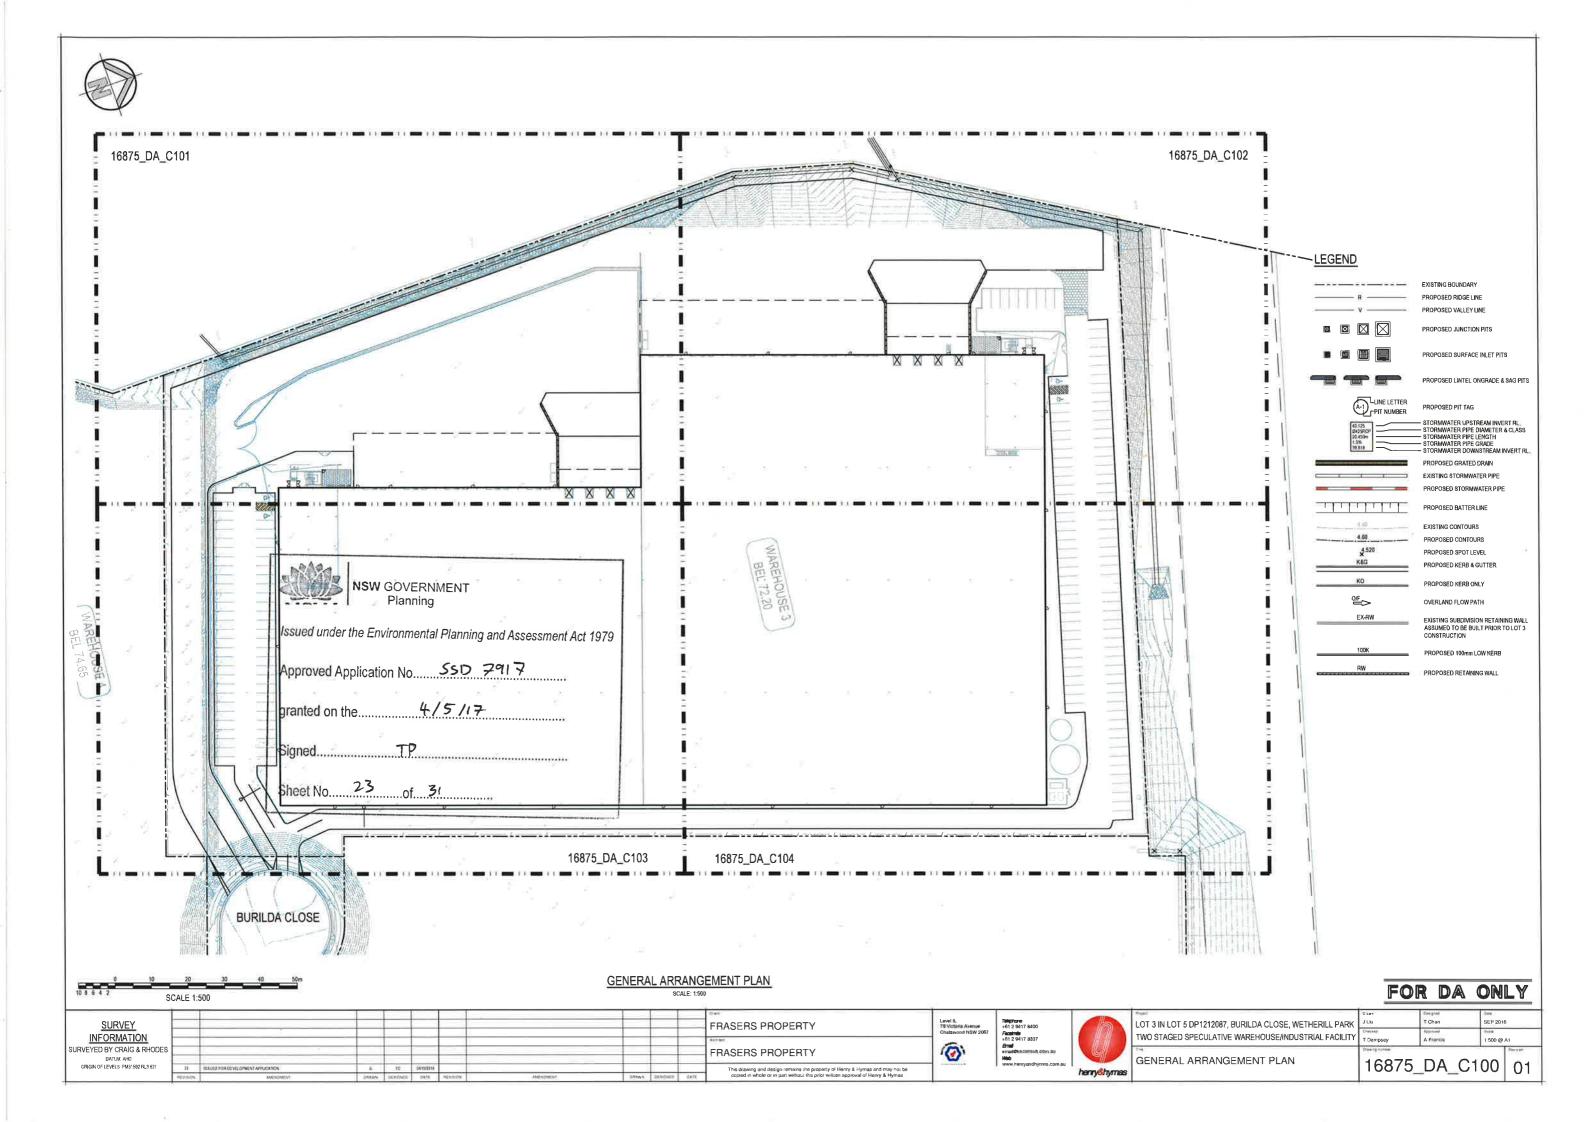

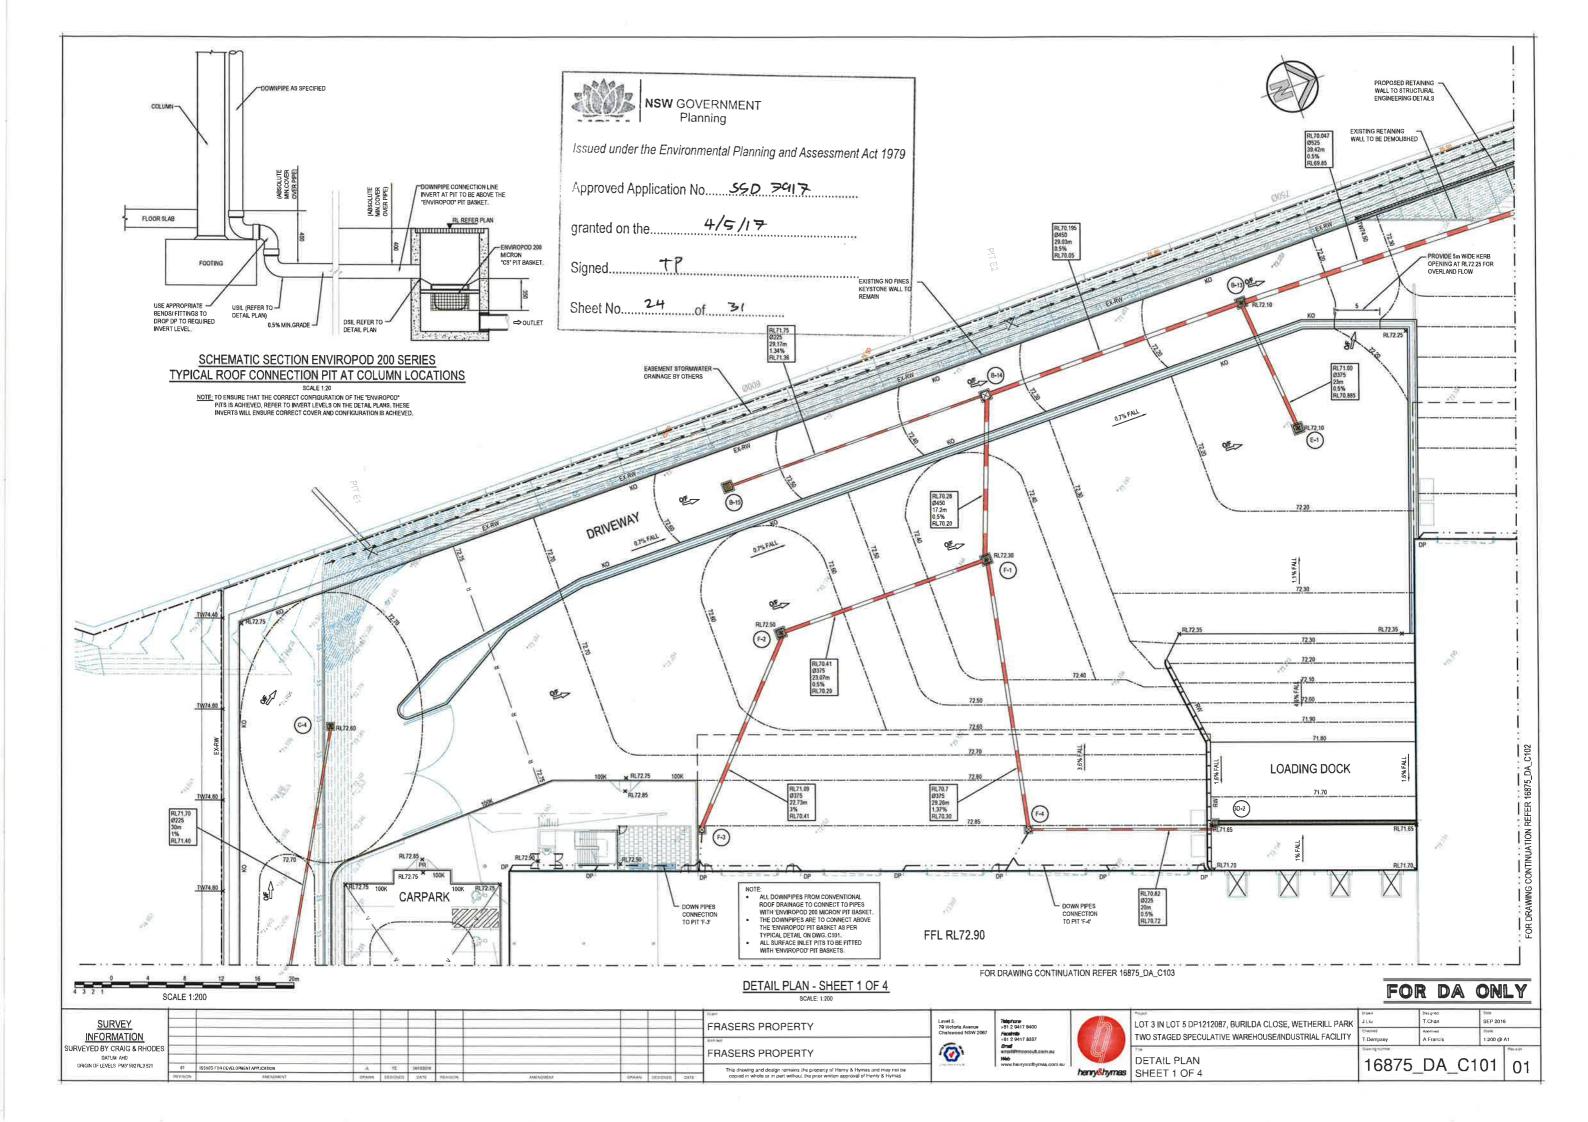

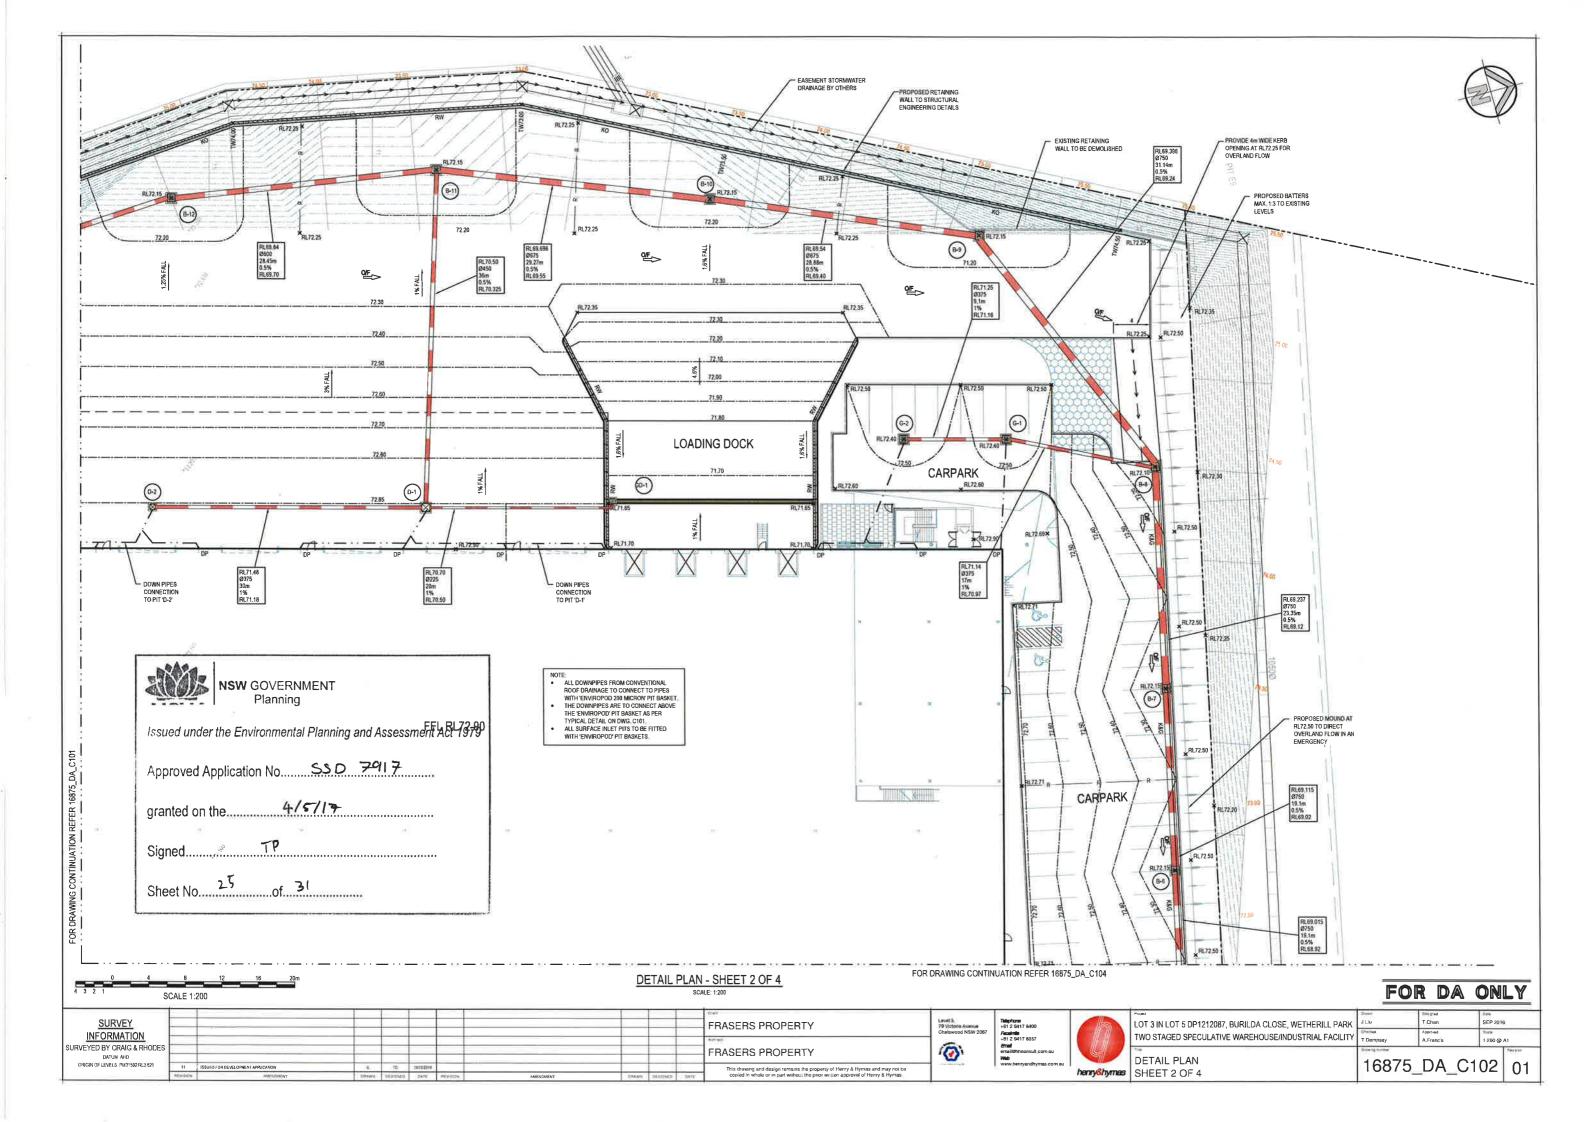

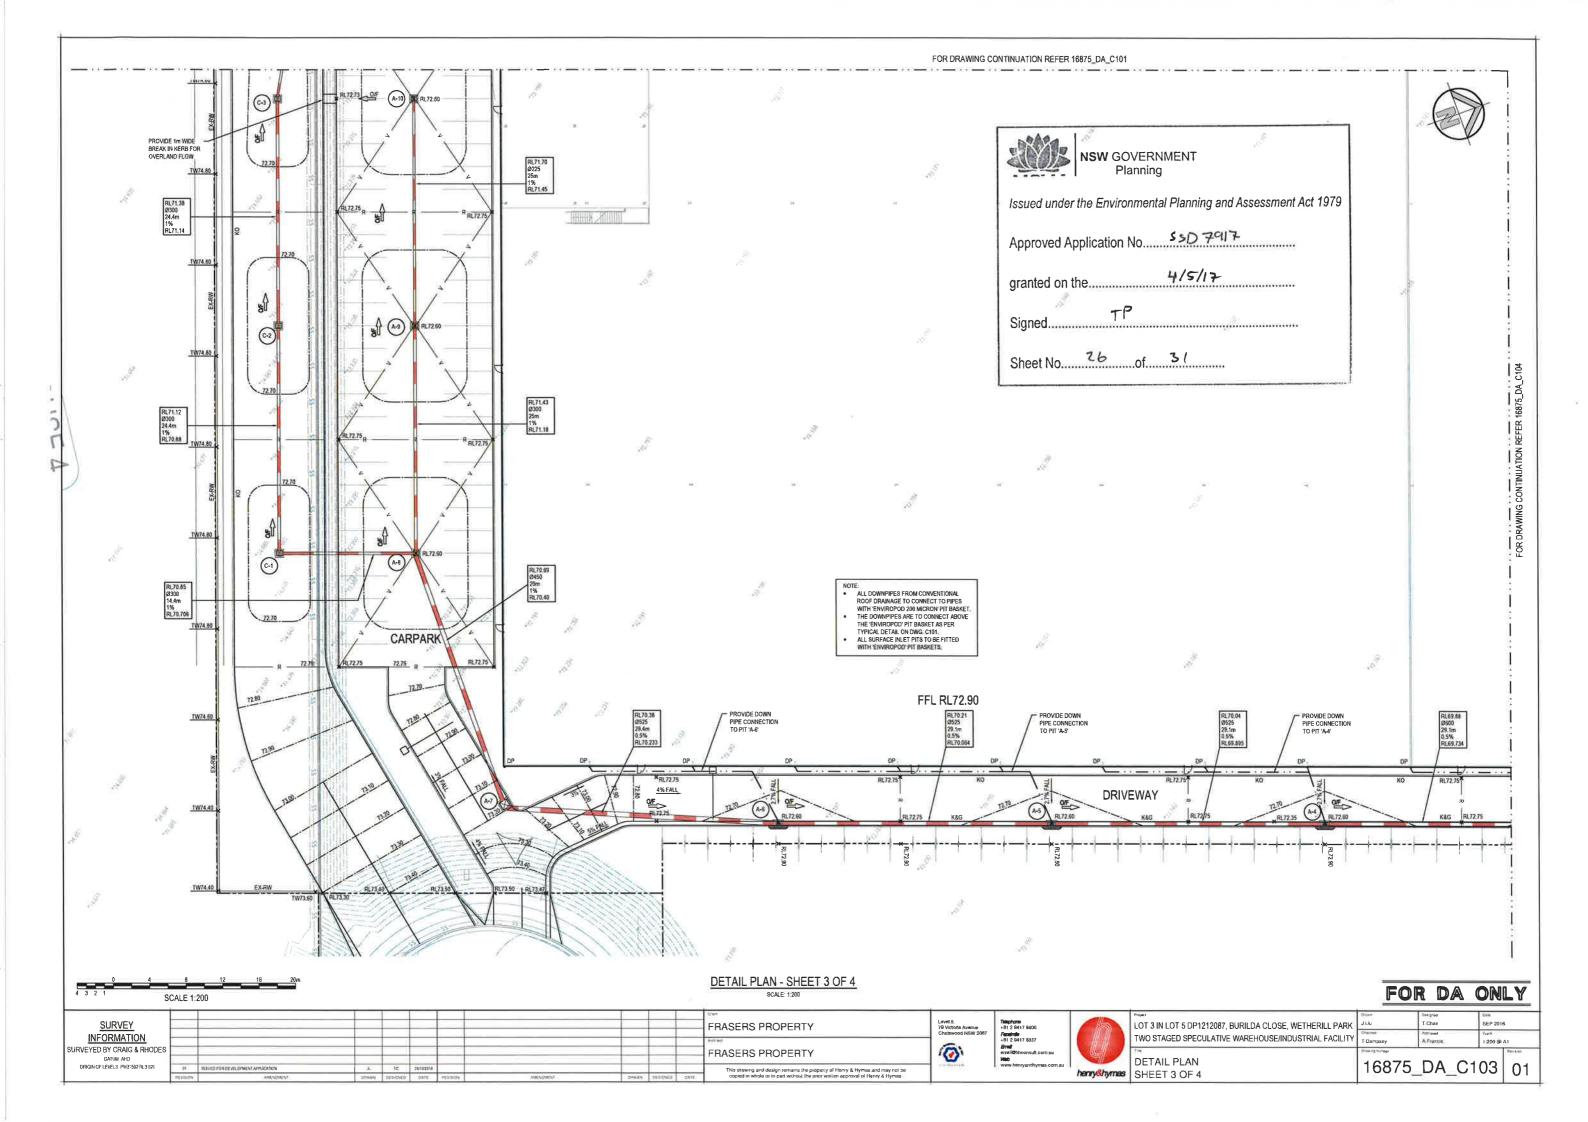

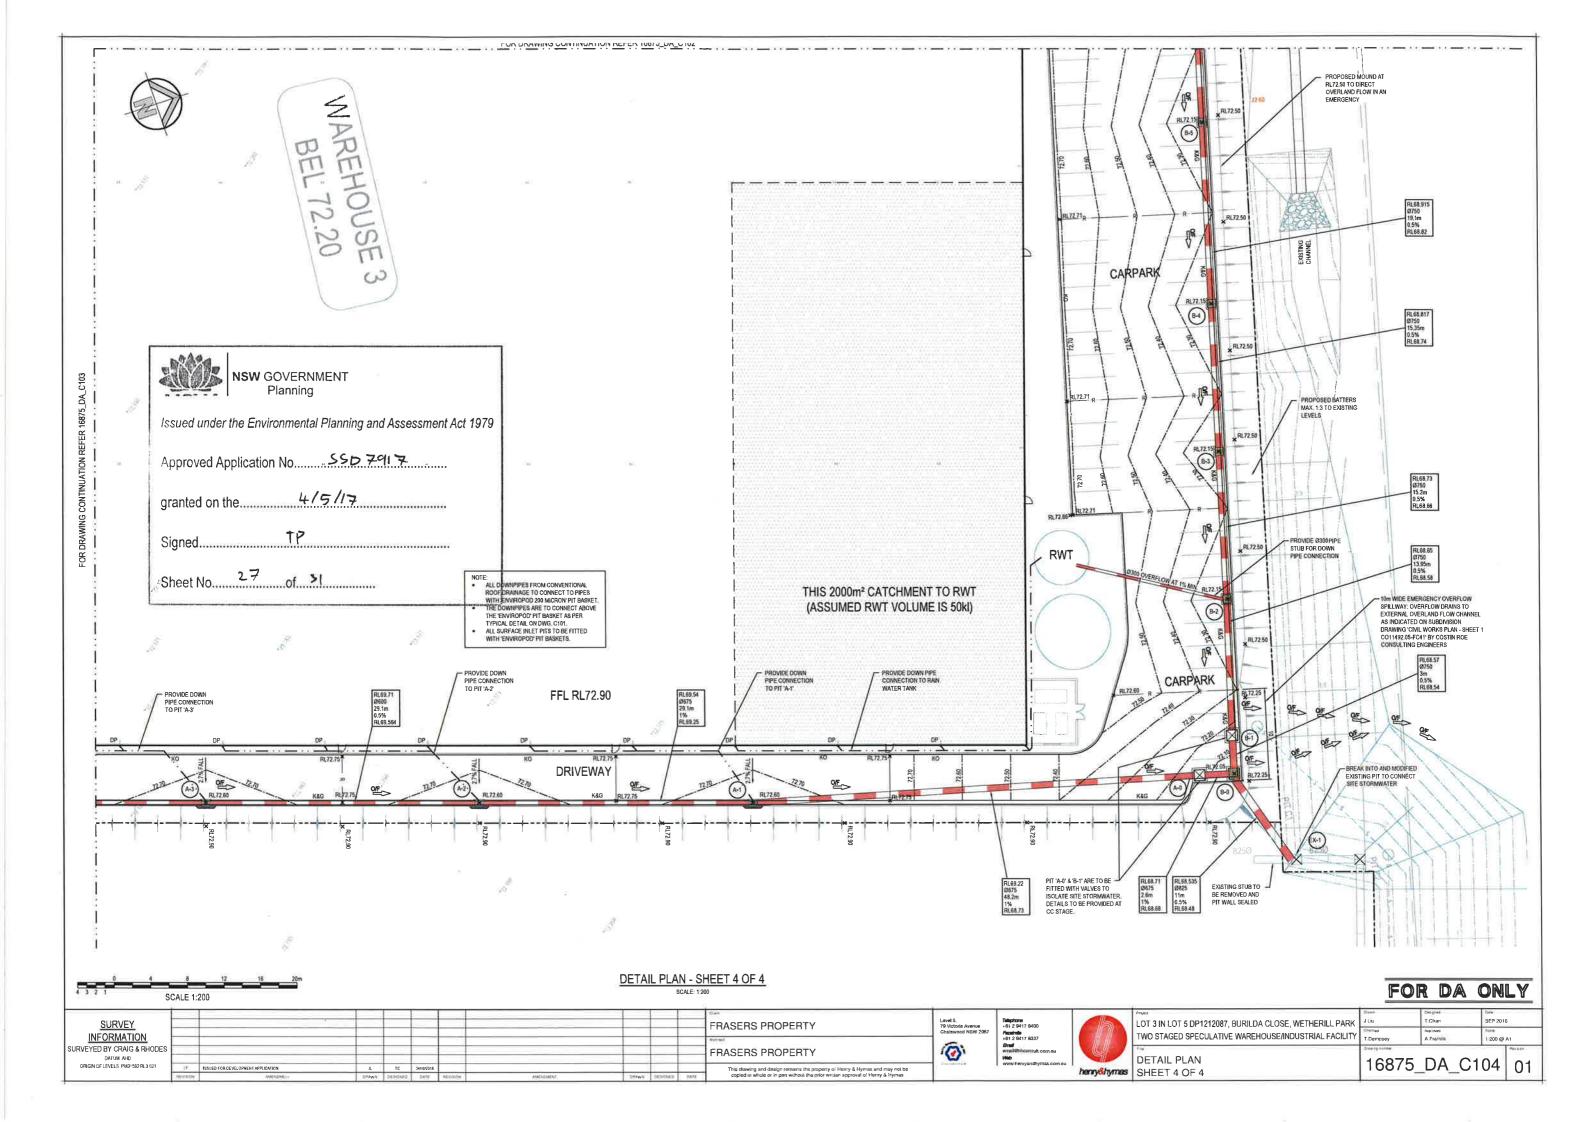

TYPICAL PIT CHAMBER SIZES IT IS THE CONTRACTORS RESPONSIBILITY TO SELECT PIT CHAMBER SIZE WITH REGARDS TO PIPE SIZE, DEPTH TO INVERT AND SKEW ANGLE, REFER SKETCHES BELOW.


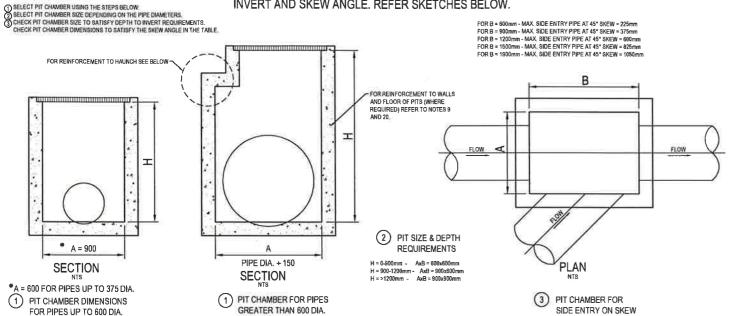


		TABLE 3		
SUPPORT TYPE	BED ZONE X	HAUNCH ZONE Y	BED AND HAUNCH ZONES COMPACTION	MAX BEDDING FACTOR
HS1		0.1D	50	2,0
HS2	100 IF D<=1500, OR 150 IF D>=1500	0.3D	60	2,5
HS3	130 11 02-1300	0.3D	70	4.0

TAI	BLE 2
SIEVE SIZE (MM)	WEIGHT PASISNG (%
19,0	100
2,36	100 TO 50
0,60	90 TO 20
0,30	60 TO 10
0,15	25 TO 0
0,075	10 TO 0

TABLE 1				
SIEVE SIZE (MM)	WEIGHT PASISNG (%)			
75.0	100			
9,5	100 TO 50			
2.36	100 TO 30			
0,60	50 TO 15			
0.075	25 TO 0			

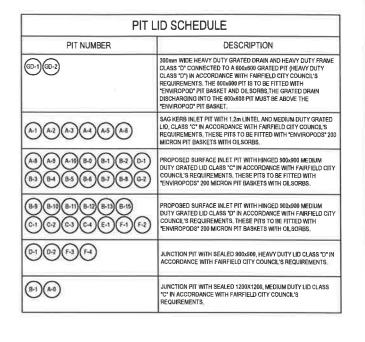

DRAINAGE NOTES:

COMPLY WITH AS 3500 PART 3

2. CONTRACTOR SHALL BE RESPONSIBLE FOR MAINTAINING THE MINIMUM COVER OF 600mm ON ALL PIPES,

3. PROTECTION OF PIPES DUE TO LOADS EXCEEDING W7 WHEEL LOAD SHALL BE THE CONTRACTOR'S

4. BEDDING TYPE SHALL BE TYPE H2 FOR RCP, WHERE NECESSARY THE OVERLAY ZONE SHALL BE REDUCED TO ACCOMMODATE PAVEMENT REQUIREMENTS, REFER TO THIS DRAWING FOR DETAILS.

5, MINIMUM COVER OVER EXISTING PIPES FOR PROTECTION DURING CONSTRUCTION SHALL BE 800mm. 6, NO CONSTRUCTION LOADS SHALL BE APPLIED TO PLASTIC PIPES.

7. FINISHED SURFACE LEVELS SHOWN ON LAYOUT PLAN DRGS TAKE PRECEDENCE OVER DESIGN DRAINAGE

8. ALL PIPES UP TO AND INCLUDING 300 DIA. SHALL BE SOLVENT OR RUBBER RING JOINTED PVC CLASS SH. PIPE TO AS1260. ALL OTHER PIPES TO BE RCP USING CLASS 2 RUBBER RING JOINTED PIPE. HARDIES FRC PIPE MAY BE USED IN LIEU OF RCP IF DESIRED IN GROUND, ALL AERIAL PIPES TO BE PVC CLASS SH,

9. ALL PITS IN NON TRAFFICABLE AREAS TO BE PREFABRICATED POLYESTER CONCRETE "POLYCRETE" WITH "LIGHT

9. ALL PITS IN NON TRAFFICABLE AREAS TO BE PREFABRICATED POLYESTER CONCRETE "POLYCRETE" WITH "LIGHT DUTY" CLASS BOALV, MILD STEEL GRATING AND FRAME. ALL PITS IN TRAFFICABLE AREAS (CLASS "D'LOADING MAX) TO HAVE 150mm THICK CONCRETE WALLS AND BASE CAST IN-SITU PE-22 MPA, REINFORCED WITH NIZ-200 BOTH LOADING WAYS CENTRALLY PLACE LIND, O. ON SEPARATE DESIGN DRAWINGS IN THIS SET, CALVAILD STEEL GRATING AND FRAME TO SUIT DESIGN LOADING, PRECAST PITS, RECTANGULAR OR CIRCULAR IN SHAPE, MAY BE USED IN LIEU AND SHALL COMPLY WITH RELEVANT AUSTRALIAN STANDARDS.

10. ALL PITS, GRATINGS AND FRAMES SHALL BE INSTALLED IN ACCORDANCE WITH THE MANUFACTURERS SPECIFICATION AND TO BE IN ACCORDANCE WITH ASSSOB, 3 AND ASSSOB.

11. PIT CHAMBER DIMENSIONS ARE TO BE SELECTED TO SATISFY THE FOLLOWING:
-PIPE SIZE
-DEPTH TO INVERT

- SKEW ANGLE

- SKEW ANGLE
REFER TYPICAL PIT CHAMBER DETAILS BELOW
IF PIT LID SIZE IS SMALLER THAN THE PIT CHAMBER SIZE THEN THE PIT LID IS TO BE CONSTRUCTED ON THE CORNER
OF THE PIT CHAMBER WITH THE STEP IRONS DIRECTLY BELOW. ALTERNATIVELY THE PIT LID TO BE USED, IS TO BE THE SAME SIZE AS THE PIT CHAMBER

12. FOR PIPE SIZES GREATER THAN Ø300mm. PIT FLOOR IS TO BE BENCHED TO FACILITATE FLOW

13. GALVANISED STEP IRONS SHALL BE PROVIDED AT 300 CTS FOR PITS HAVING A DEPTH EXCEEDING 1200 mm SUBSOIL DRAINAGE PIPE SHALL BE PROVIDED IN PIPE TRENCHES ADJACENT TO INLET PIPES (MINIMUM LENGTH 3m).

14, ALL SUBSOIL PIPES SHALL BE 100mm SLOTTED PVC IN A FILTER SOCK, UNO, WITH 3m INSTALLED UPSTREAM OF

15. ALL PIPEWORK SHALL HAVE MINIMUM DIAMETER 100.

16. MINIMUM GRADE FOR ROOFWATER DRAINAGE LINES SHALL BE 1%

17. ALL PIPE JUNCTIONS AND TAPER UP TO AND INCLUDING 300 DIA SHALL BE VIA PURPOSE MADE FITTINGS.

18, ALL ROOF DRAINAGE TO BE INSTALLED IN ACCORDANCE WITH AS3500, PART 3, TESTING TO BE UNDERTAKEN


19, LOCATION OF THE DIRECT DOWN PIPE CONNECTIONS MAY VARY ON SITE TO SUIT SITE CONDITIONS, WHERE CONNECTION SHOWN ON LONG SECTIONS CHAINAGES ARE INDICATIVE ONLY.

20, PITS IN EXCESS OF 1,5 m DEEP TO HAVE WALL AND FLOOR THICKNESS INCREASED TO 200mm, REINFORCED WITH N12@200 CTS CENTRALLY PLACED BOTH WAYS THROUGHOUT U.N.O.ON SEPARATE DESIGN DRAWINGS IN THIS SET. IF DEPTH EXCEEDS 5m CONTACT ENGINEER

21. SUBSOIL DRAINAGE LINES FOR LANDSCAPE AREA NOT SHOWN ON THESE DRAWINGS, REFER TO LANDSCAPING

22. ALL STORMWATER PITS TO HAVE Ø100 uPVC SLOTTED SUBSOIL PIPES CONNECTED TO THEM. THESE SUBSOILS

TO EXTEND 3m UPSTREAM OF THE PIT AT A MINIMUM GRADE.

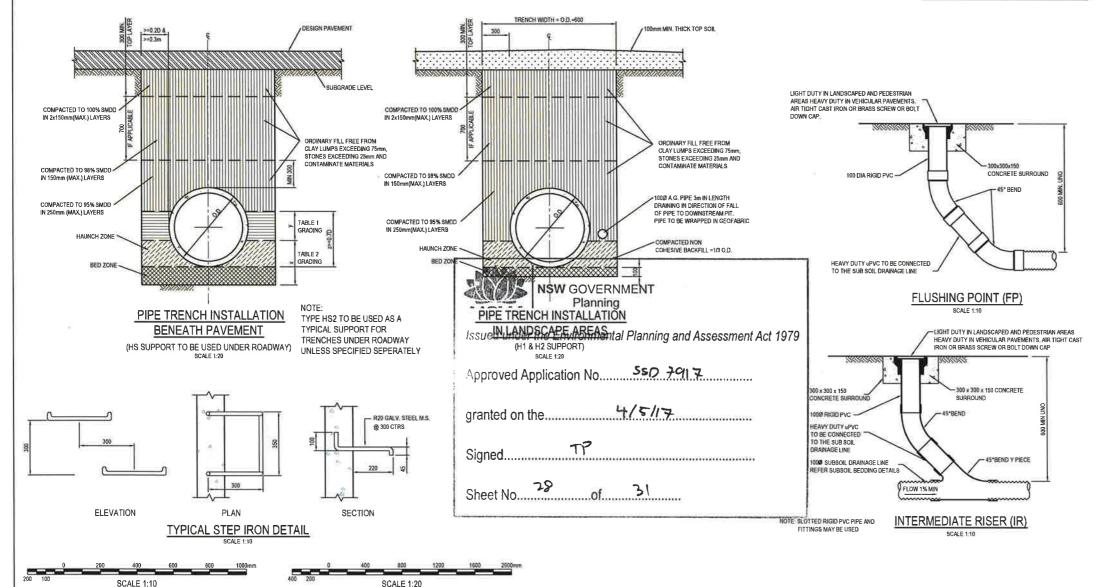

FOR DA ONLY

FRASERS PROPERTY FRASERS PROPERTY This drawing and design remains the property of Henry & Hymas and may not be copied in whole or in part without the prior written approval of Henry & Hymas

(Q)





LOT 3 IN LOT 5 DP1212087, BURILDA CLOSE, WETHERILL PARK TWO STAGED SPECULATIVE WAREHOUSE/INDUSTRIAL FACILITY


STORMWATER MISCELLANEOUS DETAILS


SEP 2016 OWN @ A1

16875 DA C200 01

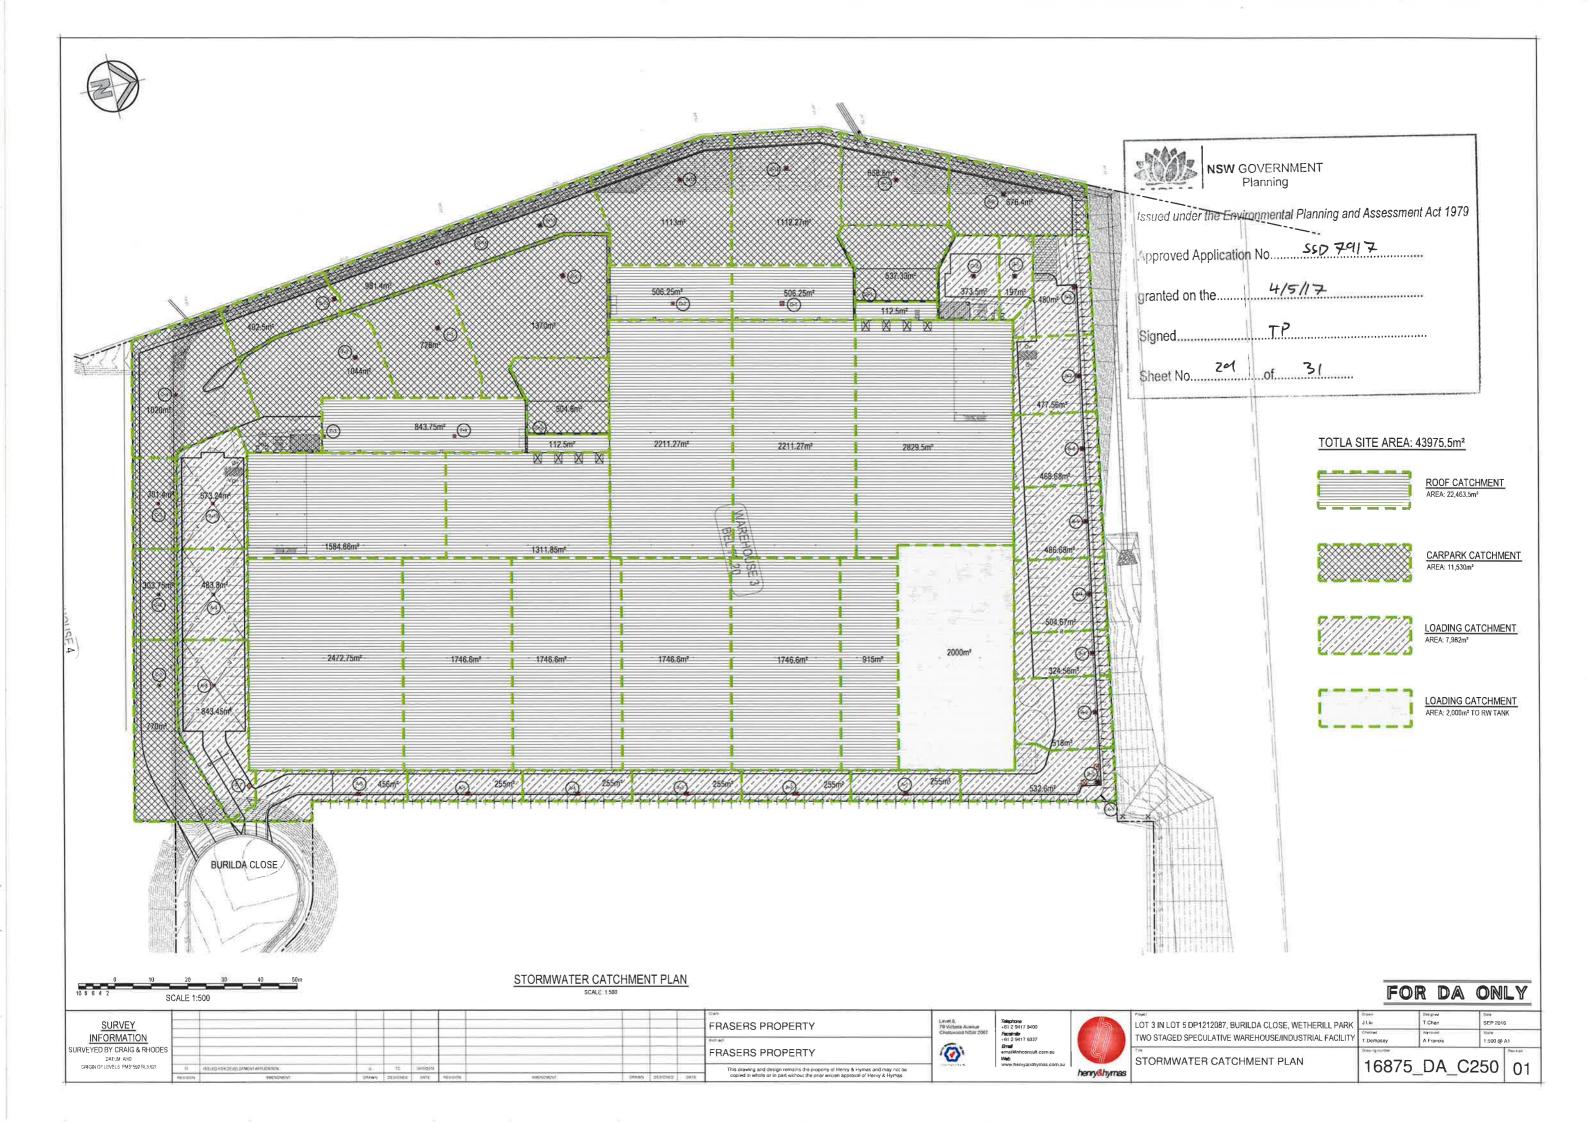

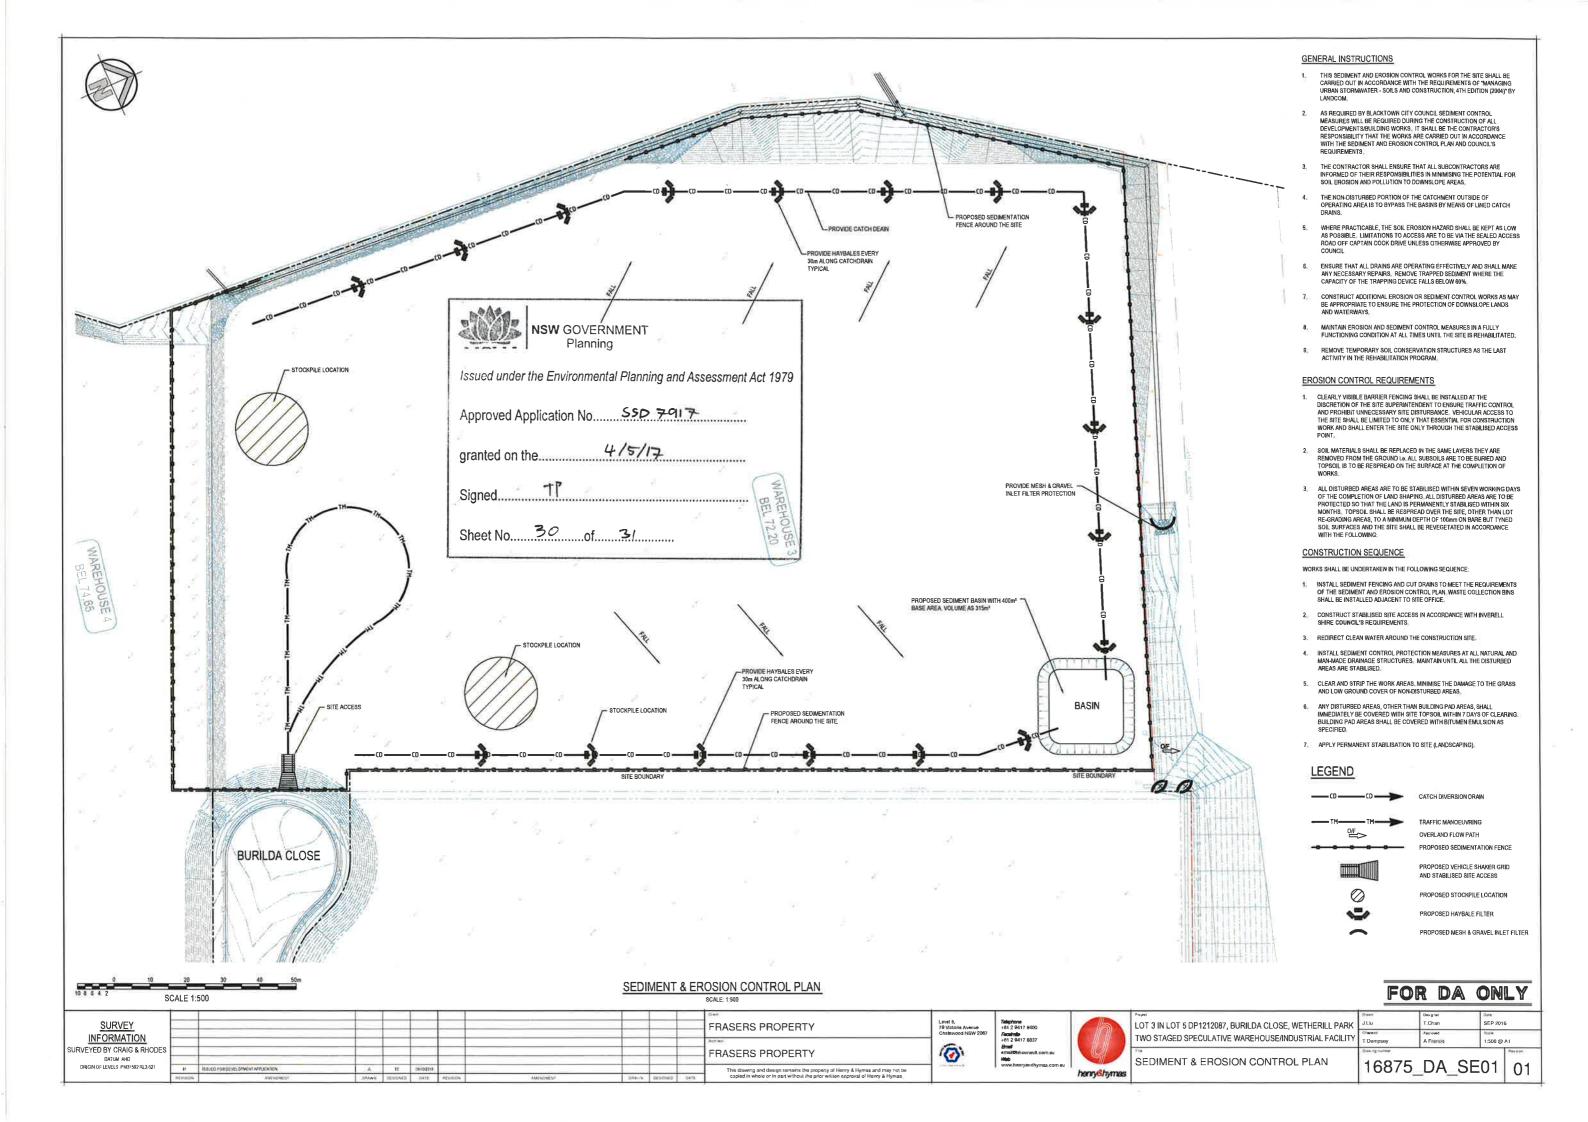


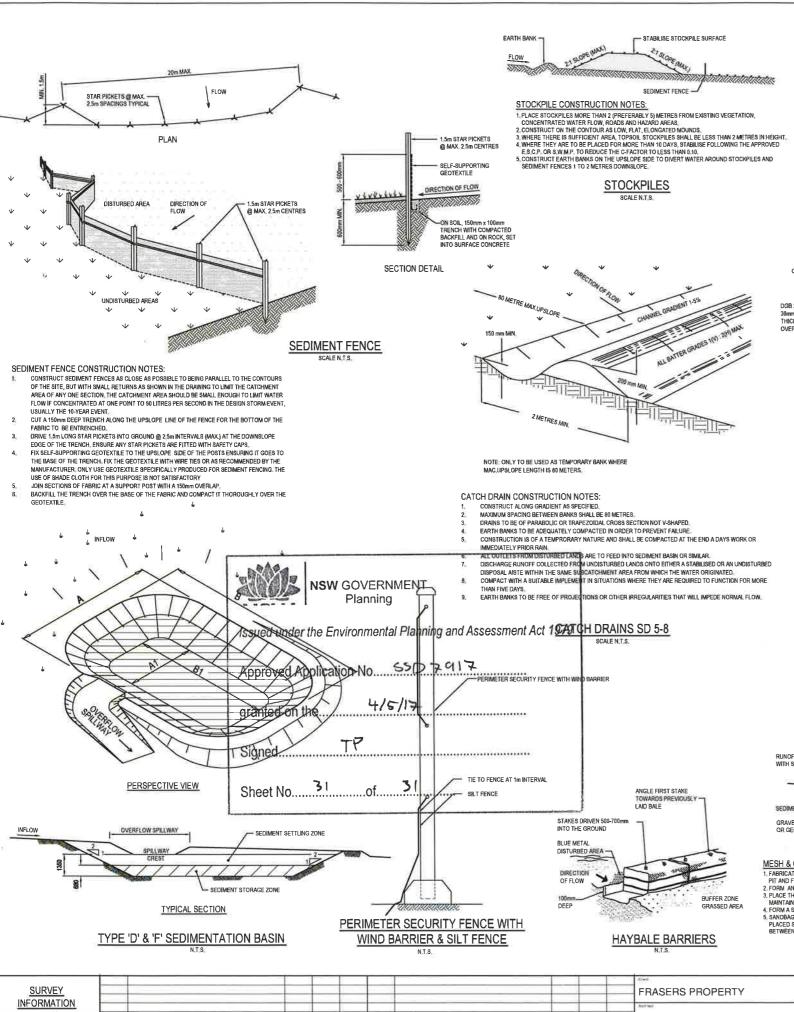

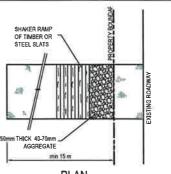

PLAN STABILISED SITE ACCESS WITH SHAKER RAMP

CONSTRUCTION SITE

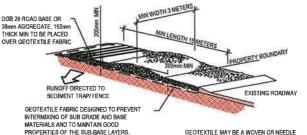


STABILISED SITE ACCESS WITH SHAKER RAMP


PUNCHED PRODUCT WITH A MINIMUM CBR

BURST STRENGTH (AS3706.4-90) OF 2500 N

NOTES:

- THIS DEVICE IS TO BE LOCATED AT ALL EXITS FROM CONSTRUCTION SITE.
- THIS DEVICE IS TO BE REGULARLY CLEANED OF DEPOSITED MATERIAL, SO AS TO MAINTAIN A 50mm DEEP SPACE BETWEEN PLANKS.
- ANY UNSEALED ROAD BETWEEN THIS DEVICE AND NEAREST ROADWAY IS TO BE TOPPED WITH 100mm THICK 40-70mm SIZE AGGREGATE:
- ALTERNATIVELY, THREE(3) PRECAST CONCRETE CATTLE GRIDS (AS MANUFACTURED BY "HUMES CONCRETE MAY BE USED, 1, 2 8.3 ABOVE ALSO APPLY,

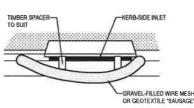

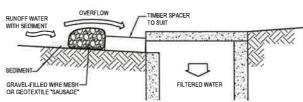

MESH & GRAVEL INLET FILTER CONSTRUCTION NOTES:

- MESH & GRAVEL INLET FILTER CONSTRUCTION NOTES:

 1. FABRICATE A SLEEVE MADE FROM GEOTEXTILE OR WIRE MESH LONGER THAN THE LENGTH OF THE INLET PIT AND FILL IT WITH 25mm TO 50mm GRAVEL.

 2. FORM. AN ELIPTICAL CROSS-SECTION ABOUT 150mm HIGH x 400mm WIDE.

 3. PLACE THE FILTER AT THE OPENING LEAVING AT LEAST A 100mm SPACE BETWEEN IT AND THE KERB INLET.

 MAINTAIN THE OPENING WITH SPACER BLOCKS.

 4. FORM A SEAL WITH THE KERB TO PREVENT SEDIMENT BYPASSING THE FILTER.

 5. SANDBAGS FILLED WITH GRAVEL CAN SUBSTITUTE FOR THE MESH OR GEOTEXTILE PROVIDING THEY ARE PLACED SO THAT THEY CAN FIRMLY ABUT EACH OTHER AND SEDIMENT /LADEN WATERS CANNOT PASS BETWEEN.

MESH & GRAVEL INLET FILTER

SEDIMENT BASIN SIZING

THE SEDIMENT BASIN SHALL BE CONSTRUCTED ON A RATE PER HECTARE BASIS AND HAS BEEN IN ACCORDANCE WITH THE REQUIREMENTS OF THE LANDCOM MANUAL "MANAGING URBAN STORMWATER - SOLS AND CONSTRUCTION", FOR SEDIMENTATION TYPE D SOLS. THE DIVIDED AREA WITHIN THIS CATCHMENT AT ANY ONE TIME SHOULD BE LIMITED TO AN AREA FOR WHICH EACH SEDIMENT BASIN CAN HANDLE, EACH BASIN SHALL BE SIZED IN ACCORDANCE WITH THE TABLE BEEUW,

SEDIMENT BASIN SIZIN	G TYPE D SOILS
VOLUMETRIC RUNOFF COEFFICIENT, CV	0.25 (APPENDIX F - TABLE F2)
75TH PERCENTILE 5 DAY TOTAL RAINFALL DEPTH, R	19,0 mm
CATCHMENT AREA, A	1 Ha (UNIT AREA)
SETTLING ZONE VOLUME (PER HECTARE) 10 CV A R	47.5 m³
DISTURBED CATCHMENT AREA	1 Ha (UNIT AREA)
RKLSPC	110,87m³
SEDIMENT ZONE VOLUME (0,17 A (R K LS P C)/1,3	14,5m² < 50% SETTLING VOL
TOTAL SEDIMENT BASIN VOLUME REQUIRED	71,25 m³/Ha

*(LANDCOM MANAGING URBAN STORMWATER MANUAL REFERENCE)

THE FOLLOWING DESIGN PARAMETERS HAVE BEEN ASSESSED FOR THE SITE:

CONSTRAINT	VALUE	(SOURCE)*		
RAINFALL EROSIVITY (R-FACTOR)	2350	APPENDIX B		
LENGTH/SLOPE GRADIENT FACTOR, LS	0,955	APPENDIX A - TABLE A1		
SOIL ERODIBILITY (K-FACTOR)	0,038	(TABLE C20 - BLACKTOWN)		
EROSION CONTROL PRACTICE FACTOR (P-FACTOR)	1.3 (COMPACTED)	APPENDIX A - TABLE A2		
COVER FACTOR (C-FACTOR)	1.0 (DURING EARTHWORKS)	APPENDIX A - FIGURE A5		
CALCULATED SOIL LOSS, A (RUSLE EQUATION)	110,87VHa/YR	A = R K LS P C APPENDIX C TABLE 20		
SOIL HYDROLOGIC GROUP	GROUP C			
SEDIMENT TYPE	TYPE D	APPENDIX C TABLE 4		
STH PERCENTILE 5-DAY RAINFALL EVENT	19,0mm (BLACKTOWN)	TABLE 6.3A		

*(LANDCOM MANAGING URBAN STORMWATER MANUAL REFERENCE)

BASIN MANAGEMENT

- THE CAPTURED STORMWATER IN THE SETTLING ZONE SHOULD BE DRAINED TO MEET THE MINIMUM STORAGE CAPACITY REQUIRED WITHIN A FIVE (5) DAY PERIOD FOLLOWING RAINFALL, PROVIDED THE ACCEPTABLE WATER QUALITY (NFR) AND TURBIDITY HAVE BEEN ACHIEVED.
- 2, CHEMICAL FLOCCULENT SUCH AS GYPSUM MAY BE DOSED TO AID SETTLING WITHIN 24 HOURS OF CONCLUSION OF EACH STORM, THE APPLIED DOSING RATES SHOULD ACHIEVE THE TARGET QUALITY WITHIN 36 TO 72 HOURS OF THE STORM EVENT
- 3, INSPECT THE SEDIMENT BASINS AFTER EACH RAINFALL EVENT AND/OR WEEKLY, ENSURE THAT ALL SEDIMENT IS REMOVED ONCE THE SEDIMENT STORAGE ZONE IS FULL (REFER TO PEGS INSTALLED IN BASINS IN ACCORDANCE WITH THE SWMP), ENSURE THAT OUTLET AND EMERGENCY SPILLWAY WORKS ARE MAINTAINED IN A FULLY OPERATIONAL CONDITION AT ALL TIMES.

SOWING SEASON	SEED MIX		
AUTUMN/WINTER	OATS@40KG/Ha + JAPANESE MILLET@10kg/Ha		
SPRING/SUMMER	OATS@20kg/Ha + JAPANESE MILLET@20kg/Ha		

NOTE: THESE PLANT SPECIES ARE FOR TEMPORARY REVEGETATION ONLY. THEY WILL ONLY PROVIDE PROTECTION FROM EROSION FOR SIX MONTHS. WHERE THE LOTS ARE TO BE LEFT UNDEVELOPED FOR A LONGER PERIOD, THE CONTRACTOR SHALL SEEK ADVICE FROM THE SITE SUPERINDENDENT AS TO MORE APPROPRIATE REVEGETATION METHODS.

REVEGETATION IN ACCORDANCE WITH THE ABOVE TABLE WILL BE ENHANCED BY ADDING LIME AT A RATE OF 4kg/TONNE OF TOPSOIL

4. THE LONG TERM GROUND COVER FACTORS FOR THE CONSTRUCTION WORKS IS NOT TO EXCEED THE FOLLOWING LIMITS:


LAND	MAXIMUM C-FACTOR	REMARKS		
WATERWAYS AND OTHER AREAS OF CONCENTRATED FLOWS, POST CONSTRUCTION	0.05	APPLIES AFTER TEN WORKING DAYS OF COMPLETION OF FORMATION AND BEFORE CONCENTRATED FLOWS ARE APPLIED. FOOT AND VEHICULAR TRAFFIC IS PROHIBITED IN THIS AREA AND 70% GROUND COVER IS REQUIRED.		
STOCKPILES, POST CONSTRUCTION	0,10	APPLIES AFTER TEN WORKING DAYS FROM COMPLETION OF FORMATION, 60% GROUND COVER IS REQUIRED.		
ALL LANDS, INCLUDING WATERWAYS AND STOCKPILES, DURING CONSTRUCTION.	0,15	APPLIES AFTER 20 DAYS OF INACTIVITY, EVEN THOUGH WORKS MAY BE INCOMPLETE, 50% GROUND COVER IS REQUIRED.		

FOR DA ONLY

SURVEY						FRASERS PROPERTY
INFORMATION						And help
SURVEYED BY CRAIG & RHODES						FRASERS PROPERTY
ORIGIN OF LEVELS PM31592 RL3.621	61	ESSUED FOR DEWY DEMENT APPLICATION	 to	34152319		The drawing and decompany the emporis of Henry & Human and may not be

0



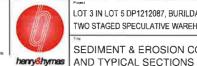

1	LOT 3 IN LOT 5 DP1212087, BURILDA CLOSE, WETHERILL PARK TWO STAGED SPECULATIVE WAREHOUSE/INDUSTRIAL FACILITY	
1	SEDIMENT & EROSION CONTROL DETAILS	İ

SEP 2016 NTS

16875 DA SE02

01