

Wenona Project Archimedes

LANDSCAPE - MAIN WORKS

FOR DEVELOPMENT APPLICATION

DRAWING REGISTER

Scale	Drawing Title	Size	Scale
General LAN-000	Cover Page and Drawing Schedule	A1	N/A
Plans			
LAN-100	Lower Ground Mez Public Domain Make Good Works	A1	1:100
LAN-101	Lower Ground 1 Plan	A1	1:100
LAN-102	Ground Floor Plan	A1	1:100
LAN-103	Level 1 Plan	A1	1:100
LAN-104	Level 2 Plan	A1	1:100
Planting			
LAN-800	Planting Schedule & Palette	A1	A/S

GENERAL NOTES

FOR DEVELOPMENT APPLICATION ONLY NOT FOR CONSTRUCTION

Do not scale from drawings

All work to be carried out in accordance to the Technical Specification

All discrepancies or conflict should be brought to the attention of the Project Landscape

Larger scale drawings and written dimensions take preference

All dimensions in mm unless otherwise stated.

* All tree dimensions and RLs in metres.

* Use figured dimensions only.

* Verify all dimensions on site before the commencement of any works.

* Contractors shall locate and protect all services prior to construction.

* All work shall be carried out in accordance with ASA, BCA and Local Government Regulations.

* Structural Details shall be subject to Engineer's Specifications.

* Drainage & Water Feature Details shall be subject to Hydraulic Engineer's Specifications.

* All work shall be carried out in a professional manner by Qualified Tradesman according to Landscape Drawings and Engineer's Specifications.

*Protect all adjoining property building, walls and paving. Damaged elements are to be replaced.

* No responsibility will be taken by 360 degrees. for any variations in design, construction method, materials specified, and general specifications without permission from the Project Engineer or Landscape Architect.

*Service location on plans are indicative only . 360 accepts no responsibility for the accuracy of service location. it is the responsibility of the contractor to determine service locations prior to the commencment of work. Any damages remains the responsibility of the contractor.

* This Drawing is copyright to 360 degrees.

LANDSCAPE FINISHES NOTES

* There are to be no sharp protusions or abrasive edges, obstrusive fittings and fixtures

* Adjust extent of each type of soilworks and edging localy as required to accomodate final constructed locations of walls/signage and pavements

* All Garden Bed Levels must be A minimum of 150mm Below Facade Flashing and Waterproof Membrane to Slab. Refer Typical Details

* All Paving and Deck Levels must be setout and co-ordinated with Civil Stormwater Pits and Trench Drains prior to Construction
Refer Civil Engineers Documentation

* Contractor to allow for access to Pits under Timber Deck

* Adjust final location of soilworks and edging localy to suit service infrastructure including services, lines, pillars, valves and the like

* Each area of turf extends to entire area boundary by adjacent walls, pavements, edges, and kerbs as shown

* For all lighting locations to landscape areas refer to Electrical Engineers drawings. Final Location to be confirmed with Projects Landscape Architect

* Finished surface levels and contours are indicative only. Refer to Civil Engineers drawings for final levels

* For all structural details of walls, pavements, and the like refer to Civil Engineers documentation and specification

* Sub soil drainage indicative only. Refer to Engineers documentation for overland flow requirements, extent and details of all sub soil drainage

* Refer to Irrigation Consultant documentation for details and requirements of landscape

PLANTING NOTES


* Adjust final location of planting locally to suit service infrastructure including service lines, pillars, valves and the like.


* Adjust final variation of plant material as directed to suit final extent of each planting area.

* All trees in general landscape grass seeded batter and turf areas are, unless otherwise noted to be provided with a mulch ring with spade finish edge.

* Project Landscape Architect to inspect and approve all Plant material prior to delivery to site.

* Project Landscape Architect to inspect and approve all Plant material setout prior to install

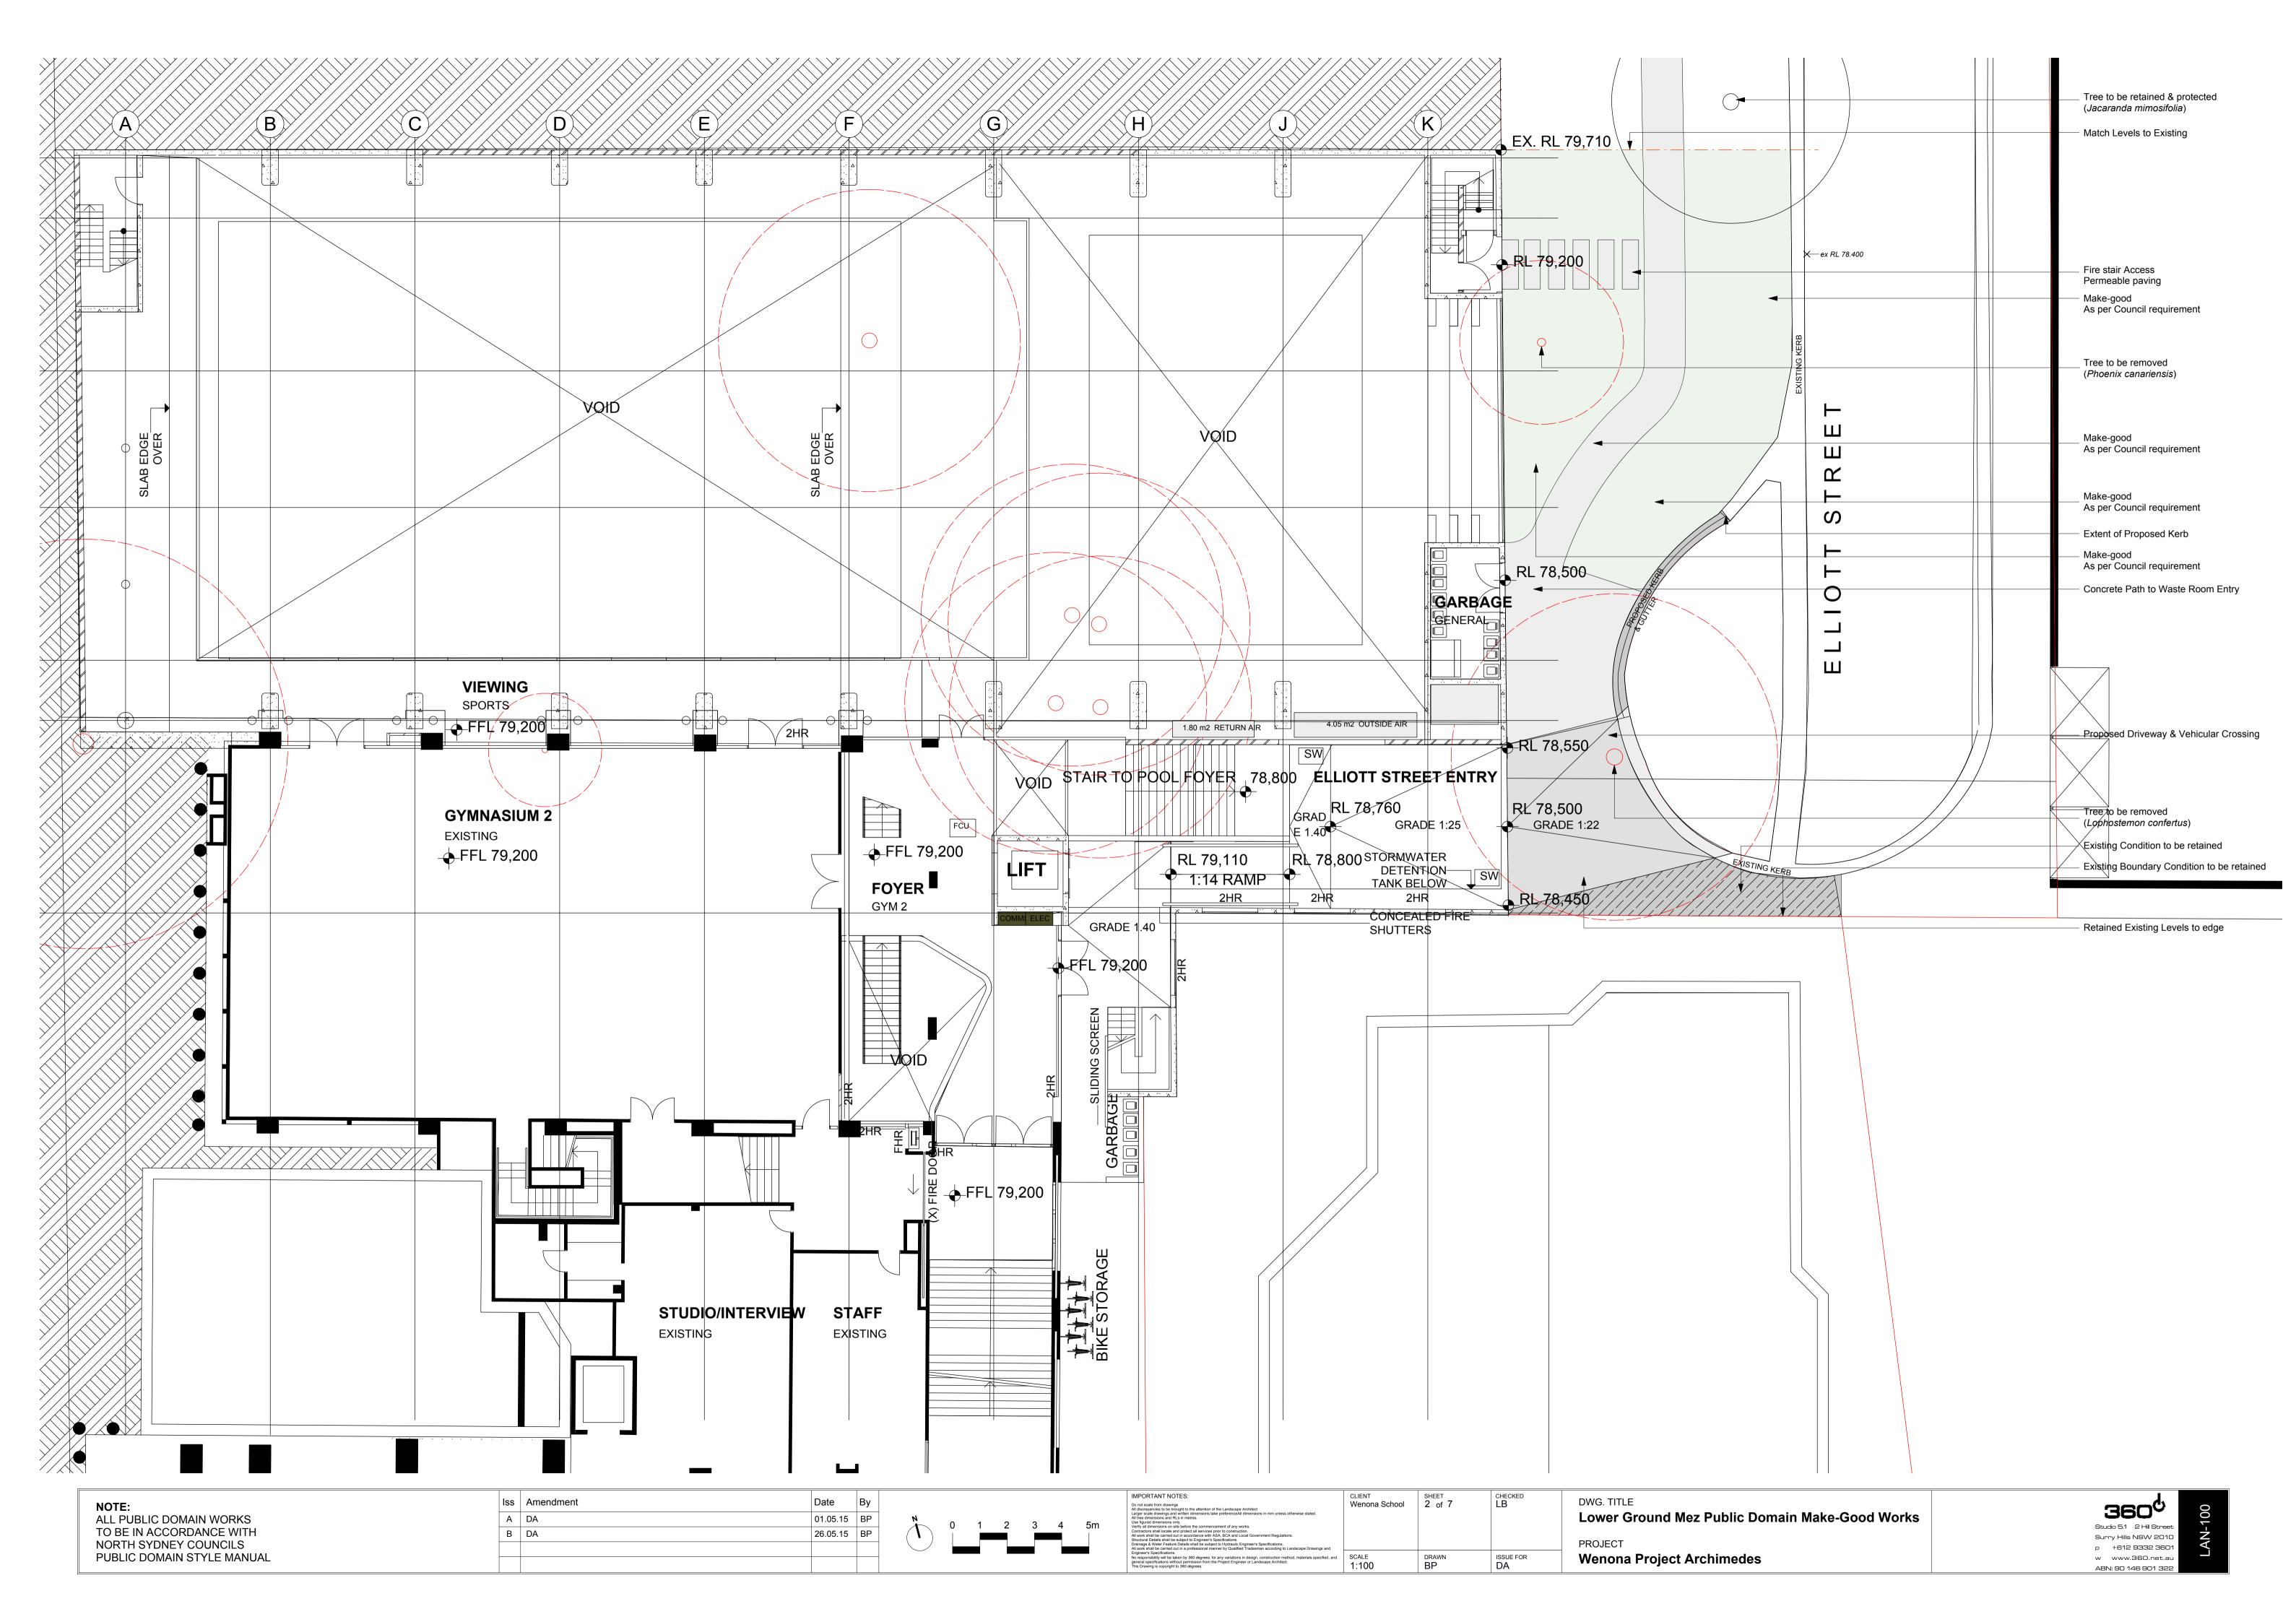

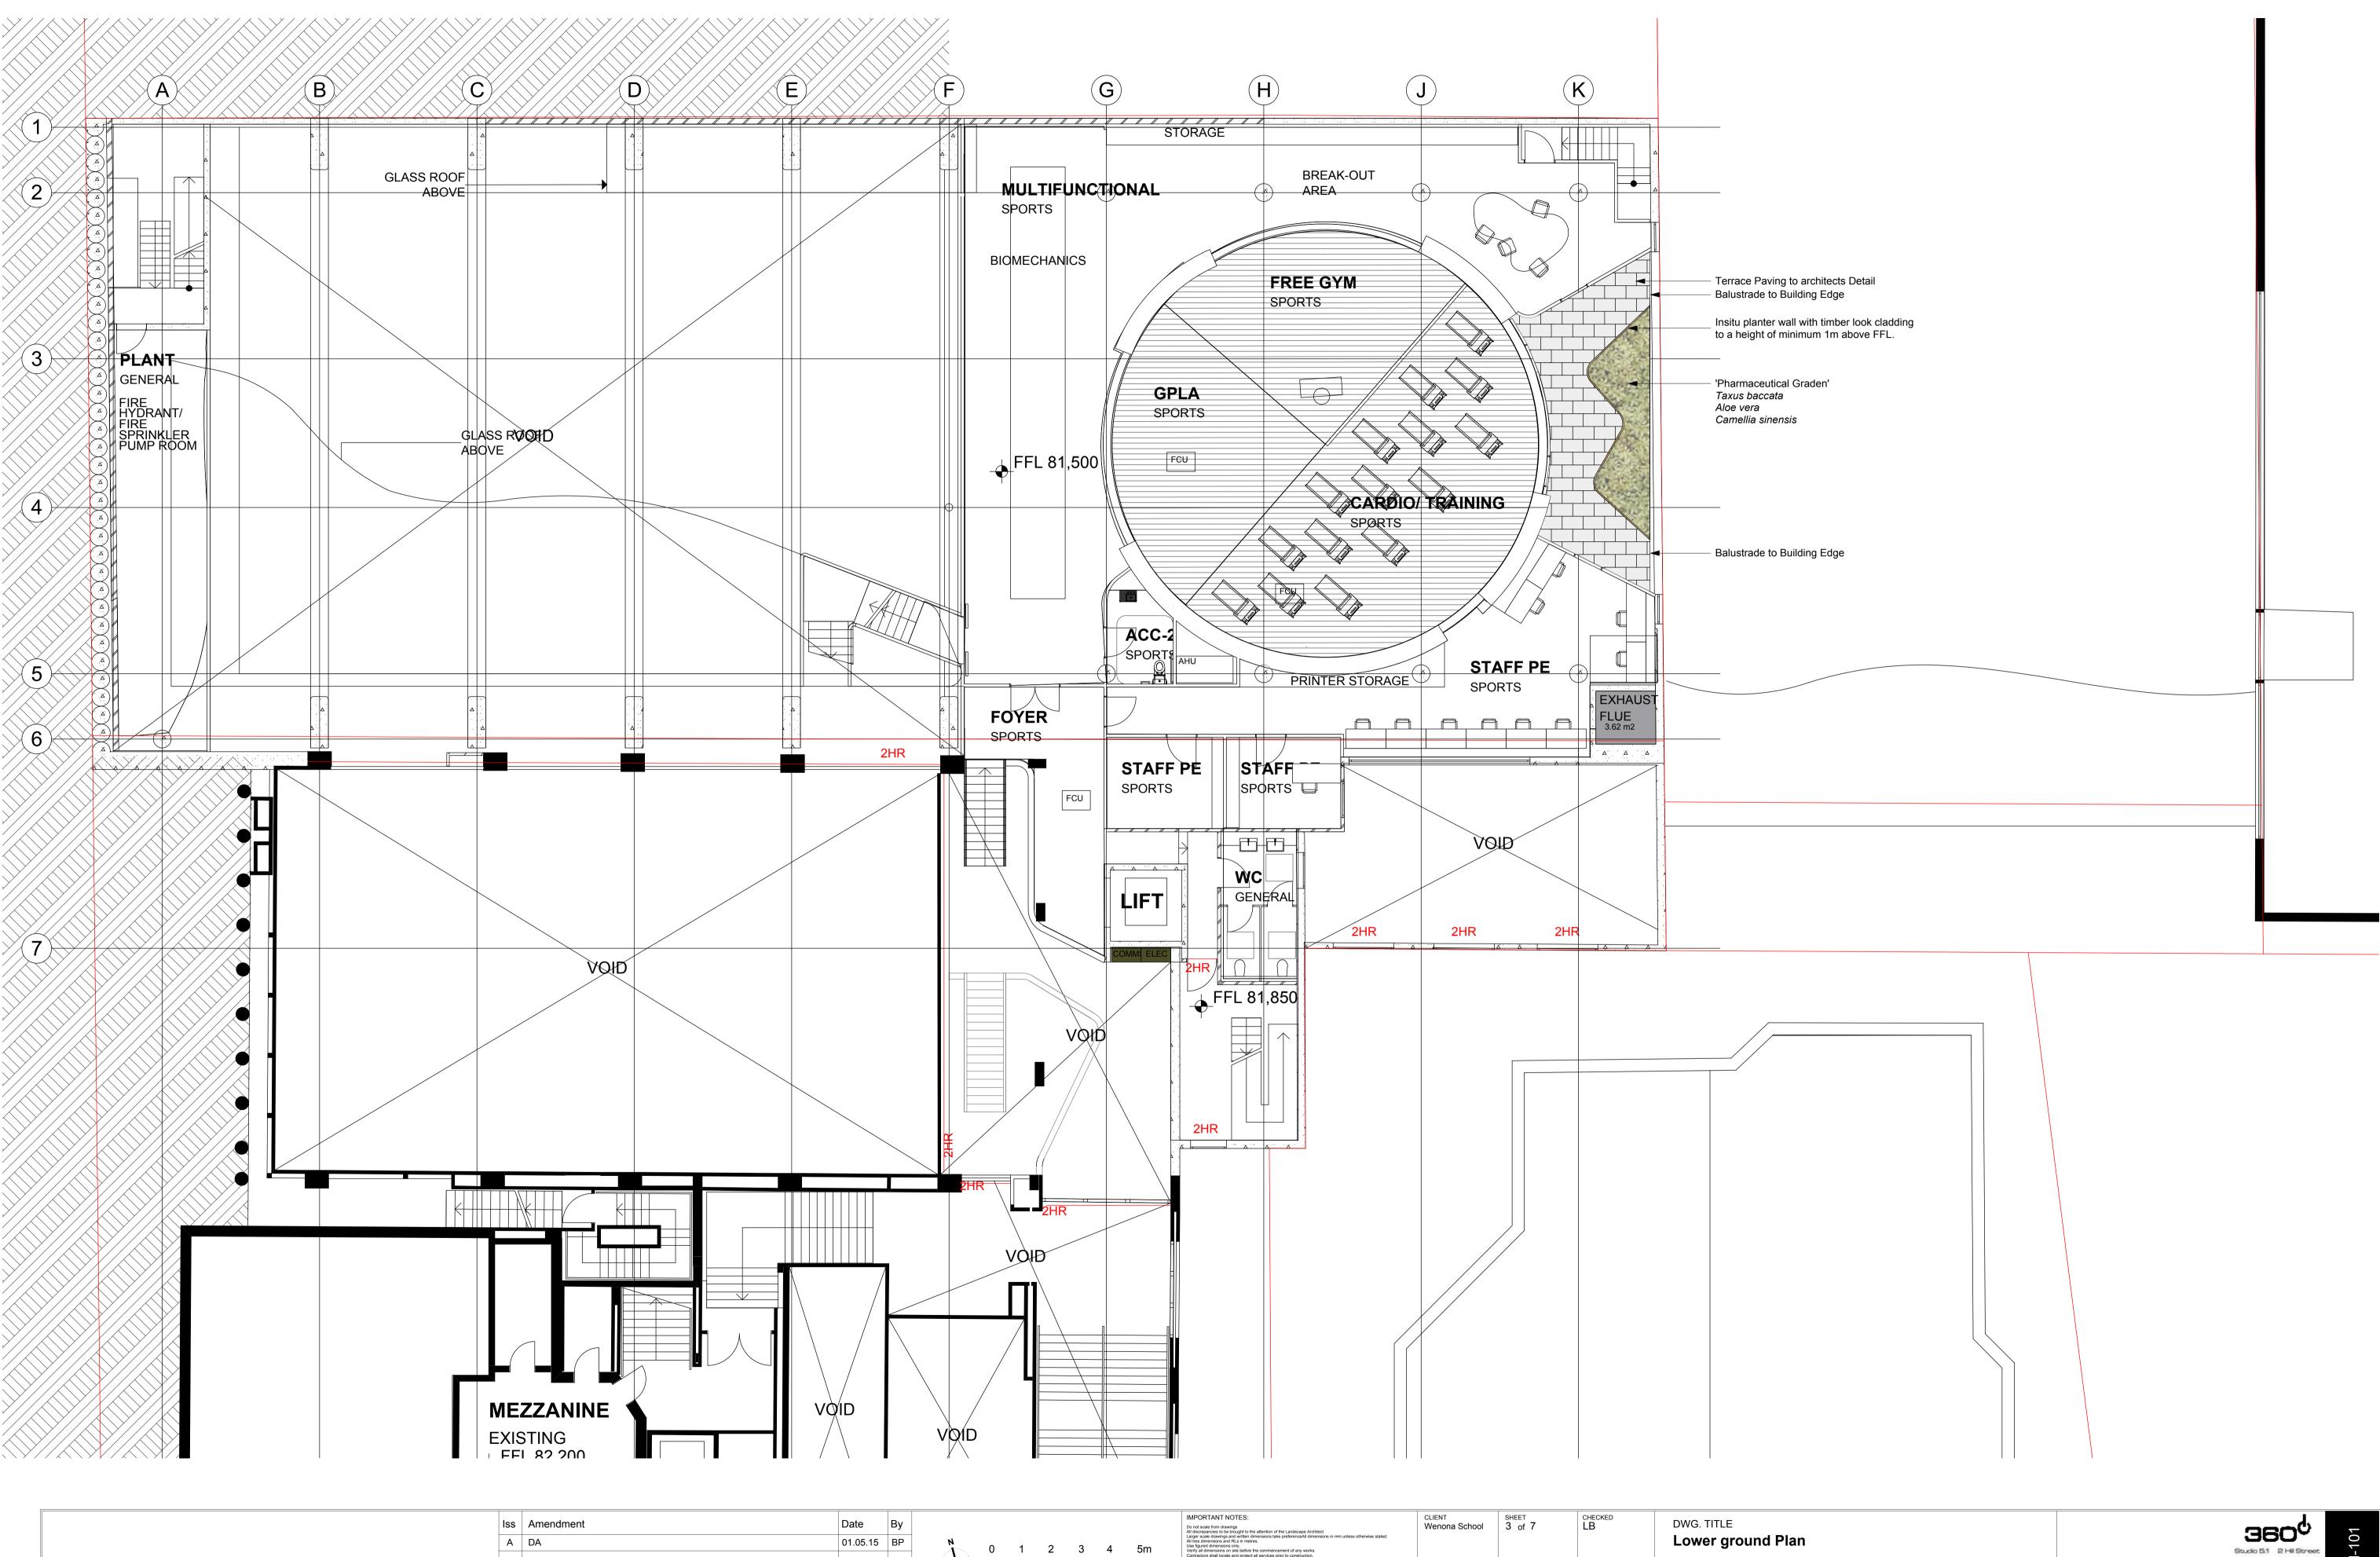


Surry Hills NSW 2010 p +612 9332 3601


w www.360.net.au ABN: 90 146 901 322

PROJECT

Wenona Project Archimedes


DRAWN BP

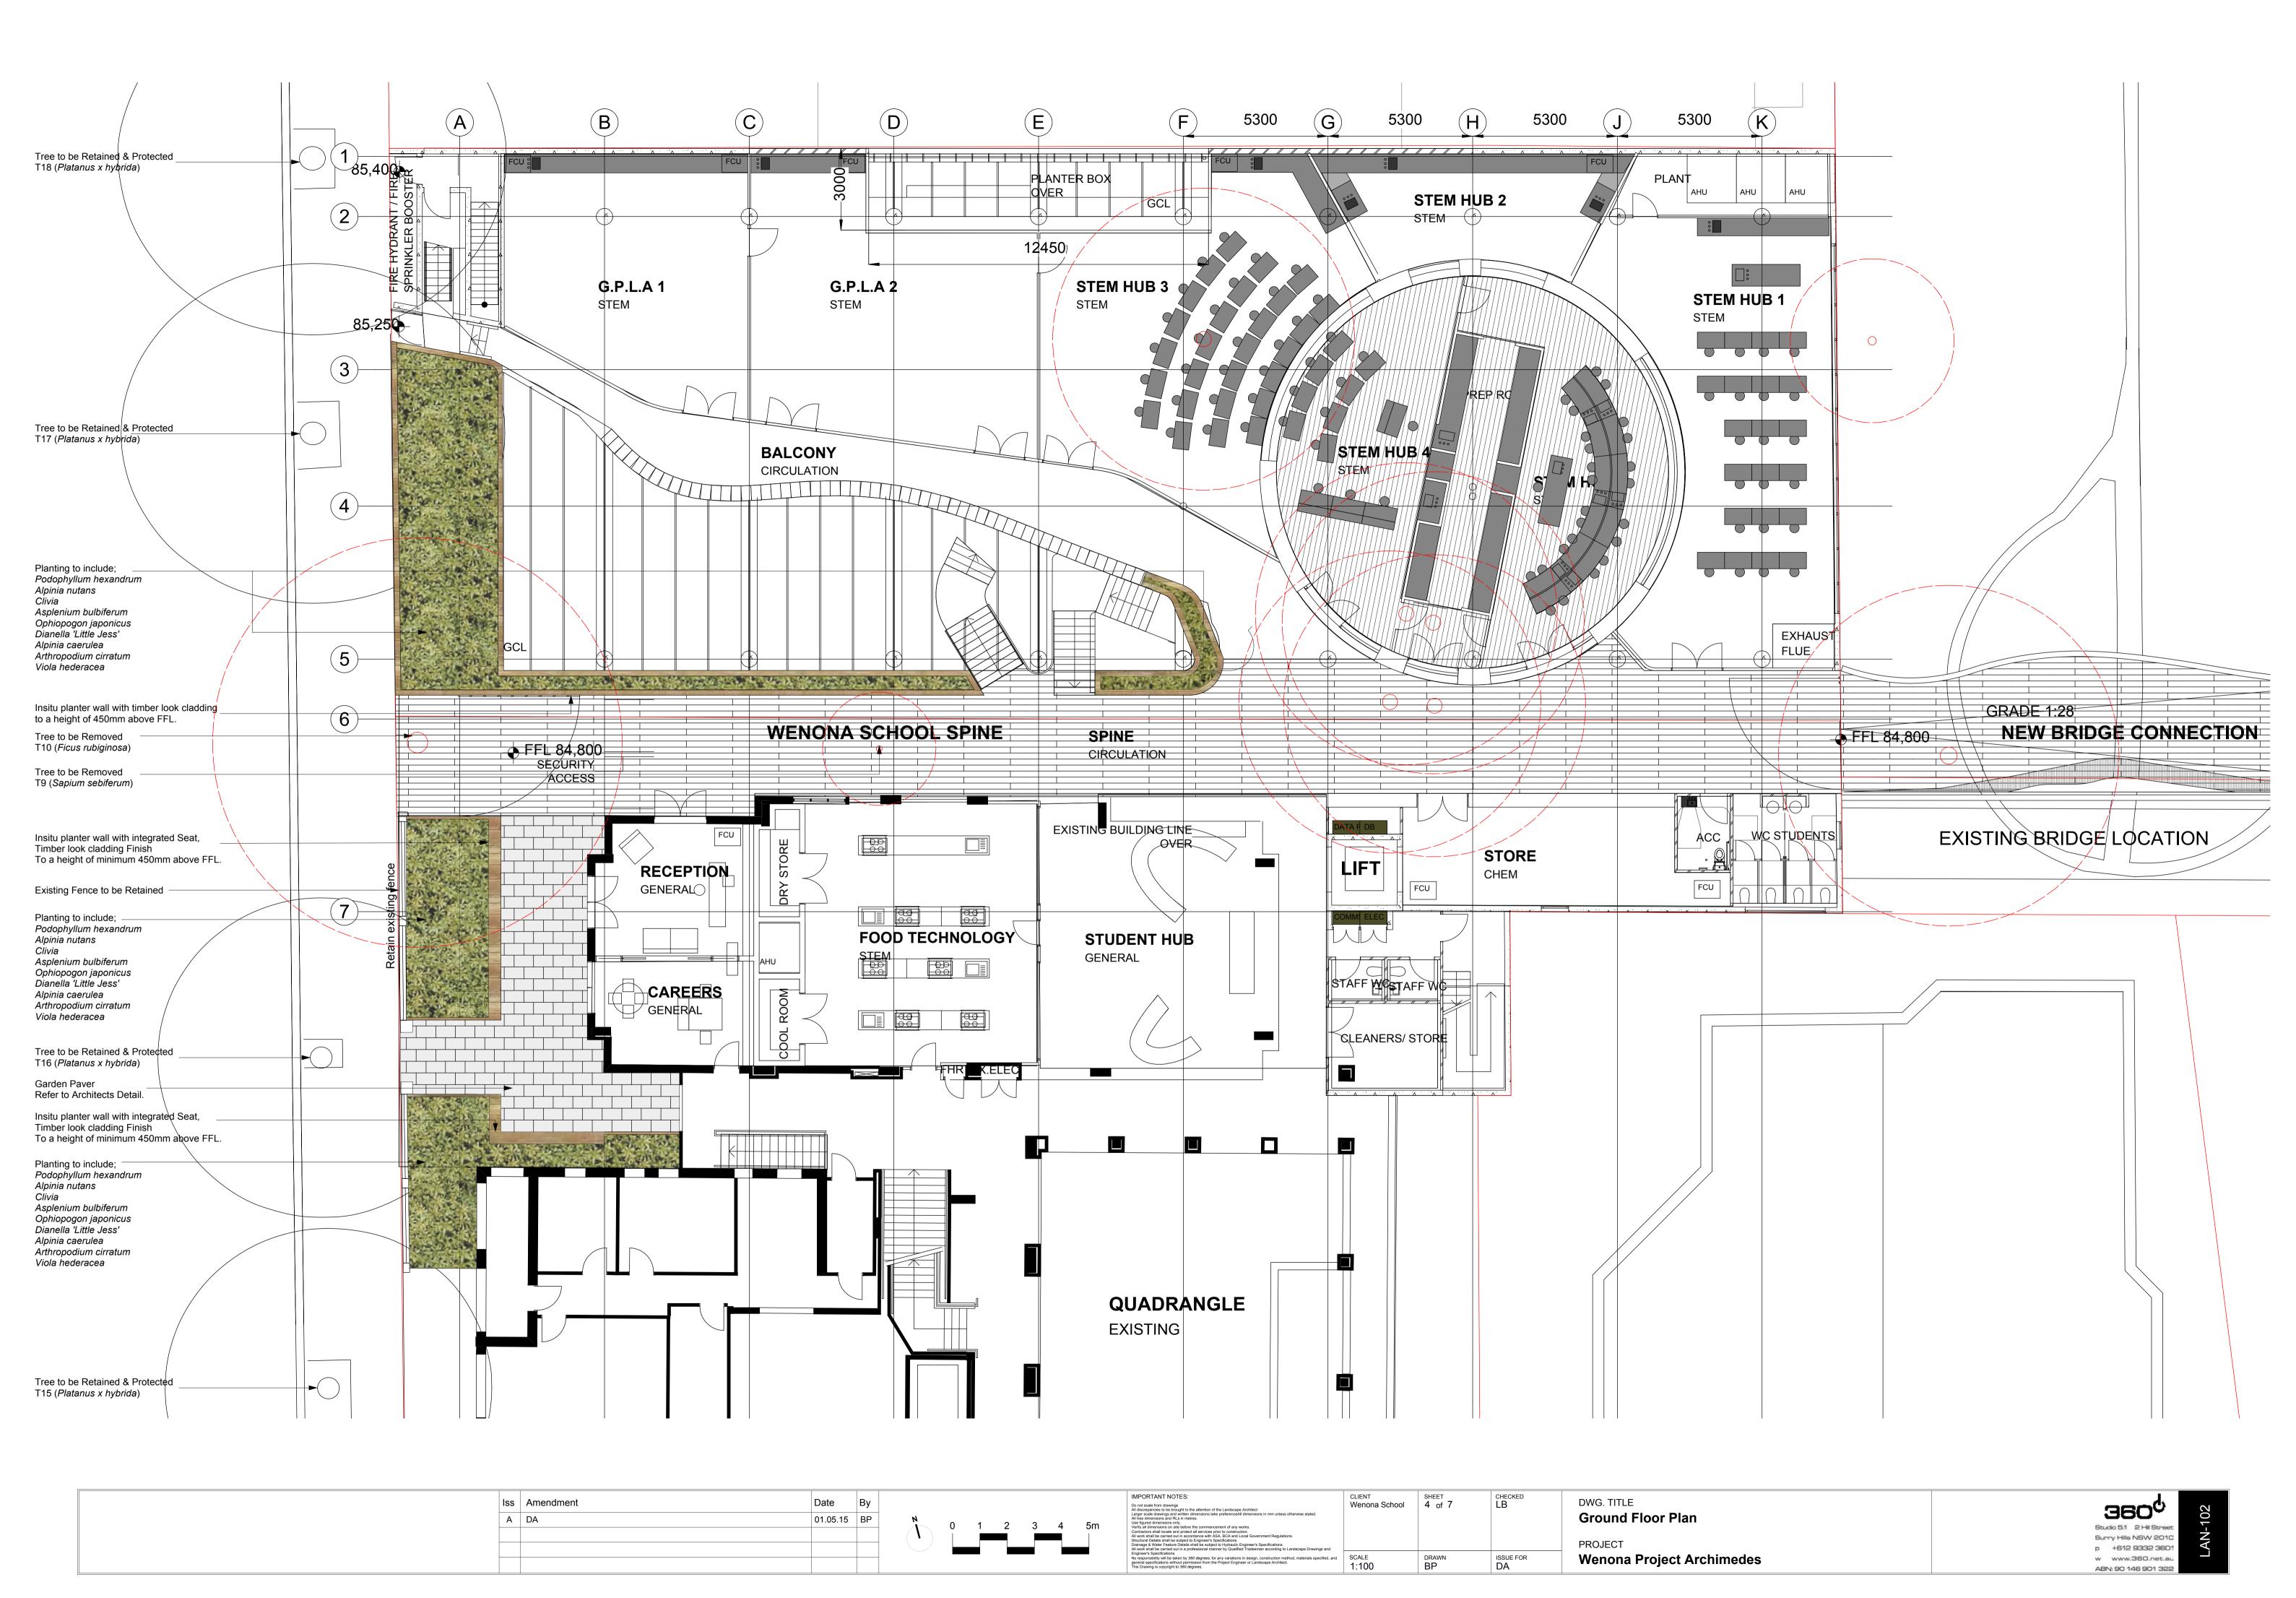

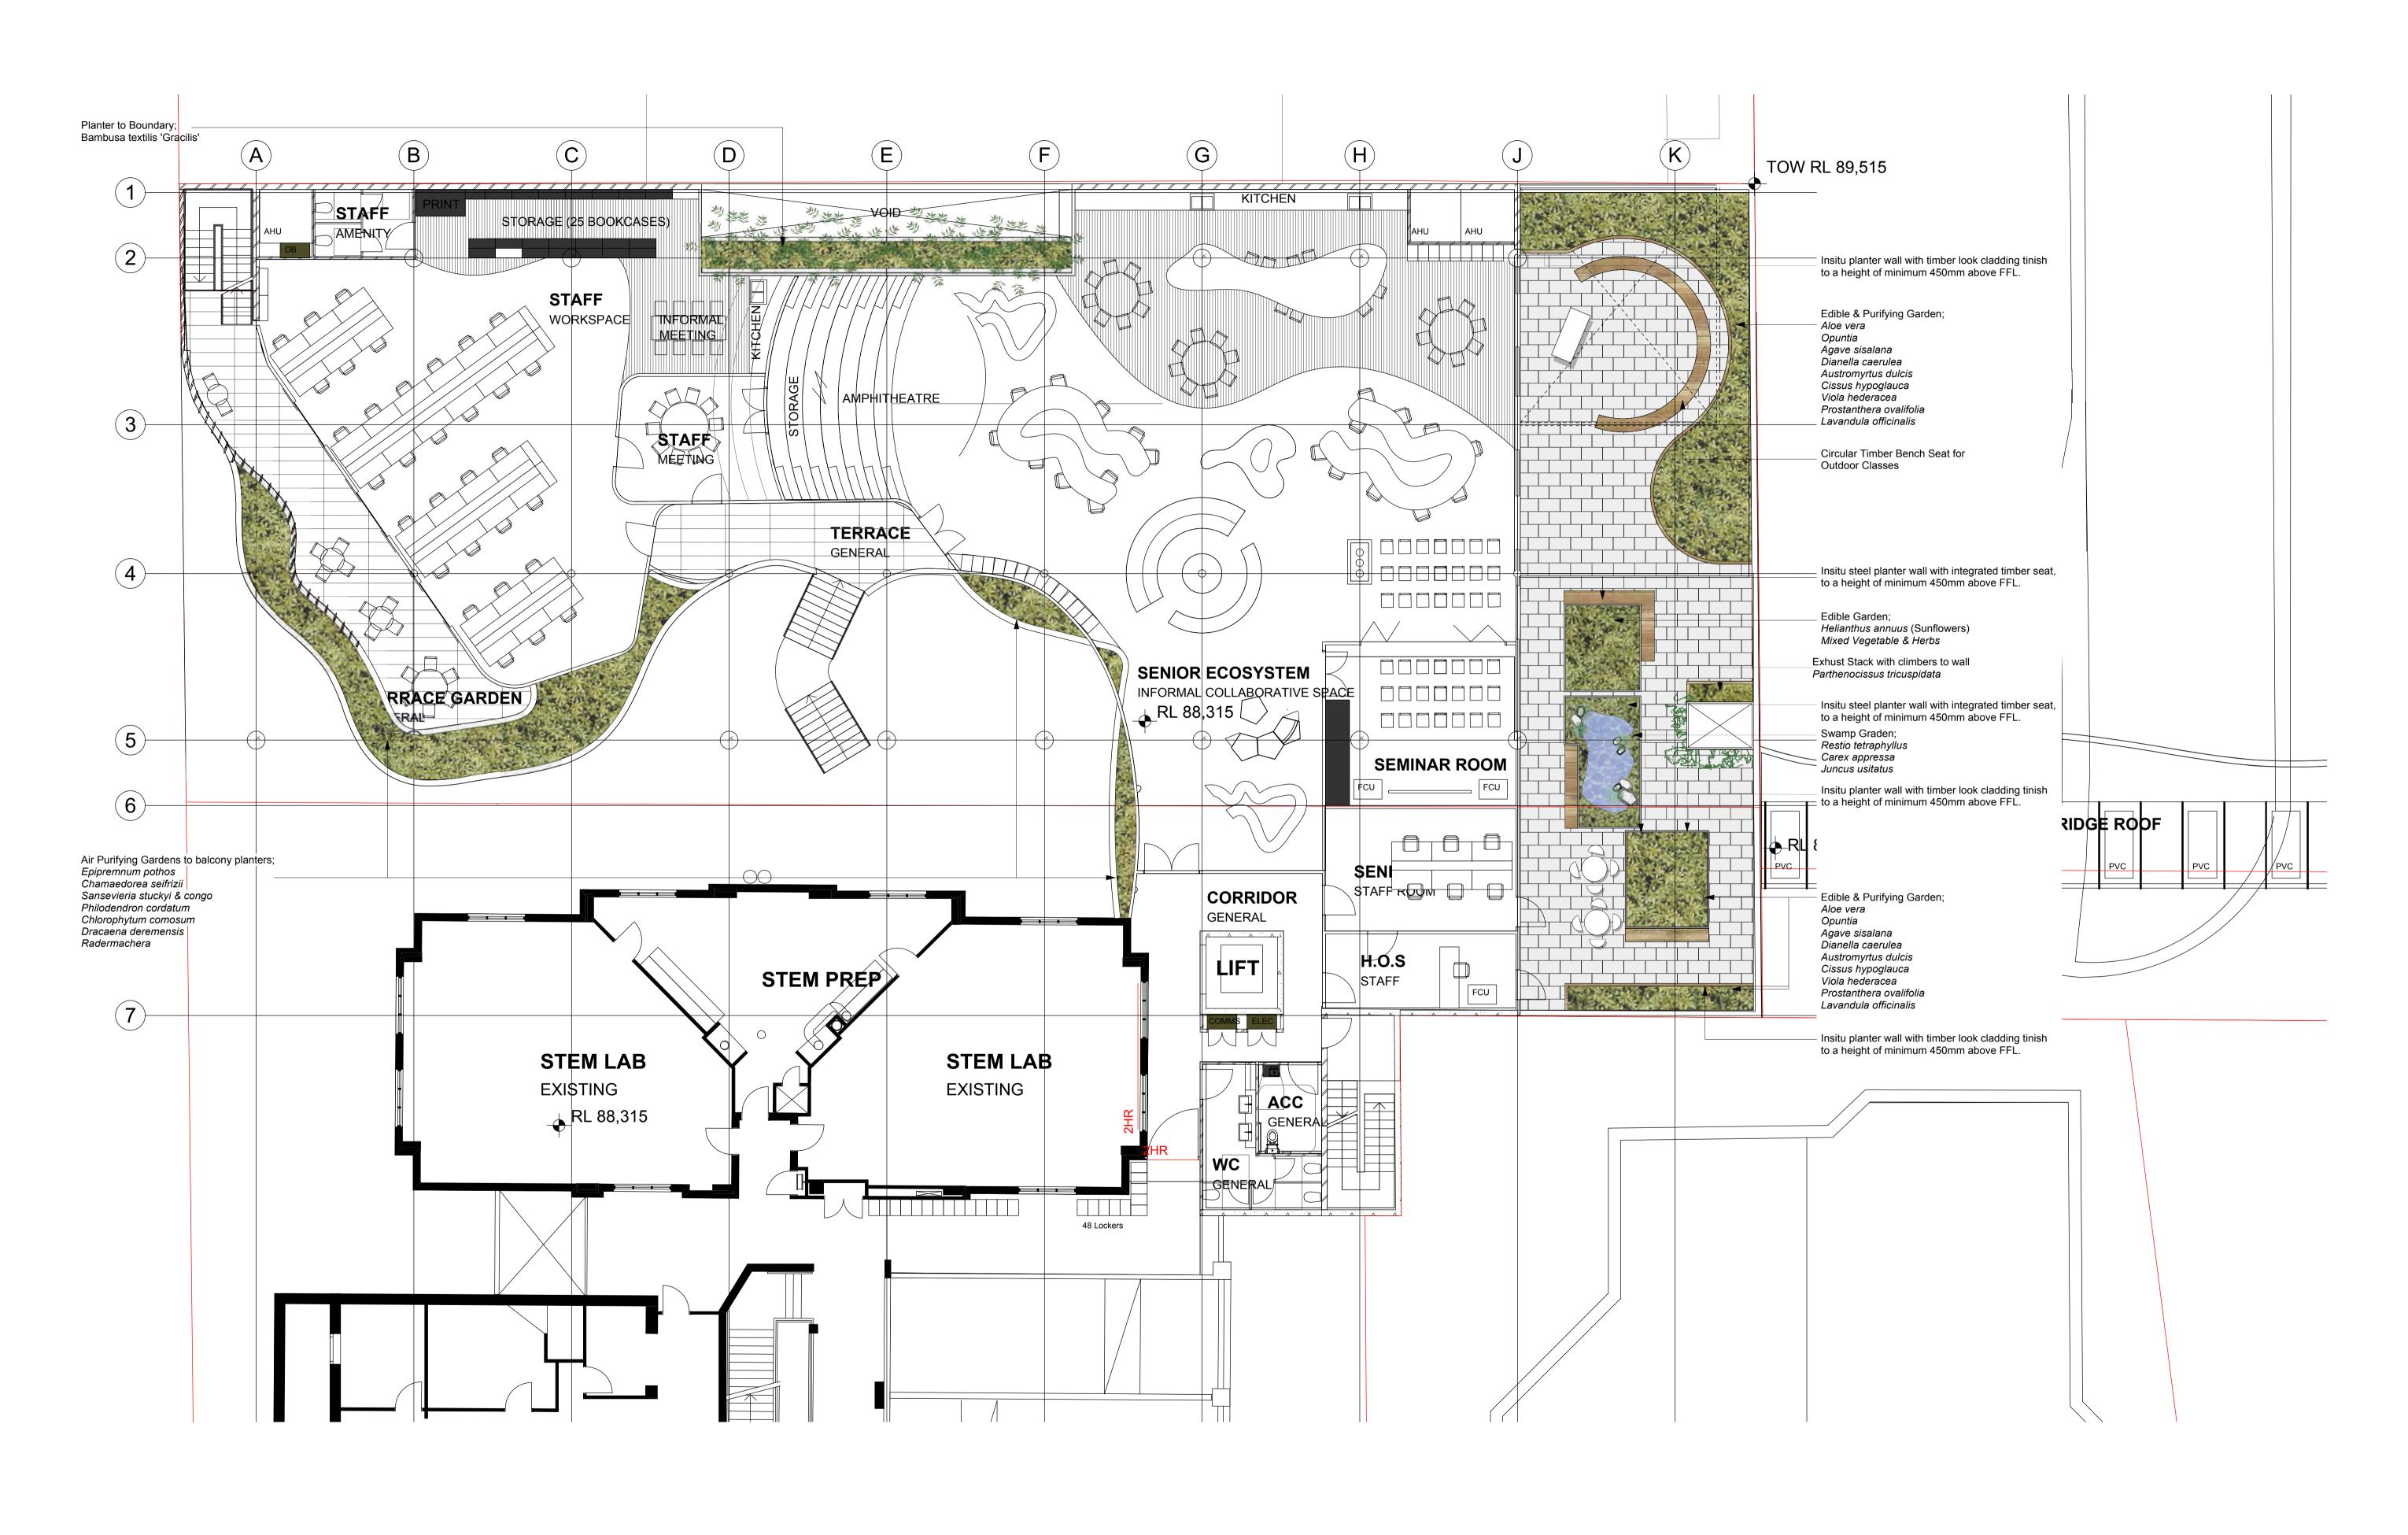

Iss Amendment A DA	Date 01.05.15	By BP		IMPORTANT NOTES: Do not scale from drawings All discrepancies to be brought to the attention of the Landscape Architect Larger scale drawings and written dimensions take preferenceAll dimensions in mm unless otherwise stated. All tree dimensions and RL sin metres. Use figured dimensions on site before the commencement of any works. Contractors shall locate and protect all services prior to construction. All work shall be carried out in accordance with ASA, BCA and Local Government Regulations. Structural Details shall be subject to Engineer's Specifications. Drainage & Water Feature Details shall be subject to the Fydraulic Engineer's Specifications. All work shall be carried out in a professional manner by Qualified Tradesman according to Landscape Drawings and All works also bedicated in a professional manner by Qualified Tradesman according to Landscape Drawings and No responsibility will be taken by 360 degrees. for any variations in design, construction method, materials specified, and general specifications without permission from the Project Engineer or Landscape Architect. This Drawing is copyright to 360 degrees.	CLIENT Wenona School	SHEET CHECKED LB		DWG. TITLE Level 1 Plan
					SCALE 1:100	DRAWN BP	ISSUE FOR DA	Wenona Project Archimedes

ABN: 90 146 901 322

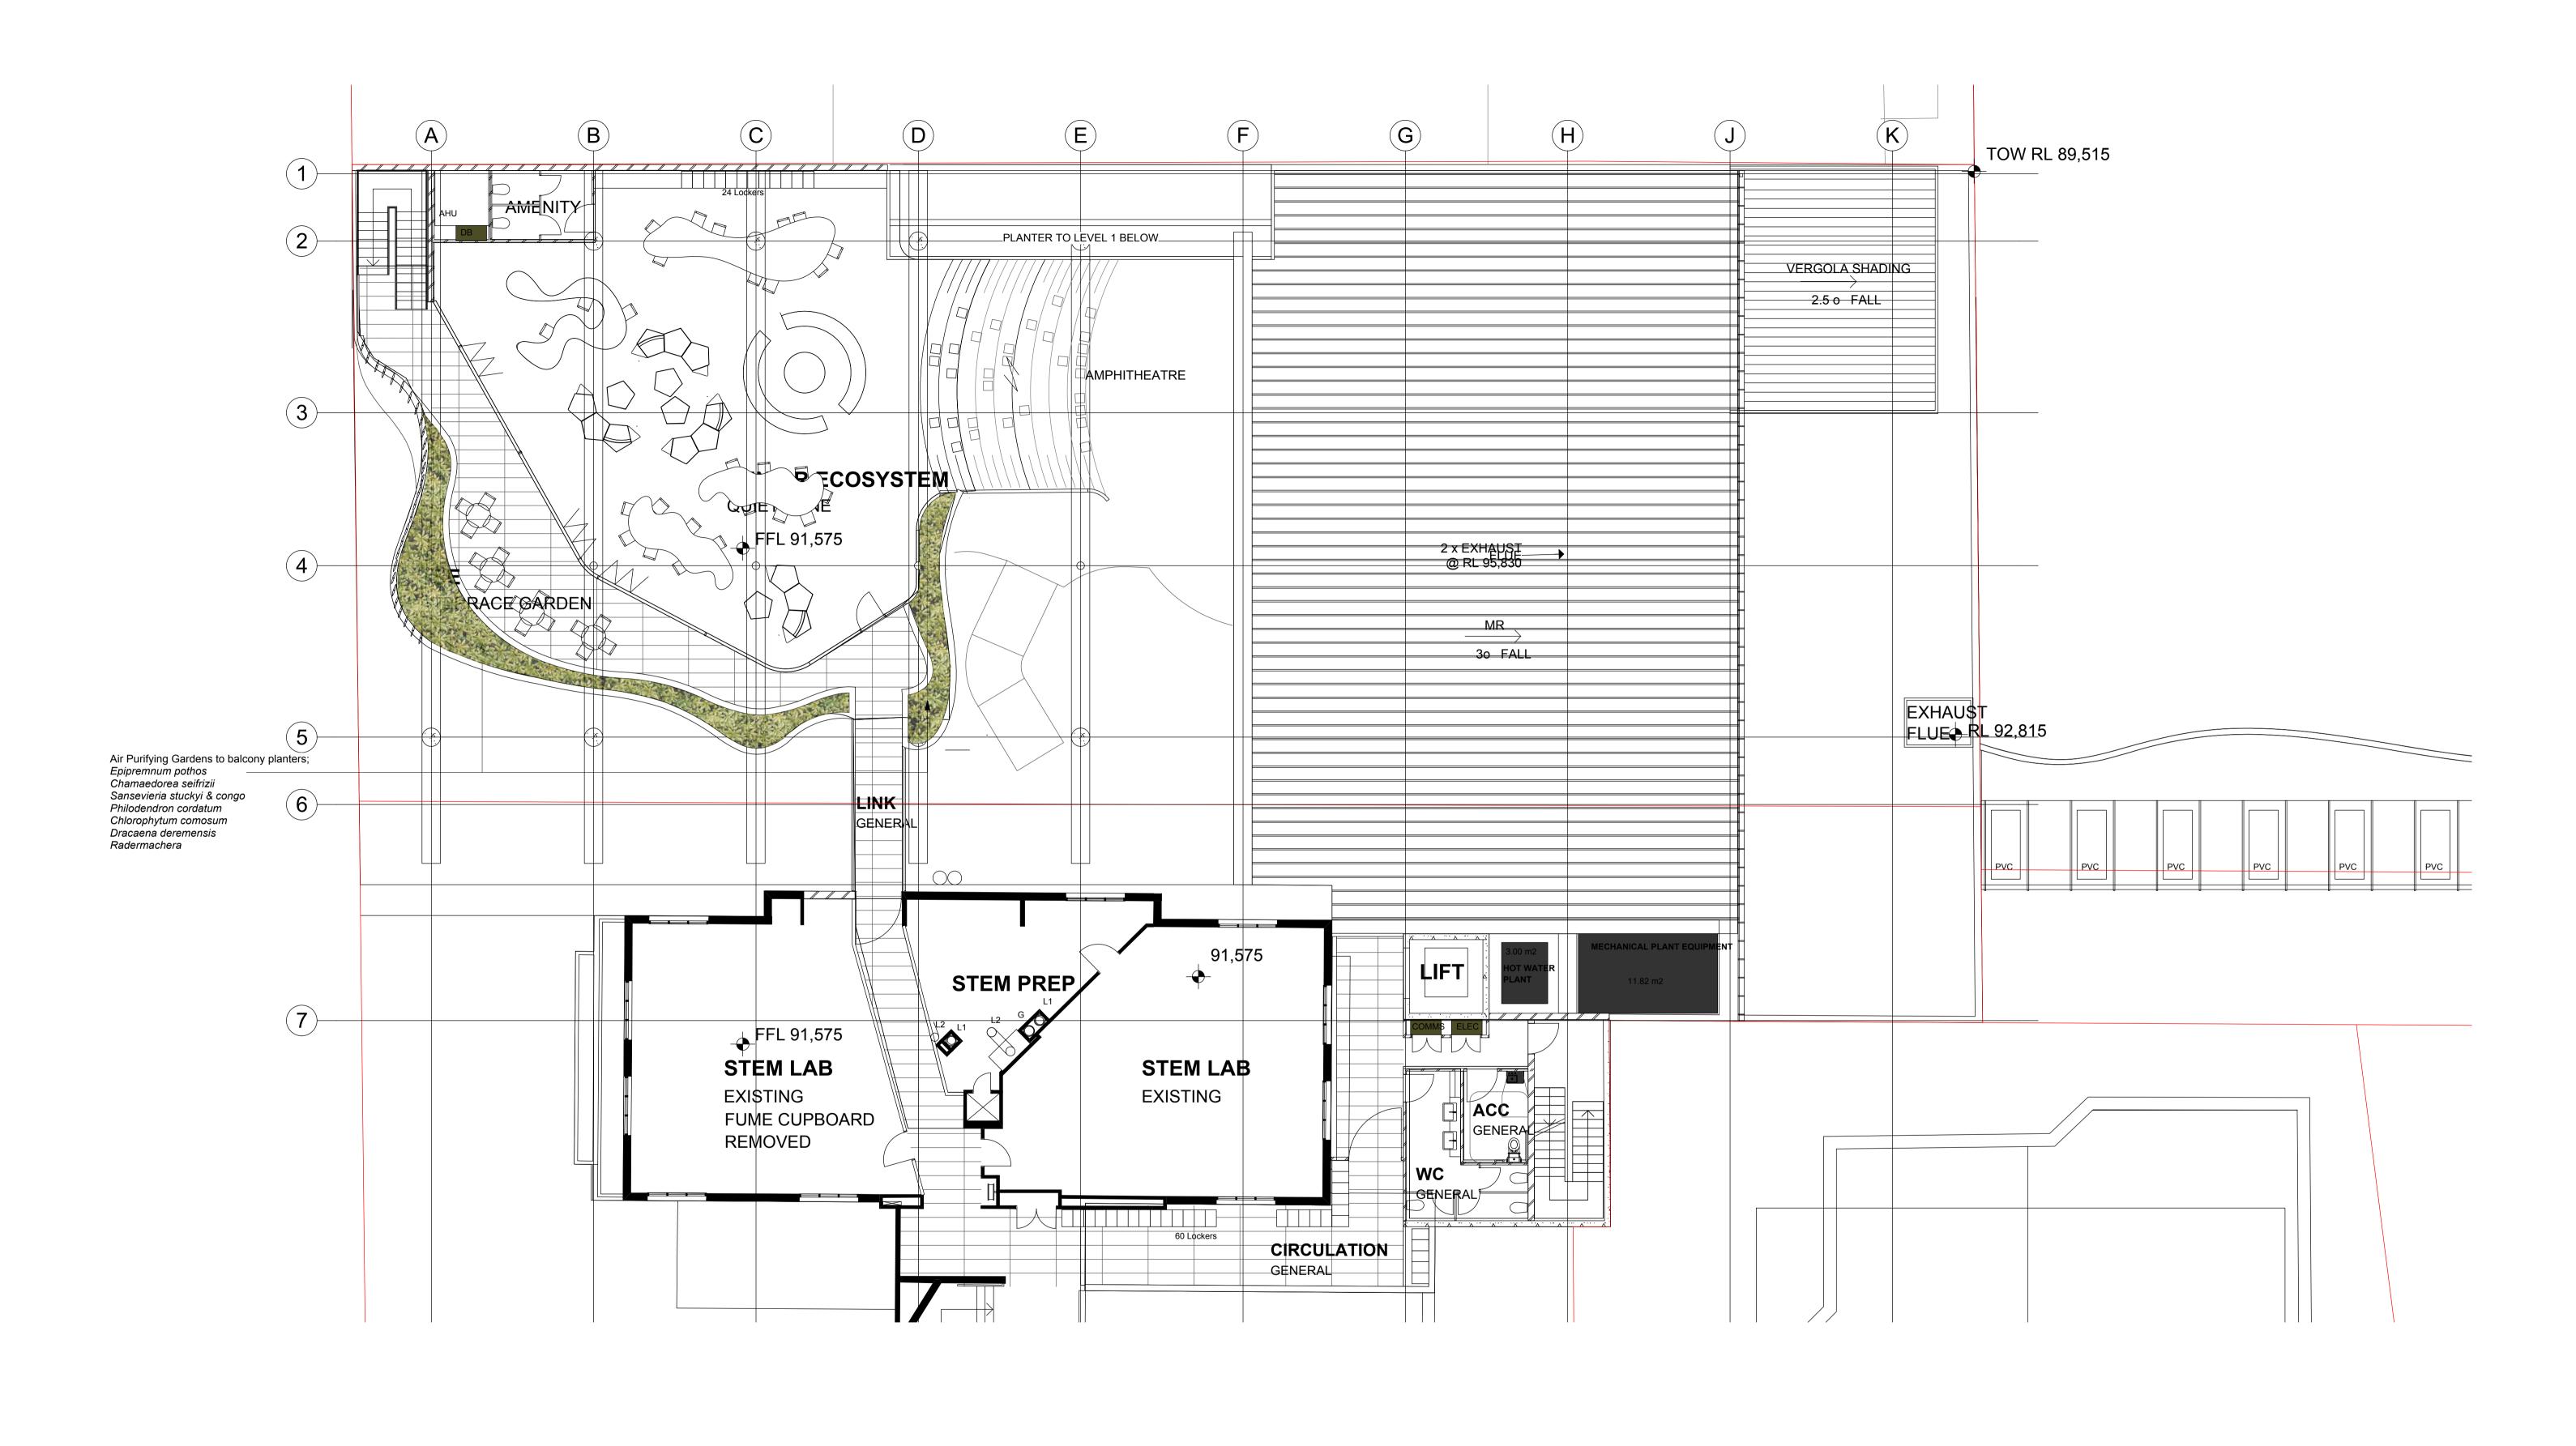

Iss Amendment A DA	Date By 01.05.15 BP	0 1 2 3 4 5m	IMPORTANT NOTES: Do not scale from drawings All discrepancies to be brought to the attention of the Landscape Architect Larger scale drawings and written dimensions take preferenceAll dimensions in mm unless otherwise stated. All tree dimensions and RLs in metres. Use figured dimensions on the before the commencement of any works. Contractors shall locate and protect all services prior to construction. Contractors shall locate and protect all services prior to construction. Structural Details shall be subject to Engineer's Specifications. Structural Details shall be subject to Engineer's Specifications. Drainage & Water Feature Details shall be subject to Hydraulic Engineer's Specifications. All work shall be carried out in a professional manner by Qualified Tradesman according to Landscape Drawings and Engineer's Specifications. No responsibility will be taken by 360 degrees. for any variations in design, construction method, materials specified, and general specifications without permission from the Project Engineer or Landscape Architect. This Drawing is copyright to 360 degrees.	CLIENT Wenona School SCALE 1:100	SHEET 6 of 7	CHECKED LB	DWG. TITLE Level 2 Plan PROJECT Wenona Project Archimedes	Studio 5.1 2 Hill Street Surry Hills NSW 2010 p +612 9332 3601 w www.360.net.au ABN: 90 146 901 322
---------------------	---------------------	--------------	--	-----------------------------------	-----------------	------------	---	---









155	Amendment	Date	Бу
A	DA	01.05.15	BP
	A.		

EVEN CARACTERISTICS. Do not a table on a contract. Do not a table on a contract. If it is a superior in the is simple in the other parties in a reasonable to enthroly the other in the parties of the contract in the cont	Wenona School	7 of 7	LB	1
d the Cut often an about the spiral includes in creatiful to a file Commercial and analytic to exceep the pure to be produced from the file of the fil	SCALE N/A	DRWWW BP	ISSUE FOR	1

Plant Schedule

Lower Ground floor - Pharmaceutical Graden

Ground Floor - World Medicine/ Culture Garden

Level 1 - Air Purifying Garden & Swamp Graden

New Zealand rock lify

Himalayan Mayapple

English levender

Temple Bamboo Australian Vine

Tall Sedge

devil's ivy

Tassel Cord Rush

Janet Craig dracaena

Heart Leaf Philodendron

Heart Leaf Philodendron

devil's rvy

Masons Congo

Mother in law's tongue

Heart Leaf Philodendron

Prickly Pear

Latin Name

Alpinia caeruleu

Podophyllum hexandrum -

Dianella Vittle Jess' Ophiopogon japonicus Viola hederacea

Alge viera
Agave sisalana
Austromytus olukis
Chamaekorea seifrizii
Chlorophylum comosum
Dracaena deremensis
Helianthus annuus

Lavandula officinalis

Sanseviena conqu.

Sansavieria stuckyi

Radermachera

Carex appressa

Epipremnum potnos

Restio tetraphytius

Viola hederacea

Dracaena deremensis

Philodendron cordetum

Grasses + Groundcovers

Level 2 - Air Purifying Garden

Grasses + Groundcovers

Mature Height Mature Spread Scheduled Size

0.4-0.5m