


Appendix 4

Plans of the Proposed Development

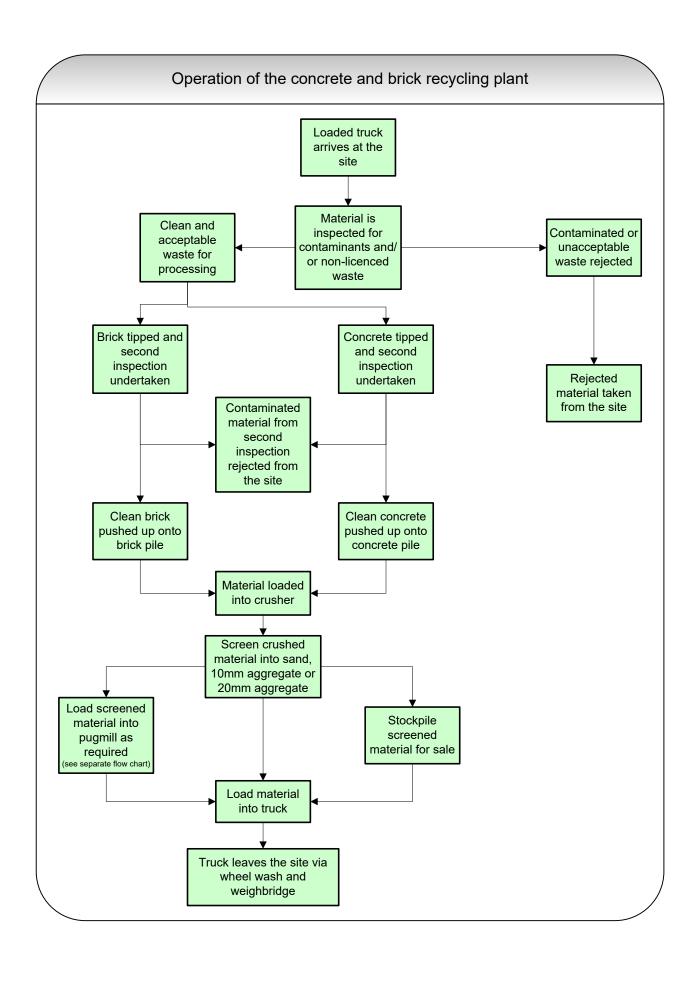

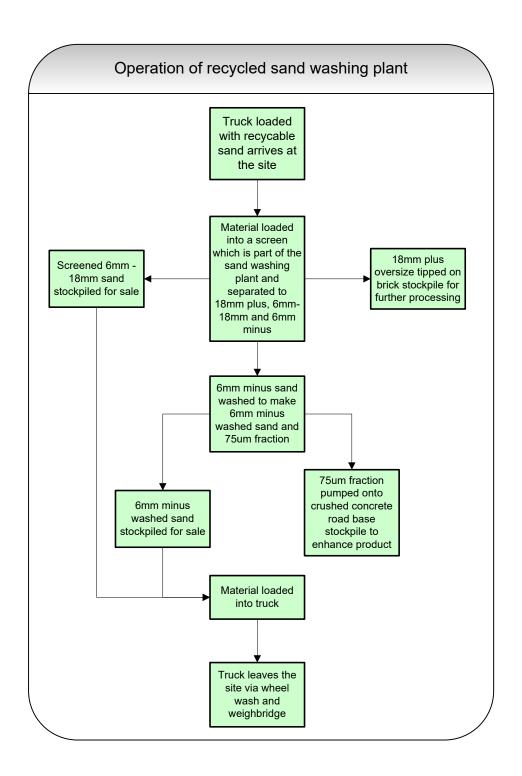

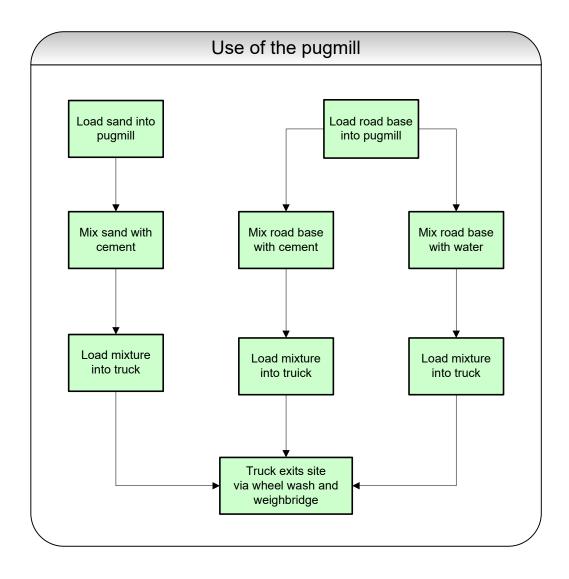

MINTO CONCRETE RECYCLERS PROJECT:

SITE EARTHWORKS PLANSET:

CONCRETE RECYCLERS (GROUP) PTY LTD CLIENT:



LOCALITY PLAN N.T.S.

LGA: CAMPBELLTOWN

A1 / A3 LANDSCAPE (A1LC_v02.0.01)

7 MONTORE ROAD, MINTO NSW 2566 LOT 52 DP 618900

ОZНА										
HD0	REV	DESCRIPTION	DATE	DRAWN	DESIGNED	CHECKED	APPRVD	GRID DATUM	PROJECT MANAGER	CLIENT
40LA	N	STOCKPILE DETAILS ADDED	26/06/2020	RK	SA	SA	TH		TH	CONCRETE RECYCLERS (GROUP) PTY LTD
.R.	М	MINOR AMENDMENTS	16/06/20	GM/JS	SS	SL	TH		ΙП	CONCILL ILLOTOLLING (GINOOI) I IT LID
USE	П	MINOR AMENDMENTS	02/03/2020	LL	EZ	TH	TH	DISCLAIMER & COPYRIGHT		PROJECT NAME/PLANSET TITLE
- 02	Κ	NEW PAGE ADDED	15/11/2019	RK/LL	EZ	TH	TH	This plan must not be used for construction uprincipal certifying authority.	unless signed as approved by	MINTO CONCRETE RECYCLERS
6.20	J	MINOR AMENDMENTS	12/10/2018	RK	EZ	TH	TH	All measurements in millimetres unless other	erwise specified	
26.0		MINOR AMENDMENTS	28/09/2018	JCF/LZ/P	EG/JCF/EZ	TH	TH	This drawing must not be reproduced in who		SITE EARTHWORKS
ITED	Н	AMENDMENTS AS PER CLIENT COMMENTS	20/09/2018	PB/JCF/L	Z JCF	TH		consent of Martens & Associates Pty Ltd.		7 MONTORE ROAD, MINTO NSW 2566
PRIN	G	CLIENT REQUESTED AMENDMENTS	12/09/2018	JCF/LZ	JCF			(C) Copyright Martens & Associates	s Pty Ltd	LOT 52 DP 618900

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DRAWING LIST

EARTHWORKS PS02-C100 G

ROADWORKS

DRAINAGE PS02-E100 K

SITEWORKS

PS02-F102 F

PS02-F103 E

PAVEMENT AND SIGNAGE PS02-G100 F PAVEMENT PLAN

DWG NO. REV DWG TITLE

COVER SHEET

CONSTRUCTION MANAGEMENT WORKS

RIPARIAN FEATURES CONSTRAINTS PLAN

SEDIMENT AND EROSION CONTROL PLAN SEDIMENT AND EROSION CONTROL DETAILS

EARTHWORKS CUT & FILL ANALYSIS PLAN

SWEPT PATH ANALYSIS - SHEET 1 (TURNING MANOEUVRE ON SITE) SWEPT PATH ANALYSIS - SHEET 2 TURNING MANOEUVRE ON SITE)

SWEPT PATH ANALYSIS - SHEET 4 (TURNING MANEOUVRE ON SITE) SWEPT PATH ANALYSIS - SHEET 5 (TURNING MANEOUVRE ON SITE)

EARTHWORKS SECTIONS - SHEET 01 EARTHWORKS SECTIONS - SHEET 02 EARTHWORKS SECTIONS - SHEET 03

SITE LOADING AND UNLOADING PLAN

SEDIMENT BASIN CROSS SECTIONS

WATER QUALITY CATCHMENT PLAN

DRIVEWAY LONGITUDINAL AND TYPICAL CROSS SECTIONS

DRAINS CATCHMENT PLANS DRAINS MODELLING RESULTS

DRIVEWAY CROSS SECTION RETAINING WALL PLAN RETAINING WALL DETAILS

DRAINAGE PLAN DRAINAGE DETAILS


DRIVEWAY PLAN


CARPARK PLAN

EARTHWORKS PLAN - SHEET 01 EARTHWORKS PLAN - SHEET 02


SITE FENCING, FIRE FIGHTING AND SPRINKLERS PLAN


DEVELOPMENT APPLICATION

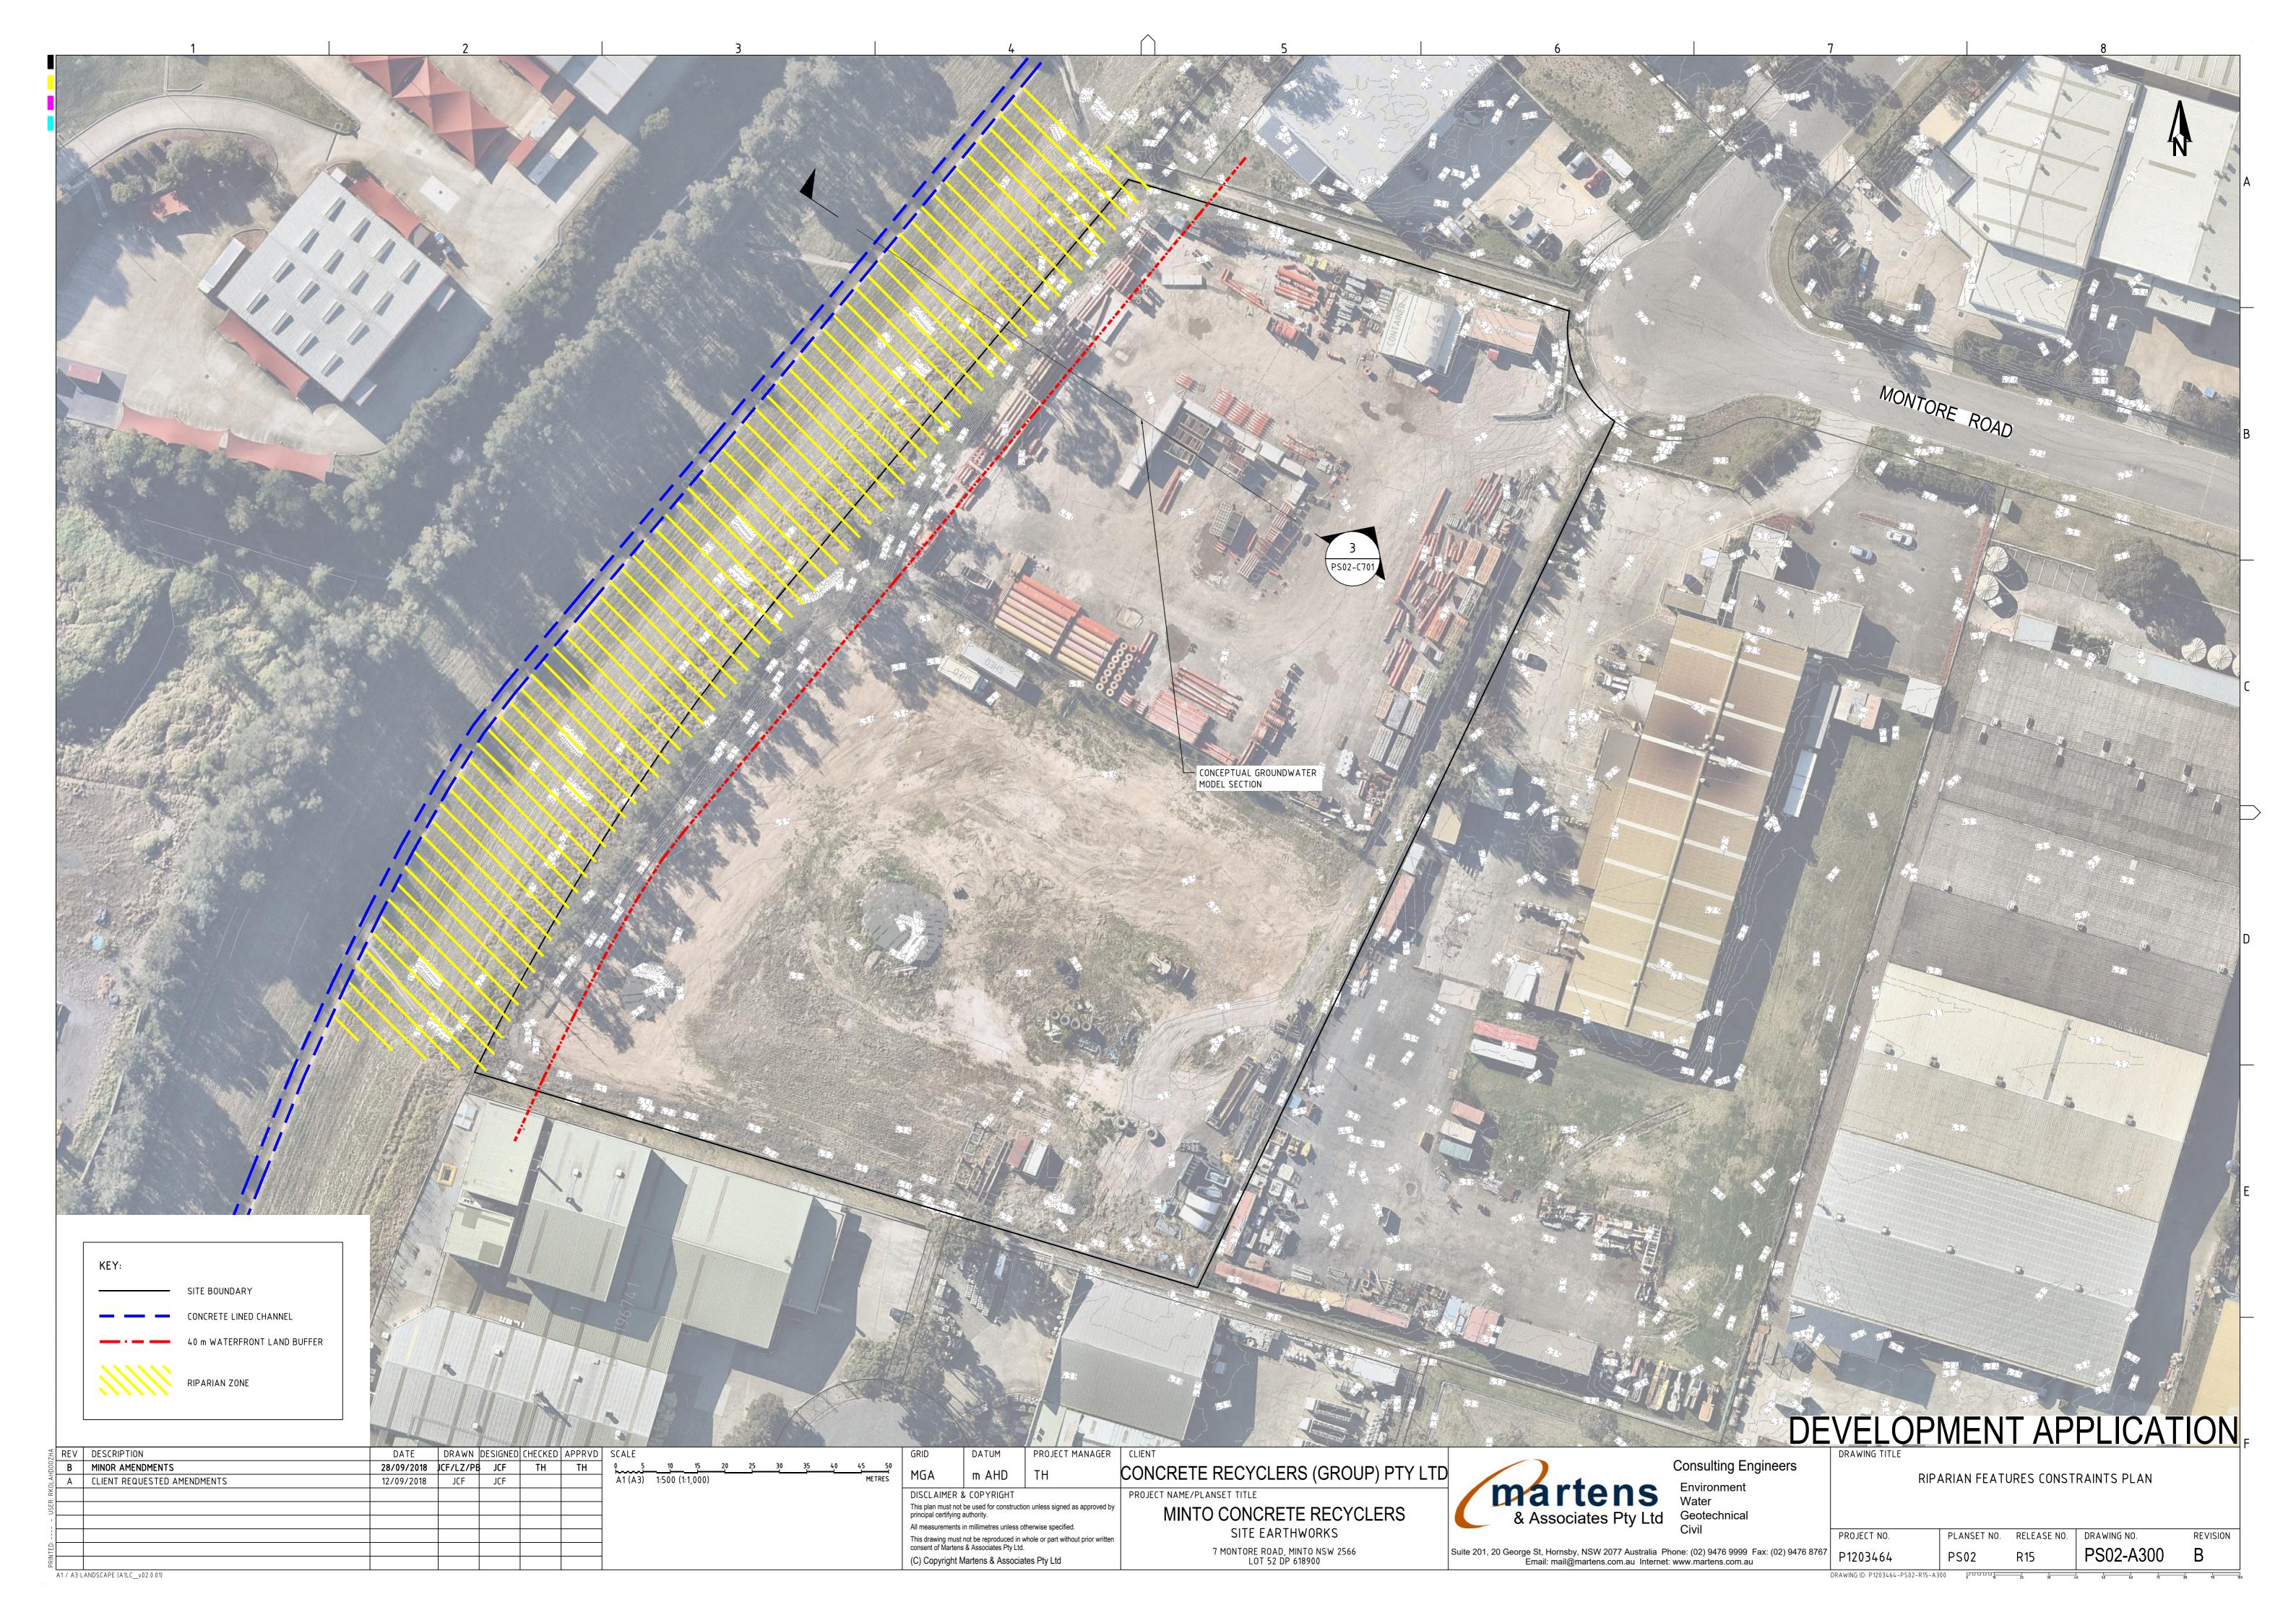

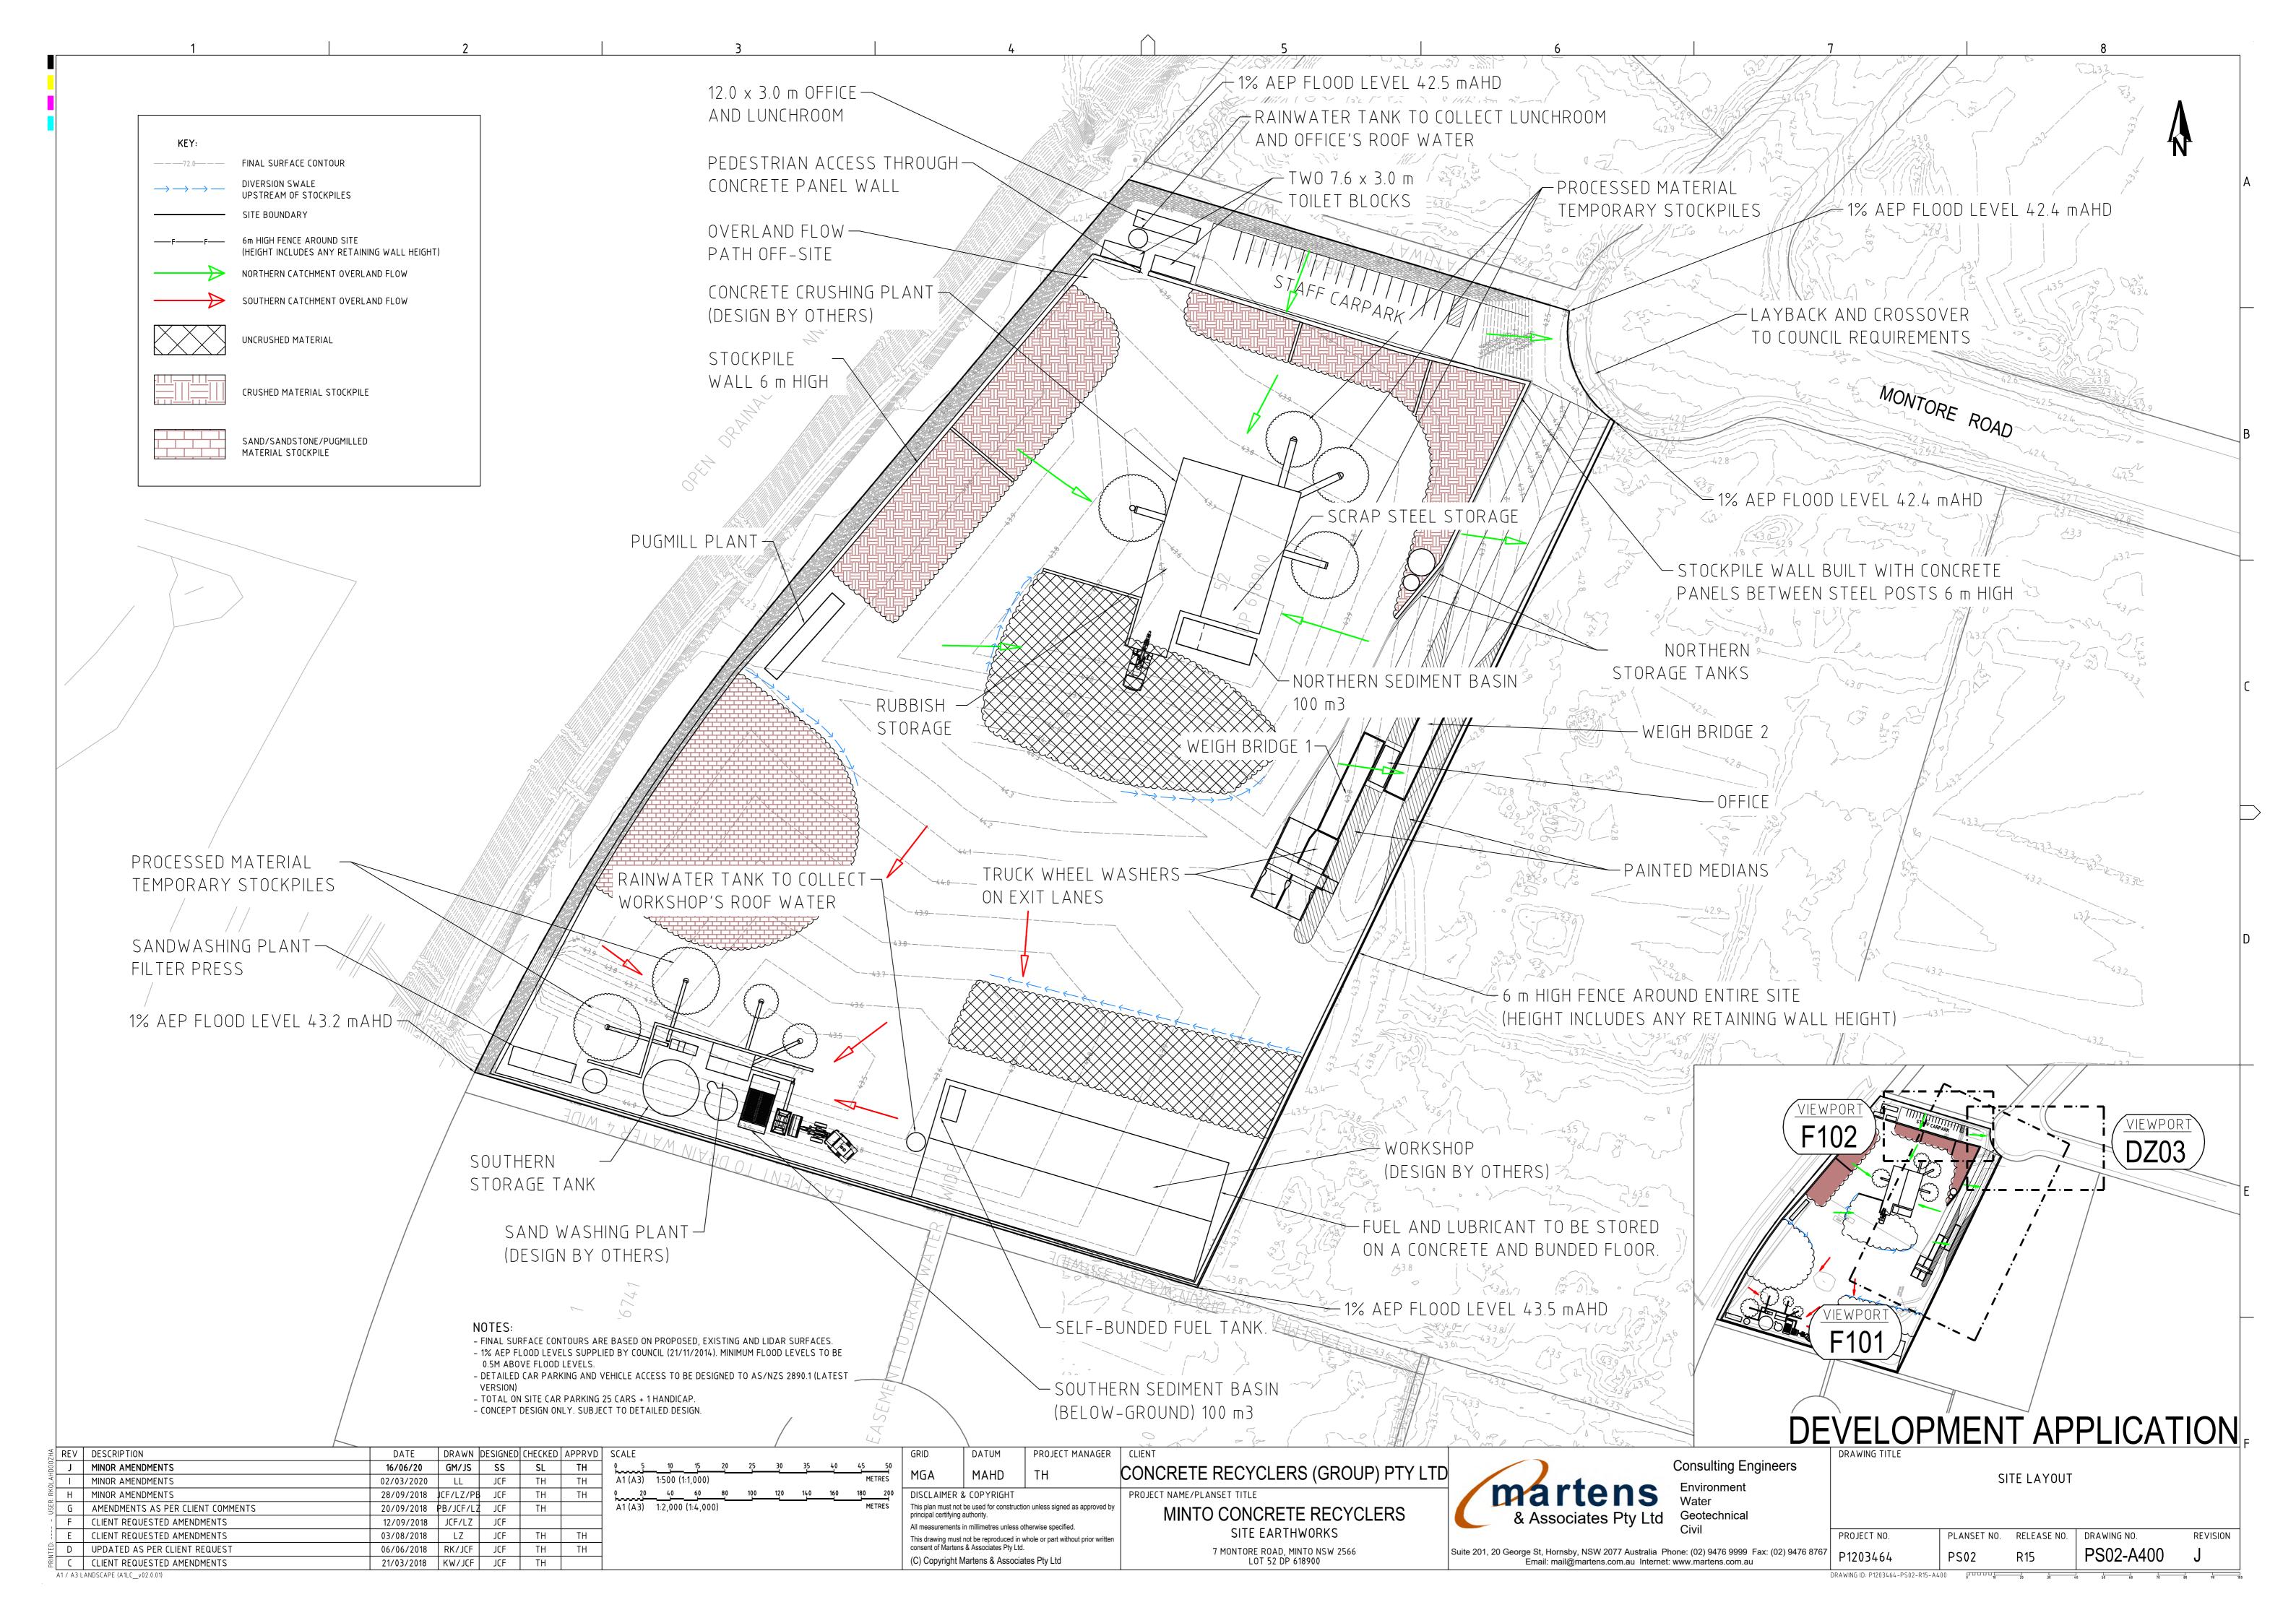





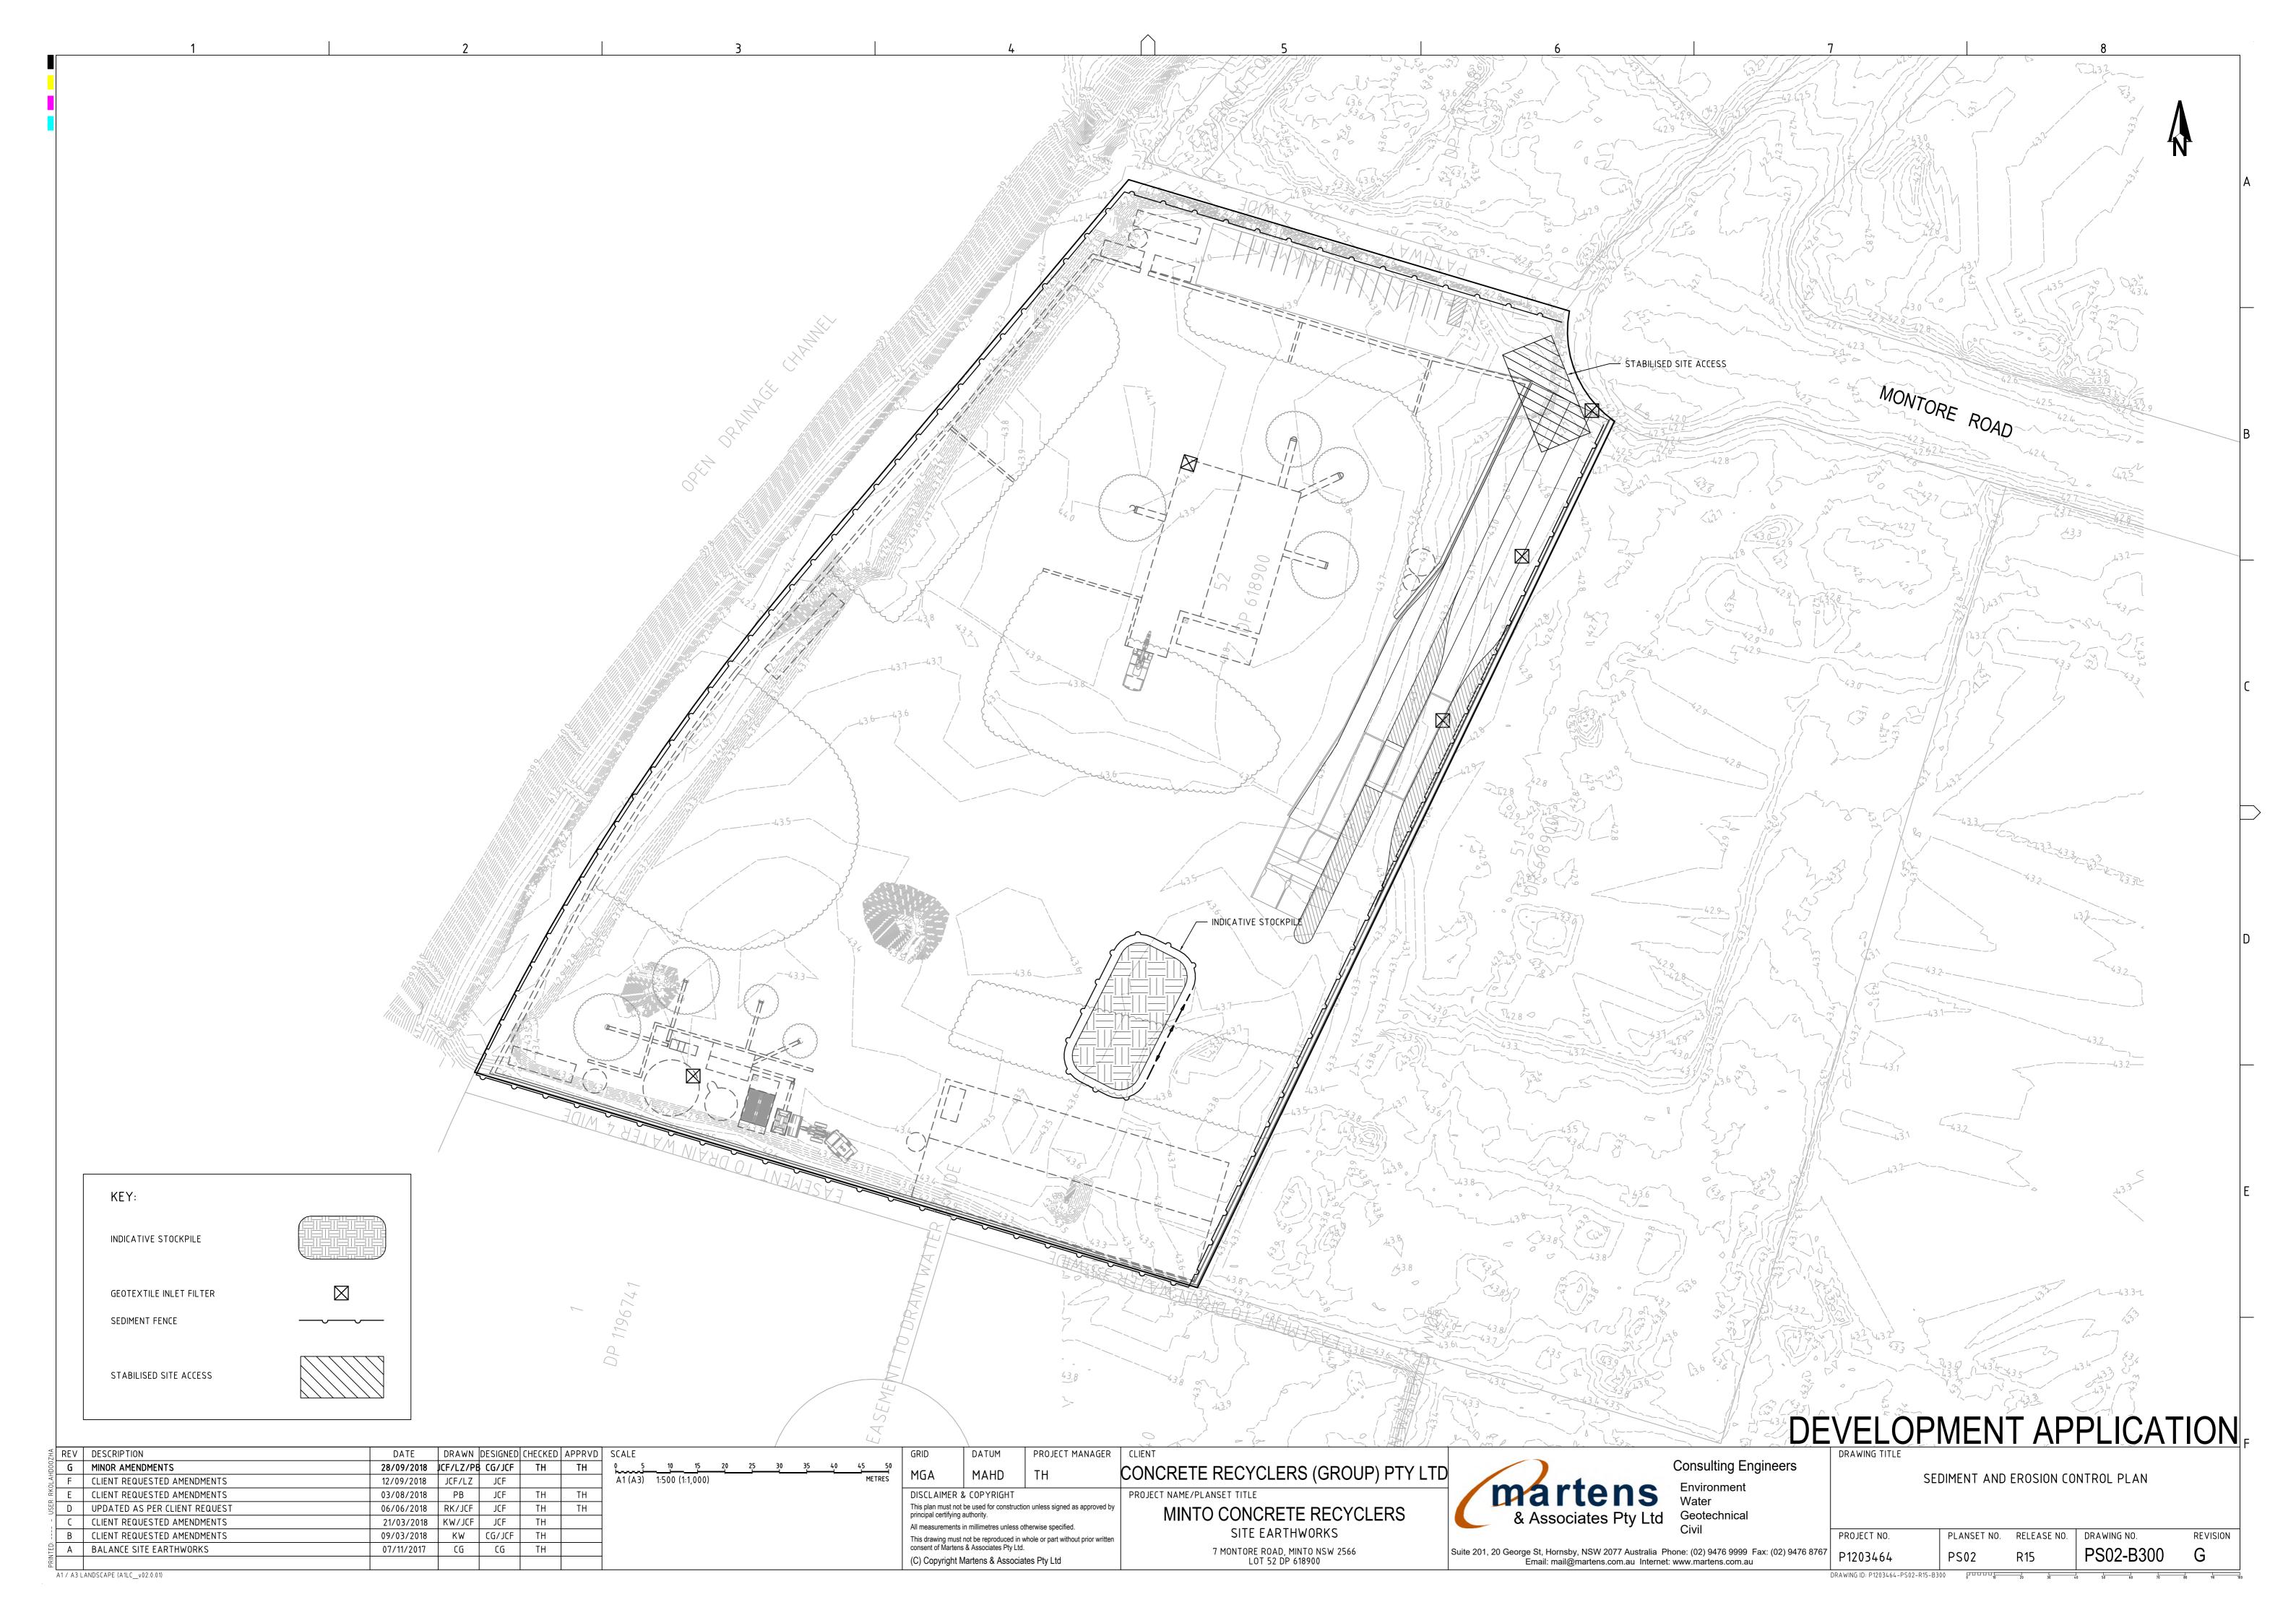

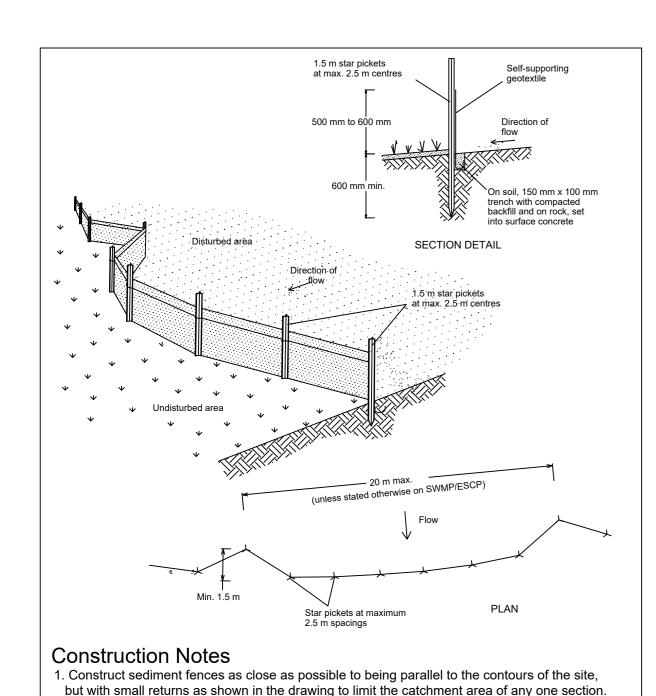

Stabilise stockpile Earth bank Sediment fence Construction Notes 1. Place stockpiles more than 2 (preferably 5) metres from existing vegetation, concentrated water flow, roads and hazard areas. 2. Construct on the contour as low, flat, elongated mounds. 3. Where there is sufficient area, topsoil stockpiles shall be less than 2 metres in height. 4. Where they are to be in place for more than 10 days, stabilise following the approved ESCP or SWMP to reduce the C-factor to less than 0.10. 5. Construct earth banks (Standard Drawing 5-5) on the upslope side to divert water around stockpiles and sediment fences (Standard Drawing 6-8) 1 to 2 metres downslope. STOCKPILES SD 4-1

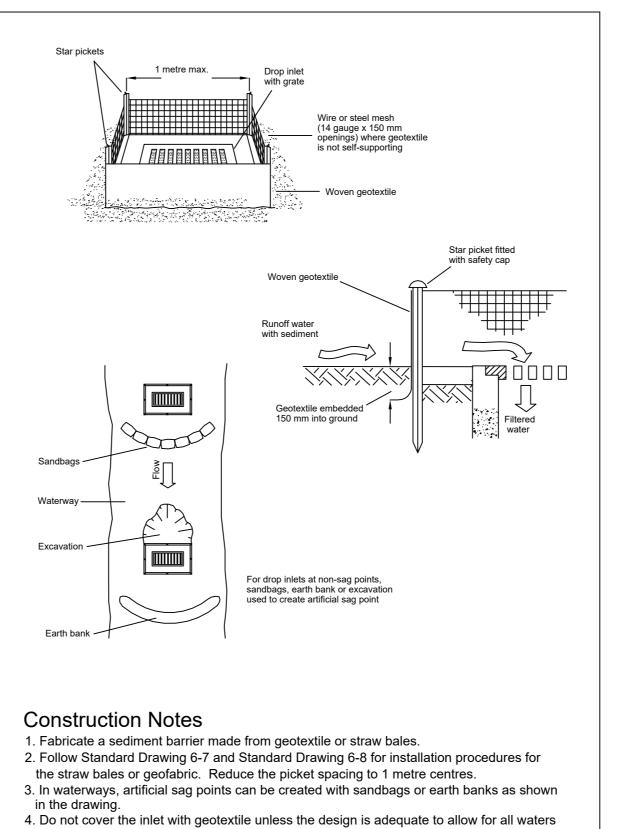

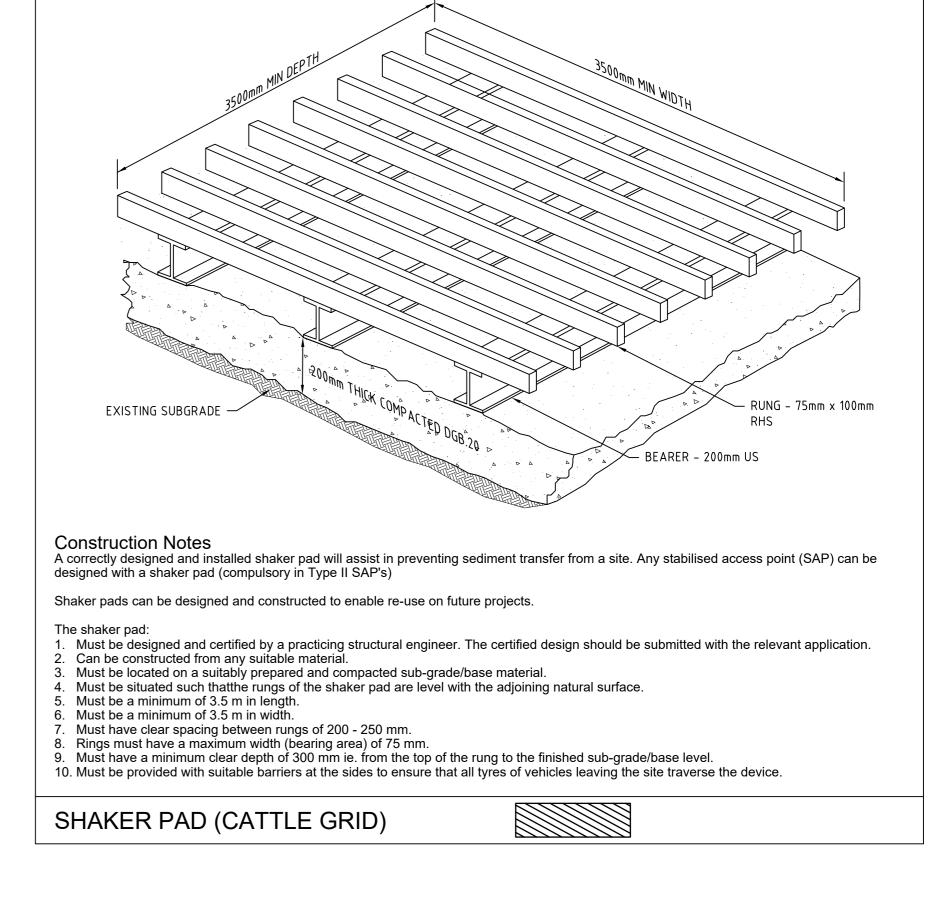



5. Join sections of fabric at a support post with a 150-mm overlap. 6. Backfill the trench over the base of the fabric and compact it thoroughly over the geotextile. SEDIMENT FENCE

50 litres per second in the design storm event, usually the 10-year event.

edge of the trench. Ensure any star pickets are fitted with safety caps.

purpose is not satisfactory.

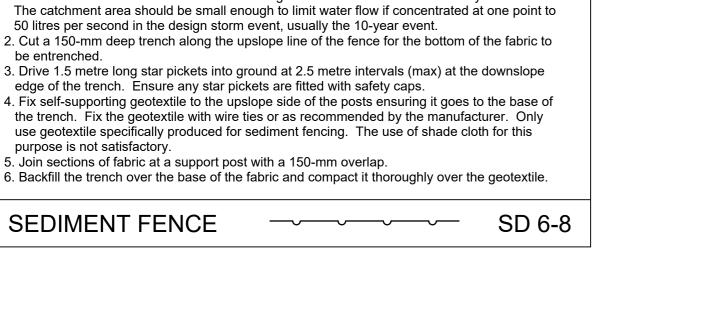

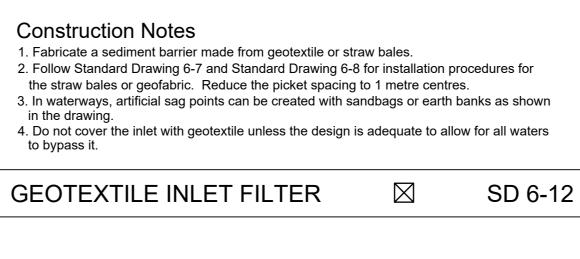



DEVELOPMENT APPLICATION, Consulting Engineers Environment Geotechnical

SEDIMENT AND EROSION CONTROL DETAILS PROJECT NO. PLANSET NO. RELEASE NO. DRAWING NO. REVISION PS02-B350 P1203464 DRAWING ID: P1203464-PS02-R15-B350

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A1 / A3 LANDSCAPE (A1LC_v02.0.01)

EXISTING SITE CONTOURS

PROPOSED SITE CONTOURS

KEY

EXISTING CONTOURS

DESIGN CONTOURS

INTERFACE

RETAINING WALL

EXTERNAL BOUNDARY

OVERLAND FLOW

A1 / A3 LANDSCAPE (A1LC_v02.0.01)


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G	MINOR AMENDMENTS	28/09/2018	JCF/LZ/P	CG/JCF	TH	TH	0 7.5 15.0 22.5 30.0 37.5 45.0 52.5 60.0 67.5 75.0	MGA	MAHD	TH	CONCRETE RECYCLERS (GROUP) PTY LTD
F	CLIENT REQUESTED AMENDMENTS	12/09/2018	JCF/LZ	JCF			A1 (A3) 1:750 (1:1,500) METRES	MUA	MAND	ІП	CONCILIE NECTOLLING (GINOOI) I II EID
Е	CLIENT REQUESTED AMENDMENTS	03/08/2018	LZ	JCF	TH	TH		DISCLAIMER 8			PROJECT NAME/PLANSET TITLE
D	UPDATED AS PER CLIENT REQUEST	06/06/2018	RK/JCF	JCF	TH	TH		This plan must not principal certifying		on unless signed as approved by	MINTO CONCRETE RECYCLERS
С	CLIENT REQUESTED AMENDMENTS	21/03/2018	KW/JCF	JCF	TH			1	in millimetres unless o	therwise specified	
В	CLIENT REQUESTED AMENDMENTS	09/03/2018	KW	CG/JCF	TH			1		whole or part without prior written	SITE EARTHWORKS
Α	BALANCE SITE EARTHWORKS	07/11/2017	CG	CG	TH			consent of Martens	& Associates Pty Ltd.		7 MONTORE ROAD, MINTO NSW 2566
								(C) Copyright N	Martens & Associa	tes Pty Ltd	LOT 52 DP 618900

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DE	VELOP	MEN [°]	T AP	PLICAT	ION				
eers	DRAWING TITLE								
	EARTHWORKS PLAN SHEET 01								
	PROJECT NO.	PLANSET NO.	RELEASE NO.	DRAWING NO.	REVISION				
(02) 9476 8767	P1203464	PS02	R15	PS02-C100	G				
	DRAWING ID: P1203464-PS02-R15-C10	0 0 10	20 30 4	0 50 60 70	80 90 10				






DATUM RL 28.000 DESIGN SURFACE LEVELS EXISTING SURFACE LEVELS CUT / FILL DEPTH CHAINAGE

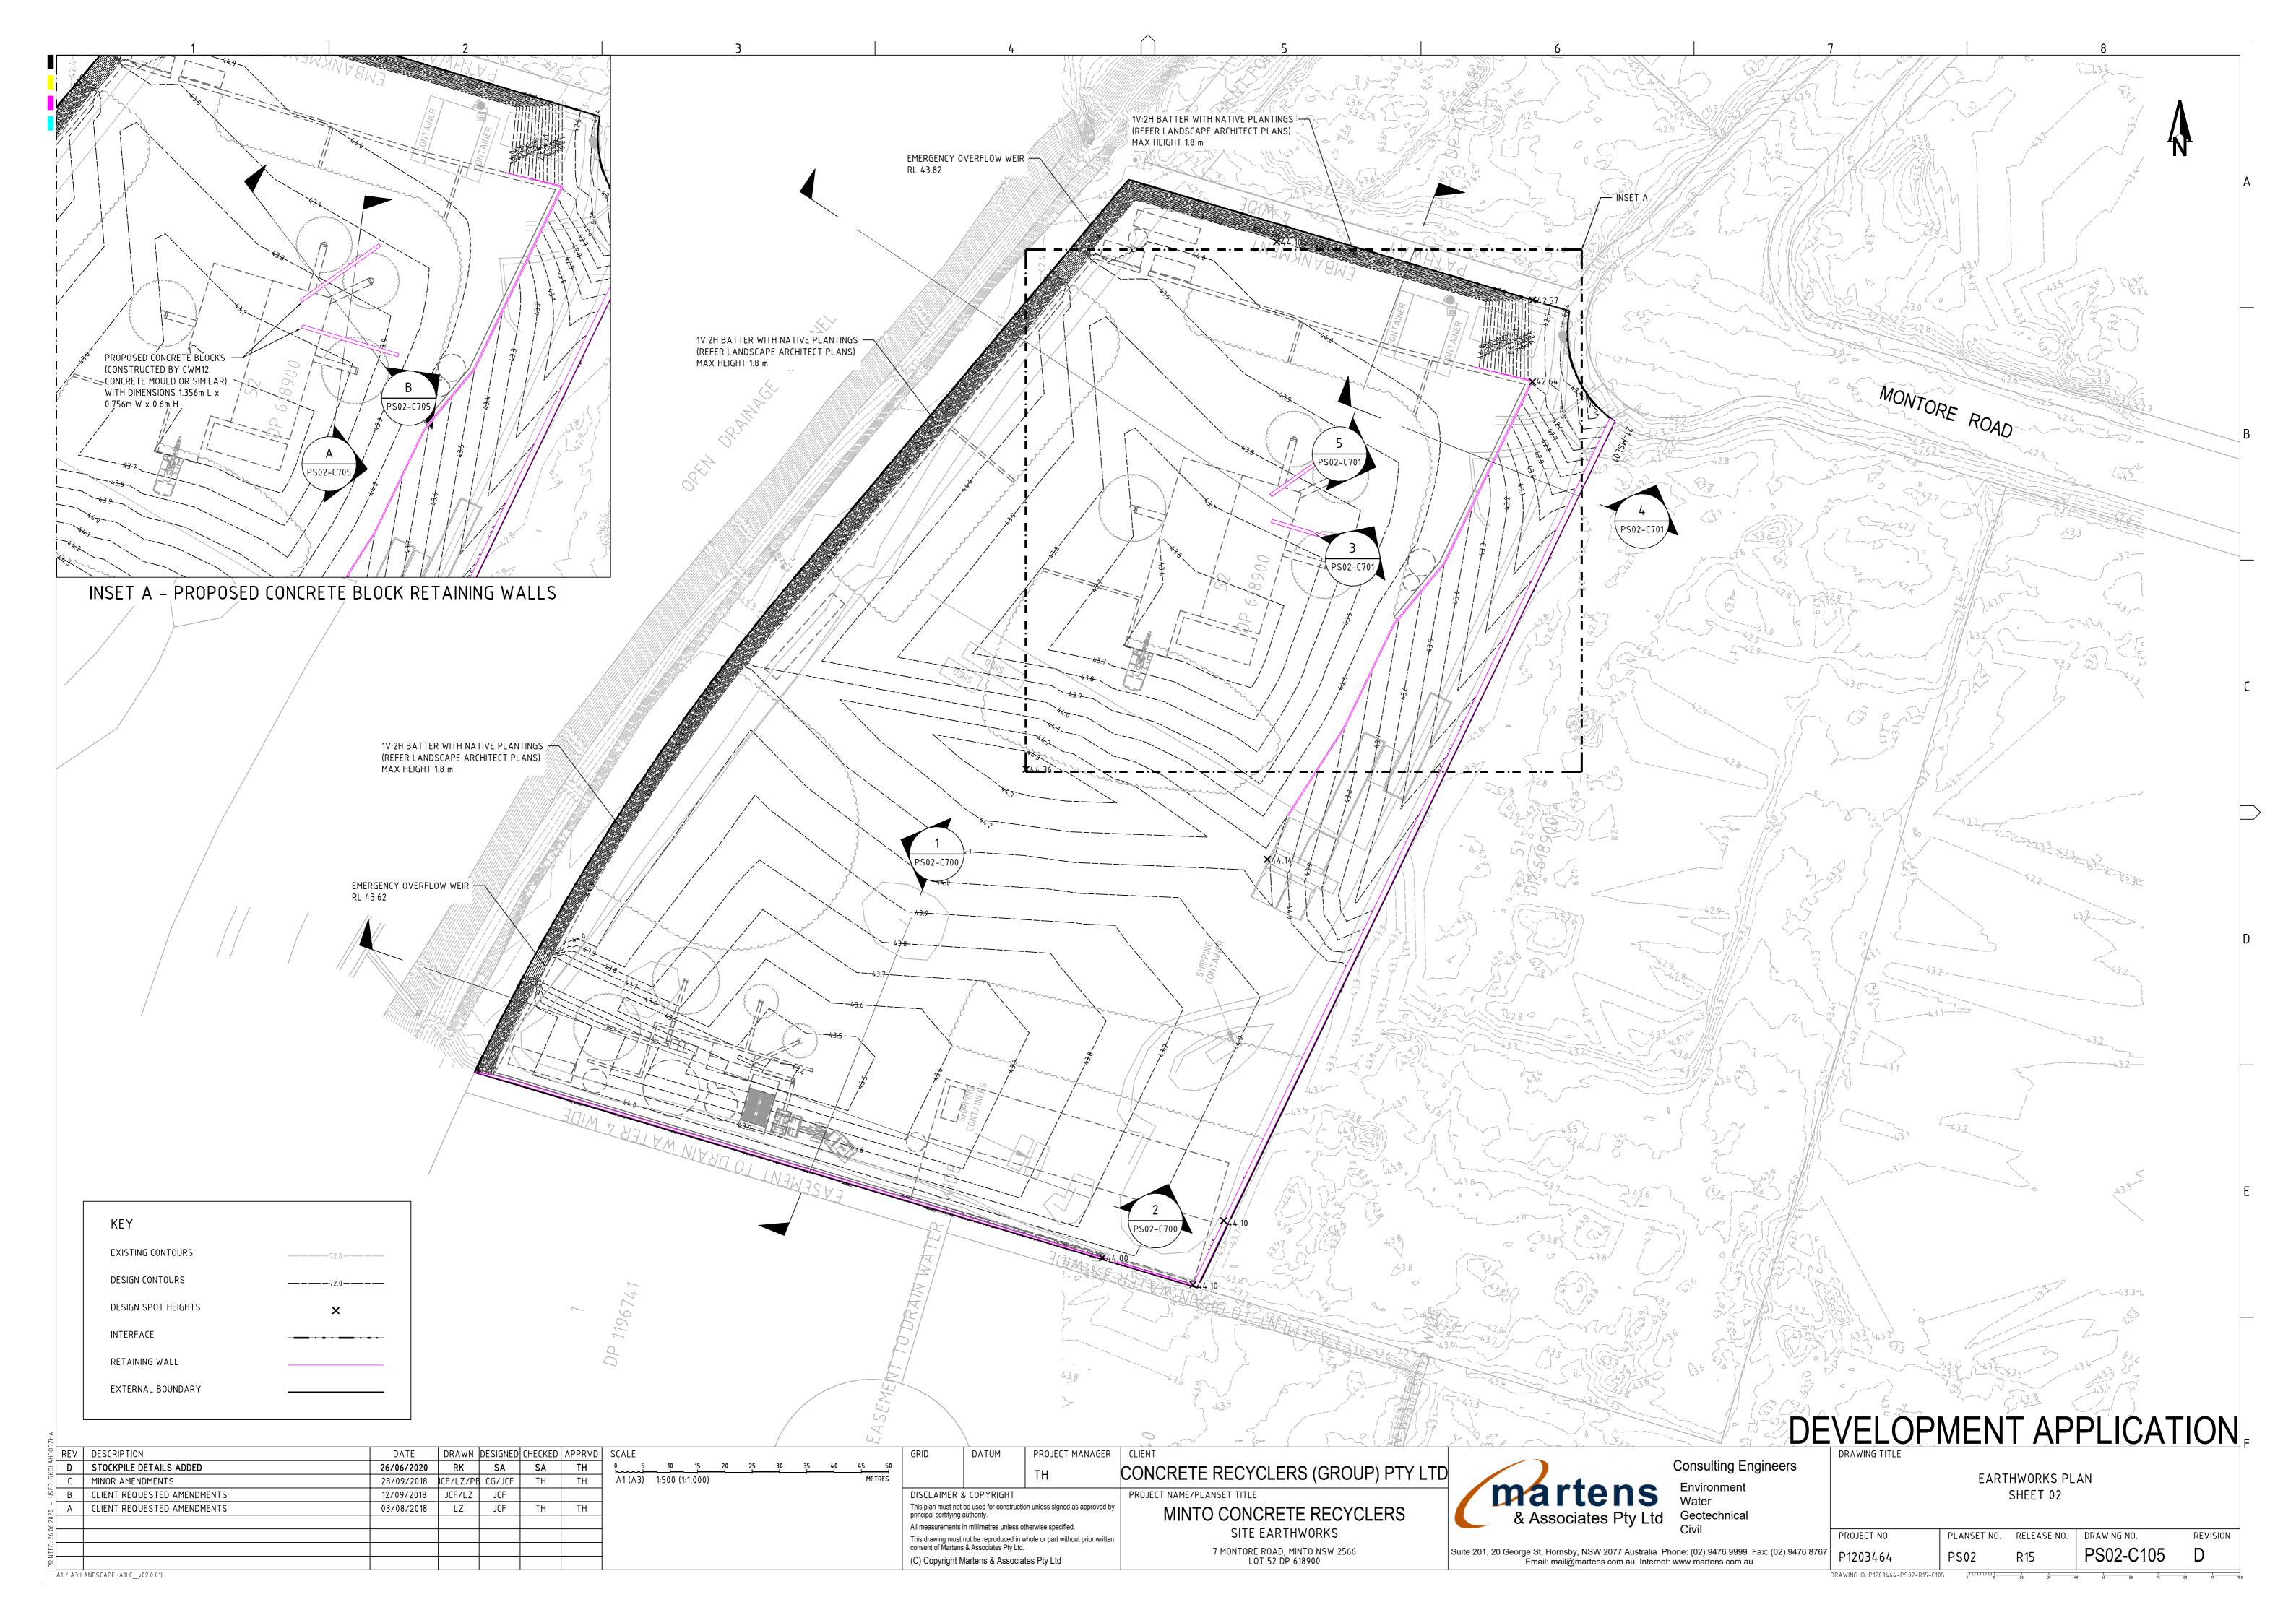SECTION 1

SCALE: HORIZONTAL - 1:200 VERTICAL - 1:200

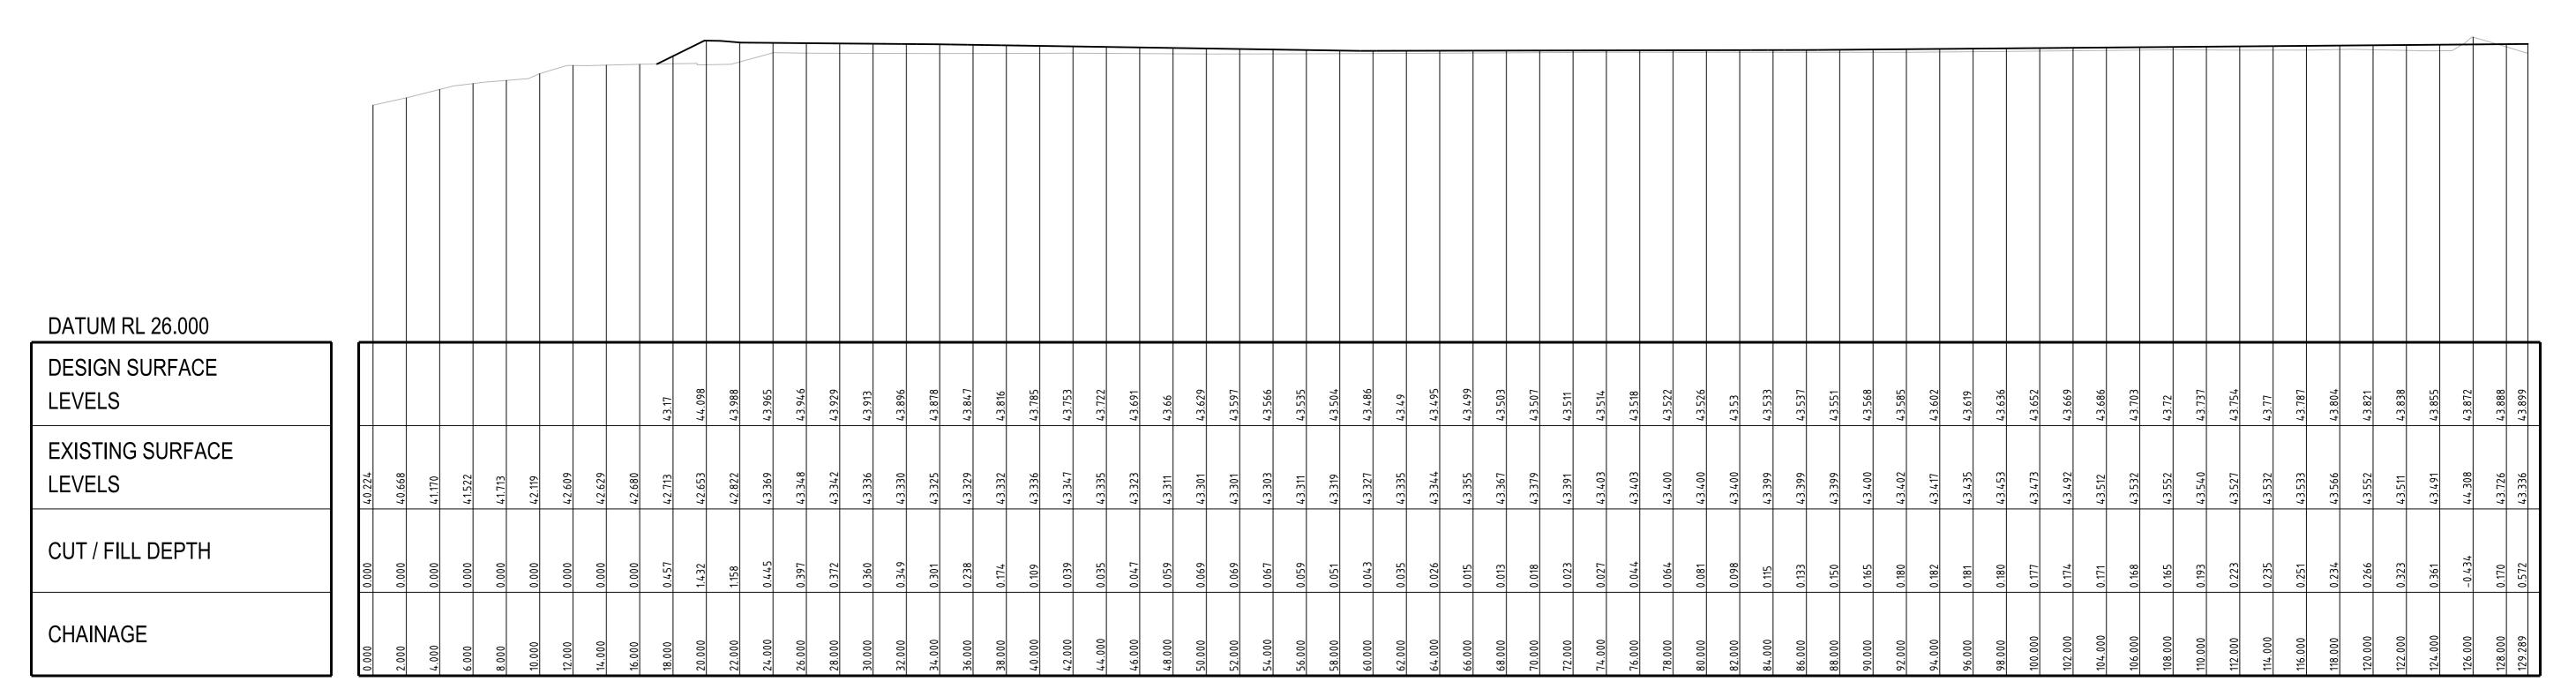

SECTION 2

SCALE: HORIZONTAL - 1:200

VERTICAL - 1:200

ZHA	REV	DESCRIPTION	DATE	DRAWN	DESIGNED	CHECKED	APPRVD	SCALE	GRID
4D00	Ε	MINOR AMENDMENTS	28/09/2018	JCF/LZ/PE	CG/JCF	TH	TH	0 2 4 6 8 10 12 14 16 18 2	
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:. RK	C	UPDATED AS PER CLIENT REQUEST	06/06/2018	RK/JCF	JCF	TH	TH		DISCLAIN
USEF	В	CLIENT REQUESTED AMENDMENTS	09/03/2018	KW	CG/JCF	TH			This plan m
1	Α	BALANCE SITE EARTHWORKS	07/11/2017	CG	CG	TH			All measure
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PROJECT MANAGER | CLIENT CONCRETE RECYCLERS (GROUP) PTY LTD MAHD PROJECT NAME/PLANSET TITLE _AIMER & COPYRIGHT nlan must not be used for construction unless signed as approved by nal certifying authority. MINTO CONCRETE RECYCLERS

asurements in millimetres unless otherwise specified. SITE EARTHWORKS rawing must not be reproduced in whole or part without prior written nt of Martens & Associates Pty Ltd. 7 MONTORE ROAD, MINTO NSW 2566 LOT 52 DP 618900 (C) Copyright Martens & Associates Pty Ltd



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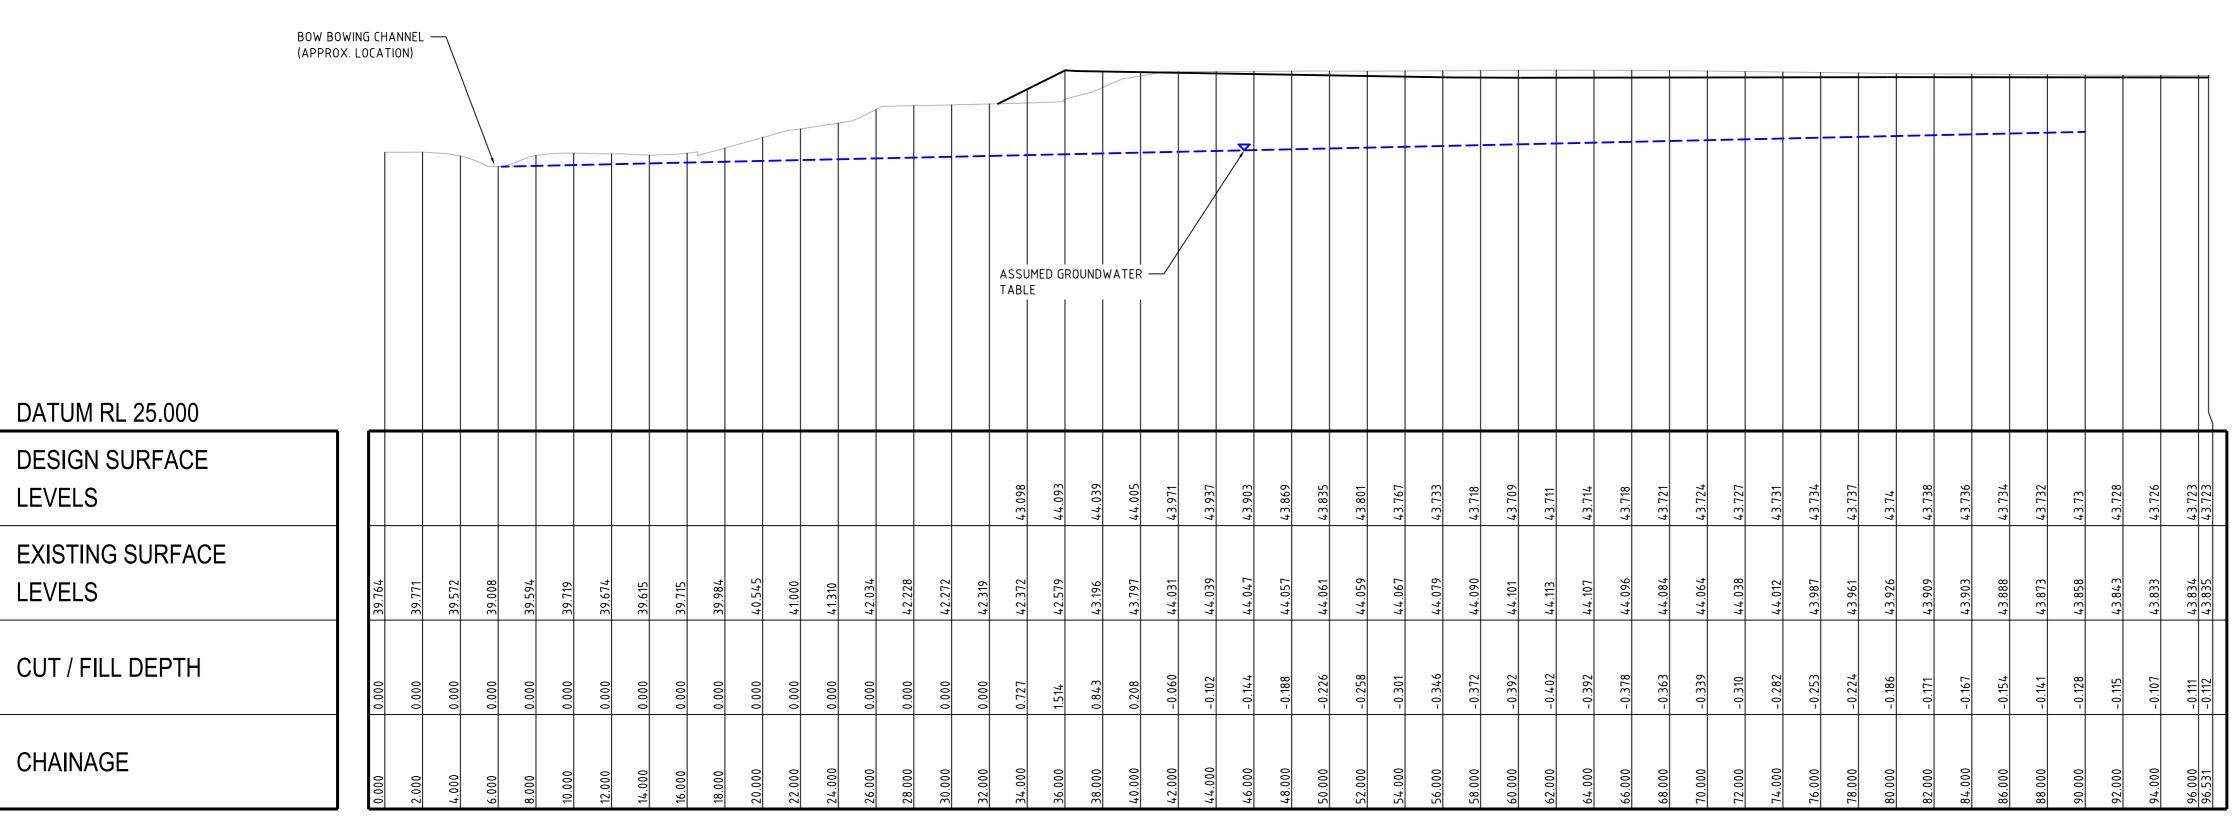
Consulting Engineers Environment

EARTHWORKS SECTIONS SHEET 01

PROJECT NO. PLANSET NO. RELEASE NO. DRAWING NO. REVISION P1203464


DEVELOPMENT APPLICATION

A1 / A3 LANDSCAPE (A1LC_v02.0.01)



SECTION 3 - CONCEPTUAL GROUNDWATER MODEL

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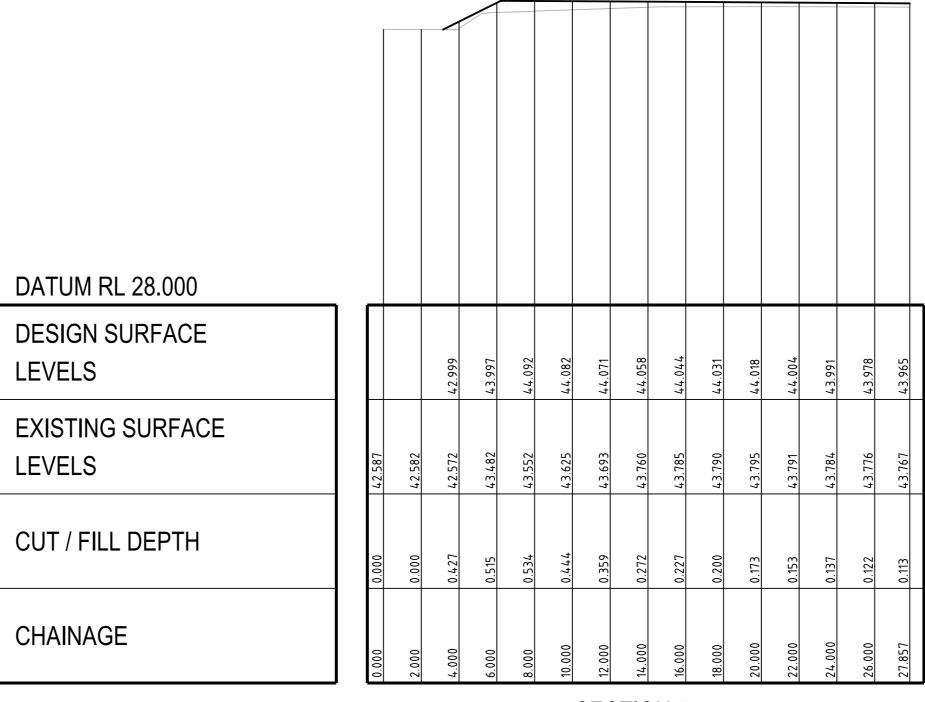


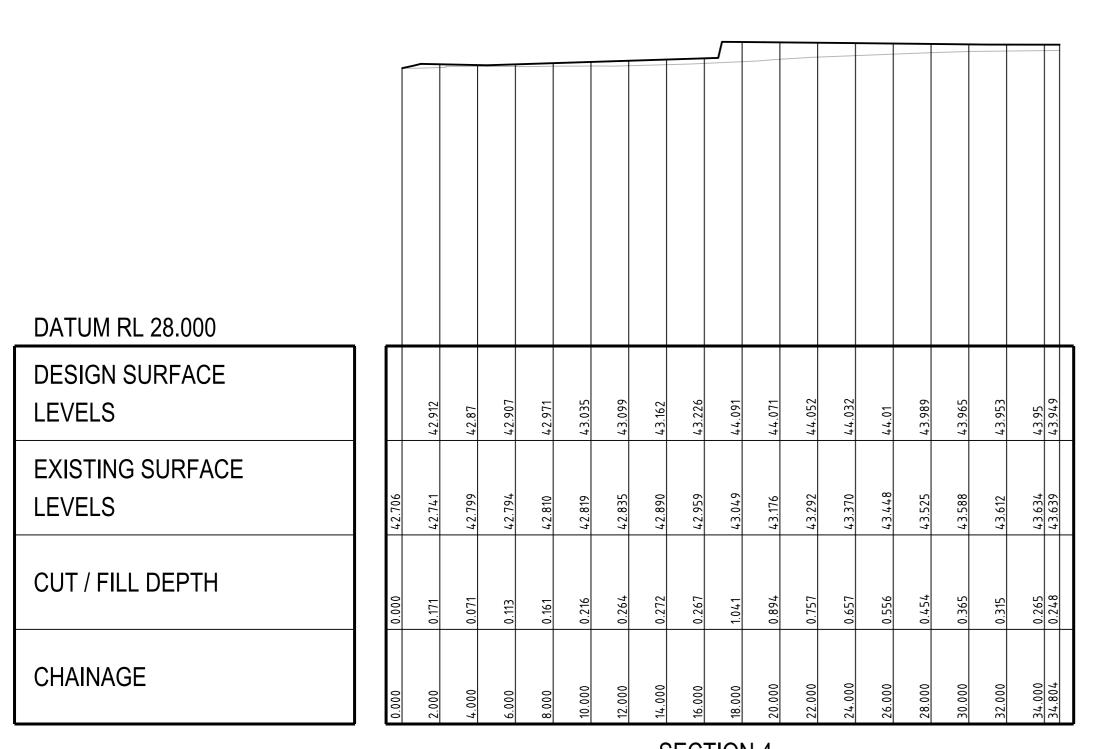07/11/2017 CG CG TH

SECTION 4

SCALE: HORIZONTAL - 1:200

VERTICAL - 1:200



SECTION 5

SCALE: HORIZONTAL - 1:200 VERTICAL - 1:200

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1D00	E MINOR AMENDMENTS	28/09/2018	JCF/LZ/PB CG/JCF	TH	TH	0 2 4 6 8 10 12 14 16 18 20		MVHD	 _{TU}	CONCRETE RECYCLERS (GROUP) PTY LTD	
OLAF	D CLIENT REQUESTED AMENDMENTS	12/09/2018	JCF/LZ JCF			A1 (A3) 1:200 (1:400) METRES		MAHD	1П	CONCRETE RECYCLERS (GROUP) PTY LTD	
₹. RK	C UPDATED AS PER CLIENT REQUEST	06/06/2018	RK/JCF JCF	TH	TH		DISCLAIMER 8	& COPYRIGHT		PROJECT NAME/PLANSET TITLE	
SEF	B CLIENT REQUESTED AMENDMENTS	09/03/2018	KW CG/JCF	TH			This plan must not	be used for construction	on unless signed as approved by	MINITO CONODETE DECVOLEDO	

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PROJECT NAME/PLANSET TITLE

MINTO CONCRETE RECYCLERS

SITE EARTHWORKS

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LOT 52 DP 618900



Consulting Engineers

Environment
Water

Geotechnical
Civil

EARTHWORKS SECTIONS SHEET 02

& Associates Pty Ltd Geotechnical Civil

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PROJECT NO. PLANSET NO. RELEASE NO. DRAWING NO. REVISION


PS02 R15

PS02-C701 E

DEVELOPMENT APPLICATION

A1 / A3 LANDSCAPE (A1LC_v02.0.01)

A BALANCE SITE EARTHWORKS

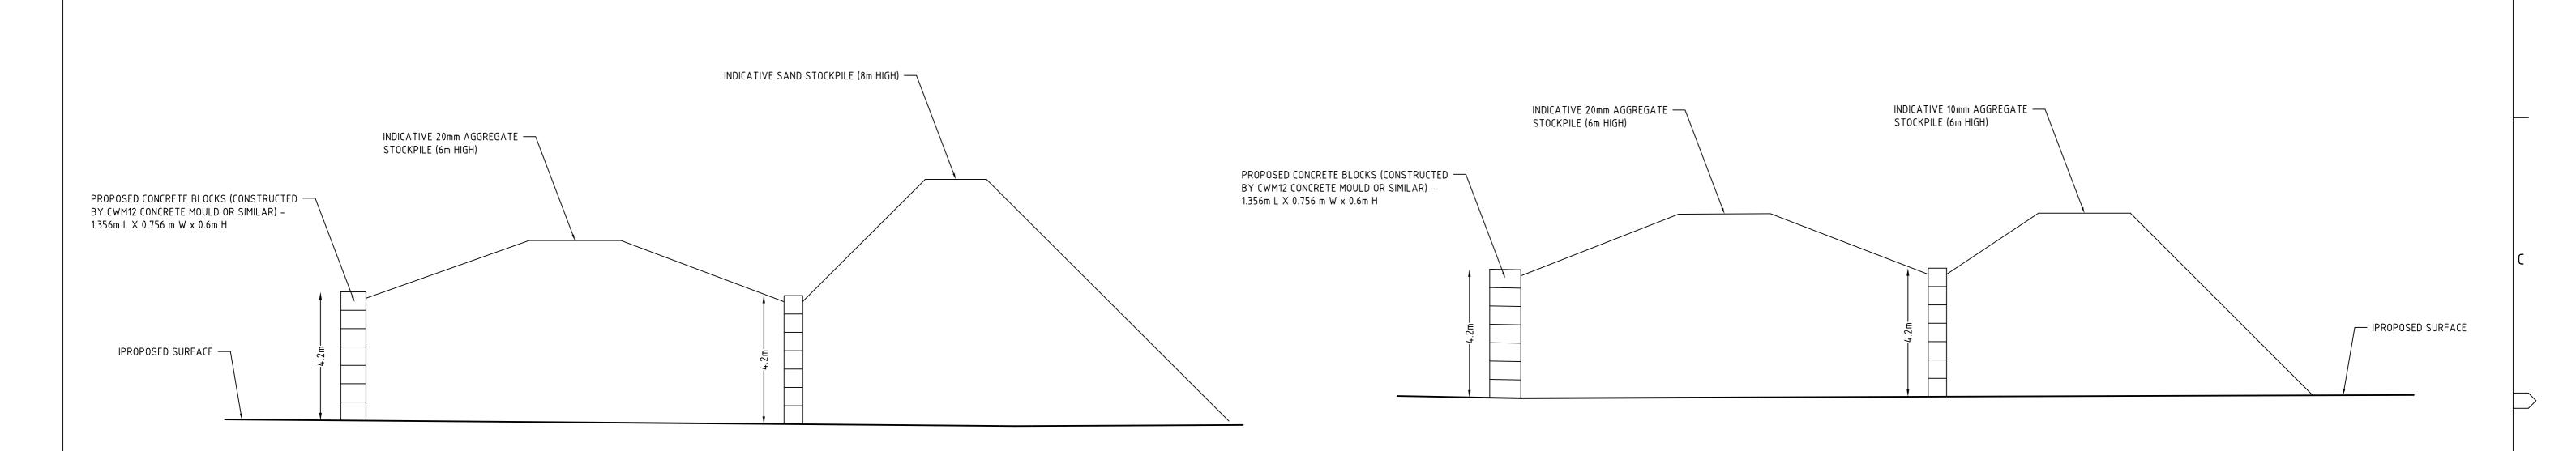

NOTES:
CONCRETE BLOCK RETAINING WALLS SHALL BE DESIGNED AND CERTIFIED BY STRUCTURAL ENGINEER.

REV DESCRIPTION

DATE DRAWN DESIGNED CHECKED APPRVD 26/06/2020 RK SA SA TH 26/06/2020 RK SA

SCALE: HORIZONTAL - 1:100

VERTICAL - 1:100

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LOT 52 DP 618900

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Water
Geotechnical
Civil

SCALE: HORIZONTAL - 1:100


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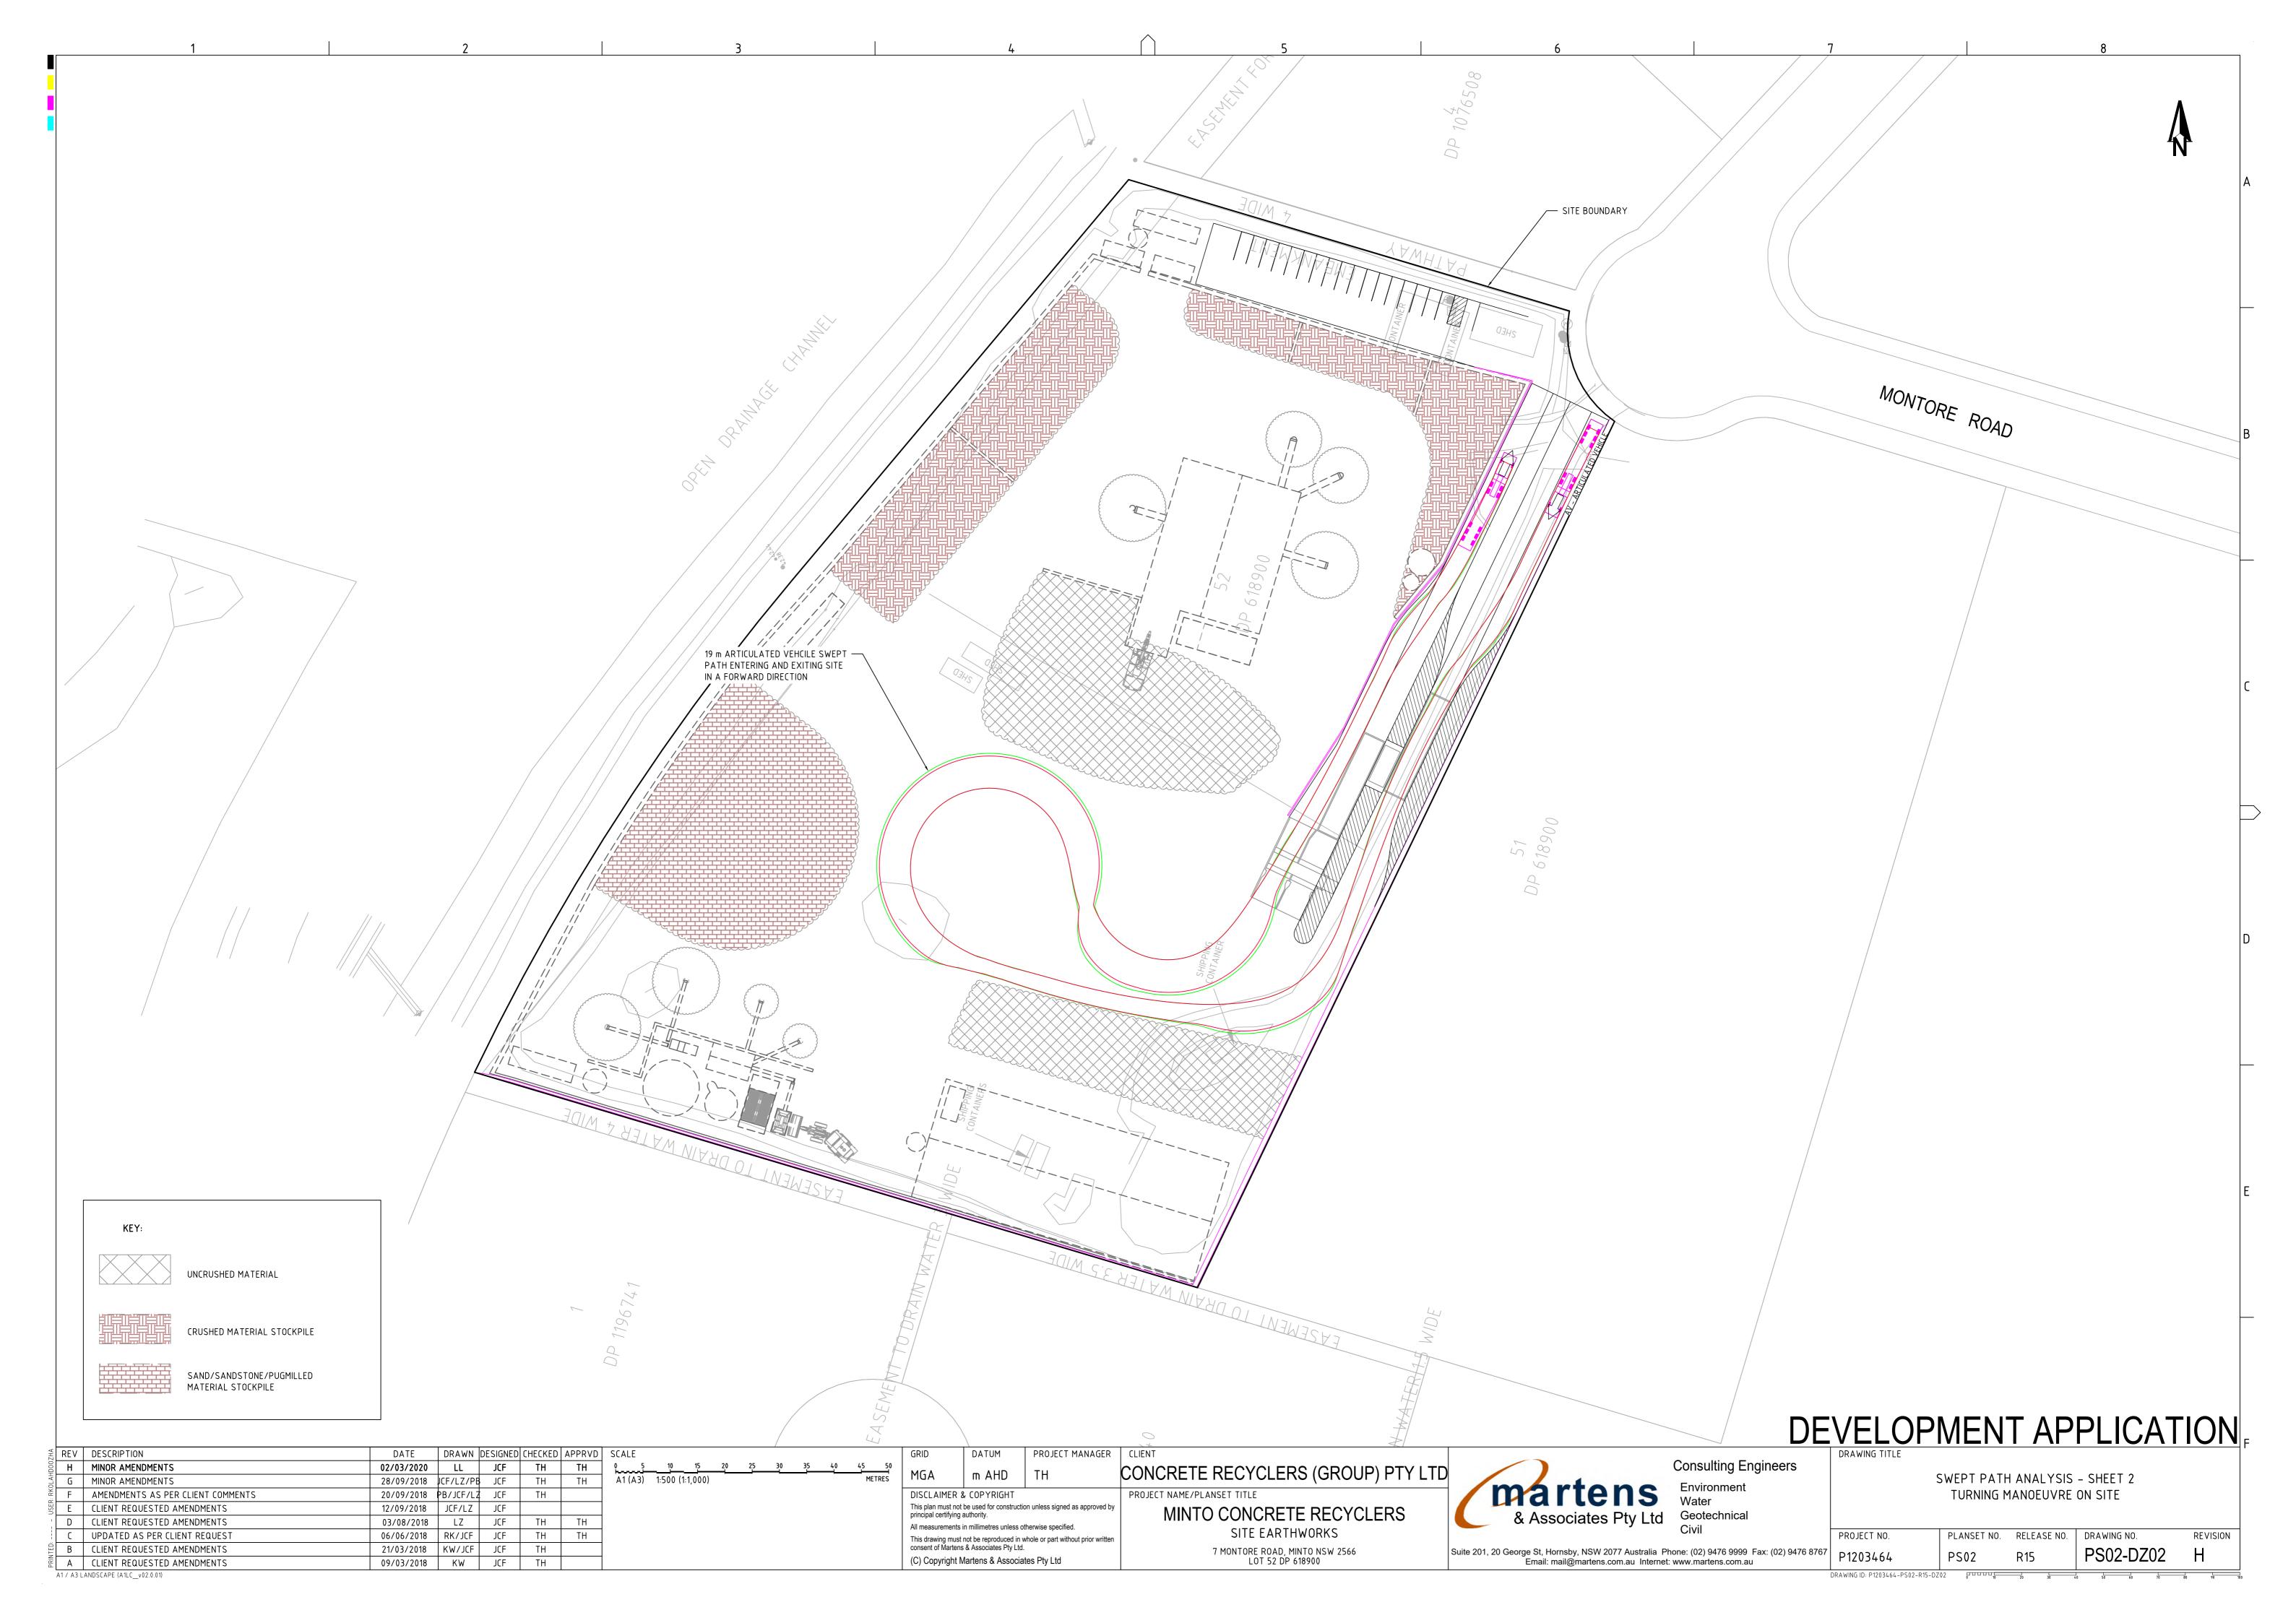
Suite 201, 20 George St, Hornsby, NSW 2077 Australia Phone: (02) 9476 9999 Fax: (02) 9476 8767 Email: mail@martens.com.au Internet: www.martens.com.au


DEVELOPMENT APPLICATION FOR SHEET 03


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P1203464 PS02 R15 PS02-C705 A


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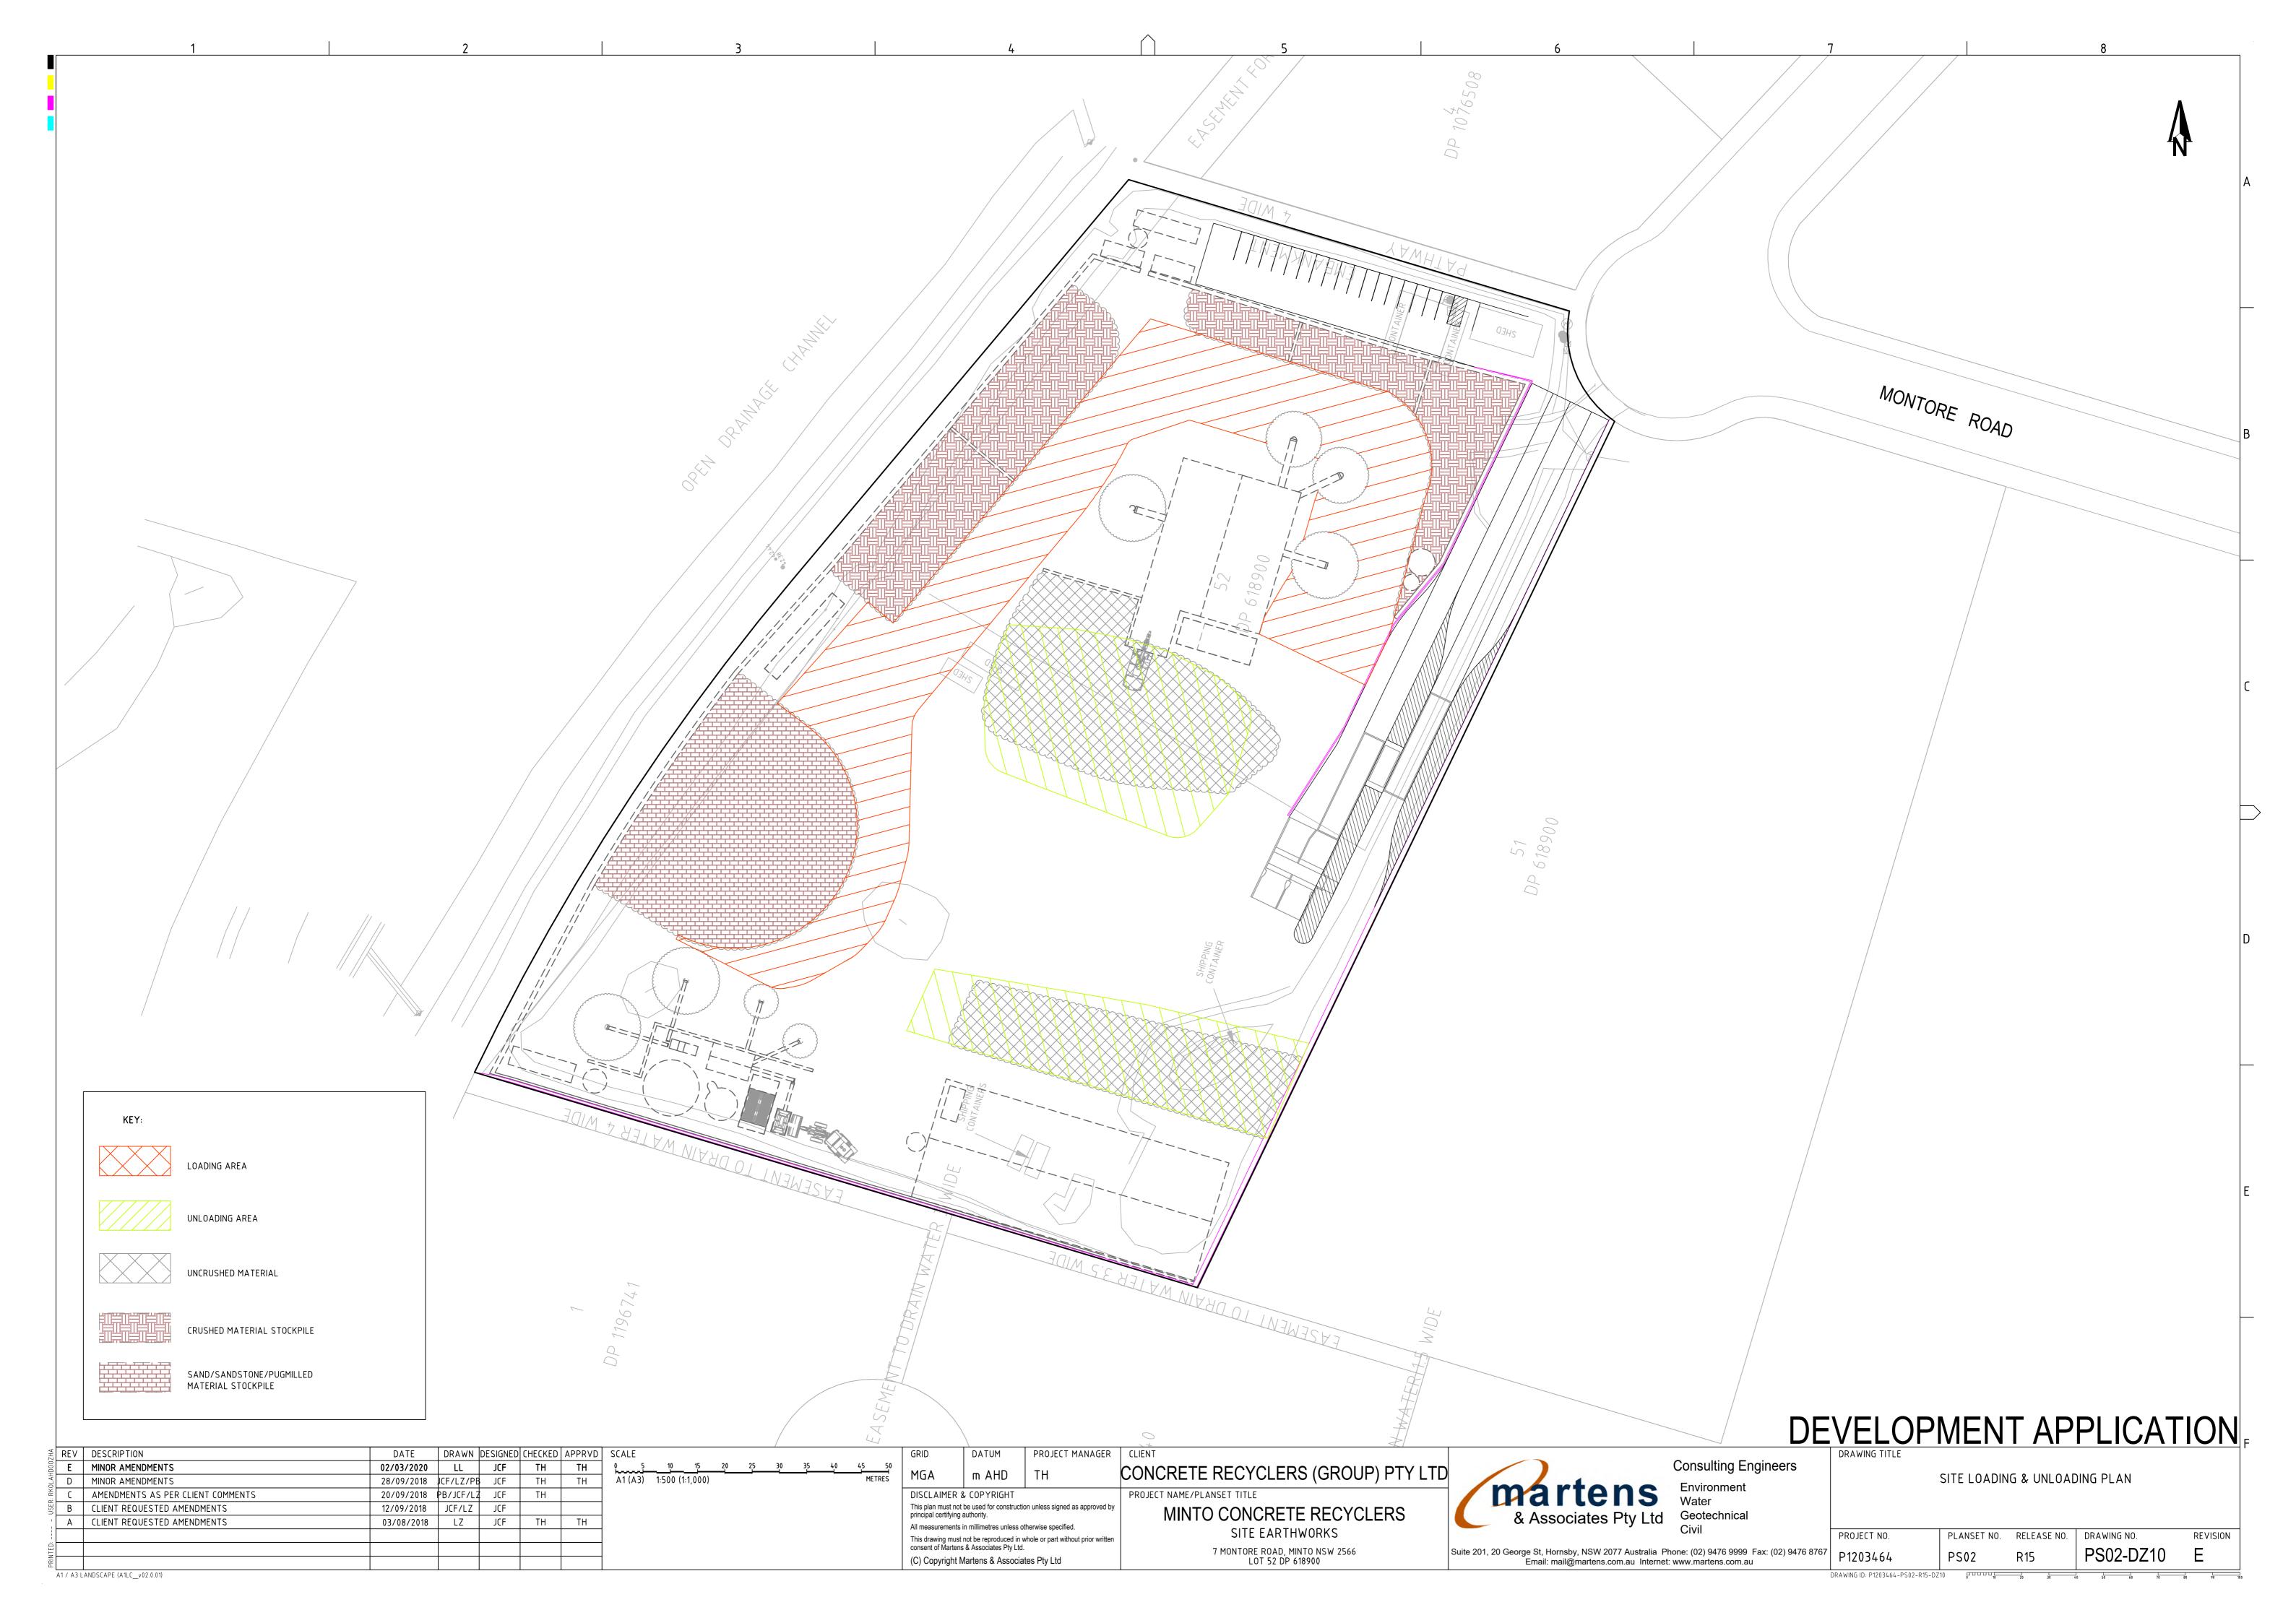





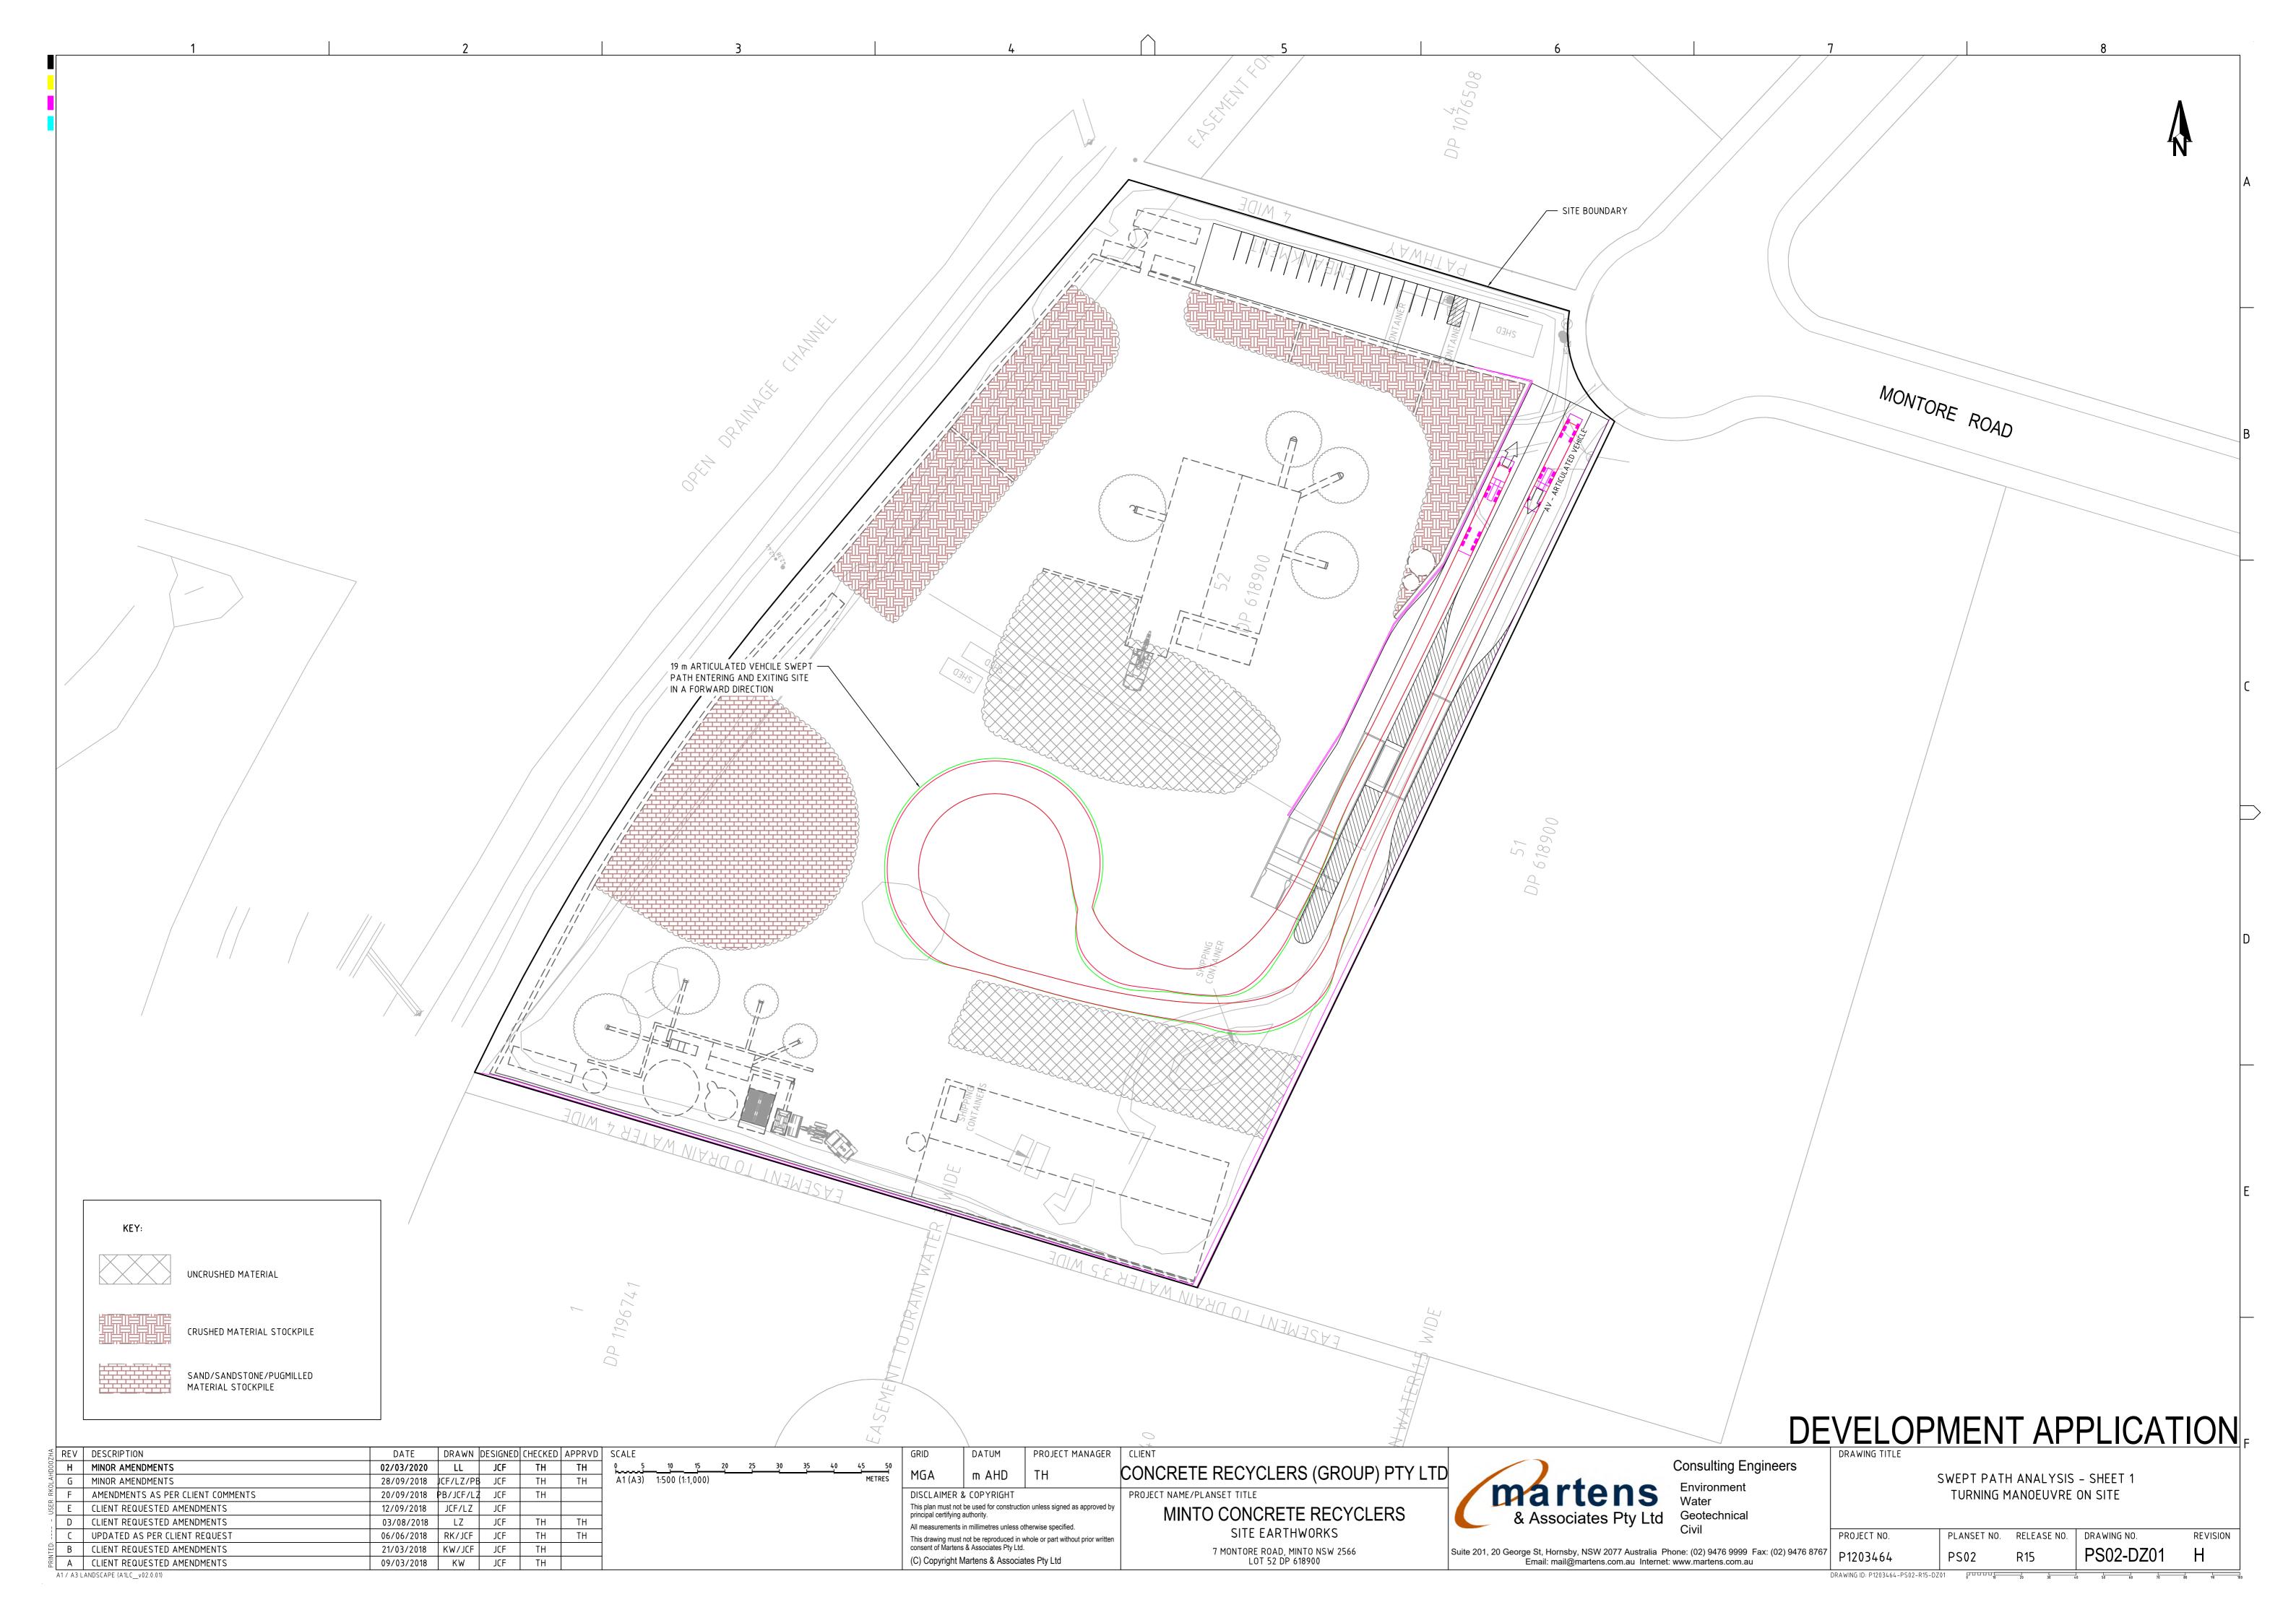


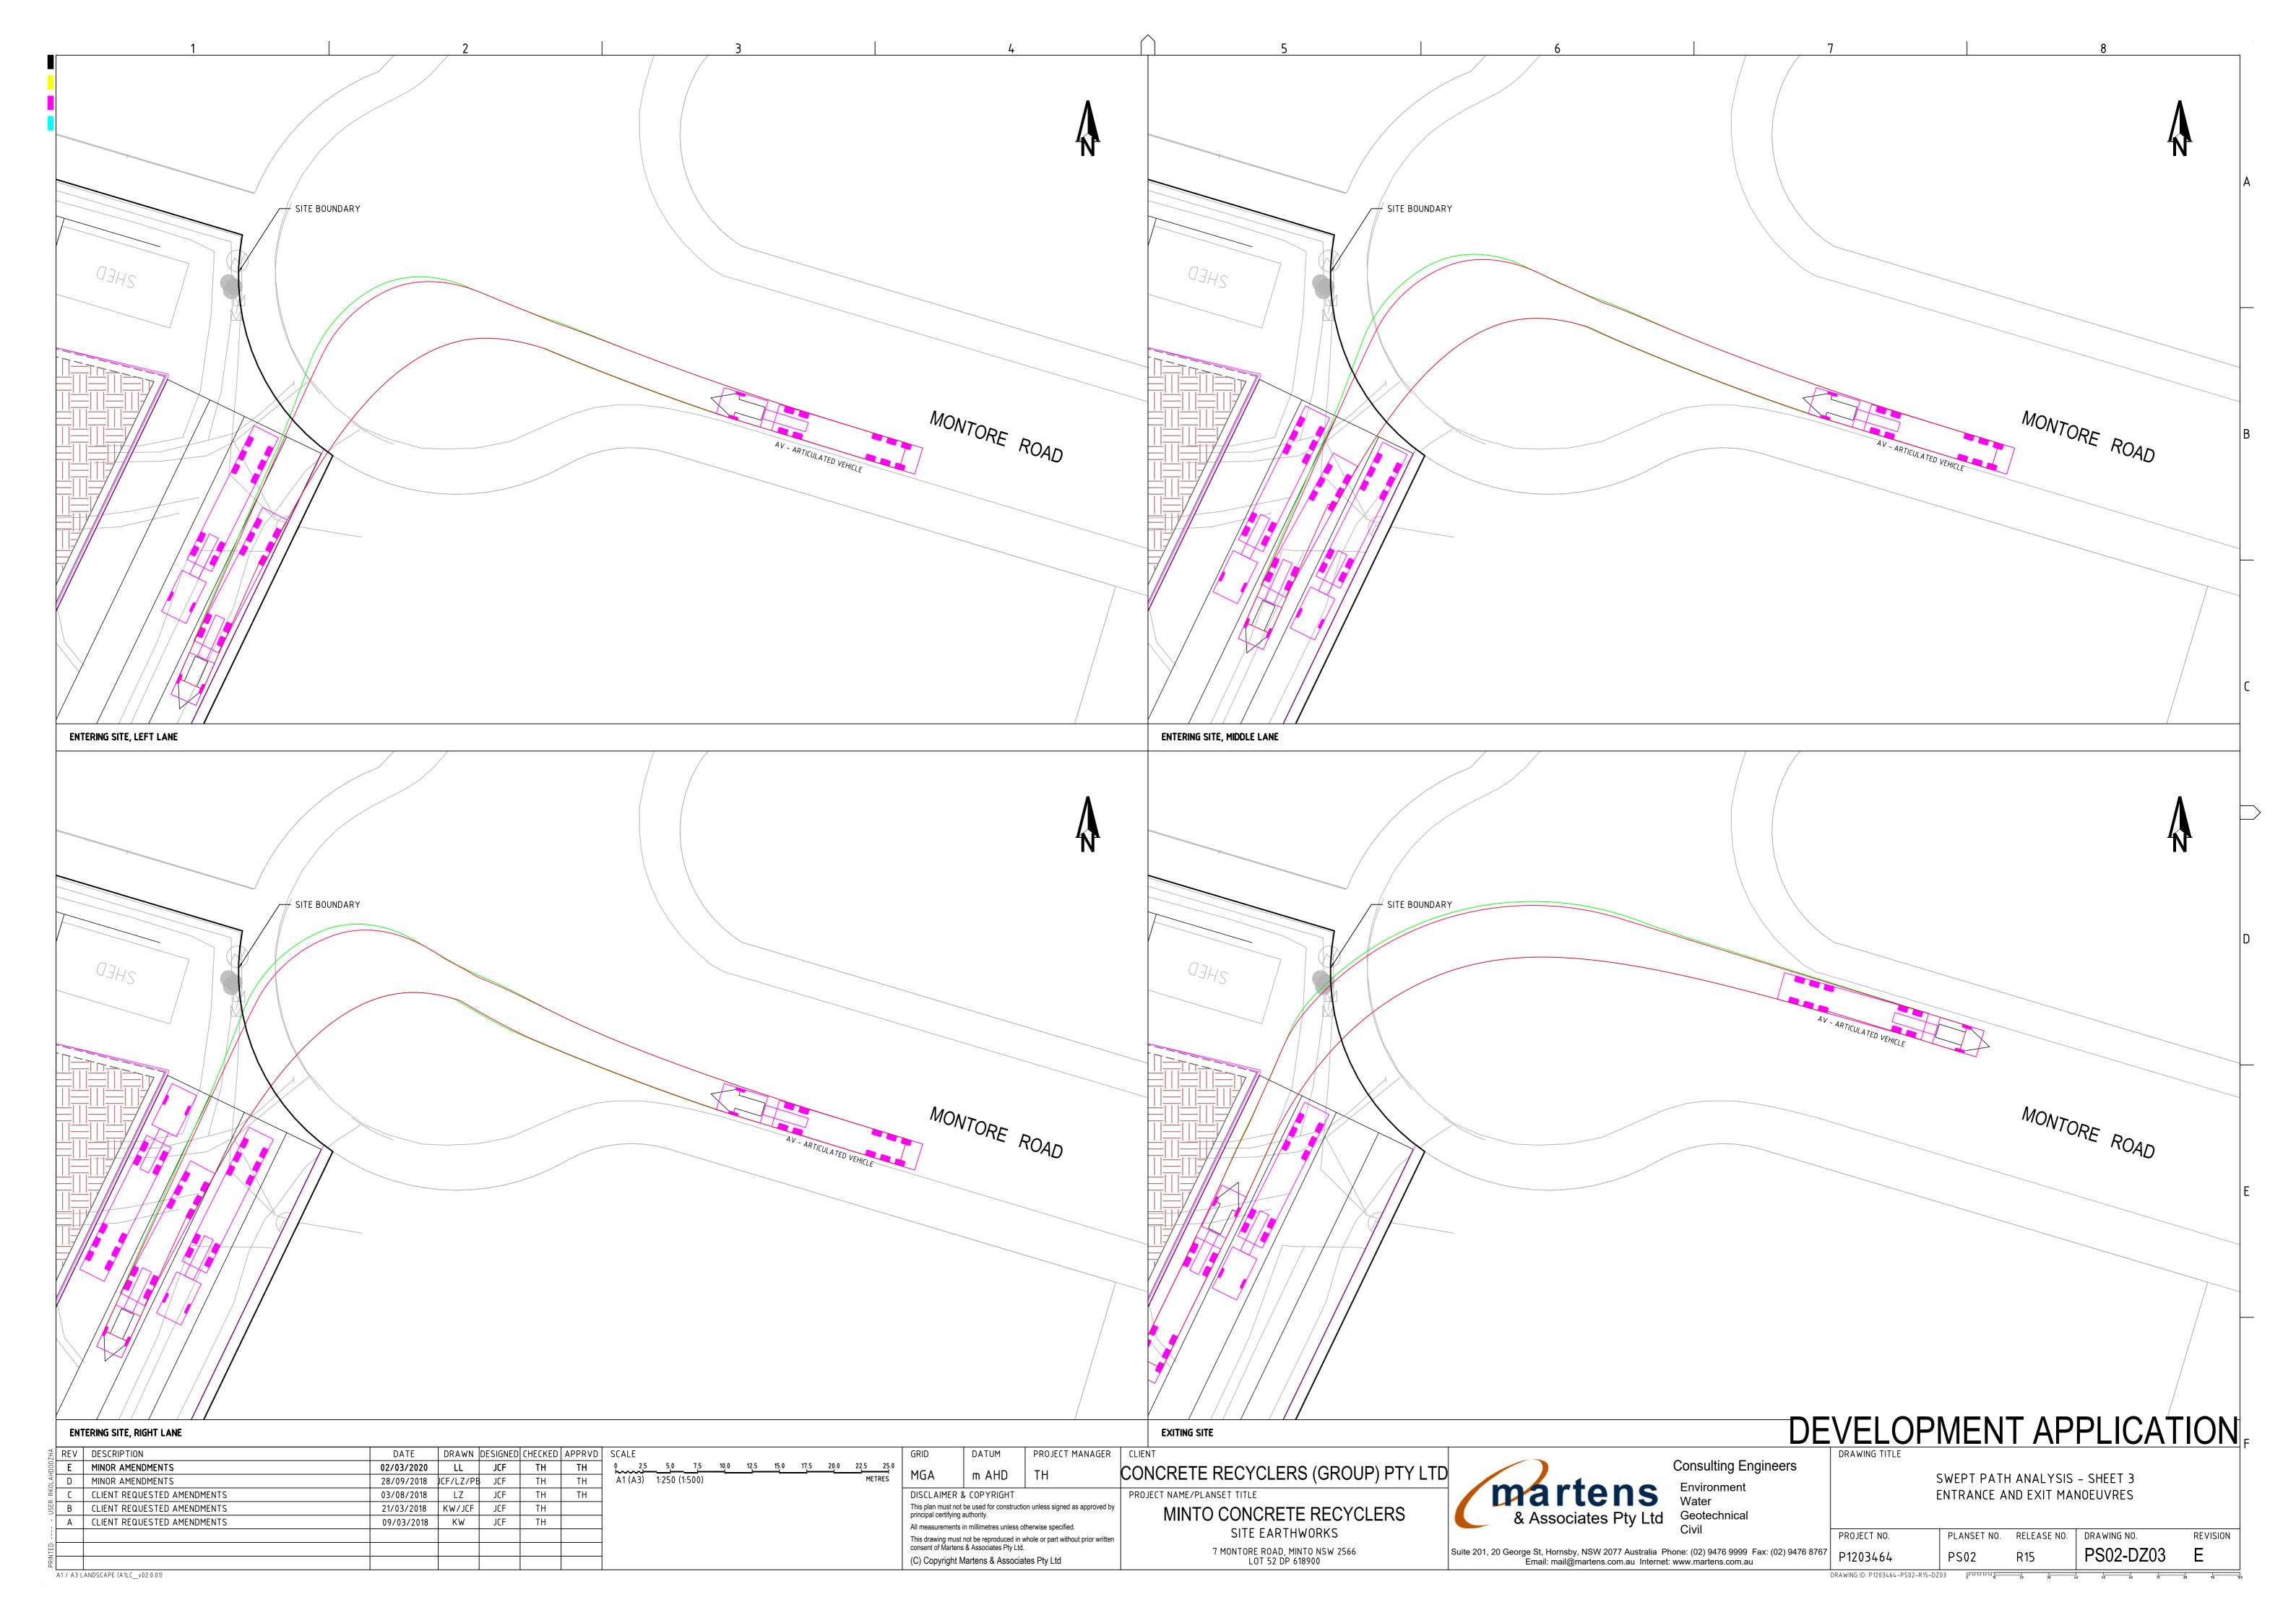

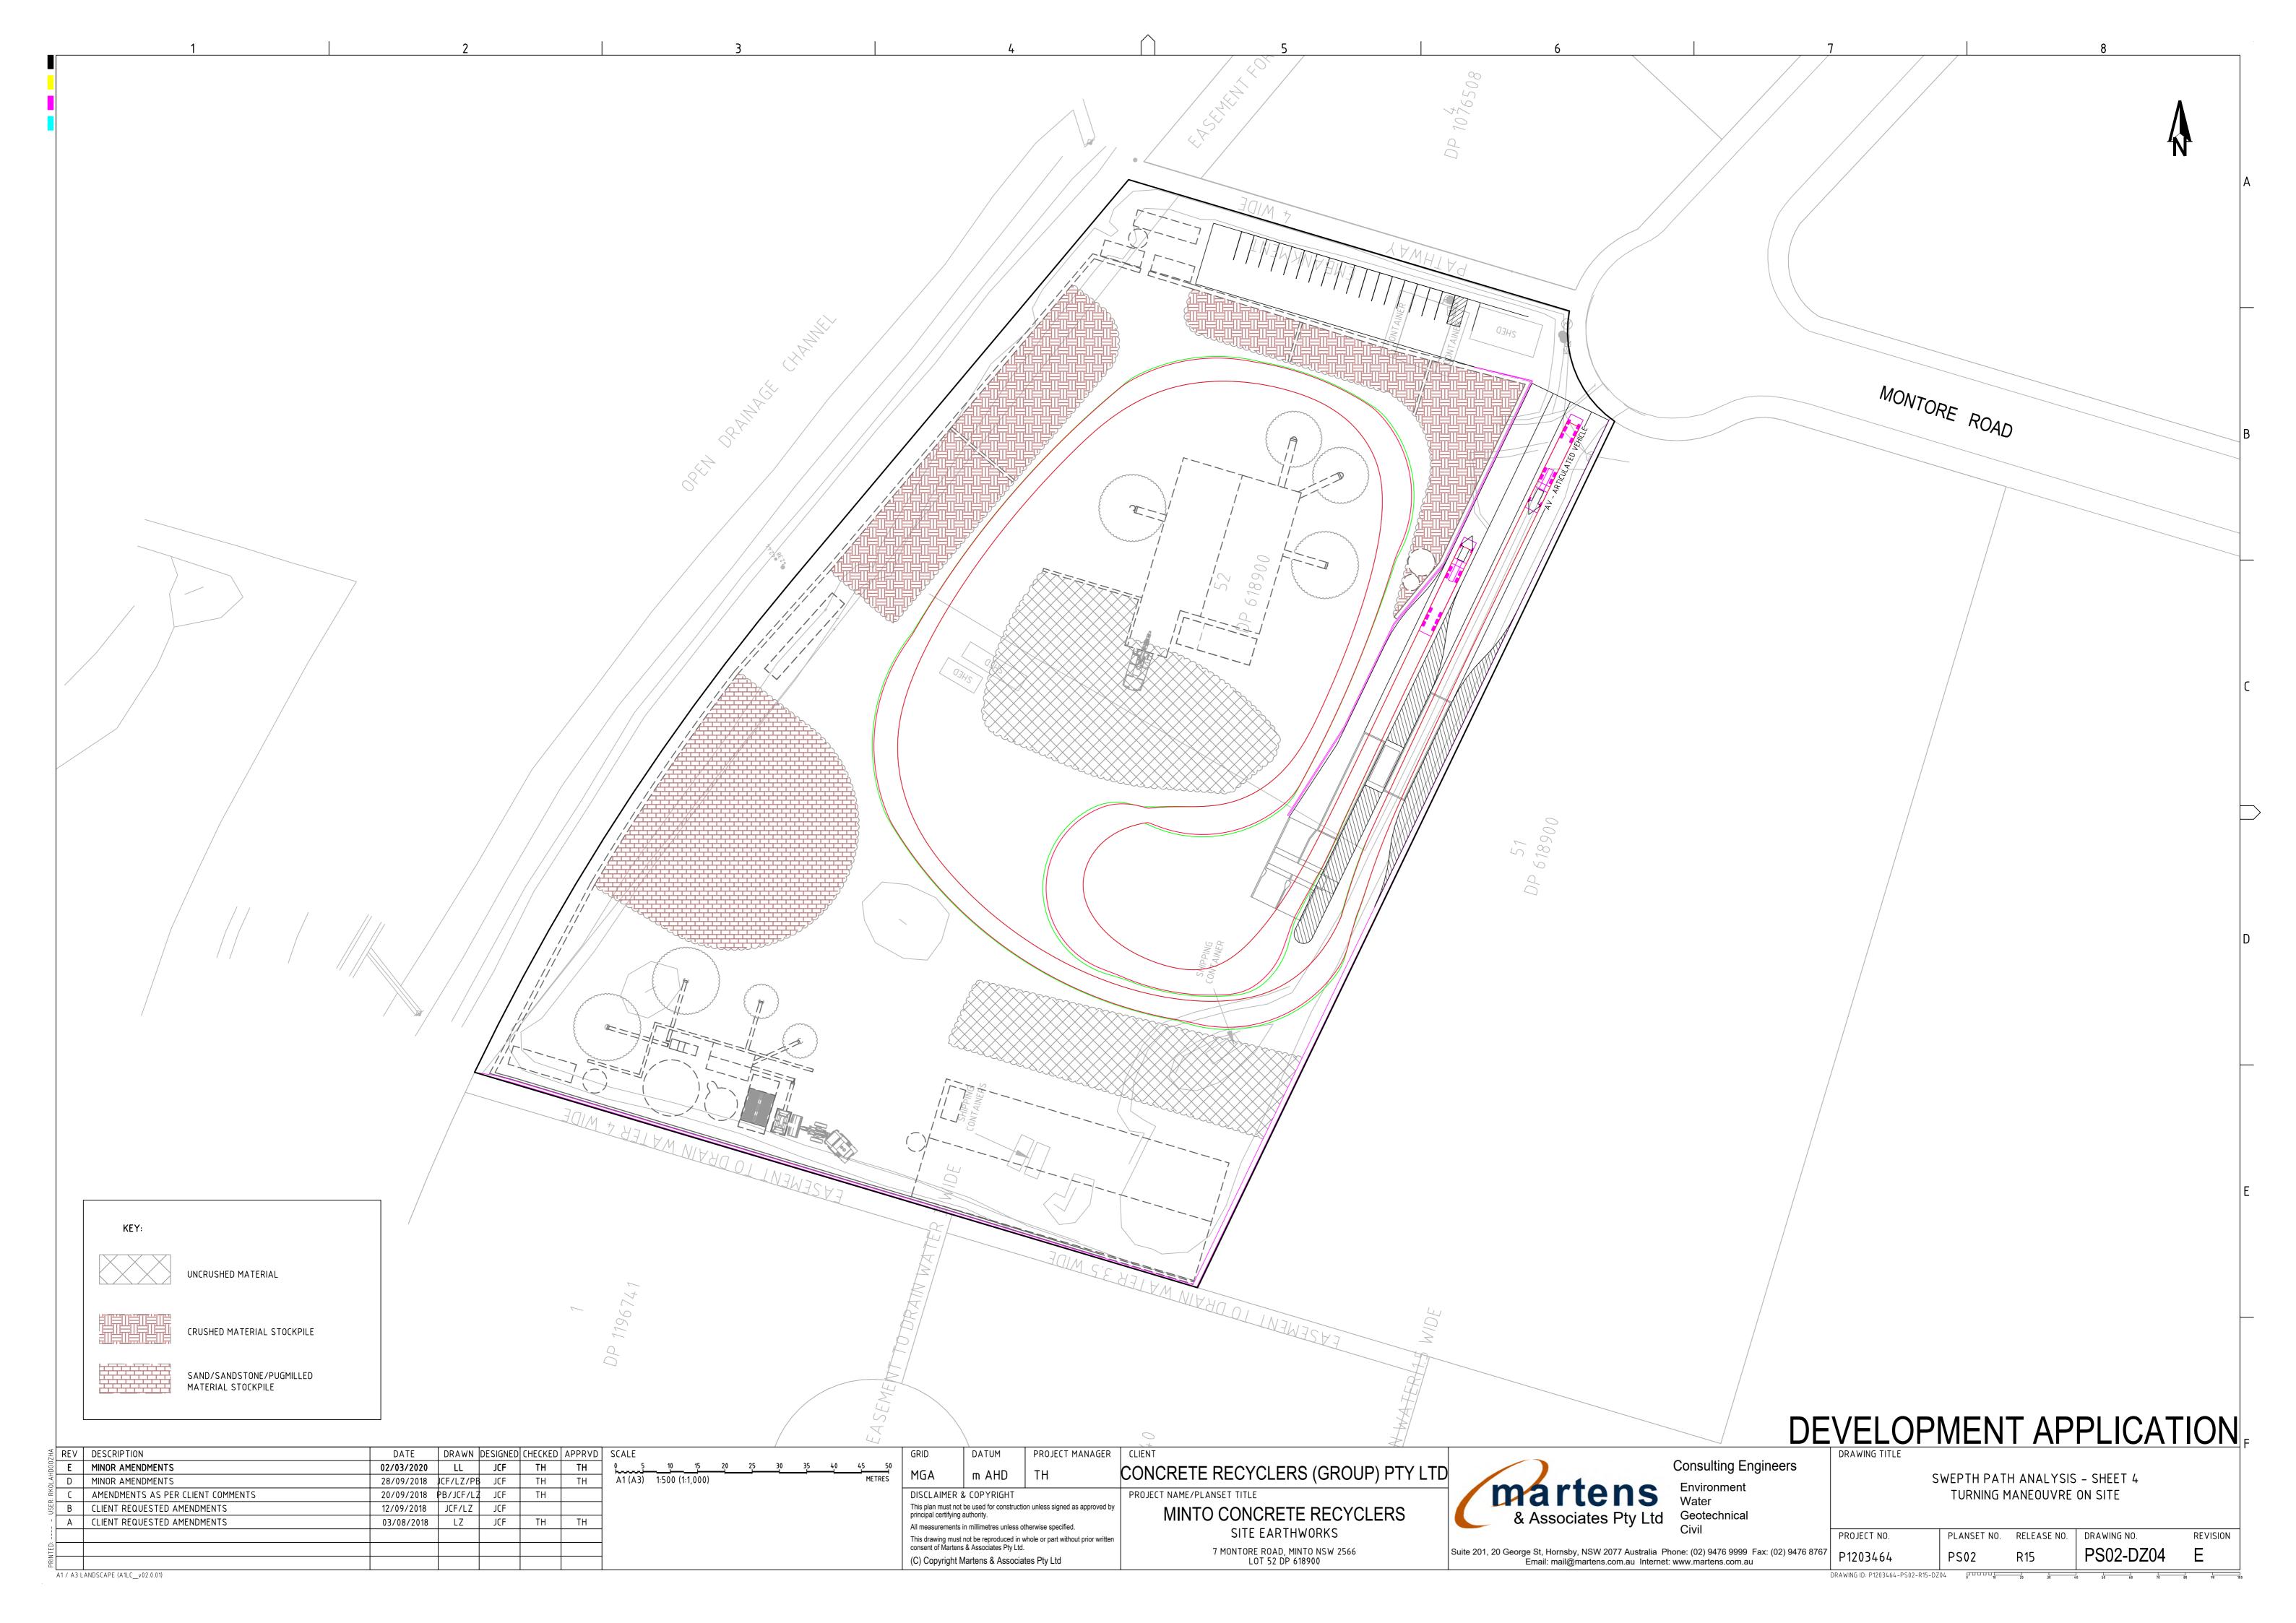


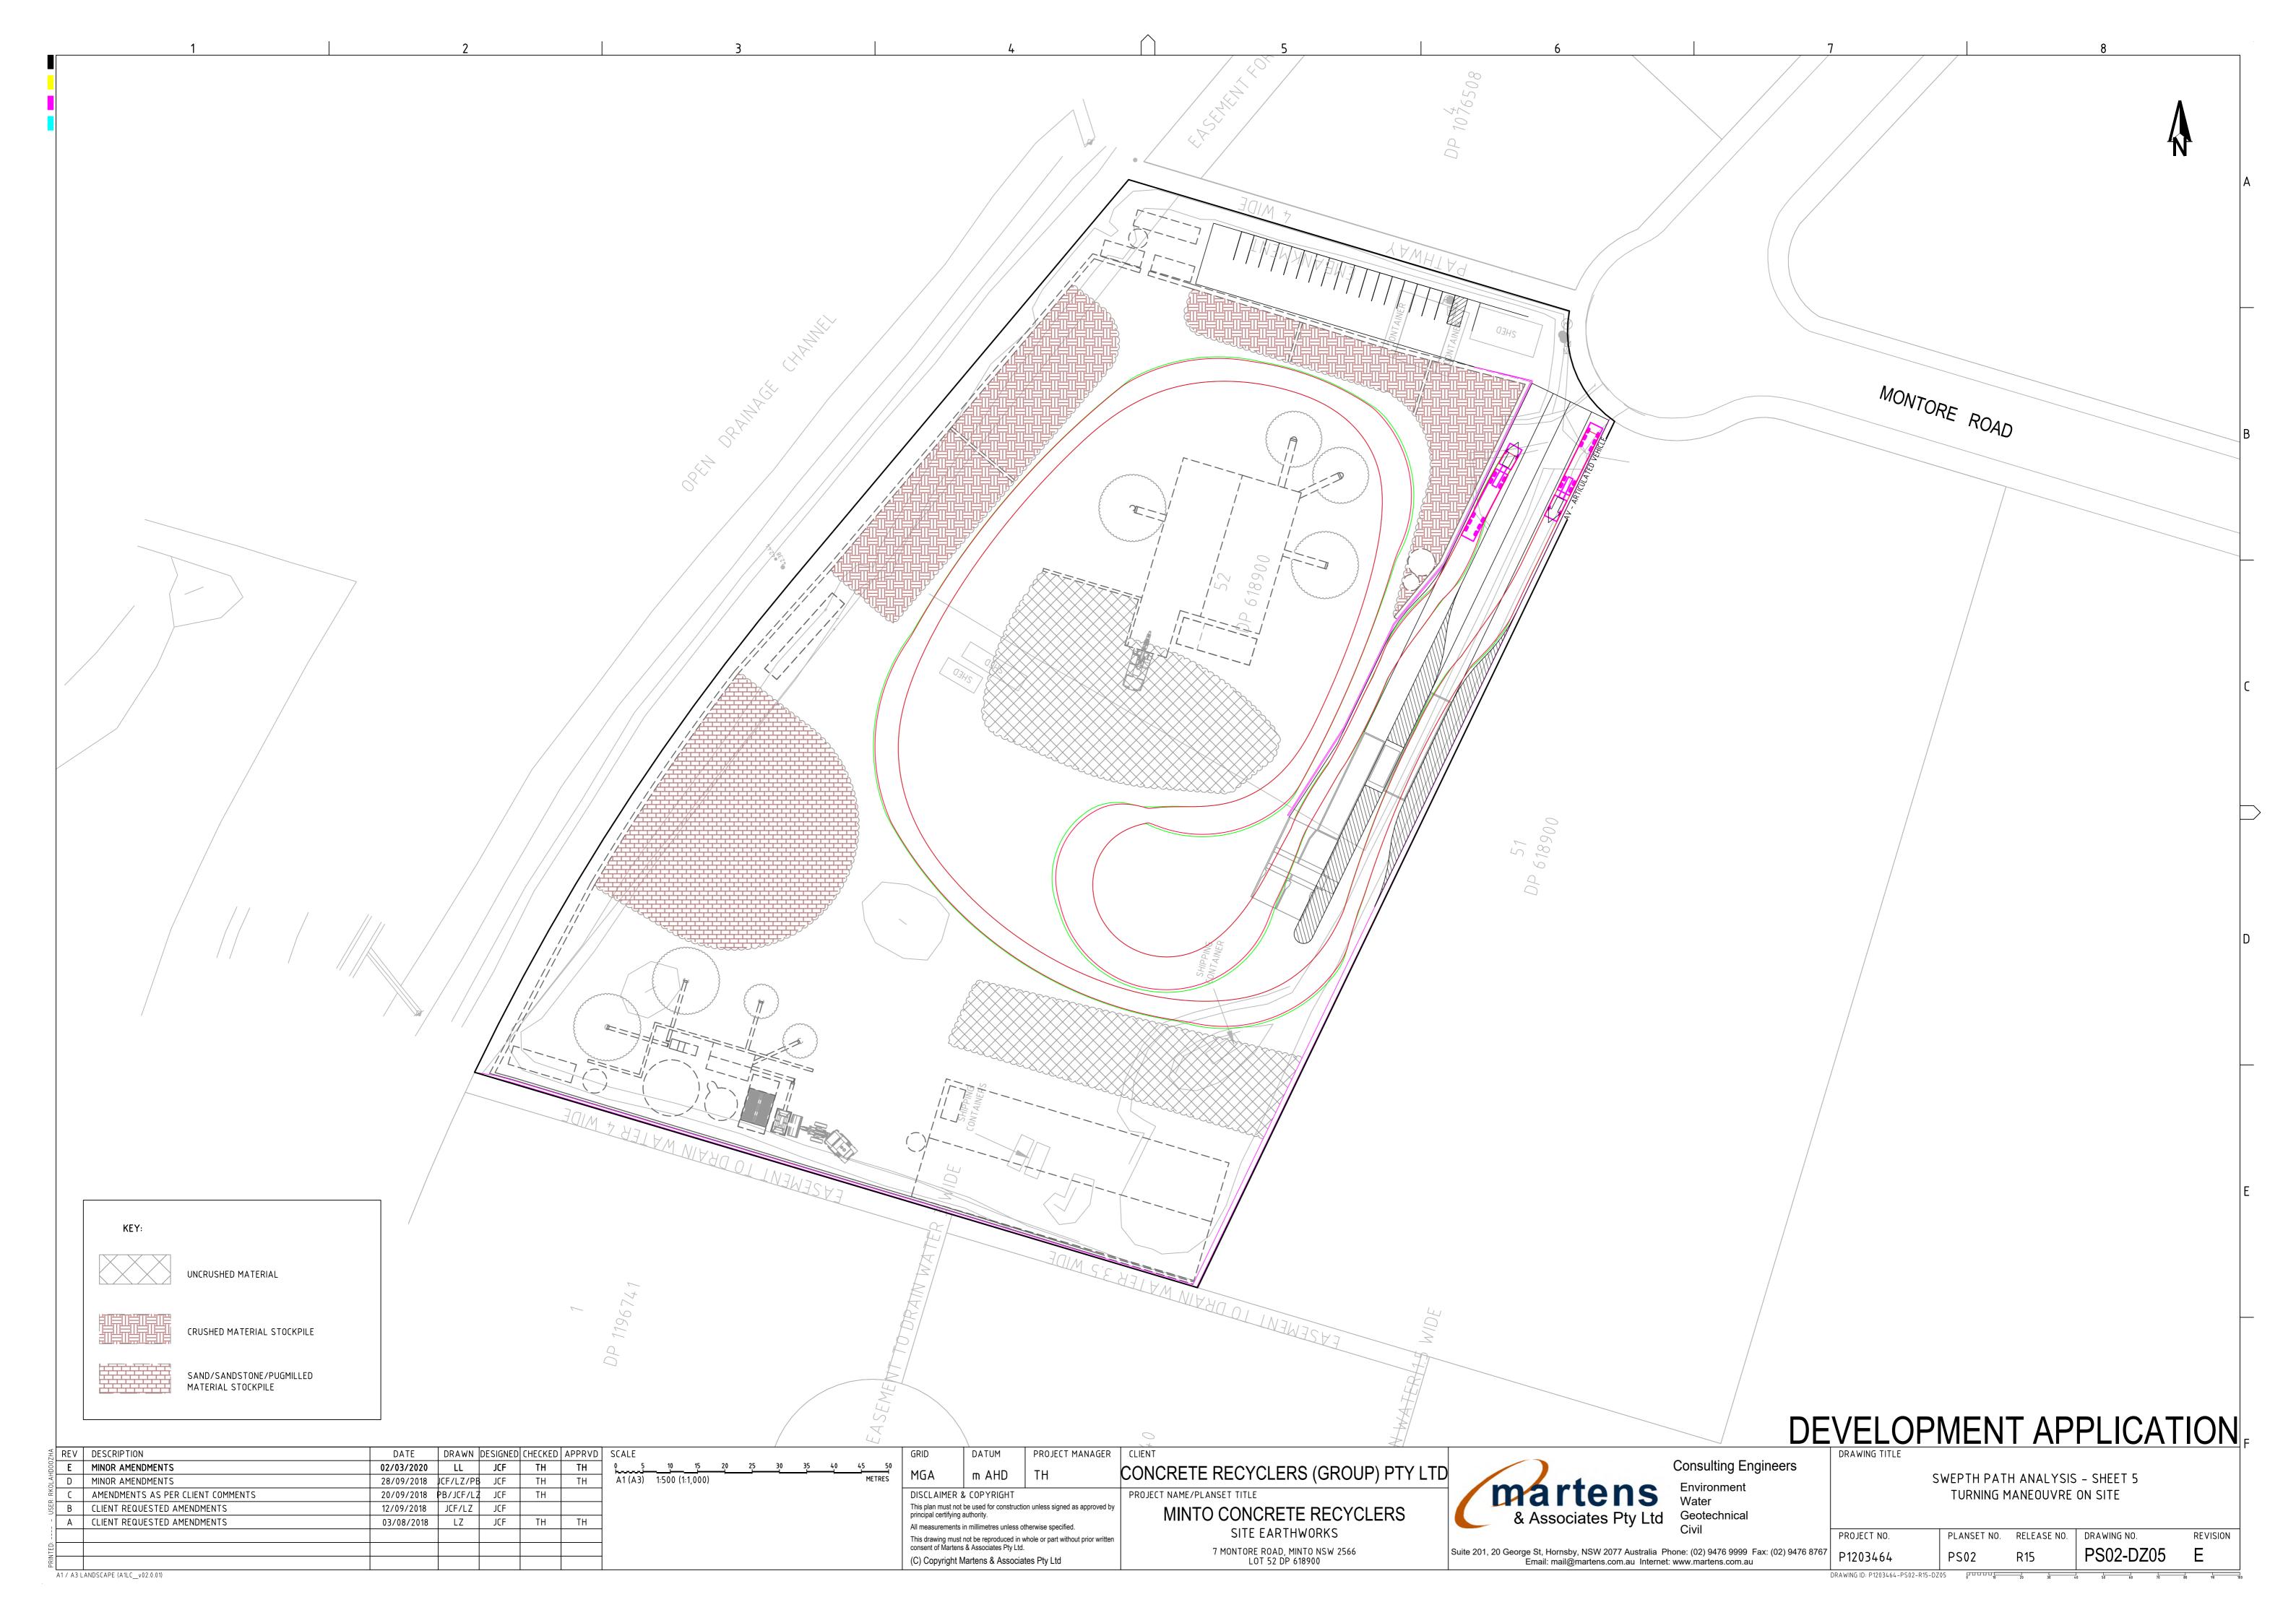

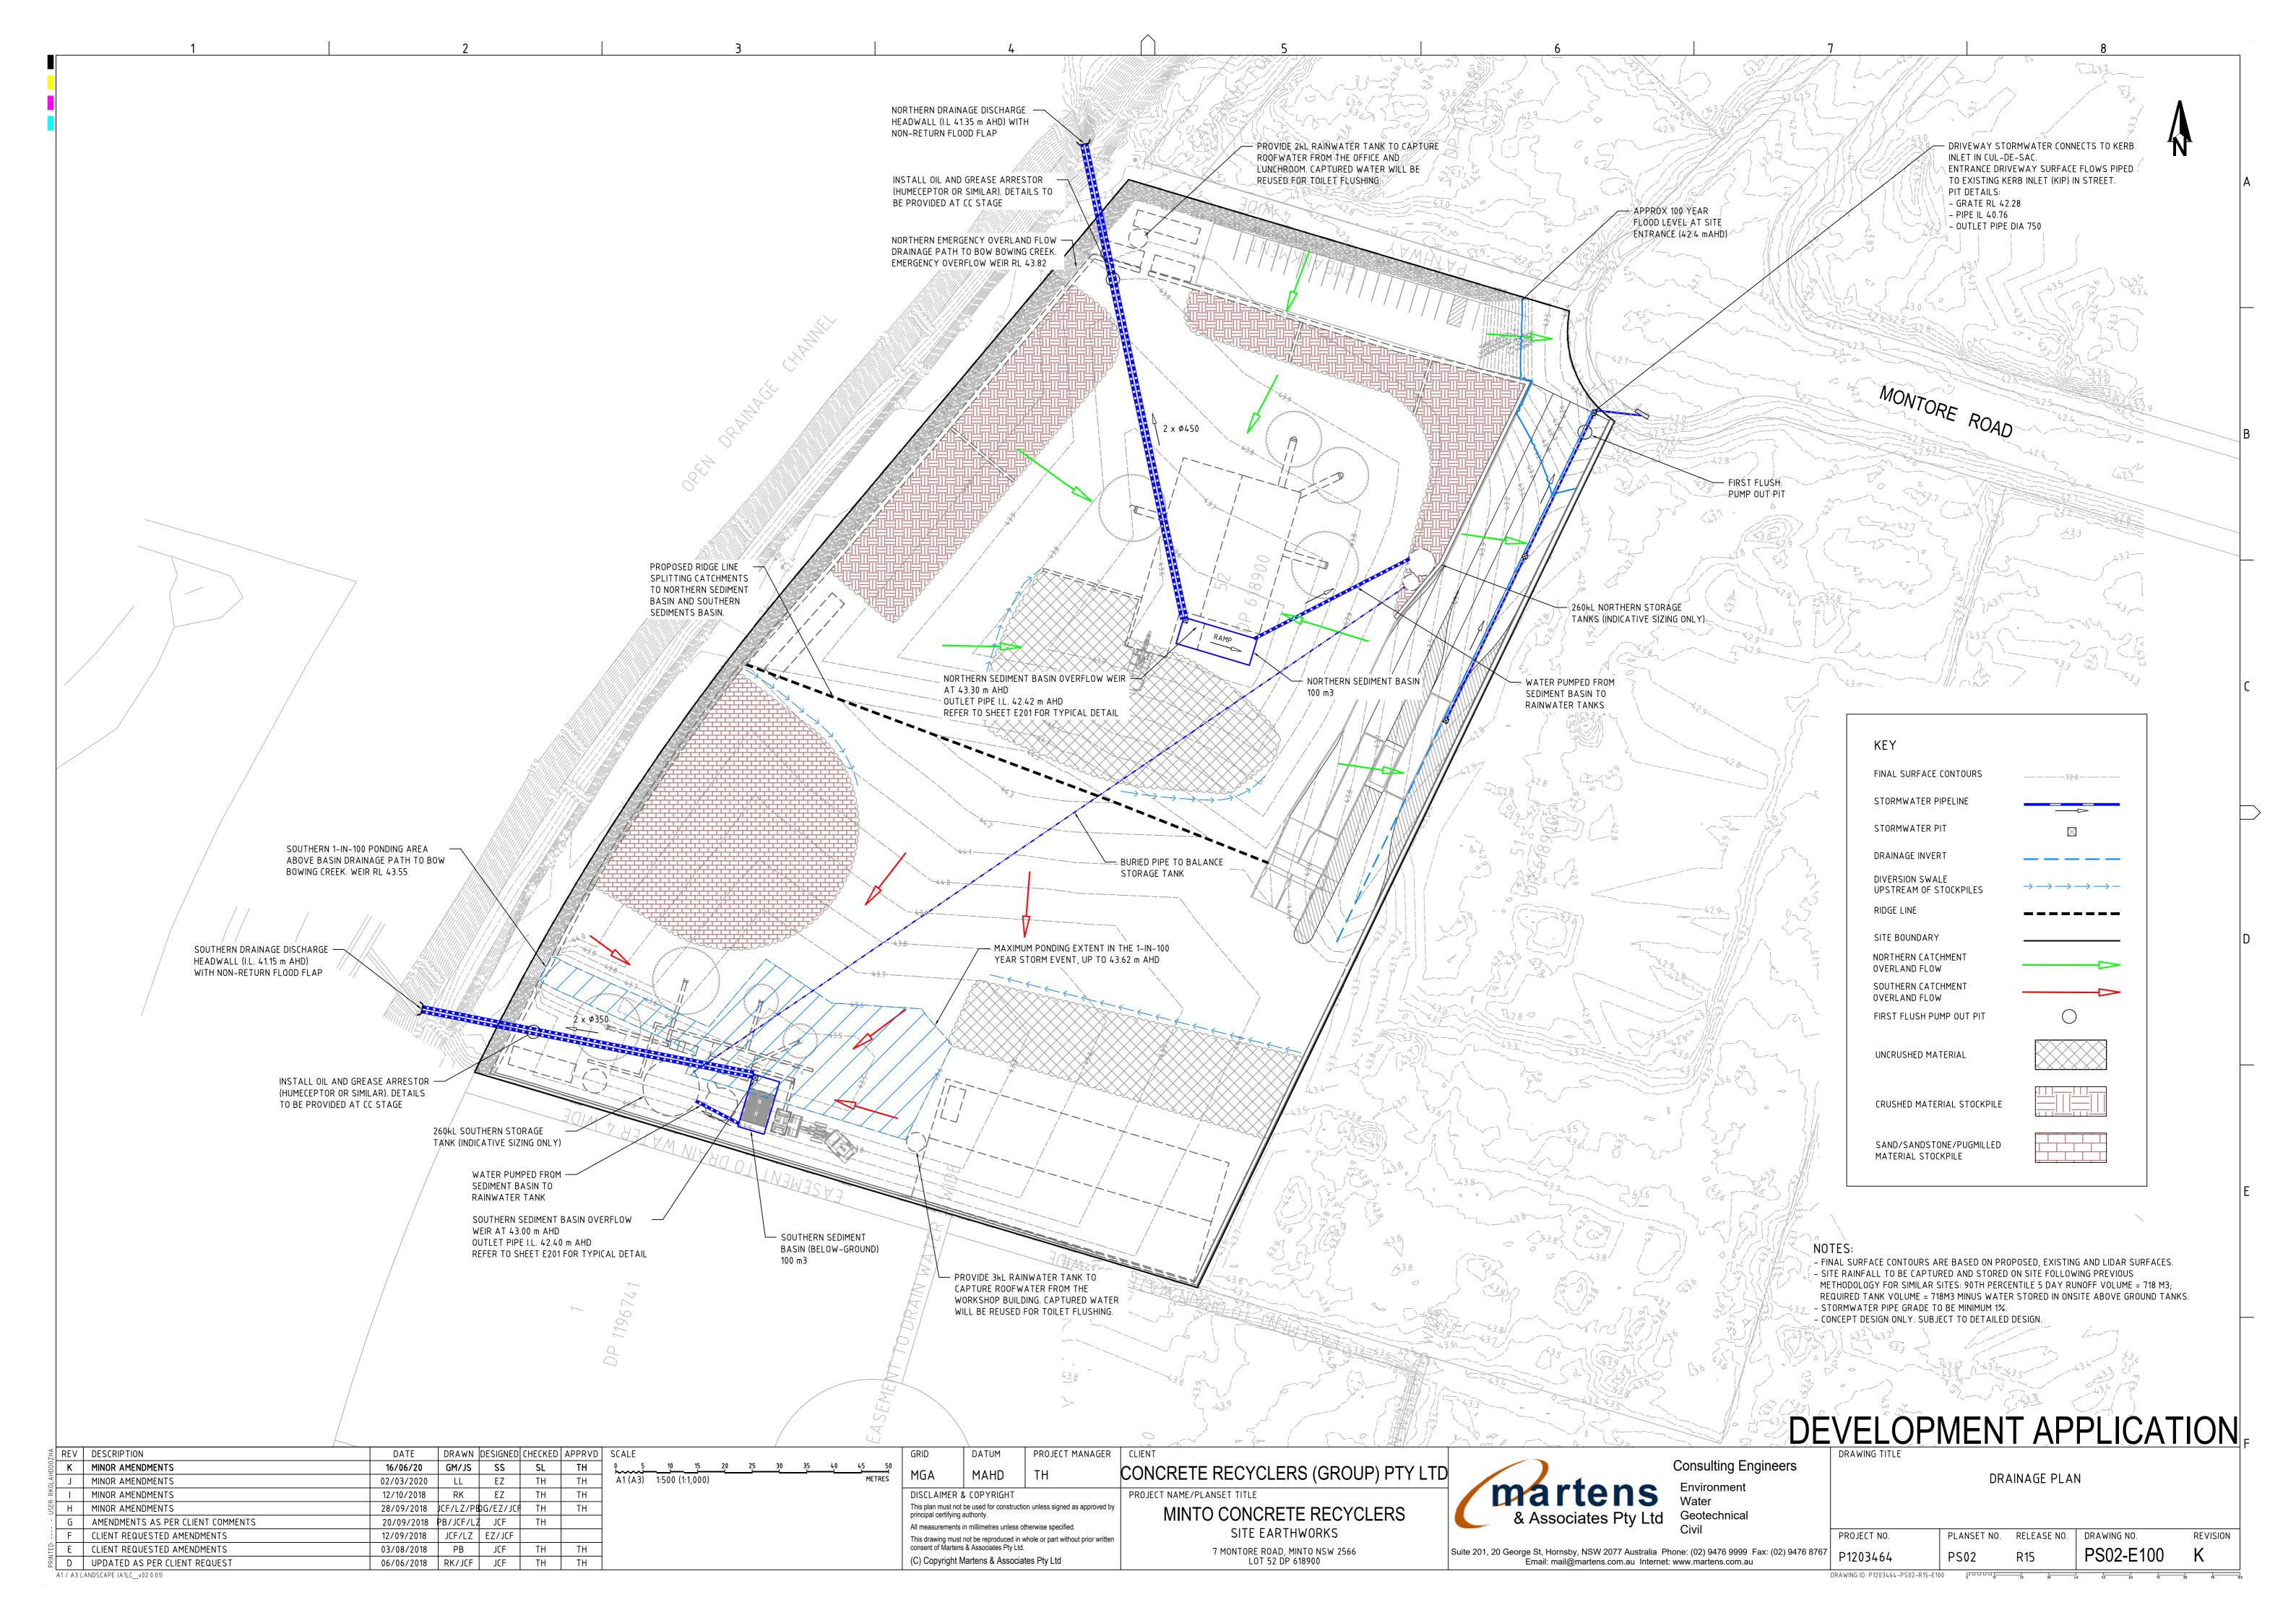

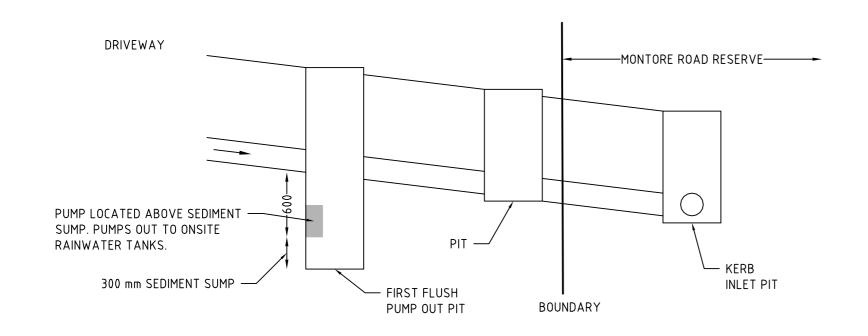

DETAIL: DRIVEWAY FIRST FLUSH PUMP

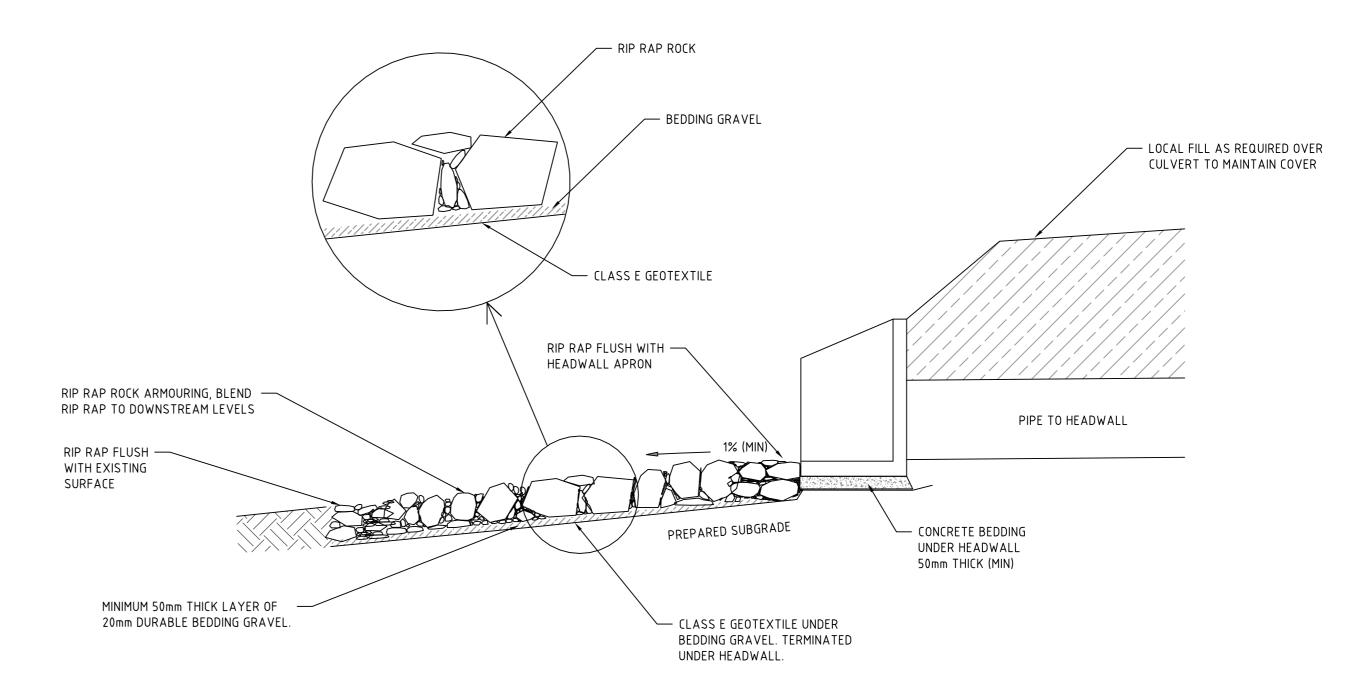


DETAIL: HEAD WALL OUTLET AND RIP RAP SECTION


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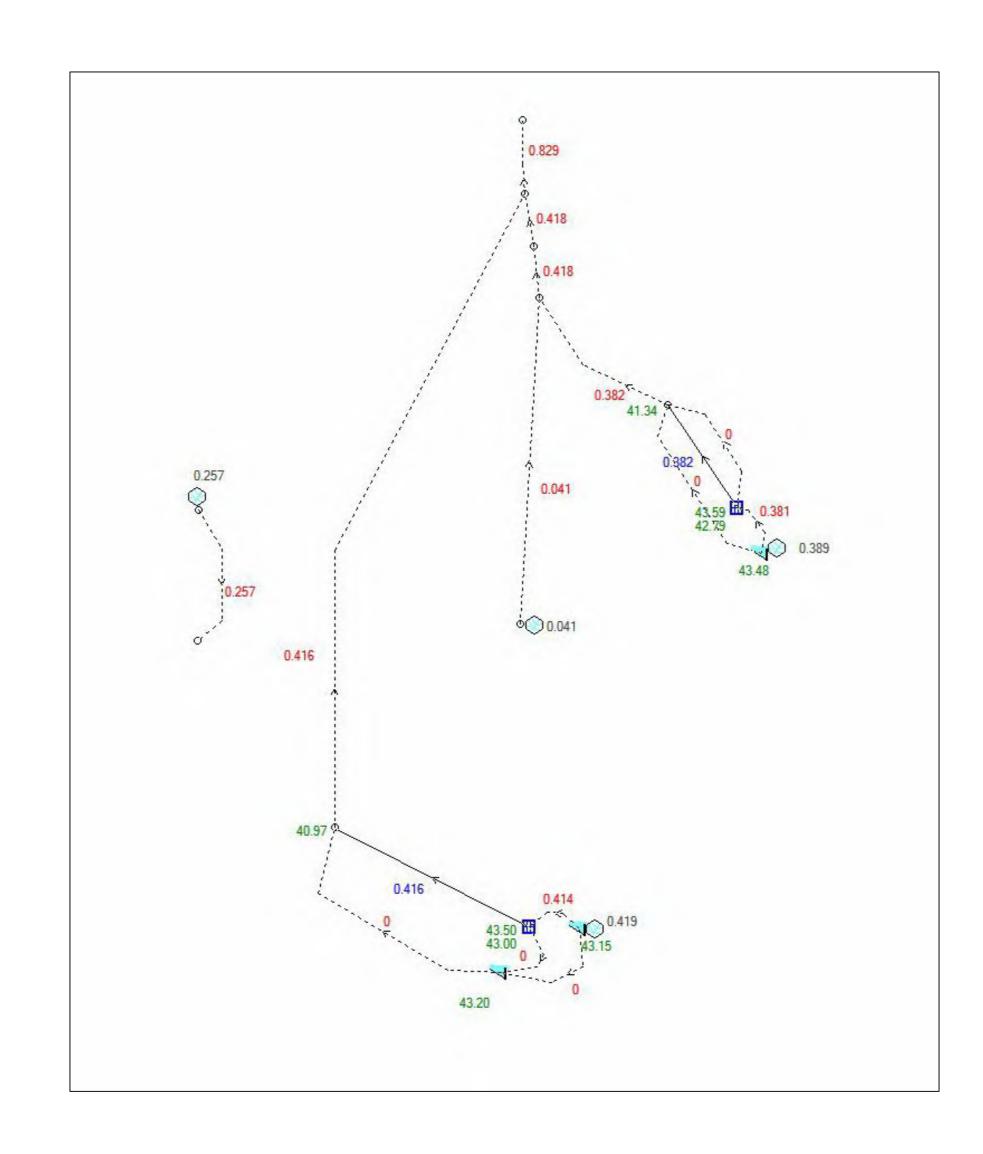
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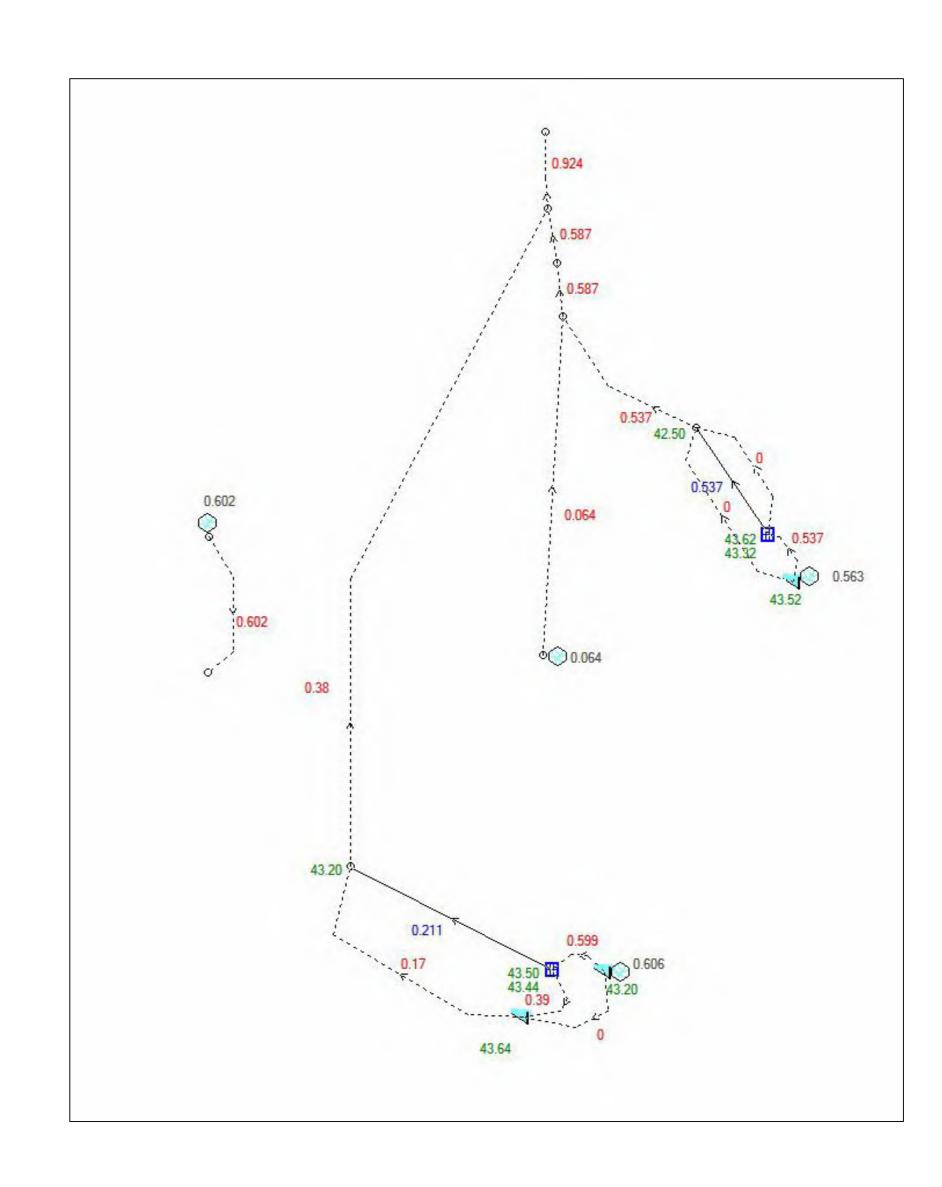
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			ents in millimetres unless otherwise specified.		& Associates Pty Ltd Geotechnical
			must not be reproduced in whole or part without prior written	SITE EARTHWORKS	Civii
			artens & Associates Pty Ltd.	7 MONTORE ROAD, MINTO NSW 2566	Suite 201, 20 George St, Hornsby, NSW 2077 Australia Phone: (02) 9476 9999 Fax: (02) 9476 8767
E C C C C C C C C C C C C C C C C C C C		(C) Copyrig	ght Martens & Associates Pty Ltd	LOT 52 DP 618900	Email: mail@martens.com.au Internet: www.martens.com.au
A1 / A3 LANDSCAPE (A1LC_v02.0.01)					

DEVELOPMENT APPLICATION DRAINAGE DETAILS PLANSET NO. RELEASE NO. DRAWING NO. PROJECT NO. REVISION PS02-E200 P1203464





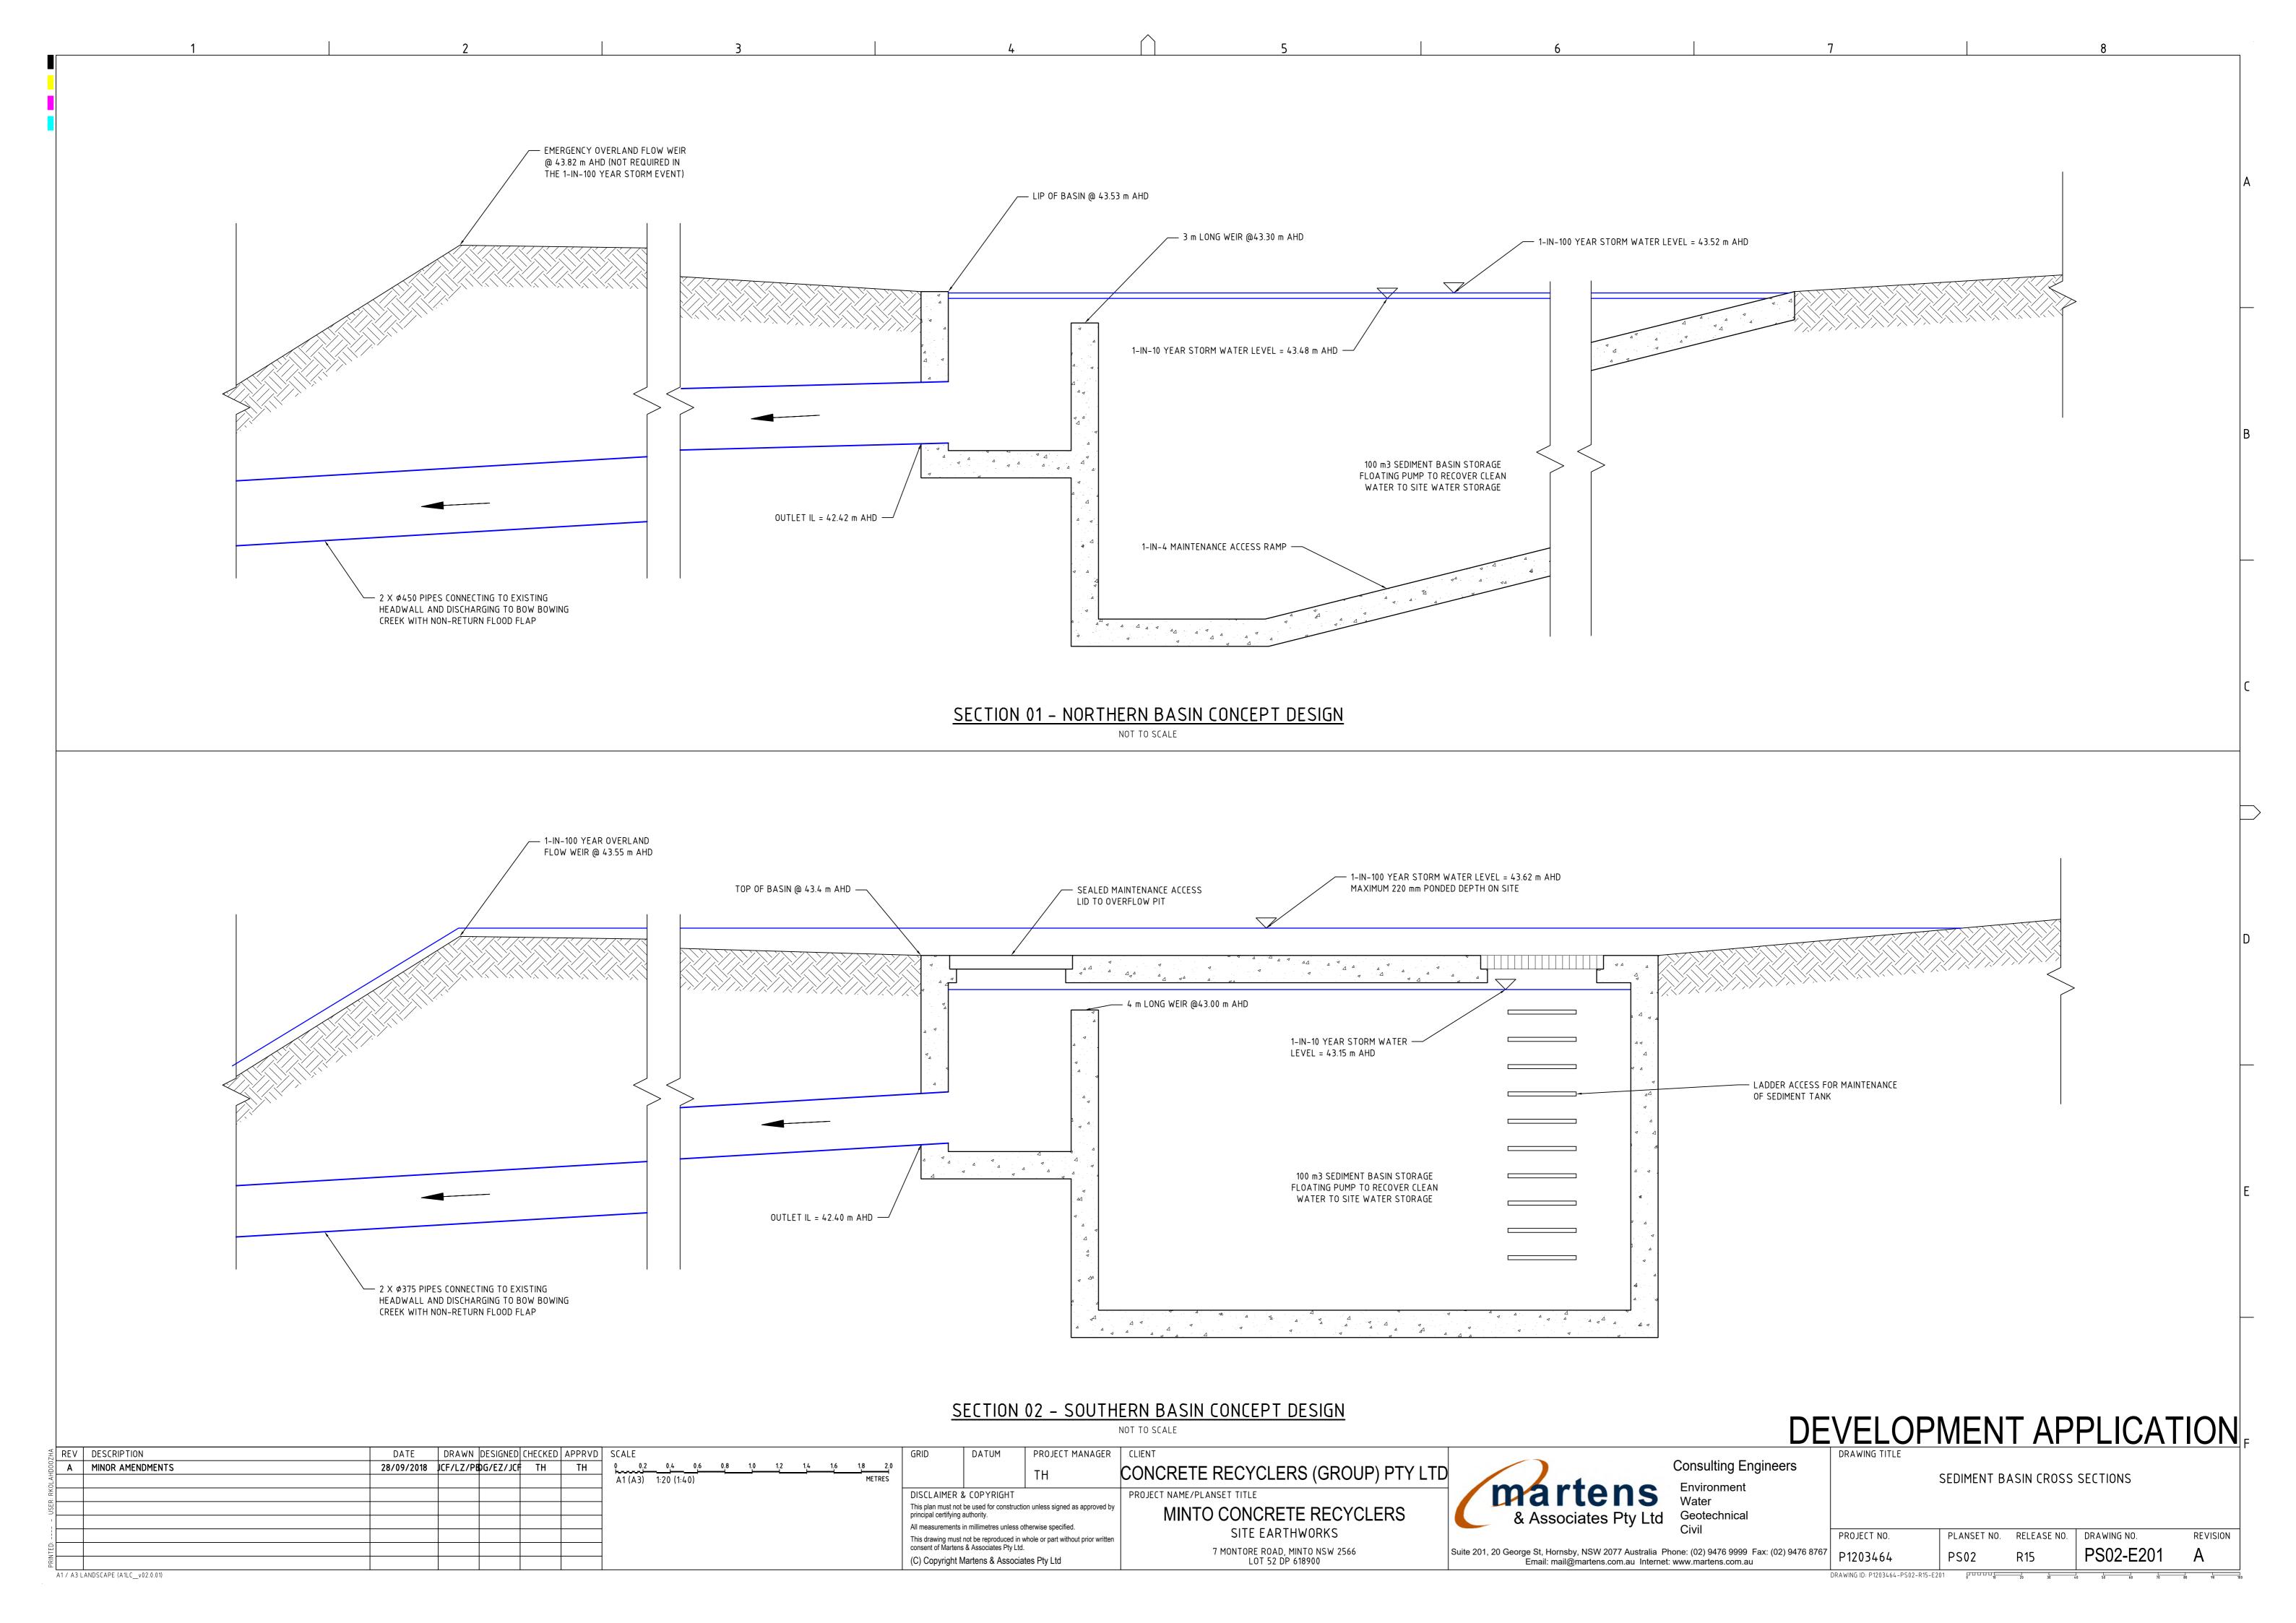

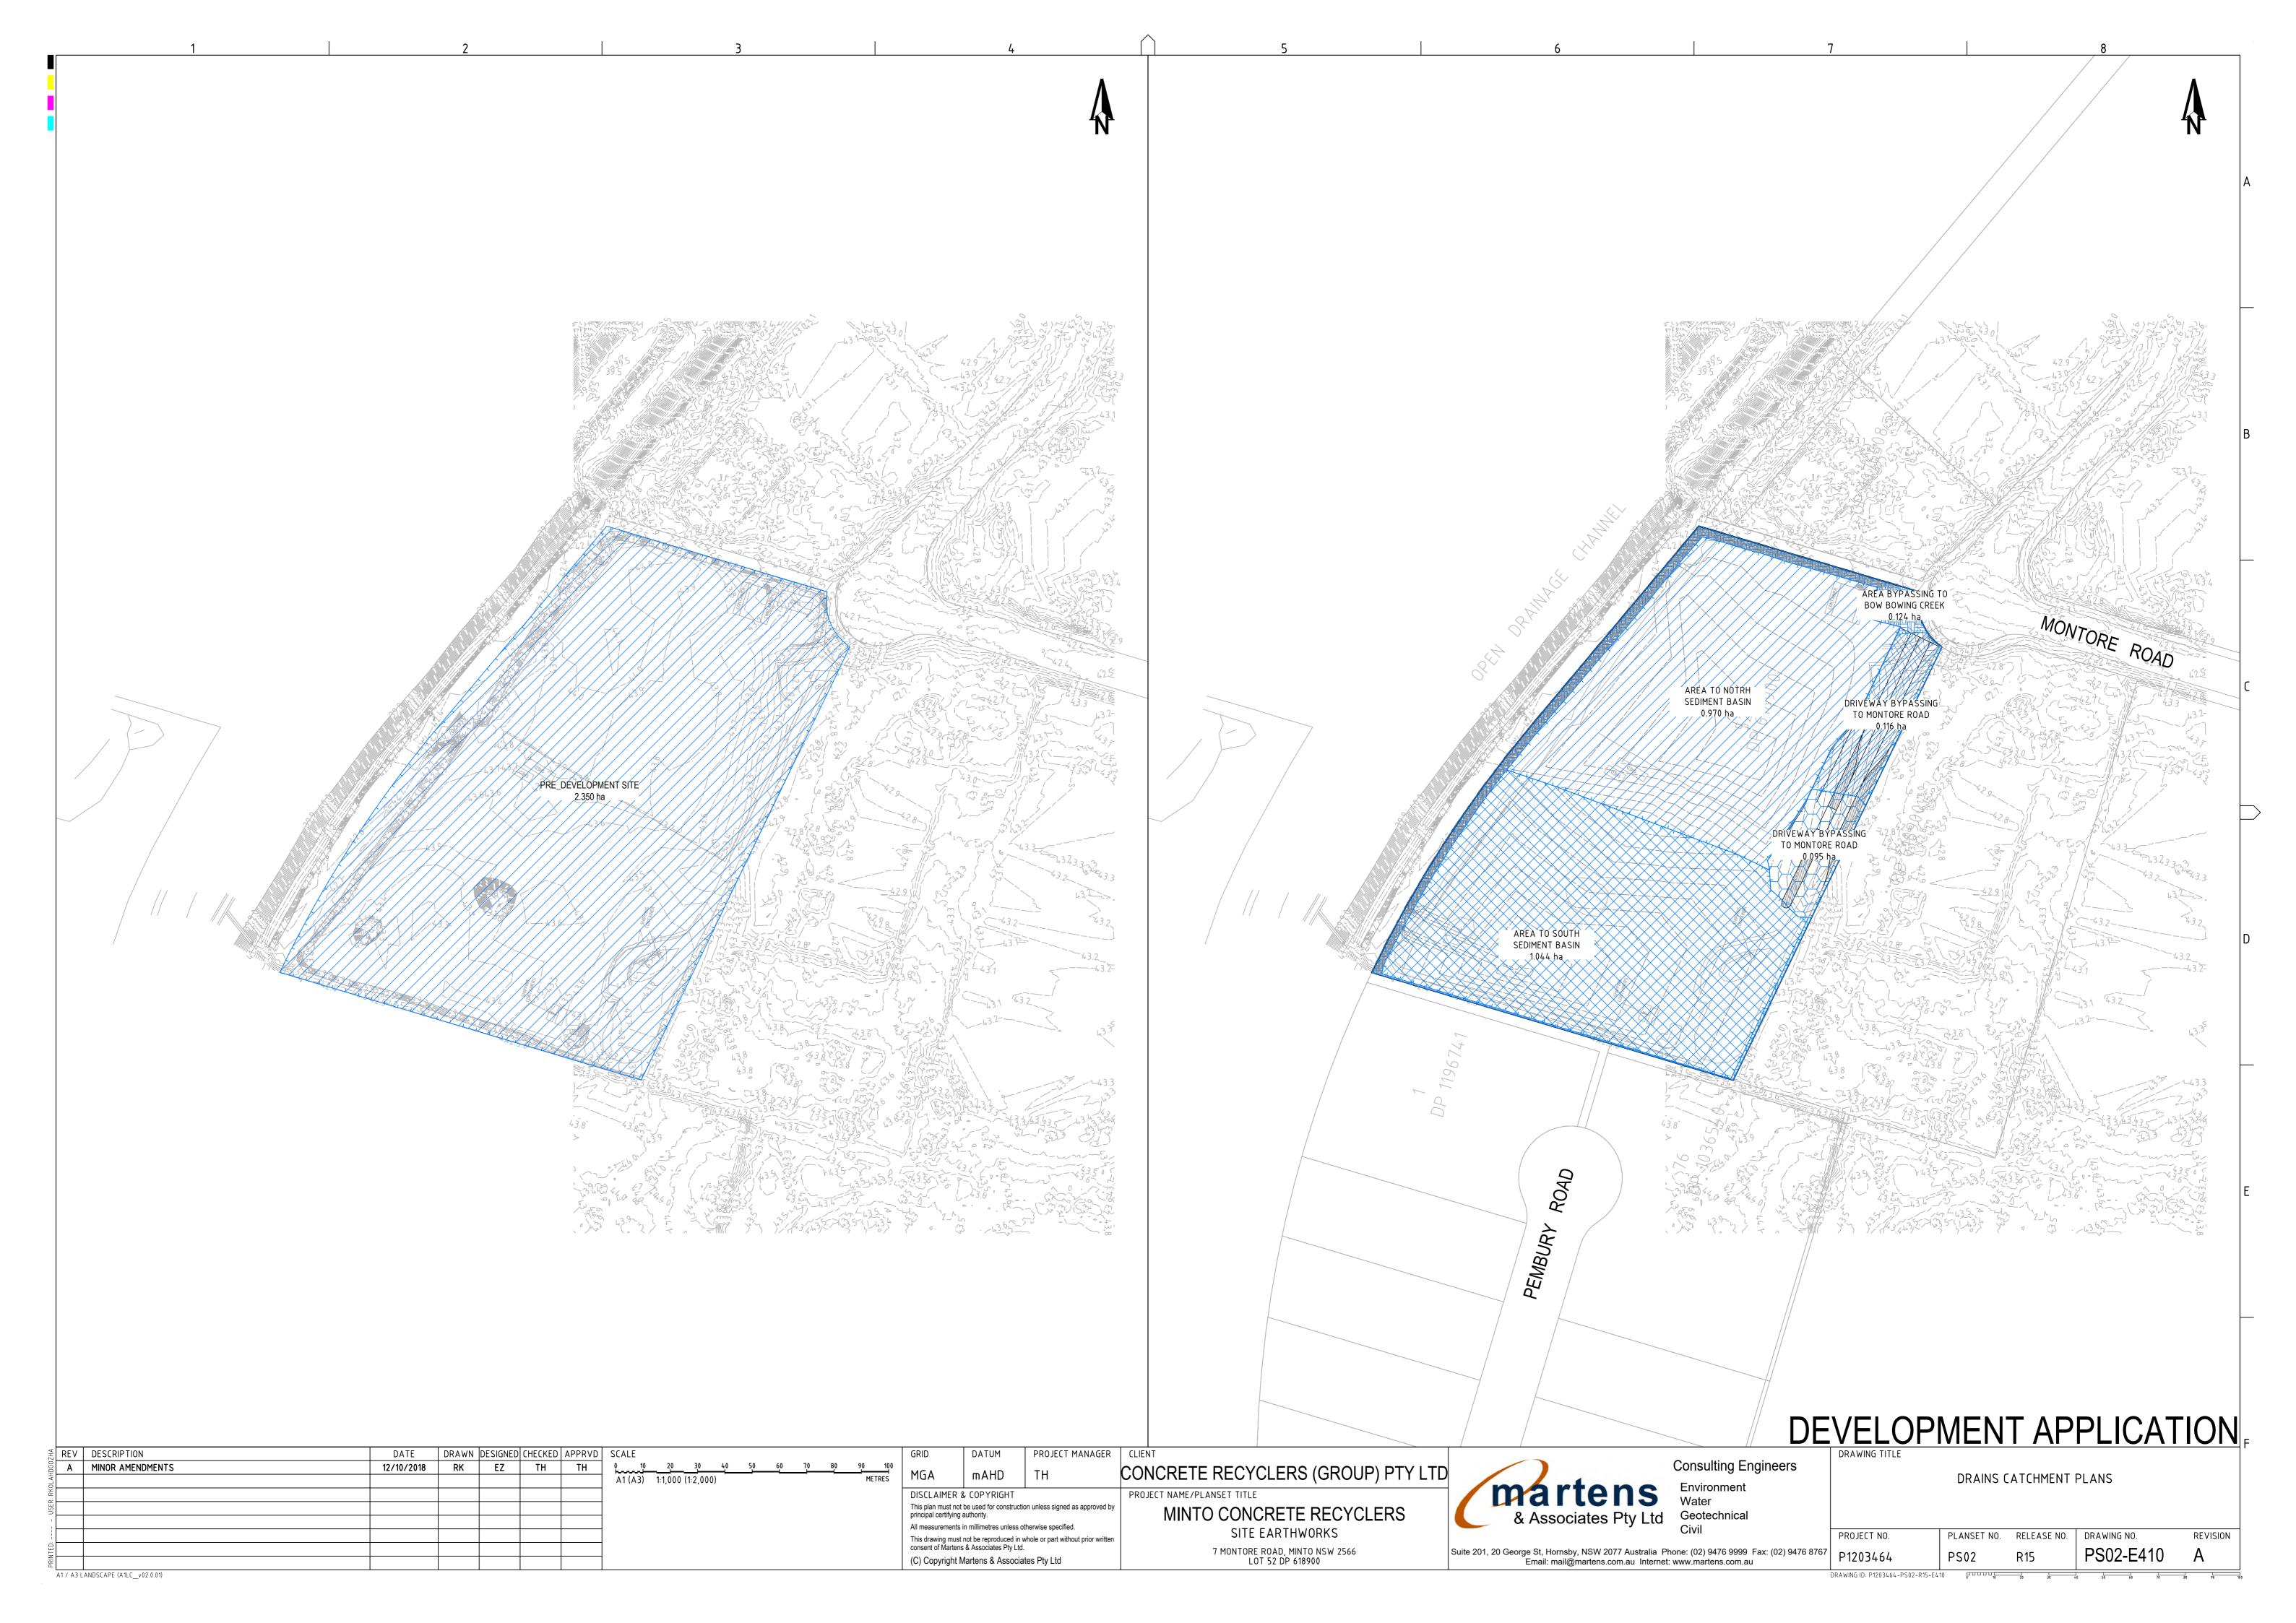

DRIVEWAY DRAINAGE 1-IN-10 YEAR ARI SEDIMENT BASINS 1-IN-100 YEAR ARI SEDIMENT BASINS 1-IN-10 YEAR ARI

DATE DRAWN DESIGNED CHECKED APPRVD SCALE REV DESCRIPTION D MINOR AMENDMENTS 15/11/2019 JCF/LZ/PB/DG/EZ/JCF TH 28/09/2018 JCF/LZ/PBG/EZ/JCF TH TH C MINOR AMENDMENTS B CLIENT REQUESTED AMENDMENTS 09/08/2018 PB EZ A UPDATE

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PROJECT MANAGER | CLIENT

CONCRETE RECYCLERS (GROUP) PTY LTD PROJECT NAME/PLANSET TITLE MINTO CONCRETE RECYCLERS

SITE EARTHWORKS 7 MONTORE ROAD, MINTO NSW 2566 LOT 52 DP 618900

Consulting Engineers Environment Geotechnical Suite 201, 20 George St, Hornsby, NSW 2077 Australia Phone: (02) 9476 9999 Fax: (02) 9476 Email: mail@martens.com.au Internet: www.martens.com.au

DE	VELOPI	MEN [*]	T AP	PLICAT	ION					
eers	DRAINS MODELLING RESULTS									
	PROJECT NO.	PLANSET NO.	RELEASE NO.	DRAWING NO.	REVISION					
(02) 9476 8767	P1203464 DRAWING ID: P1203464-PS02-R15-E6	PS02	R15	PS02-E600	D					



MUSIC CATCHMENT PLAN

SCALE: NOT TO SCALE

KEY	DESCRIPTION	MUSIC NODE ID	AREA (ha)	IMPERVIOUS %	MUSIC NODE REFERENCE
NORTHERN CATCHMEN	Ţ				
	ROOF TO 2kL RWT	1AD01a	0.008	100	NSW MUSIC MODELLING GUIDELINES 2015
	ROOF BYPASS 2kL RWT	1AD01b	0.073	100	NSW MUSIC MODELLING GUIDELINES 2015
	SEALED ROAD TO SEDIMENT BASIN	1AD01c	0.887	100	NSW MUSIC MODELLING GUIDELINES 2015
SOUTHERN CATCHMEN					
	ROOF TO 3kL RWT	1AD02a	0.122	100	NSW MUSIC MODELLING GUIDELINES 2015
	ROOF BYPASS 3kL RWT	1AD02b	0.008	100	NSW MUSIC MODELLING GUIDELINES 2015
\leftarrow	SEALED ROAD TO SEDIMENT BASIN	1AD02c	0.913	100	NSW MUSIC MODELLING GUIDELINES 2015
ATCHMENT BYPASS V	TIMENT BASINS				
$\triangle \triangle \triangle \triangle \triangle \triangle \triangle \triangle \triangle$	ROOF	1AD03a	0.002	100	NSW MUSIC MODELLING GUIDELINES 2015
	SEALED ROAD	1AD03b	0.215	100	NSW MUSIC MODELLING GUIDELINES 2015
• • • • •	BUFFER	1AD03c	0.118	0	NSW MUSIC MODELLING GUIDELINES 2015
TOTAL SITE				<u> </u>	
		TOTAL - OVERALL		2.346	= 100 % OF OVERALL AREA
		TOTAL - IMPERVIOUS		2.228	= 95 % OF OVERALL AREA
NOTES:		TOTAL - PERVIOUS		0.118	= 5 % OF OVERALL AREA

DRAWN DESIGNED CHECKED APPRVD SCALE

TH

TH


TH

2. INTERNAL REUSE FOR DUST SUPPRESSION AND SAND WASHING SYSTEM IS 81.65 kL/DAY FOR EACH SEDIMENTATION BASIN.								
MUSIC MODELLIN	IG RESULTS (P	1203464MUS01	IV01)					
MUSIC NODE	POST DEVELOPMEN	NT NODE						
PARAMETER	SOURCES	RESIDUAL LOAD	% REDUCTION	% TARGET				
Flow (ML/yr)	16.6	8.73	47.3	NONE				
Total Suspended Solids (kg/yr)	5.25E+03	9.69E+02	81.5	80				
Total Phosphorus (kg/yr)	8.91	2.31	74	45				
Total Nitrogen (kg/yr)	39.4	17.5	55.5	45				
Gross Pollutants (kg/yr)	427	40.9	90.4	90				

15/11/2019

16/06/20 | GM/JS | SS |

LL EZ

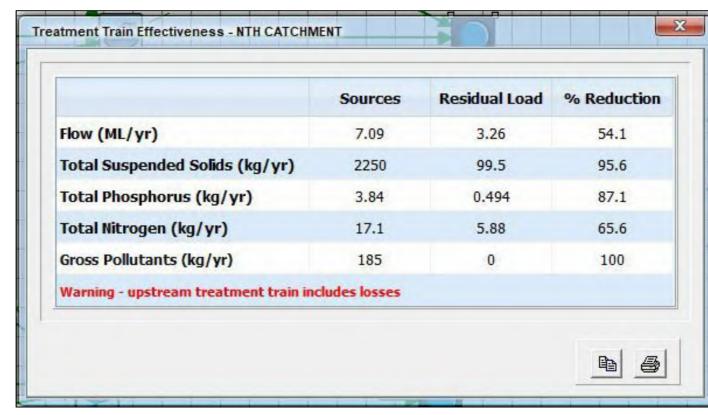

NORTHERN CATCHMENT RESULTS

	Sources	Residual Load	% Reduction
Flow (ML/yr)	7.68	3.67	52.2
Total Suspended Solids (kg/yr)	2330	258	88.9
Total Phosphorus (kg/yr)	4.09	0.807	80.3
Total Nitrogen (kg/yr)	18.2	7.51	58.7
Gross Pollutants (kg/yr)	201	0	100
Warning - upstream treatment train in	cludes losses		


SOUTHERN CATCHMENT RESULTS

PROJECT MANAGER | CLIENT DATUM CONCRETE RECYCLERS (GROUP) PTY LTD PROJECT NAME/PLANSET TITLE DISCLAIMER & COPYRIGHT This plan must not be used for construction unless signed as approved by MINTO CONCRETE RECYCLERS principal certifying authority.

All measurements in millimetres unless otherwise specified. SITE EARTHWORKS MONTORE ROAD, MINTO NSW 2566 LOT 52 DP 618900

Environment Geotechnical Suite 201, 20 George St, Hornsby, NSW 2077 Australia Phone: (02) 9476 9999 Fax: (02) 9476 8767 Email: mail@martens.com.au Internet: www.martens.com.au

WATER QUALITY CATCHMENT PLAN PROJECT NO. PLANSET NO. RELEASE NO. DRAWING NO. REVISION PS02-E700 P1203464

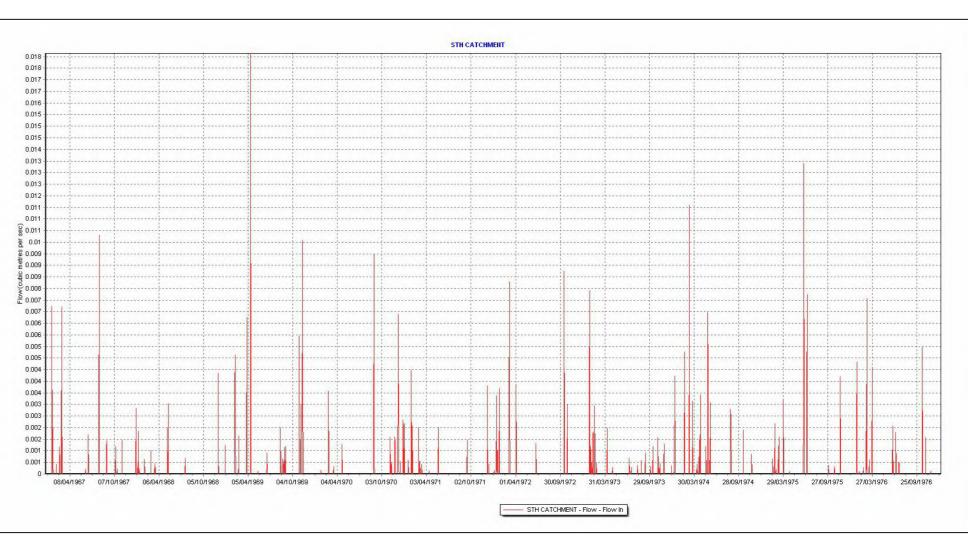

NORTHERN CATCHMENT OUTFLOW GRAPH

NTH CATCHMENT - Flow - Flow In

MUSIC LAYOUT

SOUTHERN CATCHMENT OUTFLOW GRAPH

1. WATER DISCHARGE FREQUENCY FROM NORTHERN CATCHMENT IS 6%. THE NUMBER OF DISCHARGE DAYS IS 206 OUT OF 3654 DAYS USED IN THE MODEL. 2. WATER DISCHARGE FREQUENCY FROM SOUTHERN CATCHMENT IS 6%. THE NUMBER OF DISCHARGE DAYS IS 216 OUT OF 3654 DAYS USED IN THE MODEL.

DEVELOPMENT APPLICATION

Consulting Engineers

			I his drawing must not be reproduced in whole or part without prior consent of Martens & Associates Pty Ltd.	written 7 MON
			(C) Copyright Martens & Associates Pty Ltd	
v02.0.01)				


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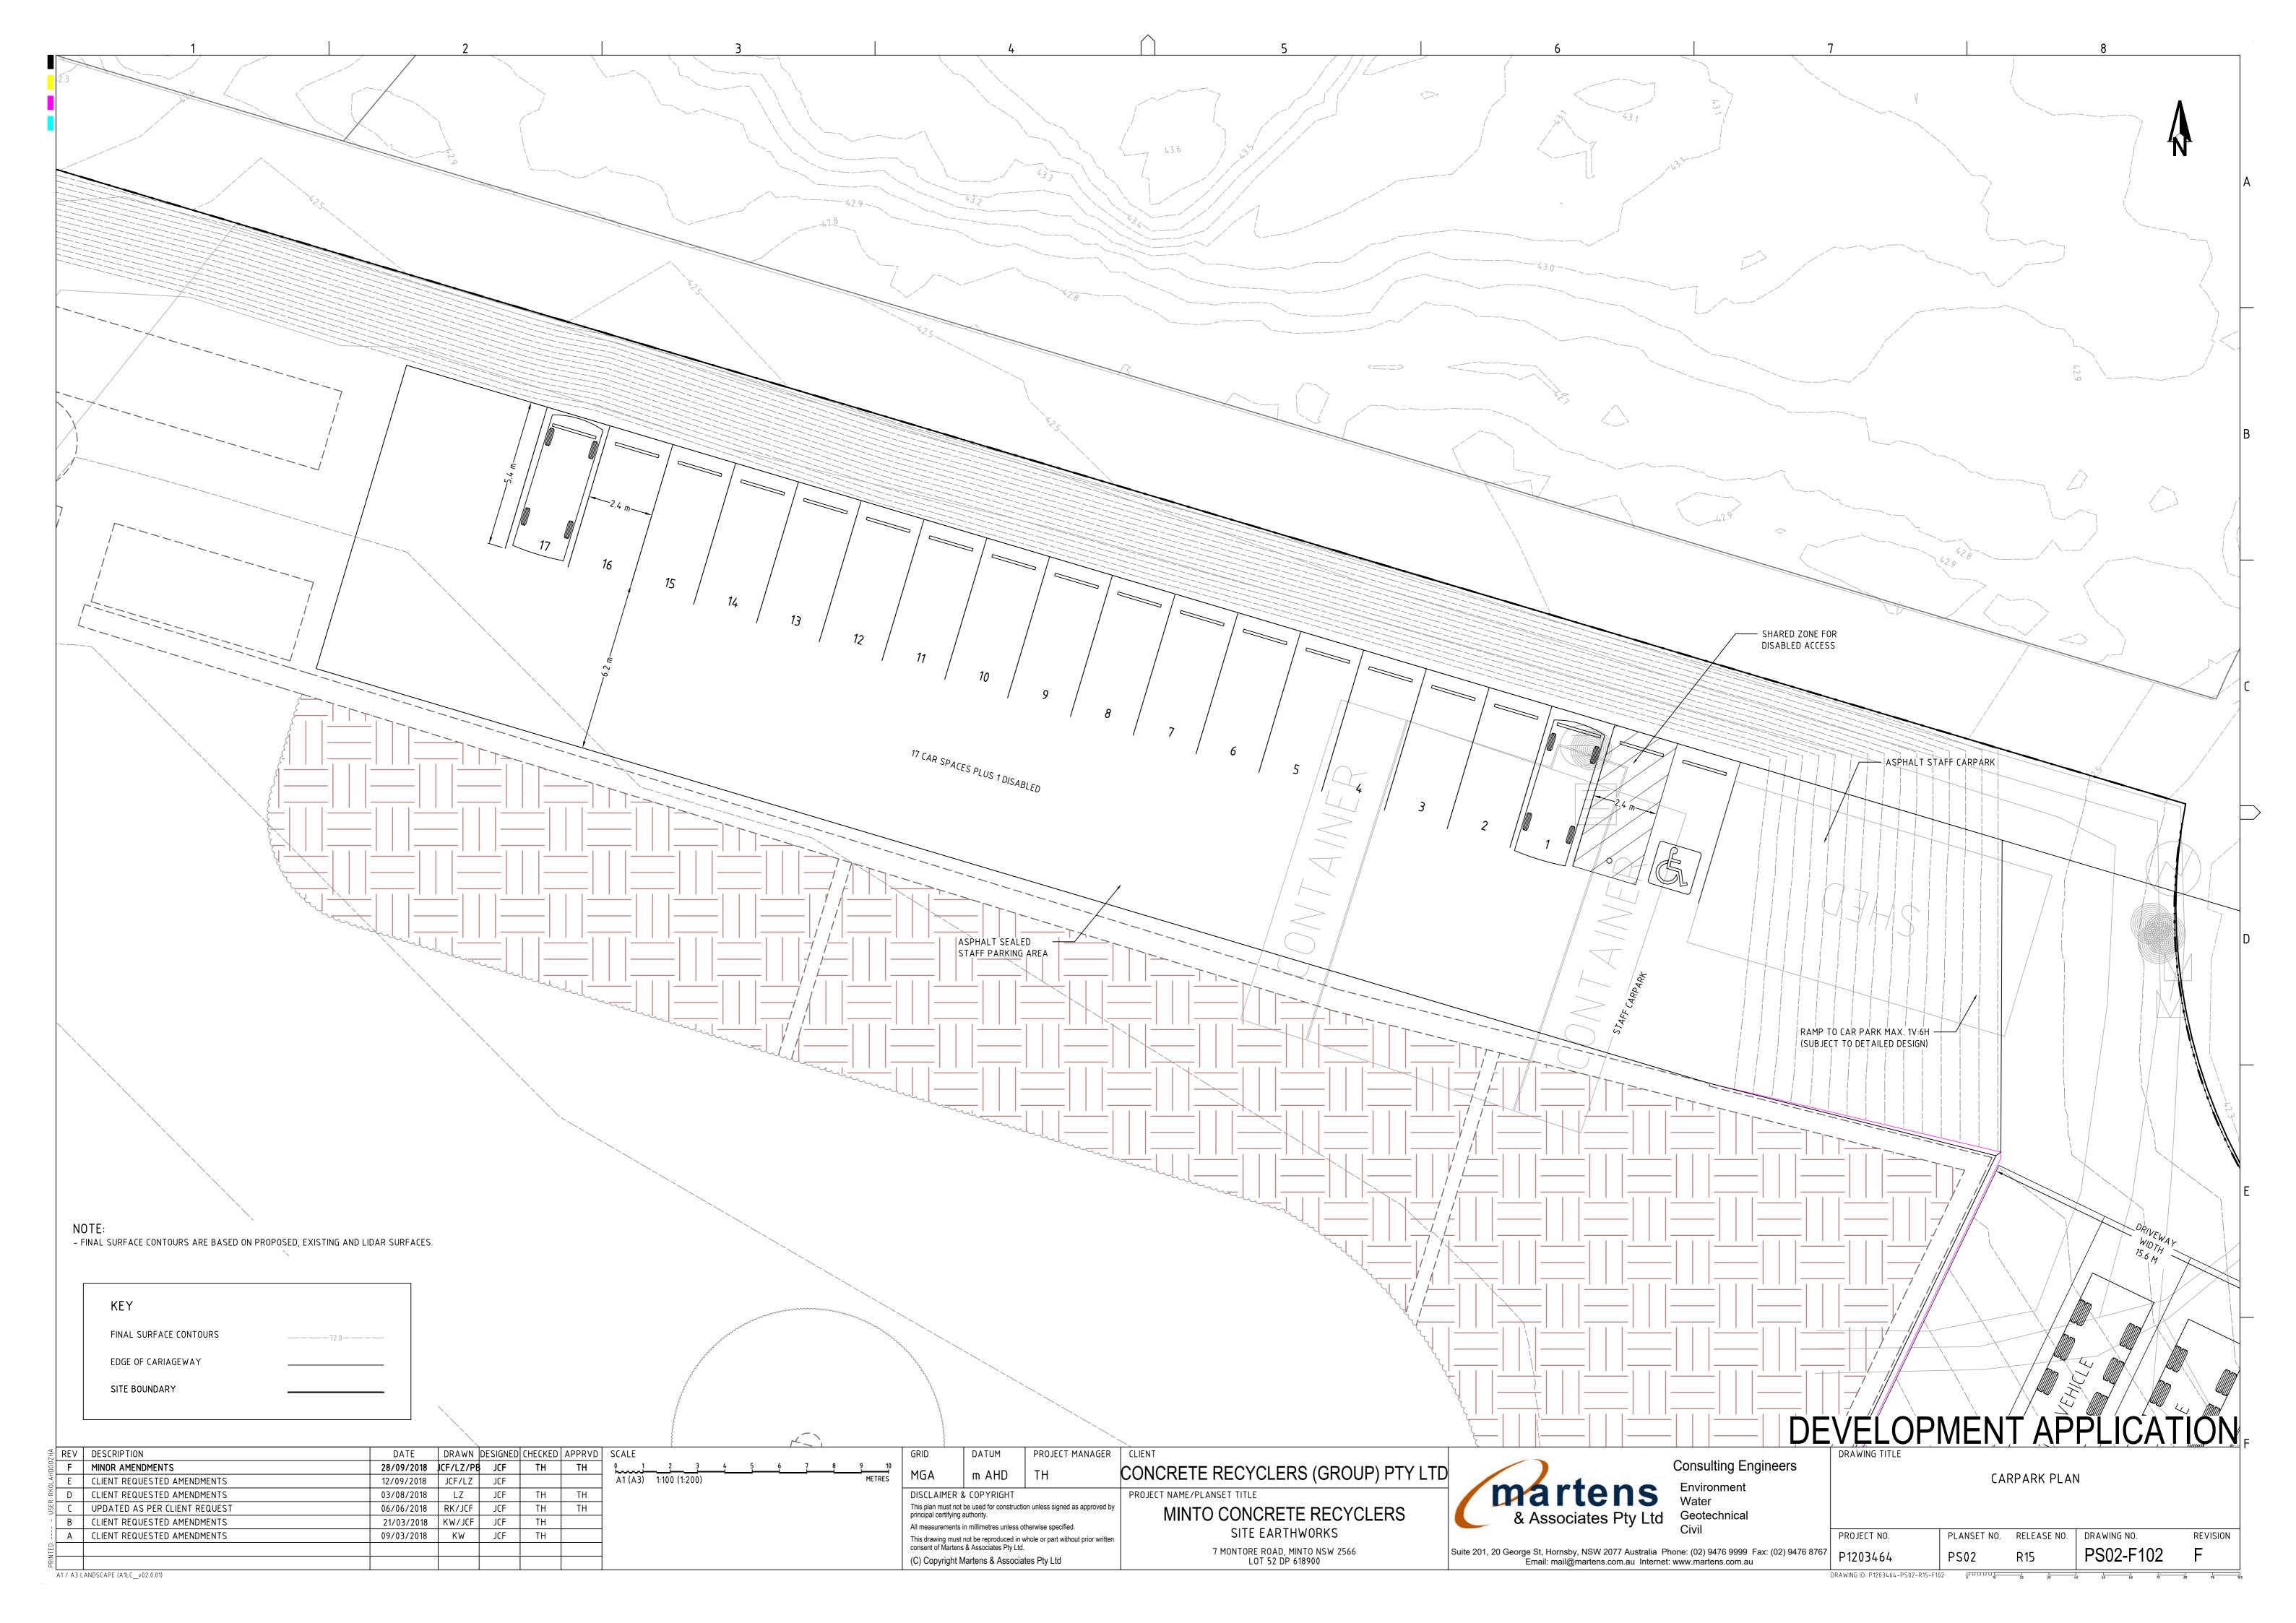
A1 / A3 LANDSCAPE (A1LC_v02


REV DESCRIPTION


B MINOR AMENDMENTS


A INITIAL RELEASE




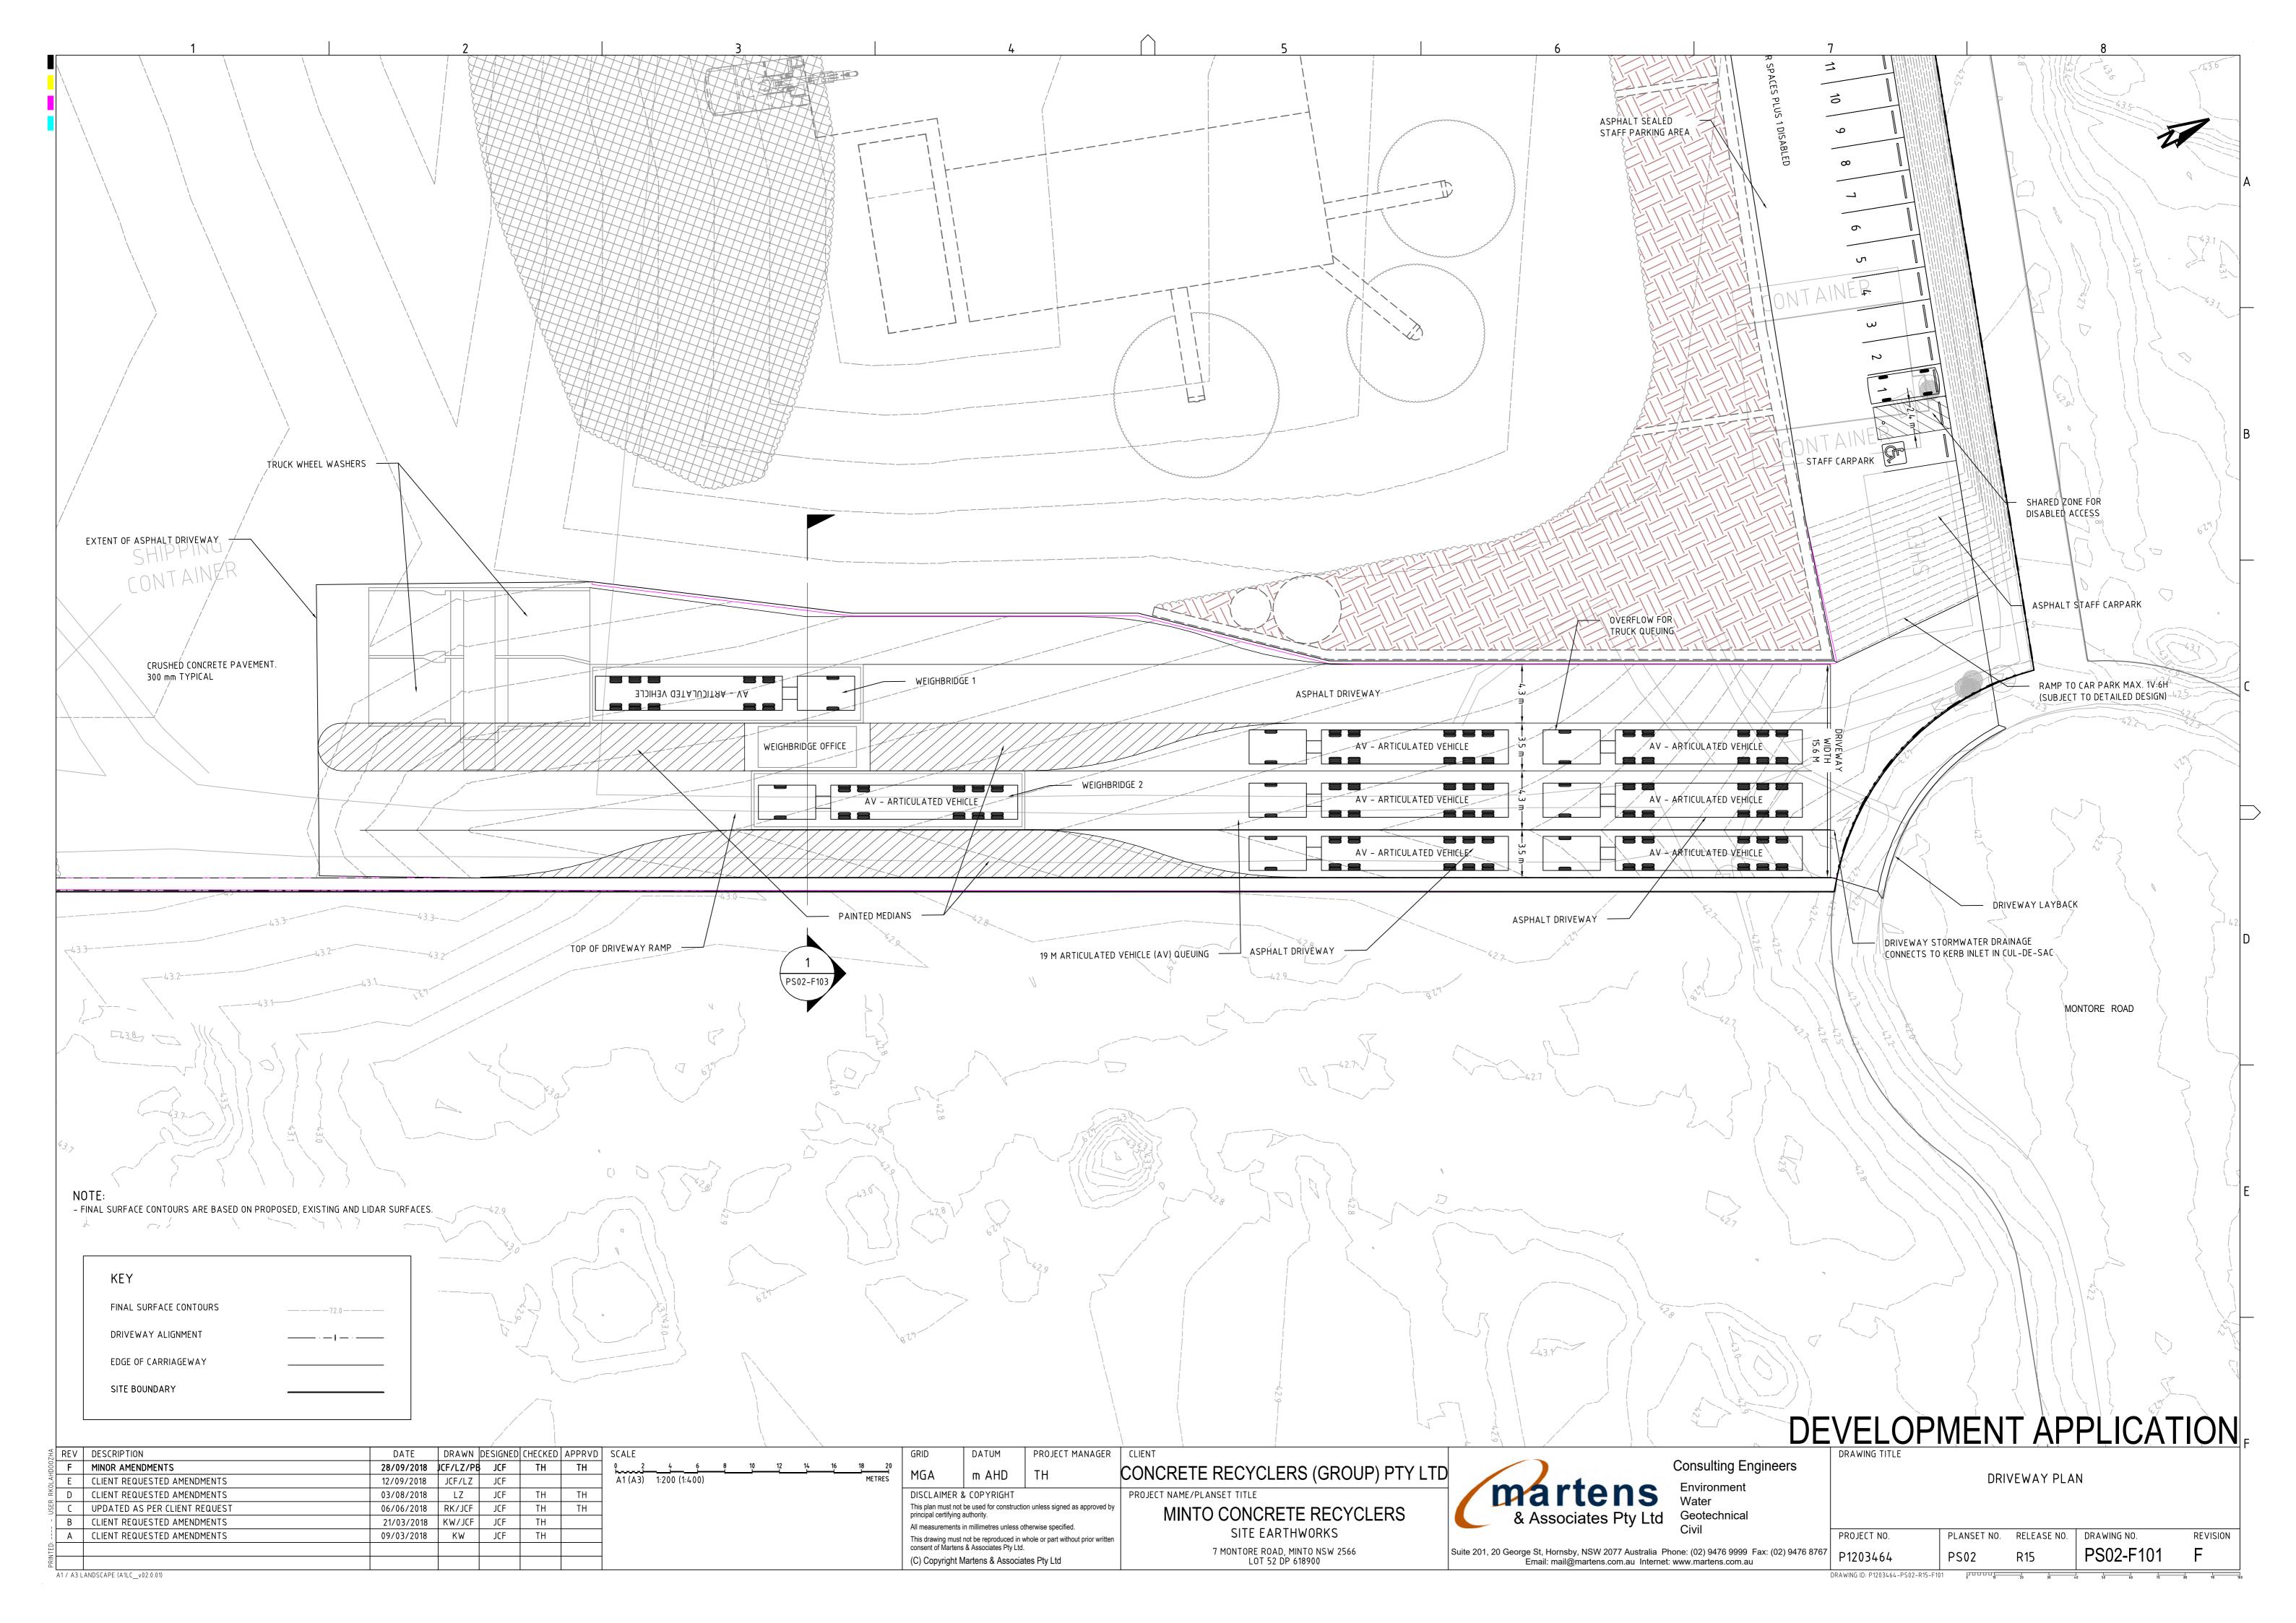

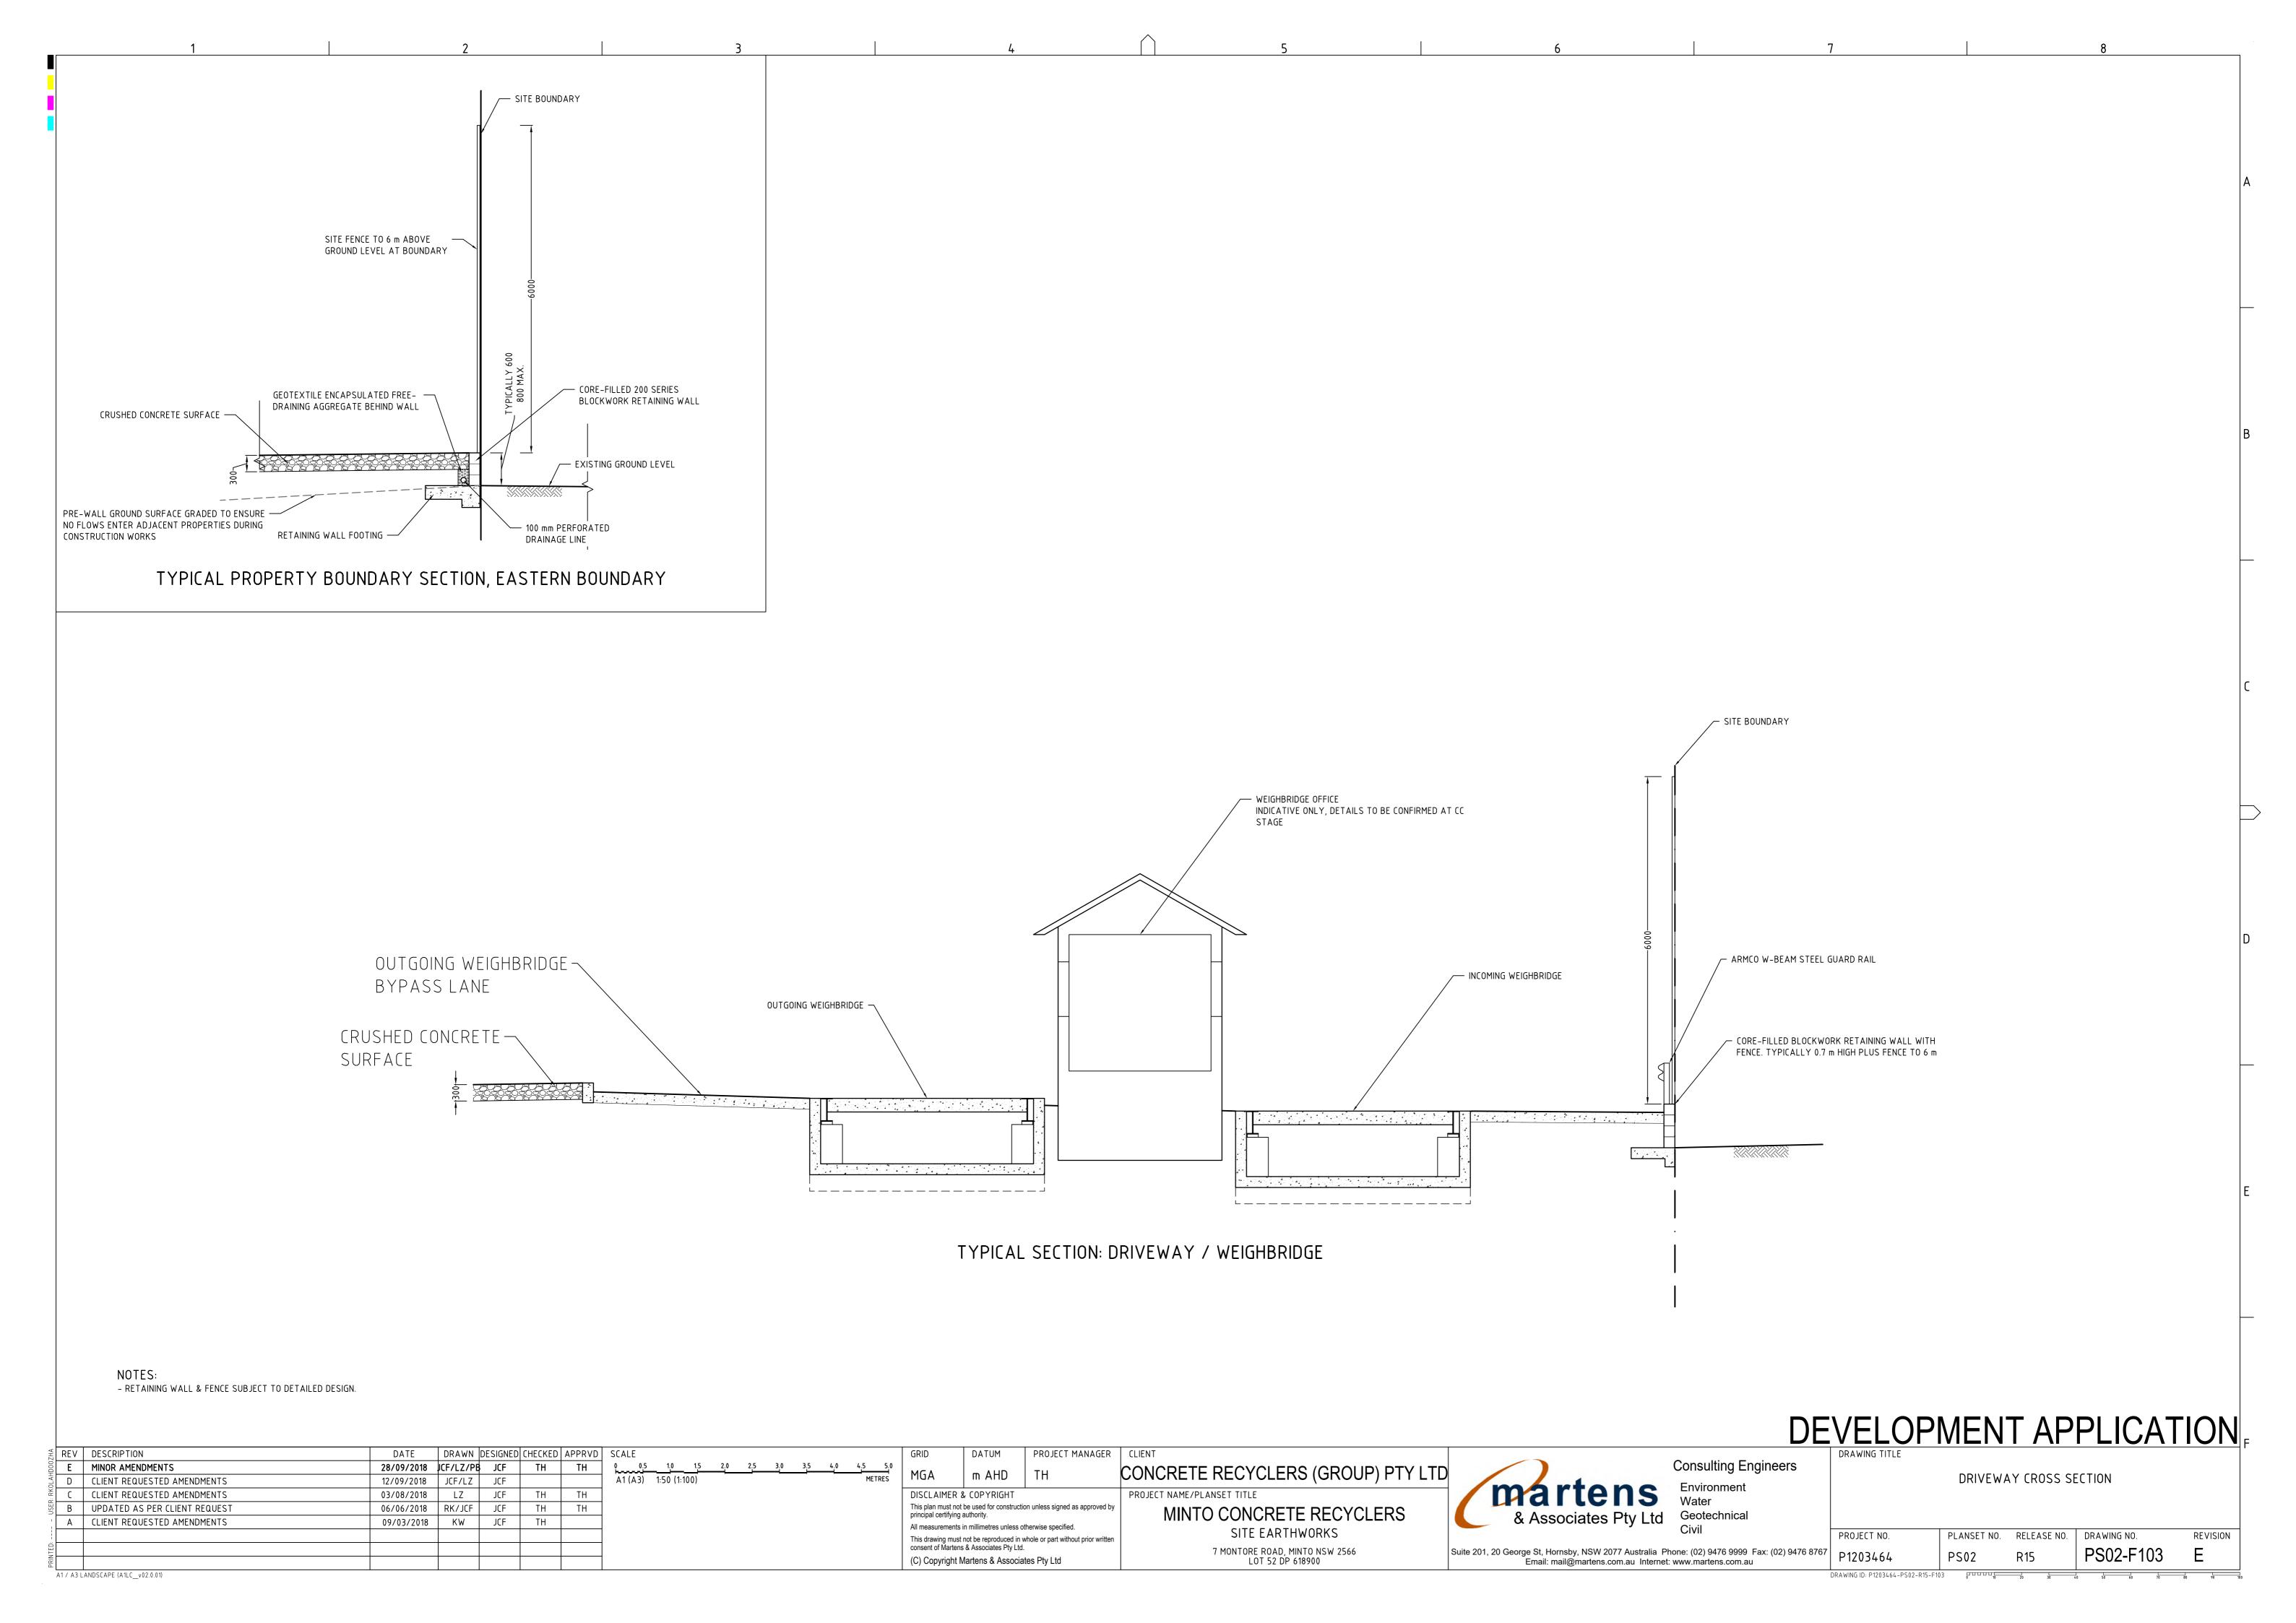


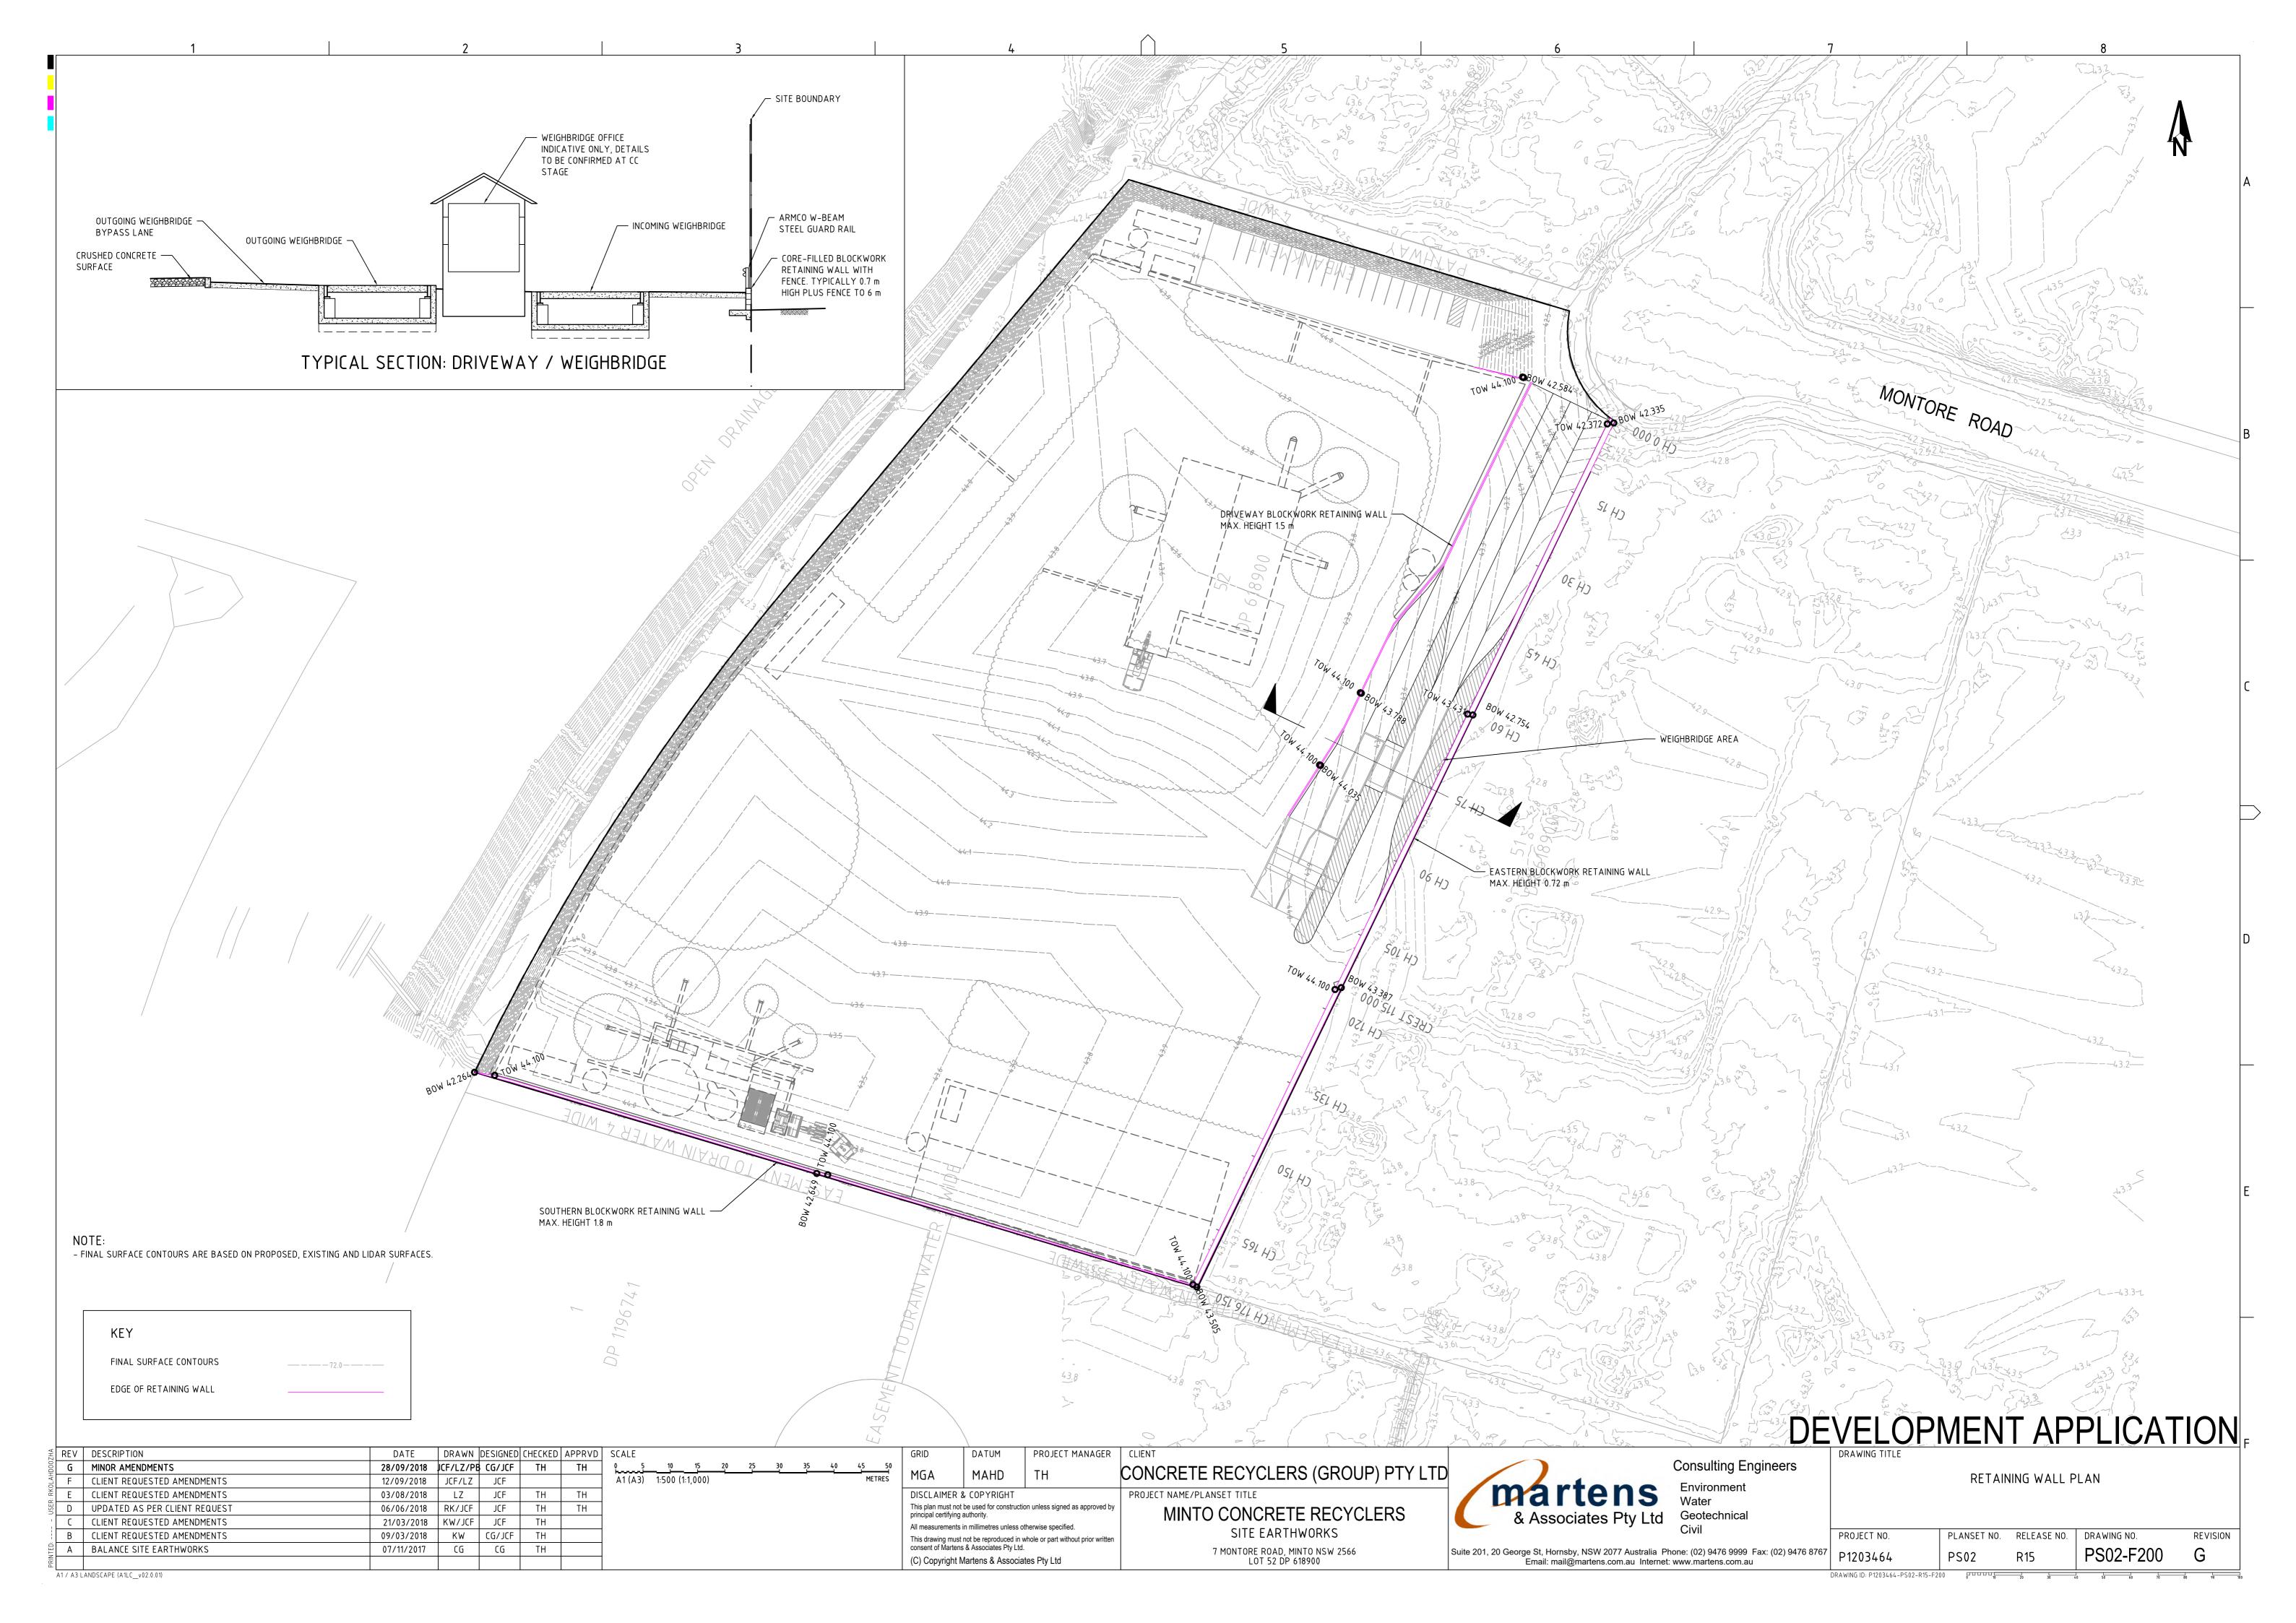


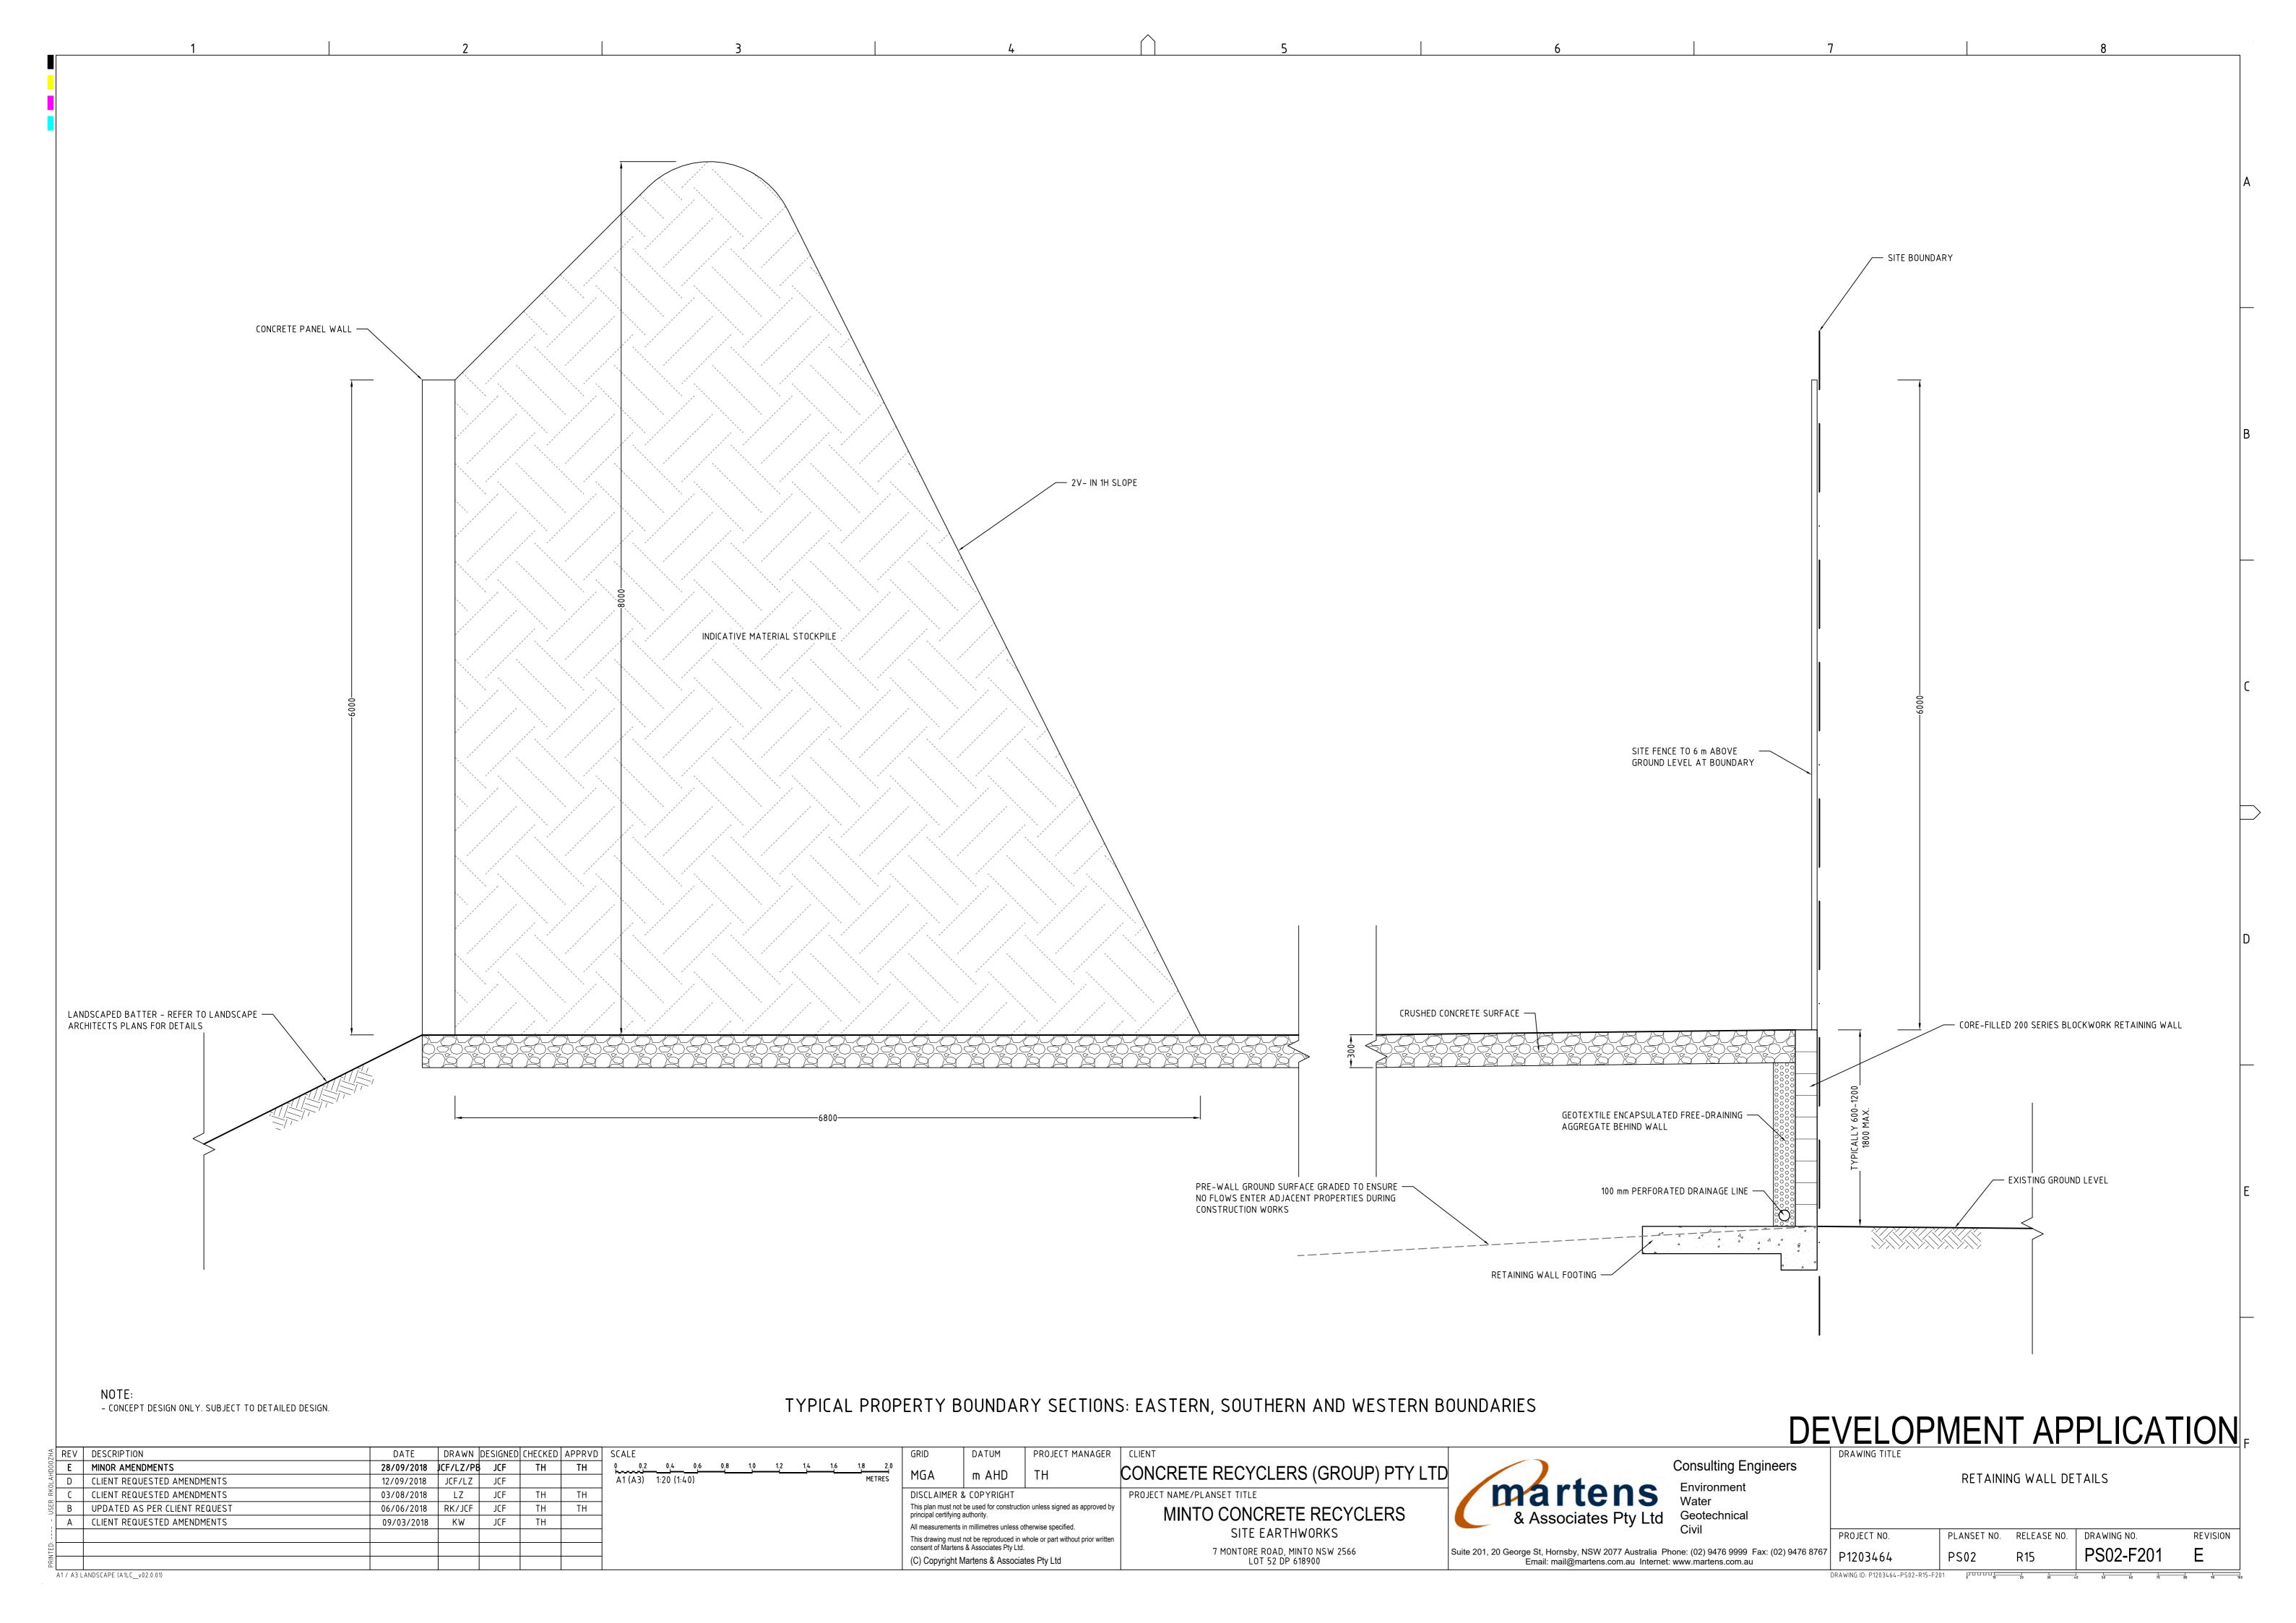


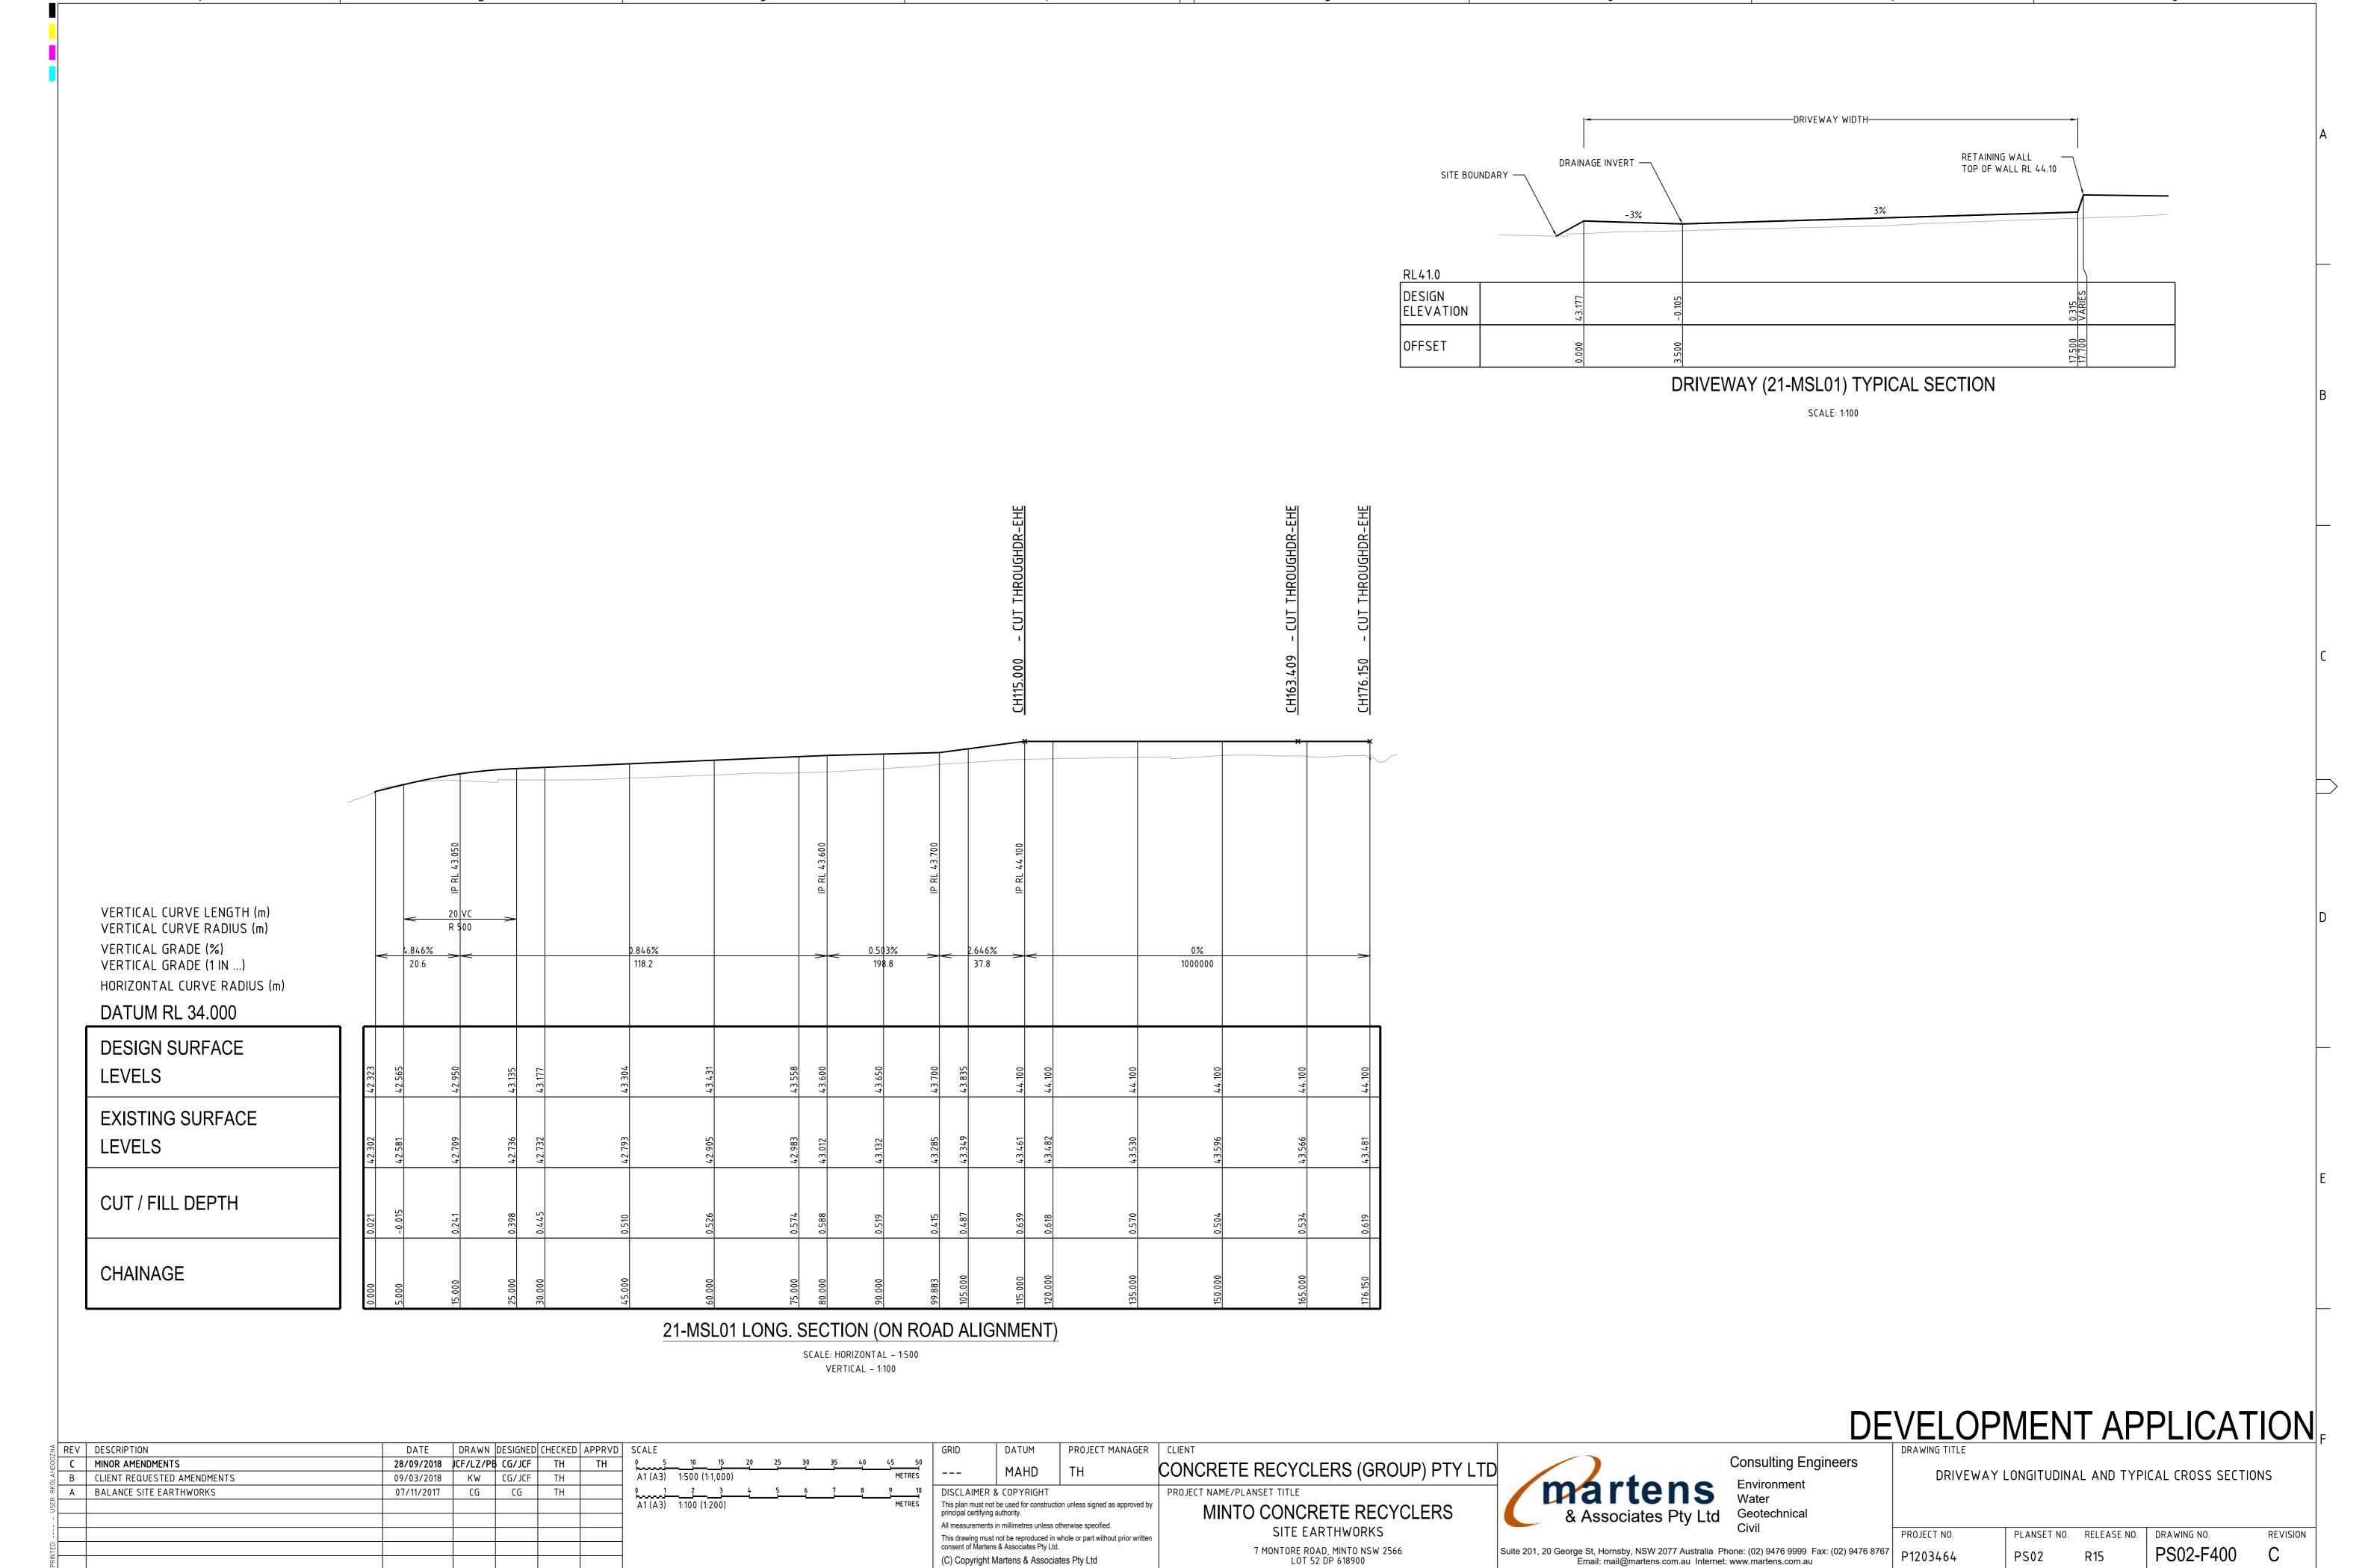



A1 / A3 LANDSCAPE (A1LC_v02.0.01)

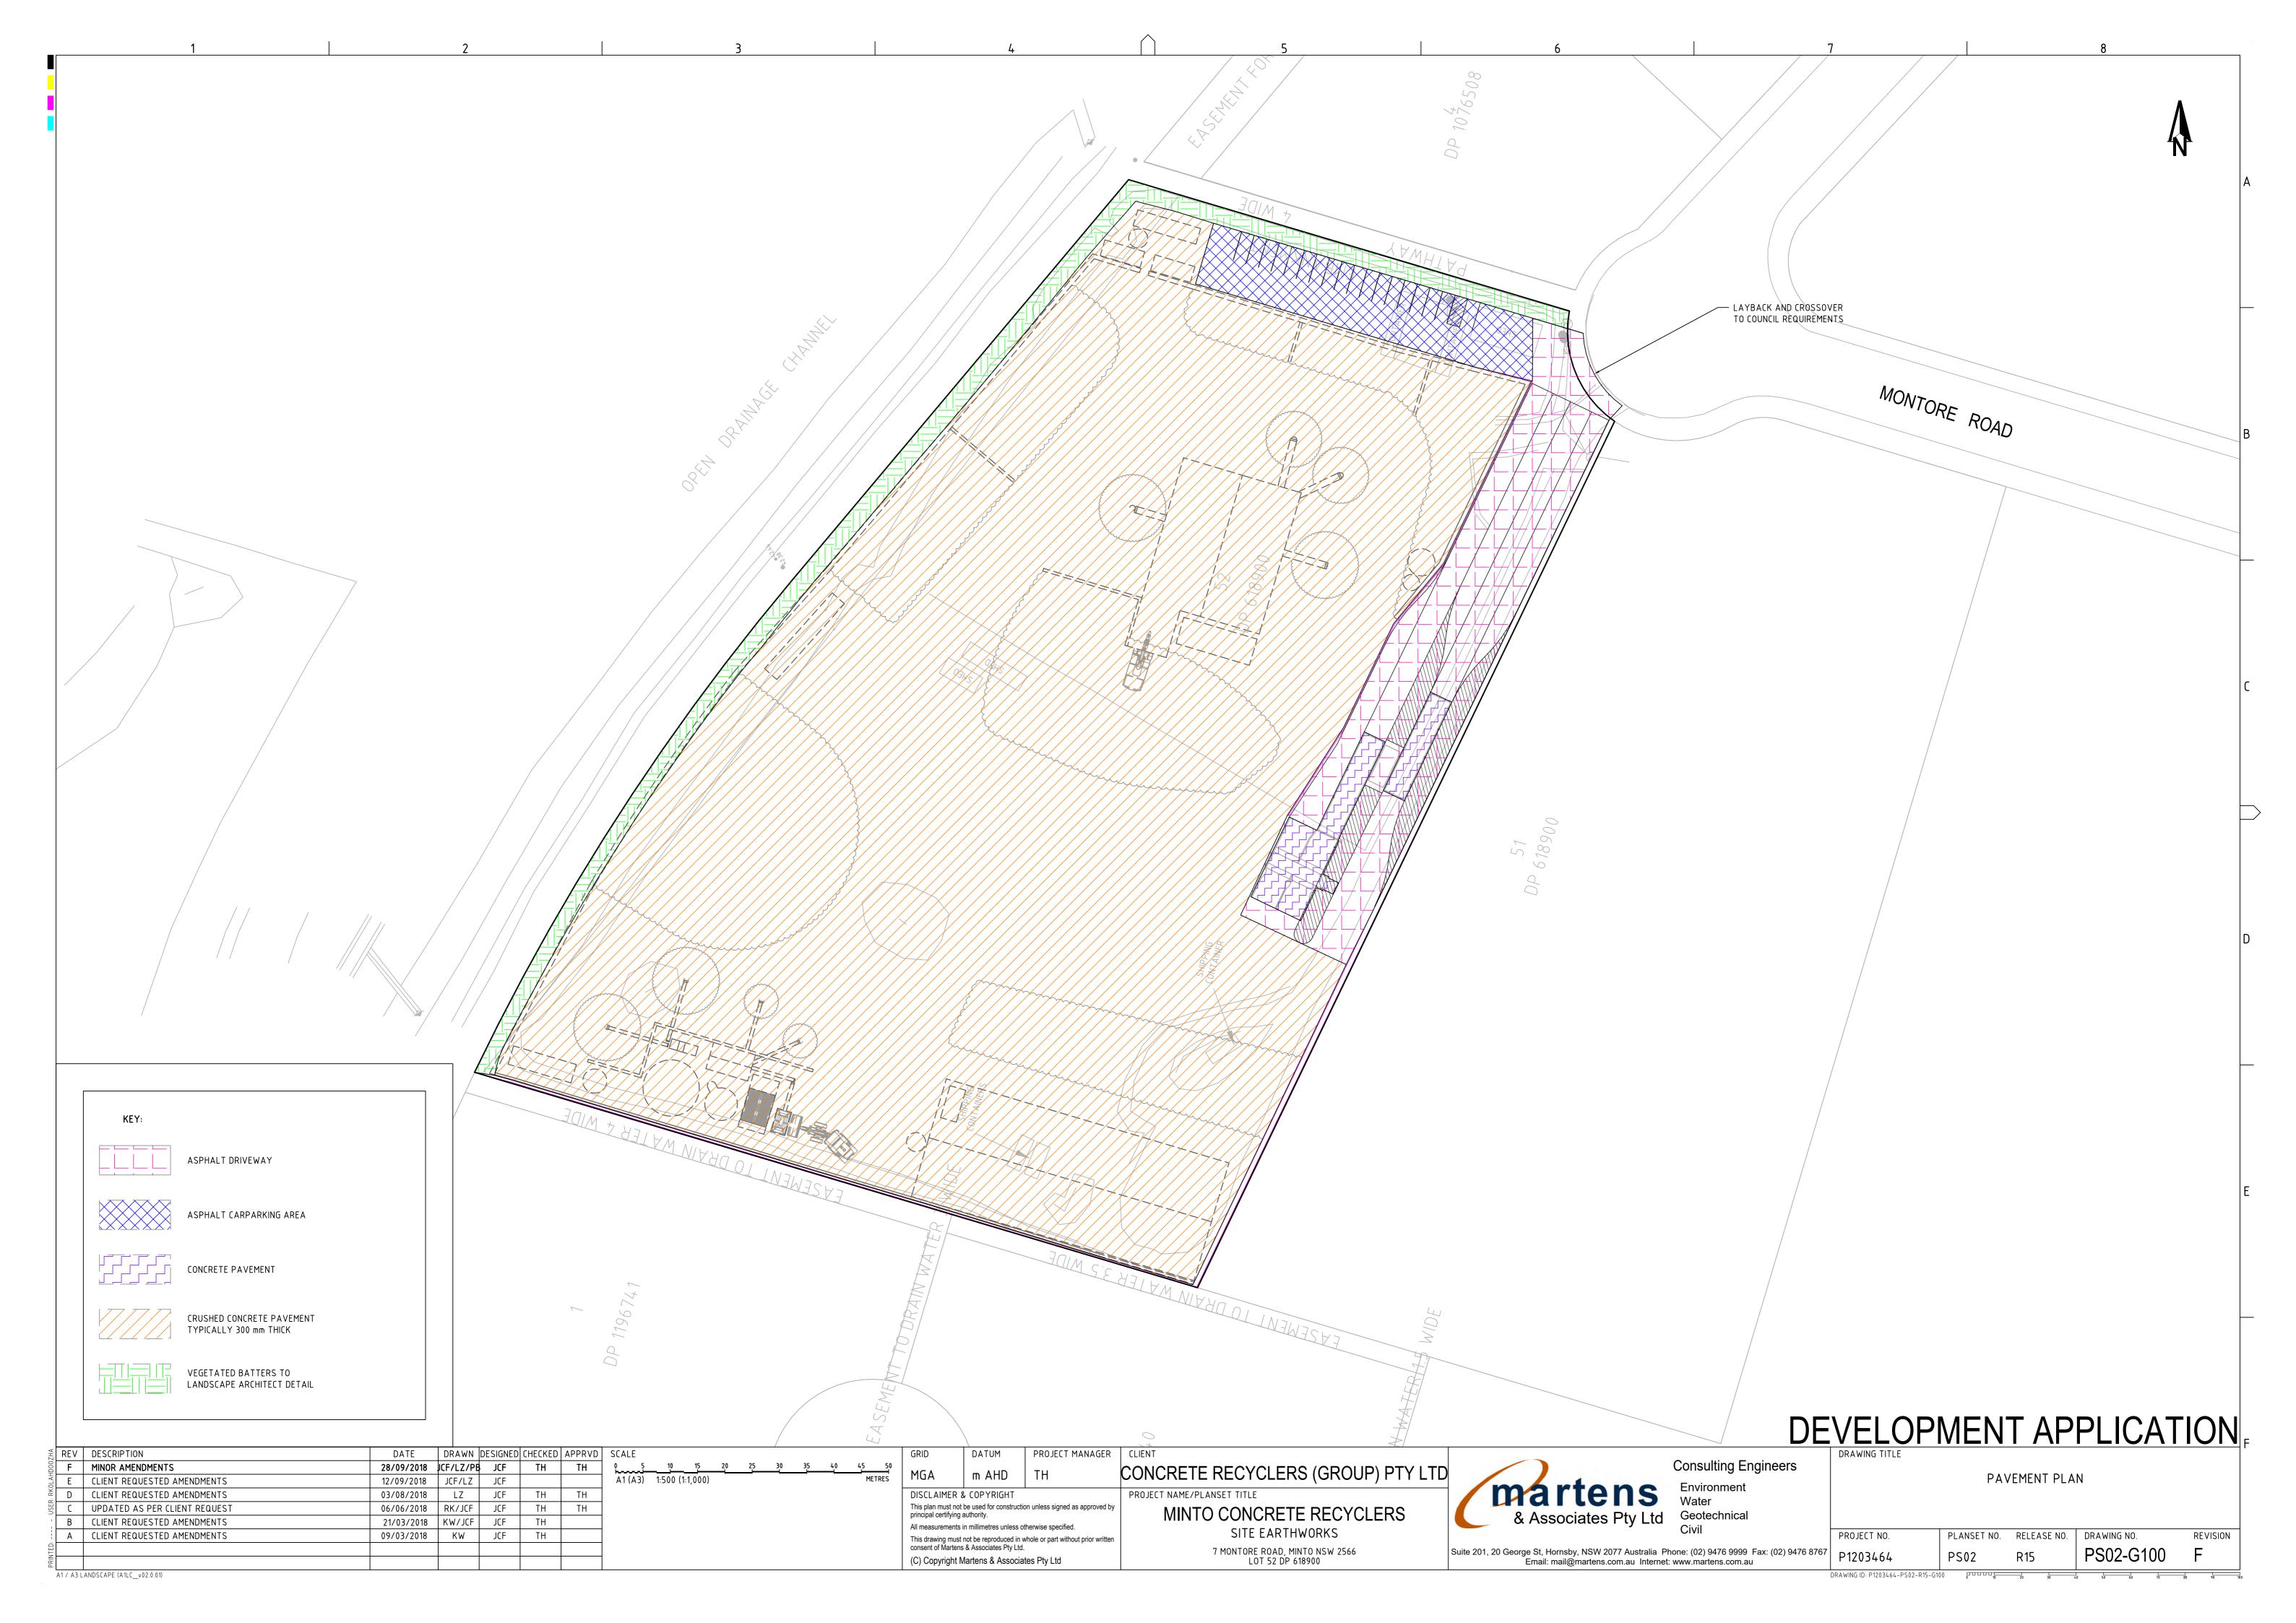

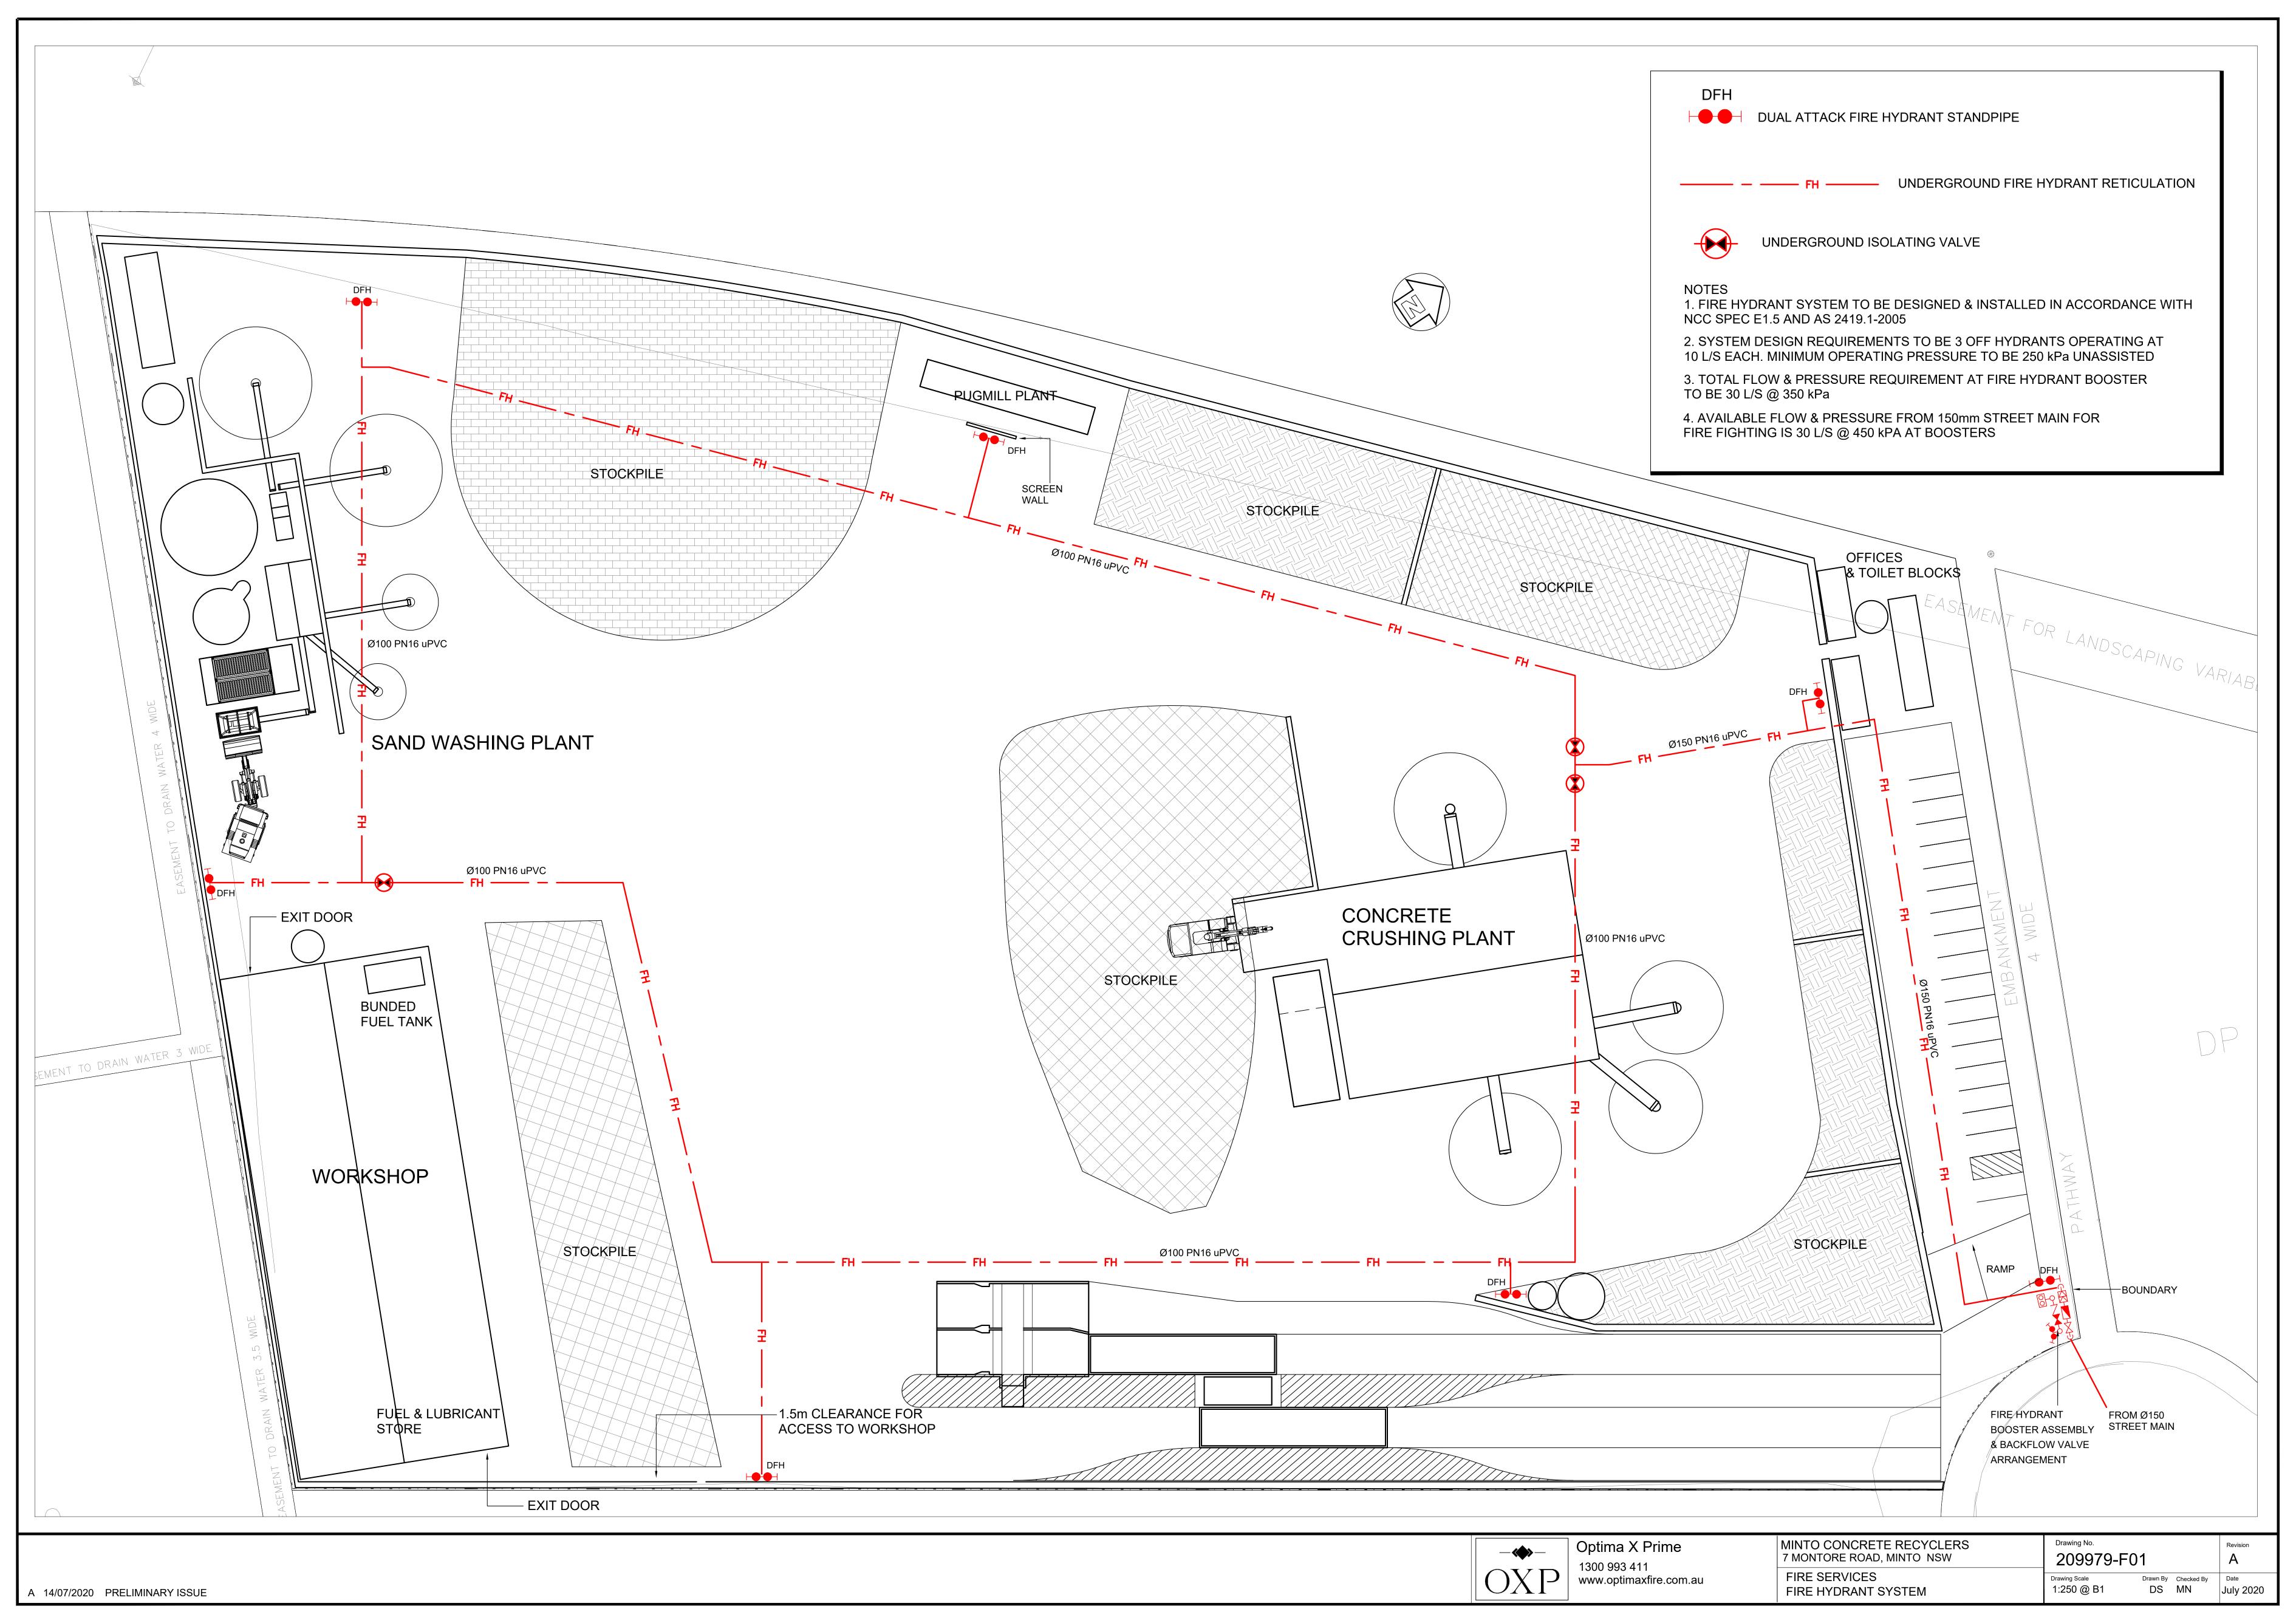


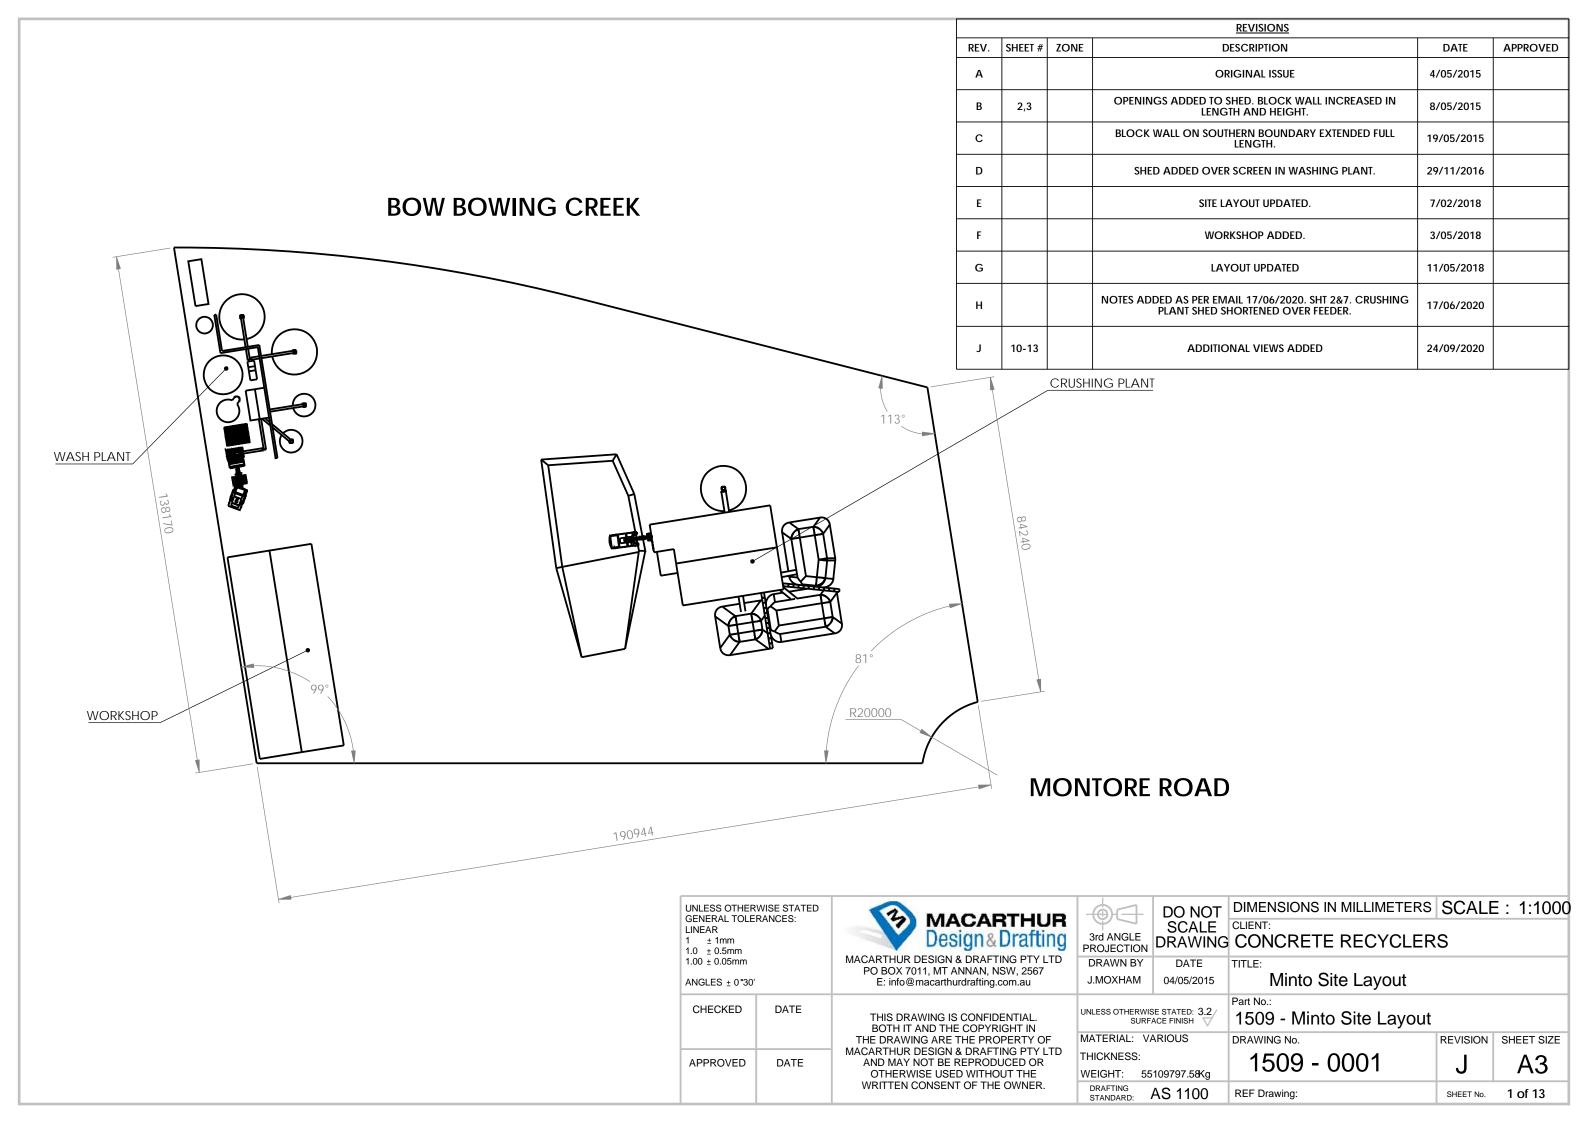

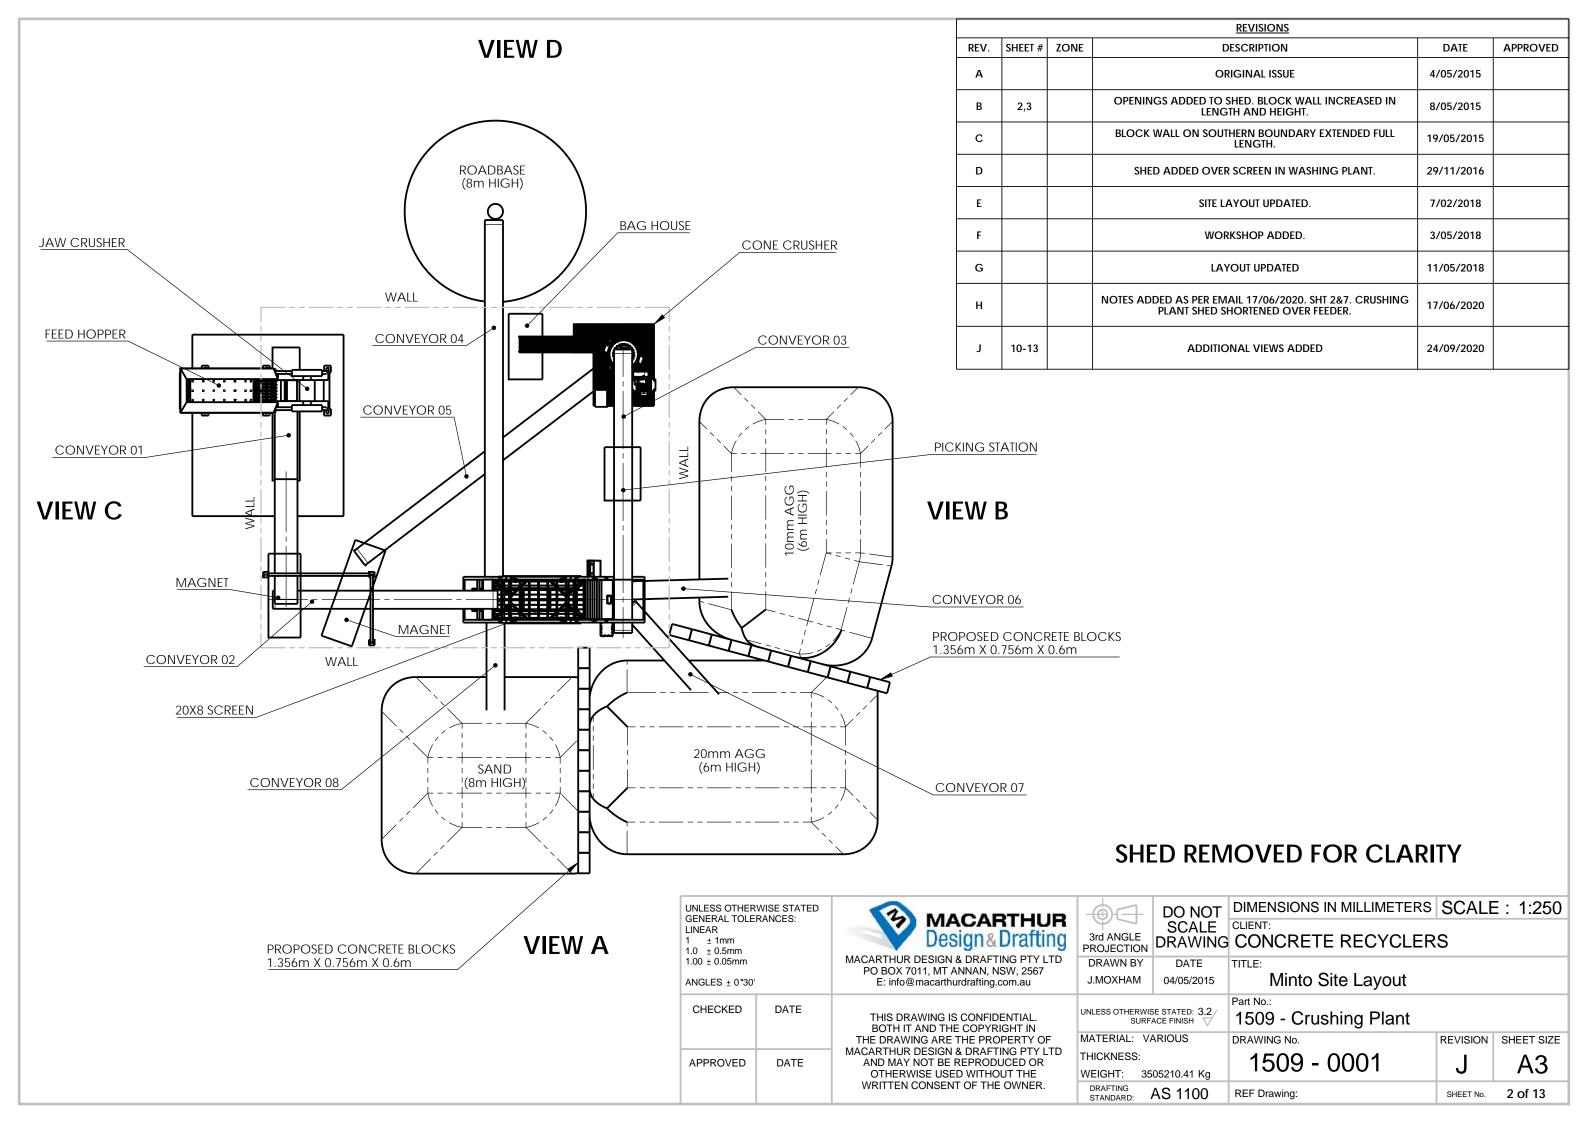

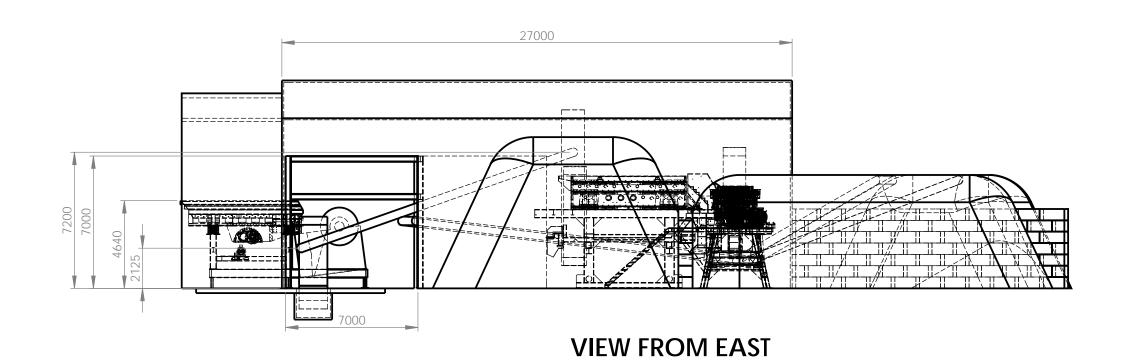


	UNLESS OTHERWISE STATED GENERAL TOLERANCES: LINEAR 1 ± 1mm 1.0 ± 0.5mm 1.00 ± 0.05mm ANGLES + 0°30'		MACARTHUR Design & Drafting MACARTHUR DESIGN & DRAFTING PTY LTD PO BOX 7011, MT ANNAN, NSW, 2567 E: info@macarthurdrafting.com.au	3rd ANGLE PROJECTION	DO NOT SCALE DRAWING	DIMENSIONS IN MILLIMETERS CLIENT: CONCRETE RECYCLER	1 0 01 1	Ξ : 1:200
				DRAWN BY J.MOXHAM	DATE 04/05/2015	Minto Site Layout		
	CHECKED	DATE	THIS DRAWING IS CONFIDENTIAL. BOTH IT AND THE COPYRIGHT IN		VISE STATED: 3.2	Part No.: 1509 - Crushing Plant		
	APPROVED	DATE	MACARTHUR DESIGN & DRAFTING PTY LTD AND MAY NOT BE REPRODUCED OR	MATERIAL: THICKNESS: WEIGHT:	VARIOUS 3505210.41 Kg	1509 - 0001	REVISION	SHEET SIZE A3
				DRAFTING STANDARD:	AS 1100	REF Drawing:	SHEET No.	3 of 13

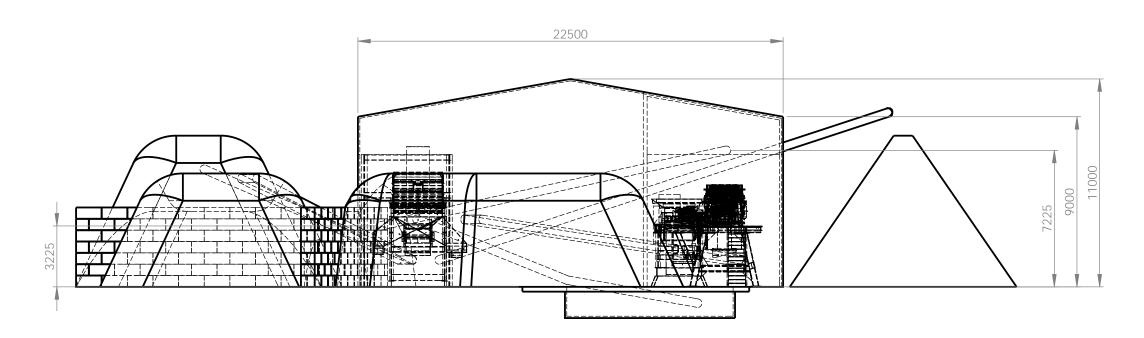



NORTH

	UNLESS OTHERWISE STATED GENERAL TOLERANCES: LINEAR 1 ± 1mm 1.0 ± 0.5mm 1.00 ± 0.05mm ANGLES + 0°30'		MACARTHUR Design & Drafting MACARTHUR DESIGN & DRAFTING PTY LTD PO BOX 7011, MT ANNAN, NSW, 2567 E: info@macarthurdrafting.com.au	3rd ANGLE PROJECTION		DIMENSIONS IN MILLIMETERS CLIENT: CONCRETE RECYCLER	1	E : 1:200
				DRAWN BY J.MOXHAM	DATE 04/05/2015	Minto Site Layout		
			TE THIS DRAWING IS CONFIDENTIAL. BOTH IT AND THE COPYRIGHT IN THE DRAWING ARE THE PROPERTY OF MACARTHUR DESIGN & DRAFTING PTY LTD TE AND MAY NOT BE REPRODUCED OR			Part No.:		
	CHECKED	DATE				1509 - Crushing Plant		
				MATERIAL: \	/ARIOUS	DRAWING No.	REVISION	SHEET SIZE
	APPROVED			THICKNESS: WEIGHT: 3505210.41 Kg		1509 - 0001	J	A3
				DRAFTING STANDARD:	AS 1100	REF Drawing:	SHEET No.	4 of 13

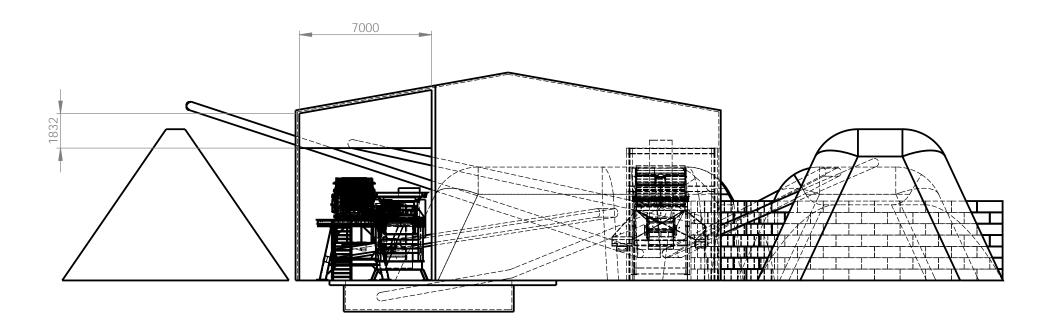



VIEW C

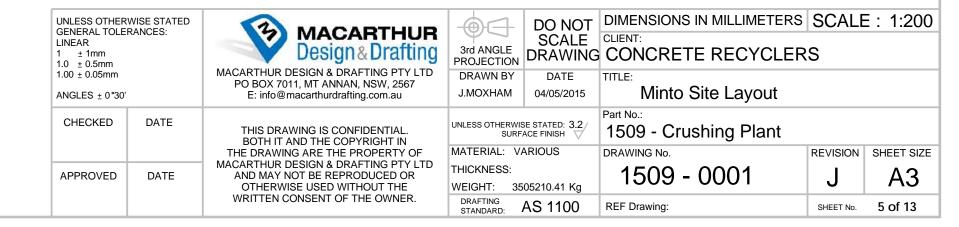


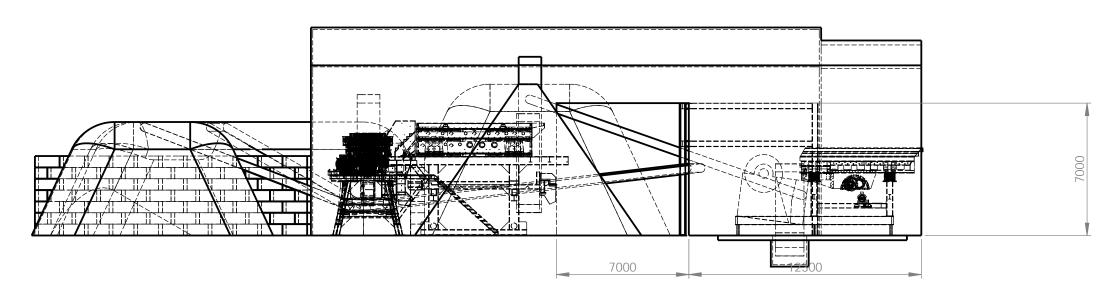


VIEW D

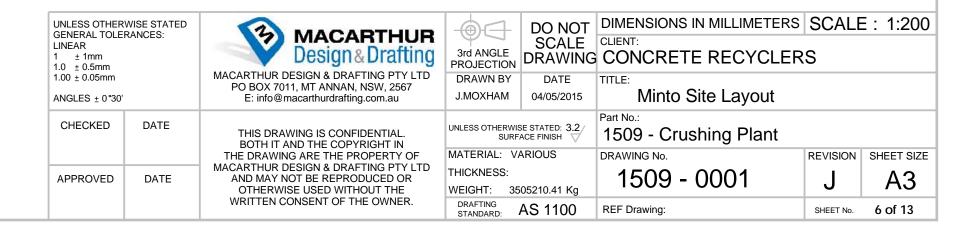


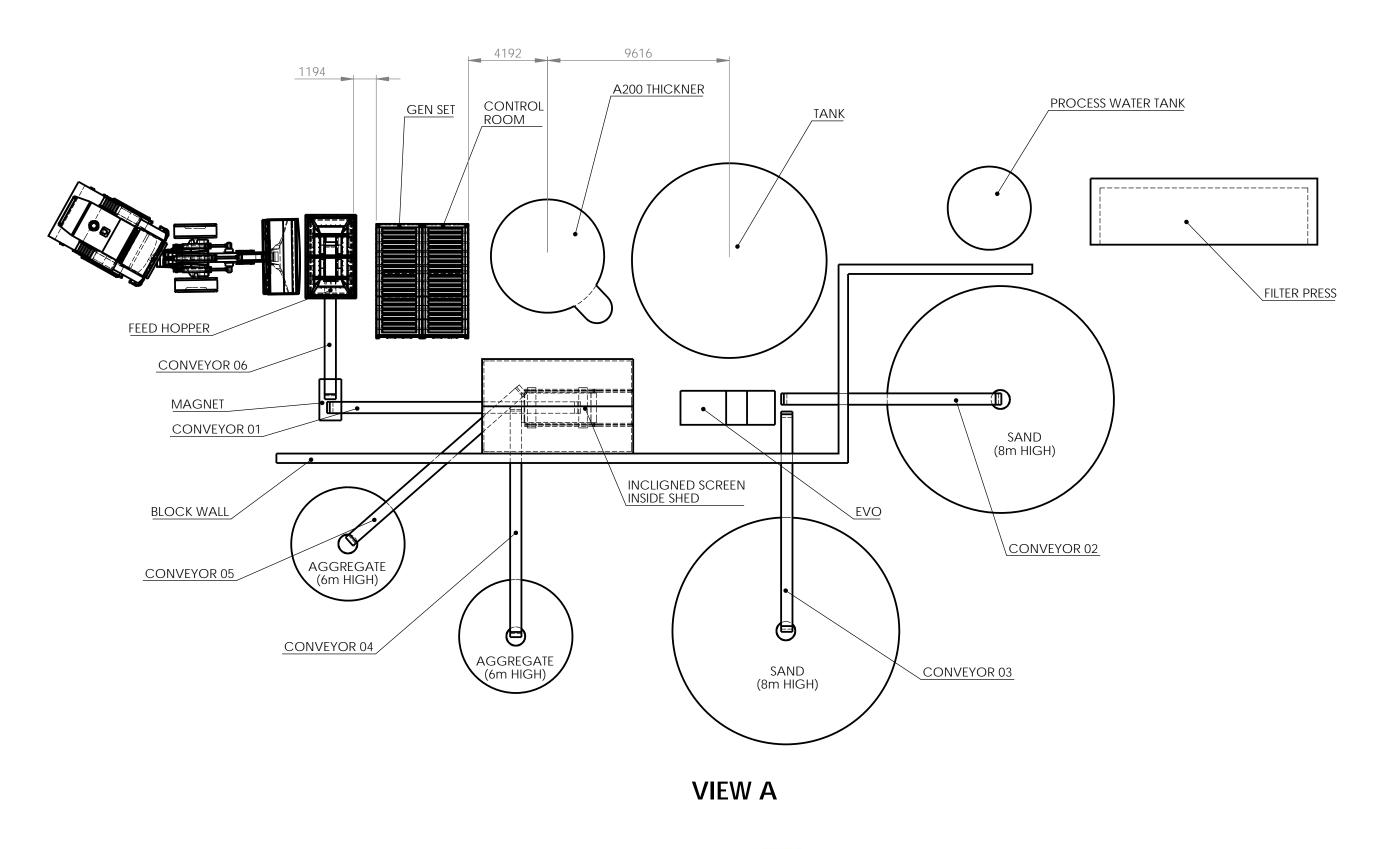

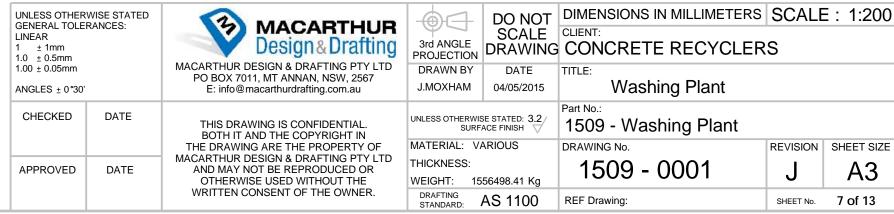

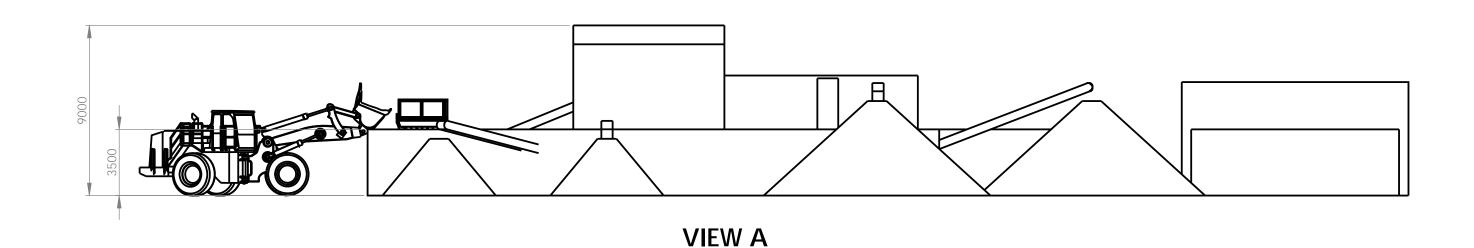



DO NOT DIMENSIONS IN MILLIMETERS | SCALE : 1:200 UNLESS OTHERWISE STATED GENERAL TOLERANCES: MACARTHUR Design & Drafting SCALE CLIENT: LINEAR 3rd ANGLE 1 ± 1mm 1.0 ± 0.5mm DRAWING CONCRETE RECYCLERS PROJECTION MACARTHUR DESIGN & DRAFTING PTY LTD 1.00 ± 0.05mm DRAWN BY DATE TITLE: PO BOX 7011, MT ANNAN, NSW, 2567 E: info@macarthurdrafting.com.au Washing Plant J.MOXHAM 04/05/2015 ANGLES ± 0°30' CHECKED DATE UNLESS OTHERWISE STATED: 3.2
SURFACE FINISH 1509 - Washing Plant THIS DRAWING IS CONFIDENTIAL. BOTH IT AND THE COPYRIGHT IN MATERIAL: VARIOUS DRAWING No. REVISION | SHEET SIZE THE DRAWING ARE THE PROPERTY OF MACARTHUR DESIGN & DRAFTING PTY LTD 1509 - 0001 THICKNESS: **A3** APPROVED DATE AND MAY NOT BE REPRODUCED OR WEIGHT: 1556498.41 Kg OTHERWISE USED WITHOUT THE WRITTEN CONSENT OF THE OWNER. DRAFTING STANDARD: AS 1100 REF Drawing: SHEET No. 8 of 13

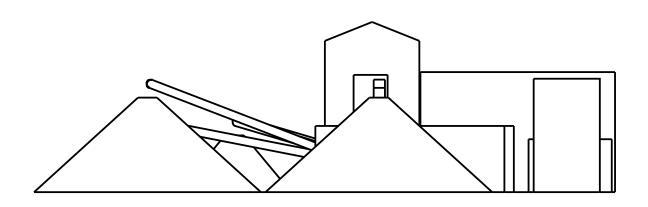



VIEW B

G LI 1	UNLESS OTHERWISE STATED GENERAL TOLERANCES: LINEAR 1 ± 1mm 1.0 ± 0.5mm 1.00 ± 0.05mm ANGLES ± 0°30'		MACARTHUR Design & Drafting MACARTHUR DESIGN & DRAFTING PTY LTD PO BOX 7011, MT ANNAN, NSW, 2567 E: info@macarthurdrafting.com.au	3rd ANGLE PROJECTION	DO NOT SCALE DRAWING	DIMENSIONS IN MILLIMETERS CLIENT: CONCRETE RECYCLER		E : 1:200
				DRAWN BY J.MOXHAM	DATE 04/05/2015	Washing Plant		
	CHECKED DATE	THIS DRAWING IS CONFIDENTIAL. BOTH IT AND THE COPYRIGHT IN		VISE STATED: 3.2	Part No.: 1509 - Washing Plant			
			THE DRAWING ARE THE PROPERTY OF MACARTHUR DESIGN & DRAFTING PTY LTD DATE AND MAY NOT BE REPRODUCED OR	MATERIAL: \	VARIOUS	DRAWING No.	REVISION	SHEET SIZE
A	APPROVED DATE	DATE		THICKNESS: WEIGHT: 1	556498.41 Kg	1509 - 0001	J	A3
				DRAFTING STANDARD:	AS 1100	REF Drawing:	SHEET No.	9 of 13

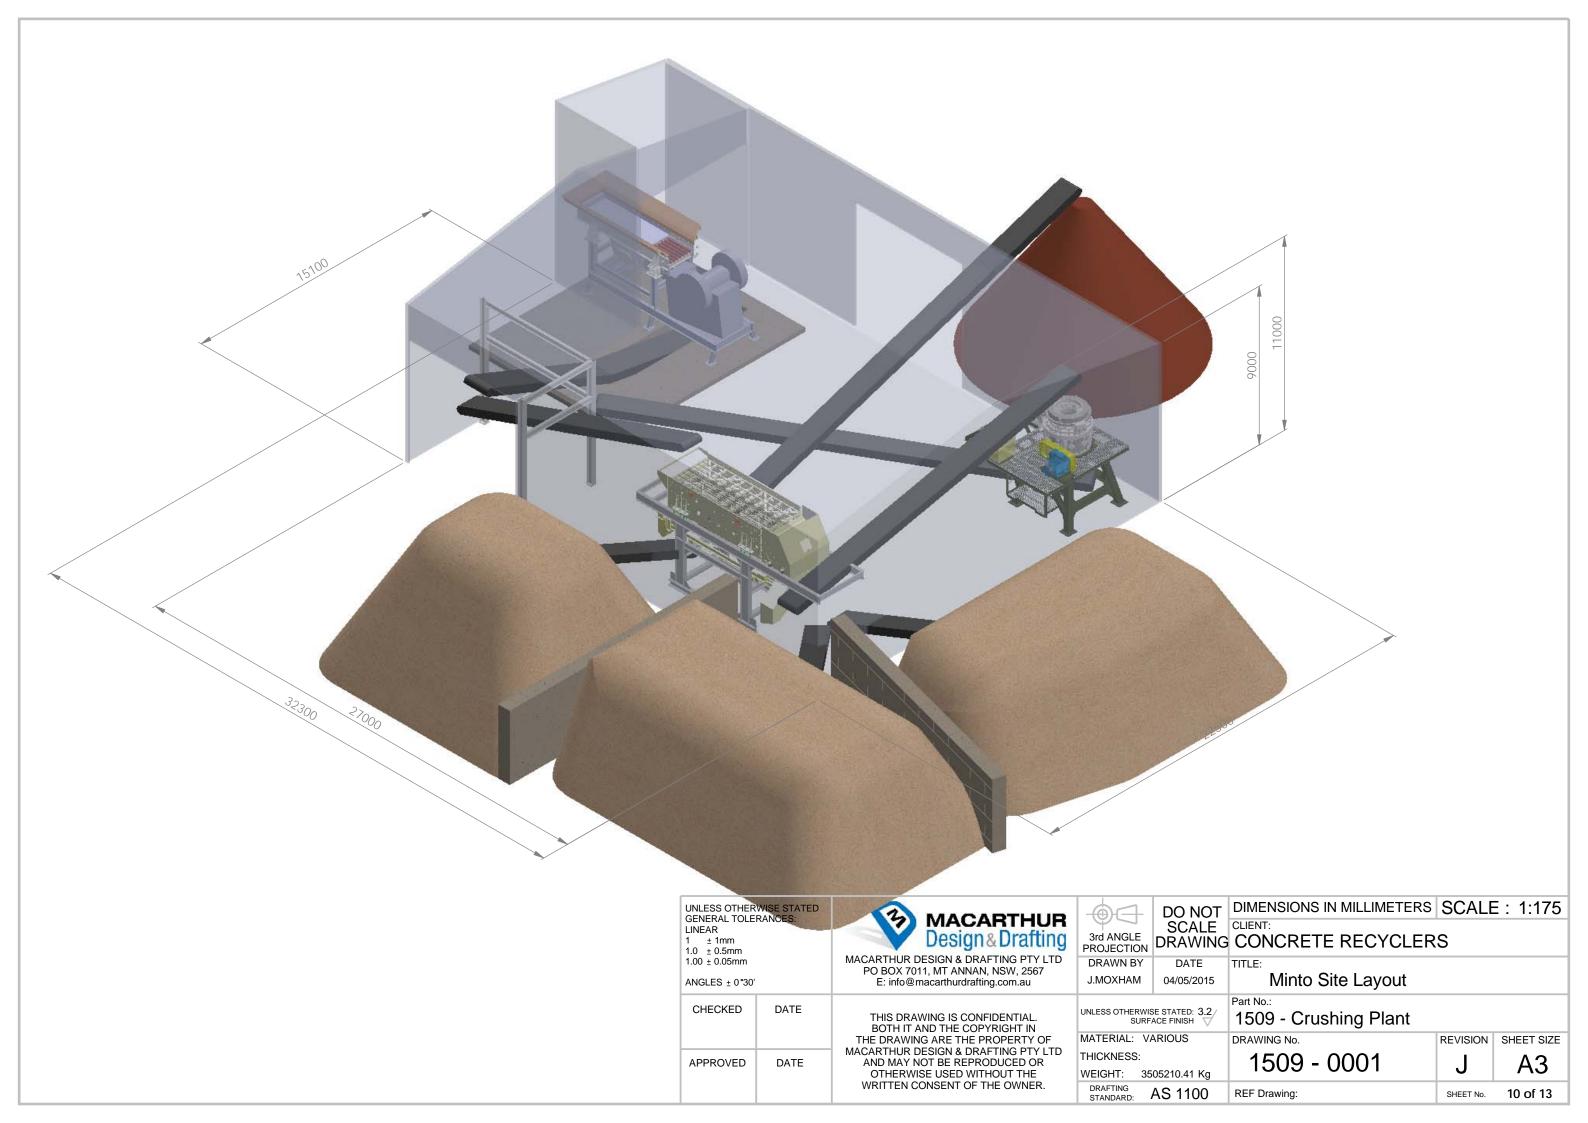

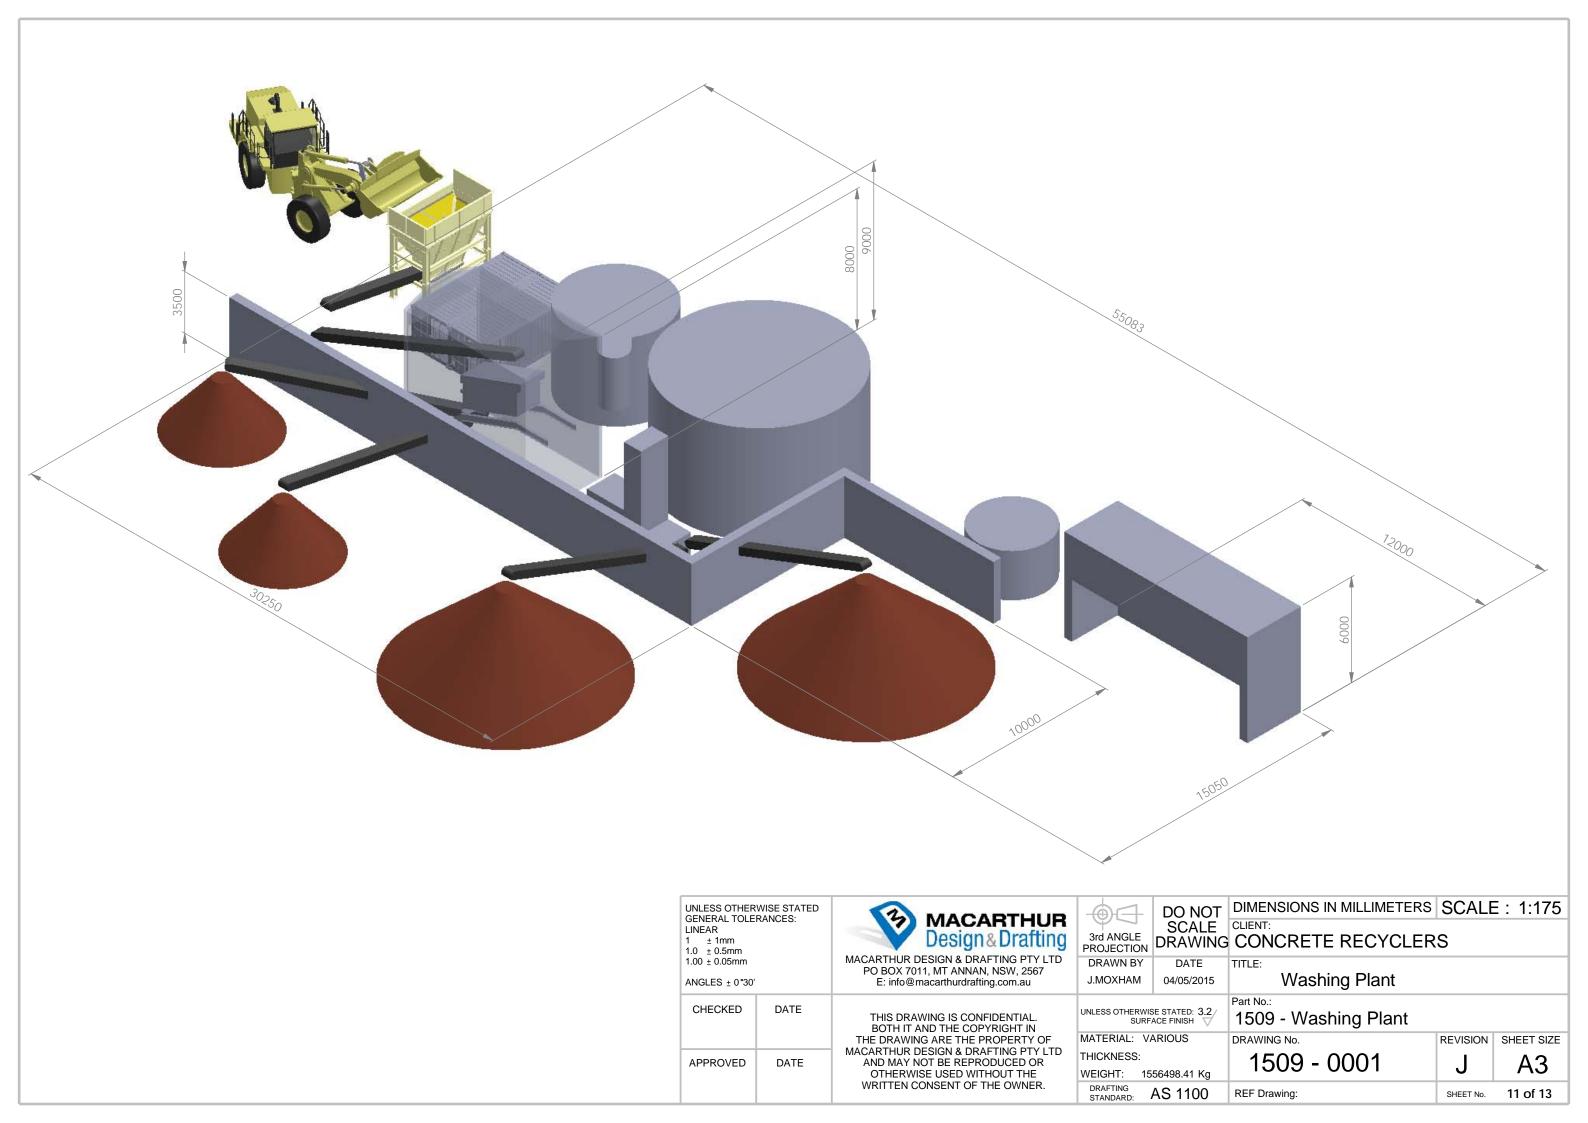

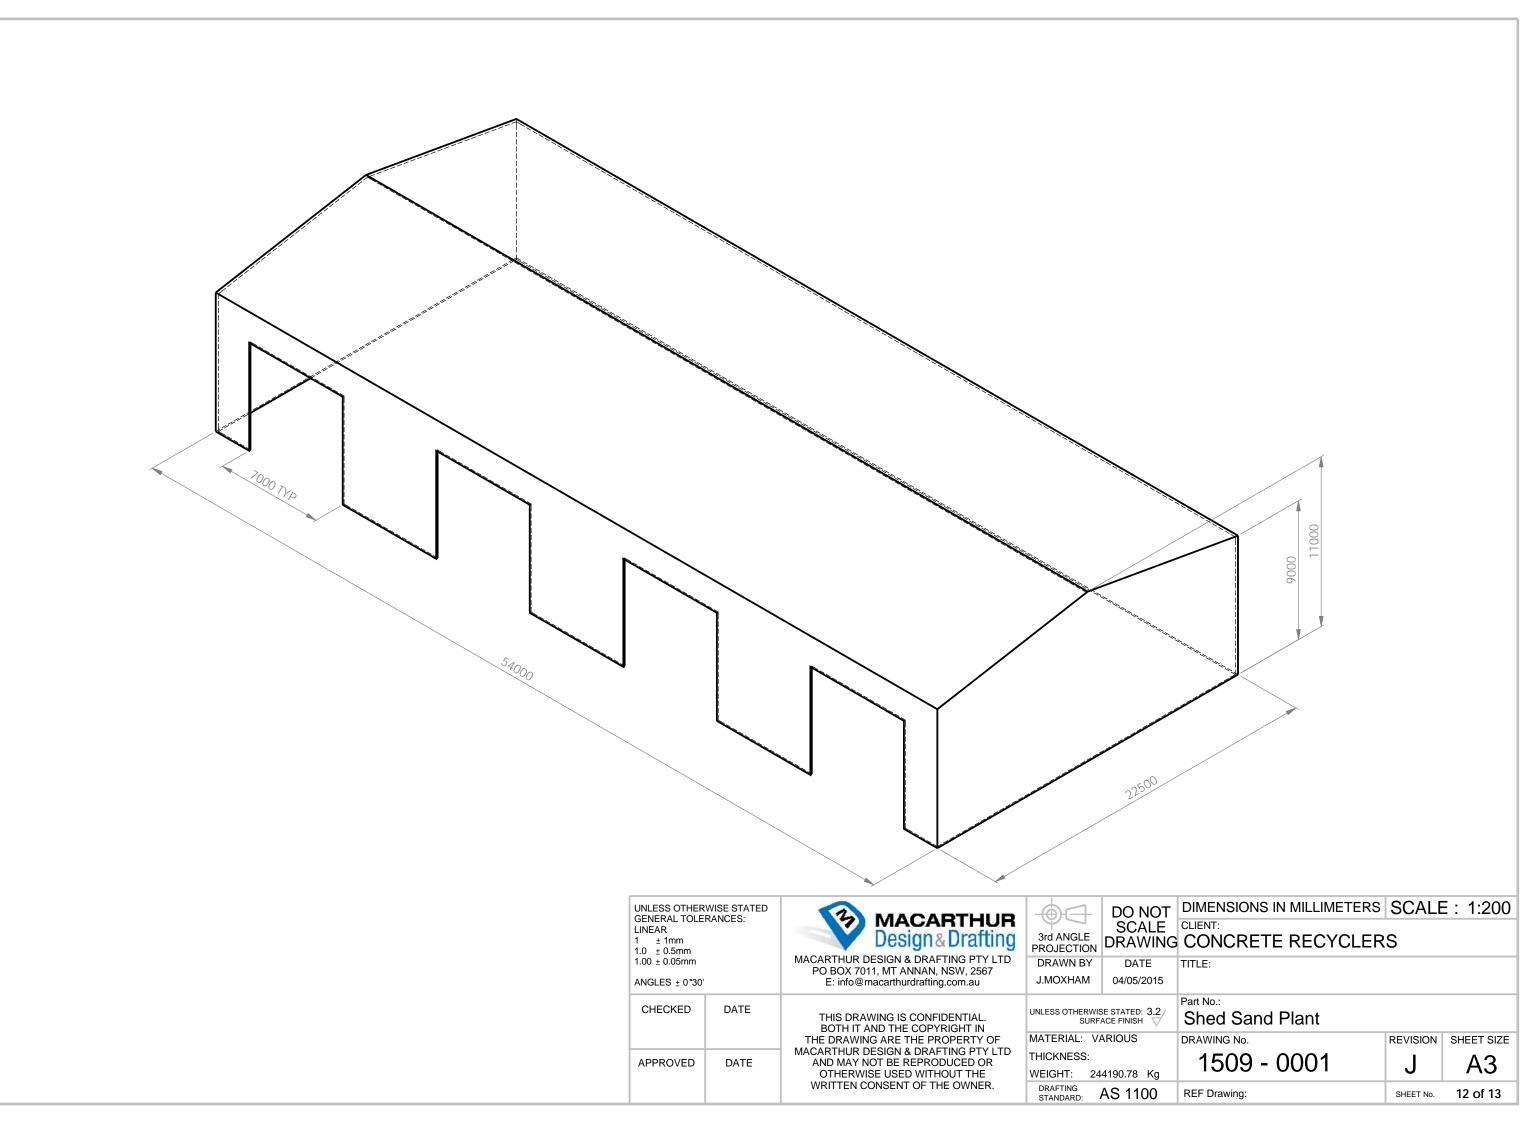

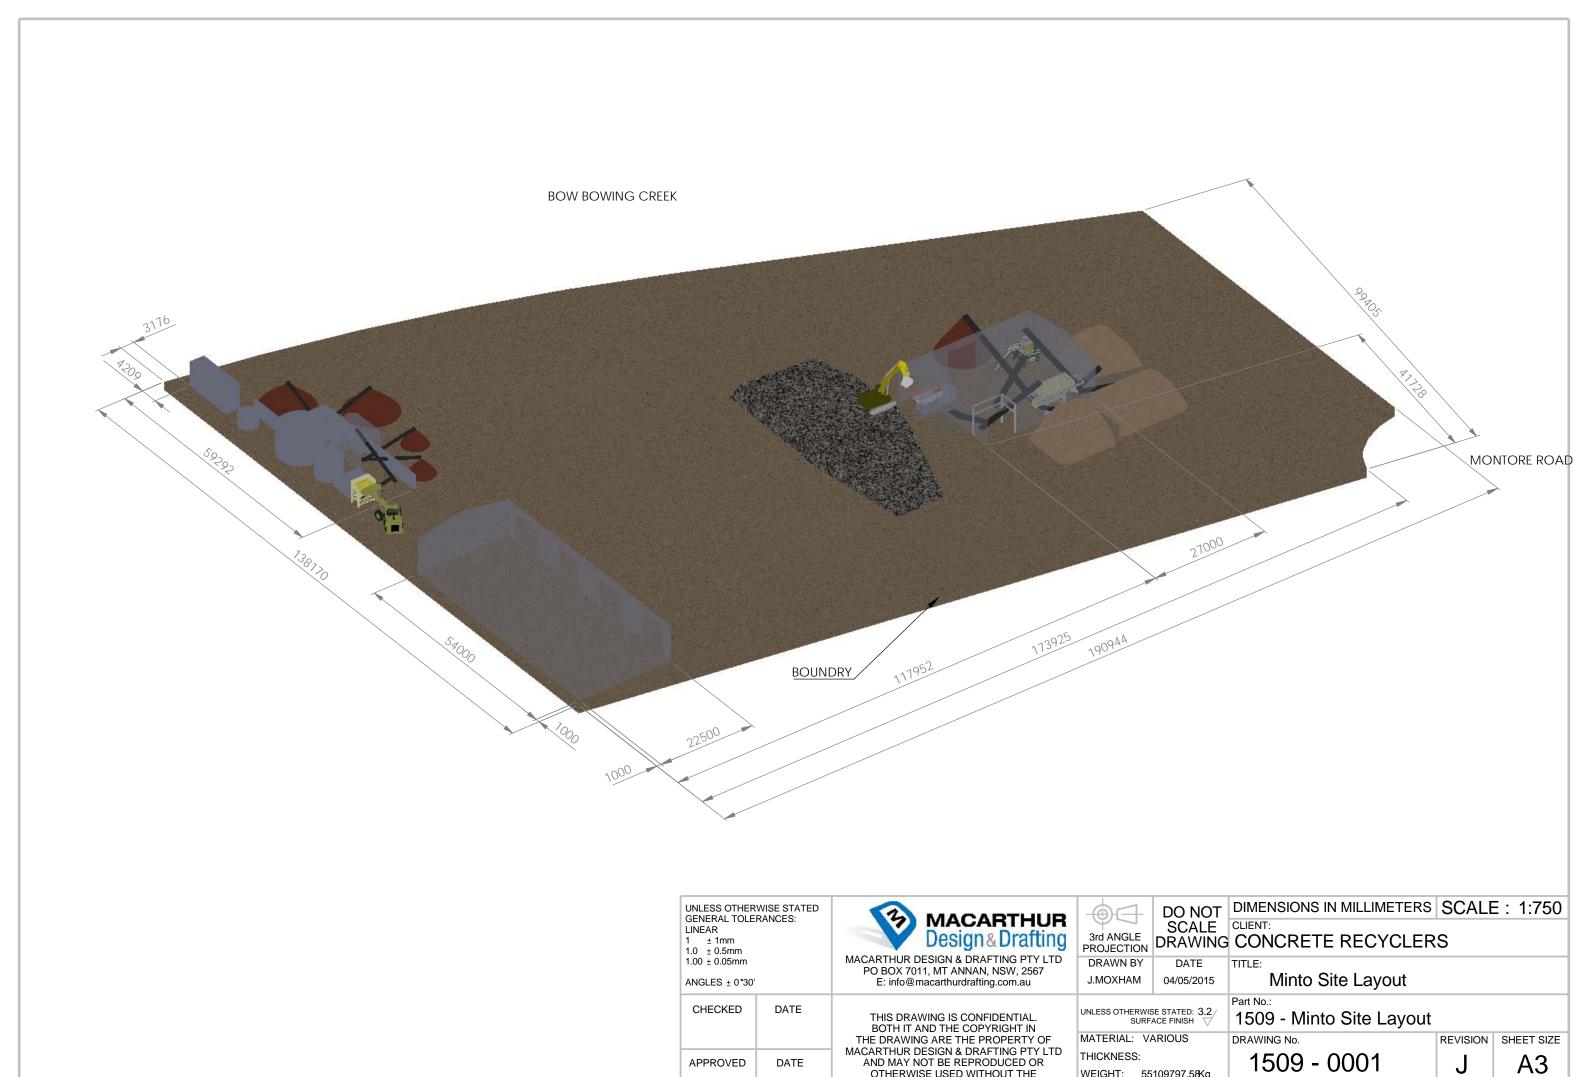

OTHERWISE USED WITHOUT THE

WRITTEN CONSENT OF THE OWNER.

WEIGHT: 55109797.58Kg

AS 1100

REF Drawing:

13 of 13

SHEET No.

DRAFTING STANDARD: