

2 SOUTH ELEVATION
1:200

29:33 PM	NORTH POINT TRUE NORTH		Health Infrastructure	ARCHITECTS CONTRACTOR	THE SUTHERLAND HOSPITAL OPERATING THEATRE UPGRADE	BUILDING ELEVATIONS - NORTH & SOUTH	SCALE 1: 200 @ A1 PROJECT NUMBER 10192314	DRAWING NUMBER HDR-AR-DG-15010	DATE 13/11/20 ISSUE 00 3
3 DRAFT EIS ISSUE 2 FOR 50% DD 1 SSD ISSUE REV DESCRIPTION OF CHANGE	AB MT 13/11/20 SJ DS 30/09/20 HDR HDR 05/08/20 CHECKED ISSUED DATE 1:0mm	0	Level 6 77 Pacific Highway, North Sydney, NSW 2060 P: +61 2 9978 5427 F: +61 2 8904 1377 www.hinfra.health.nsw.gov.au	Level 1, 110 Walker Street, North Sydney NSW 2060, Australia +61 2 9956 2666 hdrinc.com HDR Pty. Limited ABN 76 158 075 220 trading as HDR	KINGSWAY & KAREENA ROAD, CARINGBAH NSW 2229	PROJECT STATUS SSDA	THIS DOCUMENT IS THE COPYRIG ALL INFORMATION ILLUSTRATED EVENT OF DISCREPANCIES REFE SCALE DRAWINGS MANUALLY OR	SHT OF HDR. ON THIS DOCUMENT IS TO BE CHECKED AND V R TO ARCHITECT PRIOR TO COMMENCEMENT ELECTRONICALLY.	/ERIFIED ON SITE. IN THE OF THE WORK. DO NOT

BIM 360://10192314_Sutherland_Hospital_Operating_Theatre_Upgrade_2020/TSHOTUP_BUILDING.rvt



Issued under the Environmental Planning and Assessment Act 1979


Approved Application: SSD-11099584 Signed: NS

Granted on: 12 October 2021

Sheet: 5 of 53

LEGEND

- BRICK TO MATCH EXISTING BRICK AS PER STAGE 1 WORKS
- PROFILED METAL DECK ROOF COLORBOND KLIP-LOK COLOUR: SURFMIST
- 3 STAGE 2 WEATHERPROOF LOUVRES COLOUR SURF MIST
- METAL MESH SCREEN
 COLOUR RED OXIDE
 INTEGRATED ART TO BE DEVELOPED WITH CLIENT AND ART
 CONSULTANT DURING DESIGN DEVELOPMENT
- UNCAPPED DGU CURTAIN WALL SYSTEM WITH PERFORATED SUN HADING EXTENDED OFF MULLIONS
- ASYMMETRIC METAL PANEL RAINSCREEN CLADDING COLOUR WHITE
- 7 PERFORATED METAL PANEL; COLOUR: WHITE
- REIDER OR SIMILAR PPROVED CONCRETE SKIN (13MM COMPRESSED FIBRE CEMENT PANELS)
- 9 EXTRUDED STEEL CHANNEL
- 10 CLASS 2 CONCRETE DARK GREY PIGMENT
- METAL MESH SCREEN COLOUR RED OXIDE
- GLAZED CANOPY WITH ACID ETCH FRIT

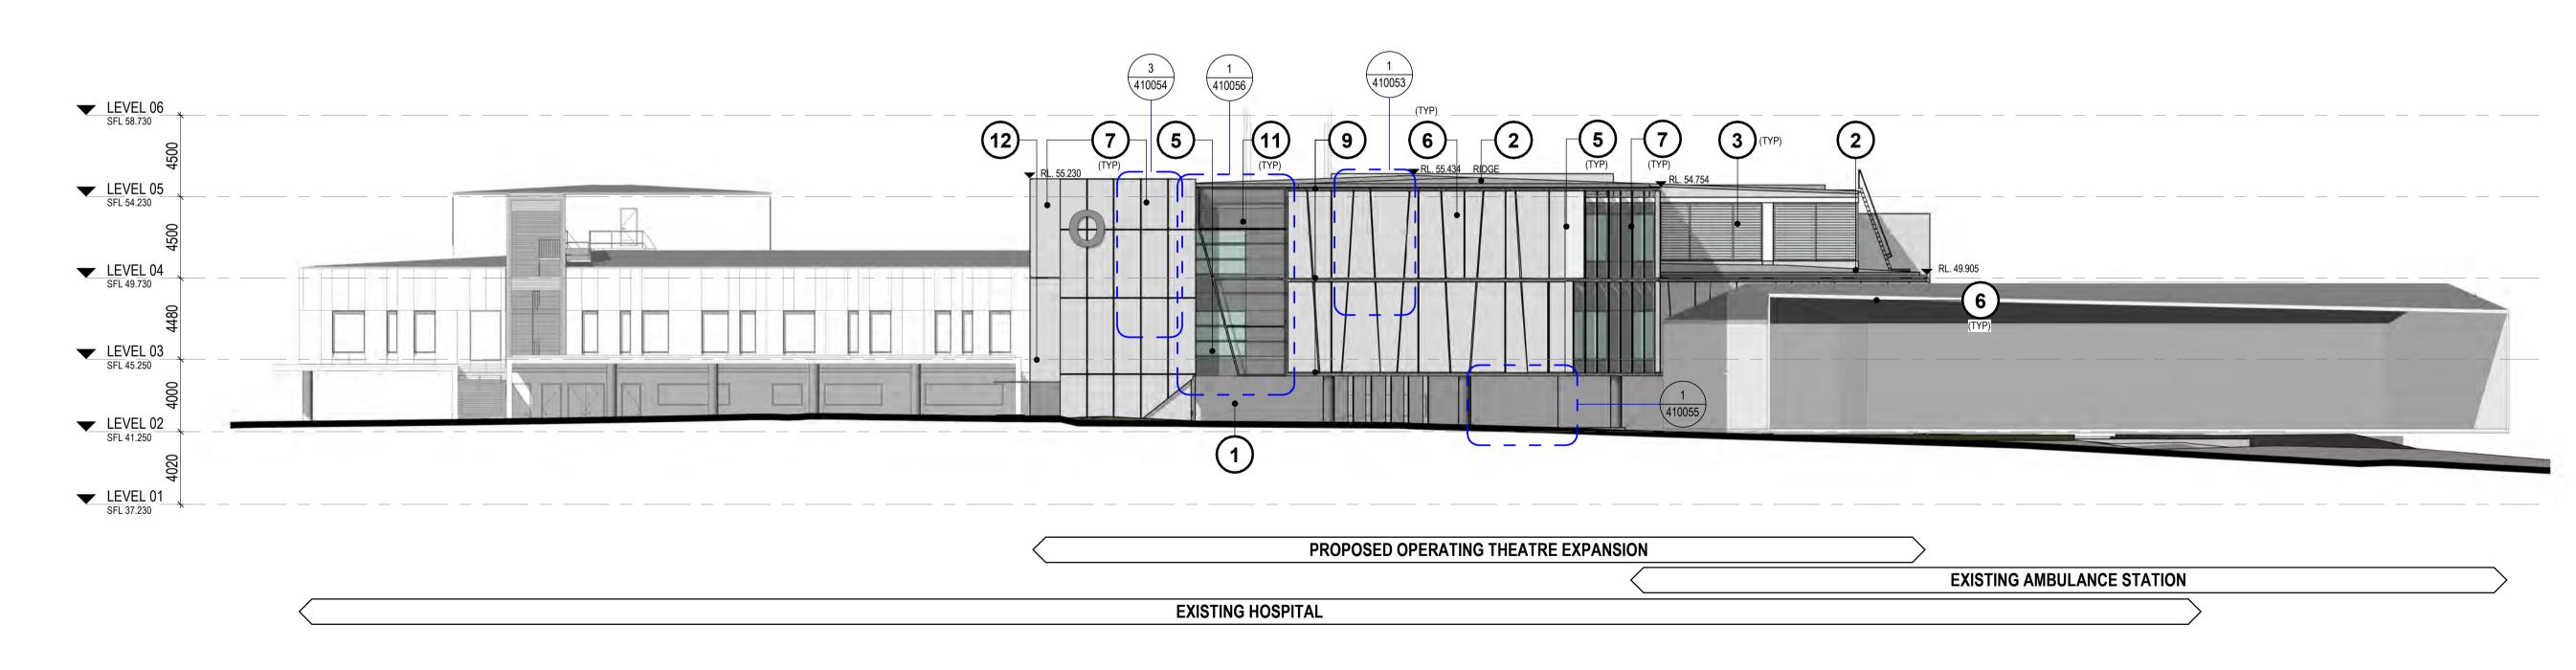


WEST ELEVATION

ARCHITECTS KEY PLAN THE SUTHERLAND HOSPITAL OPERATING **BUILDING ELEVATION - WEST** 1 : 200 @ A1 13/11/20 Health
Infrastructure
Level 6 77 Pacific Highway, North Sydney, NSW 2060
P: +61 2 9978 5427 | F: +61 2 8904 1377
www.hinfra.health.nsw.gov.au PROJECT NUMBER DRAWING NUMBER ISSUE THEATRE UPGRADE 10192314 HDR-AR-DG-150200 3
 3
 DRAFT EIS ISSUE
 AB
 MT
 13/11/20

 2
 FOR 50% DD
 SJ
 DS
 30/09/20

 1
 SSD ISSUE
 HDR
 HDR
 05/08/20

 REV
 DESCRIPTION OF CHANGE
 CHECKED
 ISSUED
 DATE
 PROJECT STATUS KINGSWAY & KAREENA ROAD, Level 1, 110 Walker Street, North Sydney NSW 2060, Australia 2 FOR 50% DD THIS DOCUMENT IS THE COPYRIGHT OF HDR.
ALL INFORMATION ILLUSTRATED ON THIS DOCUMENT IS TO BE CHECKED AND VERIFIED ON SITE. IN THE
EVENT OF DISCREPANCIES REFER TO ARCHITECT PRIOR TO COMMENCEMENT OF THE WORK. DO NOT
SCALE DRAWINGS MANUALLY OR ELECTRONICALLY. +61 2 9956 2666 | hdrinc.com **CARINGBAH NSW 2229** SSDA HDR Pty. Limited ABN 76 158 075 220 trading as HDR BIM 360://10192314_Sutherland_Hospital_Operating_Theatre_Upgrade_2020/TSHOTUP_BUILDING.rvt

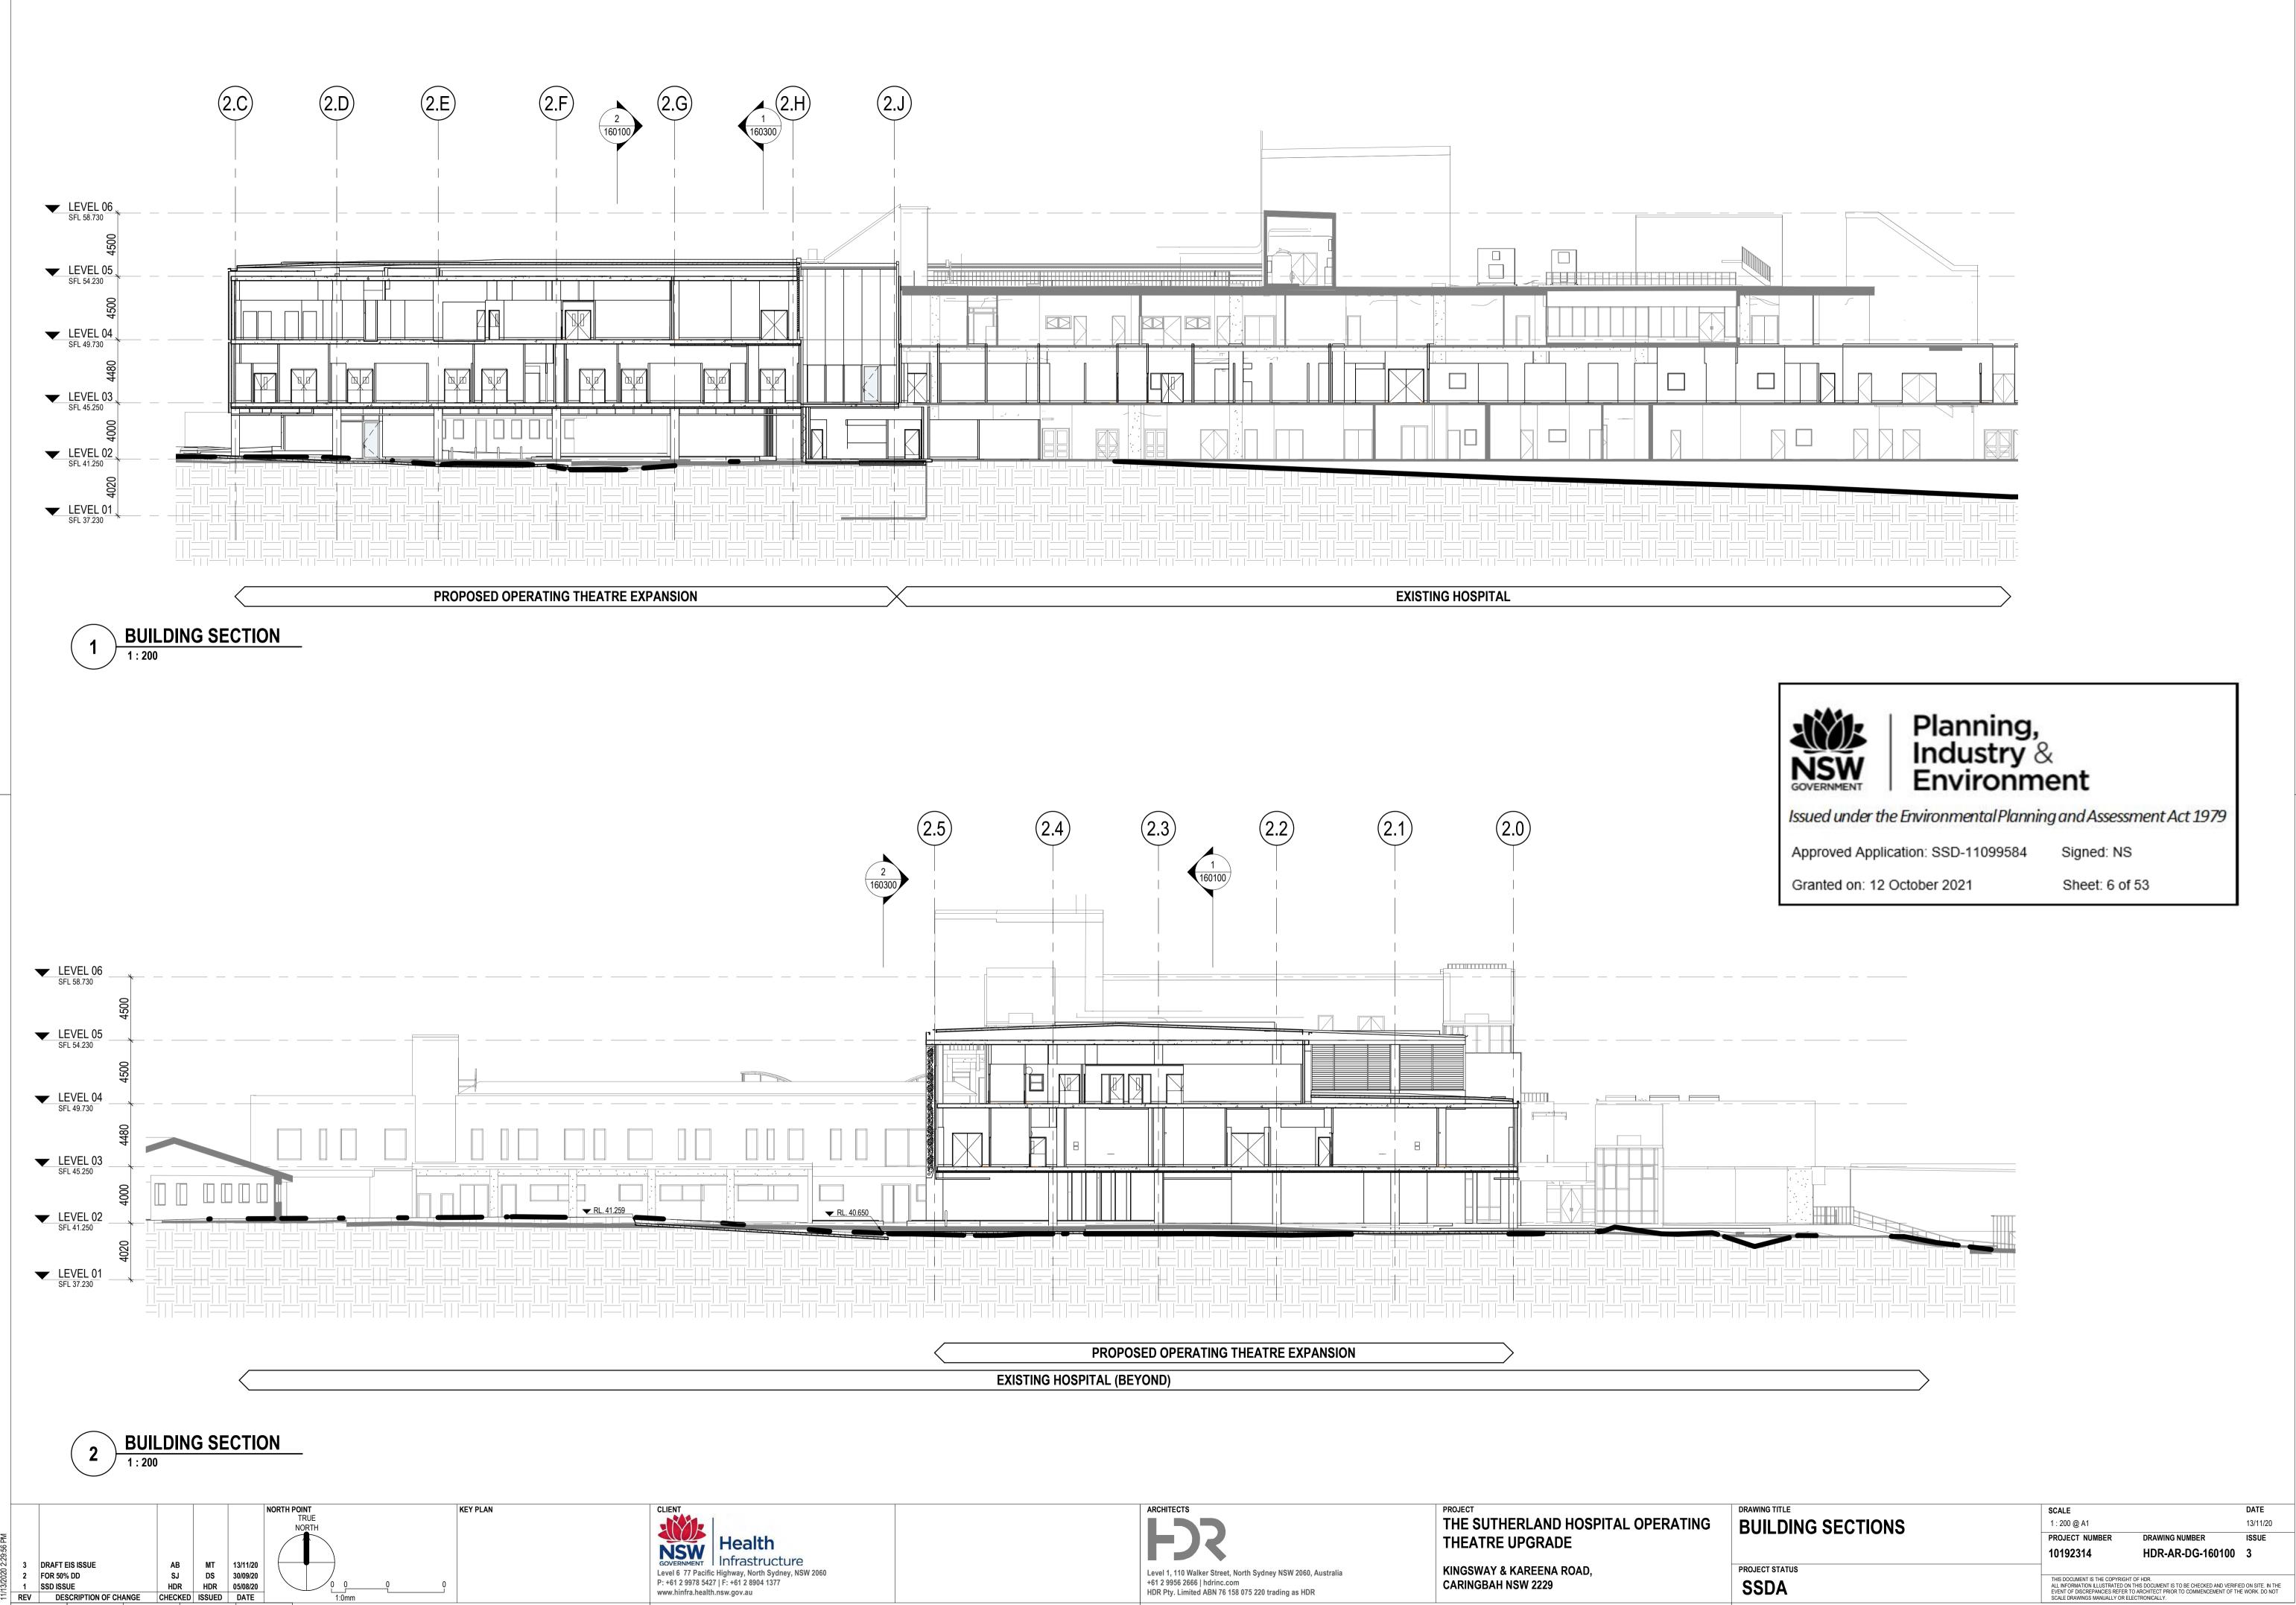


BIM 360://10192314_Sutherland_Hospital_Operating_Theatre_Upgrade_2020/TSHOTUP_BUILDING.rvt




Issued under the Environmental Planning and Assessment Act 1979

Approved Application: SSD-11099584 Signed: NS

Granted on: 12 October 2021 Sheet: 7 of 53

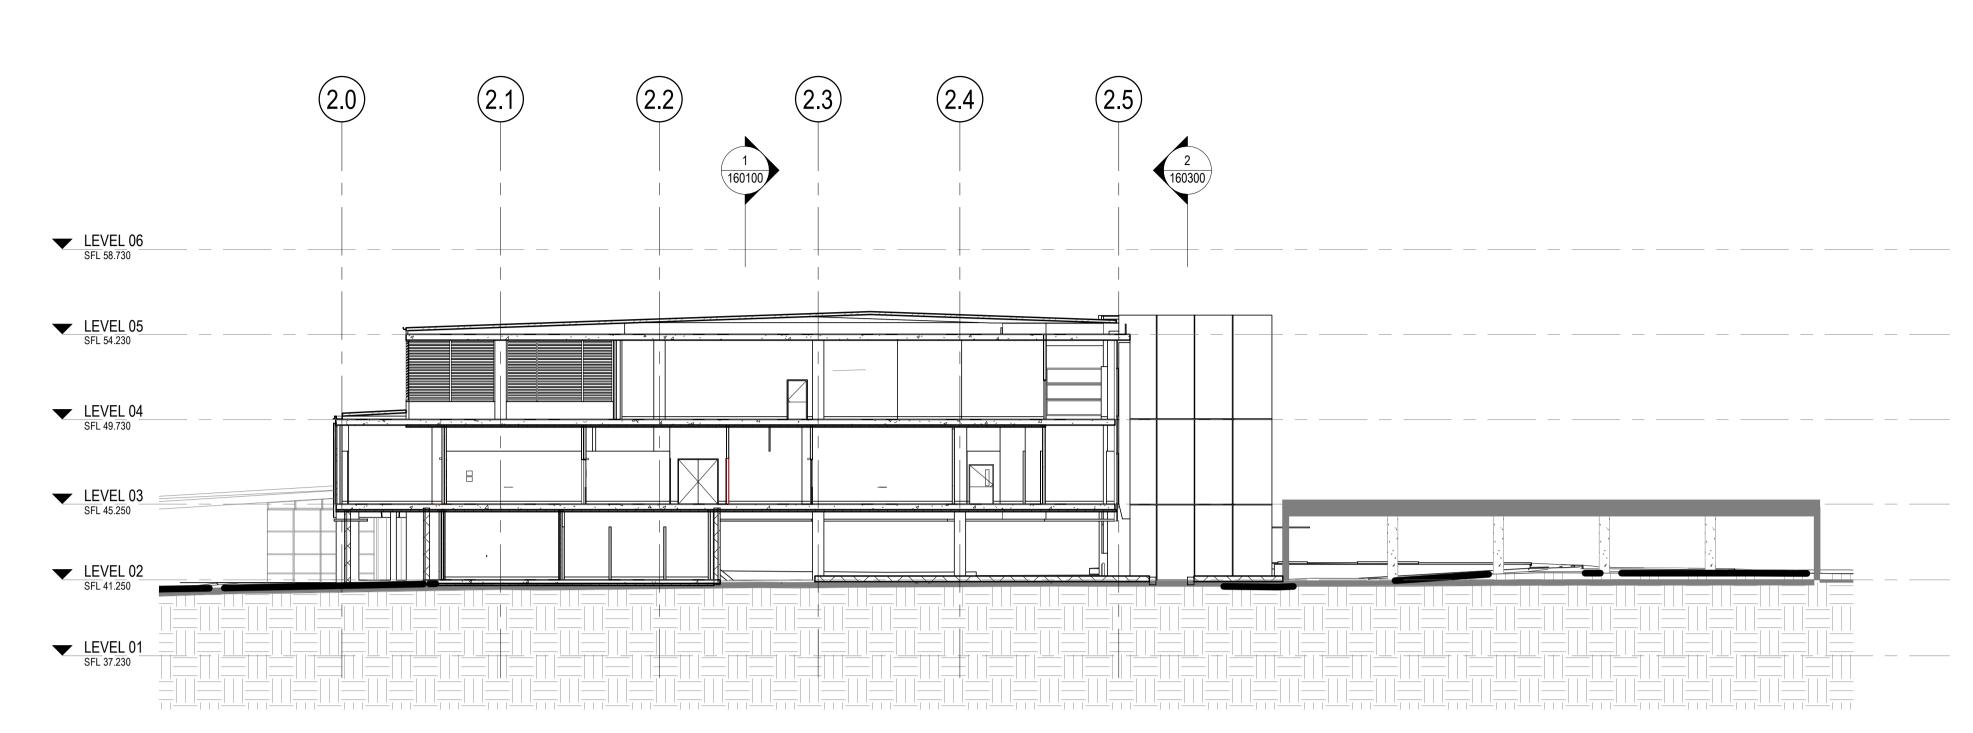

1 BUILDING SECTION
1:200

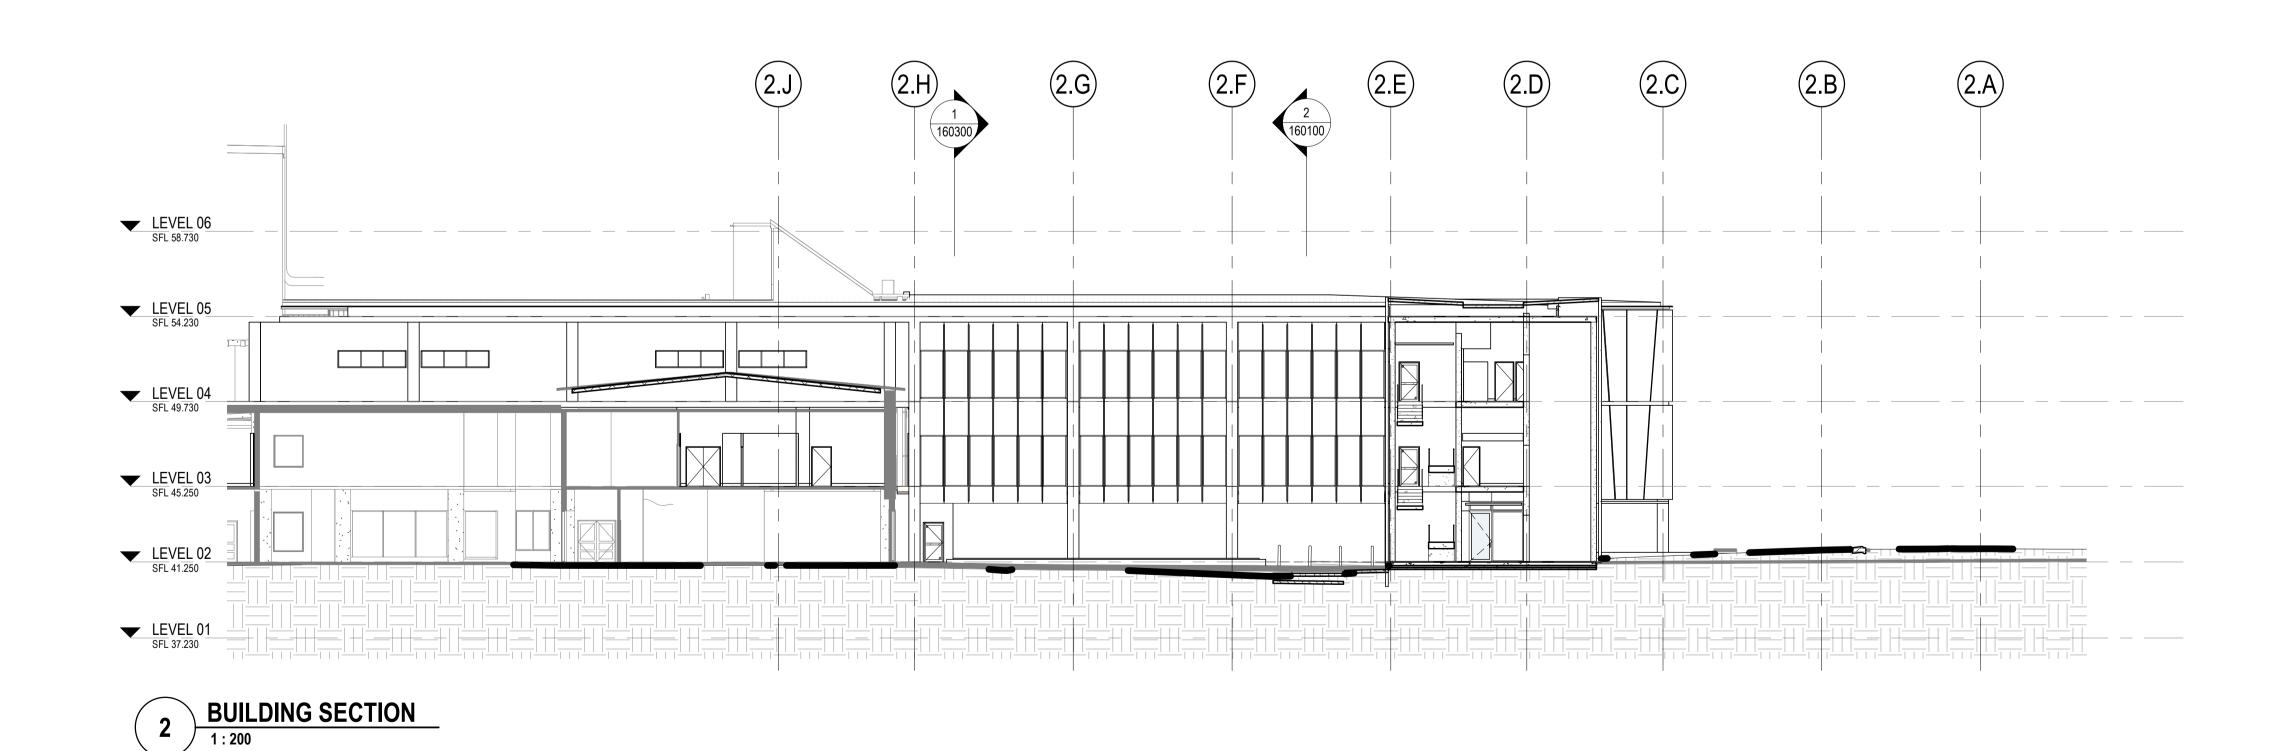

THE SUTHERLAND HOSPITAL OPERATING **BUILDING SECTIONS** 1 : 200 @ A1 13/11/20 Health
Infrastructure
Level 6 77 Pacific Highway, North Sydney, NSW 2060
P: +61 2 9978 5427 | F: +61 2 8904 1377
www.hinfra.health.nsw.gov.au PROJECT NUMBER DRAWING NUMBER ISSUE THEATRE UPGRADE 10192314 HDR-AR-DG-160300 3
 3
 DRAFT EIS ISSUE
 AB
 MT
 13/11/20


 2
 FOR 50% DD
 SJ
 DS
 30/09/20

 1
 SSD ISSUE
 HDR
 HDR
 05/08/20

 REV
 DESCRIPTION OF CHANGE
 CHECKED
 ISSUED
 DATE
 PROJECT STATUS KINGSWAY & KAREENA ROAD, Level 1, 110 Walker Street, North Sydney NSW 2060, Australia +61 2 9956 2666 | hdrinc.com S 2 FOR 50% DD THIS DOCUMENT IS THE COPYRIGHT OF HDR.
ALL INFORMATION ILLUSTRATED ON THIS DOCUMENT IS TO BE CHECKED AND VERIFIED ON SITE. IN THE
EVENT OF DISCREPANCIES REFER TO ARCHITECT PRIOR TO COMMENCEMENT OF THE WORK. DO NOT
SCALE DRAWINGS MANUALLY OR ELECTRONICALLY. CARINGBAH NSW 2229 SSDA HDR Pty. Limited ABN 76 158 075 220 trading as HDR

SCALE DRAWINGS MANUALLY OR ELECTRONICALLY.


BIM 360://10192314_Sutherland_Hospital_Operating_Theatre_Upgrade_2020/TSHOTUP_BUILDING.rvt

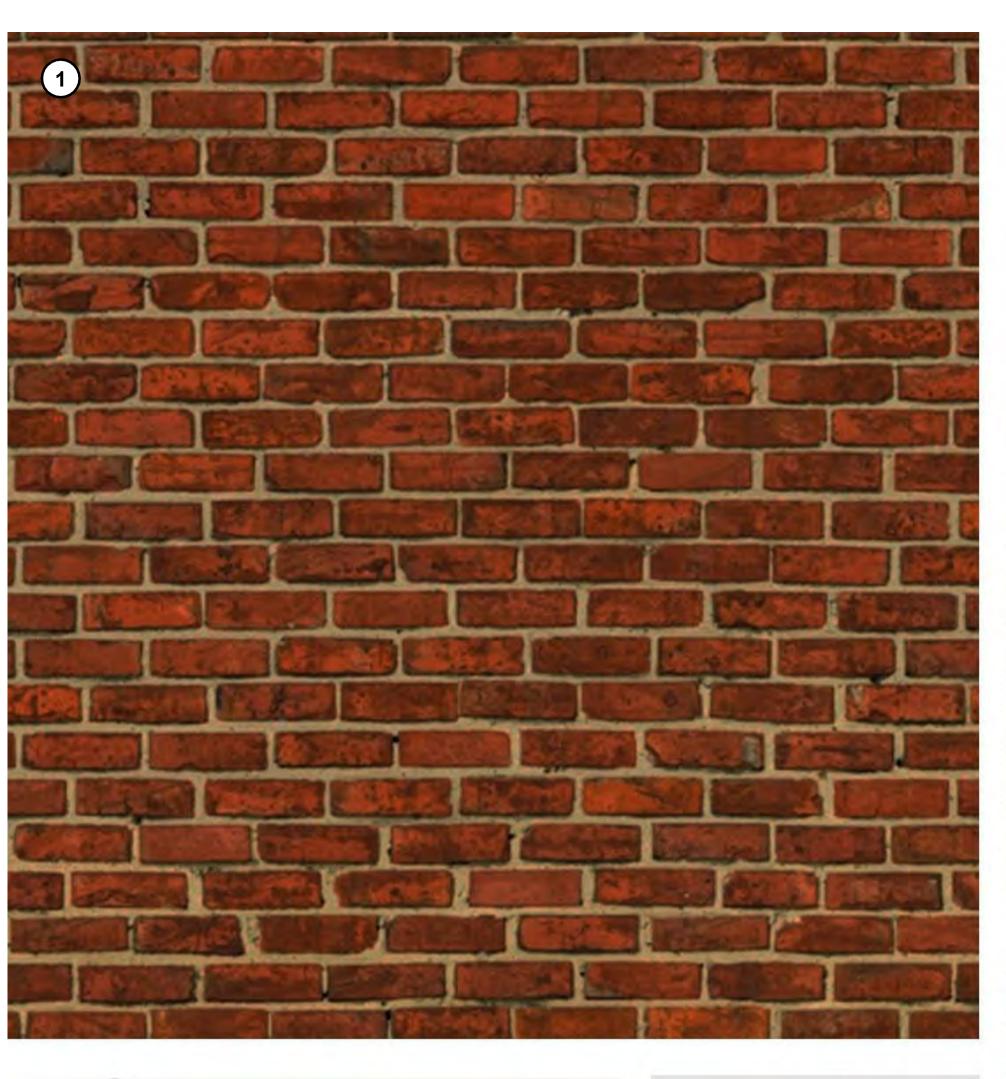










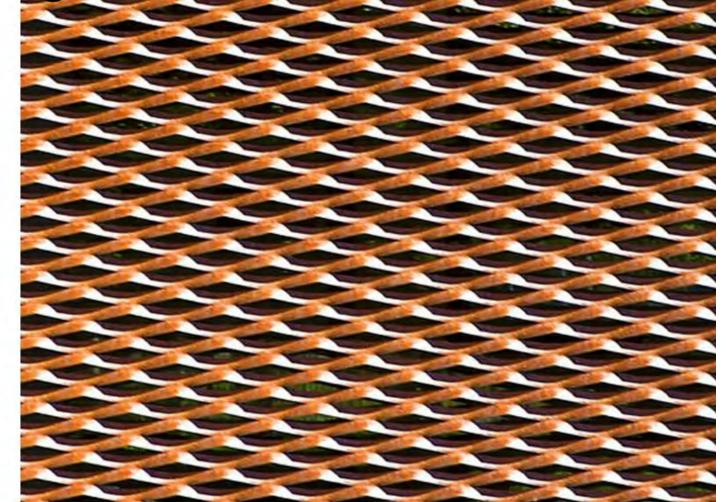

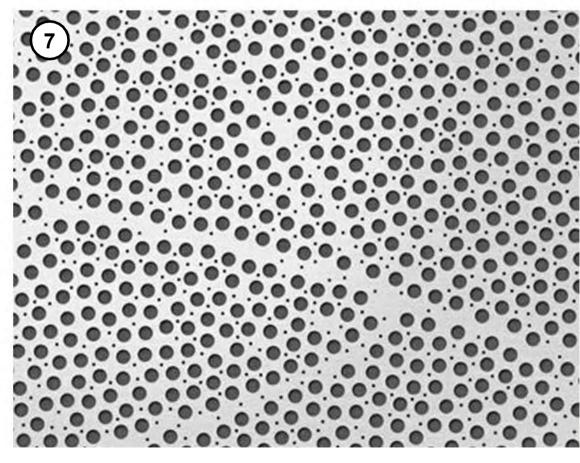

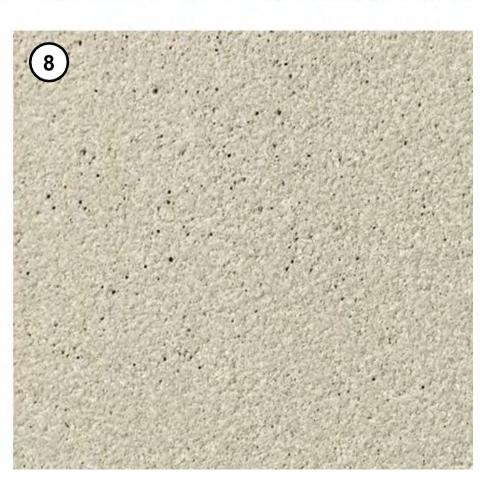

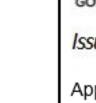

SSDA

Planning, Industry & Environment

LEGEND

BRICK TO MATCH EXISTING BRICK AS PER STAGE 1 WORKS

PROFILED METAL DECK ROOF COLORBOND KLIP-LOK COLOUR: SURFMIST

STAGE 2 WEATHERPROOF LOUVRES COLOUR SURF MIST

METAL MESH SCREEN
COLOUR RED OXIDE
INTEGRATED ART TO BE DEVELOPED WITH CLIENT AND ART
CONSULTANT DURING DESIGN DEVELOPMENT

UNCAPPED DGU CURTAIN WALL SYSTEM WITH PERFORATED SUN HADING EXTENDED OFF MULLIONS

ASYMMETRIC METAL PANEL RAINSCREEN CLADDING COLOUR - WHITE

REIDER OR SIMILAR PPROVED CONCRETE SKIN (13MM COMPRESSED FIBRE CEMENT PANELS)

7 PERFORATED METAL PANEL; COLOUR: WHITE

CLASS 2 CONCRETE - DARK GREY PIGMENT

GLAZED CANOPY WITH ACID ETCH FRIT

9 EXTRUDED STEEL CHANNEL

METAL MESH SCREEN COLOUR RED OXIDE

Issued under the Environmental Planning and Assessment Act 1979

Approved Application: SSD-11099584 Signed: NS

Granted on: 12 October 2021 Sheet: 8 of 53

DOOR 1 SSD ISSUE

AB MT 13/11/20
1 SSD ISSUE

AB MT 05/08/20

O 0 0 0

6

CLIENT

Health

Sovernment Infrastructure

Level 6 77 Pacific Highway, North Sydney, NSW 2060

P: +61 2 9978 5427 | F: +61 2 8904 1377

www.hinfra.health.nsw.gov.au

Level 1, 110 Walker Street, North Sydney NSW 2060, Australia +61 2 9956 2666 | hdrinc.com
HDR Pty. Limited ABN 76 158 075 220 trading as HDR


THE SUTHERLAND HOSPITAL OPERATING
THEATRE UPGRADE


KINGSWAY & KAREENA ROAD, CARINGBAH NSW 2229


DRAWING TITLE
MATERIALS - BUILDING FINISHES
AND COLOURS
PPO IECT STATUS


SCALE		DATE
1 : 200 @ A1		13/11/20
PROJECT NUMBER	DRAWING NUMBER	ISSUE
10192314	HDR-AR-DG-600100	2

THIS DOCUMENT IS THE COPYRIGHT OF HDR.
ALL INFORMATION LLUSTRATED ON THIS DOCUMENT IS TO BE CHECKED AND VERIFIED ON SITE. IN THE
EVENT OF DISCREPANCIES REFER TO ARCHITECT PRIOR TO COMMENCEMENT OF THE WORK. DO NOT
SCALE DRAWINGS MANUALLY OR ELECTRONICALLY.

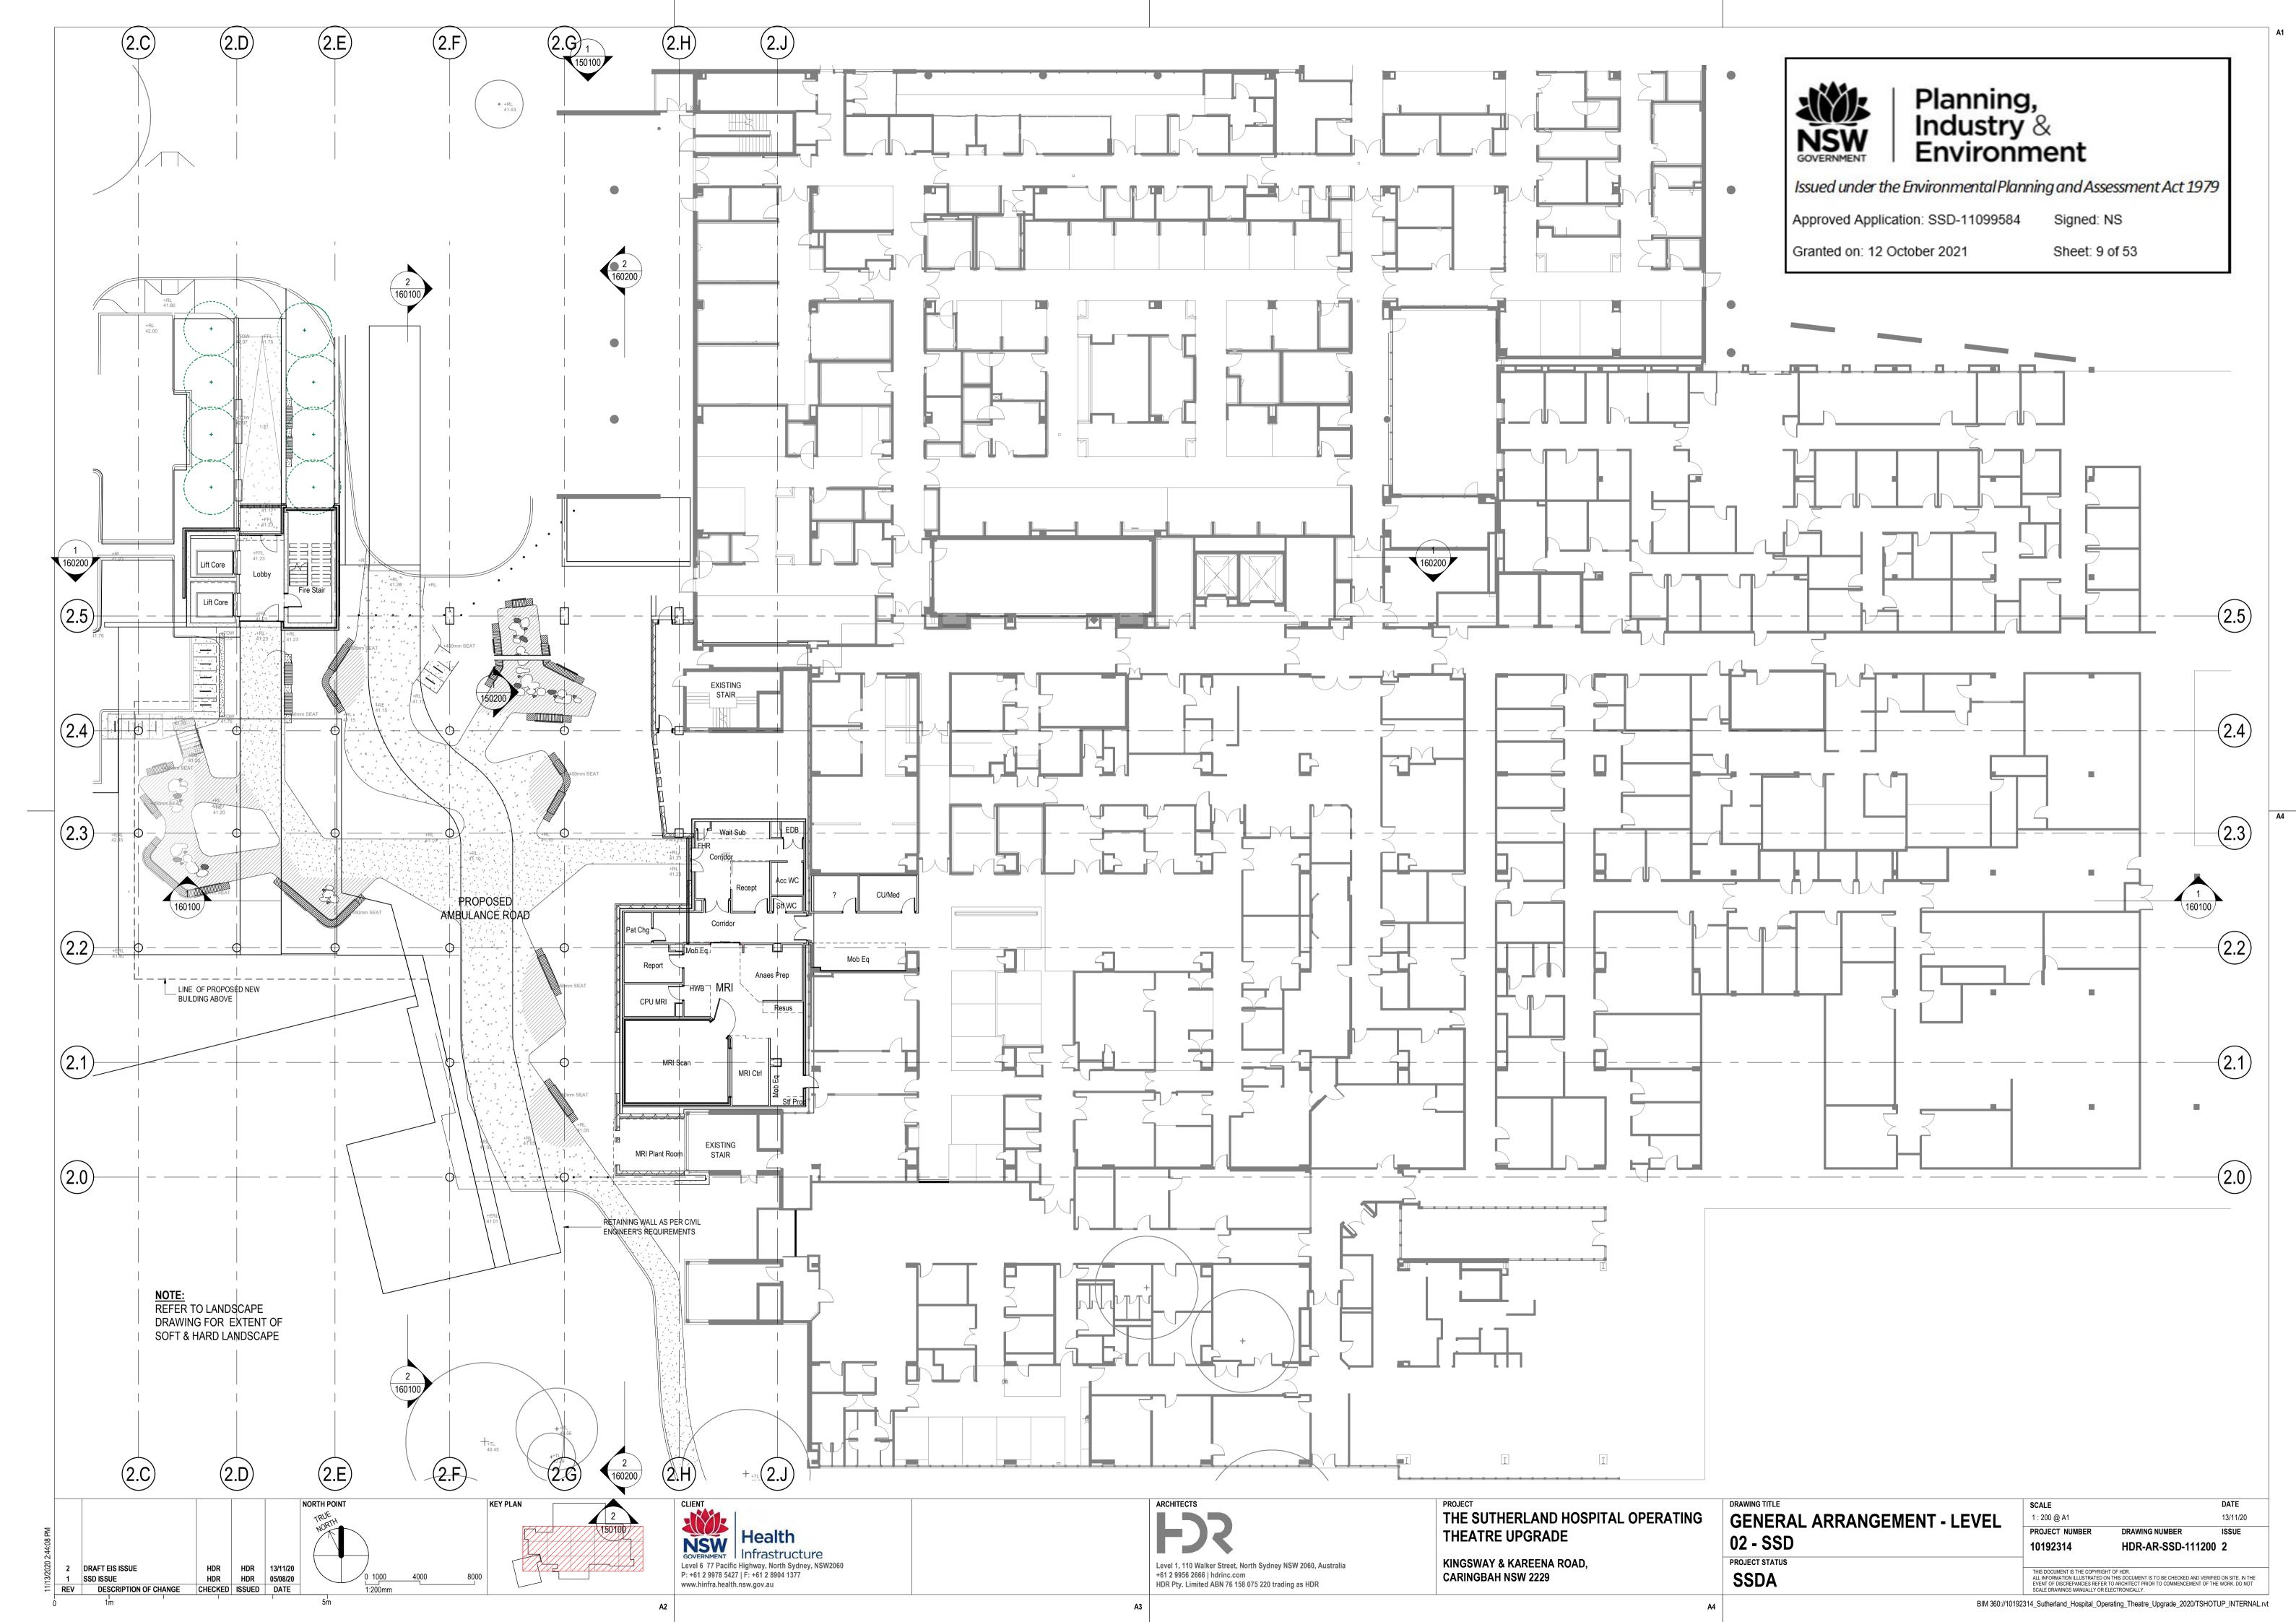

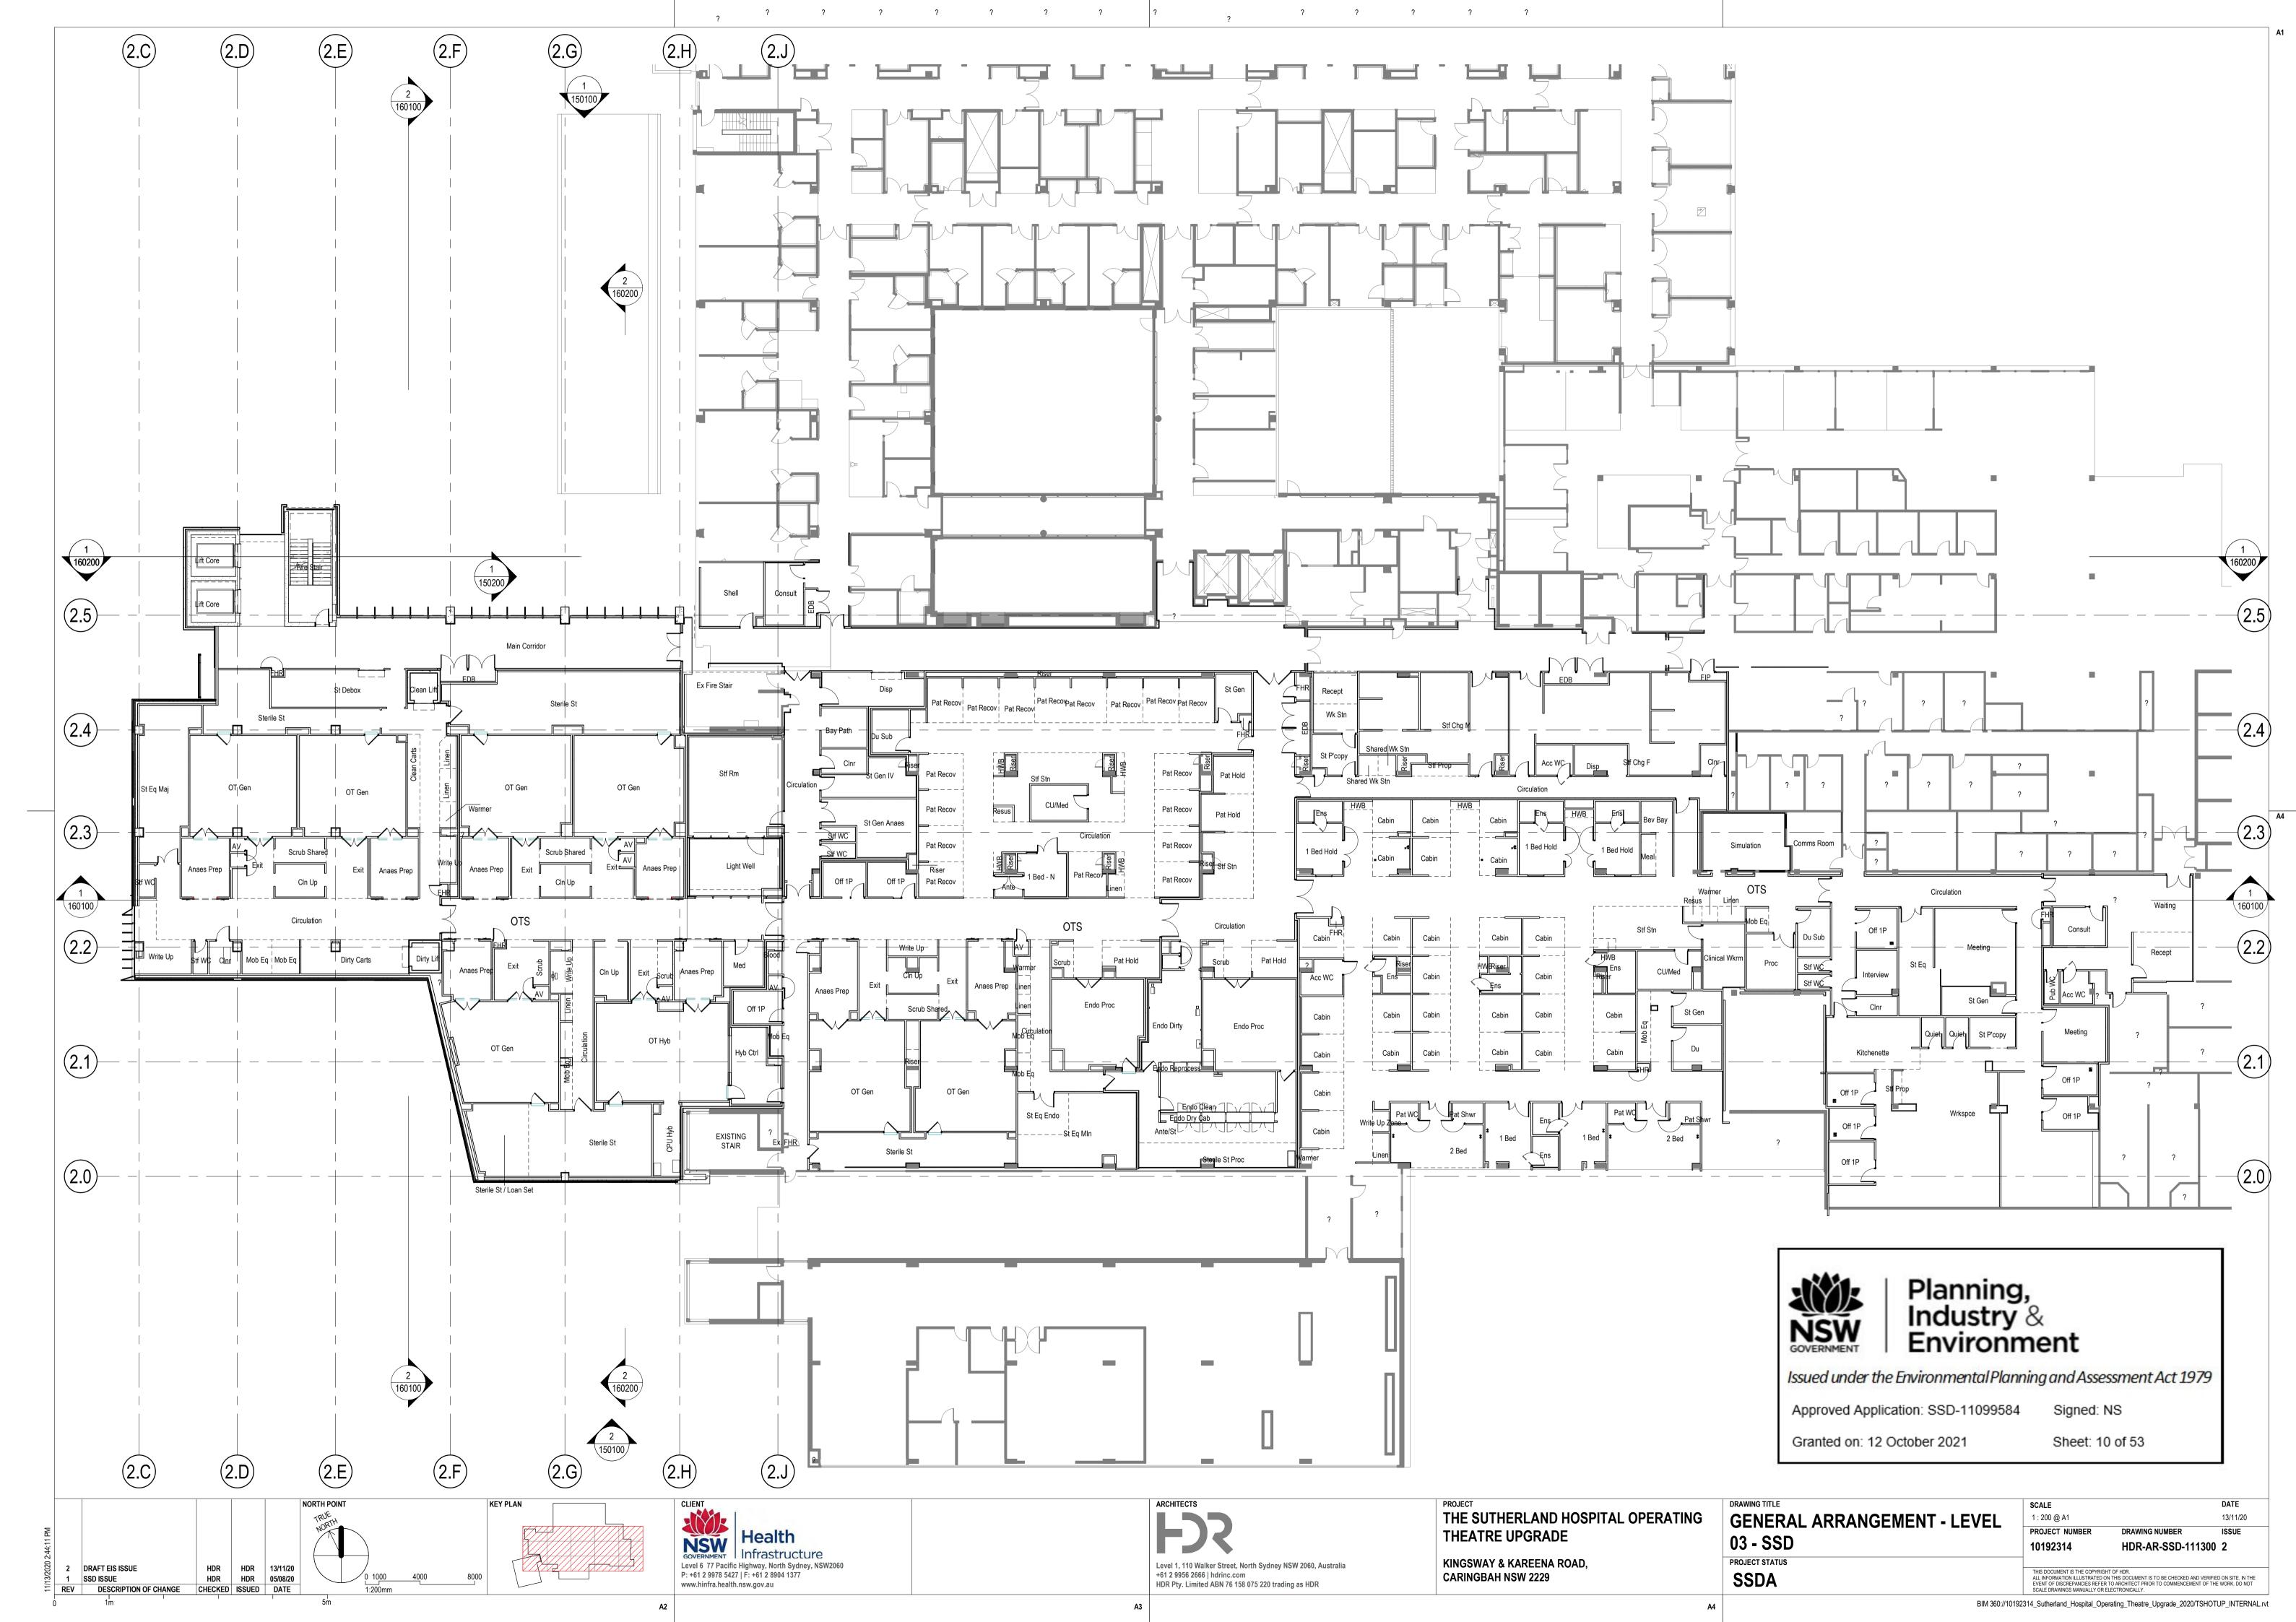

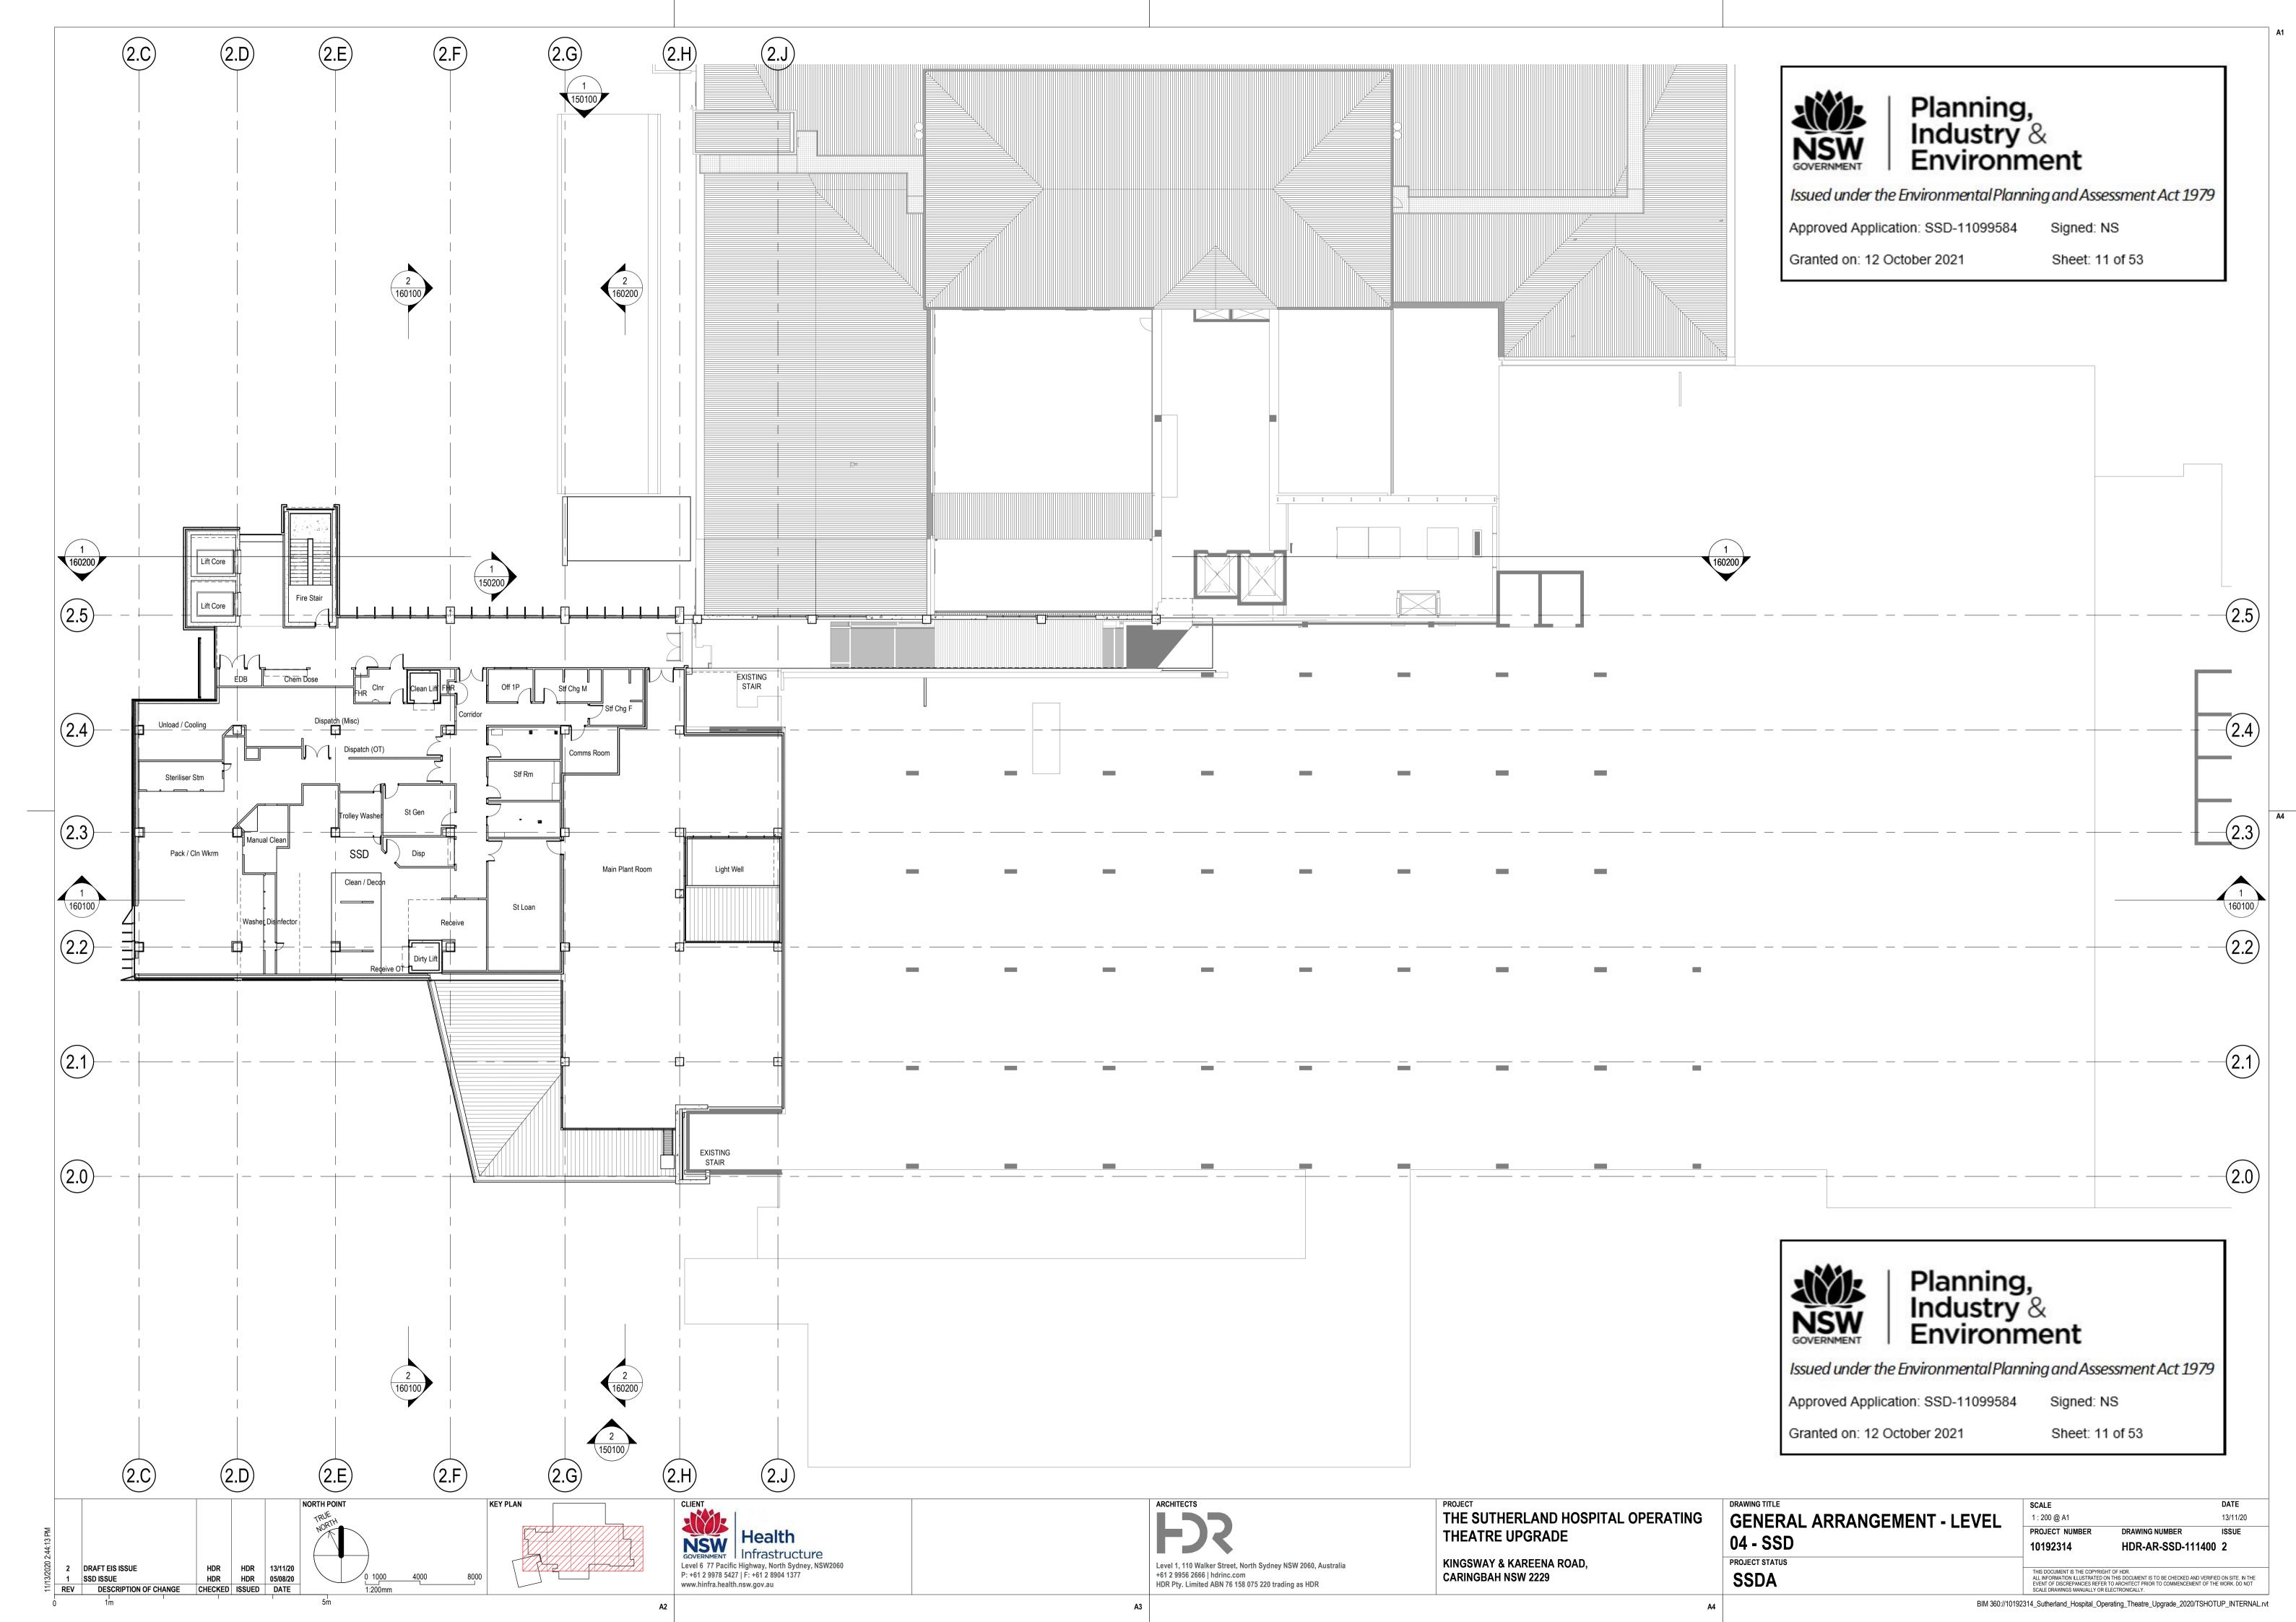

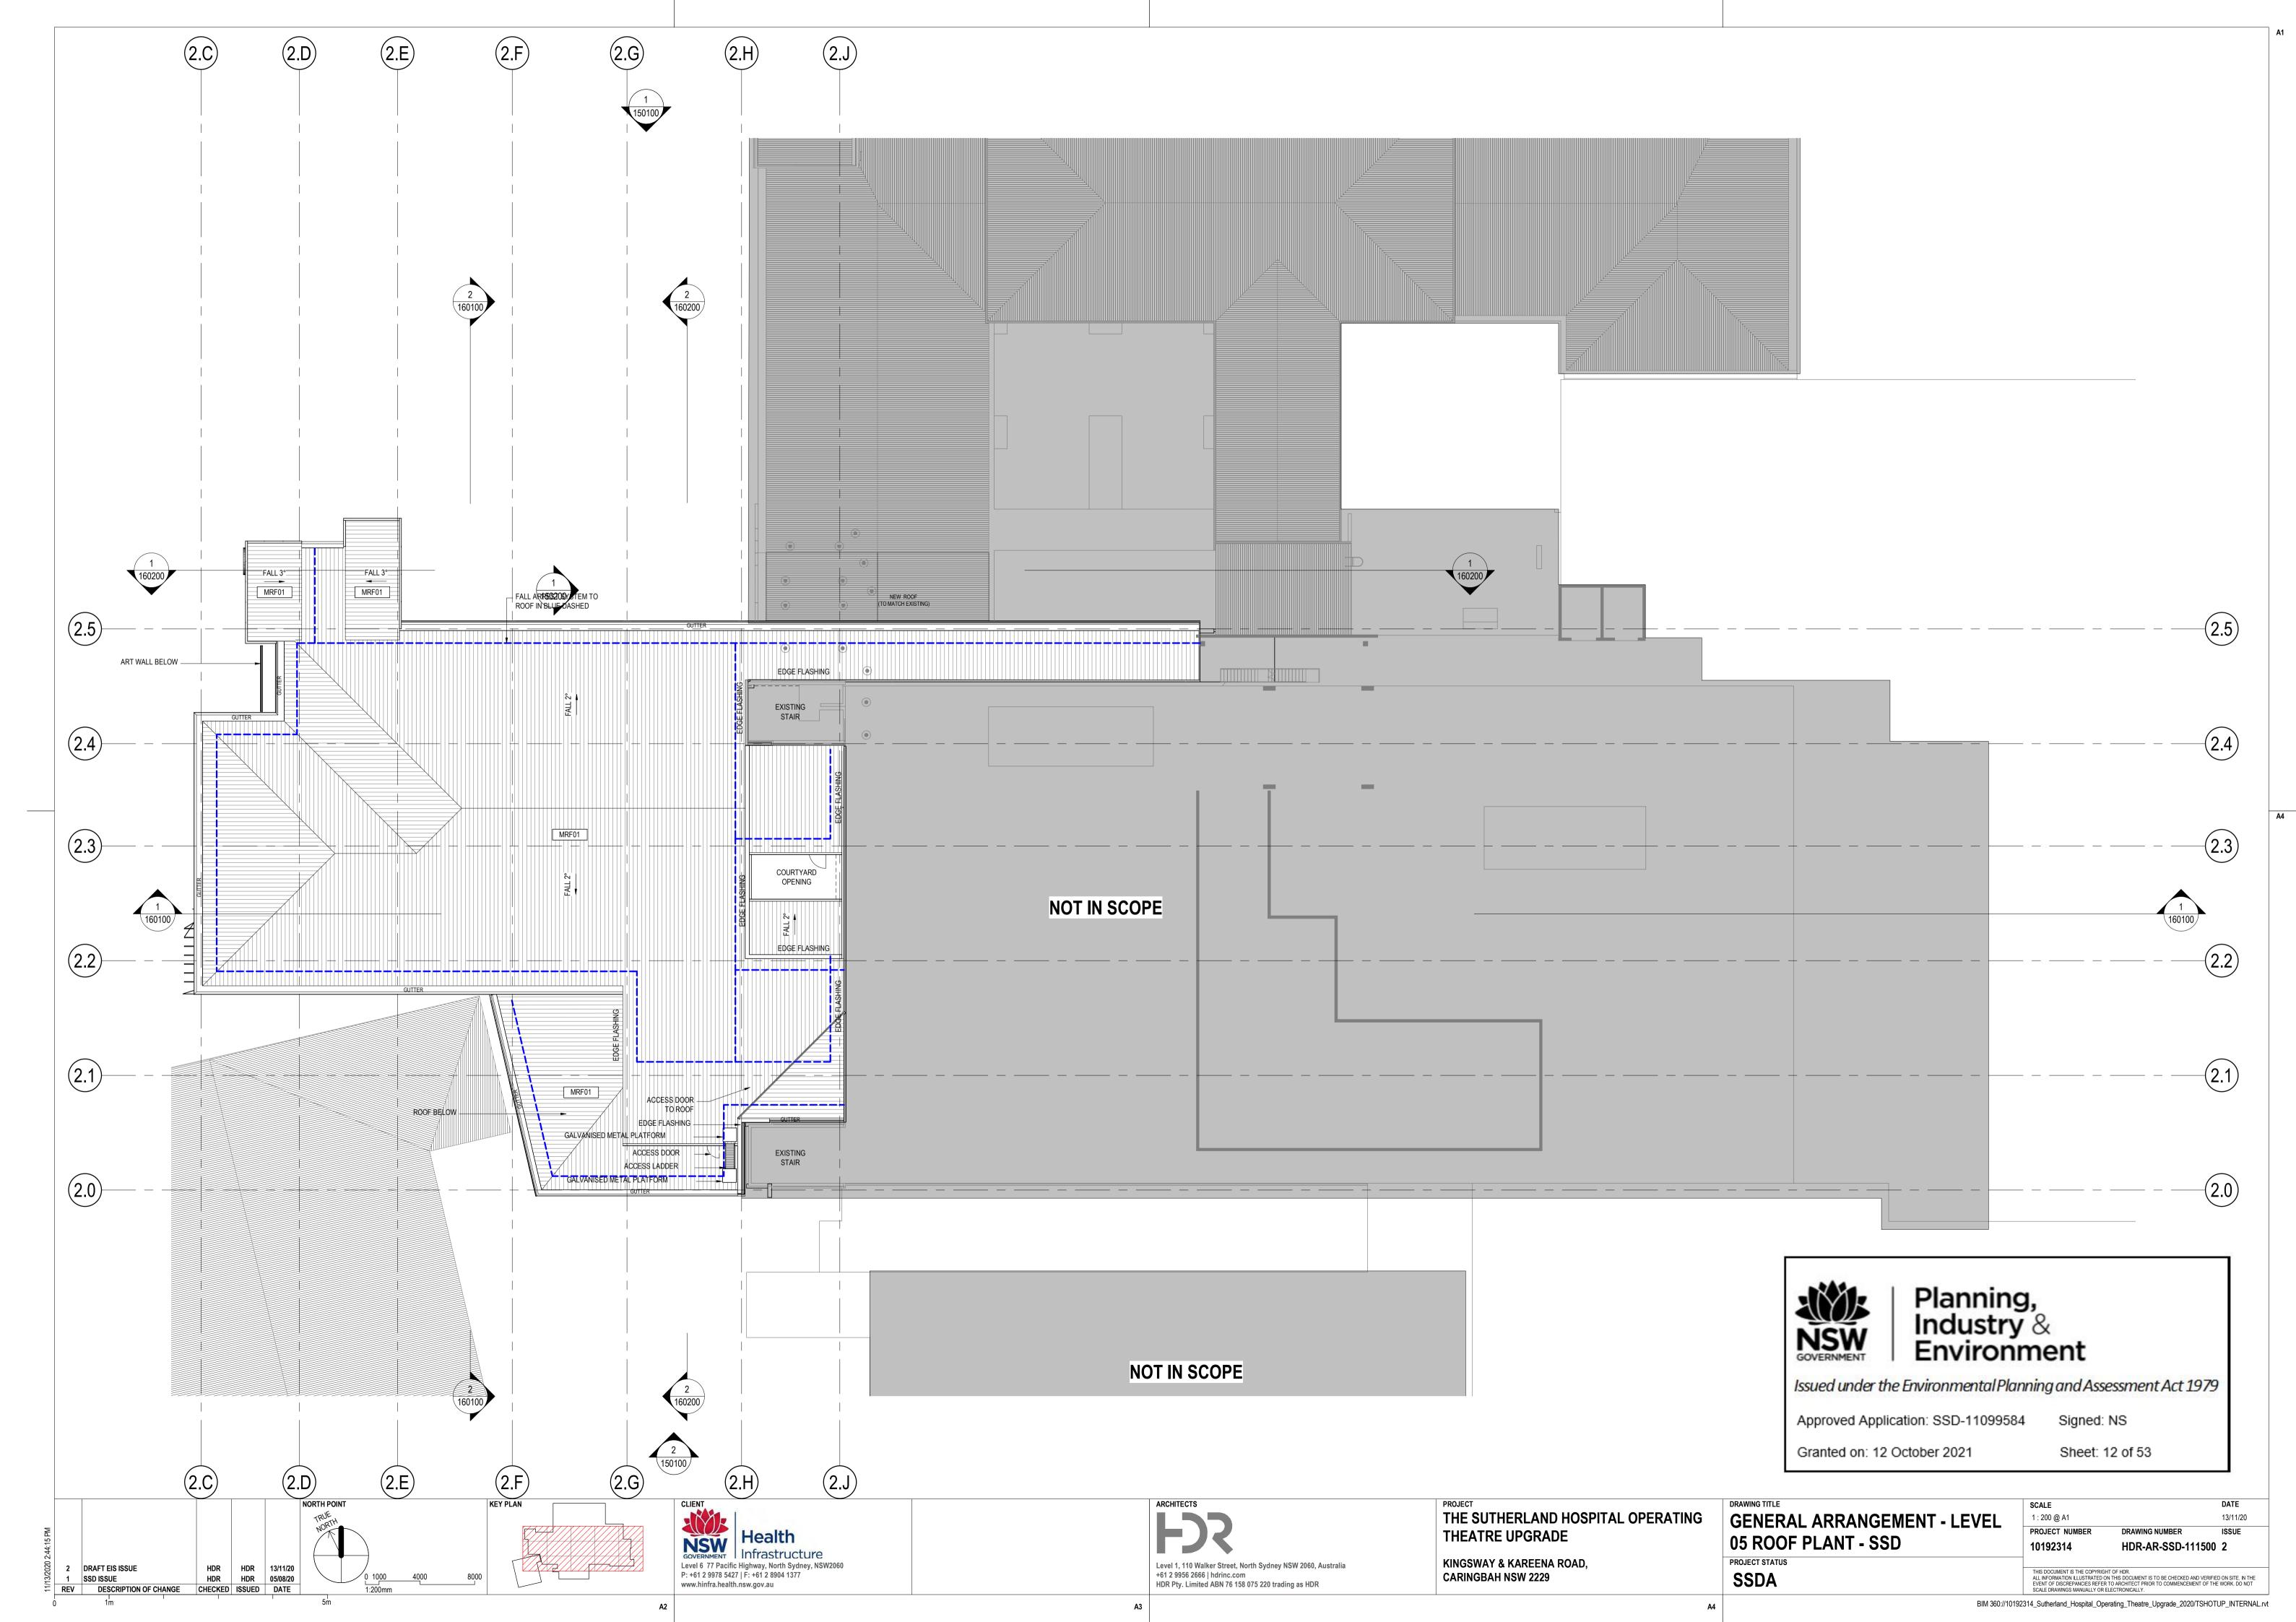

Issued under the Environmental Planning and Assessment Act 1979

WALL SYSTEM -

SOFFIT TO

UNDERCROFT TO

FACADE EDGE

Approved Application: SSD-11099584

Signed: NS

Granted on: 12 October 2021

Sheet: 13 of 53

UNCAPPED DGU CURTAIN WALL SYSTEM WITH PERFORATED SUN HADING EXTENDED OFF MULLIONS- ART WALL TO BE DEFINED WITH **CLIENT AND ART CONSULTANT DURING DESIGN DEVELOPMENT**

PANELISED CONCRETE SKIN TO LIFT CORE



BRICK BASE TO MATCH EXISTING BRICK FACADE FOR STAGE 1 WORKS-

-GLASS CANOPY FOR **NORTH ENTRY**

FOR LANDSCAPING PLEASE REFER TO LANDSCAPE SD **REPORT**



					NORTH POINT	KEY PLAN
					TRUE	
					NORTH	
						ZONE 01 ZONE 02 ZONE 03 ZONE 04 ZONE 05
						ZONE 06 ZONE 07 ZONE 08 ZONE 09 ZONE 10
						ZONE 11 ZONE 012 ZONE 13 ZONE 14 ZONE 15
2	DRAFT EIS ISSUE	AB	MT	13/11/20		
1	SSD ISSUE	HDR	HDR	05/08/20	0 0 0	
REV	DESCRIPTION OF CHANGE	CHECKED	ISSUED	DATE	1:0mm	



THE SUTHERLAND HOSPITAL OPERATING THEATRE UPGRADE KINGSWAY & KAREENA ROAD,

CARINGBAH NSW 2229

DRAWING TITLE	SCALE		DATE
INDICATIVE VIEW 01	1 : 1000 @ A1		13/11/20
INDIOATIVE VIEW OF	PROJECT NUMBER	DRAWING NUMBER	ISSUE
	10192314	HDR-AR-SSD-800101	2
PROJECT STATUS			
SSDA		ON THIS DOCUMENT IS TO BE CHECKED AND VERIFIE R TO ARCHITECT PRIOR TO COMMENCEMENT OF THE	

BIM 360://10192314_Sutherland_Hospital_Operating_Theatre_Upgrade_2020/TSHOTUP_BUILDING.rvt

Issued under the Environmental Planning and Assessment Act 1979

Approved Application: SSD-11099584

Signed: NS

Granted on: 12 October 2021

Sheet: 14 of 53

ART WALL TO BE DEFINED WITH CLIENT AND ART CONSULTANT **DURING DESIGN DEVELOPMENT**

FRAMED DGU CURTAIN **WALL SYSTEM**

PANELISED CONCRETE SKIN TO LIFT CORE

EXTRUDED MESH **COLOUR TO MATCH ART WALL**

-ASSYMETRIC METAL PANELISED SYSTEM

-UNCAPPED DGU CURTAIN WALL SYSTEM WITH PERFORATED SUN HADING EXTENDED OFF MULLIONS



FOR LANDSCAPING PLEASE REFER TO LANDSCAPE SD

REPORT

GLASS CANOPY FOR NORTH ENTRY

DARK GREY PIGMENT COLOUR TO BE USED FOR LEVEL 2 COLUMNS-

-EXTRUDED EXPOSED STEEL C SECTION

SOFFIT TO UNDERCROFT TO **EXTEND 1.2M FROM FACADE EDGE**

INDICATIVE VIEW FROM WEST

DRAFT EIS ISSUE

GOVERNMENT Infrastructure
Level 6 77 Pacific Highway, North Sydney, NSW 2060
P: +61 2 9978 5427 | F: +61 2 8904 1377
www.hinfra.health.nsw.gov.au

Level 1, 110 Walker Street, North Sydney NSW 2060, Australia +61 2 9956 2666 | hdrinc.com HDR Pty. Limited ABN 76 158 075 220 trading as HDR

THE SUTHERLAND HOSPITAL OPERATING THEATRE UPGRADE

KINGSWAY & KAREENA ROAD, CARINGBAH NSW 2229

DRAWING TITLE	SCALE		DATE
INDICATIVE VIEW 02	1 : 1000 @ A1		13/11/20
	PROJECT NUMBER	DRAWING NUMBER	ISSUE
	10192314	HDR-AR-SSD-800102	2
PROJECT STATUS			
SSDA		IN THIS DOCUMENT IS TO BE CHECKED AND VERIFIE TO ARCHITECT PRIOR TO COMMENCEMENT OF THE	

BIM 360://10192314_Sutherland_Hospital_Operating_Theatre_Upgrade_2020/TSHOTUP_BUILDING.rvt

DRAWING SCHEDULE

DRAWING NO.	DRAWING TITLE
000	COVER SHEET
100	LANDSCAPE MASTERPLAN
201 202 203 204 205	SETOUT AND GRADING- GROUND FLOOR
300 301 302 303 304 305	MATERIALS SCHEDULE HARDWORKS-GROUND FLOOR HARDWORKS-GROUND FLOOR HARDWORKS-GROUND FLOOR HARDWORKS-GROUND FLOOR HARDWORKS-GROUND FLOOR
400 401 402 403 404 405	PLANTING SCHEDULE PLANTING PLAN PLANTING PLAN PLANTING PLAN PLANTING PLAN PLANTING PLAN
501 502	SECTIONS SECTIONS
600 620 630 631 650	LANDSCAPE DETAILS LANDSCAPE DETAILS LANDSCAPE DETAILS LANDSCAPE DETAILS LANDSCAPE DETAILS
L-SP001	LANDSCAPE SPECIFICATION




Approved Application: SSD-11099584

Signed: NS

Granted on: 12 October 2021 Sheet: 15 of 53


LOCATION PLAN


SCALE: NTS

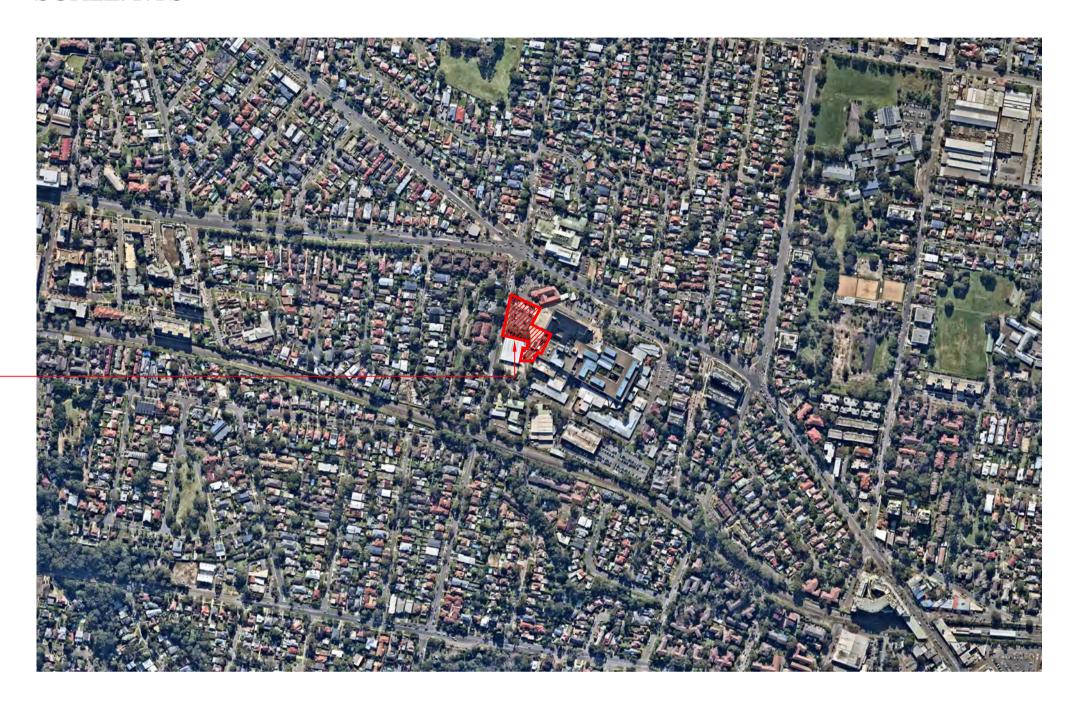

KEY PLAN

LANDSCAPE MASTERPLAN

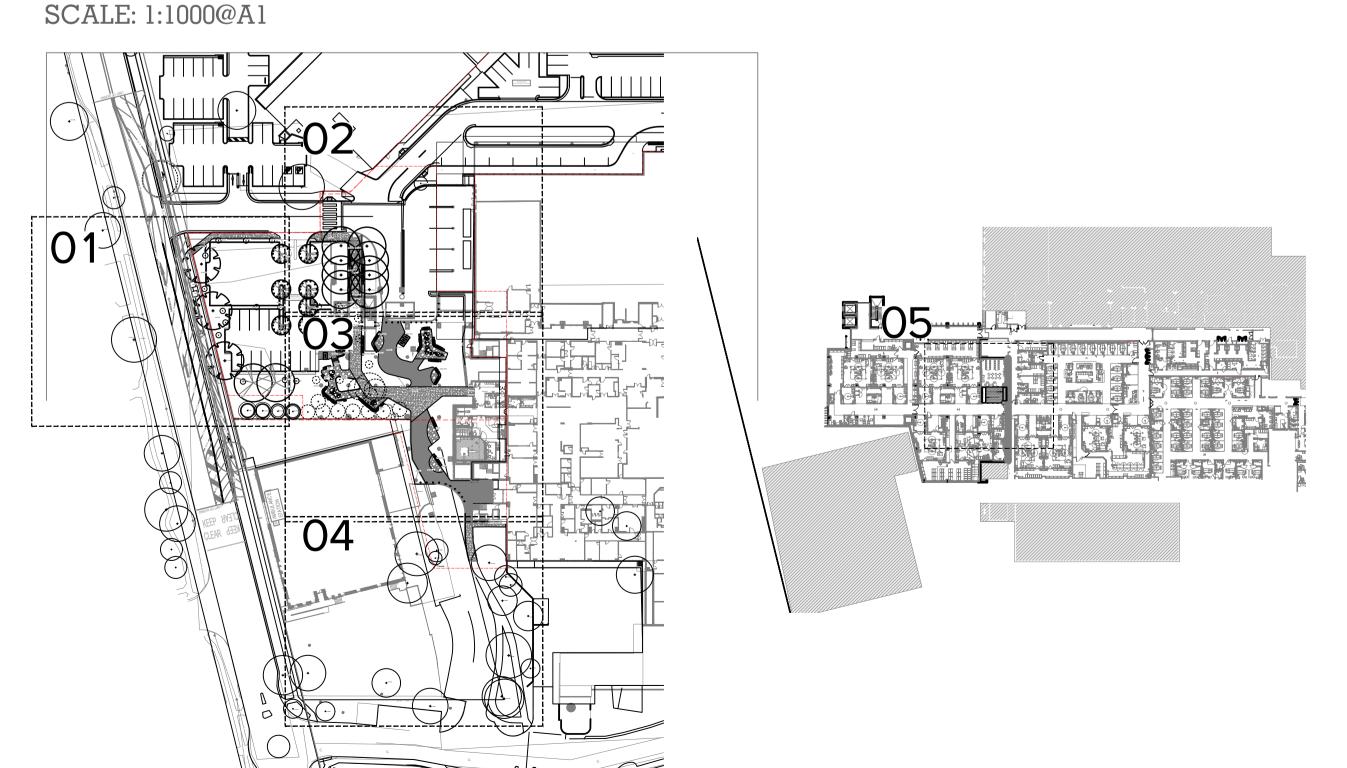

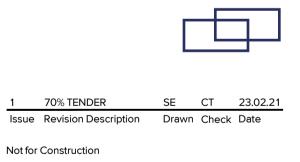

Sutherland Hospital

Kingsway & Kareena Rd Caringbah NSW 2229


Tender



Drawing Name Coversheet

Sydney, Suite 76, Jones Bay Wharf, 26-32 Pirrama Road, Pyrmont NSW 2009 Brisbane QLD 4000 E sydney@arcadiala.com.au T 02 8571 2900 E brisbane@arcadiala.com.au T 07 3071 8000



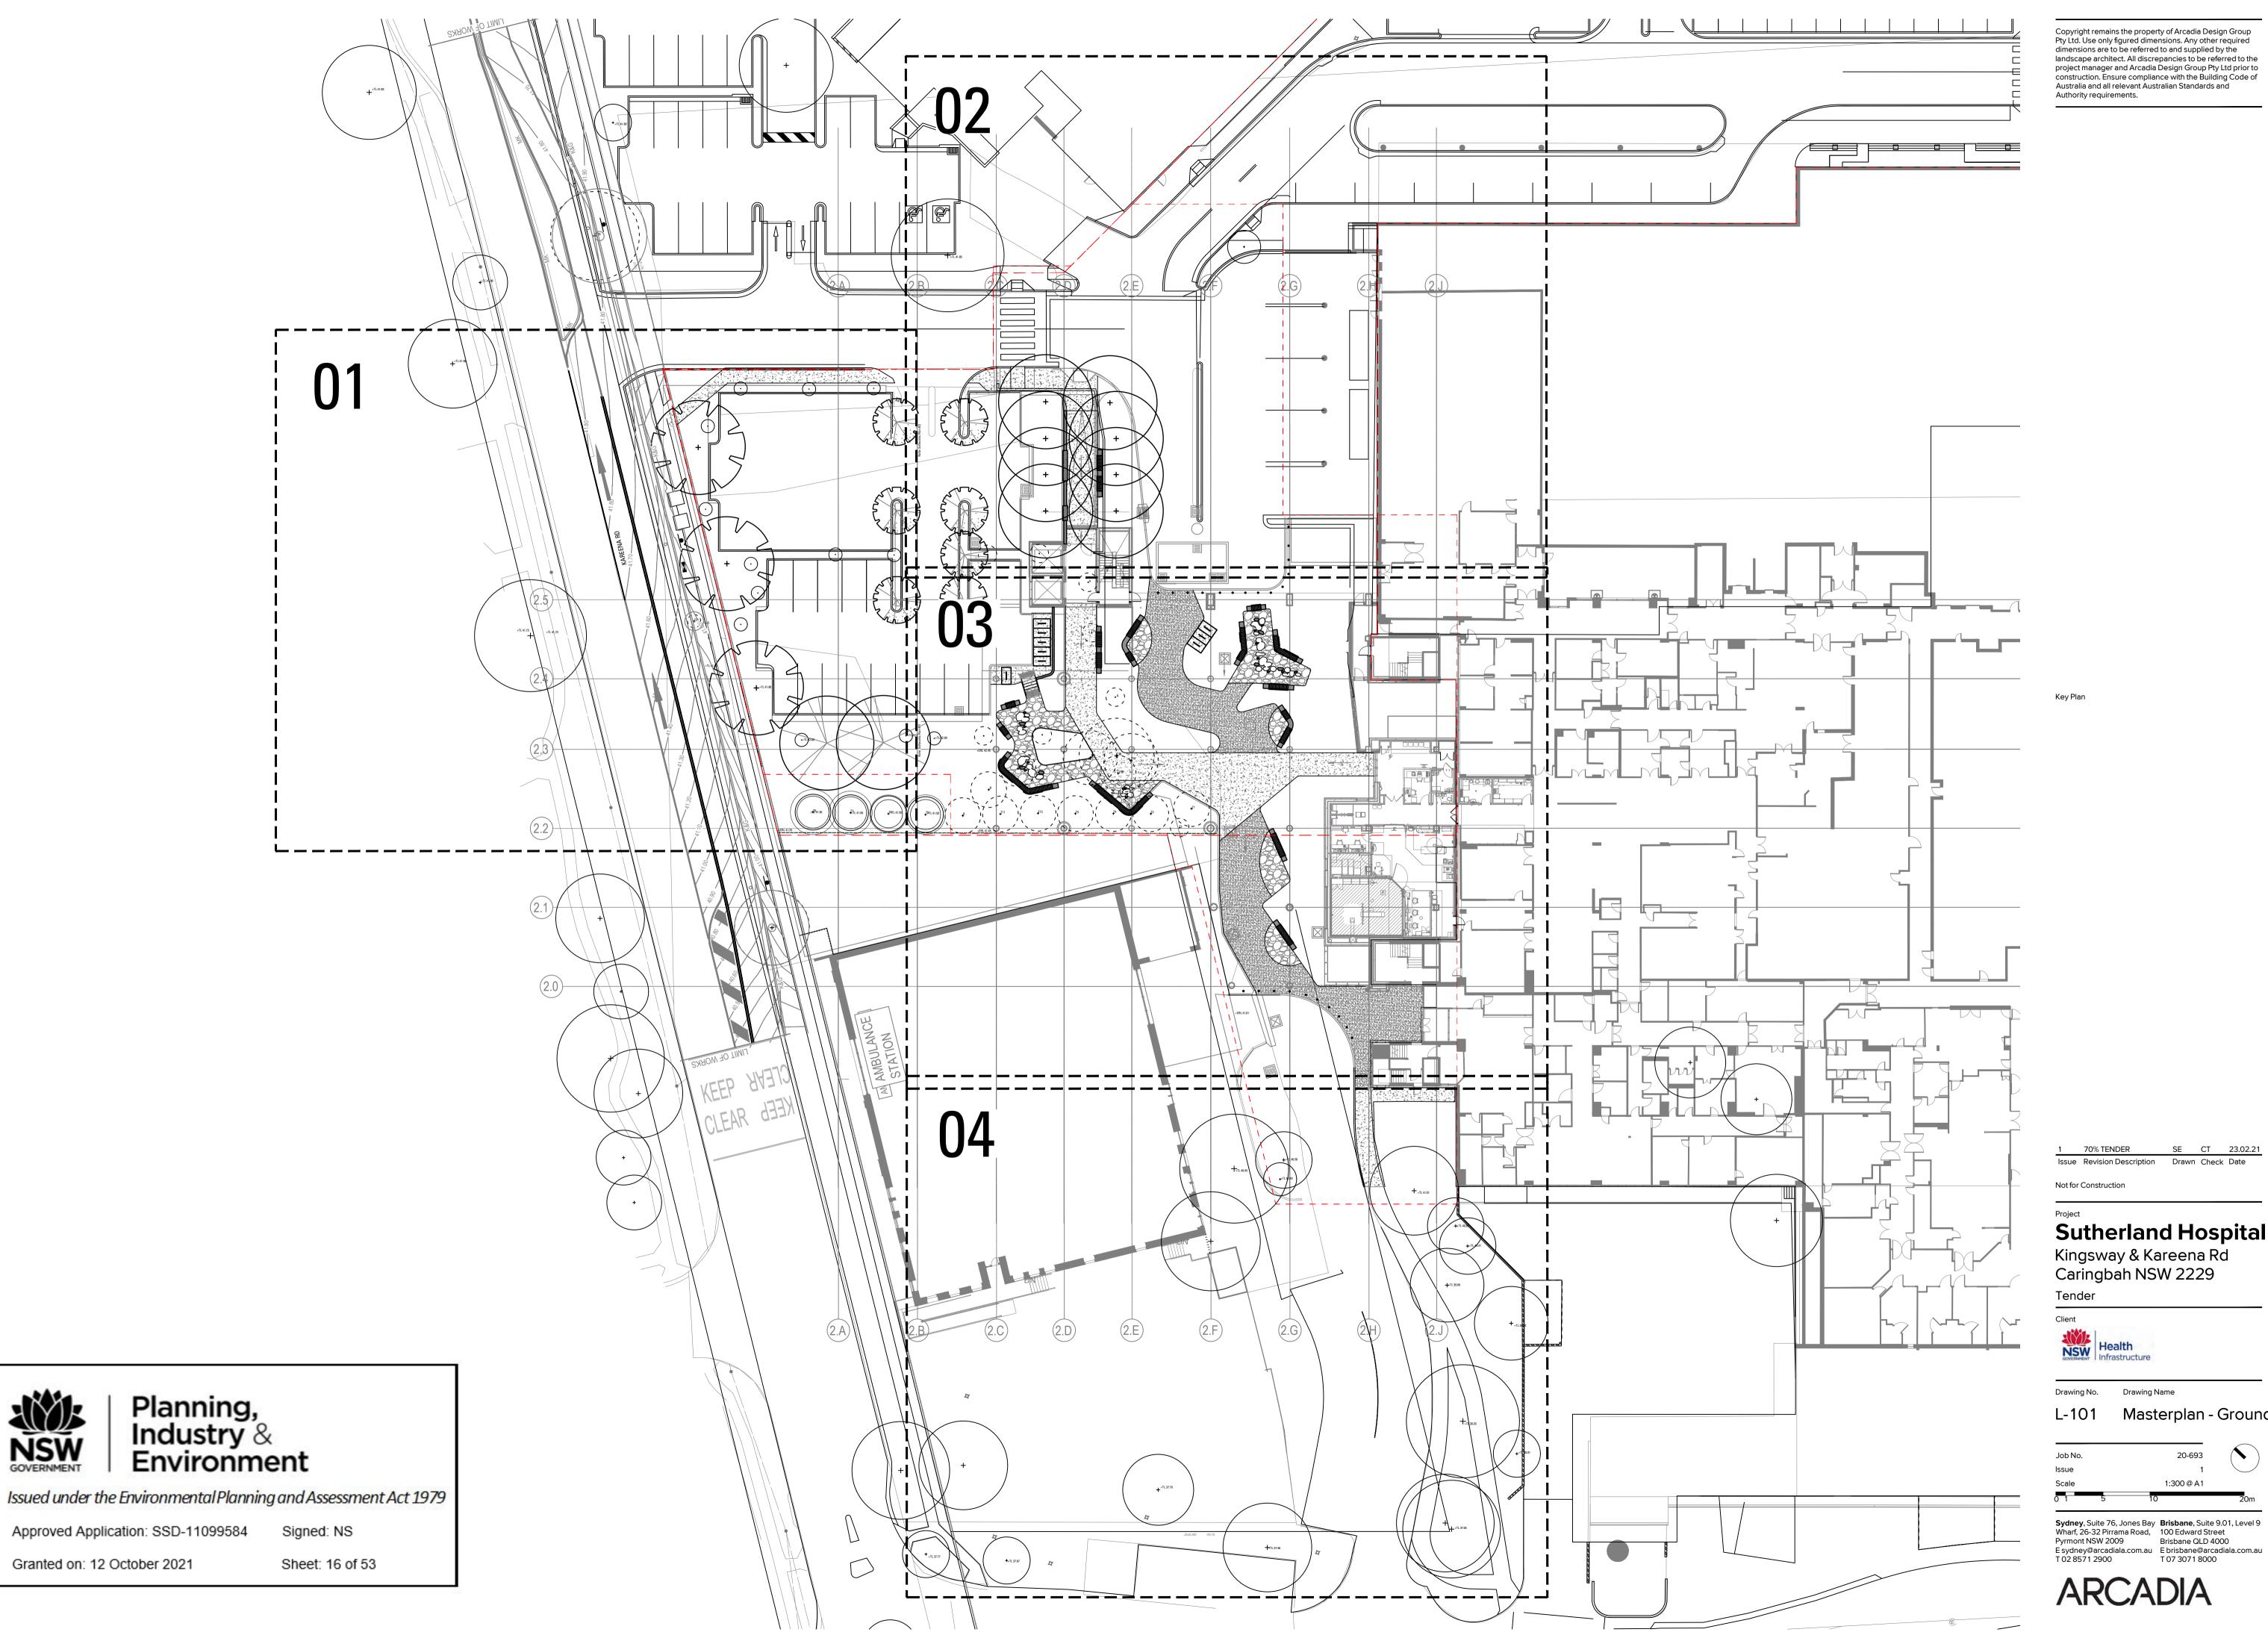


Issue Revision Description Drawn Check Date


Sutherland Hospital Kingsway & Kareena Rd Caringbah NSW 2229

Drawing Name

Masterplan - Ground

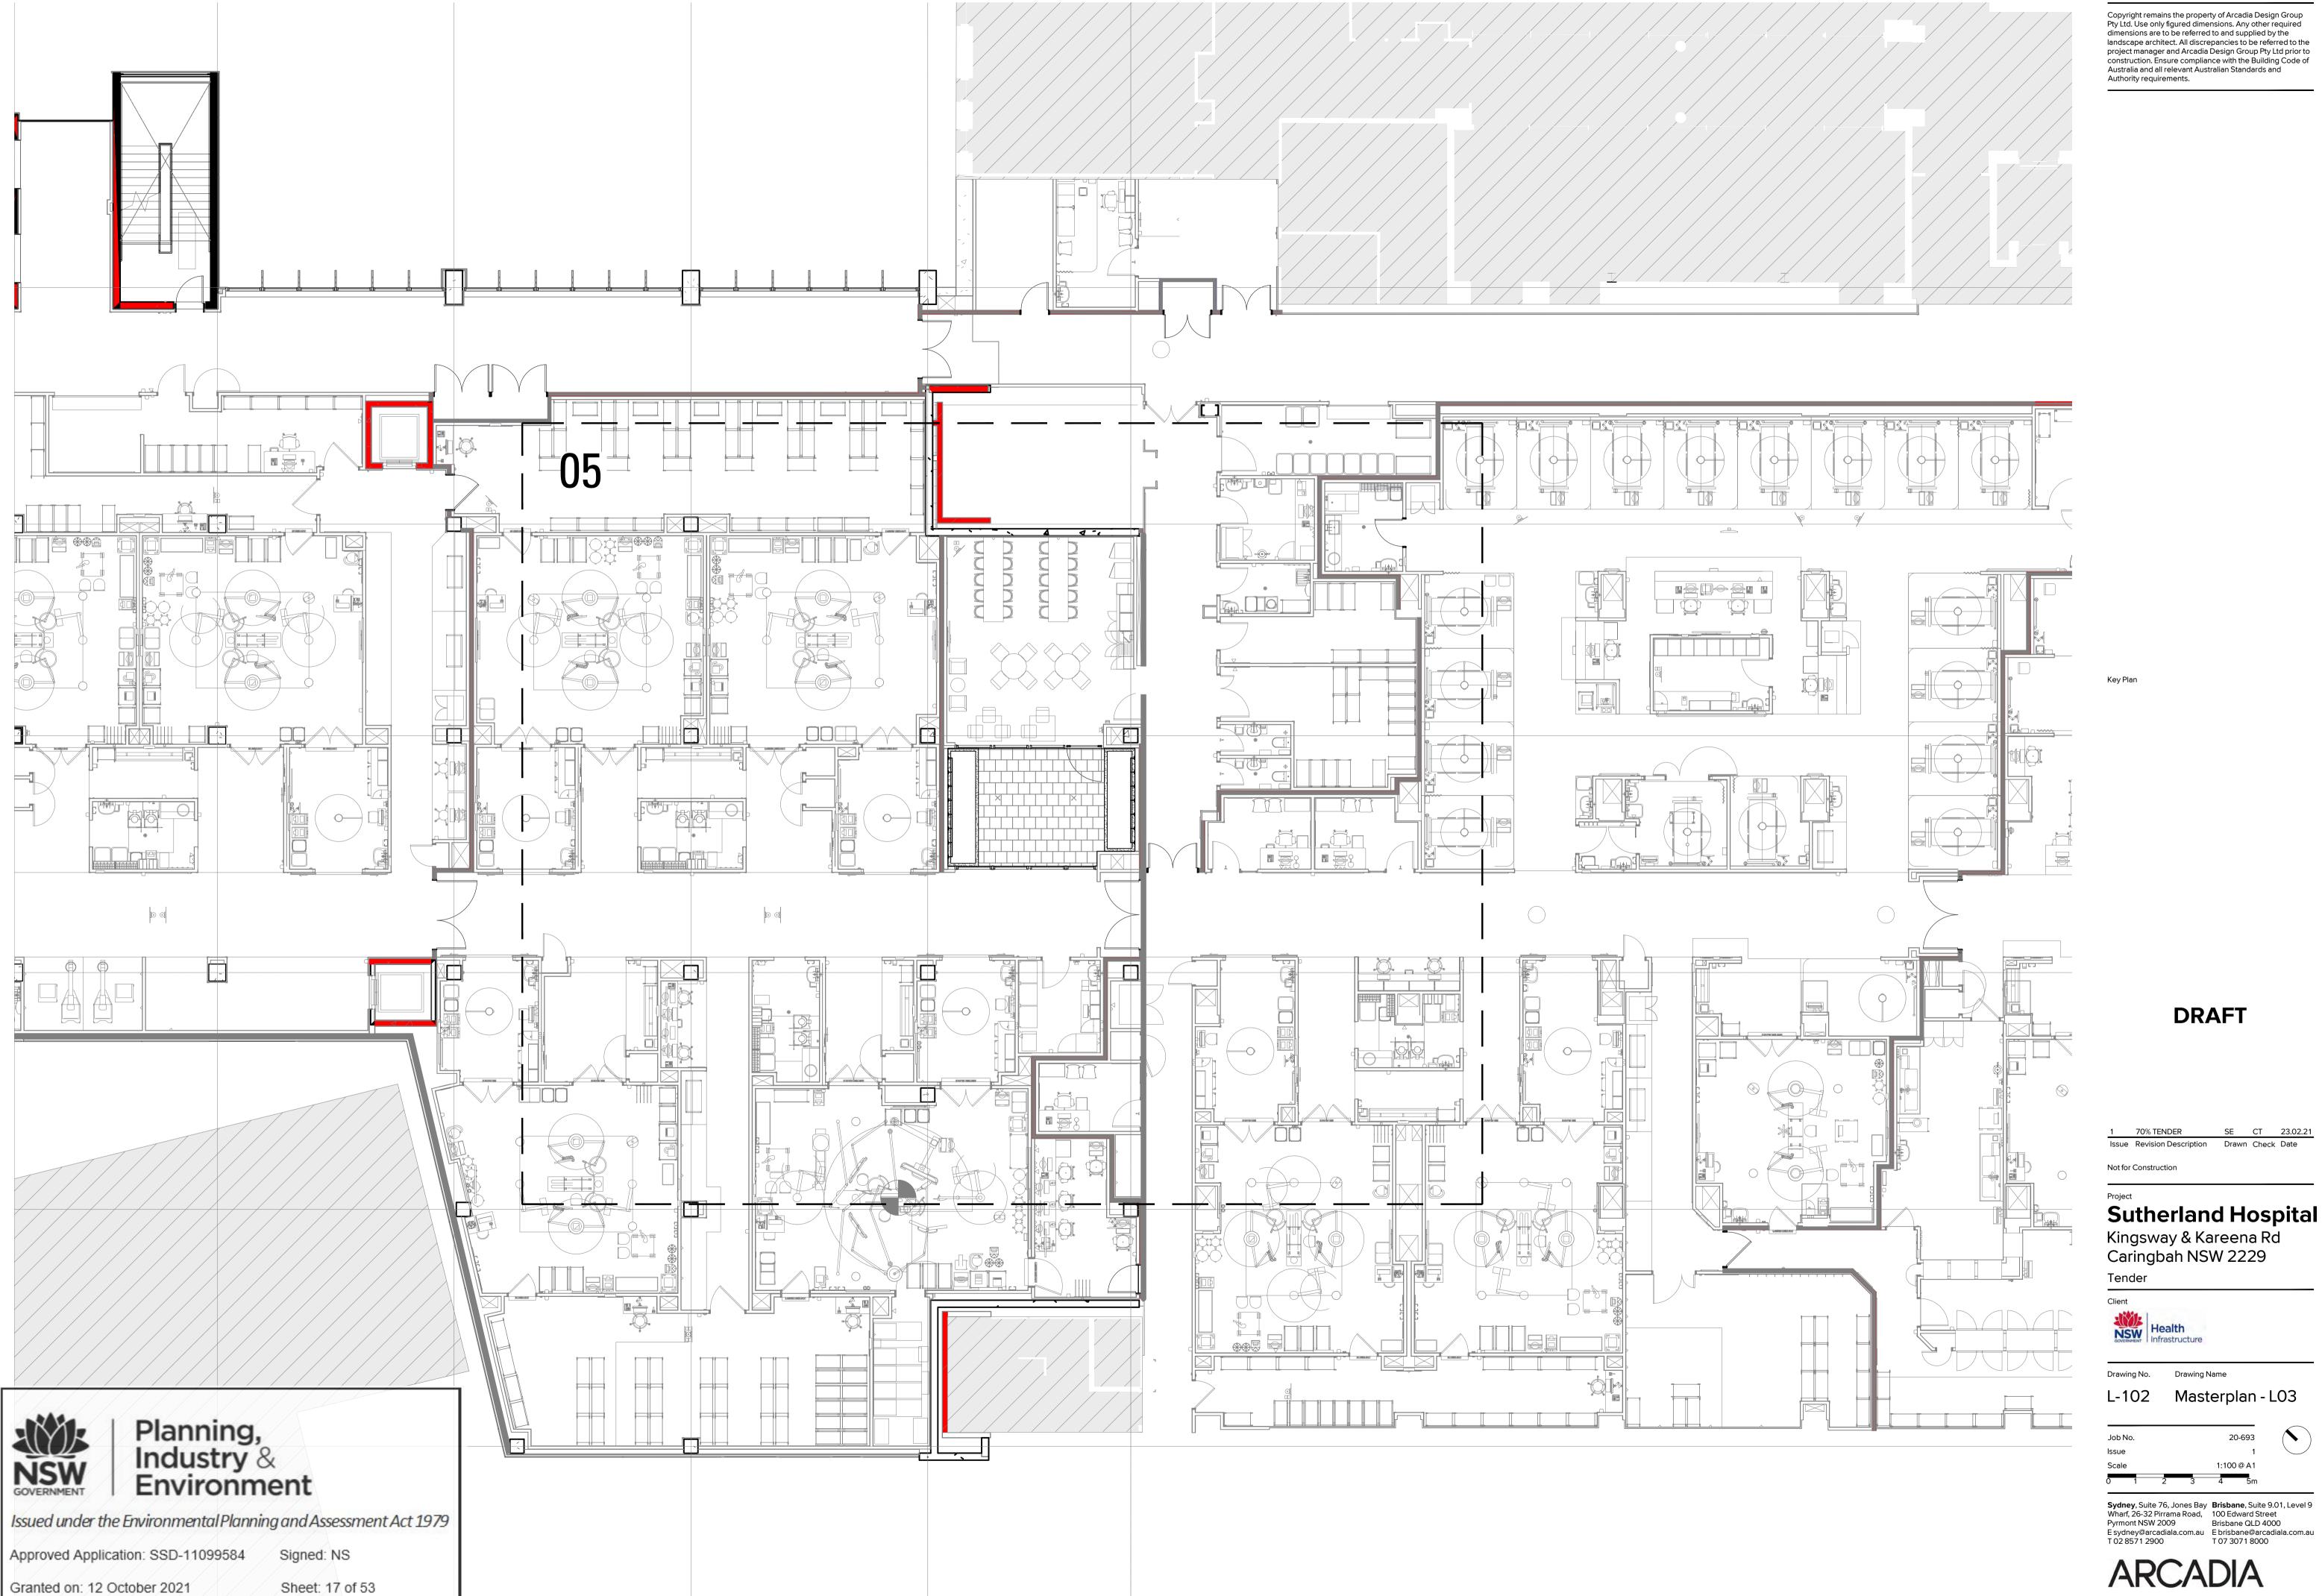

Sutherland Hospital

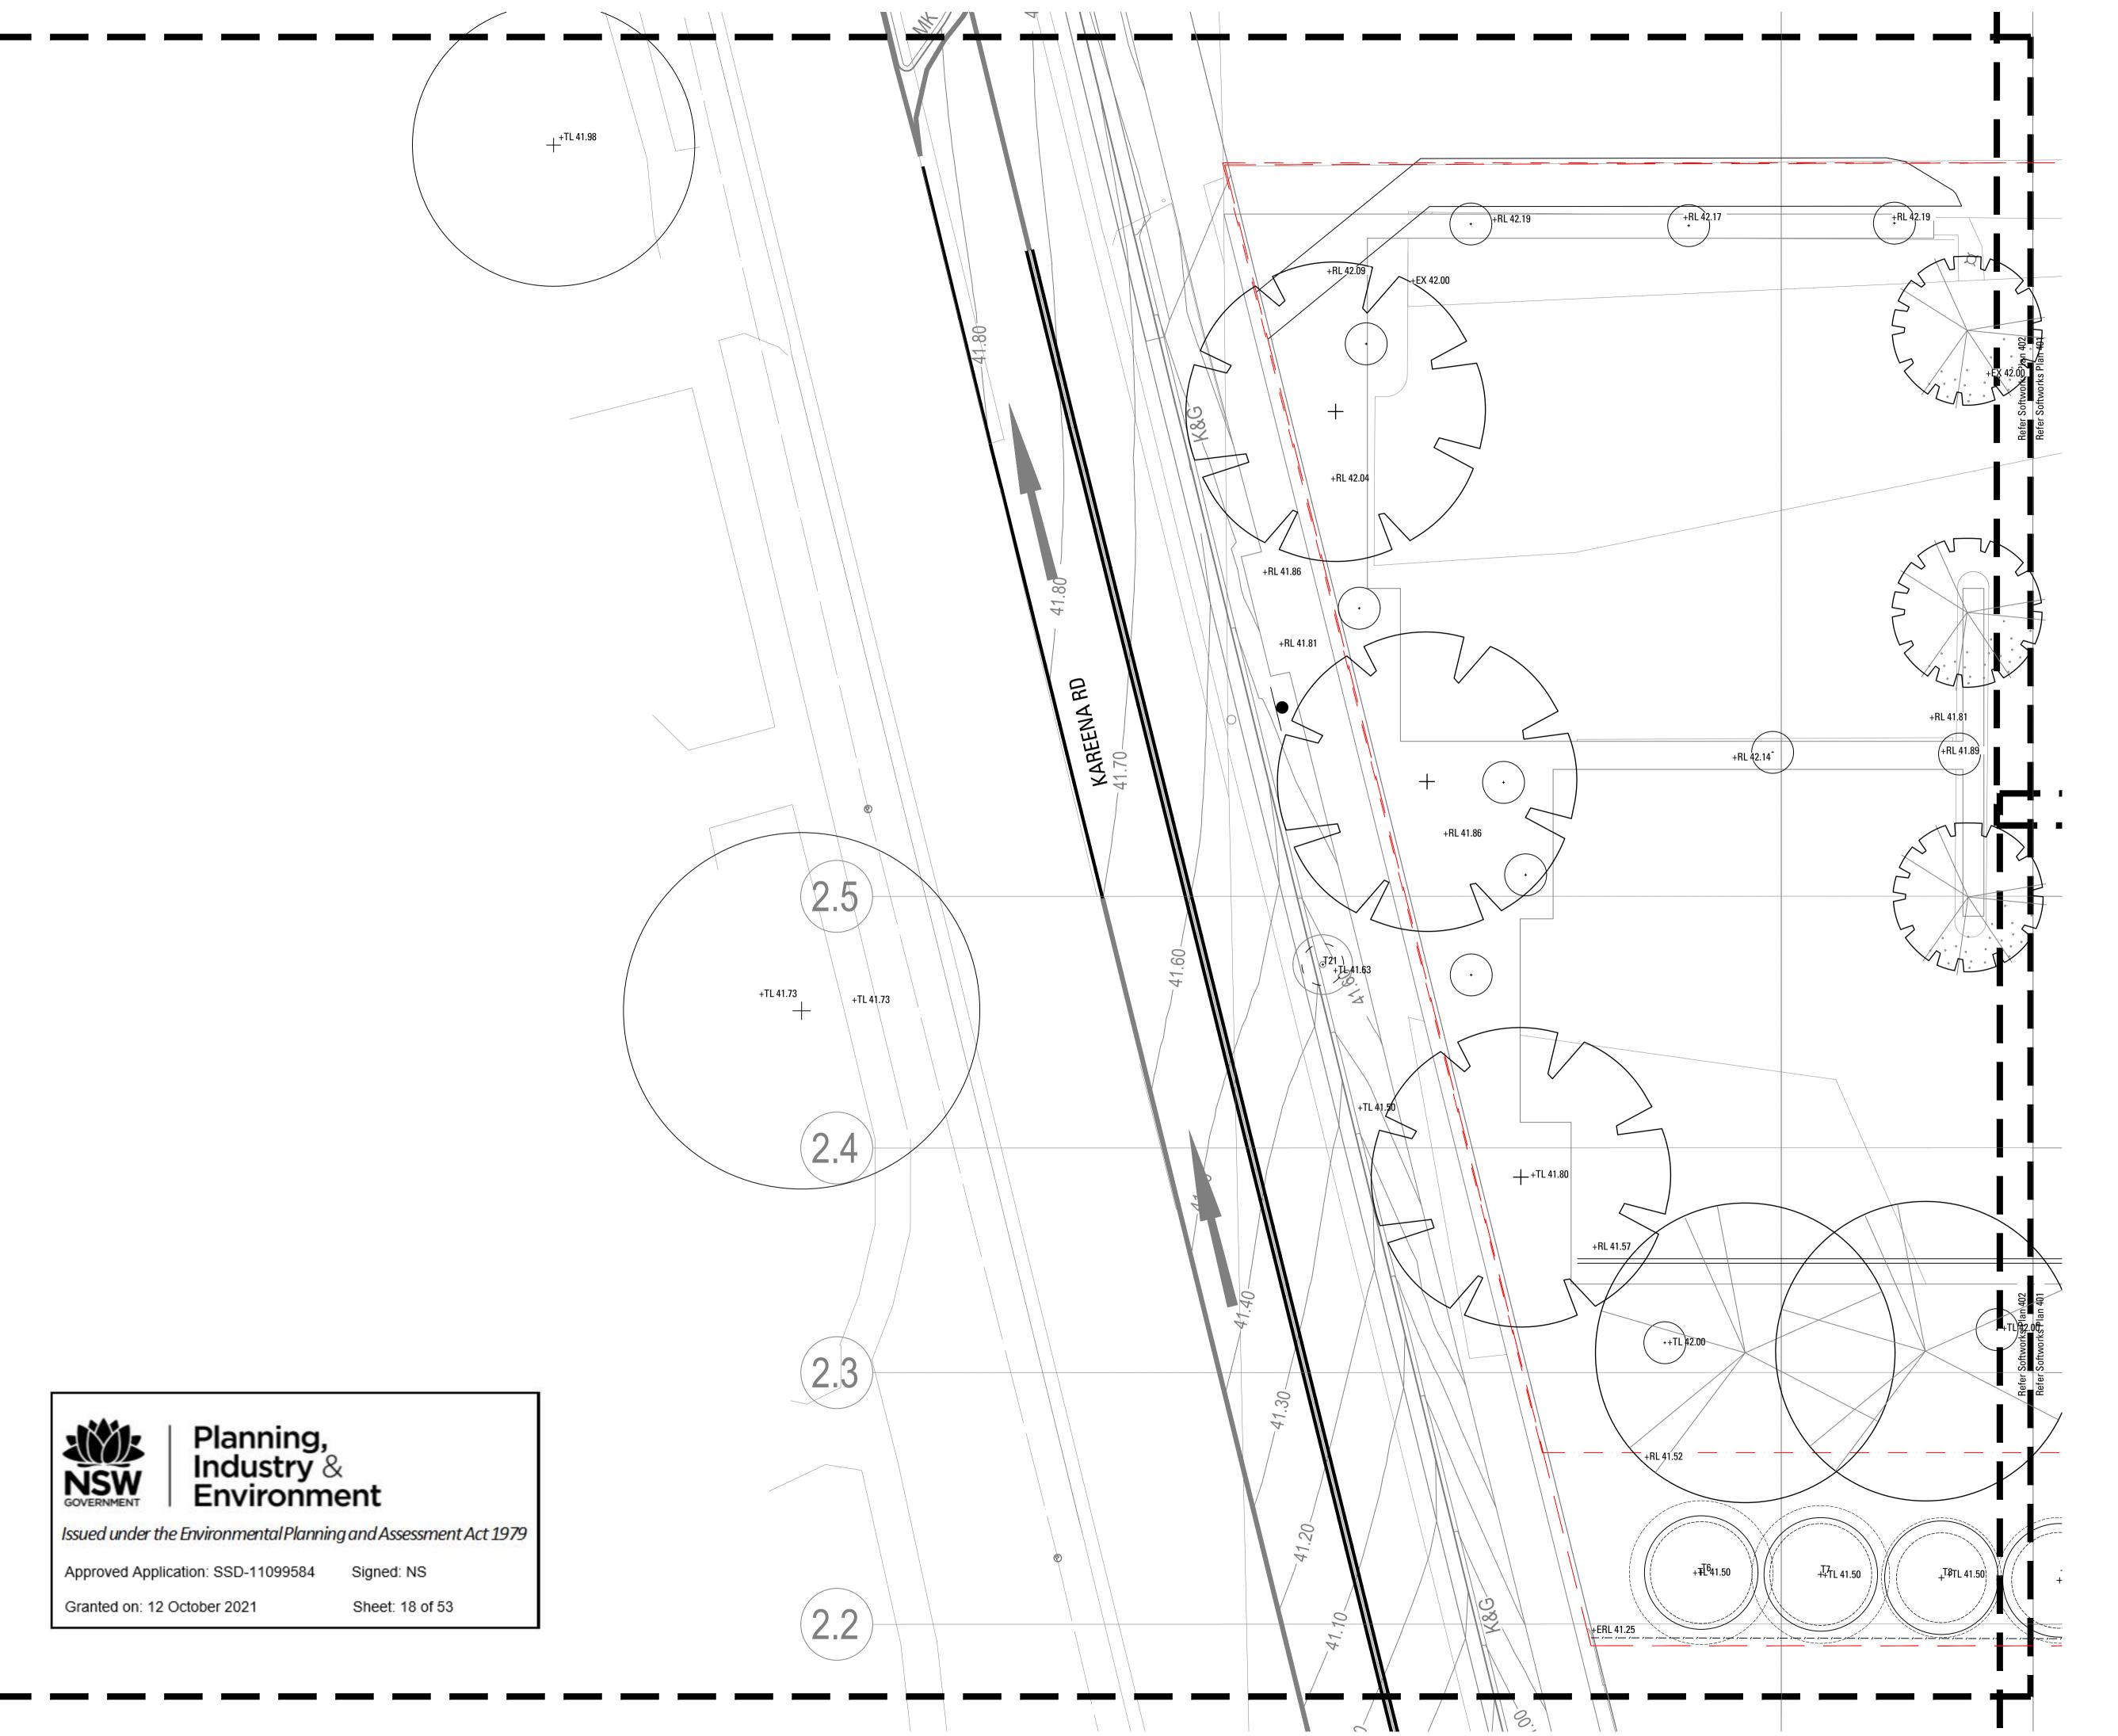

ANGLE MEASUREMENT

DISTANCE MEASUREMENT

RADIUS MEASUREMENT

SETOUT GUIDES

SETOUT MARKER

GRADING

RL REDUCED LEVEL

FFL FINISHED FLOOR LEVEL

TS/BS TOP / BOTTOM OF STEP


TW/BW TOP / BOTTOM OF WALL

PL TOP OF PIT

TOP OF SEAT

TOS

TR/BR TOP / BOTTOM OF RAMP

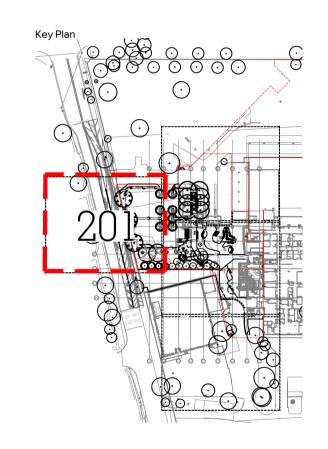

1 70% TENDER SE CT 23.02.21

Issue Revision Description Drawn Check Date

Project

Not for Construction

Sutherland Hospital
Kingsway & Kareena Rd
Caringbah NSW 2229

Tender


Health Infrastructure

g No. Drawing Name

L-201 Setout & Grading Plan

Job No. 20-693 Issue 1 Scale 1:100 @ A1

Sydney, Suite 76, Jones Bay Wharf, 26-32 Pirrama Road, Pyrmont NSW 2009 E sydney@arcadiala.com.au T 02 8571 2900 E Sydney@arcadiala.com.au T 07 3071 8000

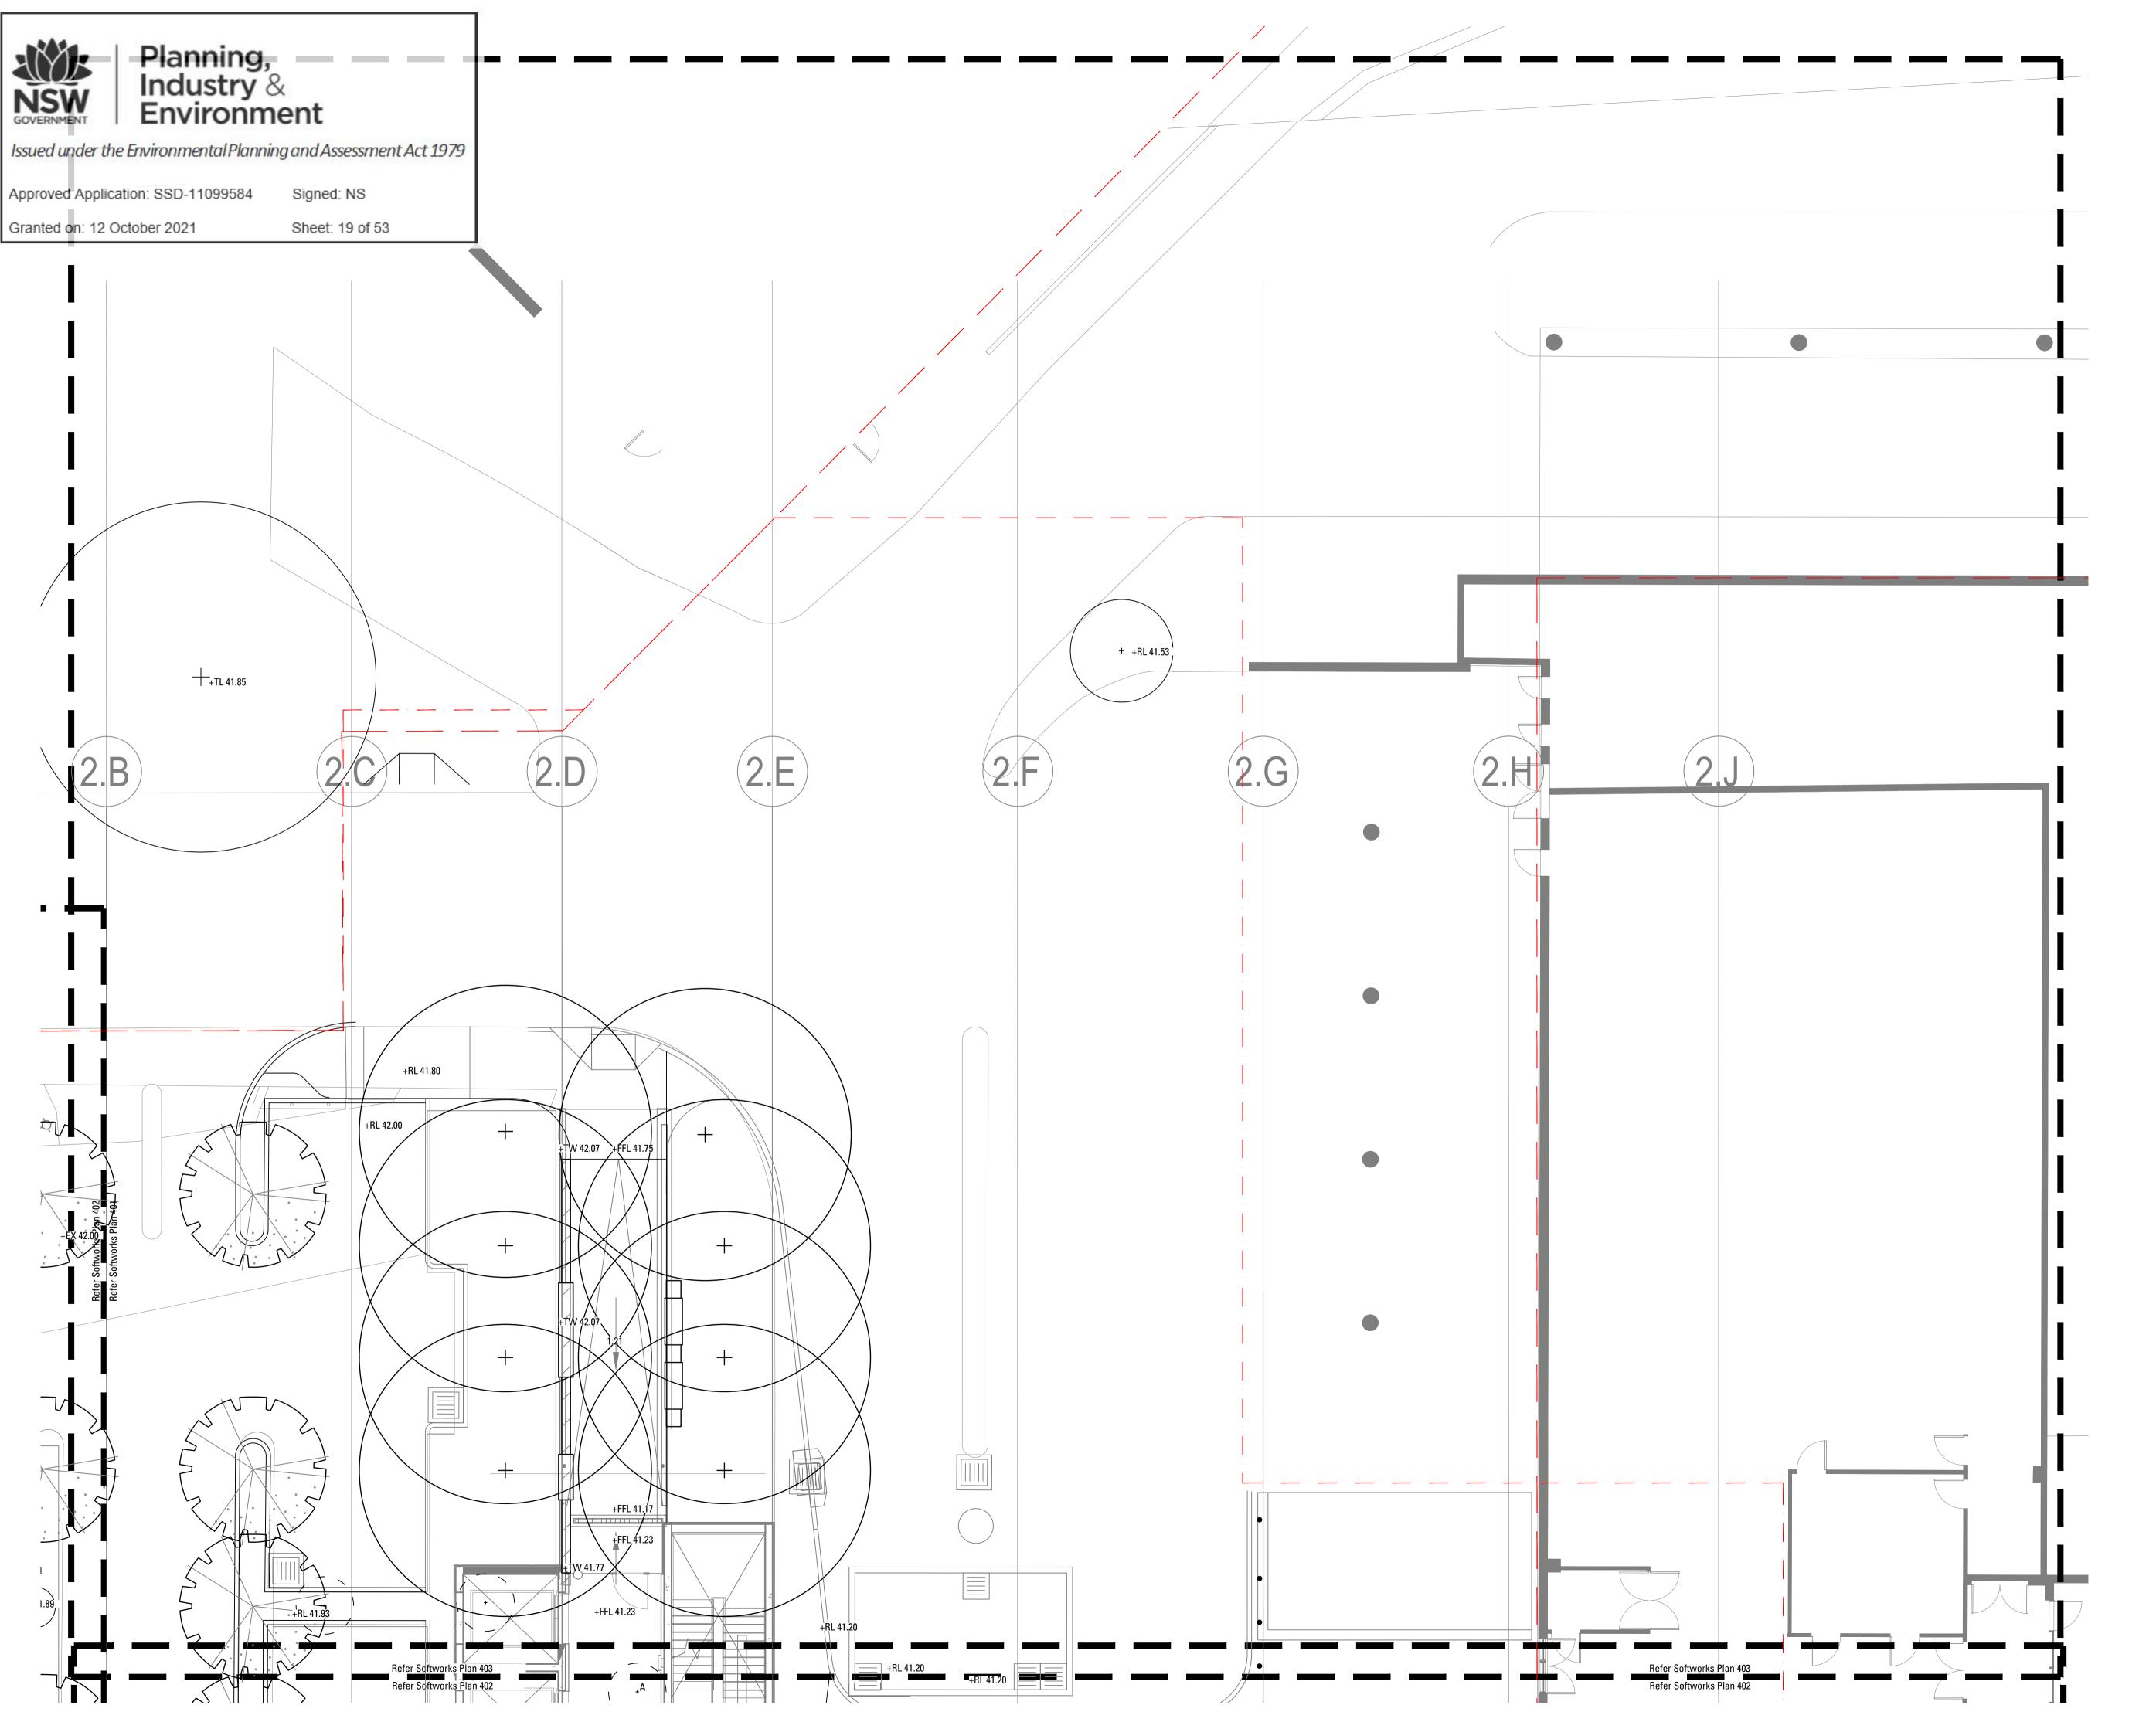

ANGLE MEASUREMENT

DISTANCE MEASUREMENT

RADIUS MEASUREMENT

SETOUT GUIDES

SETOUT MARKER

GRADING

REDUCED LEVEL

FINISHED FLOOR LEVEL FFL

TOP / BOTTOM OF STEP TS/BS


TW/BW

TOP OF PIT PL

TOP OF SEAT

TOS

TOP / BOTTOM OF RAMP TR/BR

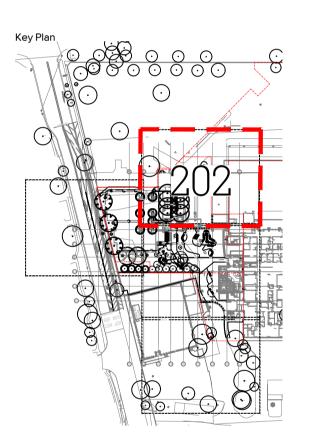

Issue Revision Description Drawn Check Date

Not for Construction


Sutherland Hospital

Kingsway & Kareena Rd Caringbah NSW 2229 Tender



L-202 Setout & Grading Plan

Sydney, Suite 76, Jones Bay Wharf, 26-32 Pirrama Road, Pyrmont NSW 2009 E sydney@arcadiala.com.au T 02 8571 2900 E Sydney. Brisbane@arcadiala.com.au T 07 3071 8000

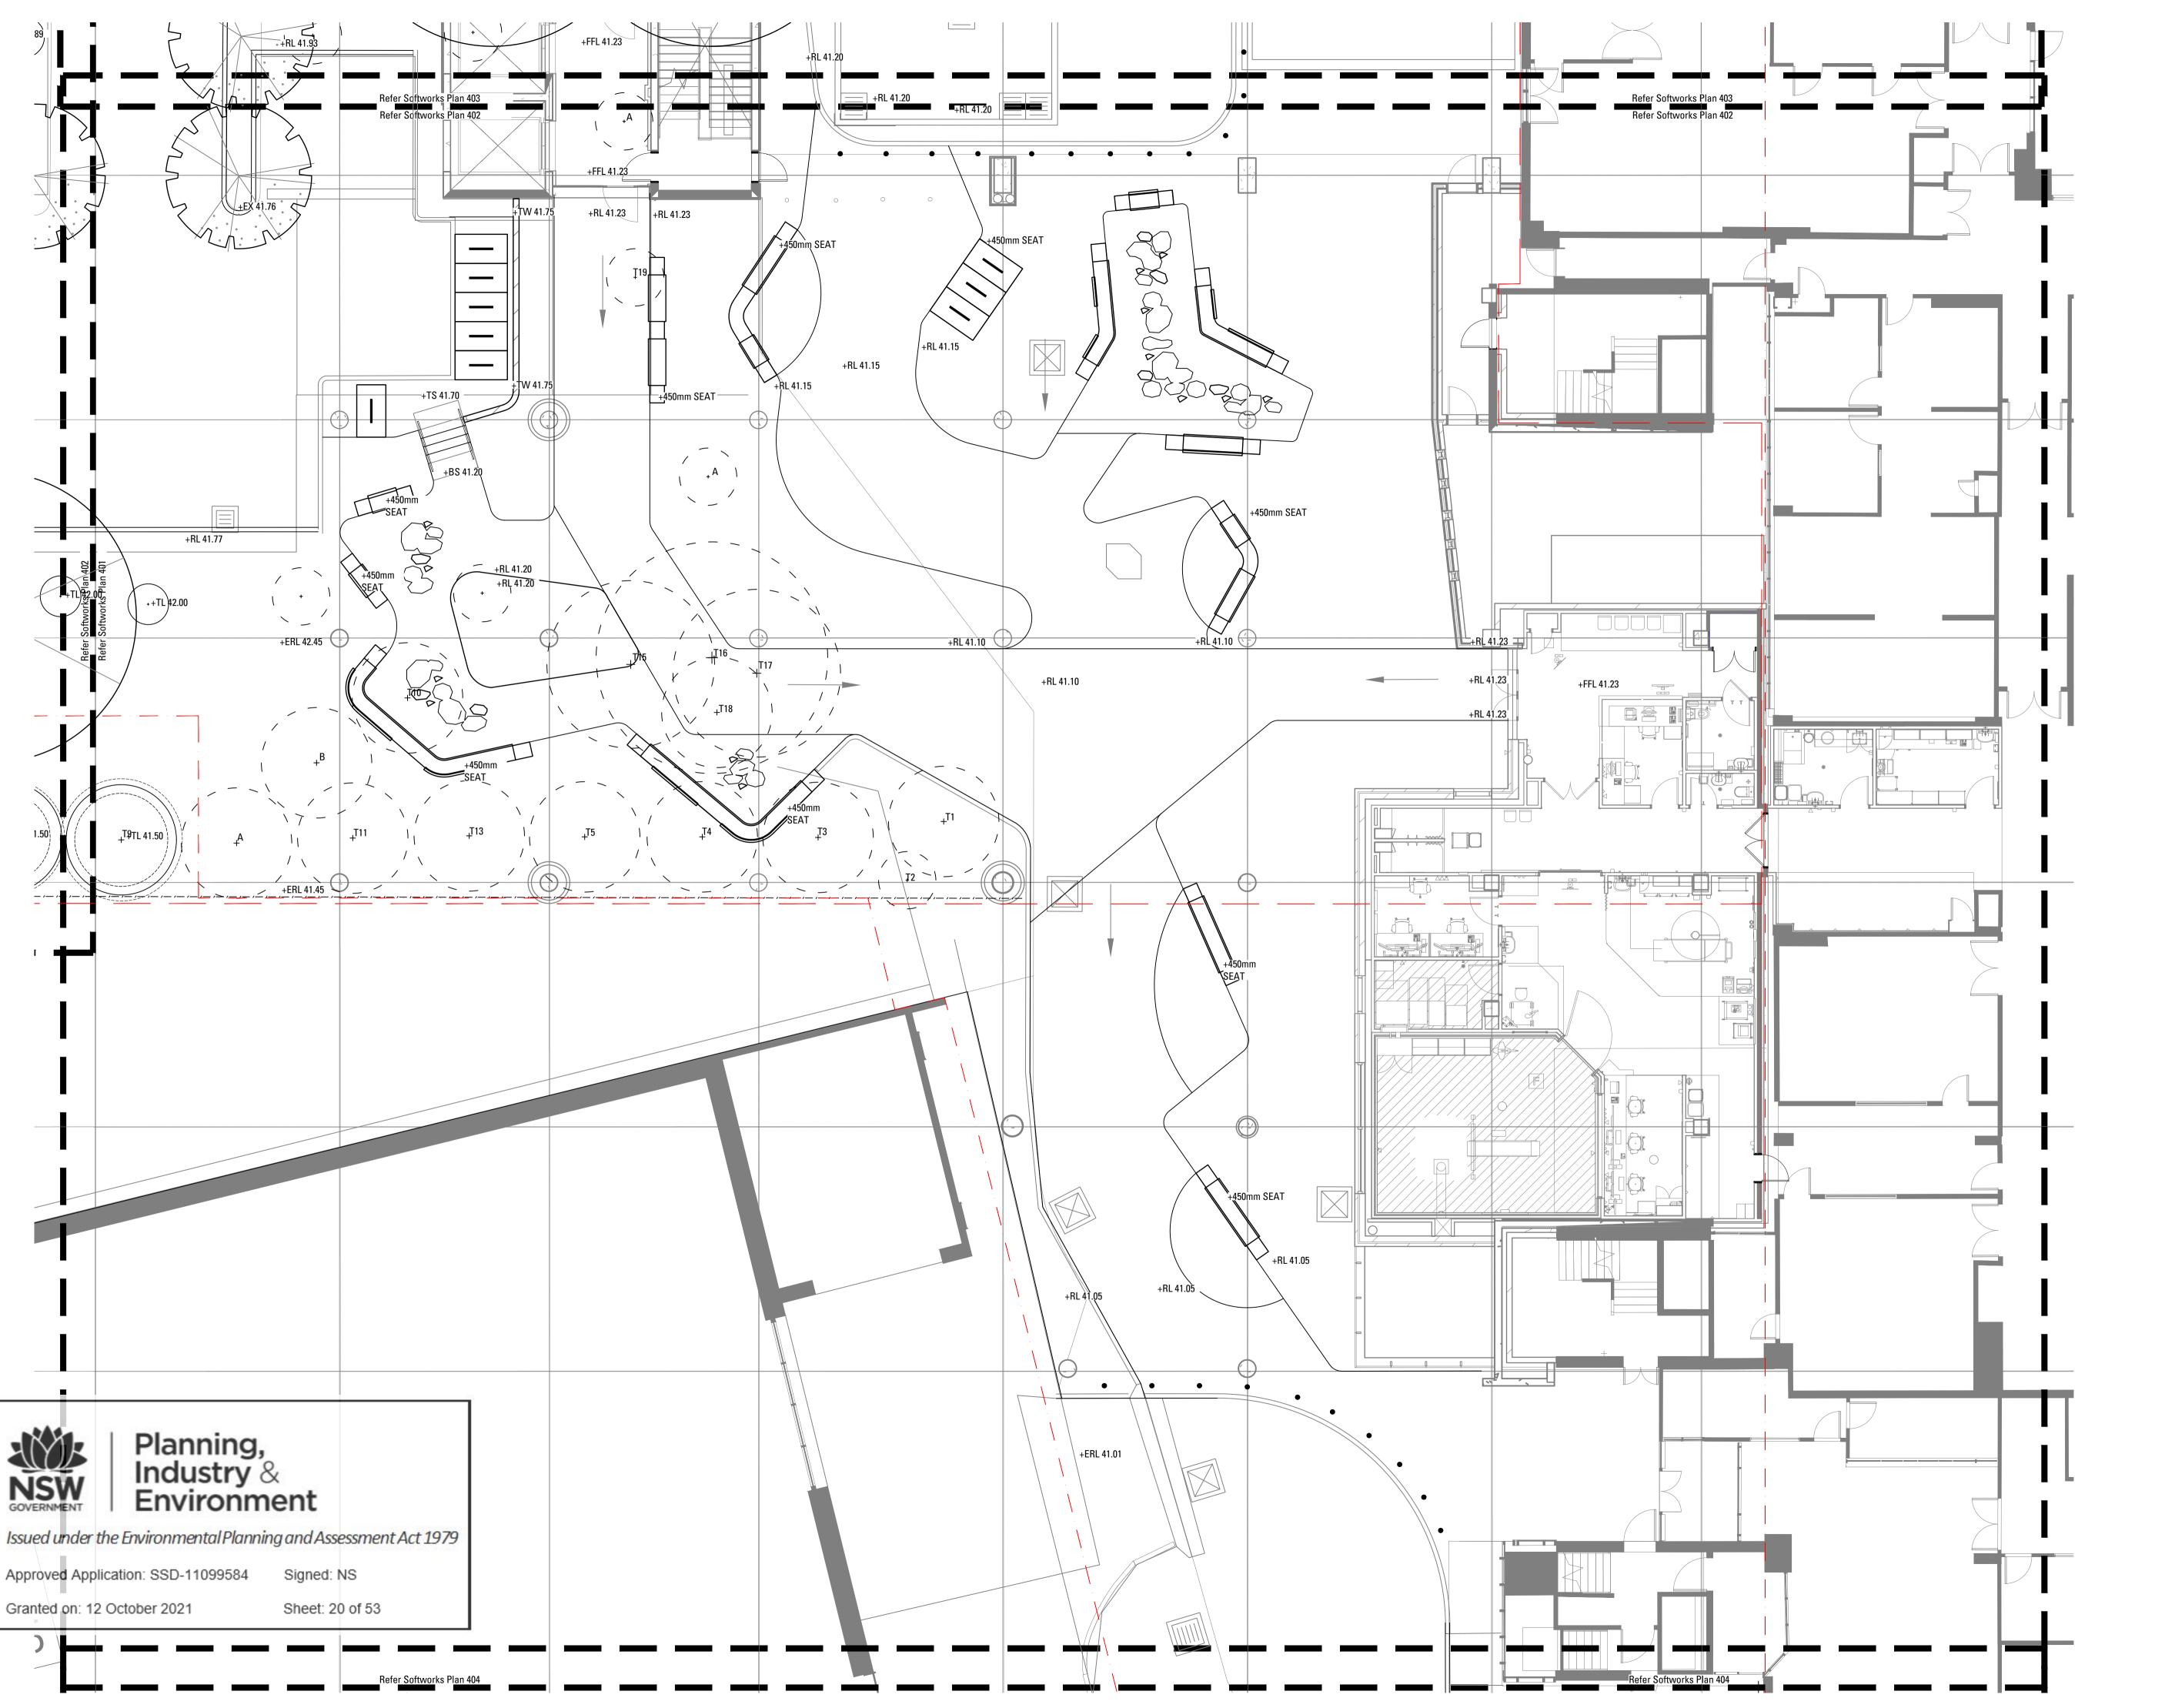

ANGLE MEASUREMENT

DISTANCE MEASUREMENT

RADIUS MEASUREMENT

SETOUT GUIDES

SETOUT MARKER

GRADING

TS/BS

REDUCED LEVEL

FINISHED FLOOR LEVEL


TOP / BOTTOM OF STEP

TW/BW TOP / BOTTOM OF WALL

PL TOP OF PIT

TOS TOP OF SEAT

TR/BR TOP / BOTTOM OF RAMP

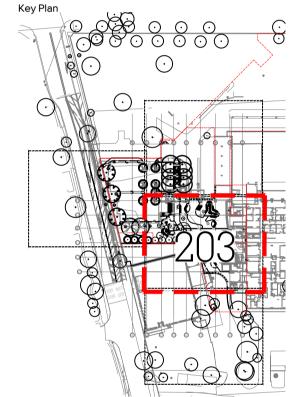

1 70% TENDER SE CT 23.02.2

Issue Revision Description Drawn Check Date

Not for Construction

oject

Sutherland Hospital Kingsway & Kareena Rd Caringbah NSW 2229

Tender

Client

NSW Health Infrastructure


Infrastructure

Drawing Name

203 Setout & Grading Plan

Job No. 20-693
Issue 1
Scale 1:100 @ A1
0 1 2 3 4 5m

Sydney, Suite 76, Jones Bay Wharf, 26-32 Pirrama Road, Pyrmont NSW 2009 E sydney@arcadiala.com.au T 02 8571 2900 Brisbane@arcadiala.com.au T 07 3071 8000 Brisbane@arcadiala.com.au

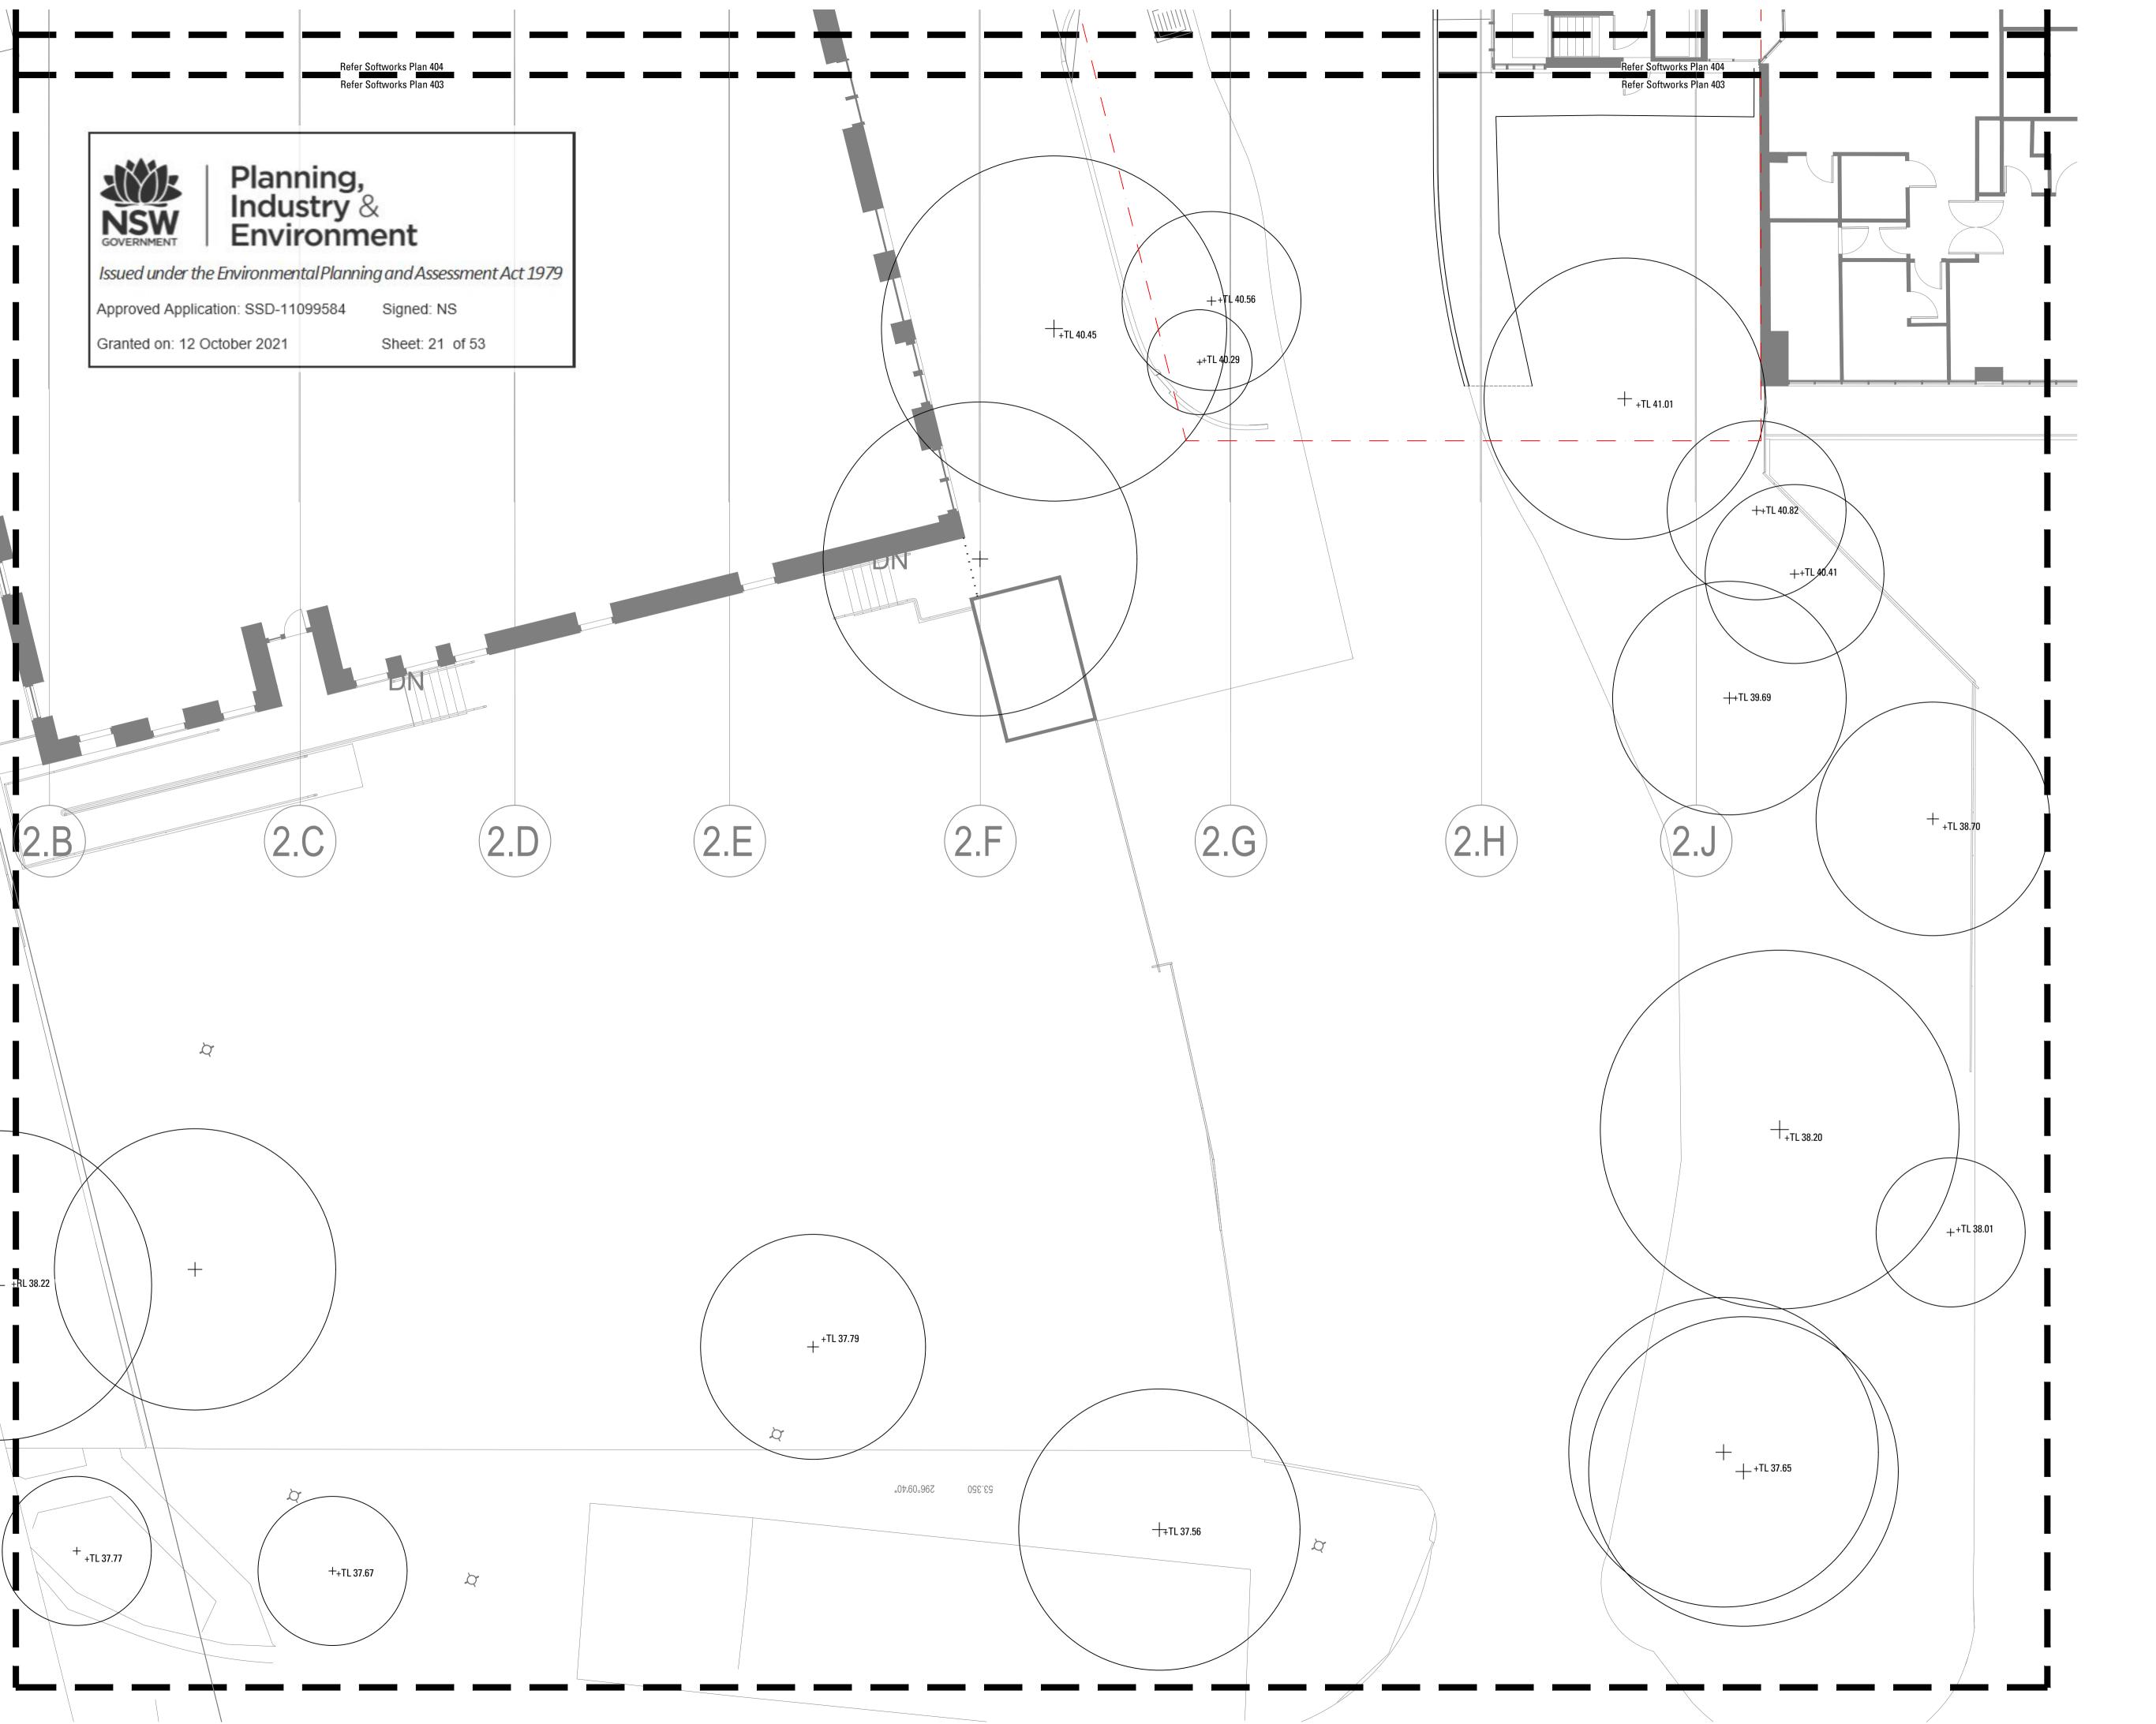

> ANGLE MEASUREMENT DISTANCE MEASUREMENT RADIUS MEASUREMENT

SETOUT GUIDES

SETOUT MARKER

GRADING

REDUCED LEVEL

FINISHED FLOOR LEVEL FFL


TOP / BOTTOM OF STEP TS/BS

TW/BW

TOP OF PIT PL

TOP OF SEAT TOS

TOP / BOTTOM OF RAMP TR/BR

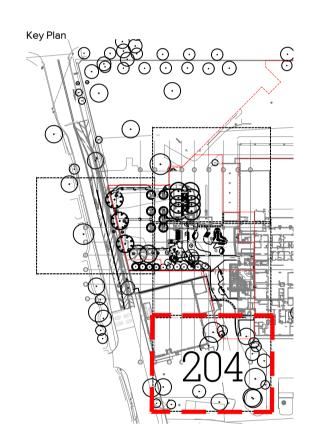

Issue Revision Description Drawn Check Date

Not for Construction

Sutherland Hospital

Kingsway & Kareena Rd Caringbah NSW 2229 Tender

Drawing Name

Setout & Grading Plan

1:100 @ A1

Sydney, Suite 76, Jones Bay Wharf, 26-32 Pirrama Road, Pyrmont NSW 2009 E sydney@arcadiala.com.au T 02 8571 2900 E Sydney. Brisbane@arcadiala.com.au T 07 3071 8000



ANGLE MEASUREMENT

DISTANCE MEASUREMENT

RADIUS MEASUREMENT

SETOUT GUIDES

SETOUT MARKER

GRADING

REDUCED LEVEL

FINISHED FLOOR LEVEL FFL


TOP / BOTTOM OF STEP TS/BS

TW/BW

PL

TOS

TOP / BOTTOM OF RAMP TR/BR

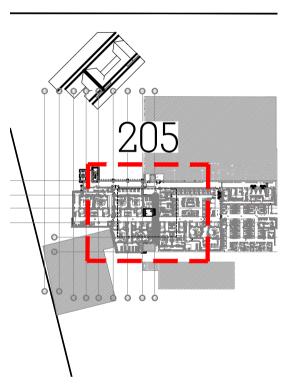

Issue Revision Description Drawn Check Date

Not for Construction

Sutherland Hospital

Kingsway & Kareena Rd Caringbah NSW 2229

Tender



Setout & Grading Plan

Sydney, Suite 76, Jones Bay Wharf, 26-32 Pirrama Road, Pyrmont NSW 2009 E sydney@arcadiala.com.au T 02 8571 2900 E Brisbane@arcadiala.com.au T 07 3071 8000

CODE	TYPE	DETAIL	LOCATION	PRODUCT INFORMATION	MATERIAL	CONSTRUCTION NOTES
CODE	TIPE	DETAIL	LOCATION	PRODUCT INFORMATION	MAILNIAL	CONSTRUCTION NOTES
	PAVING & SURFACES					
P1	Insitu concrete paving	01/600	Refer Landscape Plans	Colour - Grey Cement, Finish - Exposed Aggregate	Insitu concrete to Engineers Specification	Refer to Detail and Specification
P2	Unit pavers on pedestals	03/6 00	Refer Landscape Plans	Stone Outdoor Precast Paver. Finish: Etch; Colour: Boston	600 x 600 x 38mm Concrete Paver	Refer to Detail and Specification
P3	Feature unit pavers on grade	04/600	Refer Landscape Plans	Equal to Gosford Quarries	30mm thick Sandstone Crazy Pave, mortar to match sandstone colour	Refer to Detail and Specification
P4	Exposed Ag Paving	05/600	Refer Landscape Plans	Grey Cement CCS.Oxide Colour: Ghost Gum; Exposed Aggregate	Concrete to Engineers specification.	Refer to Detail and Specification
TGSI	Tactile Studs	N/A	Stairs, Ramps, Refer Landscape Plans	Equal to Allsafe Flooring, TIS 008-8BK	Aluminium, black, epoxy fixed	Refer to Detail and Specification
	EDGING					
SE	Typical Mild Steel Edge	06/600	Refer Landscape Plans	Galvanised Mild steel, 100x3mm in longest lengths; 10x10x200mm long	Mild galvanised steel with galvanised fixings	Refer to Detail and Specification
	WALLS					
Wla	Insitu Concrete Wall	01/610	Refer Landscape Plans	Formed Insitu Concrete.	Concrete to Engineers Specification	Refer to Detail and Specification
Wllb	Insitu Concrete Wall with	02/610	Refer Landscape Plans	Formed Insitu Concrete.	Concrete to Engineers Specification	Refer to Detail and Specification
W2	Seat Sandstone Wall	03/610	Refer Landscape Plans	Equal to Gosford Quarries	Concrete Footing to Engineers Specification	Refer to Detail and Specification
	HANDRAILS AND FENCING	[G				
Hl	Handrail type l	01/620	Refer Landscape Plans	Tubular SS 38DIA handrails	Stainless Steel	Refer to Detail and Specification
	FURNITURE & FIXTURES					
Flα	Bench seat on concrete	01/630	Refer Landscape Plans	Custom Design Refer to Detail	Aluminium Frame (Meteor); 30 x 40mm Innowood Slats FS04030S. Colour: Golden Oak; Concrete to Engineers Specification	Refer to Detail and Specification
Flb	Bench seat on concrete with backrest	02/630		Custom Design Refer to Detail	Aluminium Frame (Meteor); 30 x 40mm Innowood Slats FS04030S. Colour: Golden Oak; Concrete to Engineers Specification	Refer to Detail and Specification
F2a	Bench seat on sandstone	03/630	Refer Landscape Plans	Custom Design Refer to Detail	Aluminium Frame (Meteor); 30 x 40mm Innowood Slats FS04030S. Colour: Golden Oak; 500x500x1000 Sandstone Logs	Refer to Detail and Specification
F2b	Benchseat on sandstone with backrest	04/630	Refer Landscape Plans	Custom Design Refer to Detail	Aluminium Frame (Meteor); 30 x 40mm Innowood Slats FS04030S. Colour: Golden Oak; 500x500x1000 Sandstone Logs	Refer to Detail and Specification
F3	Sandstone Boulders	01/631	Refer Landscape Plans	Equal to Gosford Quarries	Boulders from Gosford Quarries to be selected by Landscape Architect	Refer to Detail and Specification
Bl	Fixed Bollard	02/631	Refer Landscape Plans	Equal to Street Furniture Australia Slim Bollard B5, flat top		Refer to Specification
B2	Removable Bollard	03/631	Refer Landscape Plans	Equal to Street Furniture Australia Slim Bollard B5, flat top	Stainless Steel	Refer to Specification
BR	Bike Rack	04/631	Refer Landscape Plans	Equal to D.O.Smith and Sons, B004	Stainless Steel	Refer to Specification
PT	Planting trellis	06/650	Refer Landscape Plans	Equal to Ronstan AGS5 Easy Green Wire Trellis, Vertical	Trellis: Stainless steel AGS5	Refer to Specification

HARDWORKS

INSITU CONCRETE PAVING
Refer Landscape Specification

UNIT PAVING ON PEDESTAL Refer Landscape Specification

UNIT PAVING ON GRADE
Refer Landscape Specification

FEATURE CRAZY PAVING
Refer Landscape Specification

EXPOSED AGGREGATE PAVING Refer Landscape Specification

ST1 STEPS TYPE 1
Refer Landscape Specification

DIRECTIONAL TACTILE
Refer Landscape Specification

HANDRAIL TYPE 1 H1 Refer Landscape Specification

PRAM RAMP
Refer Landscape Specification

STEEL EDGING
Refer Landscape Specification

W1a INSITU CONCRETE WALL
Refer Landscape Specification

W1b INSITU CONCRETE SEATING WALL Refer Landscape Specification

W2 SANDSTONE WALL
Refer Landscape Specification

F1a BENCH SEAT - ON CONCRETE

Refer Landscape Specification

F1b BENCH SEAT 1- ON SANDSTONE Refer Landscape Specification

F2a BENCH SEAT 2- ON SANDSTONE

Refer Landscape Specification F2b BENCH SEAT 2- ON SANDSTONE
Refer Landscape Specification

BIKE RACK
Refer Landscape Specification

 BOLLARD - FIXED B1 Refer Landscape Specification

 BOLLARD - REMOVABLE B2 Refer Landscape Specification

SANDSTONE BOULDERS F3 Refer Landscape Specification Key Plan

Issue Revision Description Drawn Check Date

Not for Construction

Sutherland Hospital Kingsway & Kareena Rd Caringbah NSW 2229

Tender

Drawing Name

Materials Schedule

20-693

Issue

Sydney, Suite 76, Jones Bay Wharf, 26-32 Pirrama Road, Pyrmont NSW 2009 E sydney@arcadiala.com.au T 02 8571 2900 E Brisbane@arcadiala.com.au T 07 3071 8000



NSW GOVERNMENT Planning, Industry & Environment


Issued under the Environmental Planning and Assessment Act 1979


Approved Application: SSD-11099584

Granted on: 12 October 2021

Sheet: 23 of 53

Signed: NS

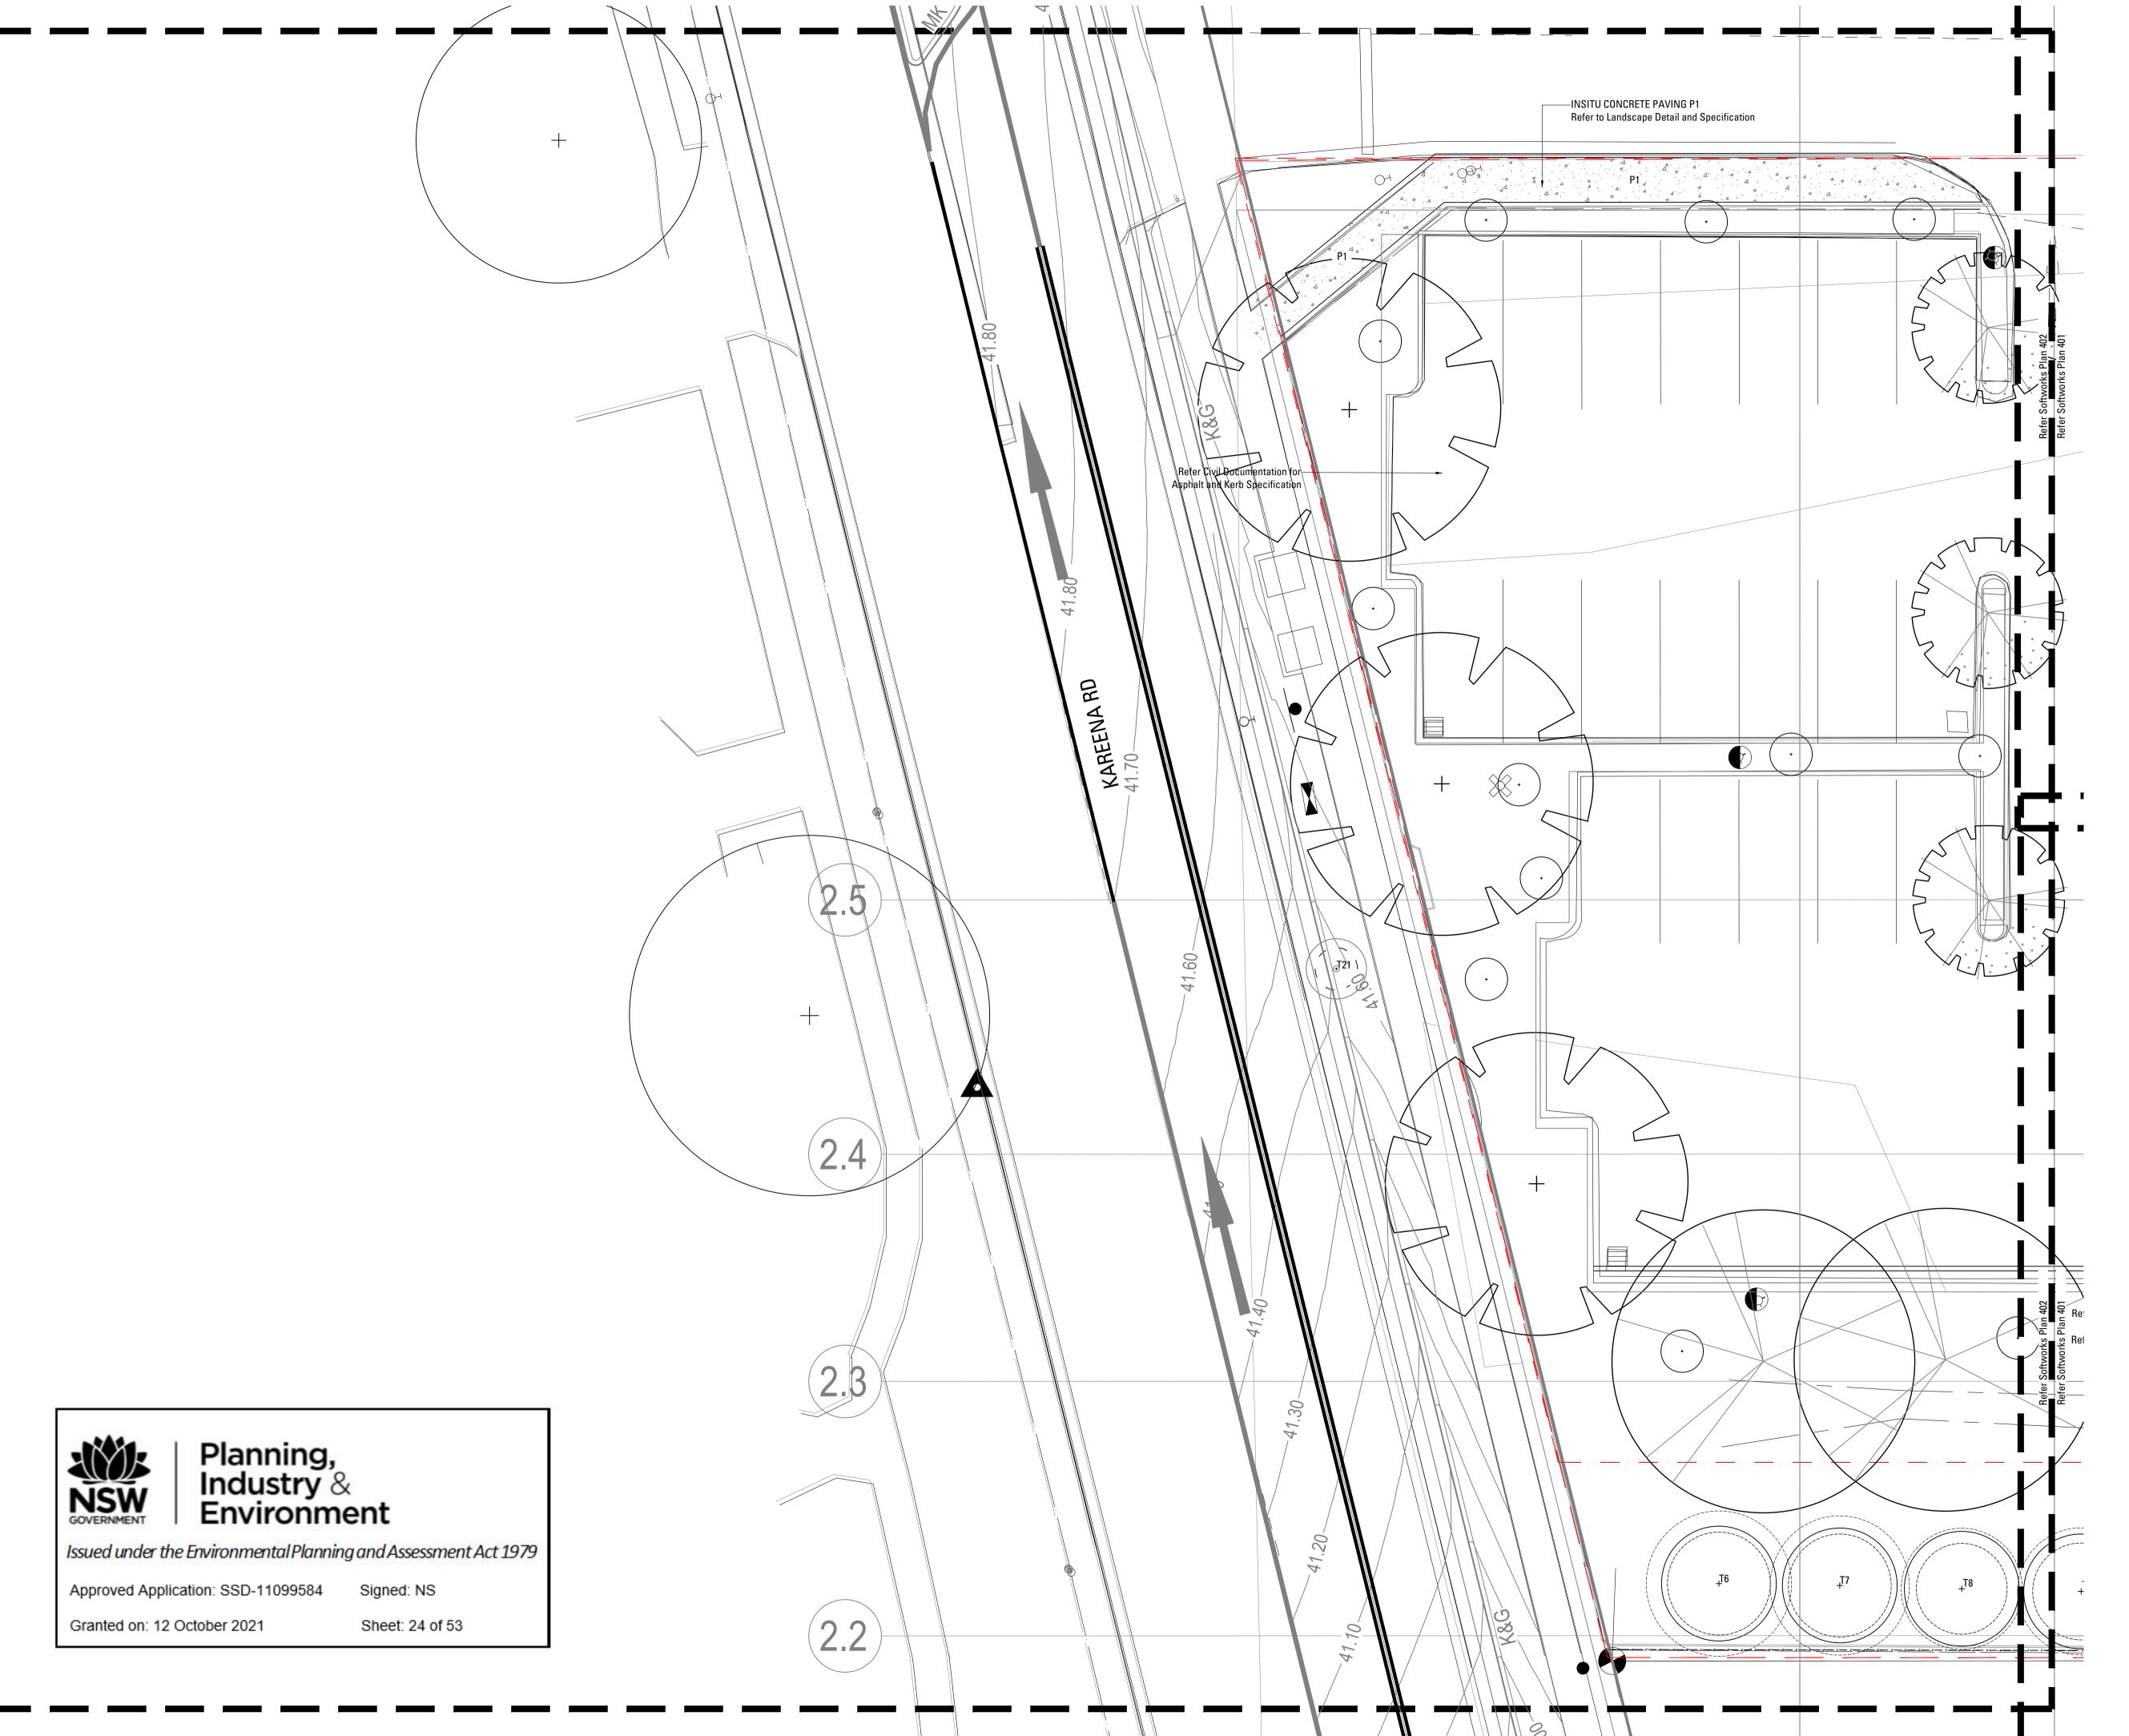

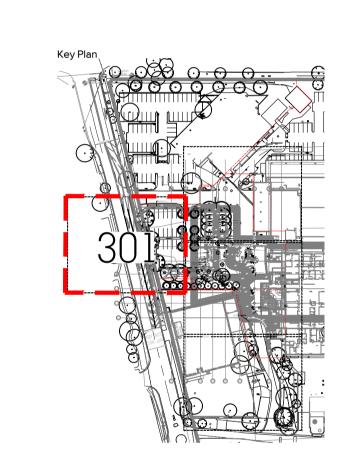

Issue Revision Description Drawn Check Date

Not for Construction

Sutherland Hospital Kingsway & Kareena Rd Caringbah NSW 2229

Tender





Drawing Name

Hardworks


Sydney, Suite 76, Jones Bay Wharf, 26-32 Pirrama Road, Pyrmont NSW 2009 E sydney@arcadiala.com.au T 02 8571 2900 Bayes Bayes Brisbane, Suite 9.01, Level 9 100 Edward Street Brisbane QLD 4000 E brisbane@arcadiala.com.au T 07 3071 8000




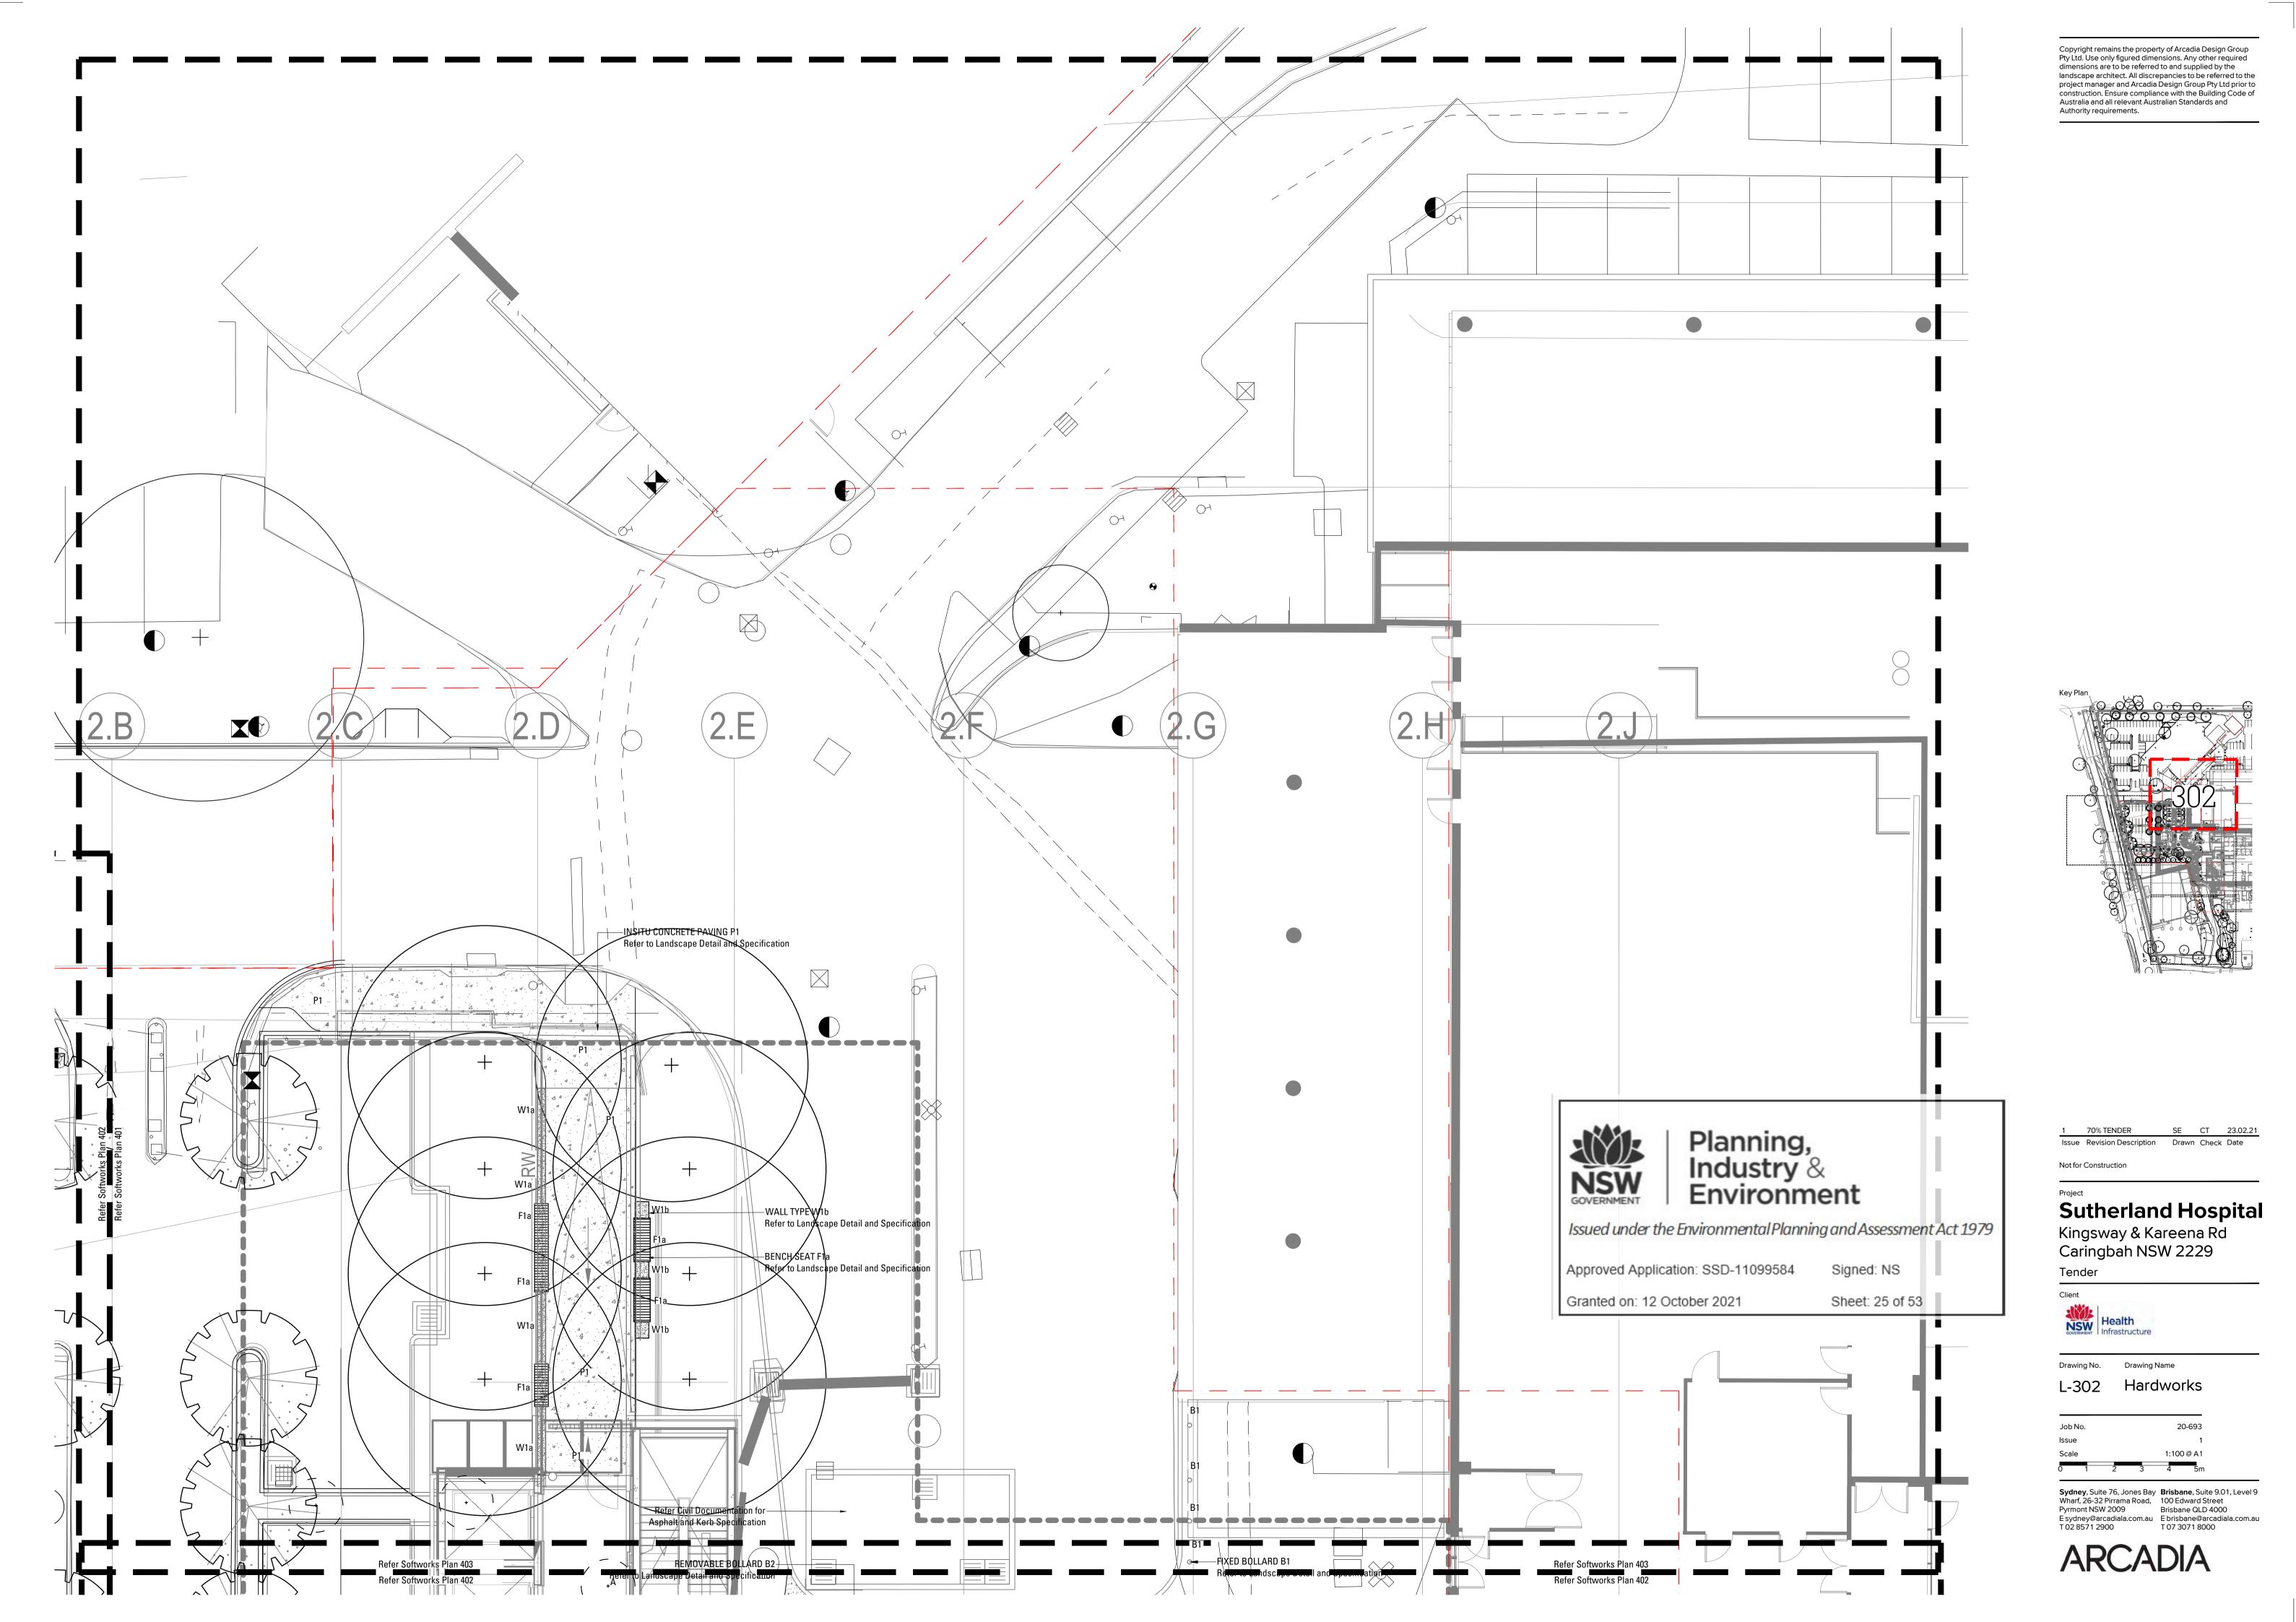

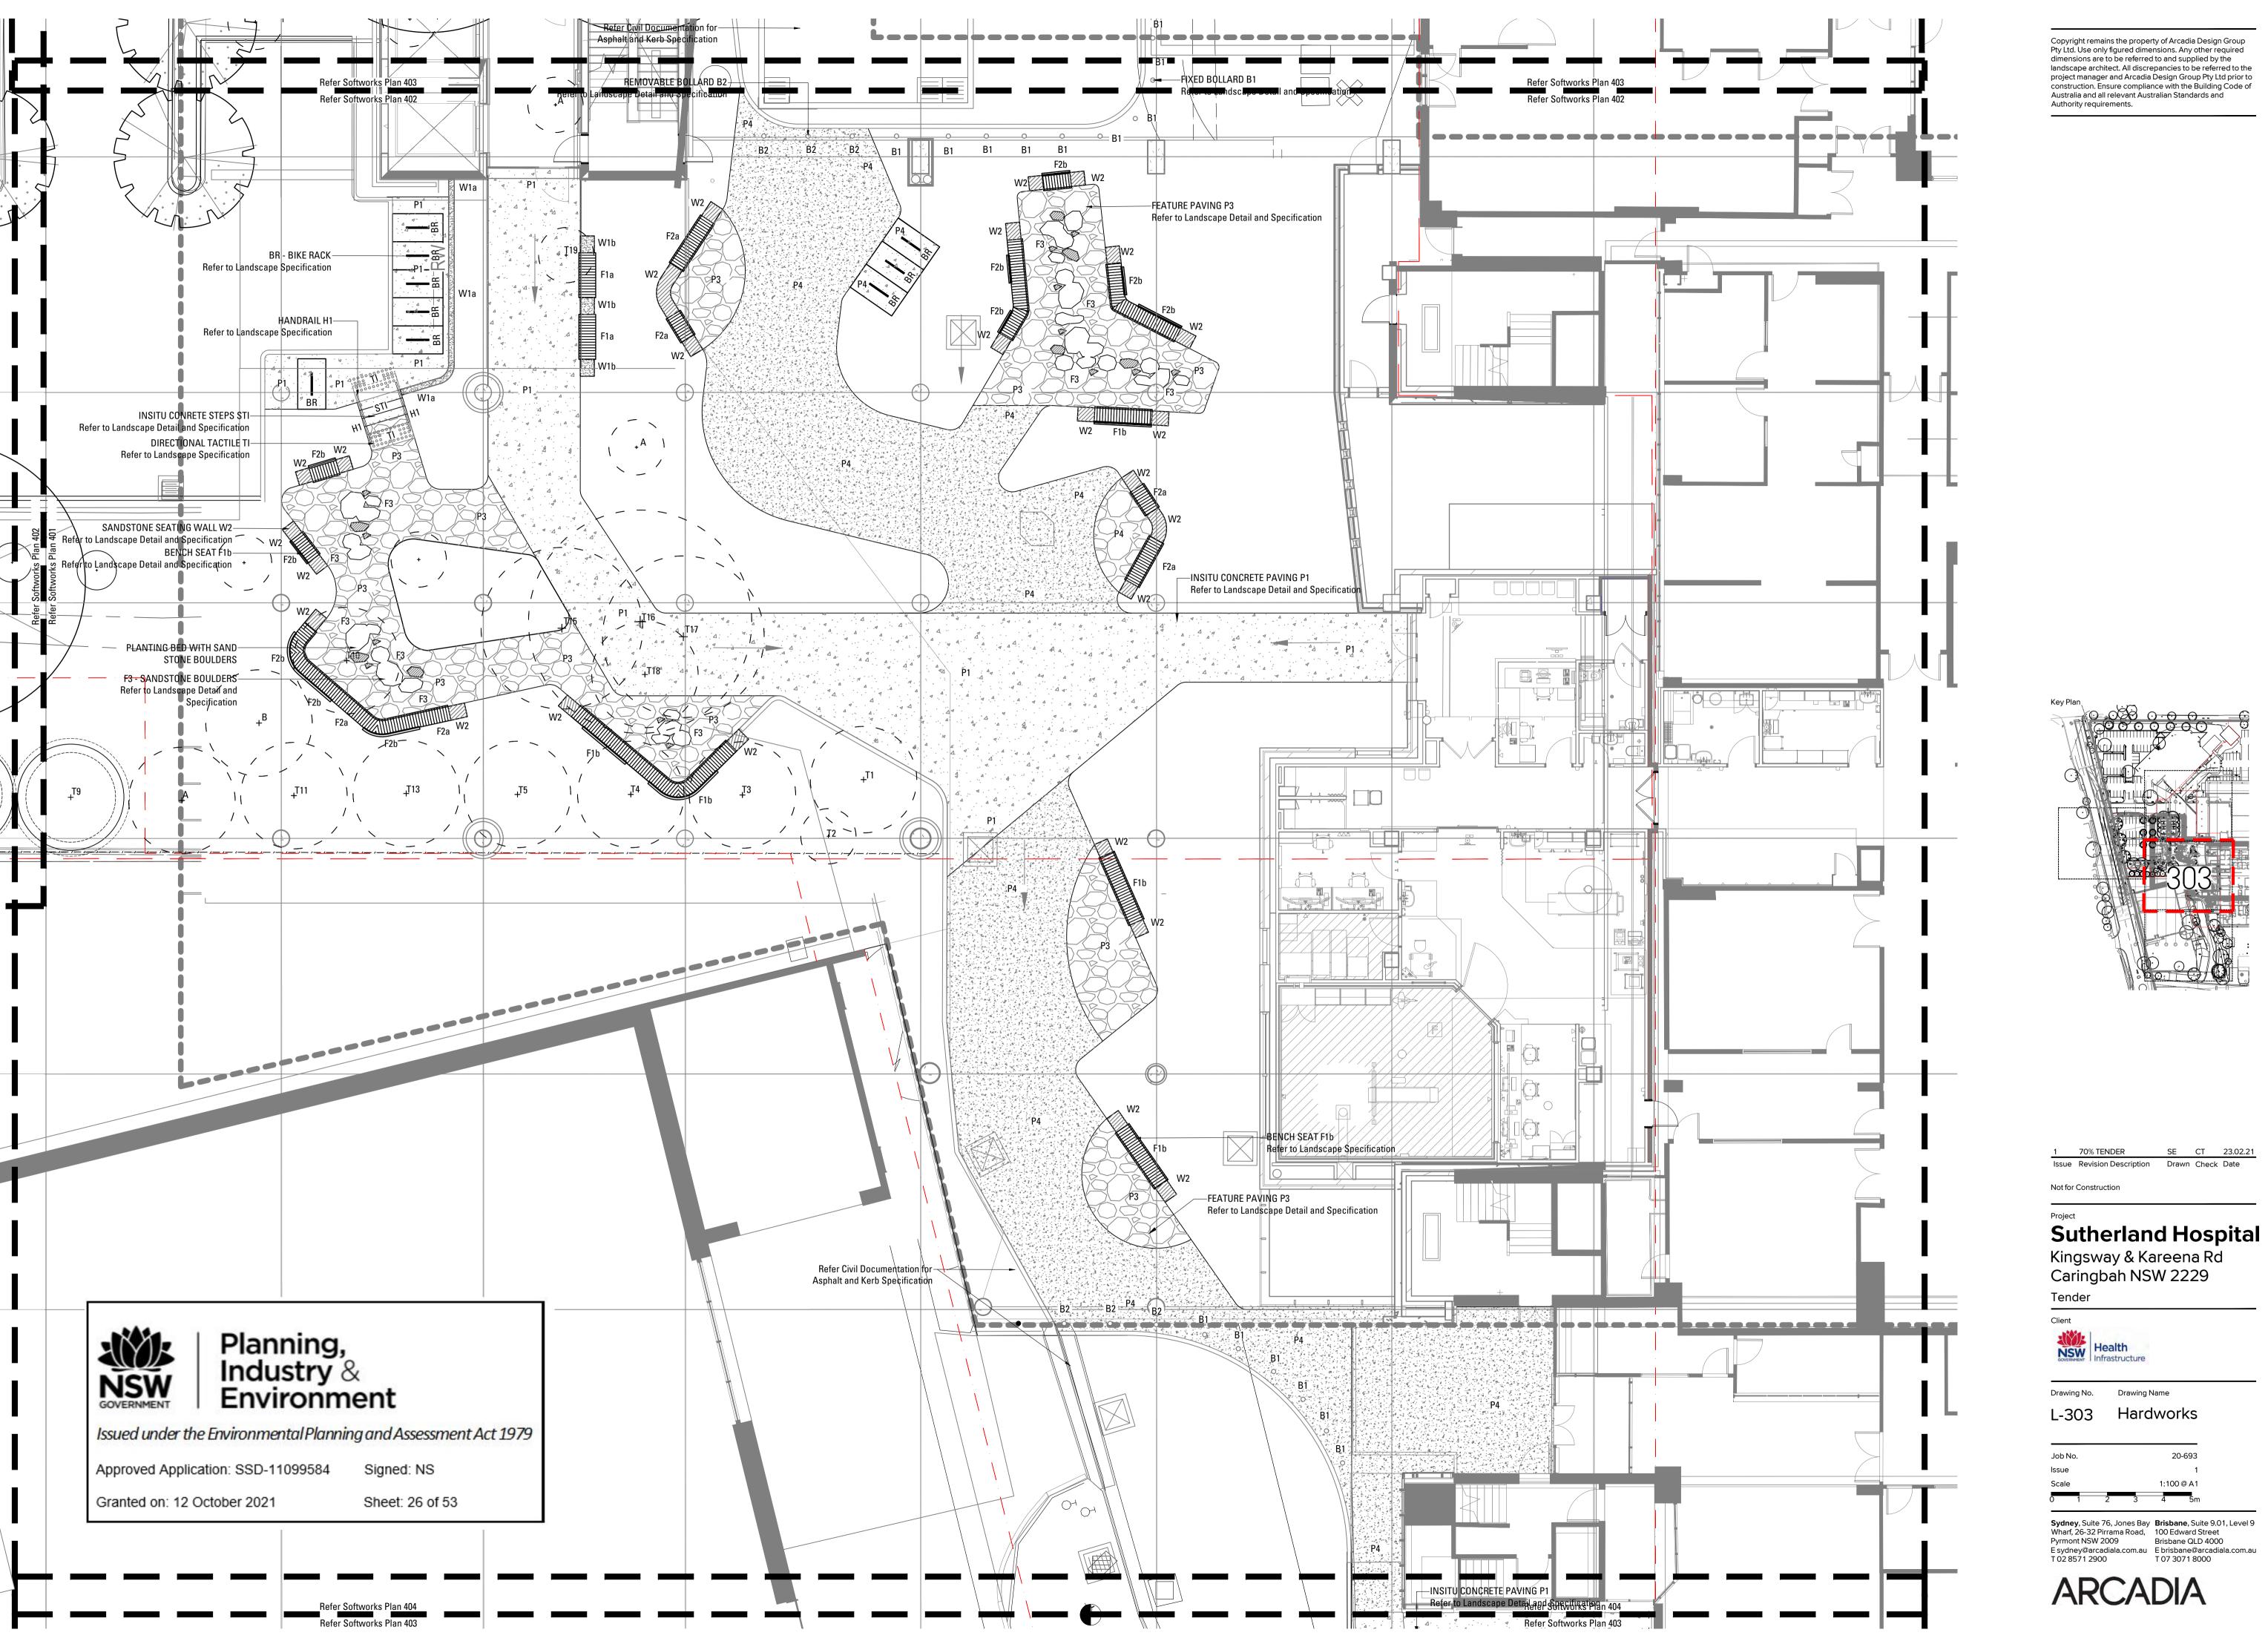

Issue Revision Description Drawn Check Date

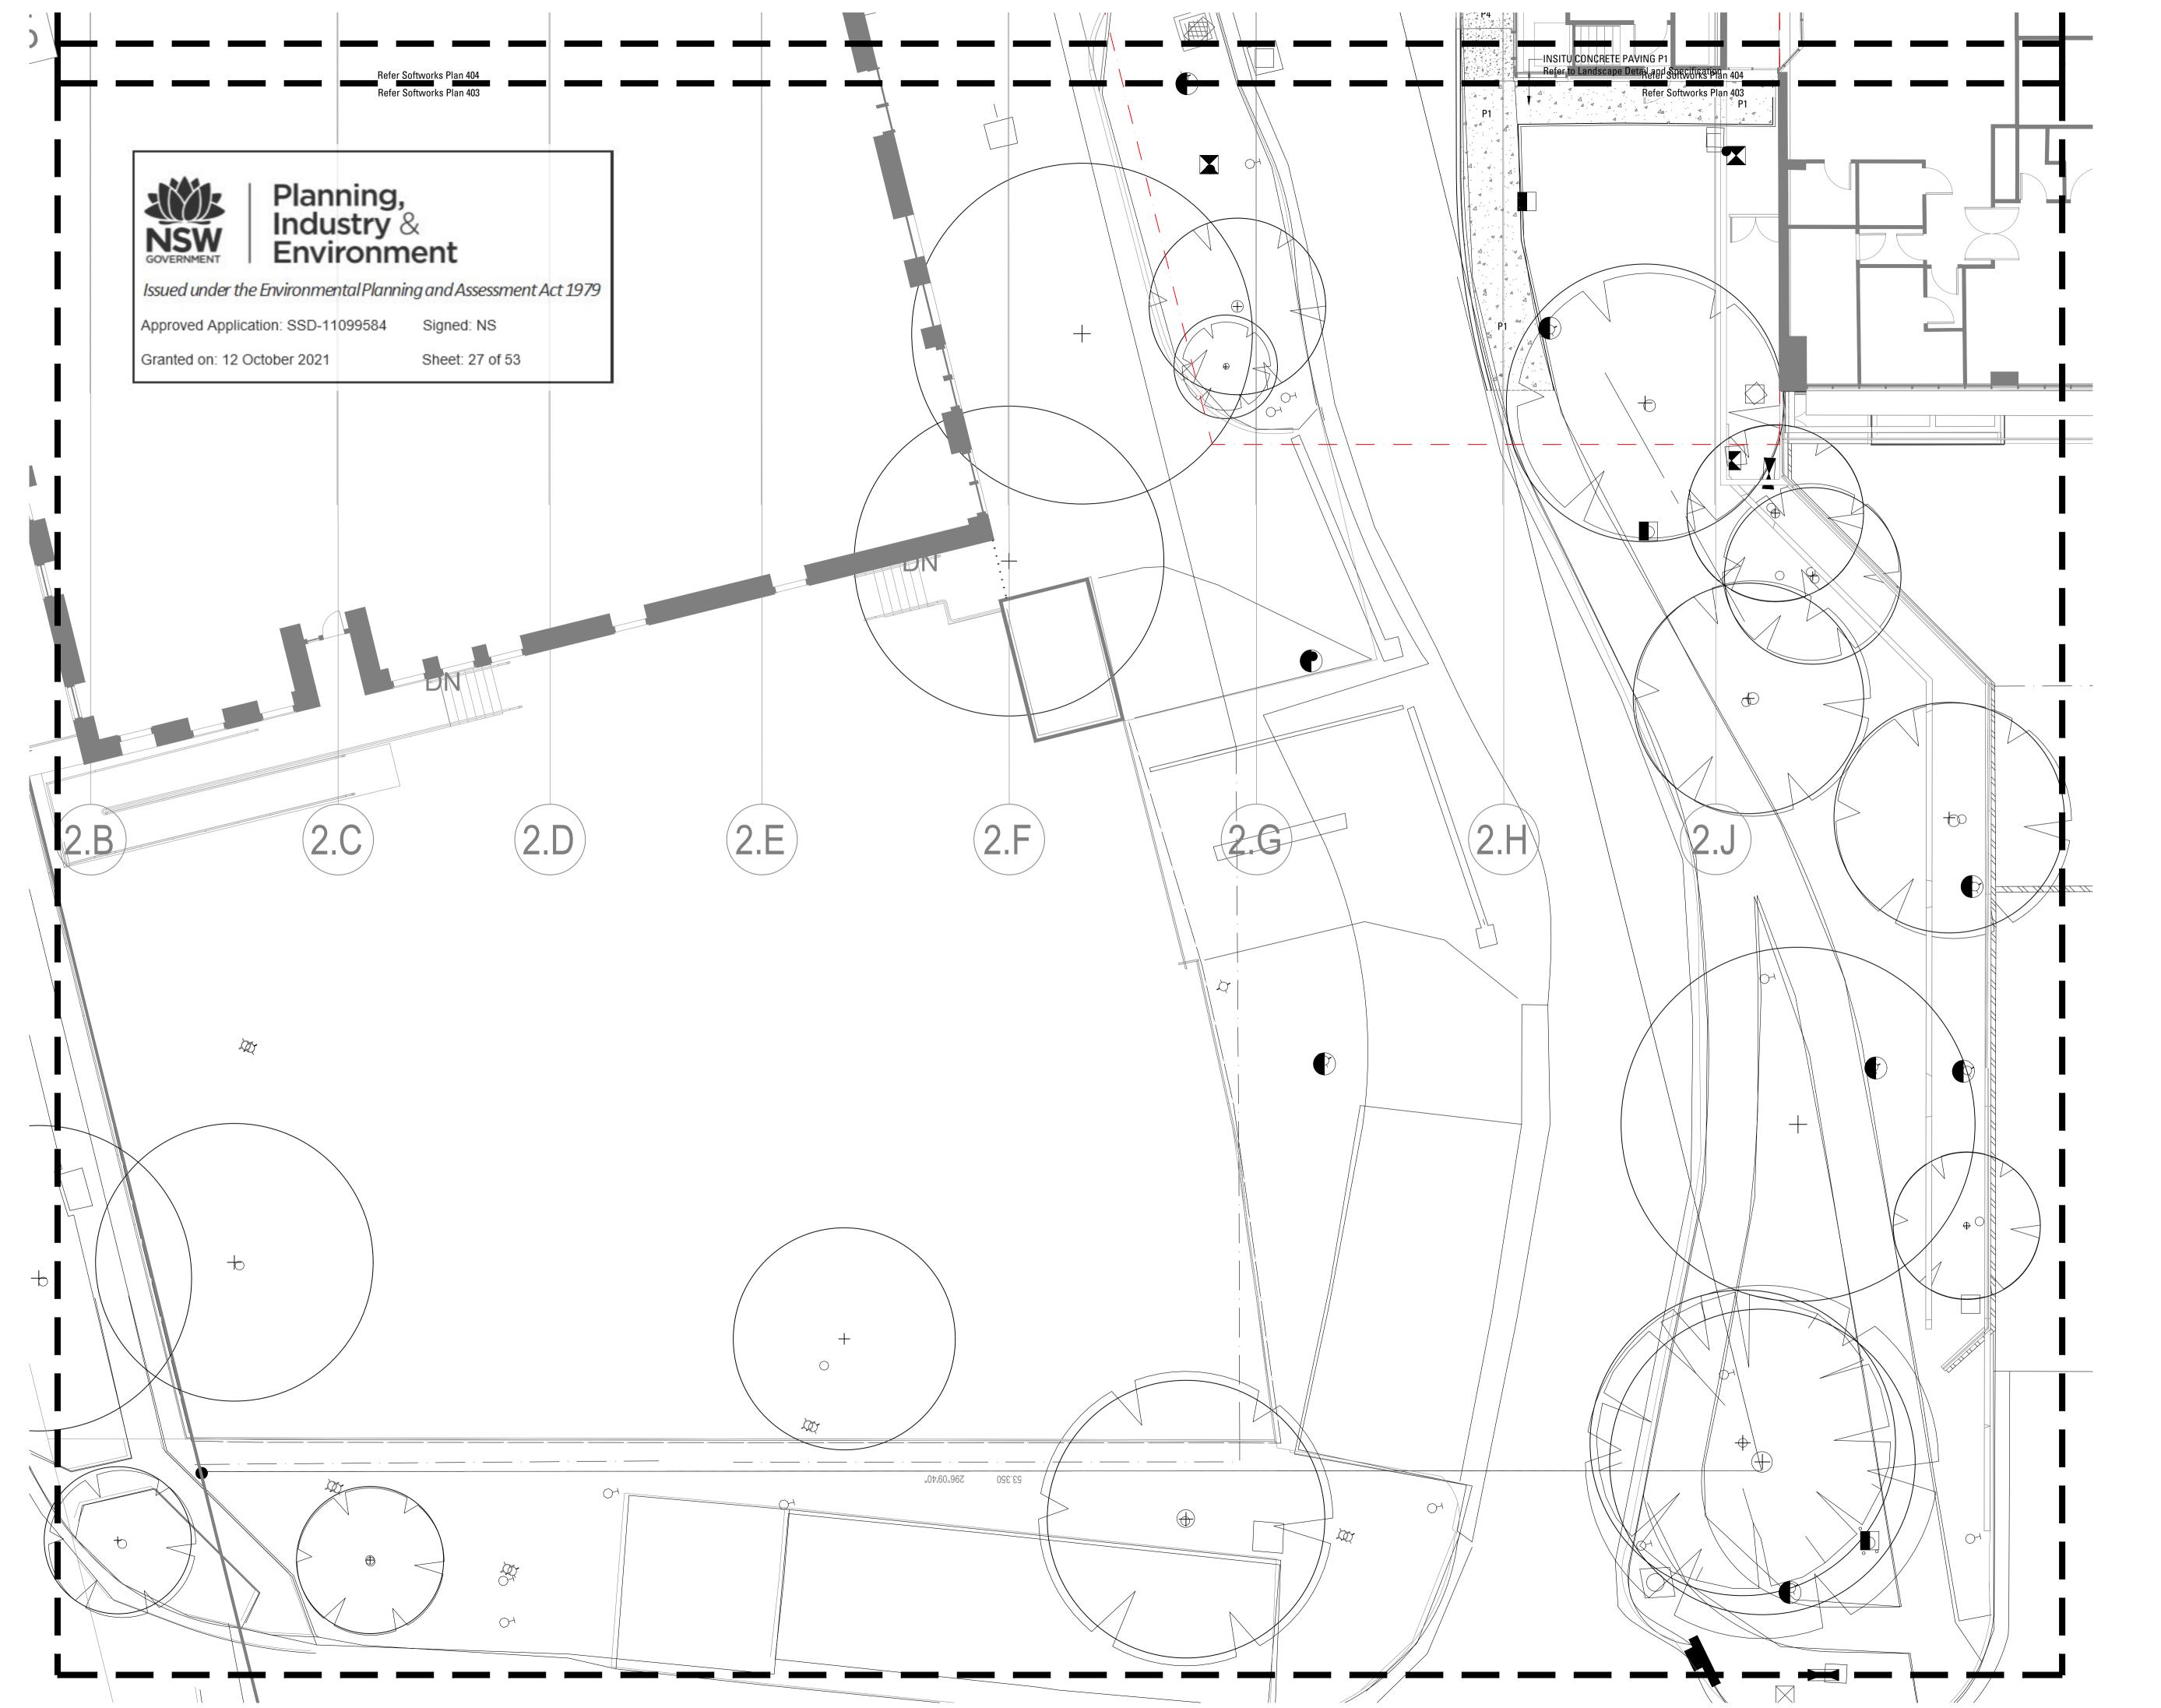

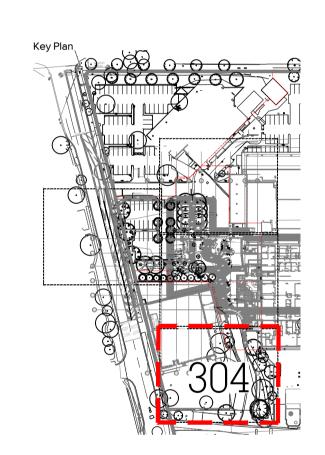

Issue Revision Description Drawn Check Date


Not for Construction

Sutherland Hospital Kingsway & Kareena Rd Caringbah NSW 2229

Tender

Drawing No. Drawing Name Hardworks

1:100 @ A1 Sydney, Suite 76, Jones Bay Wharf, 26-32 Pirrama Road, Pyrmont NSW 2009 E sydney@arcadiala.com.au T 02 8571 2900 E Sydney. Brisbane@arcadiala.com.au T 07 3071 8000

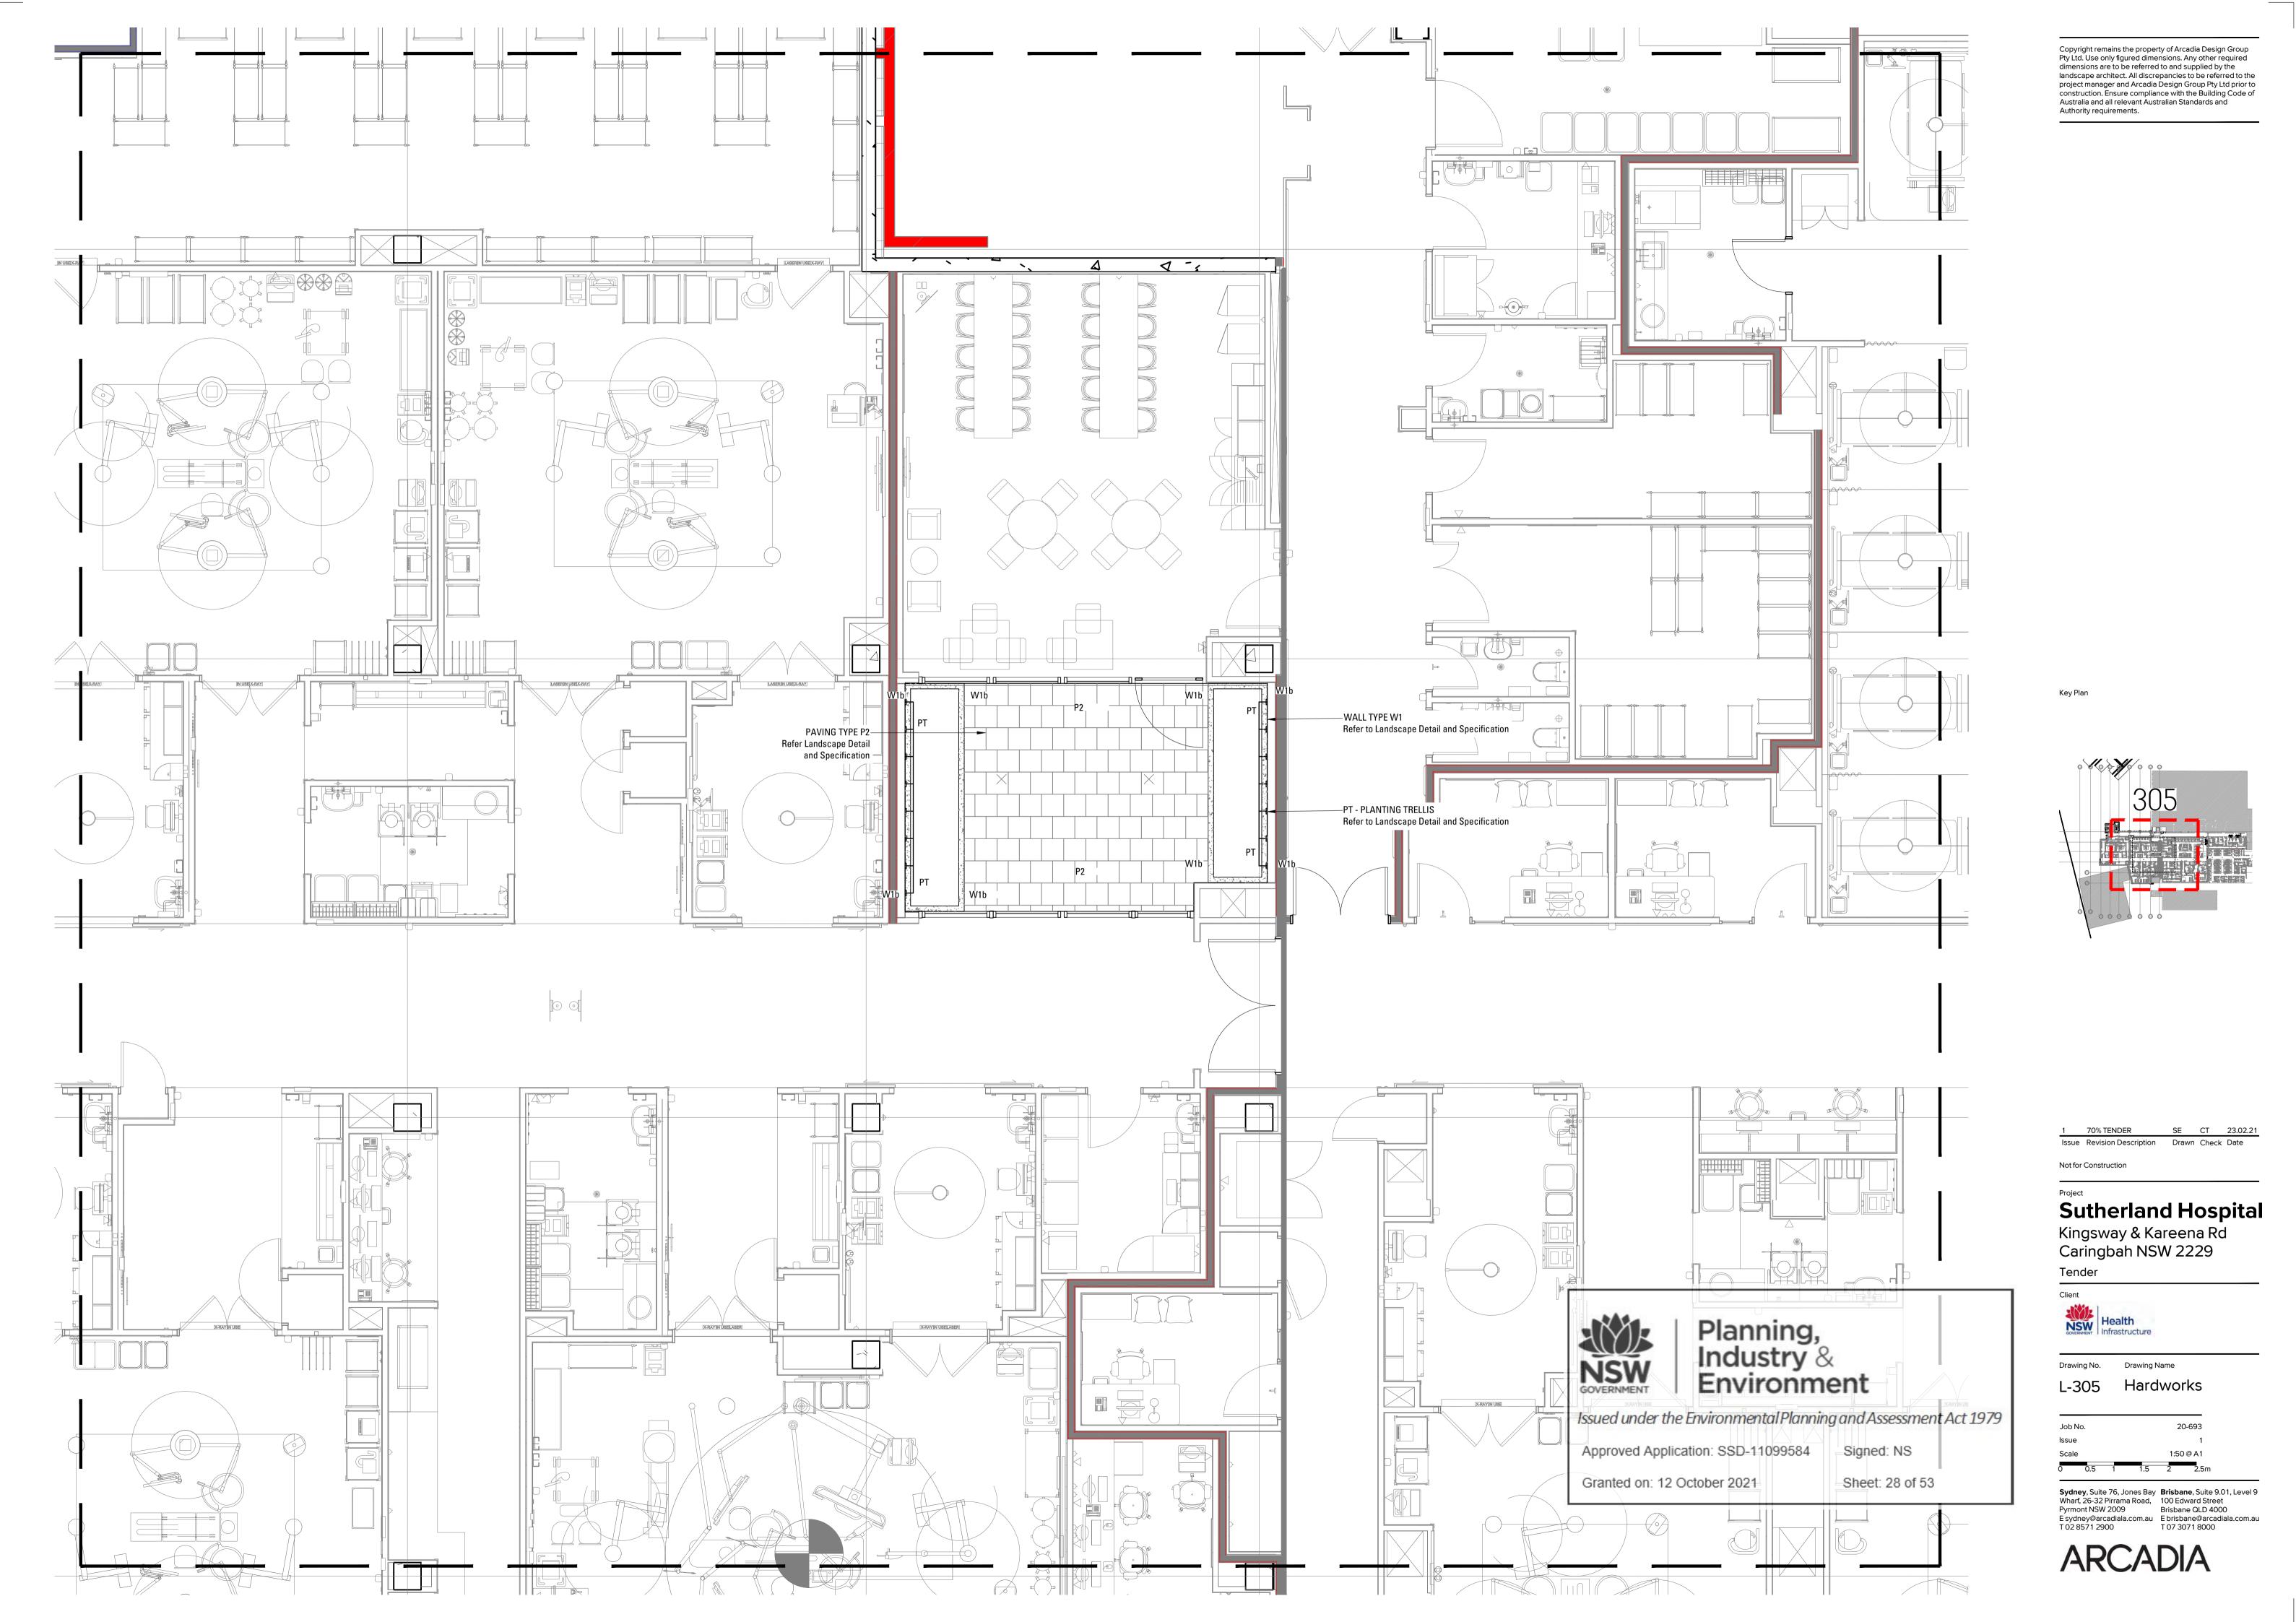

0 000	SUTHERLAND HOSPITAL P	LAIT OUILDOLL			
					- 40, 1
CODE	BOTANIC NAME	COMMON NAME	MATURE SIZE (h x w) (m)	PROPOSED POT SIZE	QUANTITY
	TREES & PALMS				
Ac	Angophora costata	Smooth-Barked Apple	20 x 10	100L	2
Eu	Eucalyptus umbra	Broad-leaved white mahogony	5 347 374 37 37	100L	2
Cm	Corymbia maculata	Spotted Gum	25 x 15	200L	8
Er	Elaeocarpus reticulatus	Blueberry Ash	8 x 5	100L	7
	SHRUBS & ACCENTS				
Bs	Banksia serrata	Saw Banksia	3 x 2	200mm	10
BGC	Banksia spinulosa 'Giant Candles'	Giant Candles Banksia	1.5 x 1	200mm	6
Bs	Boronia serrulata	Native Rose	1 x 0.6	200mm	10
Cc	Callistemon citrinus	Bottlebrush	6 x 3	200mm	6
Fe	Ficus elastic	Rubber Fig	2 x 2	300mm	8
Ab	Alocasia brisbanensis	Cunjevoi Lily/ Elephant Ears	2.5 x 1	300mm	186
CBM	Colocasia 'Black Magic'	Black Elephant Ears	1 x 1.5	300mm	42
FI	Ficus lyrata	Fiddleleaf Fig	5 x 3	300mm	26
	GROUNDCOVERS & CLIMBERS				
DSF	Dichondra repens 'Silver Falls'	Silver Falls	0.2 x spreading	150mm	155
Hv	Hardenbergia violacea	False Sarsaparilla	0.25 x spreading	150mm	212
Vh	Viola hederacea	Native Violet	0.25 x spreading 0.2 x 0.5	150mm	384
Ca	Cissus antarctica	Kangeroo Vine	0.5 x spreading	150mm	16
ou	Orosas arranotroa	ikangeree viiie	0.0 x spreading	13011111	10
	CAR PARK MATRIX				
Dr	Dianella revoluta	Spreading Flax Lily	1 x 1.5	150mm	226
LI	Lomandra longifolia	Spiny Headed Mat Rush	1 x 1	150mm	180
Ta	Themeda australis	Kangaroo Grass	1 x 1	150mm	361
Wg	Wahlenbergia gracilis	Blue Bells	0.2 x 0.2	200mm	120
Sc	Scaevola calendulacea	Dune Fan Flower	0.5 x 0.5	200mm	120
Sr	Scaevola ramosissima	Hairy Fan Flower	0.4 x 0.1	200mm	120
Smc	Scaevola aemula	Fan Flower	0.25 x 1	200mm	120
Sa	Scaevola albida	White fan flower	0.2 x 2	200mm	120
GG	Grevillea 'Gaudichaudii'	Grevillea	0.2 x 1.5	150mm	120
	GRASS MATRIX 01				
Dr	Dianella revoluta	Spreading Flax Lily	1 x 1.5	150mm	94
LI	Lomandra longifolia	Spiny Headed Mat Rush	1 x 1.3	150mm	78
Lm	Lomandra multiflora	Mat Rush	1 x 1	150mm	62
Та	Themeda australis	Kangaroo Grass	1 x 1	150mm	94
Cg	Carpobrotus glaucescens	Pig Face	0.25 x spreading	150mm	83
BRC	Banksia integrifolia 'Roller Coaster'	Banksia	0.25 x spreading 0.5 x 4	150mm	83
DITO	Danksia integritoria nonei coaster	Daliksia	0.5 X 4	13011111	03
	ENTRANCE MATRIX				
			0.00	200	100
Sa	Scaevola alhida	IWhite tan flower		Julimm i	1117
Sa Dd	Scaevola albida Damniera diversifolia	White fan flower	0.2 x 2 0.4 x 1	200mm 150mm	102 45
Sa Dd Dc	Scaevola albida Dampiera diversifolia Dianella caerulea	Dampiera Flax Lily	0.2 x 2 0.4 x 1 0.5 x 0.5	150mm 150mm	45 68

	SHADE MATRIX 01				
Dr	Dianella revoluta	Spreading Flax Lily	1 x 1.5	150mm	51
Hv	Hardenbergia violacea	False Sarsaparilla	0.25 x spreading	150mm	183
Dc	Dianella caerula	Flax Lily	0.25 x spreading 0.5 x 0.5	720000	86
		Blue Bells		150mm	
Wc	Wahlenbergia communis		0.15 x 0.15	200mm	114
Lm	Liriope muscari	Liriope	0.4 x 0.5	150mm	114
	SHADE MATRIX 02				
Ad	Adiantum aethiopicum	Maidenhair Fern	0.5 x 0.5	200mm	75
DSF	Dichondra repens 'Silver Falls'	Silver Falls	0.2 x spreading	150mm	168
Aa	Asplenium australasicum	Birds Nest Fern	1.5 x 1.5	200mm	37
Hm	Hypolepis muellerii	Harsh Ground Fern	0.3 x 1	200mm	70
Cc	Cyathea cooperi	Tree Fern	5 x 2	200mm	14
Cco	Calomnion complanatum	Calomnion Moss	0.1 x spreading	200mm	56
	SHADE MATRIX 03				
Са	Cyathea australis	Rough Tree Fern	5 x 2	200mm	8
Вс	Barbula calycina	Barbula Moss	0.1 x Spreading	200mm	80
Bn	Blechnum nudum	Fishbone water fern	1 x 1	200mm	96
Af	Adiantum formosum	Giant Maidenhair	1.2 x 0.6	200mm	60
Da	Dicksonia antarctica	Scaly Tree Fern	9 x 4	200mm	12
Vh	Viola hederacea	Native Violet	0.2 x 0.5	150mm	64
DSF	Dichondra repens 'Silver Falls'	Silver Falls	0.2 x spreading	150mm	12
Lm	Liriope muscari	Liriope	0.4 x 0.5	150mm	64

Key Plan



Issued under the Environmental Planning and Assessment Act 1979

Approved Application: SSD-11099584

Signed: NS

Granted on: 12 October 2021

Sheet: 29 of 53

1 70% TENDER SE CT 23.02.21

Issue Revision Description Drawn Check Date

Not for Construction

Sutherland Hospital

Kingsway & Kareena Rd Caringbah NSW 2229 ^{Tender}

Client



Drawing No. Drawing Name


L-400 Softworks Plan

Job No. 20-693

Scale 1:100 @ A1
0 1 2 3 4 5m

Sydney, Suite 76, Jones Bay Wharf, 26-32 Pirrama Road, Pyrmont NSW 2009 E sydney@arcadiala.com.au T 02 8571 2900 E Brisbane@arcadiala.com.au T 07 3071 8000



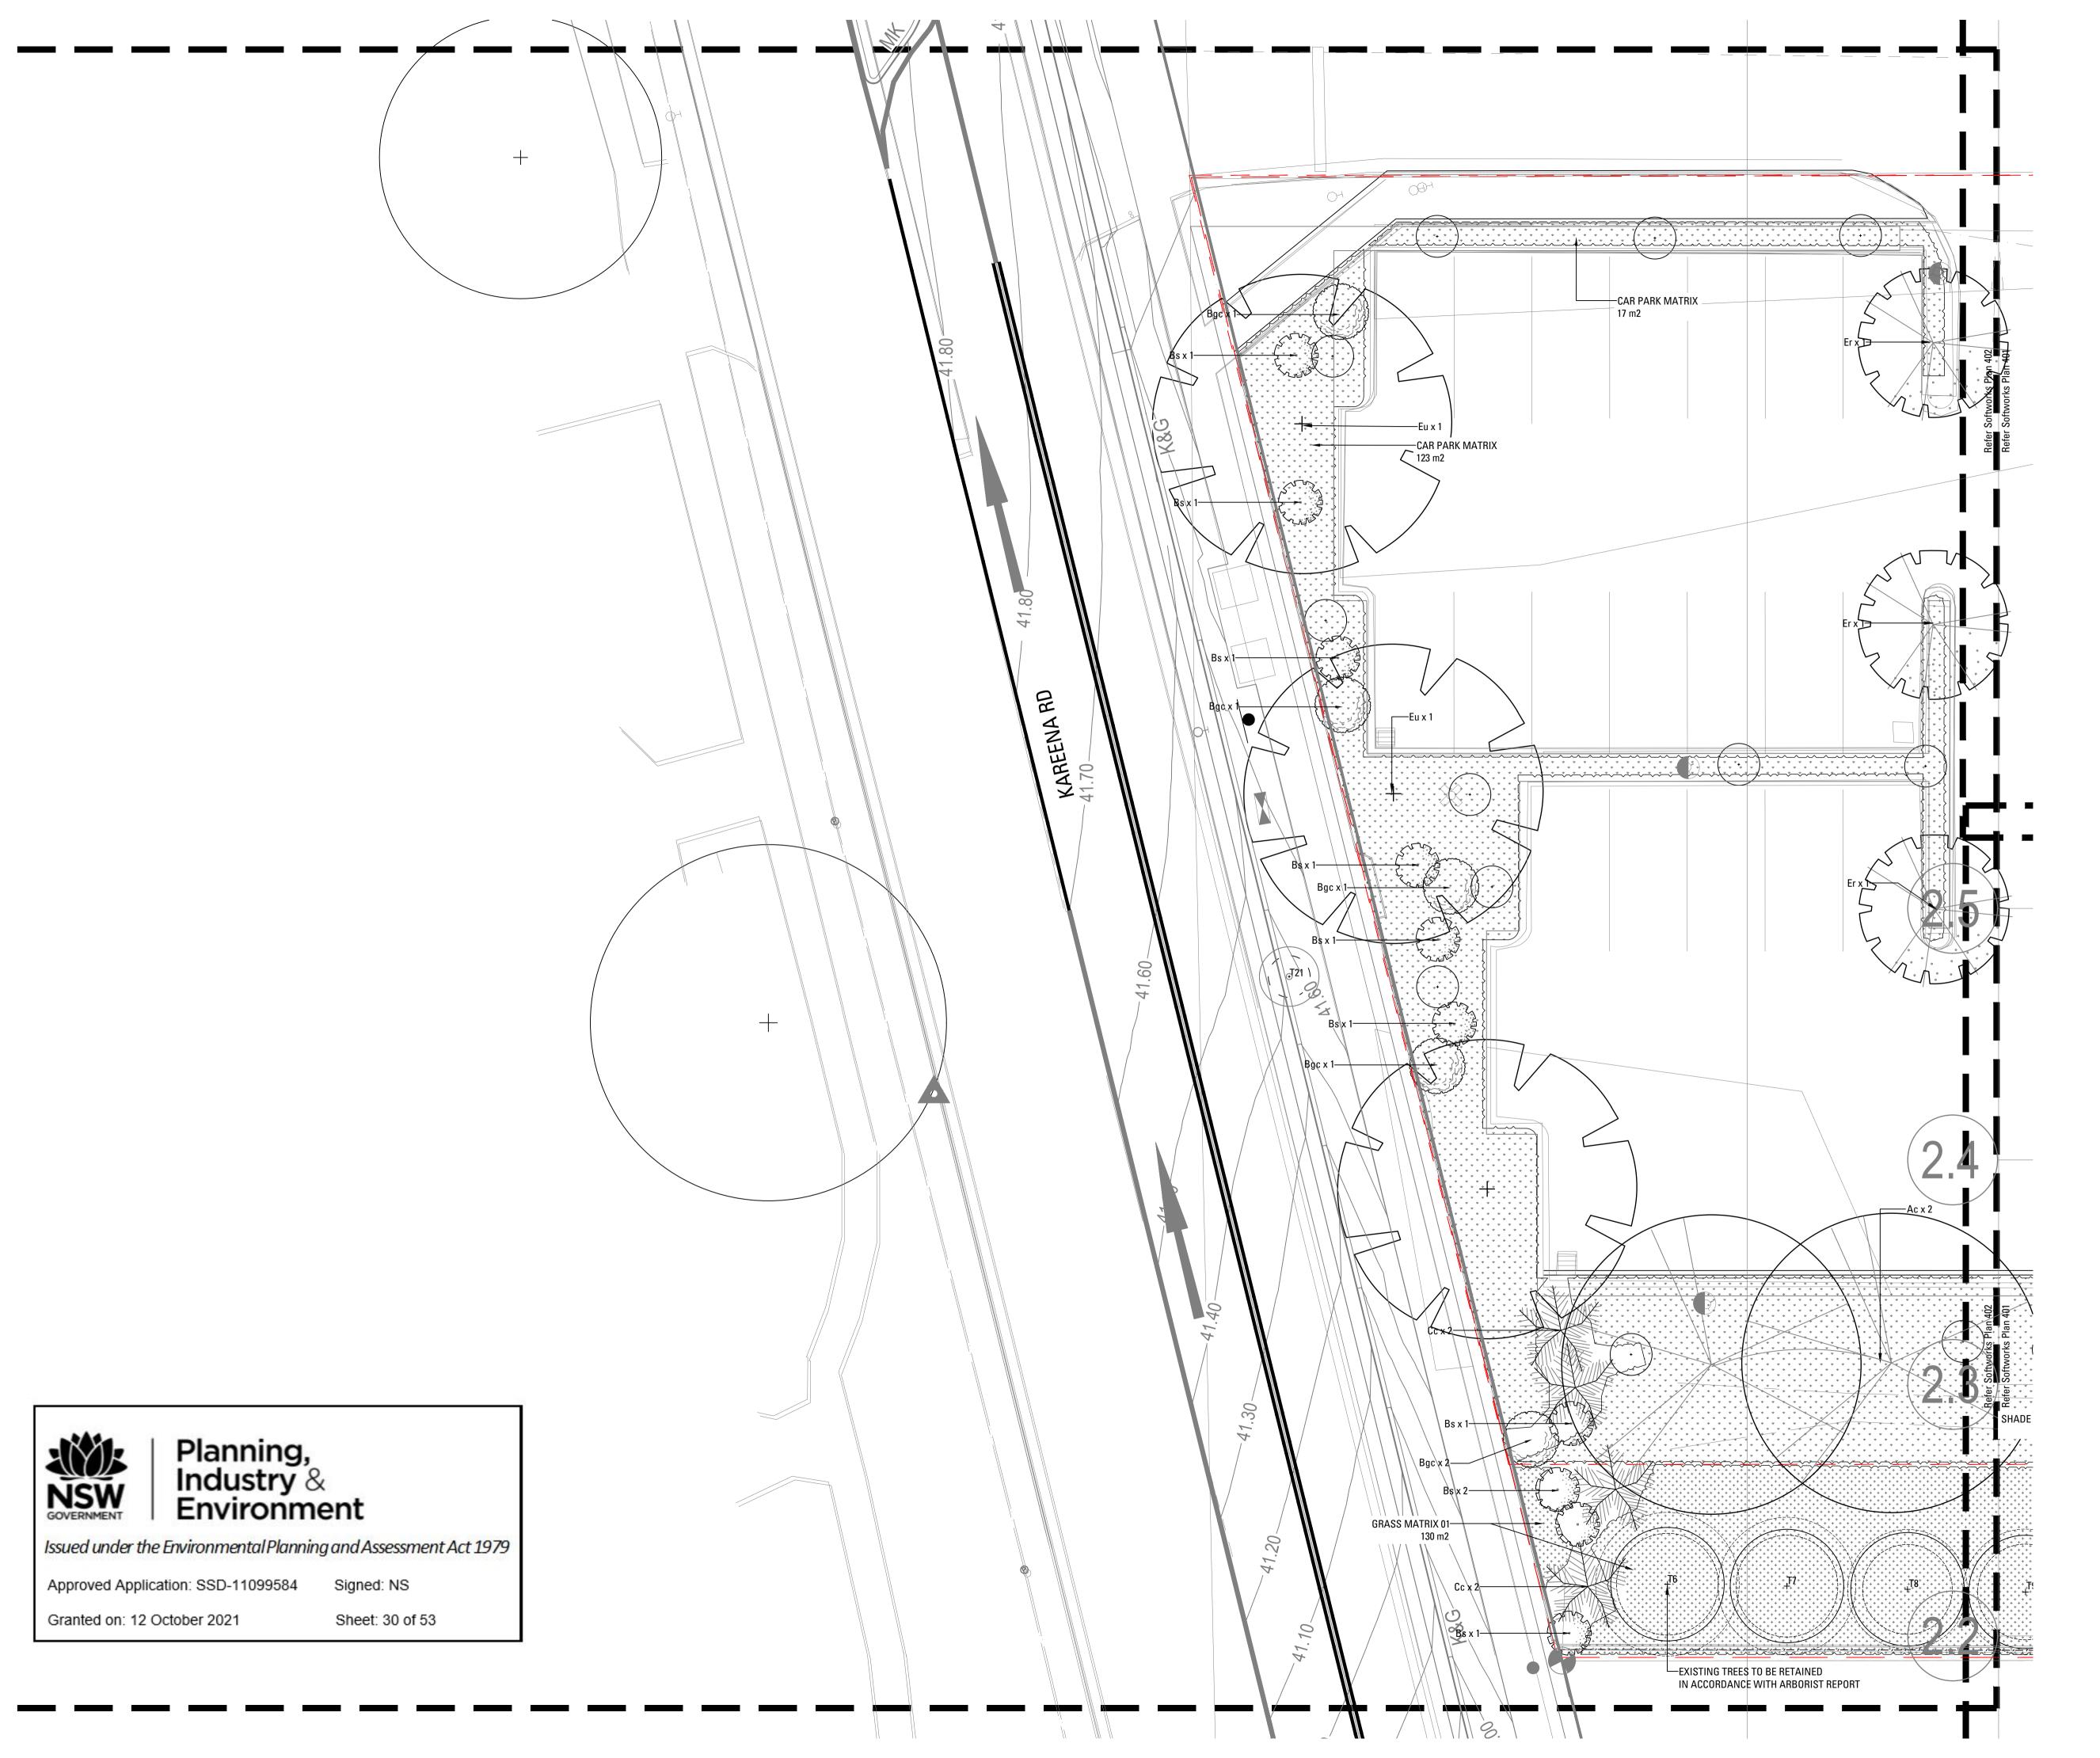

> EXISTING TREES TO BE RETAINED Refer Landscape Specification EXISTING TREES TO BE REMOVED Refer Landscape Specification

FEATURE TREE PLANTING
Refer Landscape Specification SHRUB AND ACCENT PLANTING
Refer Landscape Specification

CAR PARK MATRIX Refer Landscape Specification

ENTRANCE MATRIX Refer Landscape Specification

GRASS MATRIX Refer Landscape Specification

SHADE MATRIX 01 Refer Landscape Specification

SHADE MATRIX 02 Refer Landscape Specification

SHADE MATRIX 03 Refer Landscape Specification

TURF Refer Landscape Specification

Issue Revision Description Drawn Check Date


Not for Construction


Sutherland Hospital Kingsway & Kareena Rd Caringbah NSW 2229

Tender

Drawing Name Softworks Plan

Sydney, Suite 76, Jones Bay Wharf, 26-32 Pirrama Road, Pyrmont NSW 2009 E sydney@arcadiala.com.au T 02 8571 2900 E Sydney. Brisbane@arcadiala.com.au T 07 3071 8000

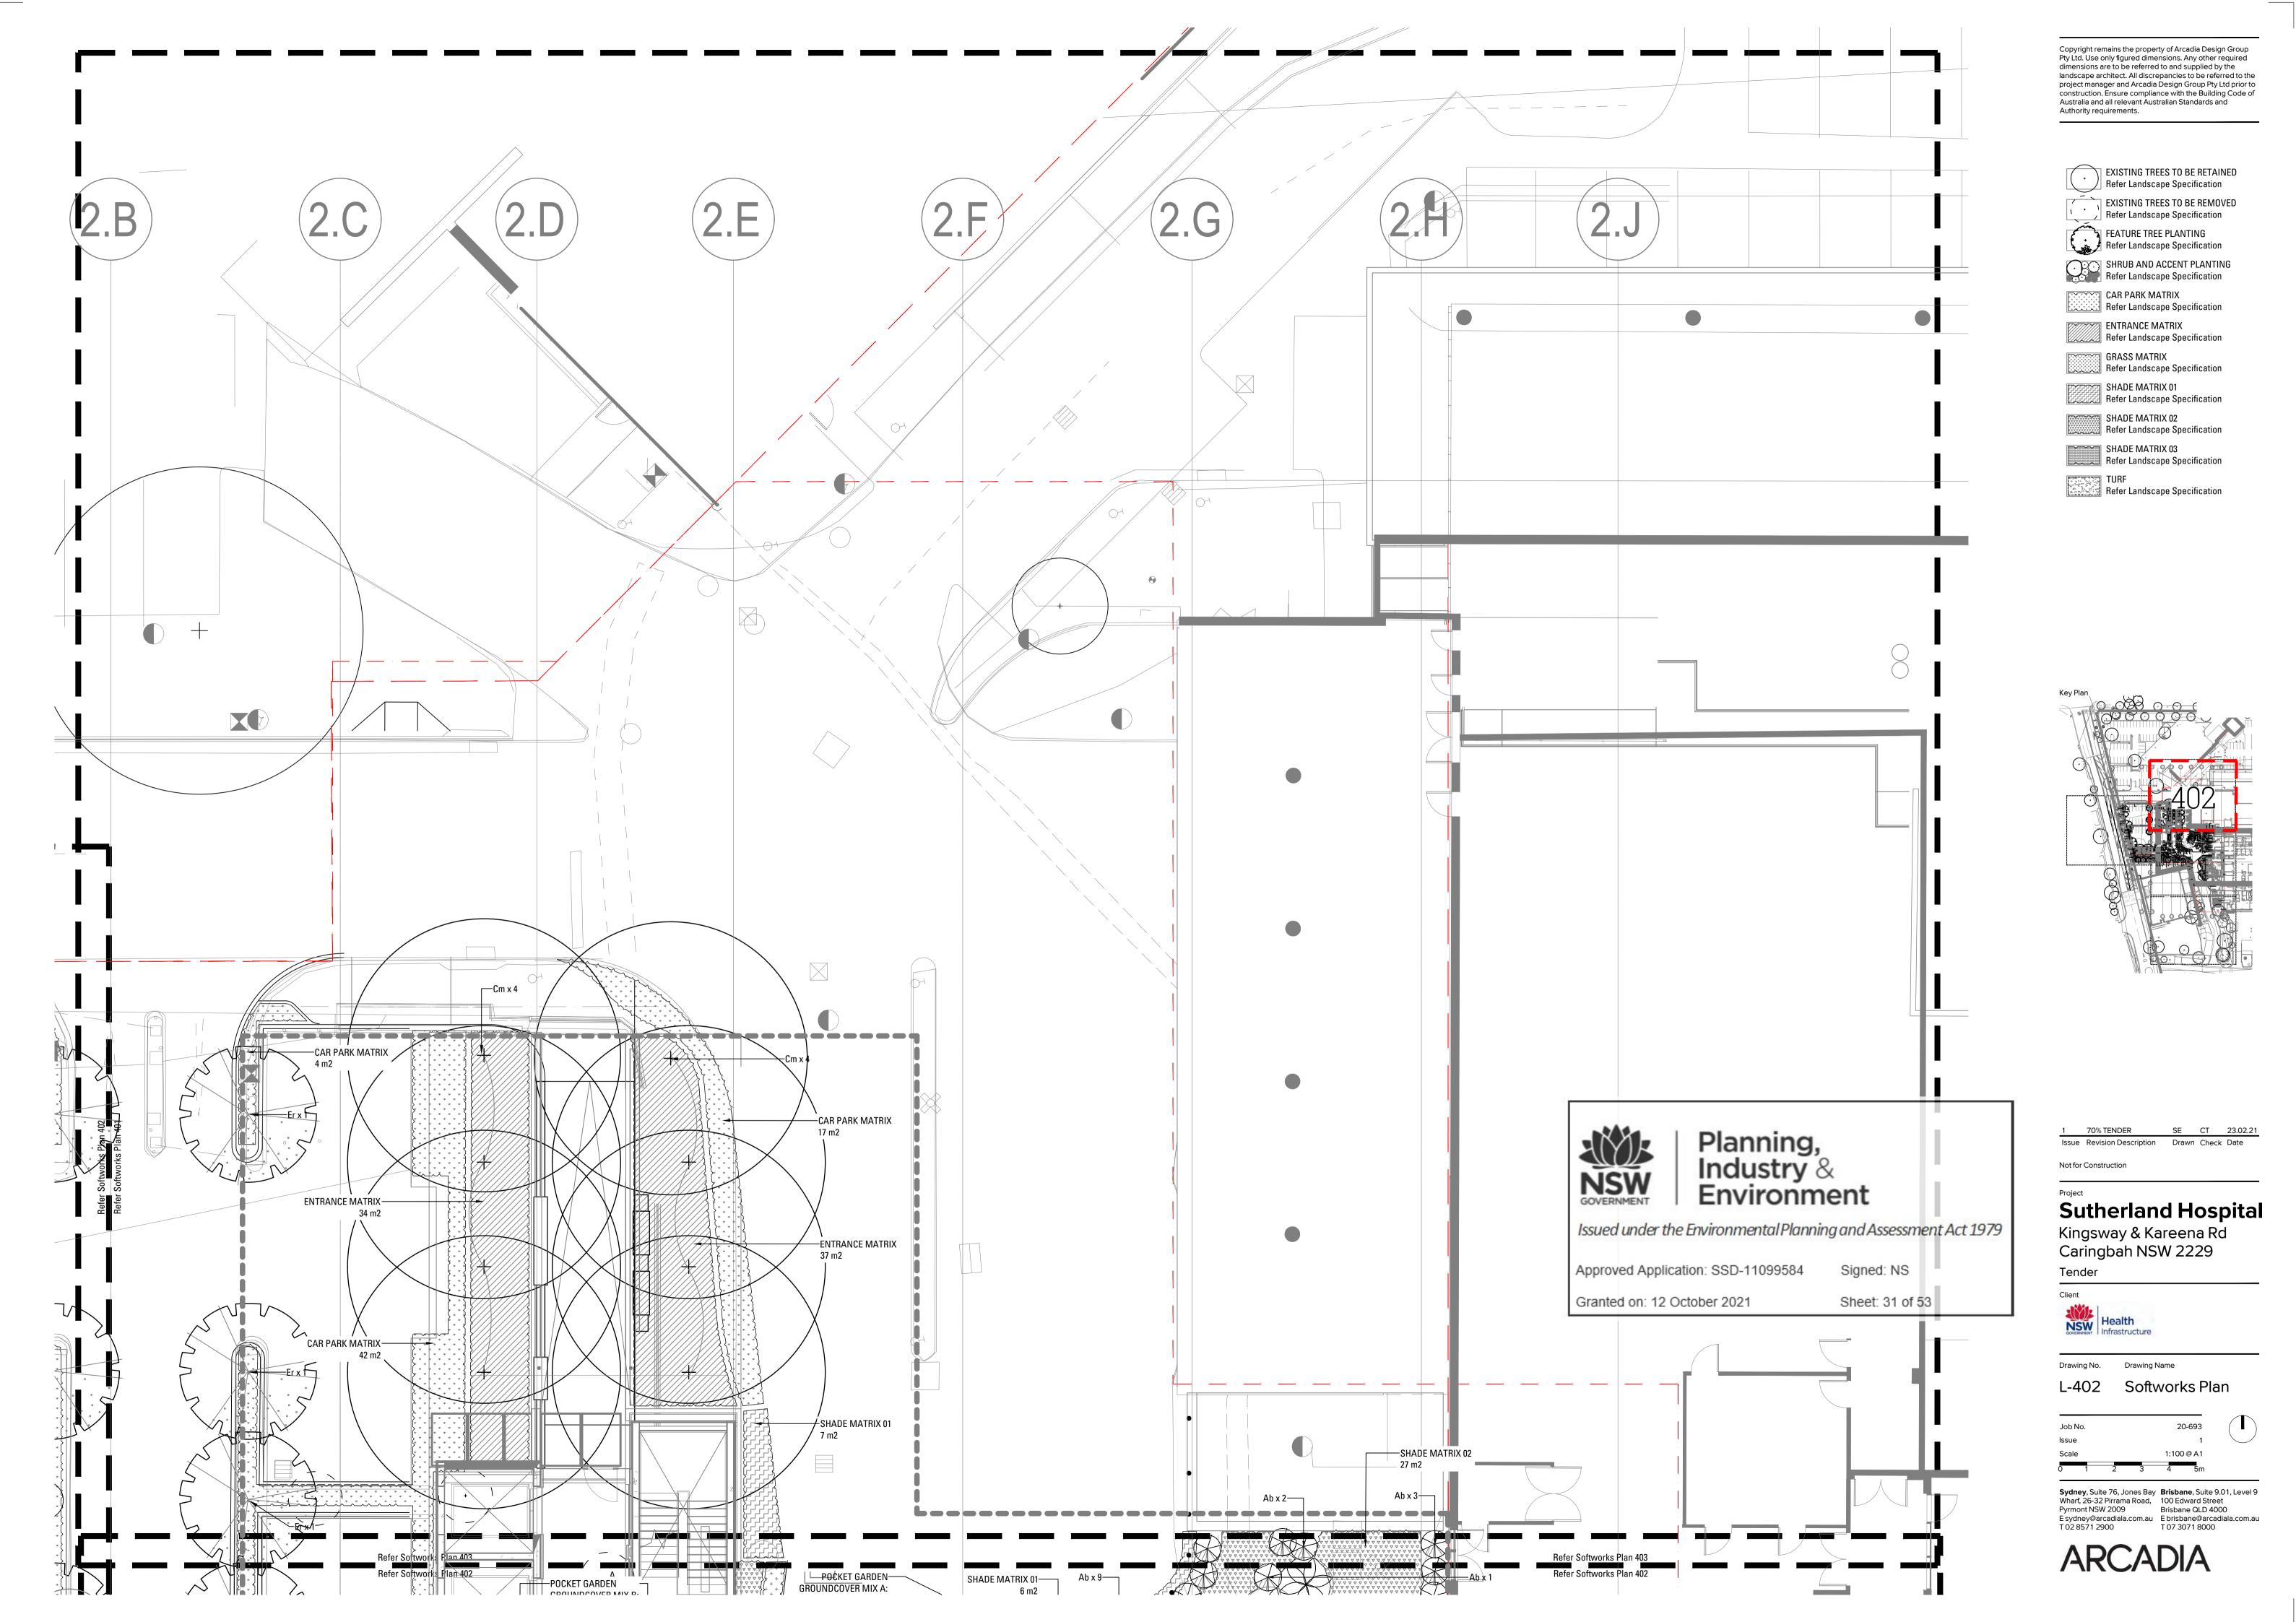

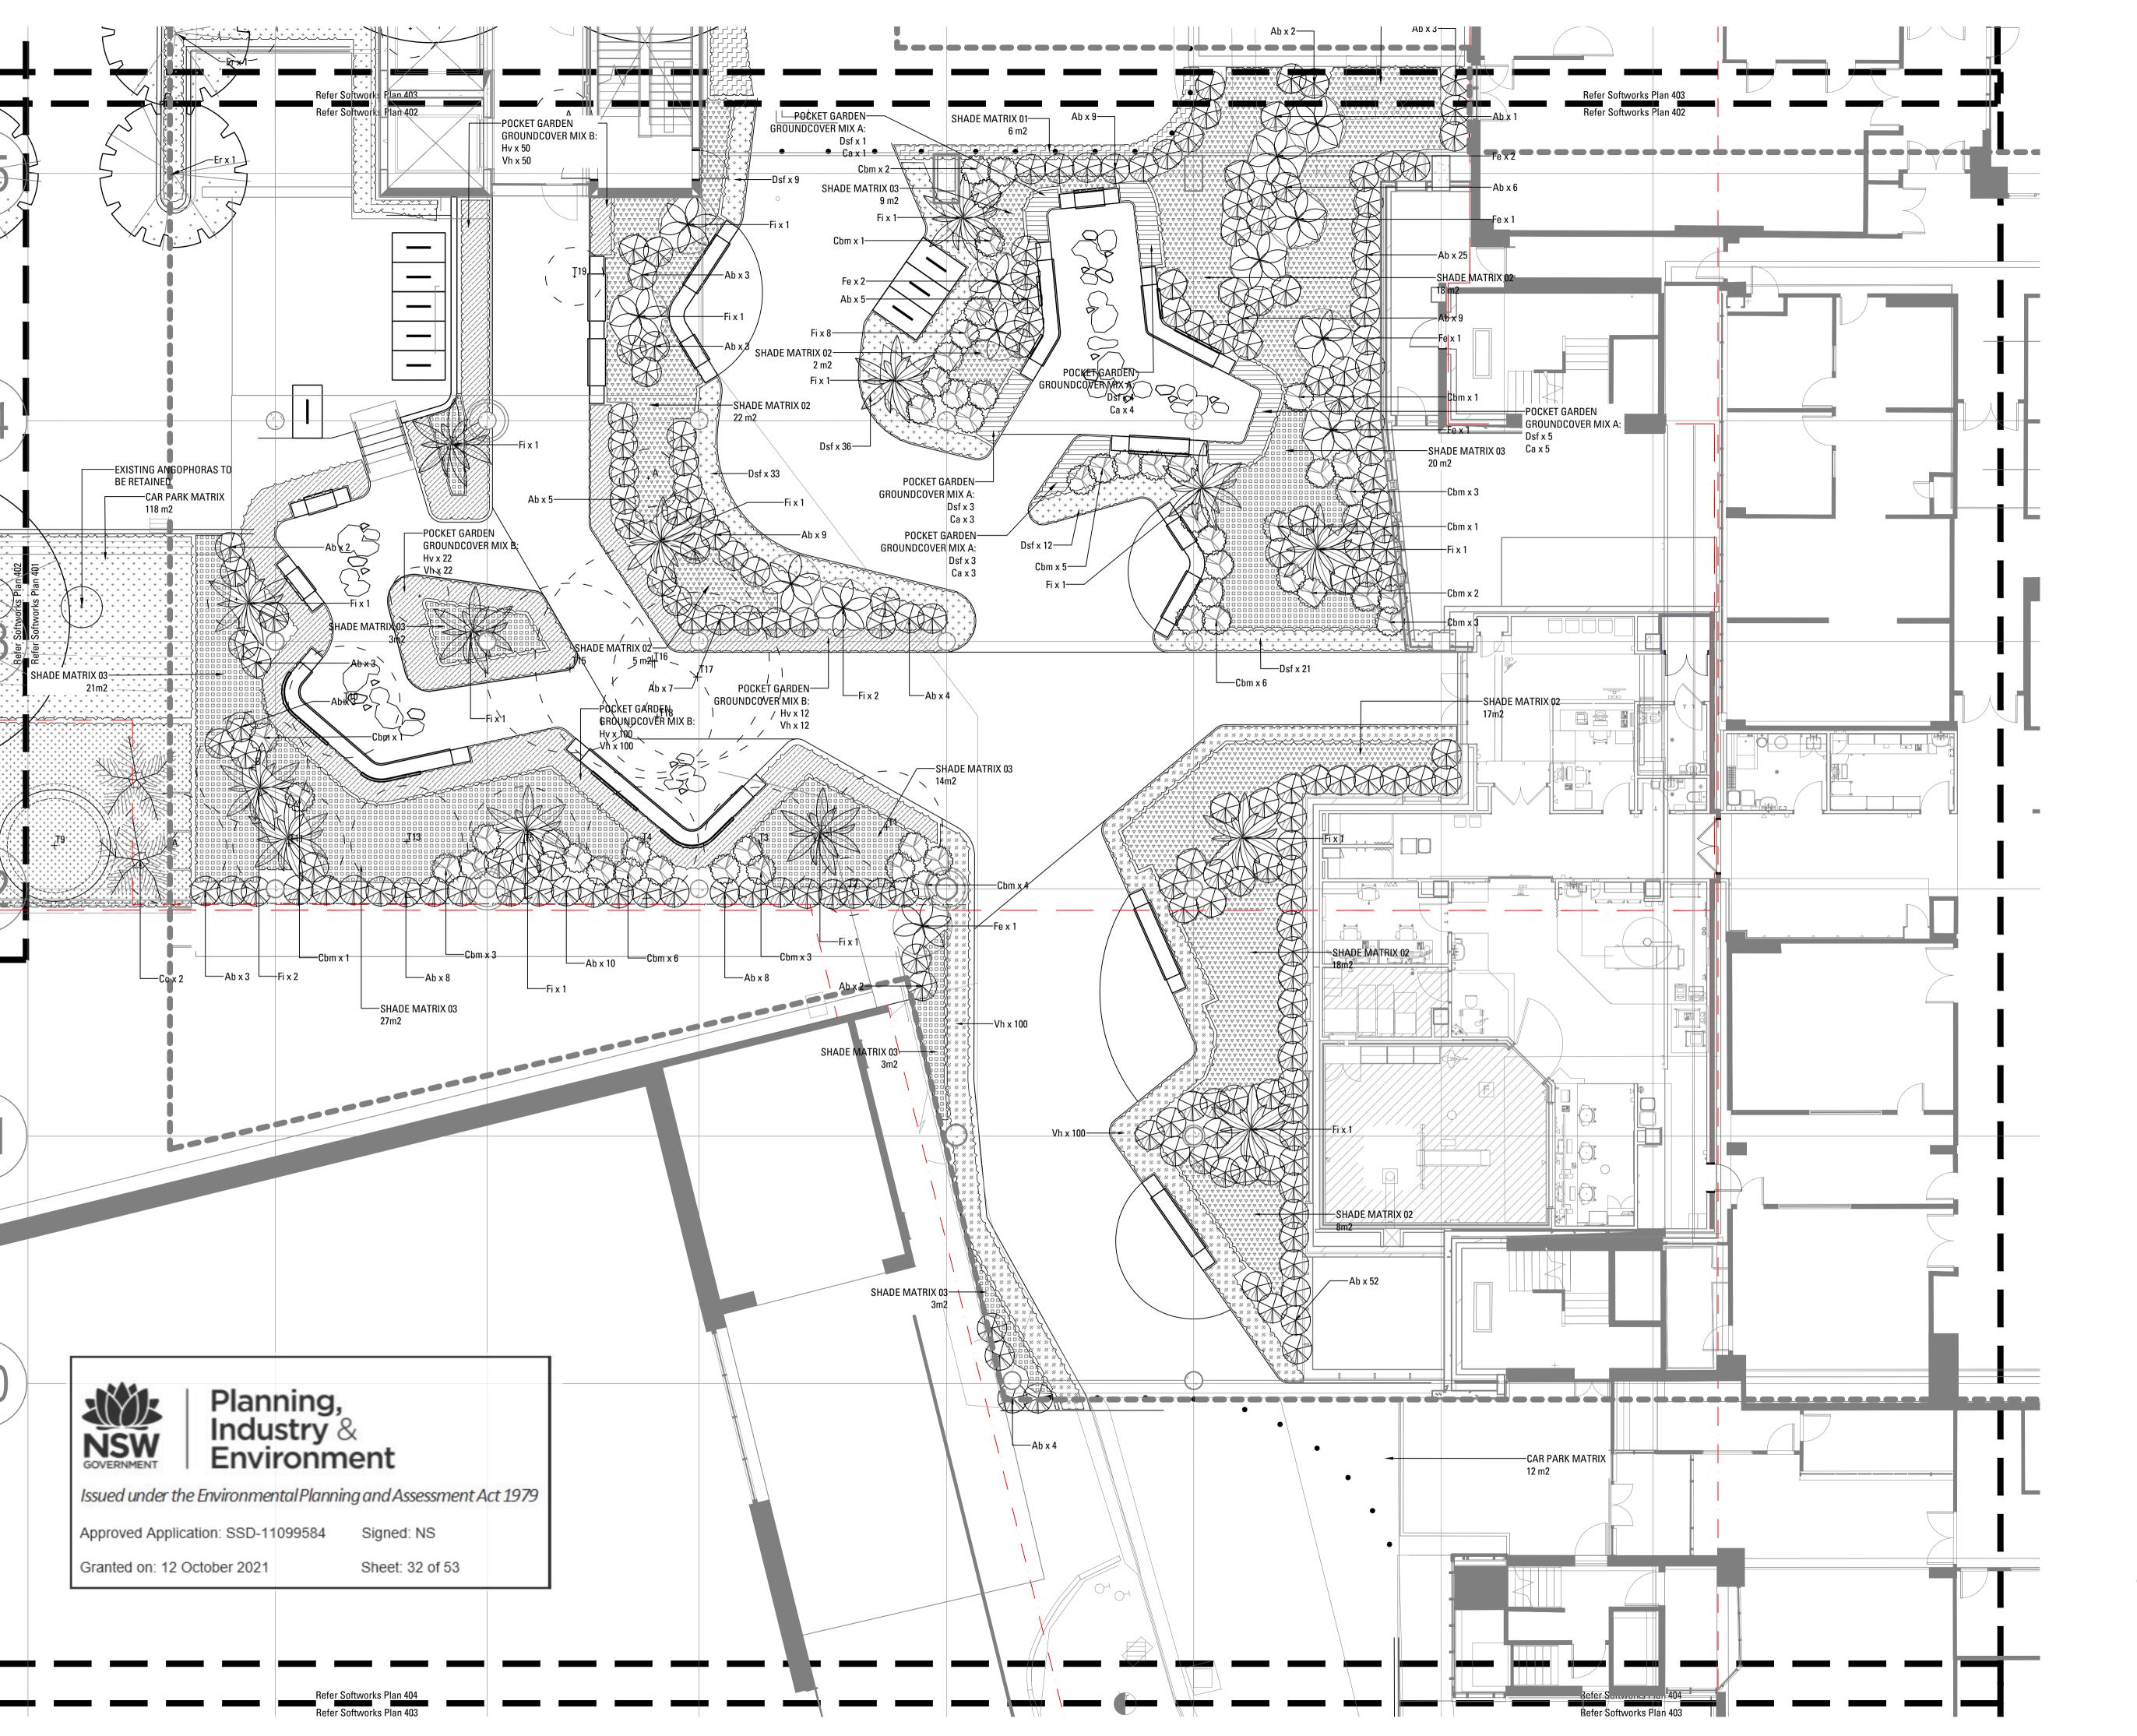

EXISTING TREES TO BE RETAINED Refer Landscape Specification

EXISTING TREES TO BE REMOVED Refer Landscape Specification FEATURE TREE PLANTING

SHRUB AND ACCENT PLANTING Refer Landscape Specification

CAR PARK MATRIX Refer Landscape Specification

ENTRANCE MATRIX Refer Landscape Specification


GRASS MATRIX Refer Landscape Specification

SHADE MATRIX 01 Refer Landscape Specification

SHADE MATRIX 02 Refer Landscape Specification

SHADE MATRIX 03

Refer Landscape Specification Refer Landscape Specification

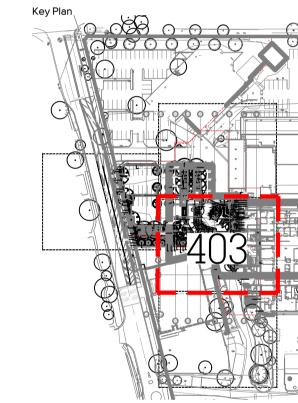

Issue Revision Description Drawn Check Date

Not for Construction

Sutherland Hospital

Kingsway & Kareena Rd Caringbah NSW 2229 Tender




Drawing Name

Softworks Plan

Sydney, Suite 76, Jones Bay Wharf, 26-32 Pirrama Road, Pyrmont NSW 2009 Brisbane QLD 4000

E sydney@arcadiala.com.au T 02 8571 2900 E brisbane@arcadiala.com.au T 07 3071 8000

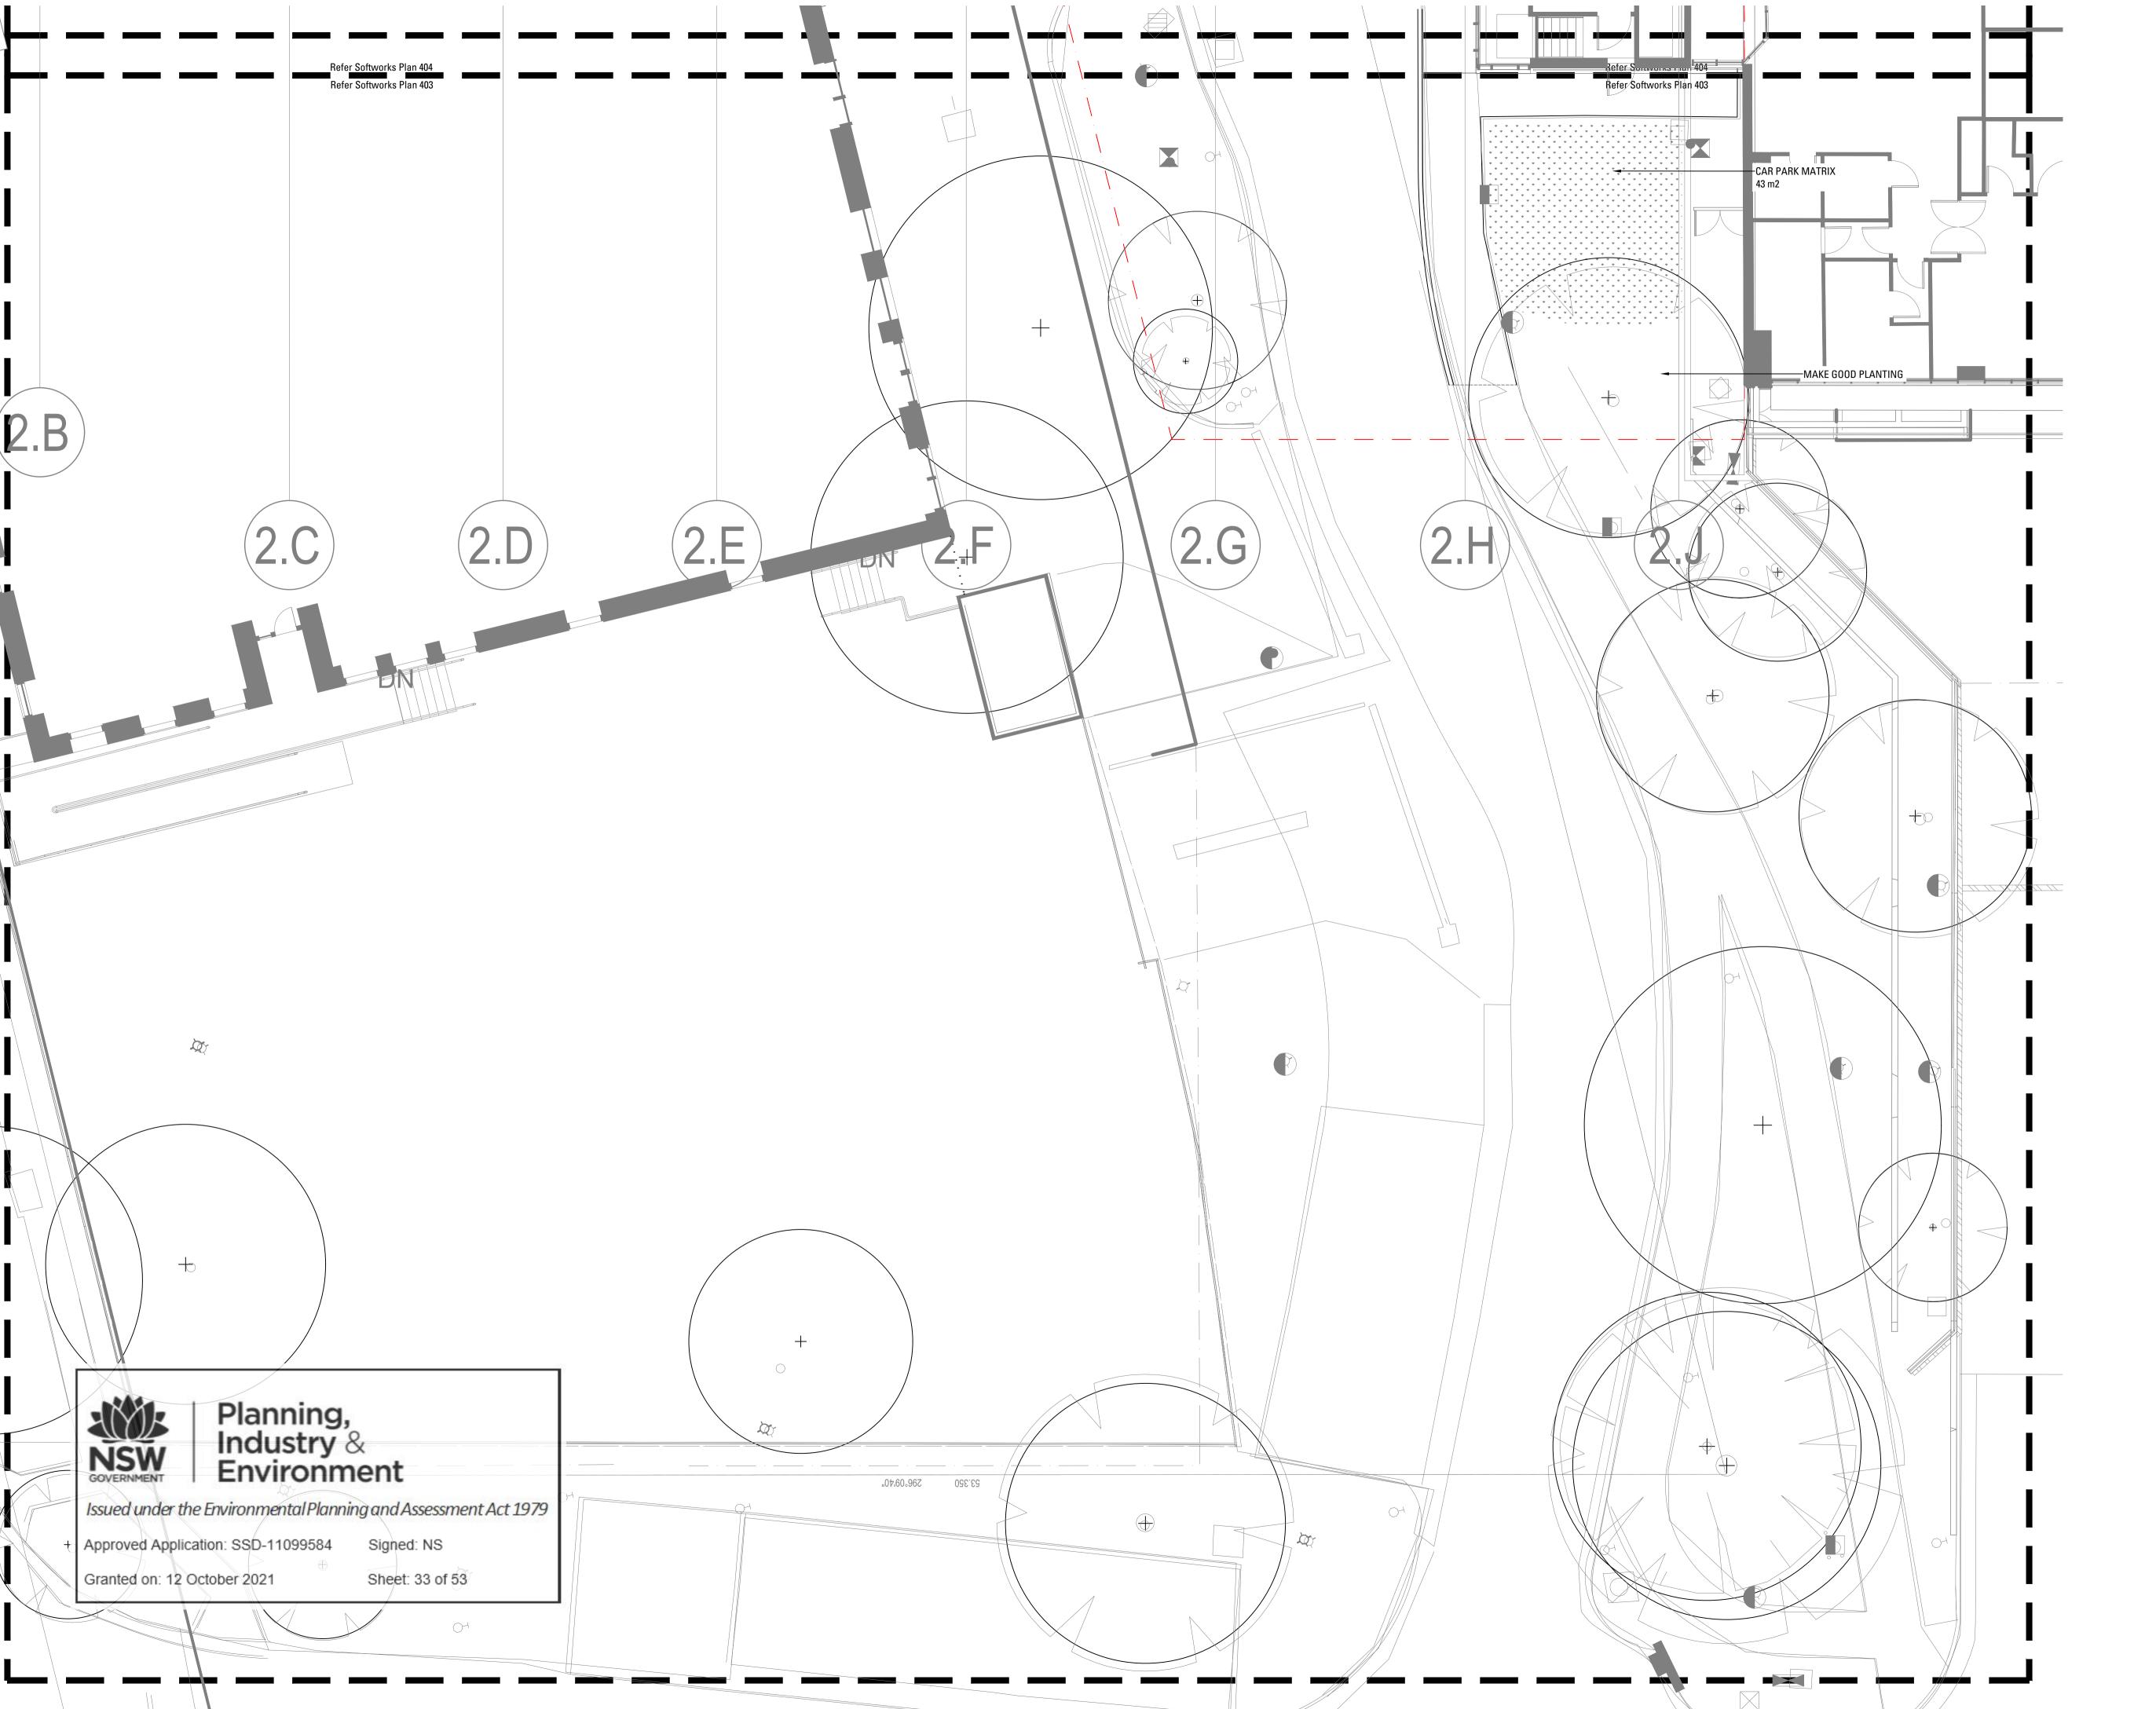

> EXISTING TREES TO BE RETAINED Refer Landscape Specification EXISTING TREES TO BE REMOVED Refer Landscape Specification

FEATURE TREE PLANTING
Refer Landscape Specification

SHRUB AND ACCENT PLANTING
Refer Landscape Specification CAR PARK MATRIX Refer Landscape Specification

ENTRANCE MATRIX

Refer Landscape Specification GRASS MATRIX


Refer Landscape Specification SHADE MATRIX 01

Refer Landscape Specification SHADE MATRIX 02

Refer Landscape Specification

SHADE MATRIX 03 Refer Landscape Specification

TURF Refer Landscape Specification

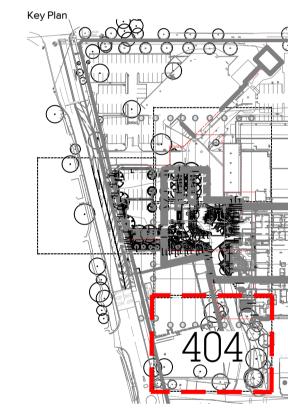

Issue Revision Description Drawn Check Date

Not for Construction

Sutherland Hospital Kingsway & Kareena Rd Caringbah NSW 2229


Tender





Drawing Name


Softworks Plan


Sydney, Suite 76, Jones Bay Wharf, 26-32 Pirrama Road, Pyrmont NSW 2009 E sydney@arcadiala.com.au T 02 8571 2900 E Sydney. Brisbane@arcadiala.com.au T 07 3071 8000

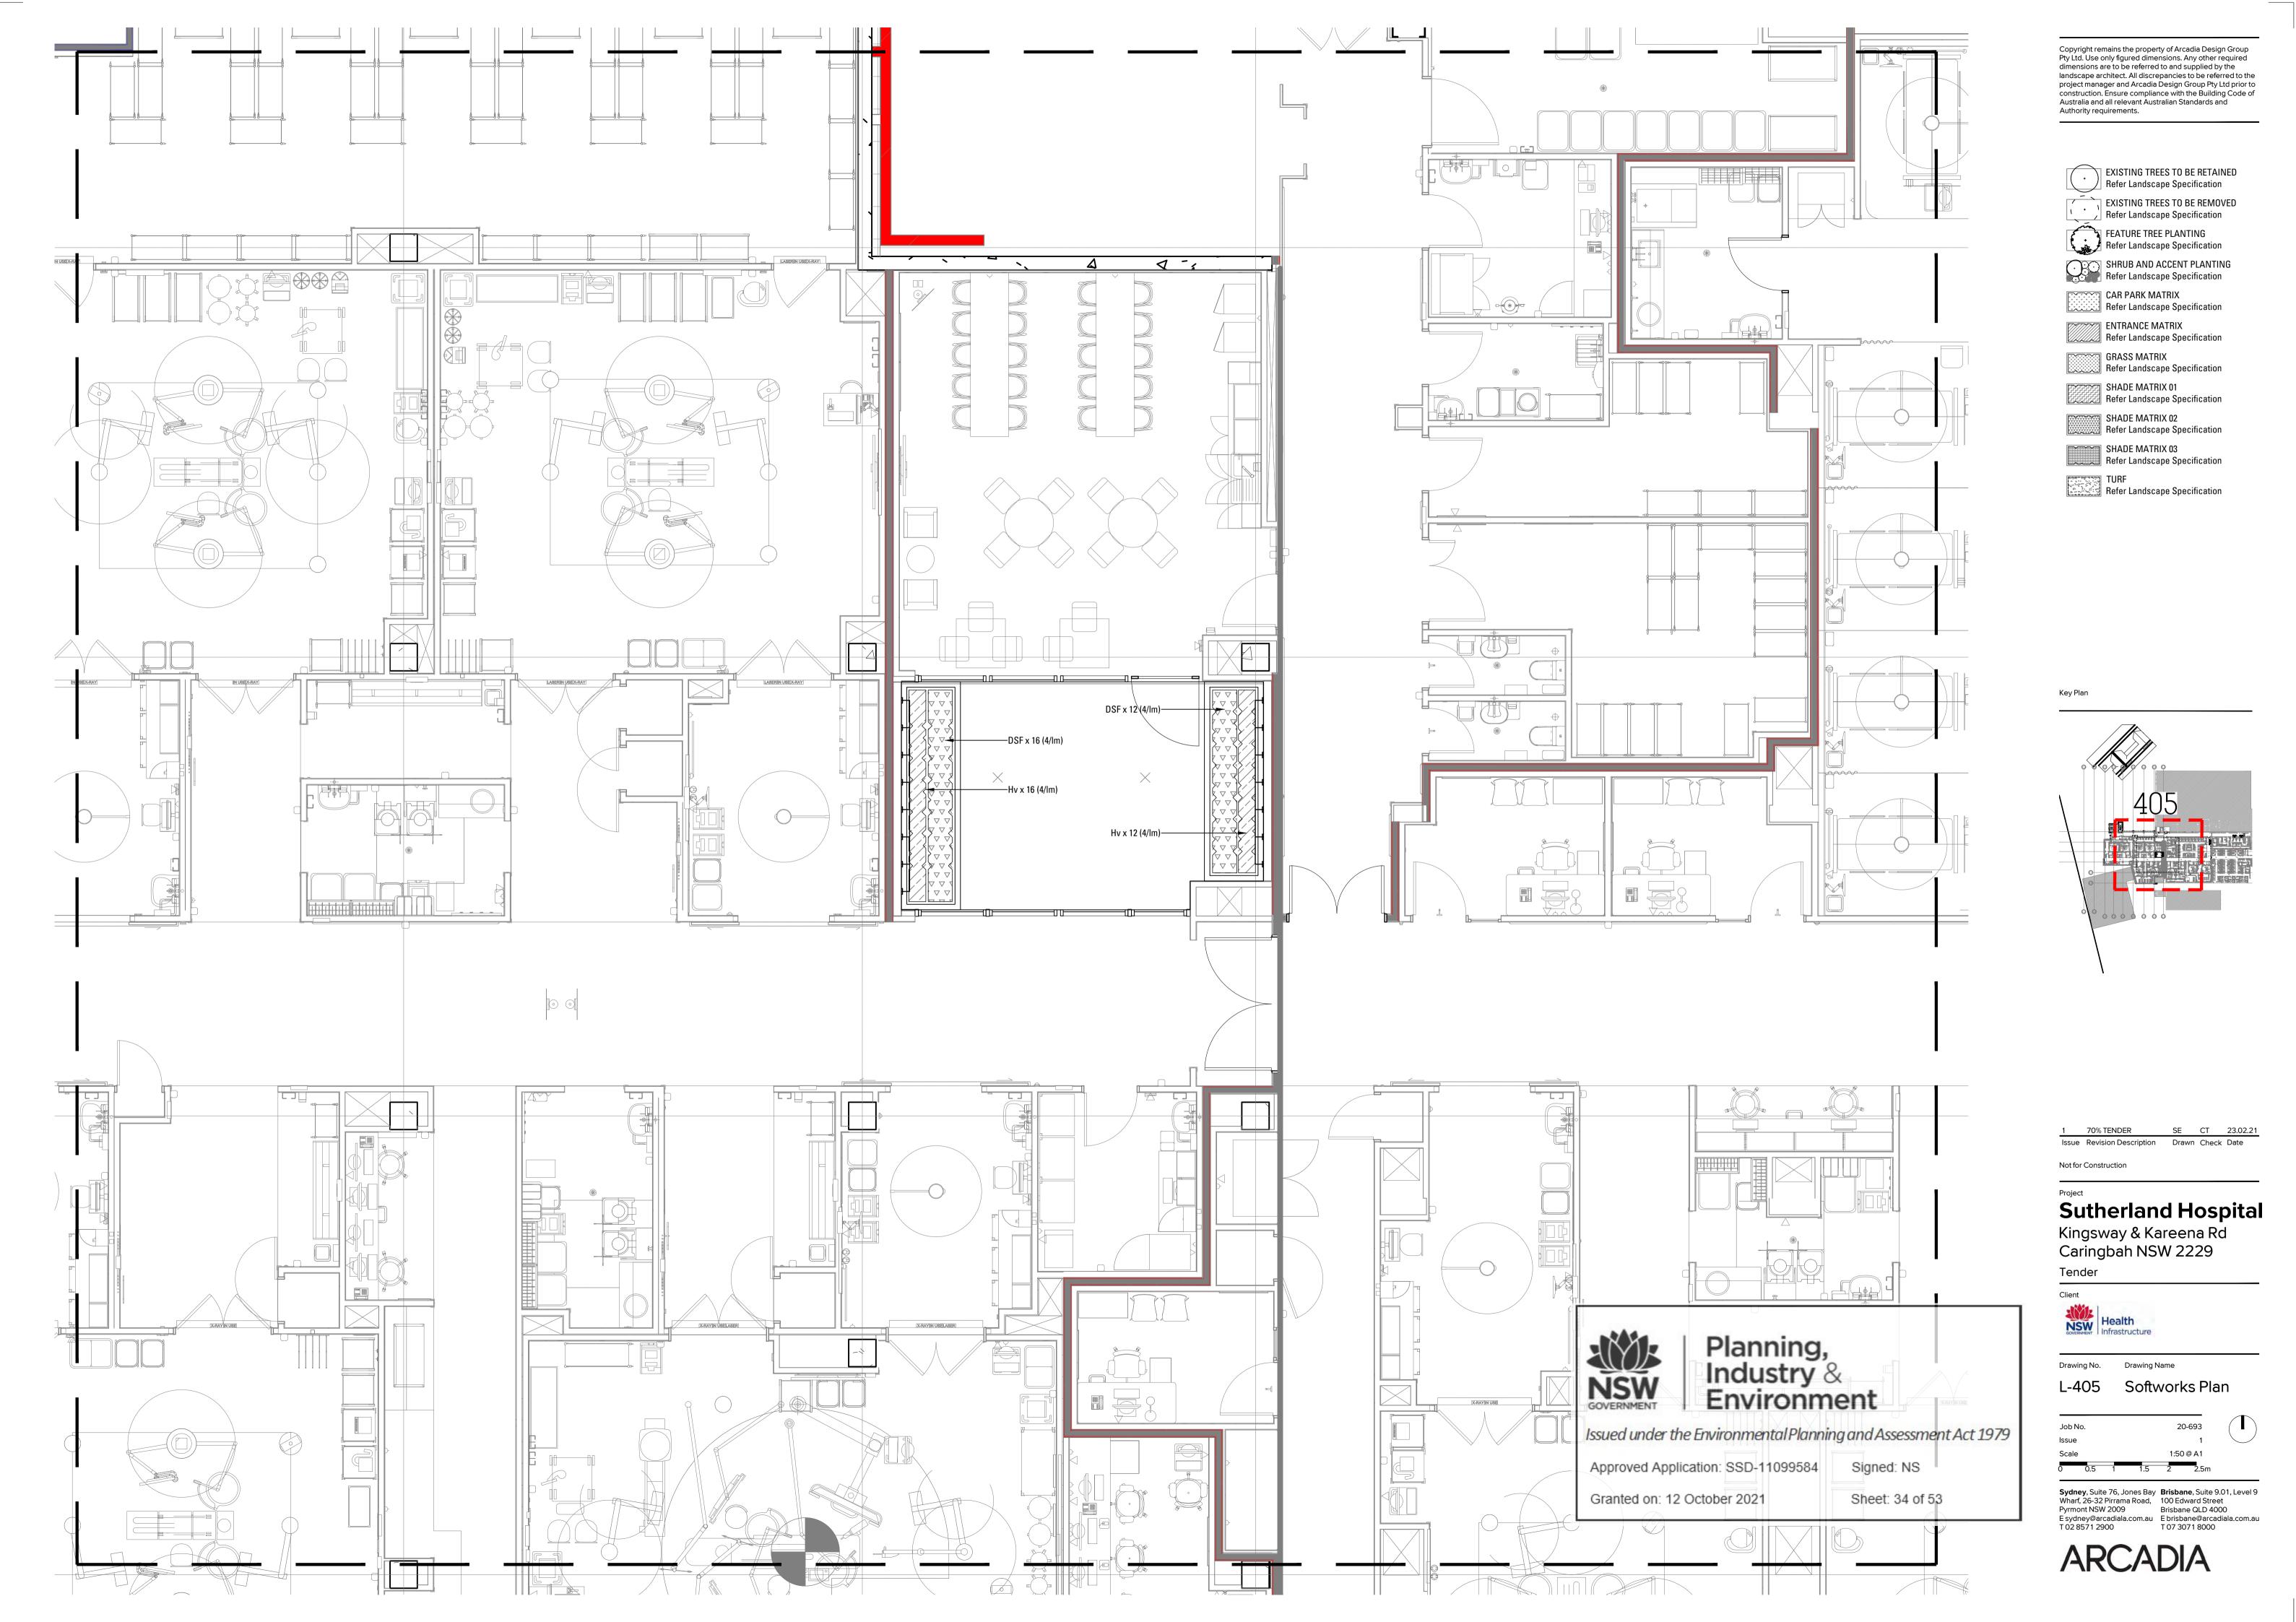

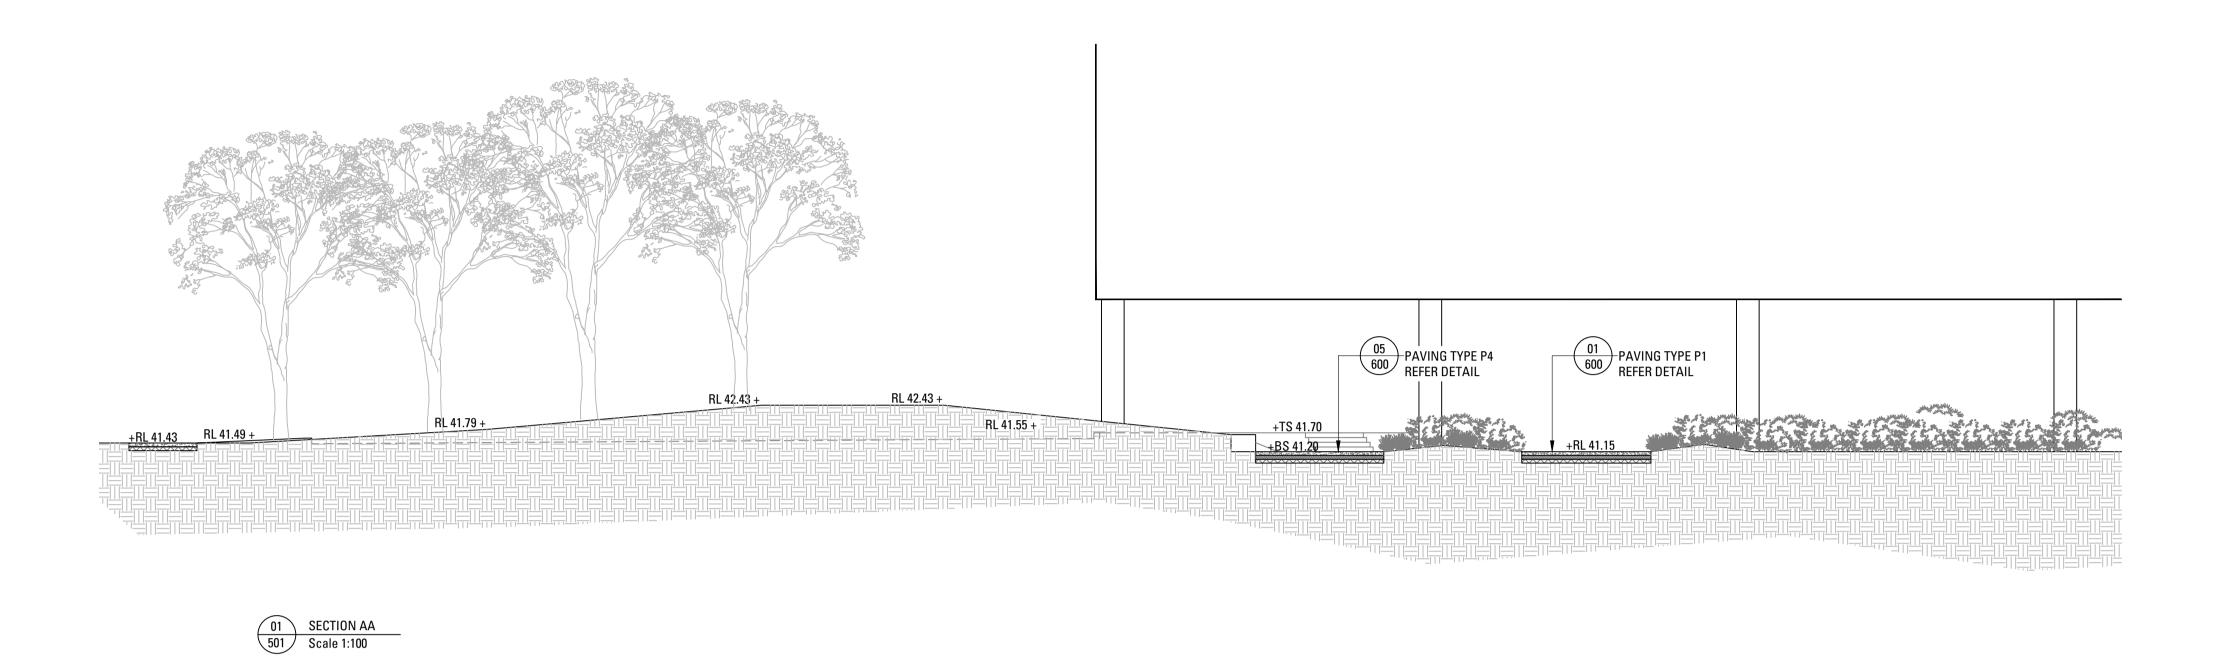

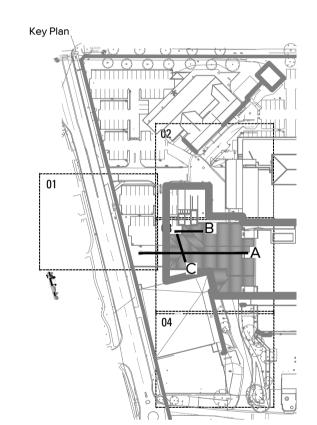

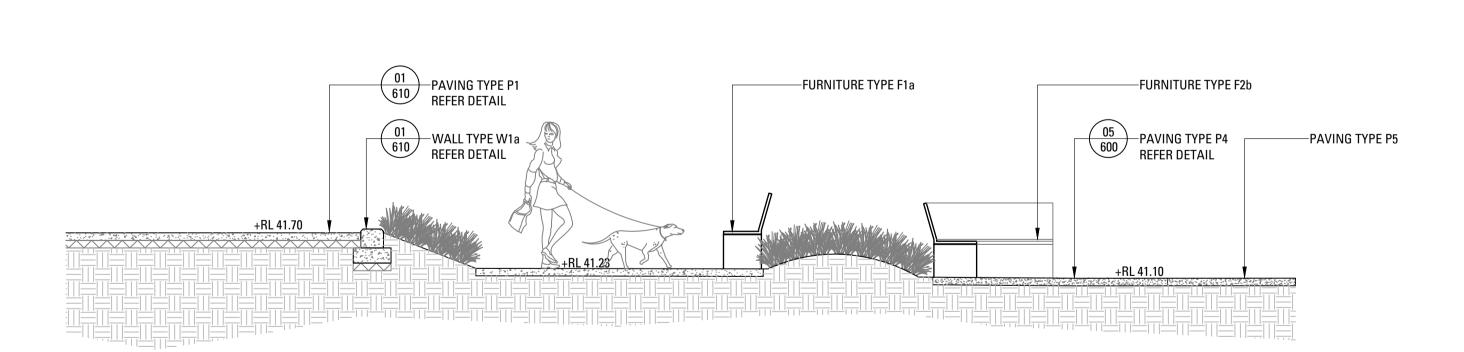

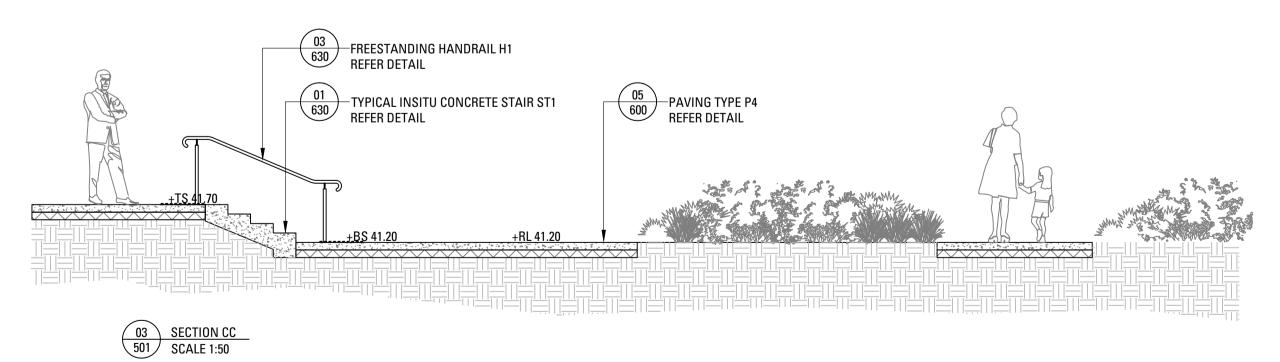

02 SECTION BB 501 SCALE 1:50



Issued under the Environmental Planning and Assessment Act 1979

Approved Application: SSD-11099584 S

Signed: NS

Granted on: 12 October 2021 Sheet: 36 of 53

1 70% TENDER SE CT 23.02.21

Issue Revision Description Drawn Check Date

Not for Construction

Sutherland Hospital
Kingsway & Kareena Rd

Kingsway & Kareena Rd Caringbah NSW 2229 ^{Tender}

Client



L-501 Section 01

Job No. 20-693
Issue 1
Scale 1:100 @ A1

Sydney, Suite 76, Jones Bay Wharf, 26-32 Pirrama Road, Pyrmont NSW 2009
E sydney@arcadiala.com.au T 02 8571 2900

Brisbane, Suite 9.01, Level 9
100 Edward Street Brisbane QLD 4000
E brisbane@arcadiala.com.au T 07 3071 8000



03 SECTION FF 502 Scale 1:50


Issued under the Environmental Planning and Assessment Act 1979


Approved Application: SSD-11099584


Signed: NS

Granted on: 12 October 2021

Sheet: 36 of 53

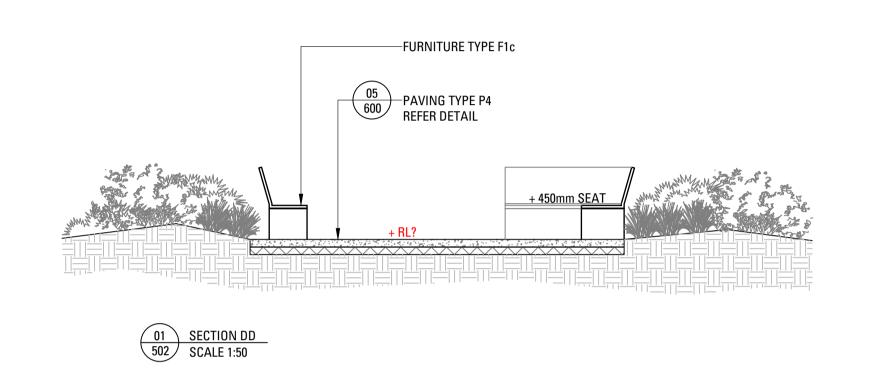

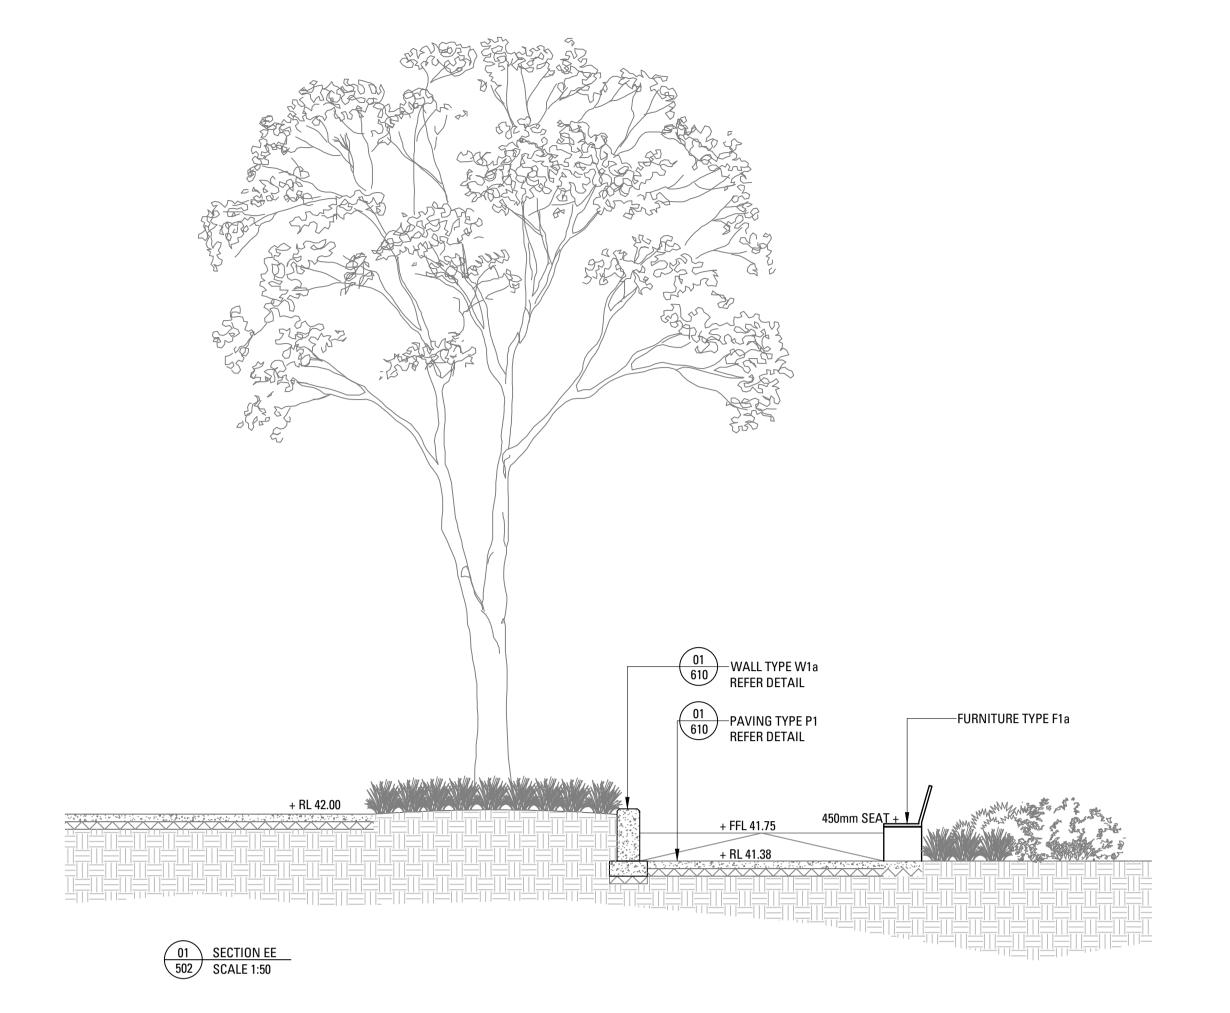

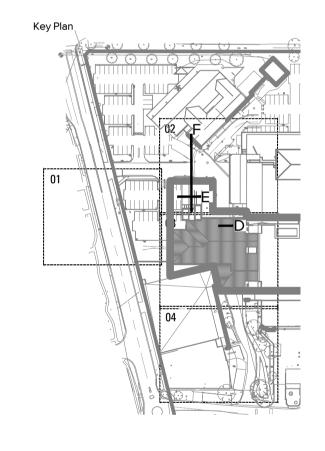

Issue Revision Description Drawn Check Date

Sutherland Hospital

Kingsway & Kareena Rd Caringbah NSW 2229

Copyright remains the property of Arcadia Design Group Pty Ltd. Use only figured dimensions. Any other required dimensions are to be referred to and supplied by the landscape architect. All discrepancies to be referred to the project manager and Arcadia Design Group Pty Ltd prior to construction. Ensure compliance with the Building Code of Australia and all relevant Australian Standards and Authority requirements.

WALL TYPE W1a REFER DETAIL PLANTING TYPE P1
REFER DETAIL + TW 42.07 + RL 41.70 + RL 41.75 + RL 41.59 FFL 41.23 +


Tender


Not for Construction


Drawing No. Drawing Name Section 02

Sydney, Suite 76, Jones Bay Wharf, 26-32 Pirrama Road, Pyrmont NSW 2009 E sydney@arcadiala.com.au T 02 8571 2900 E Brisbane@arcadiala.com.au T 07 3071 8000




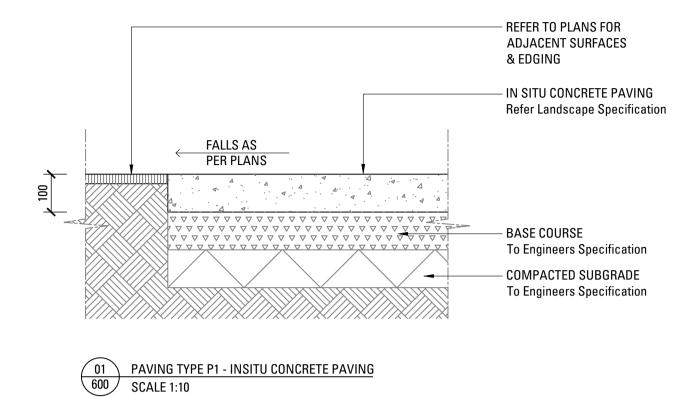

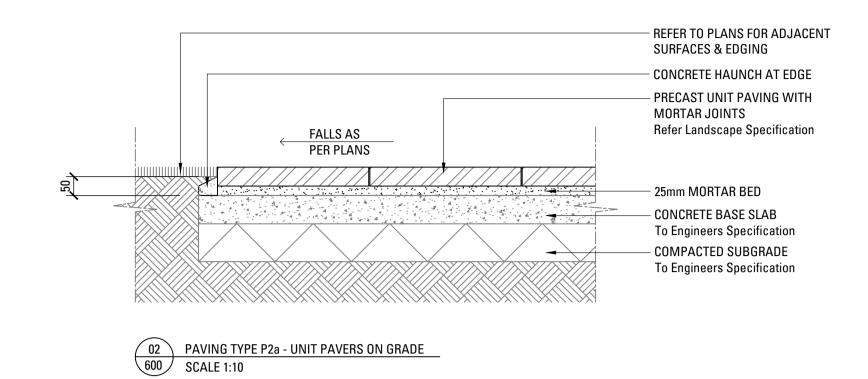


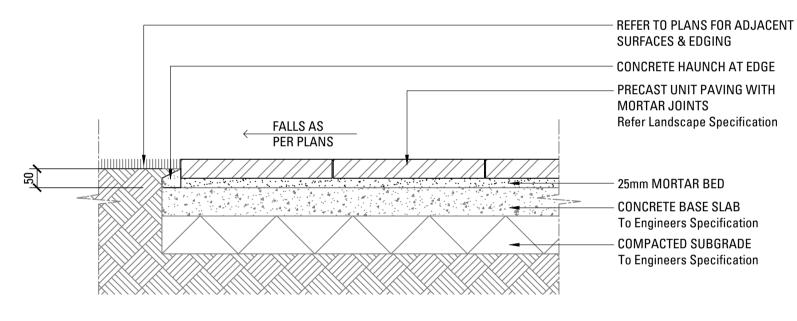




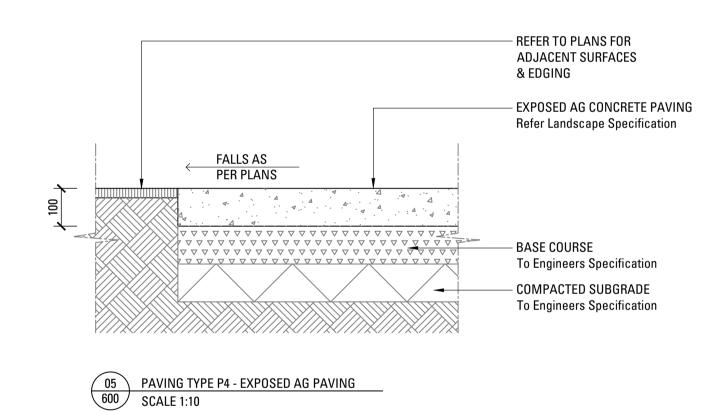


Copyright remains the property of Arcadia Design Group Pty Ltd. Use only figured dimensions. Any other required dimensions are to be referred to and supplied by the landscape architect. All discrepancies to be referred to the project manager and Arcadia Design Group Pty Ltd prior to construction. Ensure compliance with the Building Code of Australia and all relevant Australian Standards and Authority requirements.

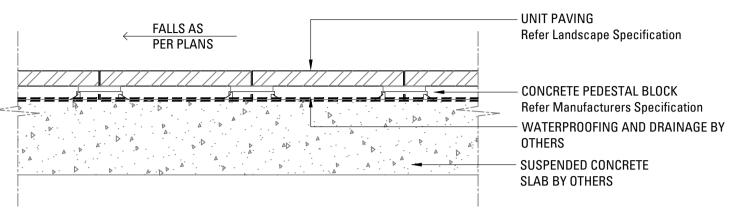




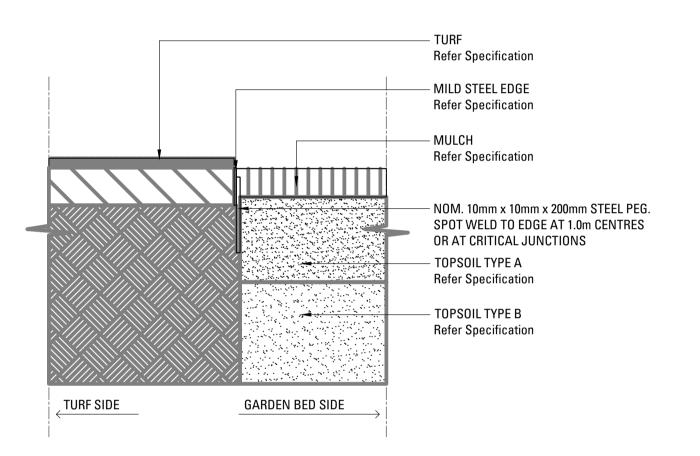

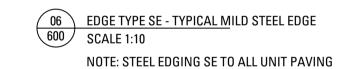

DRAFT

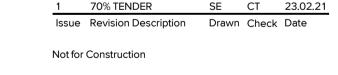

Key Plan

Sutherland Hospital Kingsway & Kareena Rd

Caringbah NSW 2229 Tender





Drawing Name Paving Details


20-693

Sydney, Suite 76, Jones Bay Wharf, 26-32 Pirrama Road, 100 Edward Street Pyrmont NSW 2009 Brisbane QLD 4000 Esydney@arcadiala.com.au Ebrisbane@arcadiala.com.au T 02 8571 2900 T 07 3071 8000


AS SHOWN





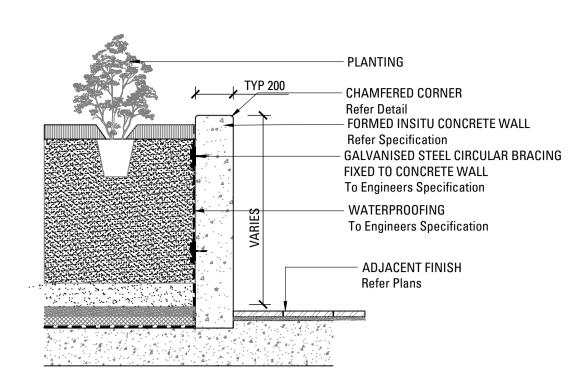


01 W1a - FORMED INSITU CONCRETE RETAINING WALL SCALE 1:20

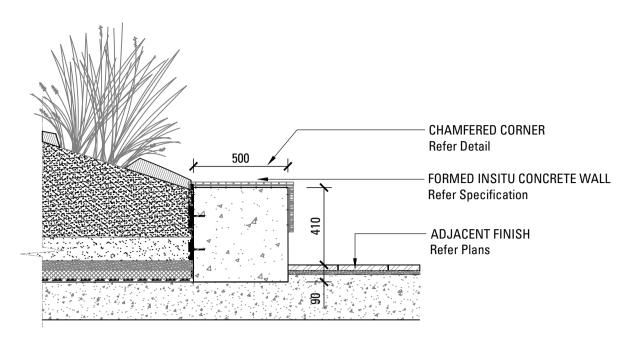


02 W1b - FORMED INSITU CONCRETE WALL WITH SEAT SCALE 1:20

Copyright remains the property of Arcadia Design Group Pty Ltd. Use only figured dimensions. Any other required dimensions are to be referred to and supplied by the landscape architect. All discrepancies to be referred to the project manager and Arcadia Design Group Pty Ltd prior to construction. Ensure compliance with the Building Code of Australia and all relevant Australian Standards and Authority requirements.

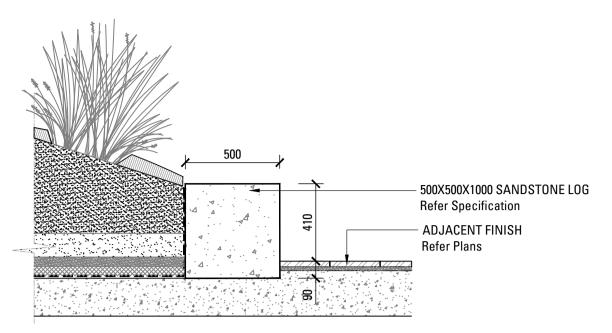



Key Plan

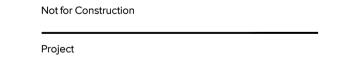

Issue Revision Description Drawn Check Date

Sutherland Hospital Kingsway & Kareena Rd Caringbah NSW 2229

Tender





Drawing Name Wall + Fence Details

20-693 AS SHOWN

Sydney, Suite 76, Jones Bay Wharf, 26-32 Pirrama Road, Pyrmont NSW 2009 E sydney@arcadiala.com.au T 02 8571 2900 E Brisbane@arcadiala.com.au T 07 3071 8000






Issued under the Environmental Planning and Assessment Act 1979

Signed: NS

Approved Application: SSD-11099584


Sheet: 38 of 53 Granted on: 12 October 2021

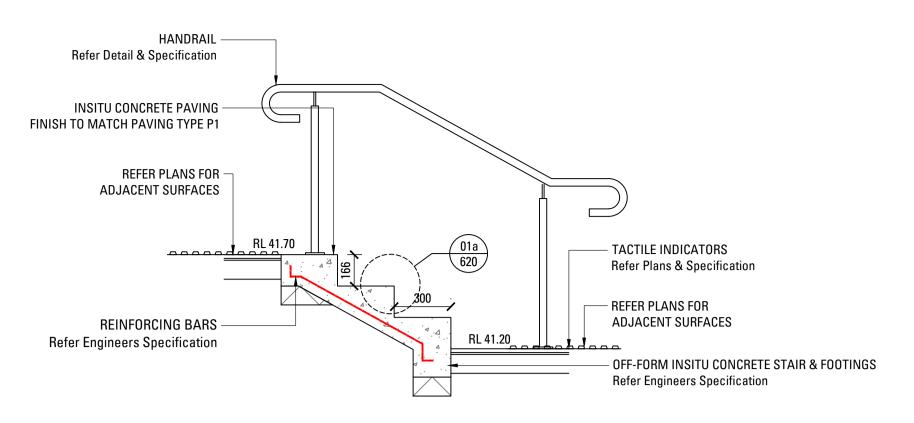


TYPICAL INSITU CONCRETE STAIRS - ST1 620 SCALE 1:20

GENERAL NOTES: 1. NOT MORE THAN 18 NOR LESS THAN 2 RISERS 2. GOINGS & RISERS CONSTANT THROUGHOUT IN ONE FLIGHT 3. RATIO OF GOING (G) TO RISER (R) TO EQUAL $2R + G \ge 550$ mm $\& \le 700$ mm. 4. TREADS TO HAVE A NON-SKID STRIP AT EDGE AS SPECIFIED.

SHOP DRAWINGS TO BE PROVIDED FOR REVIEW AND APPROVAL.

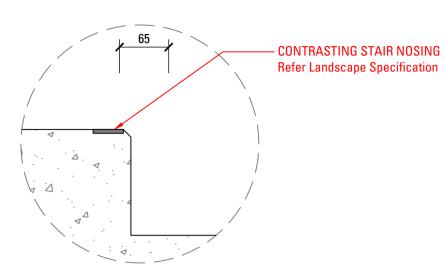


01a STEP TYPE ST1 NOSING - TYPICAL DETAIL 620 SCALE 1:5

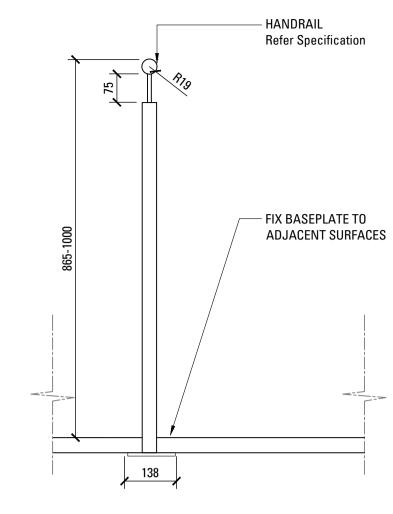

02 FREESTANDING HANDRAIL - POST ELEVATION - H1
620 SCALE 1:10

Copyright remains the property of Arcadia Design Group Pty Ltd. Use only figured dimensions. Any other required dimensions are to be referred to and supplied by the landscape architect. All discrepancies to be referred to the project manager and Arcadia Design Group Pty Ltd prior to construction. Ensure compliance with the Building Code of Australia and all relevant Australian Standards and Authority requirements.

Key Plan

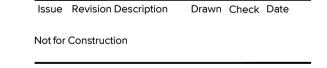

Sutherland Hospital

Kingsway & Kareena Rd Caringbah NSW 2229

Tender





Drawing Name

Step + Handrail Details

20-693 AS SHOWN


Sydney, Suite 76, Jones Bay Wharf, 26-32 Pirrama Road, Pyrmont NSW 2009 E sydney@arcadiala.com.au T 02 8571 2900 E Brisbane@arcadiala.com.au T 07 3071 8000






Issued under the Environmental Planning and Assessment Act 1979

Approved Application: SSD-11099584 Signed: NS Granted on: 12 October 2021 Sheet: 39 of 53

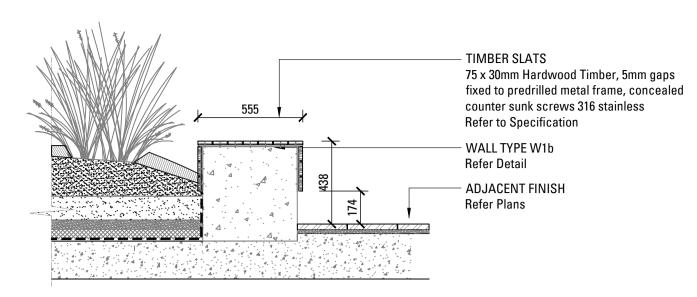


01 F1a - BENCH SEAT ON CONCRETE - TYPICAL SECTION SCALE 1:20

NOTE: SHOP DRAWINGS TO BE PROVIDED FOR APPROVAL

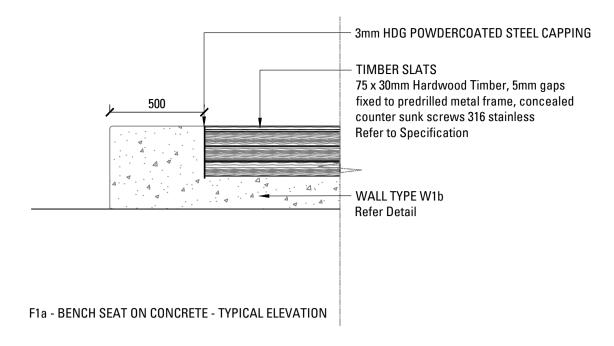

NOTE: SHOP DRAWINGS TO BE PROVIDED FOR APPROVAL

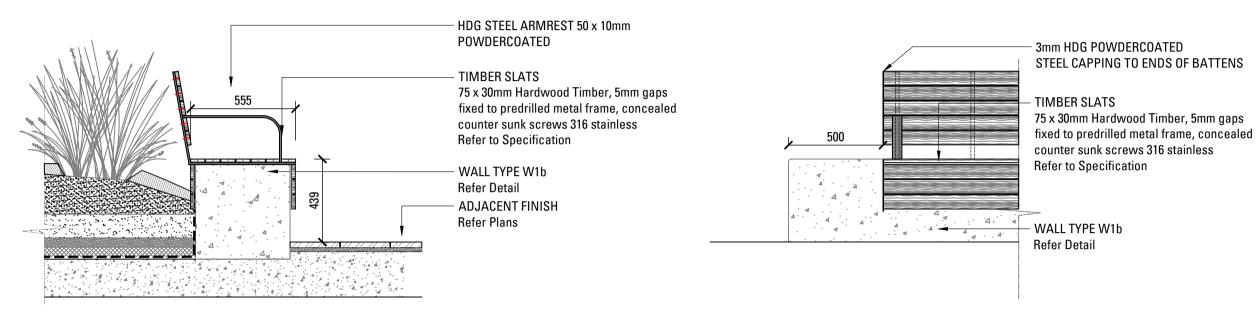


02 F1b - BENCH SEAT WITH BACKREST ON CONCRETE - TYPICAL SECTION SCALE 1:20


NOTE: SHOP DRAWINGS TO BE PROVIDED FOR APPROVAL

F1b - BENCH SEAT WITH BACKREST ON CONCRETE - TYPICAL ELEVATION


NOTE: SHOP DRAWINGS TO BE PROVIDED FOR APPROVAL

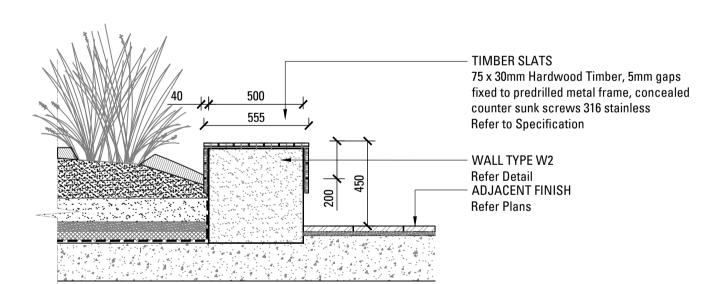


630 F2a - BENCH SEAT ON SANDSTONE - TYPICAL SECTION SCALE 1:20

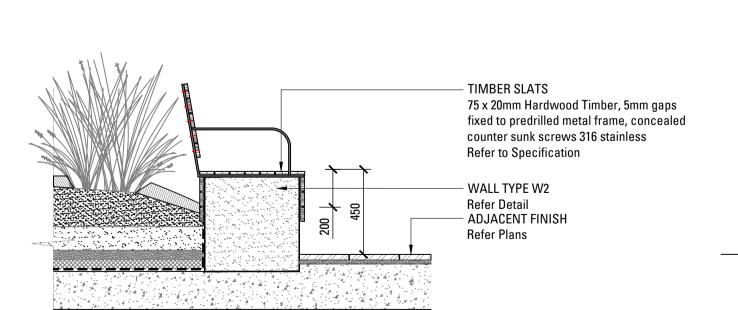

04 F2b - BENCH SEAT WITH BACKREST ON SANDSTONE - TYPICAL SECTION SCALE 1:20

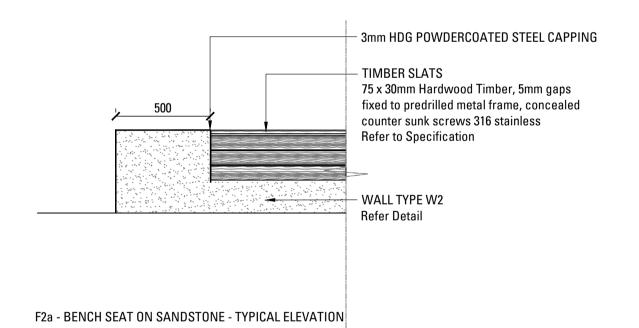

NOTE: SHOP DRAWINGS TO BE PROVIDED FOR APPROVAL

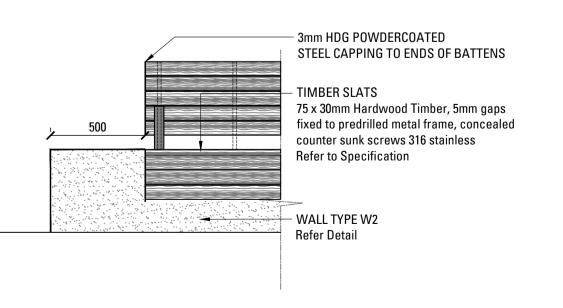

F2b - BENCH SEAT WITH BACKREST ON SANDSTONE - TYPICAL ELEVATION

NOTE: SHOP DRAWINGS TO BE PROVIDED FOR APPROVAL

Copyright remains the property of Arcadia Design Group Pty Ltd. Use only figured dimensions. Any other required dimensions are to be referred to and supplied by the landscape architect. All discrepancies to be referred to the project manager and Arcadia Design Group Pty Ltd prior to construction. Ensure compliance with the Building Code of Australia and all relevant Australian Standards and Authority requirements.

Key Plan



Issued under the Environmental Planning and Assessment Act 1979

Approved Application: SSD-11099584 Signed: NS

Granted on: 12 October 2021 Sheet: 42 of 53



Not for Construction



Job No. 20-693
Issue 1
Scale AS SHOWN


Sydney, Suite 76, Jones Bay Wharf, 26-32 Pirrama Road, Pyrmont NSW 2009 E sydney@arcadiala.com.au T 02 8571 2900 Brisbane Brisbane, Suite 9.01, Level 9 Brisbane, Suite


Issue Revision Description Drawn Check Date

Sutherland Hospital


Kingsway & Kareena Rd



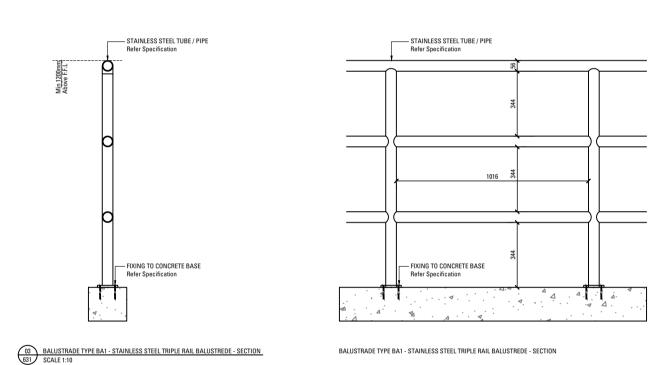

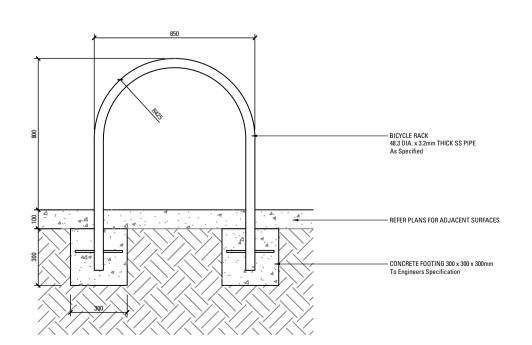

05 SUB-SURFACE FIXED BIKE RACK - BR
631 SCALE 1:10

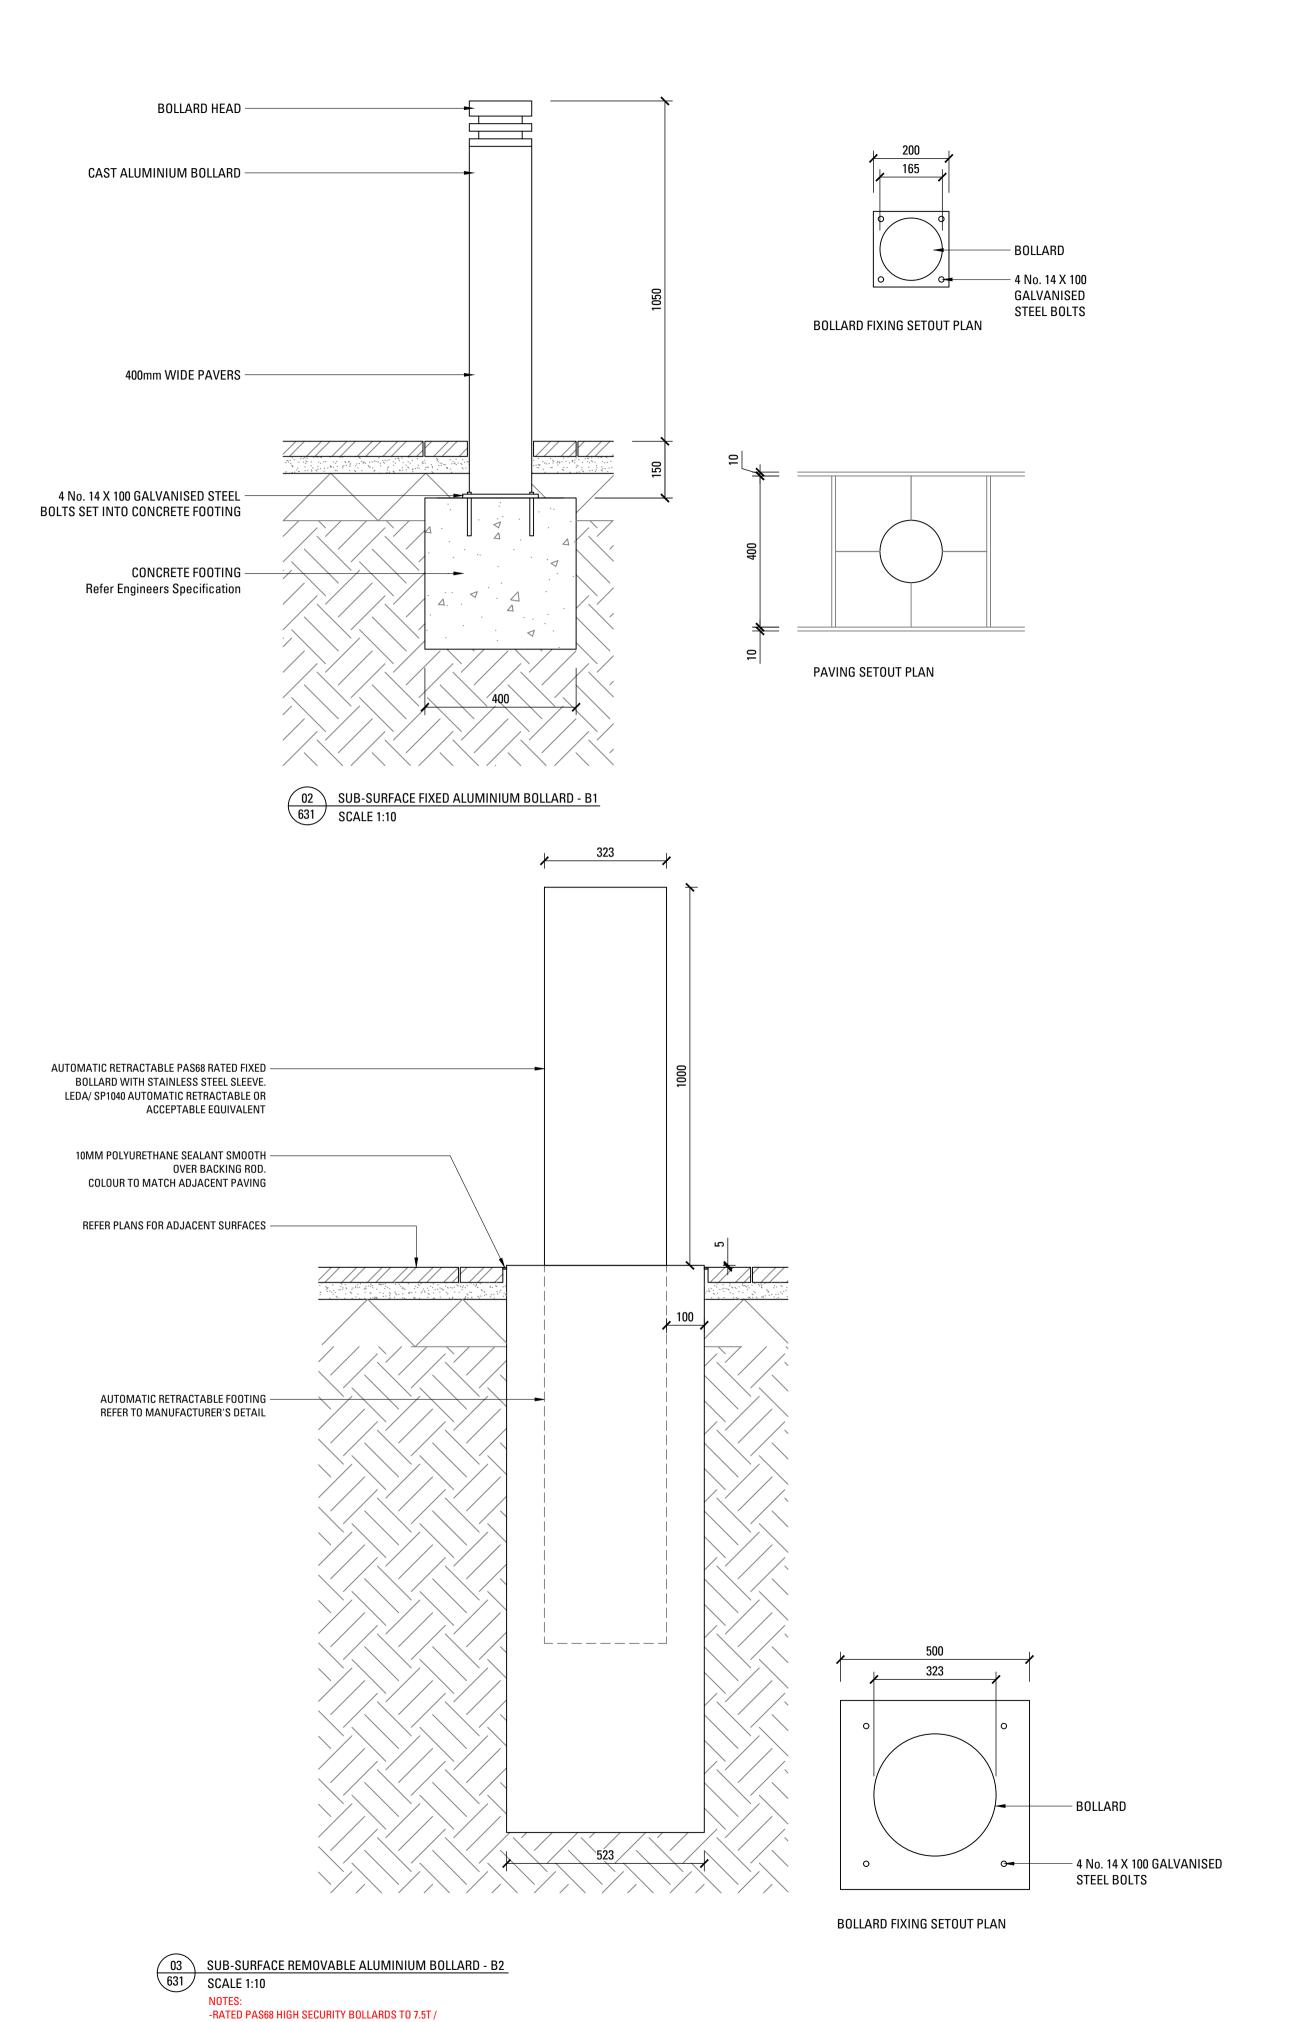

80KM/HR TO SECURITY CONSULTANTS APPROVAL -BOLLARDS SHALL PROVIDE MINIMUM 30% LUMINANCE CONTRAST TO ADJACENT PAVEMENT SURFACES

-0.5MM OFFSET TOP FOOTING OUTER FROM FFL. REFER TO MANUFACTURER'S DETAILS Copyright remains the property of Arcadia Design Group Pty Ltd. Use only figured dimensions. Any other required dimensions are to be referred to and supplied by the landscape architect. All discrepancies to be referred to the project manager and Arcadia Design Group Pty Ltd prior to construction. Ensure compliance with the Building Code of Australia and all relevant Australian Standards and Authority requirements.

Key Plan



Issued under the Environmental Planning and Assessment Act 1979

Approved Application: SSD-11099584 Signed: NS

Granted on: 12 October 2021 Sheet: 41 of 53

1 70% TENDER SE CT 23.02.21

Issue Revision Description Drawn Check Date

Not for Construction

Project

Sutherland Hospital Kingsway & Kareena Rd

Caringbah NSW 2229 Tender

Client

Health

owing No. Drawing Name
-631 Furniture

L-631 Furniture


 Job No.
 20-693


 Issue
 1

 Scale
 AS SHOWN

Sydney, Suite 76, Jones Bay Wharf, 26-32 Pirrama Road, Pyrmont NSW 2009 E sydney@arcadiala.com.au T 02 8571 2900 E Sydney 8 100 Edward Street Brisbane QLD 4000 E brisbane@arcadiala.com.au T 07 3071 8000



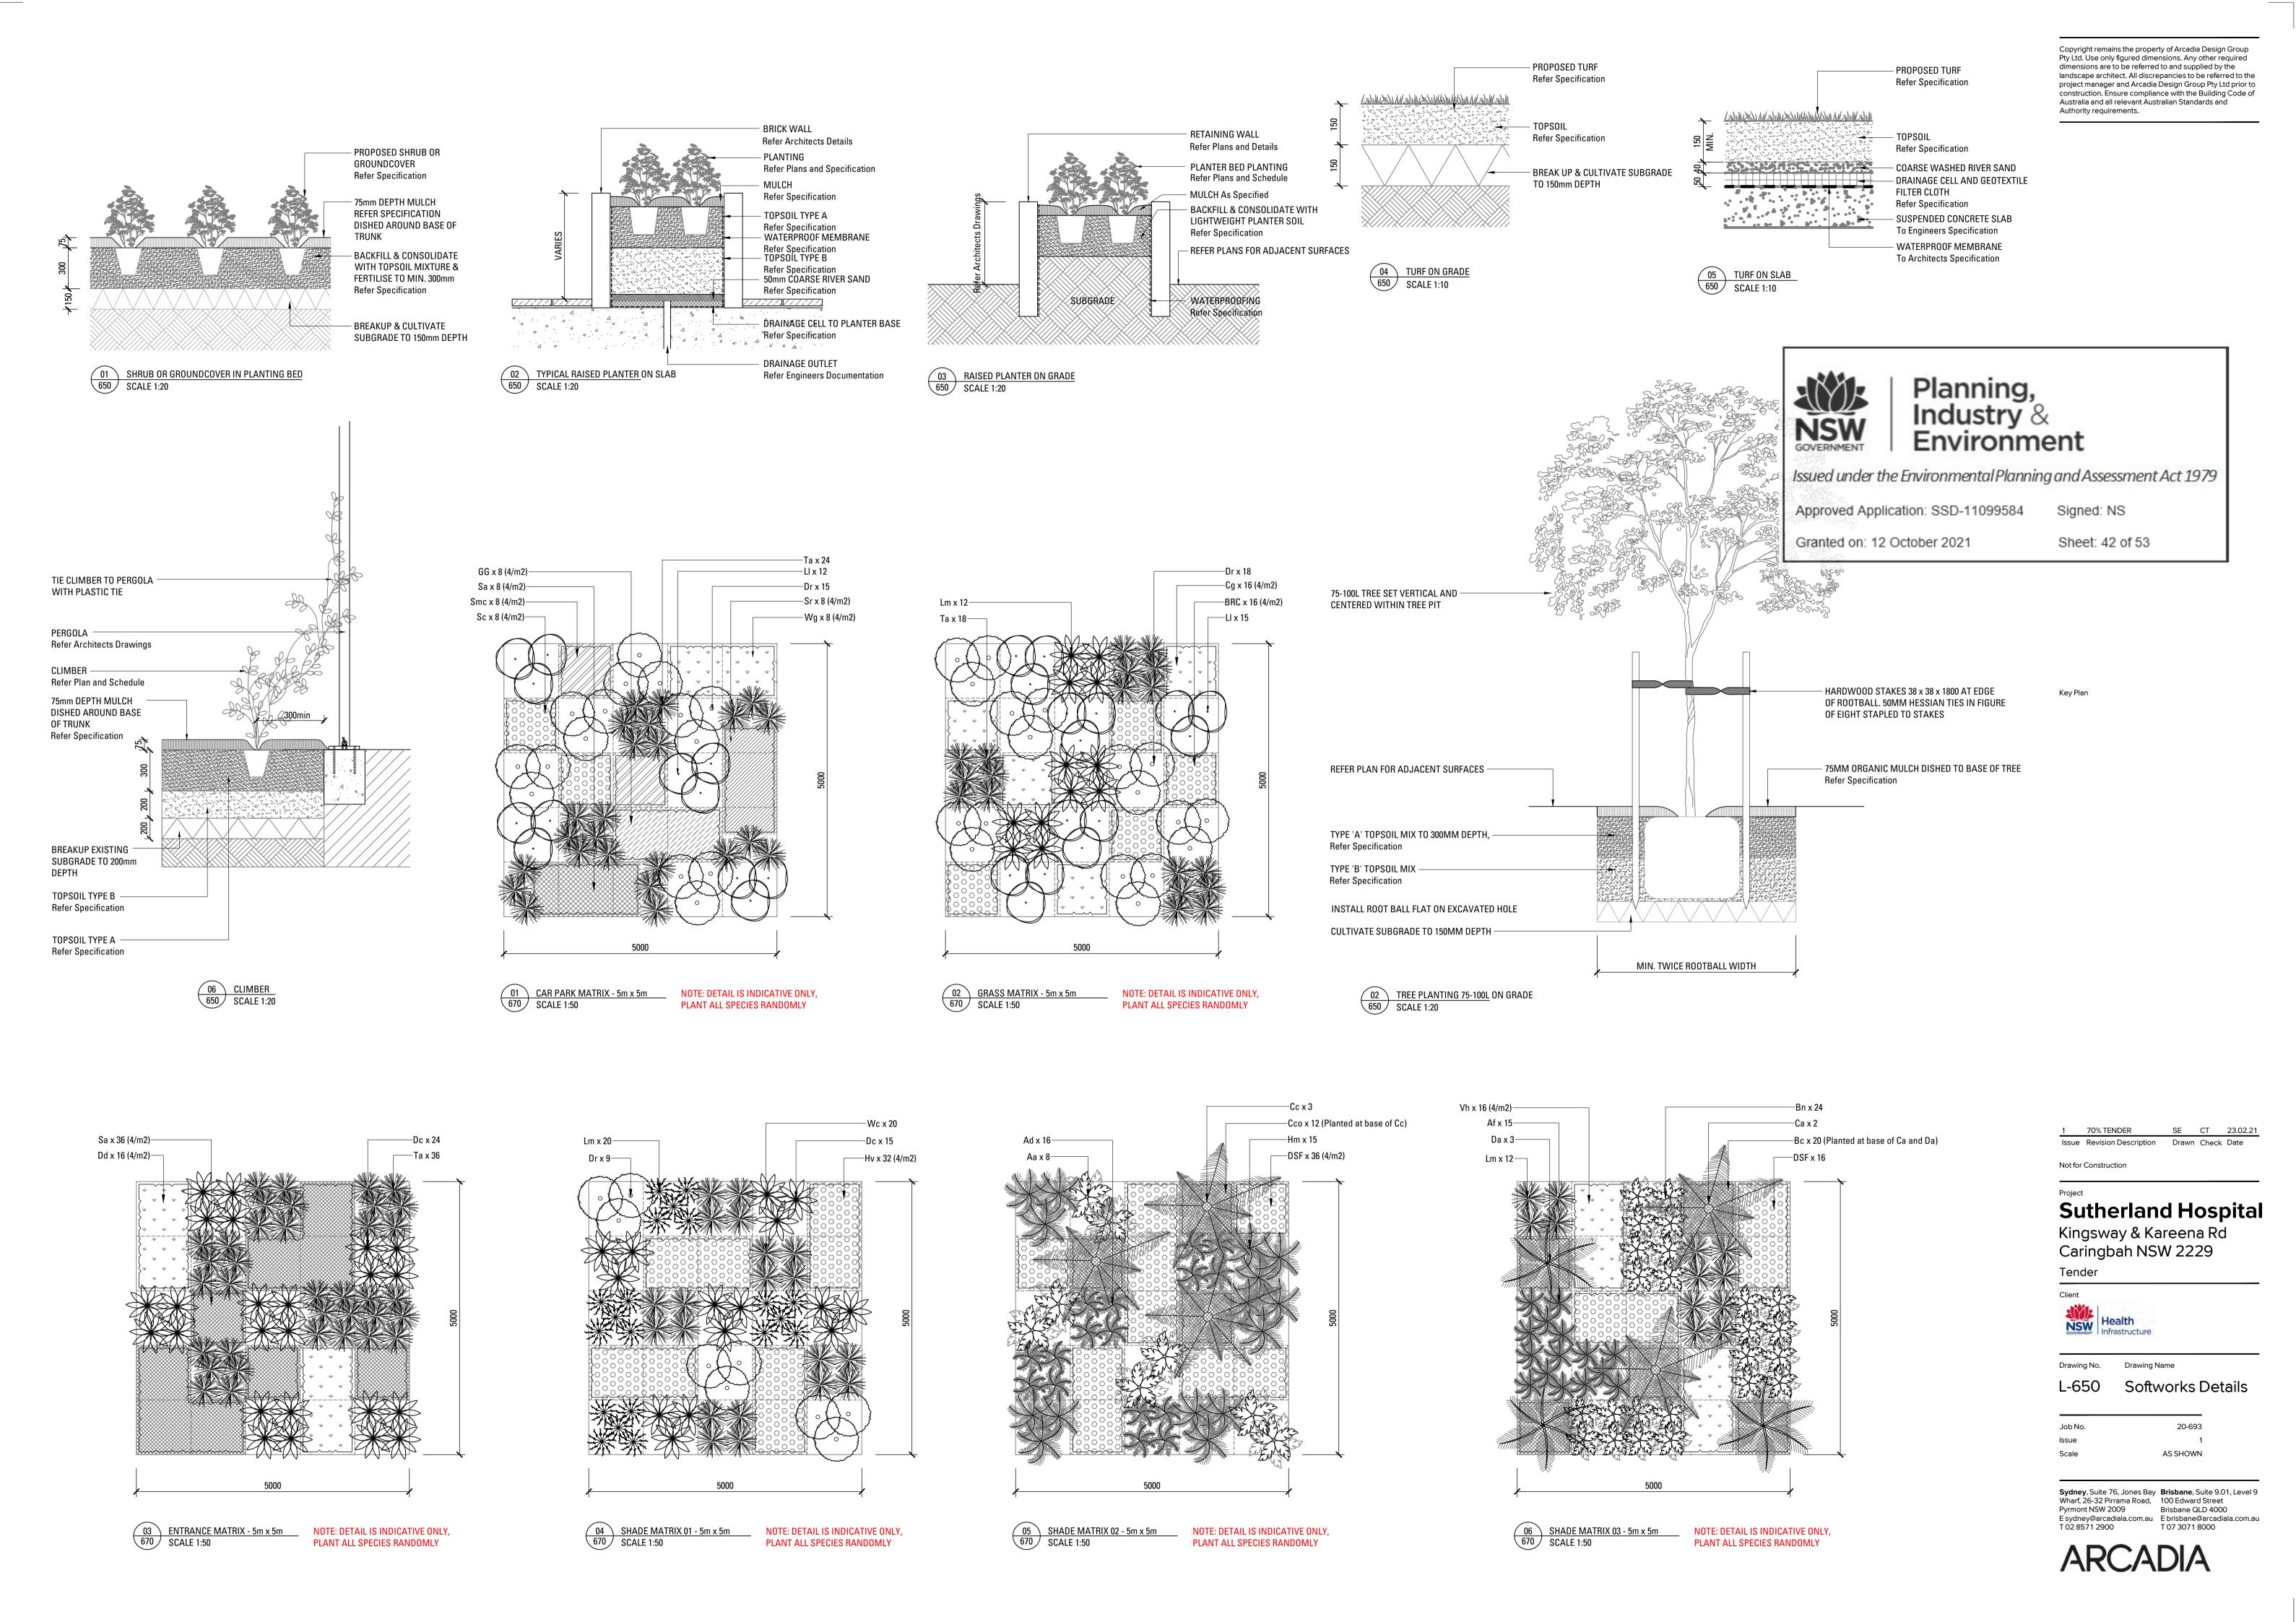

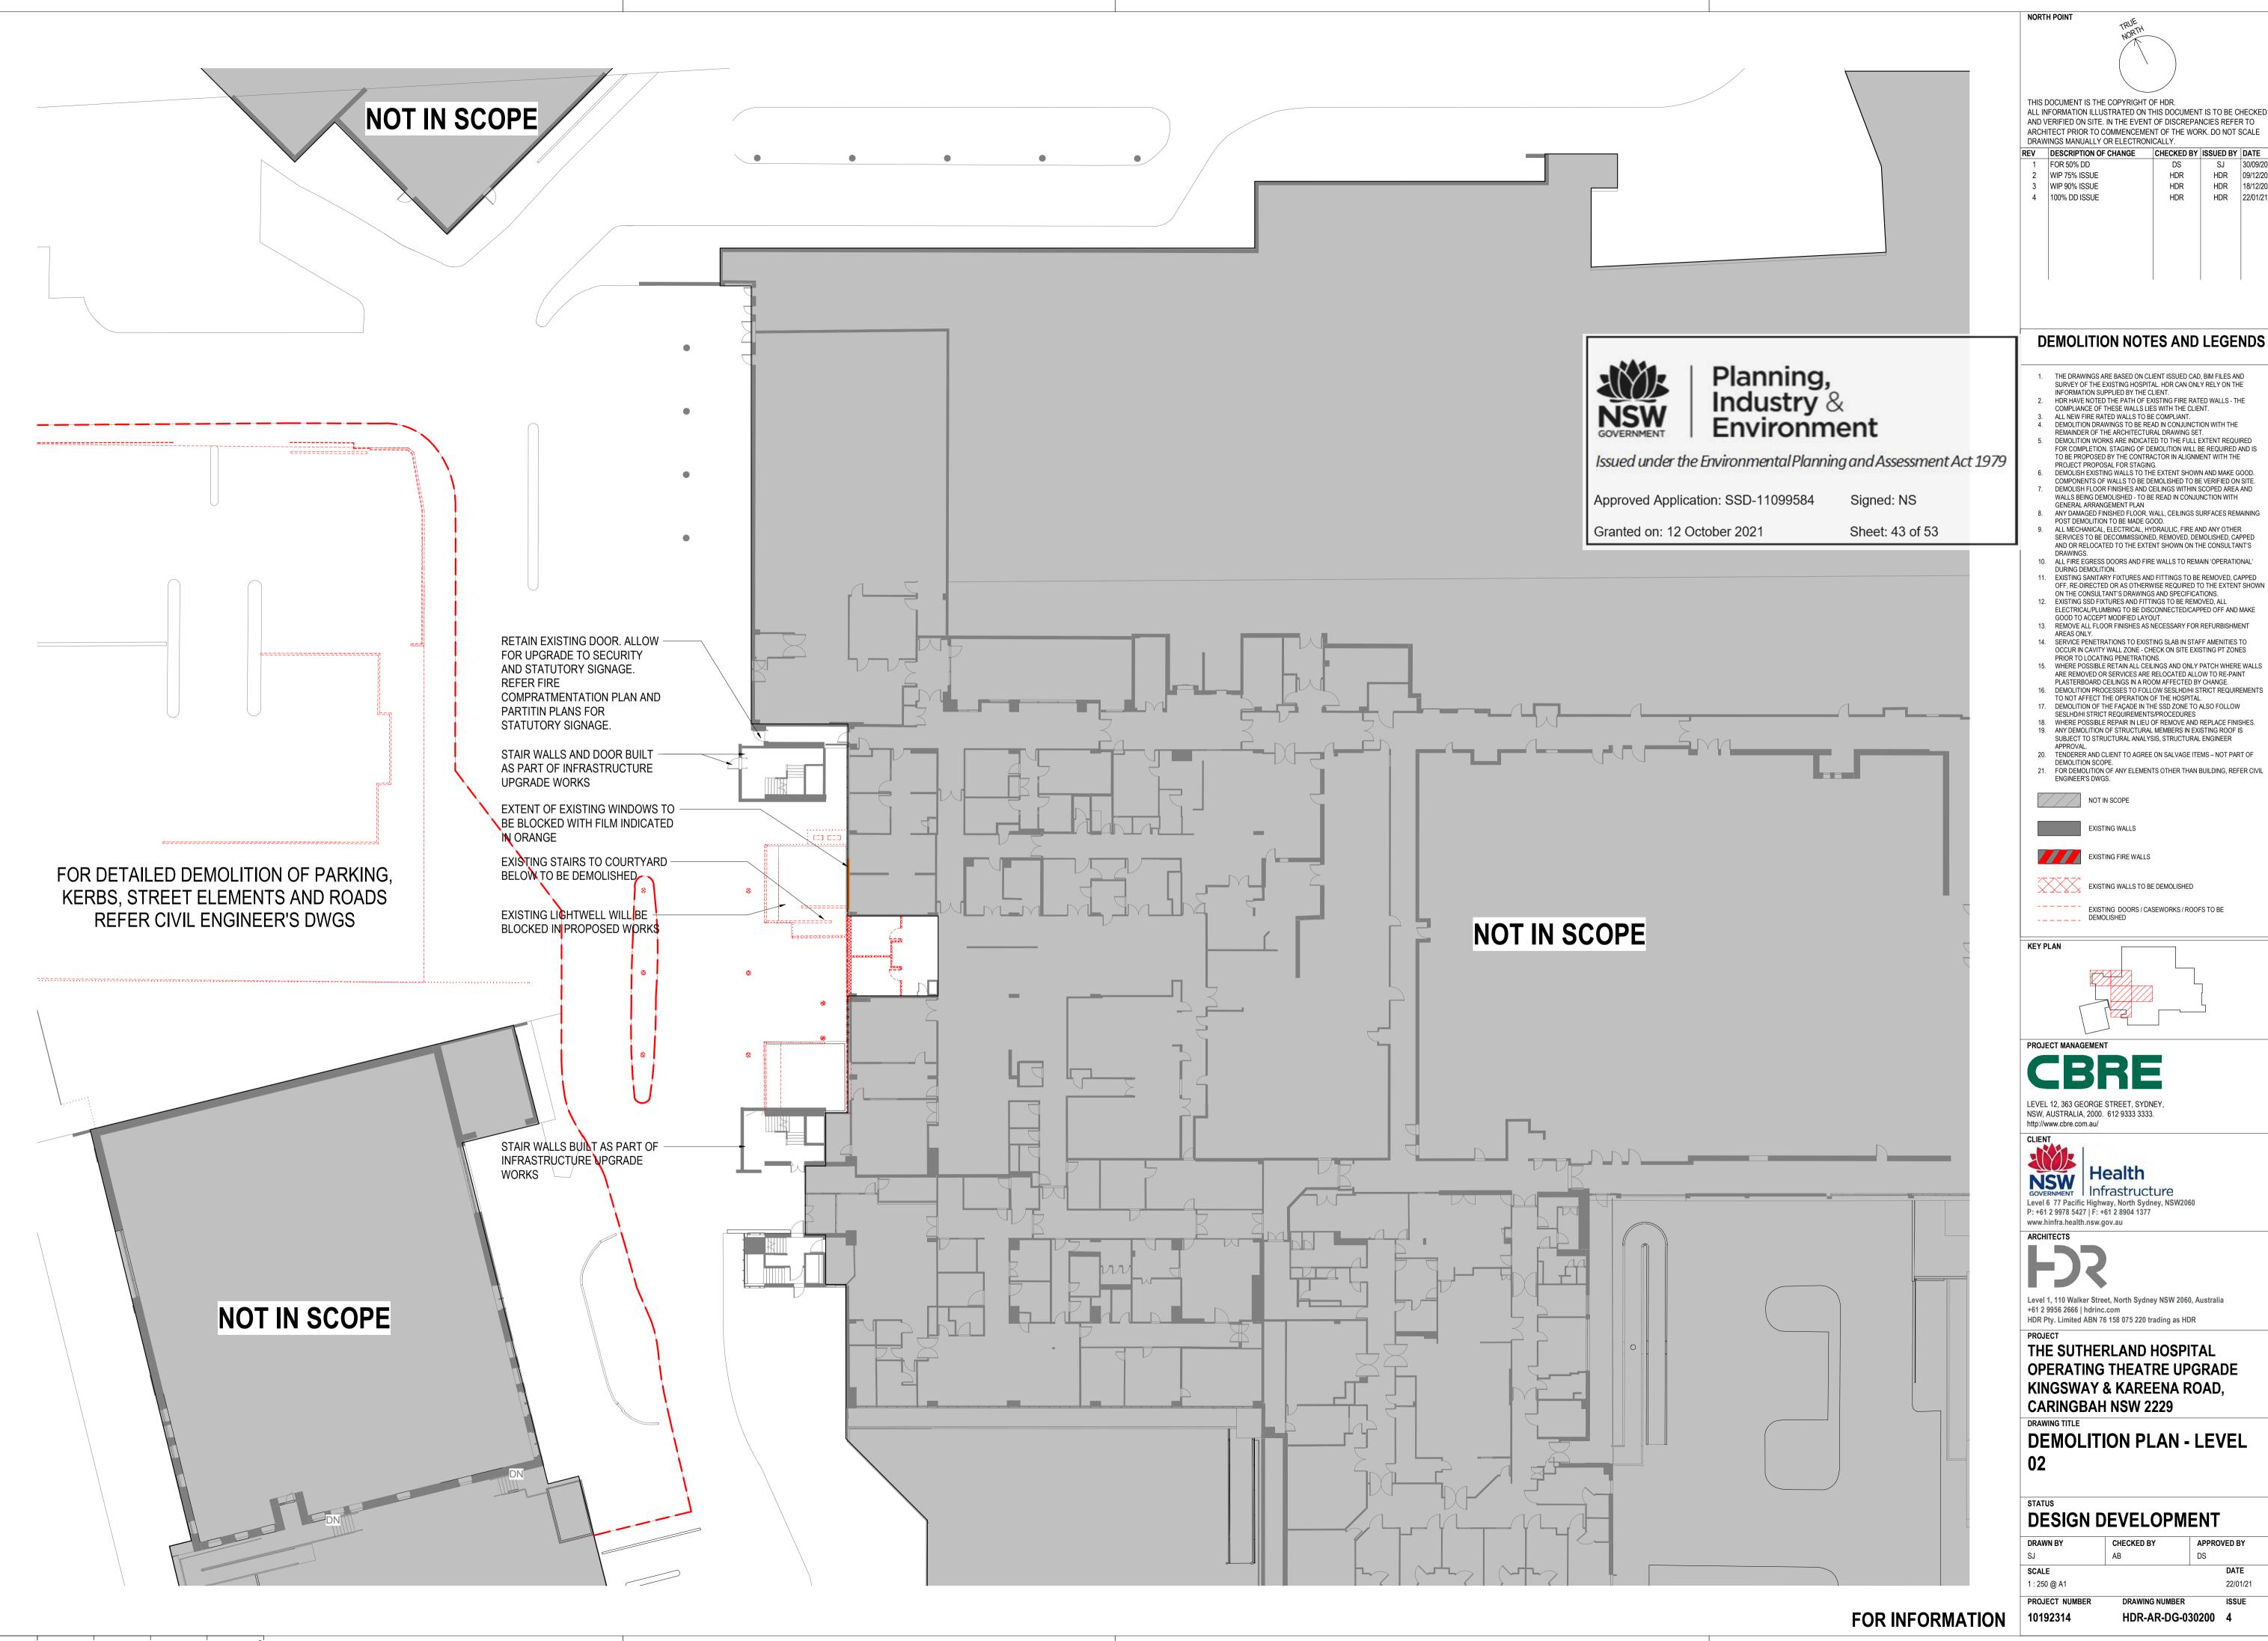


BIM 360://10192314_Sutherland_Hospital_Operating_Theatre_Upgrade_2020/TSHOTUP_INTERNAL.rvt

ISSUE

HDR 09/12/20 HDR 18/12/20

HDR 22/01/21

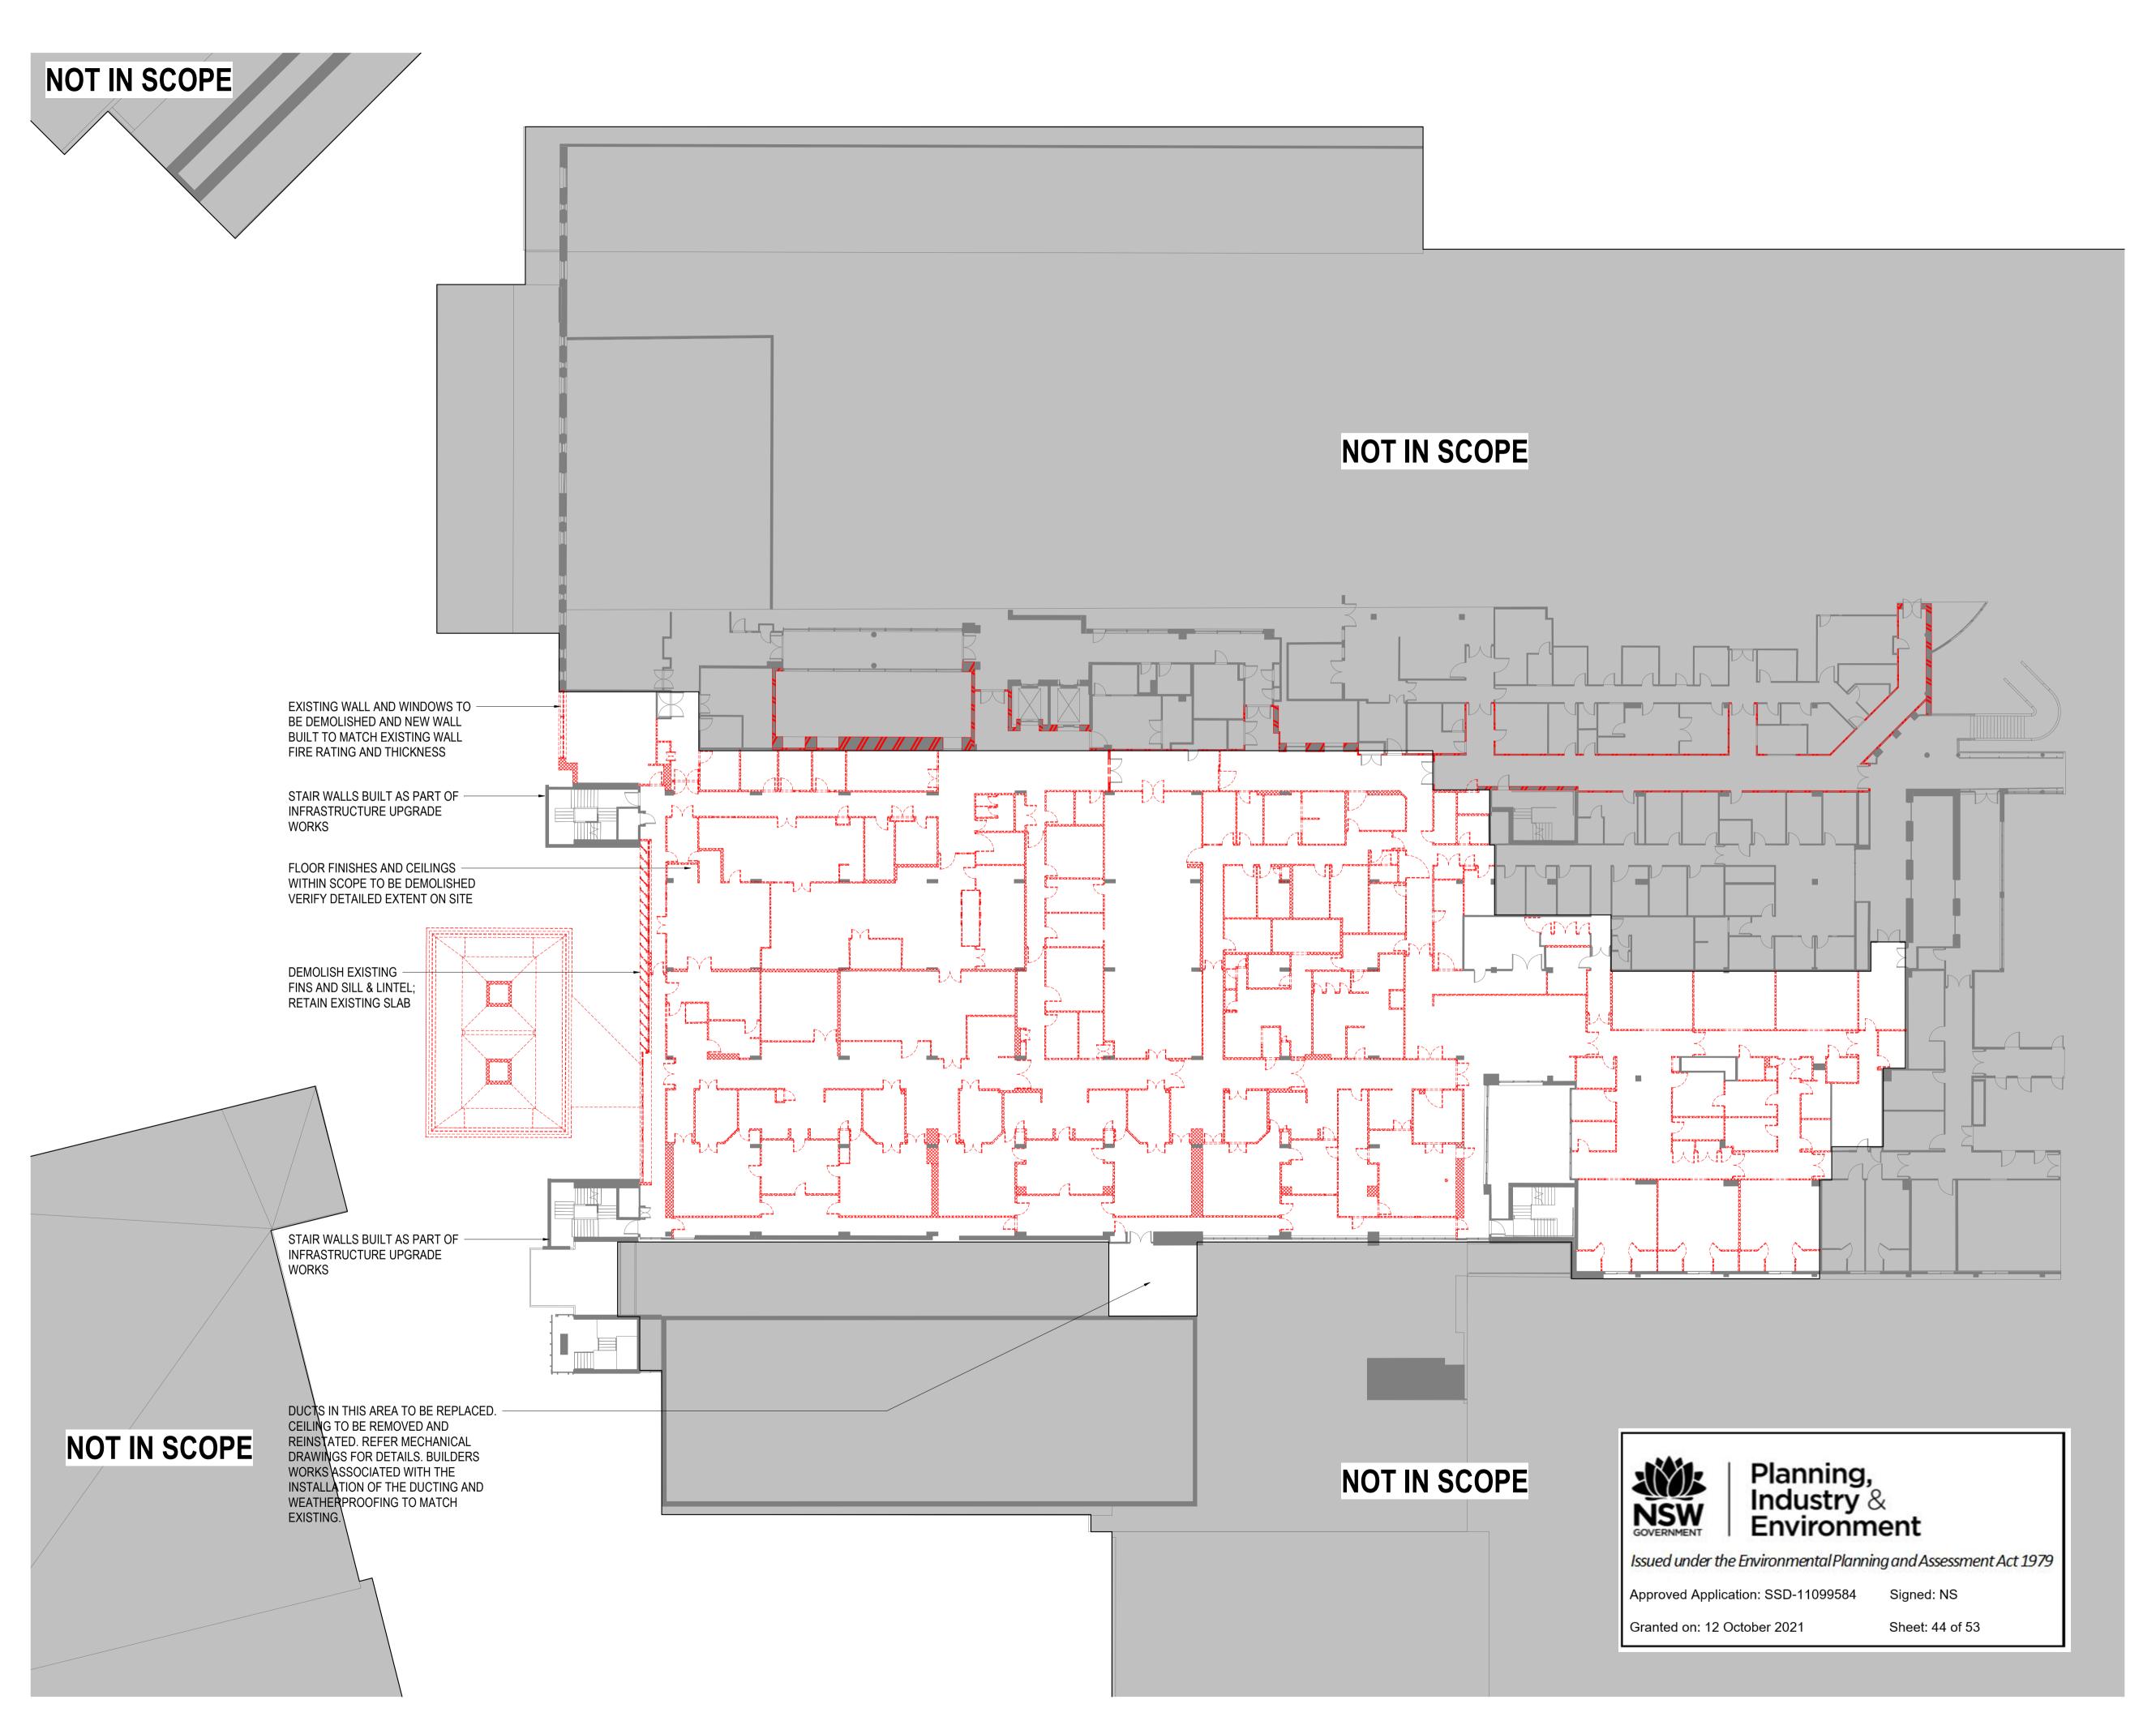

THIS DOCUMENT IS THE COPYRIGHT OF HDR. ALL INFORMATION ILLUSTRATED ON THIS DOCUMENT IS TO BE CHECKED AND VERIFIED ON SITE. IN THE EVENT OF DISCREPANCIES REFER TO ARCHITECT PRIOR TO COMMENCEMENT OF THE WORK. DO NOT SCALE DRAWINGS MANUALLY OR ELECTRONICALLY.

REV DESCRIPTION OF CHANGE CHECKED BY ISSUED BY DATE 1 FOR 50% DD HDR 2 WIP 75% ISSUE HDR 09/12/20 HDR 18/12/20 3 WIP 90% ISSUE HDR 4 100% DD ISSUE HDR HDR 22/01/21

DEMOLITION NOTES AND LEGENDS

- THE DRAWINGS ARE BASED ON CLIENT ISSUED CAD, BIM FILES AND SURVEY OF THE EXISTING HOSPITAL. HDR CAN ONLY RELY ON THE INFORMATION SUPPLIED BY THE CLIENT.
- HDR HAVE NOTED THE PATH OF EXISTING FIRE RATED WALLS THE COMPLIANCE OF THESE WALLS LIES WITH THE CLIENT. ALL NEW FIRE RATED WALLS TO BE COMPLIANT.
- DEMOLITION DRAWINGS TO BE READ IN CONJUNCTION WITH THE
- REMAINDER OF THE ARCHITECTURAL DRAWING SET.
 DEMOLITION WORKS ARE INDICATED TO THE FULL EXTENT REQUIRED
- FOR COMPLETION. STAGING OF DEMOLITION WILL BE REQUIRED AND IS TO BE PROPOSED BY THE CONTRACTOR IN ALIGNMENT WITH THE PROJECT PROPOSAL FOR STAGING.
- 6. DEMOLISH EXISTING WALLS TO THE EXTENT SHOWN AND MAKE GOOD.
- COMPONENTS OF WALLS TO BE DEMOLISHED TO BE VERIFIED ON SITE. DEMOLISH FLOOR FINISHES AND CEILINGS WITHIN SCOPED AREA AND
- WALLS BEING DEMOLISHED TO BE READ IN CONJUNCTION WITH GENERAL ARRANGEMENT PLAN
 ANY DAMAGED FINISHED FLOOR, WALL, CEILINGS SURFACES REMAINING
- POST DEMOLITION TO BE MADE GOOD. 9. ALL MECHANICAL, ELECTRICAL, HYDRAULIC, FIRE AND ANY OTHER
 SERVICES TO BE DECOMMISSIONED, REMOVED, DEMOLISHED, CAPPED
 AND OR RELOCATED TO THE EXTENT SHOWN ON THE CONSULTANT'S
- DRAWINGS.

 10. ALL FIRE EGRESS DOORS AND FIRE WALLS TO REMAIN 'OPERATIONAL' DURING DEMOLITION.

 11. EXISTING SANITARY FIXTURES AND FITTINGS TO BE REMOVED, CAPPED OFF, RE-DIRECTED OR AS OTHERWISE REQUIRED TO THE EXTENT SHOWN ON THE CONSULTANT'S DRAWINGS AND SPECIFICATIONS.

- EXISTING SSD FIXTURES AND FITTINGS TO BE REMOVED, ALL ELECTRICAL/PLUMBING TO BE DISCONNECTED/CAPPED OFF AND MAKE GOOD TO ACCEPT MODIFIED LAYOUT.
- 13. REMOVE ALL FLOOR FINISHES AS NECESSARY FOR REFURBISHMENT AREAS ONLY.

 14. SERVICE PENETRATIONS TO EXISTING SLAB IN STAFF AMENITIES TO
- OCCUR IN CAVITY WALL ZONE CHECK ON SITE EXISTING PT ZONES
- PRIOR TO LOCATING PENETRATIONS.

 15. WHERE POSSIBLE RETAIN ALL CEILINGS AND ONLY PATCH WHERE WALLS ARE REMOVED OR SERVICES ARE RELOCATED ALLOW TO RE-PAINT
- PLASTERBOARD CEILINGS IN A ROOM AFFECTED BY CHANGE.
- 16. DEMOLITION PROCESSES TO FOLLOW SESLHD/HI STRICT REQUIREMENTS TO NOT AFFECT THE OPERATION OF THE HOSPITAL. 17. DEMOLITION OF THE FAÇADE IN THE SSD ZONE TO ALSO FOLLOW
- SESLHD/HI STRICT REQUIREMENTS/PROCEDURES

 18. WHERE POSSIBLE REPAIR IN LIEU OF REMOVE AND REPLACE FINISHES. 19. ANY DEMOLITION OF STRUCTURAL MEMBERS IN EXISTING ROOF IS
- SUBJECT TO STRUCTURAL ANALYSIS, STRUCTURAL ENGINEER 20. TENDERER AND CLIENT TO AGREE ON SALVAGE ITEMS – NOT PART OF
- DEMOLITION SCOPE.
 21. FOR DEMOLITION OF ANY ELEMENTS OTHER THAN BUILDING, REFER CIVIL




EXISTING WALLS



EXISTING WALLS TO BE DEMOLISHED

EXISTING DOORS / CASEWORKS / ROOFS TO BE DEMOLISHED

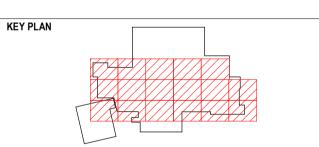

CBRE

LEVEL 12, 363 GEORGE STREET, SYDNEY, NSW, AUSTRALIA, 2000. 612 9333 3333.

NSW GOVERNMENT Infract Infrastructure

Level 6 77 Pacific Highway, North Sydney, NSW2060 P: +61 2 9978 5427 | F: +61 2 8904 1377 www.hinfra.health.nsw.gov.au

Level 1, 110 Walker Street, North Sydney NSW 2060, Australia +61 2 9956 2666 | hdrinc.com HDR Pty. Limited ABN 76 158 075 220 trading as HDR


THE SUTHERLAND HOSPITAL OPERATING THEATRE UPGRADE KINGSWAY & KAREENA ROAD, **CARINGBAH NSW 2229**

DRAWING TITLE **DEMOLITION PLAN - LEVEL**

DESIGN DEVELOPMENT

CHECKED BY APPROVED BY SCALE 1:250 @ A1 22/01/21 PROJECT NUMBER ISSUE

HDR-AR-DG-030300 4

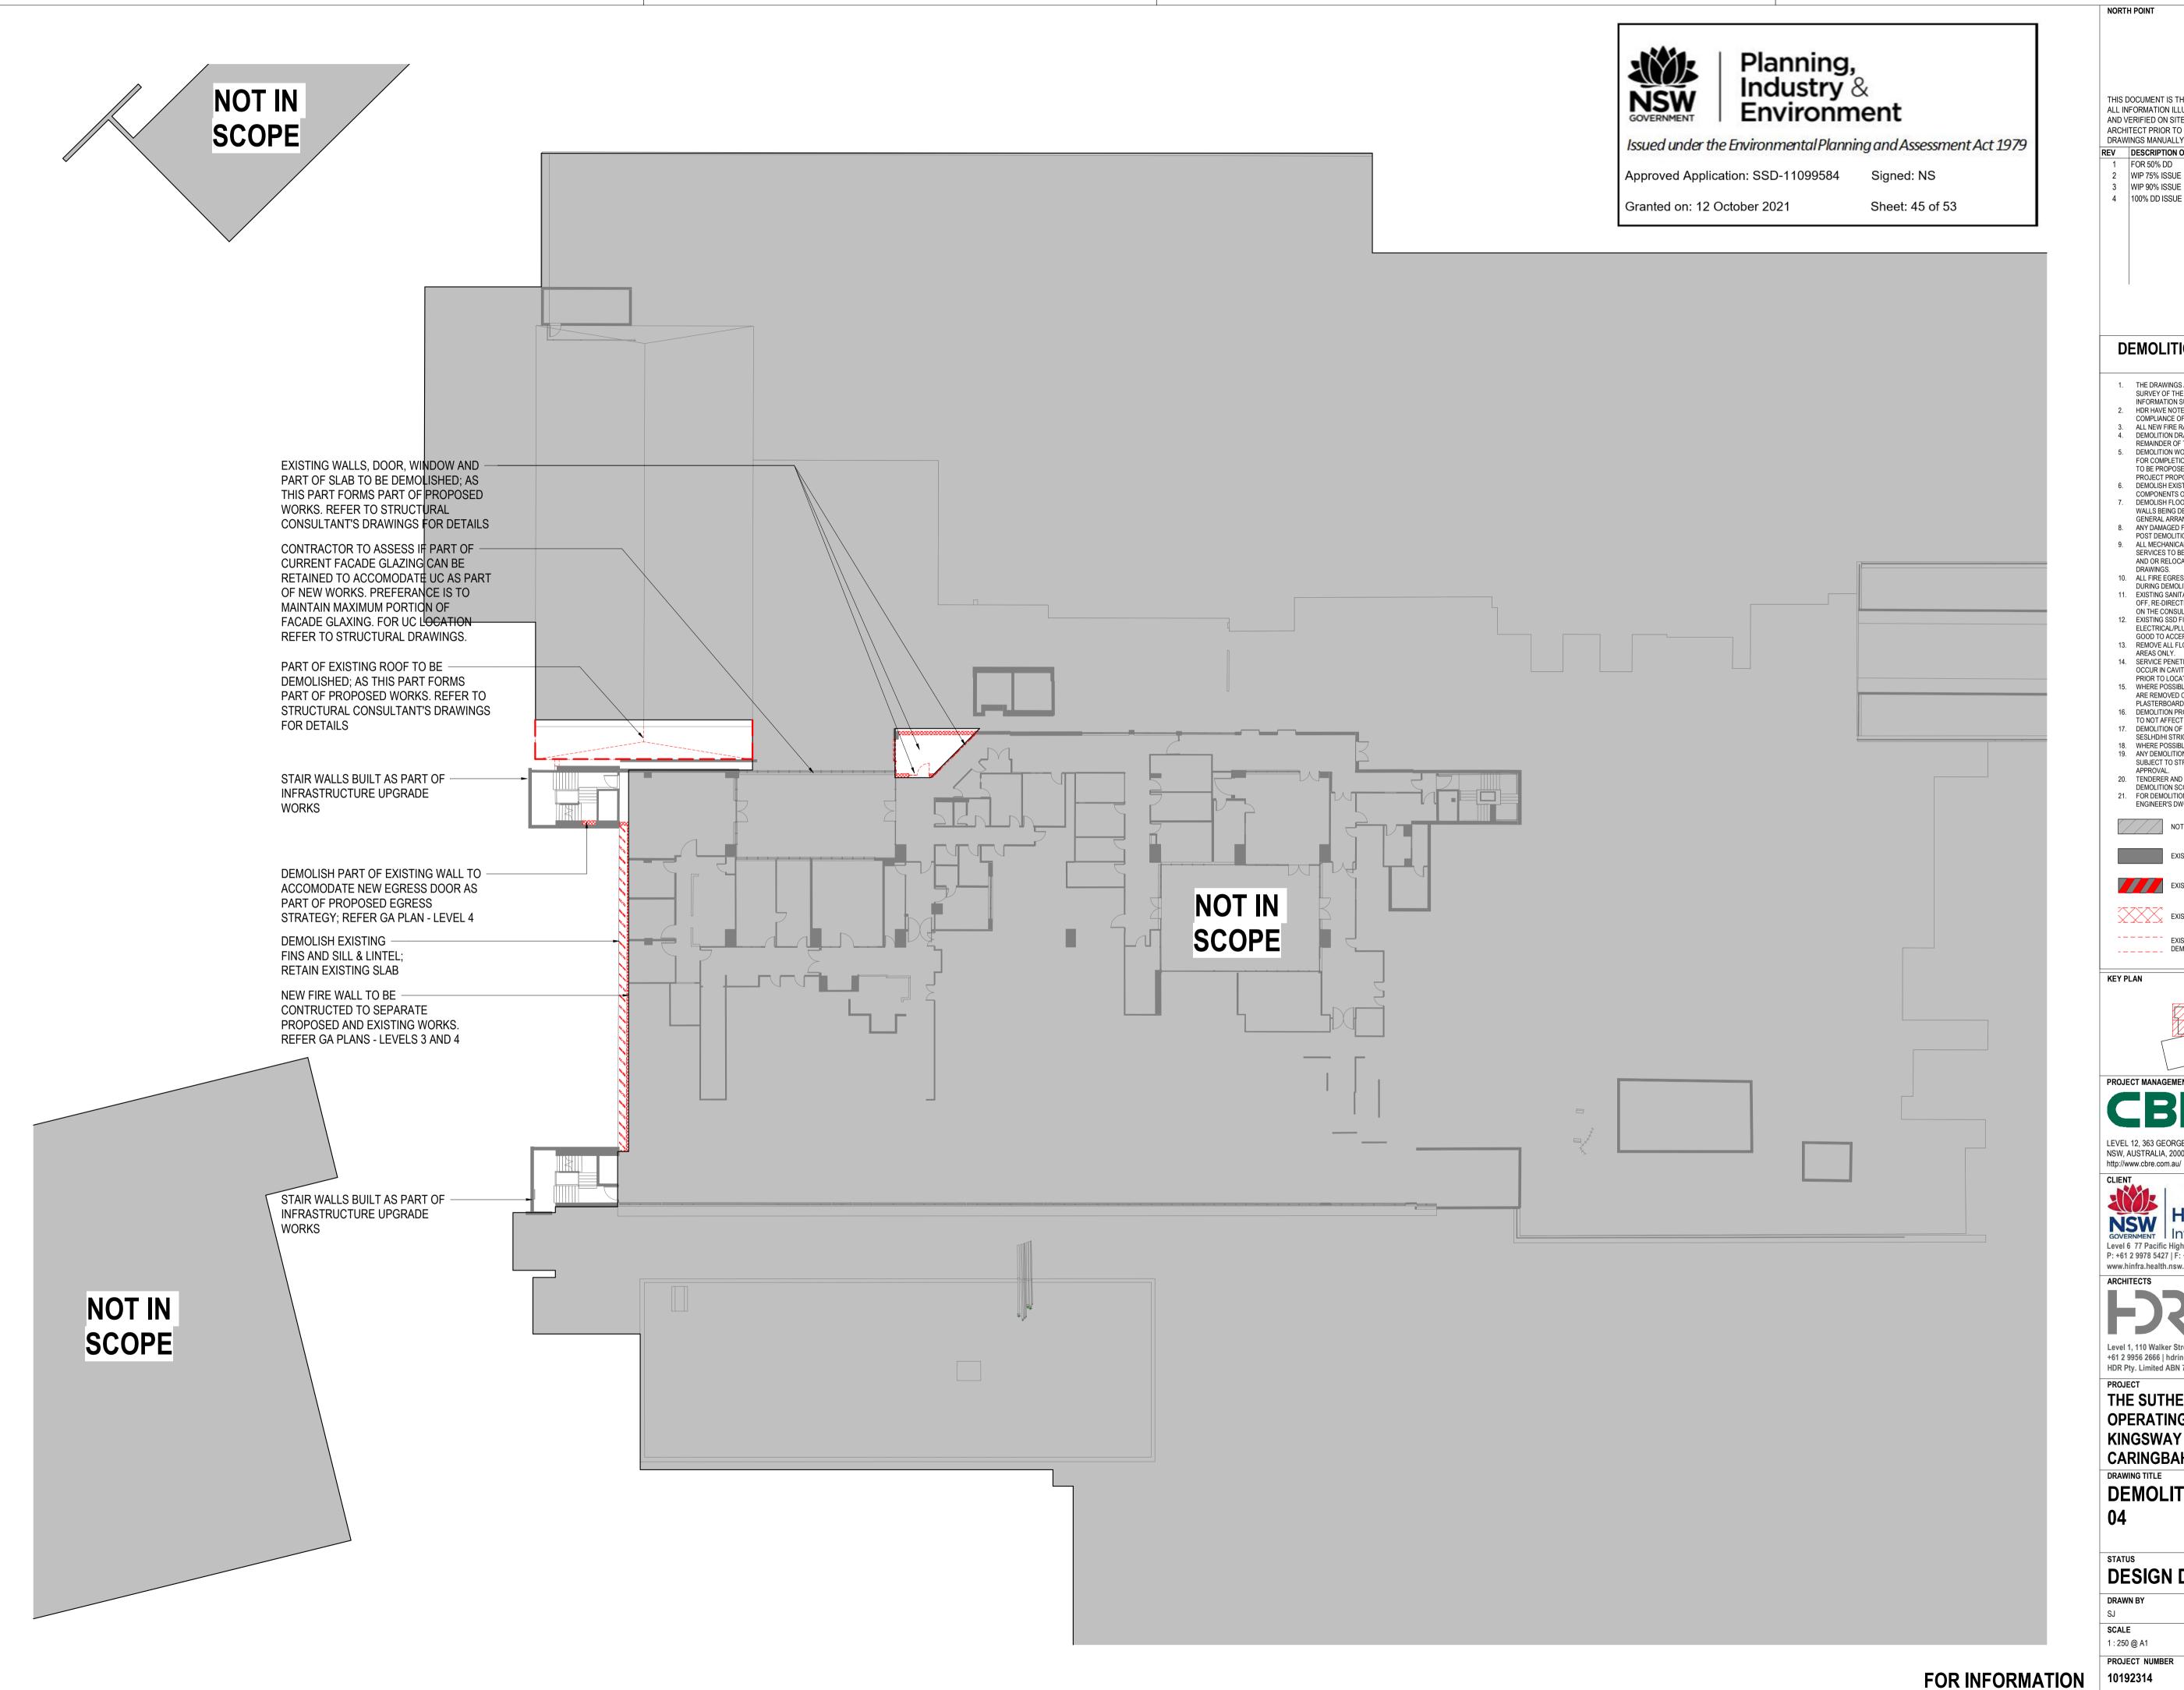

THIS DOCUMENT IS THE COPYRIGHT OF HDR. ALL INFORMATION ILLUSTRATED ON THIS DOCUMENT IS TO BE CHECKED AND VERIFIED ON SITE. IN THE EVENT OF DISCREPANCIES REFER TO ARCHITECT PRIOR TO COMMENCEMENT OF THE WORK. DO NOT SCALE DRAWINGS MANUALLY OR ELECTRONICALLY.

HDR

HDR 09/12/20 HDR 18/12/20

HDR 22/01/21

REV DESCRIPTION OF CHANGE CHECKED BY ISSUED BY DATE 1 FOR 50% DD HDR 2 WIP 75% ISSUE 3 WIP 90% ISSUE HDR

DEMOLITION NOTES AND LEGENDS

- 1. THE DRAWINGS ARE BASED ON CLIENT ISSUED CAD, BIM FILES AND
- SURVEY OF THE EXISTING HOSPITAL. HDR CAN ONLY RELY ON THE INFORMATION SUPPLIED BY THE CLIENT.

 HDR HAVE NOTED THE PATH OF EXISTING FIRE RATED WALLS THE
- COMPLIANCE OF THESE WALLS LIES WITH THE CLIENT.
- ALL NEW FIRE RATED WALLS TO BE COMPLIANT.
 DEMOLITION DRAWINGS TO BE READ IN CONJUNCTION WITH THE
- REMAINDER OF THE ARCHITECTURAL DRAWING SET.

 5. DEMOLITION WORKS ARE INDICATED TO THE FULL EXTENT REQUIRED FOR COMPLETION. STAGING OF DEMOLITION WILL BE REQUIRED AND IS TO BE PROPOSED BY THE CONTRACTOR IN ALIGNMENT WITH THE
- PROJECT PROPOSAL FOR STAGING.
 DEMOLISH EXISTING WALLS TO THE EXTENT SHOWN AND MAKE GOOD. COMPONENTS OF WALLS TO BE DEMOLISHED TO BE VERIFIED ON SITE.
- DEMOLISH FLOOR FINISHES AND CEILINGS WITHIN SCOPED AREA AND WALLS BEING DEMOLISHED TO BE READ IN CONJUNCTION WITH GENERAL ARRANGEMENT PLAN
- 8. ANY DAMAGED FINISHED FLOOR, WALL, CEILINGS SURFACES REMAINING POST DEMOLITION TO BE MADE GOOD.

 9. ALL MECHANICAL, ELECTRICAL, HYDRAULIC, FIRE AND ANY OTHER
- SERVICES TO BE DECOMMISSIONED, REMOVED, DEMOLISHED, CAPPED
- AND OR RELOCATED TO THE EXTENT SHOWN ON THE CONSULTANT'S
- 10. ALL FIRE EGRESS DOORS AND FIRE WALLS TO REMAIN 'OPERATIONAL' DURING DEMOLITION.

 11. EXISTING SANITARY FIXTURES AND FITTINGS TO BE REMOVED, CAPPED
- OFF, RE-DIRECTED OR AS OTHERWISE REQUIRED TO THE EXTENT SHOWN
- ON THE CONSULTANT'S DRAWINGS AND SPECIFICATIONS.

 12. EXISTING SSD FIXTURES AND FITTINGS TO BE REMOVED, ALL ELECTRICAL/PLUMBING TO BE DISCONNECTED/CAPPED OFF AND MAKE
- GOOD TO ACCEPT MODIFIED LAYOUT.

 13. REMOVE ALL FLOOR FINISHES AS NECESSARY FOR REFURBISHMENT AREAS ONLY.
- SERVICE PENETRATIONS TO EXISTING SLAB IN STAFF AMENITIES TO OCCUR IN CAVITY WALL ZONE CHECK ON SITE EXISTING PT ZONES PRIOR TO LOCATING PENETRATIONS. 15. WHERE POSSIBLE RETAIN ALL CEILINGS AND ONLY PATCH WHERE WALLS
- ARE REMOVED OR SERVICES ARE RELOCATED ALLOW TO RE-PAINT PLASTERBOARD CEILINGS IN A ROOM AFFECTED BY CHANGE.
- 16. DEMOLITION PROCESSES TO FOLLOW SESLHD/HI STRICT REQUIREMENTS TO NOT AFFECT THE OPERATION OF THE HOSPITAL.

 17. DEMOLITION OF THE FAÇADE IN THE SSD ZONE TO ALSO FOLLOW
- SESLHD/HI STRICT REQUIREMENTS/PROCEDURES
- 18. WHERE POSSIBLE REPAIR IN LIEU OF REMOVE AND REPLACE FINISHES.

 19. ANY DEMOLITION OF STRUCTURAL MEMBERS IN EXISTING ROOF IS
- SUBJECT TO STRUCTURAL ANALYSIS, STRUCTURAL ENGINEER
- 20. TENDERER AND CLIENT TO AGREE ON SALVAGE ITEMS NOT PART OF DEMOLITION SCOPE.
- 21. FOR DEMOLITION OF ANY ELEMENTS OTHER THAN BUILDING, REFER CIVIL


ENGINEER'S DWGS. NOT IN SCOPE

EXISTING WALLS

EXISTING FIRE WALLS

EXISTING WALLS TO BE DEMOLISHED

EXISTING DOORS / CASEWORKS / ROOFS TO BE

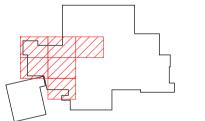

CBRE

LEVEL 12, 363 GEORGE STREET, SYDNEY, NSW, AUSTRALIA, 2000. 612 9333 3333.



NSW GOVERNMENT Infrast OVERNMENT Infrastructure

Level 6 77 Pacific Highway, North Sydney, NSW2060 P: +61 2 9978 5427 | F: +61 2 8904 1377 www.hinfra.health.nsw.gov.au

Level 1, 110 Walker Street, North Sydney NSW 2060, Australia +61 2 9956 2666 | hdrinc.com HDR Pty. Limited ABN 76 158 075 220 trading as HDR

THE SUTHERLAND HOSPITAL OPERATING THEATRE UPGRADE KINGSWAY & KAREENA ROAD, **CARINGBAH NSW 2229**

DRAWING TITLE **DEMOLITION PLAN - LEVEL**


DESIGN DEVELOPMENT


SCALE 1:250 @ A1 22/01/21 ISSUE PROJECT NUMBER


HDR-AR-DG-030400 4

THE SUTHERLAND HOSPITAL OPERATING THEATRE UPGRADE PROJECT MAIN BUILDING WORKS

CIVIL ENGINEERING SERVICES

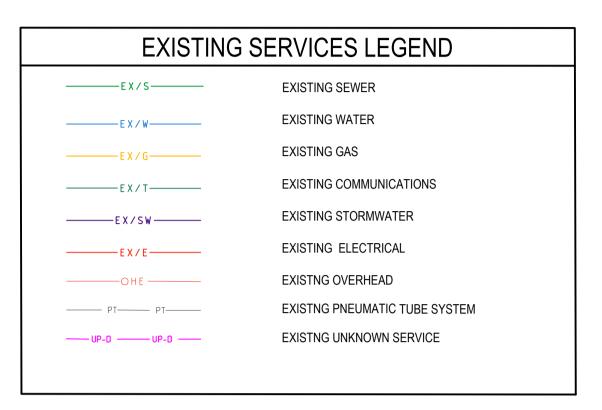

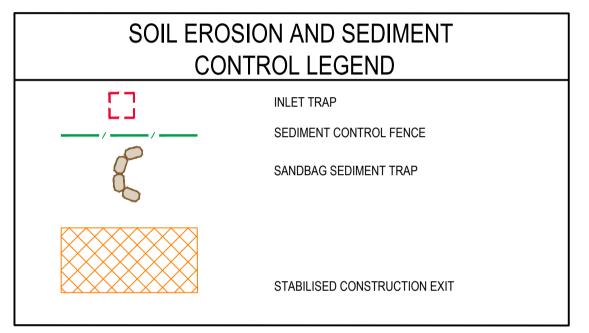

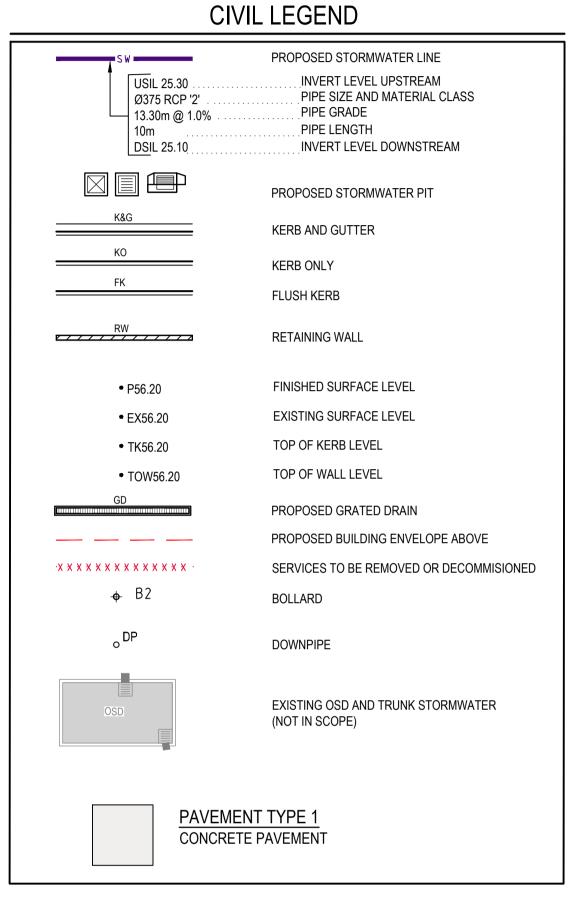



	DRAWING INDEX			
	DWG No.	DESCRIPTION		
CV-DG-1001 COVER SHEET, DRAWING INDEX AND LE				
	CV-DG-1002	NOTES		
	CV-DG-1005	DETAILS - SHEET 1		
	CV-DG-1006	DETAILS - SHEET 2		
	CV-DG-1007	DETAILS - SHEET 3		
	CV-DG-3001	CIVIL WORKS PLAN		
	CV-DG-3100	STORMWATER MANAGEMENT PLAN		
	CV-DG-5001	SOIL EROSION AND SEDIMENT CONTROL PLAN		



Granted on: 12 October 2021

DIAL BEFORE YOU DIG				
DIAL BEFORE YOU DIG www.1100.com.au	IMPORTANT: THE CONTRACTOR IS TO MAINTAIN A CURRENT SET OF "DIAL BEFORE YOU DIG" DRAWINGS ON SITE AT ALL TIMES.			

COPYRIGHT of this design and plan is the property of ACOR Consultants Pty Ltd, ACN 079 306 246 ABN 40 079 306 246, all rights reserved. It must not be used, modified, reproduced or copied wholly or in part without written permission from ACOR Consultants Pty Ltd.

Sheet: 46 of 53

This drawing has been assigned an electronic code that signifies the drawing has been checked and approved by: ISSUE FOR DRAFT SSDA A ISSUE FOR SCHEMATIC DESIGN







St Leonards NSW 2065 T +61 2 9438 5098

ACOR Consultants Pty Ltd

Suita 2 Level 1 33 Herbert Street THE SUTHERLAND HOSPITAL OPERATING THEATRE UPGRADE PROJECT -

COVER SHE	END			
Drawn	Date	Scale	A1	Q.A. Check
DK	Jul-20	N/A		

NOT FOR CONSTRUCTION

CONSULTANTS ENGINEERS | MANAGERS | INFRASTRUCTURE PLANNERS | DEVELOPMENT CONSULTANTS

- THE CONTRACTOR SHALL ENSURE THAT AT ALL TIMES SERVICES TO ALL BUILDINGS NOT AFFECTED BY THE WORKS ARE NOT DISRUPTED.
- PRIOR TO COMMENCEMENT OF ANY WORKS THE CONTRACTOR SHALL GAIN WRITTEN APPROVAL OF HIS PROGRAMME FOR THE RELOCATION/CONSTRUCTION OF TEMPORARY SERVICES.
- EXISTING BUILDINGS, EXTERNAL STRUCTURES, AND TREES SHOWN ON THESE DRAWINGS ARE FEATURES EXISTING PRIOR TO ANY DEMOLITION WORKS.
- CONTRACTOR SHALL CONSTRUCT TEMPORARY SERVICES TO MAINTAIN EXISTING SUPPLY TO BUILDINGS REMAINING IN OPERATION DURING WORKS TO THE SATISFACTION AND APPROVAL OF THE SUPERINTENDENT. ONCE DIVERSION IS IS COMPLETE AND COMMISSIONED THE CONTRACTOR SHALL REMOVE ALL SUCH TEMPORARY SERVICES AND MAKE GOOD TO THE SATISFACTION OF THE SUPERINTENDENT.
- INTERRUPTION TO SUPPLY OF EXISTING SERVICES SHALL BE DONE SO AS NOT TO CAUSE ANY INCONVENIENCE TO THE PRINCIPAL. CONTRACTOR TO GAIN APPROVAL OF SUPERINTENDENT FOR TIME OF INTERRUPTION.

SITEWORKS NOTES

- ORIGIN OF LEVELS :- AUSTRALIAN HEIGHT DATUM (A.H.D.)
- 2. CONTRACTOR MUST VERIFY ALL DIMENSIONS AND EXISTING LEVELS ON SITE PRIOR TO COMMENCEMENT OF WORK
- ALL WORK IS TO BE UNDERTAKEN IN ACCORDANCE WITH THE DETAILS SHOWN ON THE DRAWINGS, THE SPECIFICATIONS AND THE DIRECTIONS OF THE PRINCIPAL'S REPRESENTATIVE.
- EXISTING SERVICES HAVE BEEN PLOTTED FROM SUPPLIED DATA AND AS SUCH THEIR ACCURACY CANNOT BE GUARANTEED. IT IS THE RESPONSIBILITY OF THE CONTRACTOR TO ESTABLISH THE LOCATION AND LEVEL OF ALL EXISTING SERVICES PRIOR TO THE COMMENCEMENT OF ANY WORK. ANY DISCREPANCIES SHALL BE REPORTED TO THE PRINCIPAL'S REPRESENTATIVE. CLEARANCES SHALL BE OBTAINED FROM THE RELEVANT SERVICE AUTHORITY.
- WHERE NEW WORKS ABUT EXISTING THE CONTRACTOR SHALL ENSURE THAT A SMOOTH EVEN PROFILE, FREE FROM ABRUPT CHANGES IS OBTAINED.
- THE CONTRACTOR SHALL ARRANGE ALL SURVEY SETOUT TO BE CARRIED OUT BY A REGISTERED SURVEYOR.
- CARE IS TO BE TAKEN WHEN EXCAVATING NEAR EXISTING SERVICES. NO MECHANICAL EXCAVATIONS ARE TO BE UNDERTAKEN OVER COMMUNICATIONS OR ELECTRICAL SERVICES.
- HAND EXCAVATE IN THESE AREAS. ALL SERVICE TRENCHES UNDER VEHICULAR PAVEMENTS SHALL BE BACKFILLED WITH AN APPROVED NON-NATURAL GRANULAR MATERIAL AND COMPACTED TO 98% STANDARD
- 9. ALL TRENCH BACKFILL MATERIAL SHALL BE COMPACTED TO THE SAME DENSITY AS THE ADJACENT MATERIAL.
- 10. ON COMPLETION OF PIPE INSTALLATION ALL DISTURBED AREAS MUST BE RESTORED TO ORIGINAL, INCLUDING KERBS, FOOTPATHS, CONCRETE AREAS, GRAVEL AND GRASSED AREAS AND ROAD PAVEMENTS.
- PROVIDE 12mm WIDE EXPANDING CORK JOINTS BETWEEN CONCRETE PAVEMENTS AND ALL BUILDINGS, WALLS, FOOTINGS, COLUMNS, KERBS, DISH DRAINS, GRATED DRAINS, BOLLARD
- 12. CONTRACTOR TO OBTAIN ALL AUTHORITY APPROVALS.
- 13. ALL BATTERS TO BE GRASSED LINED WITH MINIMUM 100 TOPSOIL AND APPROVED COUCH
- 14. MAKE SMOOTH TRANSITION TO EXISTING SERVICES AND MAKE GOOD.

MAXIMUM DRY DENSITY IN ACCORDANCE WITH AS.1289.5.1.1.

- THE CONTRACTOR SHALL PROVIDE ALL TEMPORARY DIVERSION DRAINS AND MOUNDS TO ENSURE THAT AT ALL TIMES EXPOSED SURFACES ARE FREE DRAINING AND WHERE NECESSARY EXCAVATE SUMPS AND PROVIDE PUMPING EQUIPMENT TO DRAIN EXPOSED AREAS.
- THESE PLANS SHALL BE READ IN CONJUNCTION WITH APPROVED ARCHITECTURAL, STRUCTURAL, HYDRAULIC AND ELECTRICAL DRAWINGS AND SPECIFICATIONS.
- TRENCHES THROUGH EXISTING ROAD AND CONCRETE PAVEMENTS SHALL BE SAWCUT TO FULL DEPTH OF CONCRETE AND A MIN 50mm IN BITUMINOUS PAVING.
- 18. ALL BRANCH GAS AND WATER SERVICES UNDER DRIVEWAYS AND BRICK PAVING SHALL BE

LOCATED IN Ø80 uPVC SEWER GRADE CONDUITS EXTENDING A MIN OF 500mm PAST PAVING.

19. ON COMPLETION OF WORKS ALL DISTURBED AREAS MUST BE RESTORED TO ORIGINAL INCLUDING, BUT NOT LIMITED TO, KERBS, FOOTPATHS, CONCRETE AREAS, GRASS AND LANDSCAPED AREAS.

STORMWATER NOTES

- ALL 225 DIA. DRAINAGE PIPES AND LARGER SHALL BE CLASS "2" APPROVED SPIGOT AND SOCKET FRC OR RCP PIPES WITH RUBBER RING JOINTS. (U.N.O.) ALL DOWNPIPE DRAINAGE LINES SHALL BE SEWER GRADE uPVC WITH SOLVENT WELD JOINTS. (U.N.O.)
- 2. EQUIVALENT STRENGTH REINFORCED CONCRETE PIPES MAY BE USED.
- ALL PIPE JUNCTIONS UP TO AND INCLUDING 450 DIA. AND TAPERS SHALL BE VIA PURPOSE MADE FITTINGS.
- 4. MINIMUM GRADE TO STORMWATER LINES TO BE 1%. (U.N.O.)
- CONTRACTOR TO SUPPLY AND INSTALL ALL FITTINGS AND SPECIALS INCLUDING VARIOUS PIPE ADAPTORS TO ENSURE PROPER CONNECTION BETWEEN DISSIMILAR PIPEWORK.
- ALL CONNECTIONS TO EXISTING DRAINAGE PITS SHALL BE MADE IN A TRADESMAN-LIKE MANNER AND THE INTERNAL WALL OF THE PIT AT THE POINT OF ENTRY SHALL BE CEMENT RENDERED TO ENSURE A SMOOTH FINISH.
- PRECAST PITS SHALL NOT BE USED UNLESS WRITTEN APPROVAL IS OBTAINED FROM THE SUPERINTENDENT.
- WHERE TRENCHES ARE IN ROCK, THE PIPE SHALL BE BEDDED ON A MIN. 50MM CONCRETE BED (OR 75MM THICK BED OF 12MM BLUE METAL) UNDER THE BARREL OF THE PIPE. THE PIPE COLLAR AT NO POINT SHALL BEAR ON THE ROCK. IN OTHER THAN ROCK, PIPES SHALL BE LAID ON A 75MM THICK SAND BED. IN ALL CASES BACKFILL THE TRENCH WITH SAND TO 200MM ABOVE THE PIPE. WHERE THE PIPE IS UNDER PAVEMENTS BACKFILL REMAINDER OF TRENCH WITH SAND OR APPROVED GRANULAR BACKFILL COMPACTED IN 150MM LAYERS TO 98% STANDARD MAX. DRY DENSITY.
- BEDDING SHALL BE (U.N.O.) TYPE H1, IN ACCORDANCE WITH CURRENT RELEVANT AUSTRALIAN STANDARDS.
- 10. WHERE STORMWATER LINES PASS UNDER FLOOR SLABS SEWER GRADE RUBBER RING JOINTS ARE TO BE USED.
- 11. WHERE SUBSOIL DRAINAGE LINES PASS UNDER FLOOR SLABS AND VEHICULAR PAVEMENTS UNSLOTTED UPVC SEWER GRADE PIPE SHALL BE USED.
- 12. PROVIDE 3.0M LENGTH OF 100 DIA. SUBSOIL DRAINAGE PIPE WRAPPED IN FABRIC SOCK, AT UPSTREAM END OF EACH PIT.

SUBGRADE PREPARATION

- REMOVE ALL TOPSOIL, VEGETABLE MATTER AND RUBBLE.
- 2. PROOF ROLL NATURAL SURFACE.
- REMOVE ANY SOFT AREAS.
- 4. PLACE APPROVED NON ORGANIC FILL WITH A MAXIMUM PARTICLE SIZE OF 75mm AND COMPACT IN 200mm MAX, THICK LAYERS, U.N.O.
- COMPACTION IS TO BE CARRIED OUT BY ROLLING AT OPTIMUM MOISTURE CONTENT TO OBTAIN A DENSITY EQUIVALENT TO 98% OF MAXIMUM DRY DENSITY WHEN TESTED BY THE STANDARD COMPACTION TEST. No. E1.1 FROM A.S. 1289.5.1.1.
- 6. COMPACTION SHALL BE CARRIED OUT WITH A VIBRATING ROLLER WITH AT LEAST 10 TONNE STATIC WEIGHT.
- 7. TESTING OF THE SUBGRADE SHALL BE CARRIED OUT BY AN APPROVED N.A.T.A. REGISTERED LABORATORY.

COMPACTION NOTES

- STRIP TOPSOIL TO EXPOSE NATURALLY OCCURRING MATERIAL AND STOCKPILE ON SITE FOR SELECTIVE RE-USE OR DISPOSE OFF-SITE AS DIRECTED BY THE SUPERINTENDENT.
- WHERE FILLING IS REQUIRED TO ACHIEVE DESIGN SUBGRADE PROOF ROLL EXPOSED NATURAL SURFACE WITH A MINIMUM OF TEN PASSES OF A VIBRATING ROLLER (MINIMUM STATIC WEIGHT OF 10 TONNES) IN THE PRESENCE OF THE SUPERINTENDENT. REFER TO SPECIFICATION FOR DETAILS.
- 3. ALL SOFT, WET OR UNSUITABLE MATERIAL TO BE REMOVED AS DIRECTED BY THE SUPERINTENDENT AND REPLACED WITH APPROVED MATERIAL SATISFYING THE REQUIREMENTS LISTED BELOW.
- 4. ALL FILL MATERIAL SHALL BE FROM A SOURCE APPROVED BY THE SUPERINTENDENT AND SHALL COMPLY WITH THE FOLLOWING:
 - a. FREE FROM ORGANIC, PERISHABLE AND CONTAMINATED MATTER
 - b. MAXIMUM PARTICLE SIZE 75MM c. PLASTICITY INDEX BETWEEN 2% AND 15%
- ALL FILL MATERIAL SHALL BE PLACED IN MAXIMUM 200MM THICK LAYERS AND COMPACTED AT OPTIMUM MOISTURE CONTENT (+ OR - 2%) TO ACHIEVE A DRY DENSITY DETERMINED IN ACCORDANCE WITH AS 1289.5.3.1 OF NOT LESS THAN THE FOLLOWING STANDARD MINIMUM DRY DENSITY IN ACCORDANCE WITH AS 1289.5.1.1:

STANDARD DRY DENSITY **UNDER BUILDING SLABS** AREAS OF SERVICE TRENCHES 98% EXTERNAL PAVED AREAS, ROADS AND CARPARKS 98% LANDSCAPED AREAS 90%

- THE CONTRACTOR SHALL PROGRAM THE EARTHWORKS OPERATION SO THAT THE WORKING AREAS ARE ADEQUATELY DRAINED DURING THE PERIOD OF CONSTRUCTION. THE SURFACE SHALL BE GRADED AND SEALED OFF TO REMOVE DEPRESSIONS, ROLLER MARKS AND SIMILAR WHICH WOULD ALLOW WATER TO POND AND PENETRATE THE UNDERLYING MATERIAL. ANY DAMAGE RESULTING FROM THE CONTRACTOR NOT OBSERVING THESE REQUIREMENTS SHALL BE RECTIFIED BY THE CONTRACTOR AT THEIR COST.
- TESTING OF THE SUBGRADE SHALL BE CARRIED OUT BY AN APPROVED NATA REGISTERED LABORATORY AT THE CONTRACTORS EXPENSE.

CONCRETE NOTES

GENERAL

- ALL WORKMANSHIP AND MATERIALS SHALL COMPLY WITH AS 3600 CURRENT EDITIONS WITH AMENDMENTS, AND THE ACSE CONCRETE SPECIFICATION EXCEPT WHERE VARIED BY THE CONTRACT DOCUMENTS.
- 2. VERIFY ALL SETTING OUT DIMENSIONS WITH THE ARCHITECT AND/OR THE SURVEYOR.
- 3. DO NOT OBTAIN DIMENSIONS BY SCALING THE DRAWINGS.
- IN CASE OF DOUBT ASK.

DESIGN LOADS

1. N/A CONCRETE

> PLACE CONCRETE OF THE FOLLOWING CHARACTERISTIC COMPRESSIVE STRENGTH F"C AS DEFINED IN AS.3600 OR M.R. FORM 609. ADD WATER REDUCING ADMIXTURE EQUAL TO WRDA.

LOCATION	AS.3600 F'c MPa AT 28 DAYS	SPECIFIED SLUMP	NOMINAL AGG. SIZE
ALL KERB PITS ETC.	25	80	20
VEHICULAR PAVEMENTS	32	80	20

- 2. USE "A.C.S.E. SPECIFICATION TYPE A" CEMENT
- 3. ALL CONCRETE SHALL BE SUBJECT TO PROJECT CONTROL SAMPLE AND TESTING TO AS.3600.
- 4. CONSOLIDATE BY VIBRATION.

REINFORCEMENT

FIX REINFORCEMENT AS SHOWN ON DRAWINGS. THE TYPE AND GRADE IS INDICATED BY A SYMBOL AS SHOWN BELOW. ON THE DRAWING N IS FOLLOWED BY A NUMERAL WHICH INDICATES THE SIZE IN MILLIMETRES. A MARK NUMERAL (IF USED) FOLLOWS THIS NUMERAL. N. HOT ROLLED DEFORMED BAR, GRADE 410Y S. HOT ROLLED DEFORMED BAR, GRADE 230S

R. PLAIN ROUND BAR, GRADE 230R SL. HARD DRAWN WIRE FABRIC.

PROVIDE BAR SUPPORTS OR SPACERS TO GIVE THE FOLLOWING CONCRETE COVER TO ALL REINFORCEMENT UNLESS NOTED OTHERWISE.

- 75 BOTTOM, 65 TOP AND SIDES SLABS

- 20 TOP AND BOTTOM, 30 WHEN EXPOSED TO WEATHER.

- 50 BOTTOM AND SIDES (TO STIRRIPS) TOP COVER AS DETAILED COLUMNS

- 40 TO TIES AND SPIRALS 50 WHEN EXPOSED TO WEATHER

- 25 GENERALLY 30 WHEN CAST IN FORMS BUT LATER EXPOSED TO WEATHER OR

GROUND. 65 WHEN CAST DIRECTLY IN CONTACT WITH GROUND.

CURING

CURE ALL CONCRETE IN ACCORDANCE TO THE METHOD PROVIDED IN THE SPECIFICATION.

CONCRETE PAVEMENT JOINT NOTES

- PJ1. CONCRETE MIX PARAMETERS

 - MAXIMUM AGGREGATE SIZE 20mm - FLEXURAL STRENGTH AT 28 DAYS = 3.5MPa
 - FLEXURAL STRENGTH AT 90 DAYS = 3.85 MPa
 - MAXIMUM WATER / CEMENT RATIO = 0.55 STRAINS
 - MAXIMUM SHRINKAGE LIMIT = 650 MICRON (AS 1012 Pt 13)
 - · MINIMUM CEMENT CONTENT = 300kg/m3 - CEMENT TO BE TYPE "A" (NORMAL CEMENT) TO AS.1315
- PJ2. JOINT TO BE SAWN AS SOON AS CONCRETE HAS HARDENED SUFFICIENTLY THAT IT WILL NOT BE DAMAGED BY SAWING. IF AN UNPLANNED CRACK OCCURS THE CONTRACTOR SHALL REPLACE WHOLE SLABS EITHER SIDE OF THE UNPLANNED CRACK, UNLESS
- PJ3. a. CONSTRUCT JOINTS AS DETAILED

DIRECTED OTHERWISE.

- SLUMP = 80mm

- CONSTRUCTION JOINTS WHERE REQUIRED BUT NOT SHOWN, SHALL BE LOCATED TO THE APPROVAL OF THE ENGINEER AND CONSTRUCTED AT THE CONTRACTORS EXPENSE.
- c. ALL LONGITUDINAL CONSTRUCTION JOINTS SHALL BE FORMED AND INCLUDE DOWEL BARS AS SPECIFIED. ALL TRANSVERSE CONSTRUCTION JOINTS SHALL BE FORMED AND INCLUDE DOWEL BARS AS SPECIFIED.
- d. BOND BREAKER TO BE TWO (2) UNIFORM COATS OF BITUMEN EMULSION ALL OVER THE EXPOSED SURFACE AND ON END.
- DOWELS AND TIE BARS TO MEET STRENGTH REQUIREMENTS OF STRUCTURAL GRADE STEEL IN ACCORDANCE AS. 1302. DOWELS AND TIE BARS SHALL BE ;-
 - STRAIGHT - TO LENGTH SPECIFIED
 - CLEAN AND FREE FROM MILL SCALE, RUST AND OIL
 - SAWN TO LENGTH NOT CROPPED.
- PJ5. DIMENSIONS OF SEALANT RESERVOIR DEPENDANT ON THE SEALANT TYPE ADOPTED ENGINEERS APPROVAL TO BE OBTAINED FOR SEALANT AND RESERVOIR DIMENSIONS AND DETAIL PROPOSED BY THE CONTRACTOR. REFER DETAIL "B" FOR TYPICAL ARRANGEMENT AND SEALANT.
- PRIOR TO THE PLACEMENT OF CONCRETE IN THE ADJACENT SLAB, SELF EXPANDING CORK FILLER SHALL BE ADHERED TO THE ALREADY CAST AND CLEANED CONCRETE FACE USING AN APPROVED WATERPROOF ADHESIVE. ADHESIVE SHALL BE LIBERALLY APPLIED TO THE FULL FACE OF THE CONCRETE SLAB TO BE COVERED BY THE FILLER, AND ON THE FULL FACE OF THE FILLER TO BE ADHERED.
- PJ7. REFER TO COMPACTION NOTES FOR PREPARATION OF SUB-BASE AND SUB-GRADE.
- PJ8. ALL WORK TO BE BROOM FINISH.

EROSION AND SEDIMENT CONTROL NOTES

GENERAL INSTRUCTIONS

- E1. THIS PLAN IS TO BE READ IN CONJUNCTION WITH THE ENGINEERING PLANS. AND ANY OTHER PLANS OR WRITTEN INSTRUCTIONS THAT MAY BE ISSUED AND RELATING TO DEVELOPMENT AT THE SUBJECT SITE.
- E2. THE SITE SUPERINTENDENT WILL ENSURE THAT ALL SOIL AND WATER MANAGEMENT WORKS ARE LOCATED AS INSTRUCTED IN THIS SPECIFICATION.
- E3. ALL BUILDERS AND SUB-CONTRACTORS WILL BE INFORMED OF THEIR RESPONSIBILITIES IN MINIMISING THE POTENTIAL FOR SOIL EROSION AND POLLUTION TO DOWNSLOPE LANDS AND WATERWAYS.

CONSTRUCTION SEQUENCE

- E4. THE SOIL EROSION POTENTIAL ON THIS SITE SHALL BE MINIMISED. HENCE WORKS SHALL BE UNDERTAKEN IN THE FOLLOWING SEQUENCE:
 - INSTALL SEDIMENT FENCES, TEMPORARY CONSTRUCTION EXIT AND SANDBAG KERB INLET SEDIMENT TRAP.
 - UNDERTAKE SITE DEVELOPMENT WORKS IN ACCORDANCE WITH THE ENGINEERING PLANS. PHASE DEVELOPMENT SO THAT LAND DISTURBANCE IS CONFINED TO AREAS OF WORKABLE SIZE.

EROSION CONTROL

- E5. DURING WINDY CONDITIONS, LARGE, UNPROTECTED AREAS WILL BE KEPT MOIST (NOT WET) BY SPRINKLING WITH WATER TO KEEP DUST UNDER CONTROL.
- E6. FINAL SITE LANDSCAPING WILL BE UNDERTAKEN AS SOON AS POSSIBLE AND WITHIN 20 WORKING DAYS FROM COMPLETION OF CONSTRUCTION ACTIVITIES.

FENCING

- E7. STOCKPILES WILL NOT BE LOCATED WITHIN 2 METRES OF HAZARD AREAS, INCLUDING LIKELY AREAS OF CONCENTRATED OR HIGH VELOCITY FLOWS SUCH AS WATERWAYS. WHERE THEY ARE BETWEEN 2 AND 5 METRES FROM SUCH AREAS, SPECIAL SEDIMENT CONTROL MEASURES SHOULD BE TAKEN TO MINIMISE POSSIBLE POLLUTION TO DOWNSLOPE WATERS, E.G. THROUGH INSTALLATION OF SEDIMENT FENCING.
- E8. ANY SAND USED IN THE CONCRETE CURING PROCESS (SPREAD OVER THE SURFACE) WILL BE REMOVED AS SOON AS POSSIBLE AND WITHIN 10 WORKING DAYS FROM PLACEMENT.
- E9. WATER WILL BE PREVENTED FROM ENTERING THE PERMANENT DRAINAGE SYSTEM UNLESS IT IS RELATIVELY SEDIMENT FREE, I.E. THE CATCHMENT AREA HAS BEEN PERMANENTLY LANDSCAPED AND/OR ANY LIKELY SEDIMENT HAS BEEN FILTERED THROUGH AN APPROVED STRUCTURE.
- E10. TEMPORARY SOIL AND WATER MANAGEMENT STRUCTURES WILL BE REMOVED ONLY AFTER THE LANDS THEY ARE PROTECTING ARE REHABILITATED.

- E11. ACCEPTABLE RECEPTORS WILL BE PROVIDED FOR CONCRETE AND MORTAR SLURRIES, PAINTS, ACID WASHINGS, LIGHT-WEIGHT WASTE MATERIALS AND LITTER.
- E12. RECEPTORS FOR CONCRETE AND MORTAR SLURRIES, PAINTS, ACID WASHINGS, LIGHT-WEIGHT WASTE MATERIALS AND LITTER ARE TO BE EMPTIED AS NECESSARY, DISPOSAL OF WASTE SHALL BE IN A MANNER APPROVED BY THE SITE SUPERINTENDENT.

SITE INSPECTION & MAINTENANCE

E13. EROSION AND SEDIMENT CONTROL MEASURES SHALL BE INSPECTED AFTER RAINFALL EVENTS TO ENSURE THAT THEY OPERATE EFFECTIVELY. REPAIR AND OR MAINTENANCE SHALL BE UNDERTAKEN AS REQUIRED.



Issued under the Environmental Planning and Assessment Act 1979

Approved Application: SSD-11099584 Signed: NS

Granted on: 12 October 2021 Sheet: 47 of 53

NOT FOR CONSTRUCTION

Q.A. Check Designed SY191015 CV-DG-1002

C) COPYRIGHT of this design and plan is the property of ACOR Consultants Pty Ltd, ACN 079 306 246 ABN 40 079 306 246, all rights reserved. It must not be used, modified, reproduced or copied wholly or in part without written permission from ACOR Consultants Pty Ltd.

ISSUE FOR DRAFT SSDA A ISSUE FOR SCHEMATIC DESIGN 07.08.20 DK CR Issue. Description Drawn Approved

his drawing has been assigned an electronic code that signifies the drawing has been checked and approved by:

Health Infrastructure LEVEL 8, 77 PACIFIC HWY NORTH SYDNEY, NSW 2060 www.hinfra.health.nsw.gov.au

LEVEL 1, 110 WALKER STREET, NORTH SYDNEY, NSW 2060 +61 2 9956 2666 I hdrinc.com HDR Pty. Limited ABN 76 158 075 220 trading as HDR



Suite 2, Level 1, 33 Herbert Street


ACOR Consultants Ptv Ltd | Project THE SUTHERLAND HOSPITAL OPERATING St Leonards NSW 2065 THEATRE UPGRADE PROJECT -T +61 2 9438 5098

ICONSULTANTS ENGINEERS | MANAGERS | INFRASTRUCTURE PLANNERS | DEVELOPMENT CONSULTANTS

CARINGBAH NSW 2229

MAIN BUILDING WORKS

NOTES

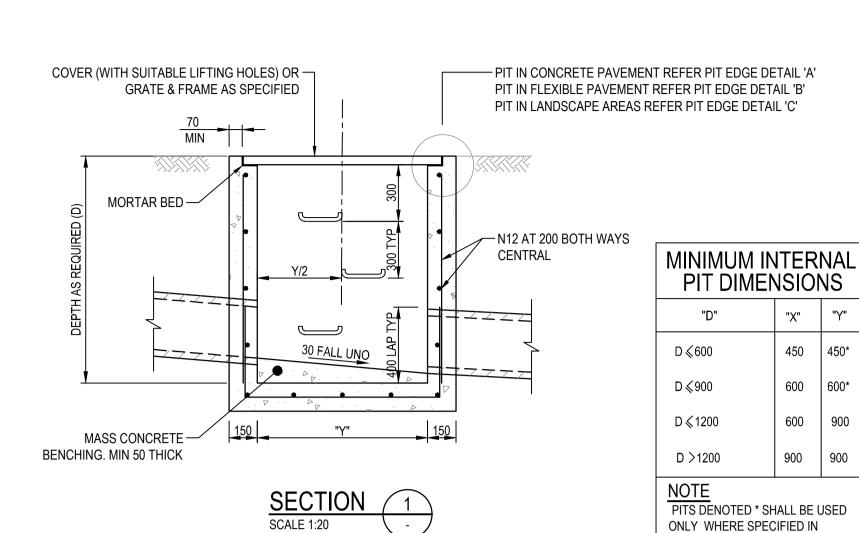

PLAN

SURFACE INLET/JUNCTION PIT

450 MIN LAP FOR N12 — 600 MIN LAP FOR N16

TYPICAL PIT CORNER DETAIL

— PROVIDE STEP IRONS IF PIT DEEPER

THAN 900 (REFER DETAILS)

SETOUT POINT IN THE

MIDDLE OF GRATE / LID

"X"


450 450*

600 | 600*


600 900

900 900


DRAINAGE SCHEDULE OR ON PLAN.

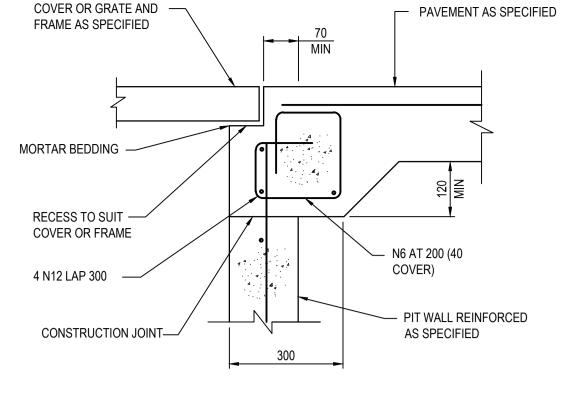



PIT EDGE DETAIL "A"

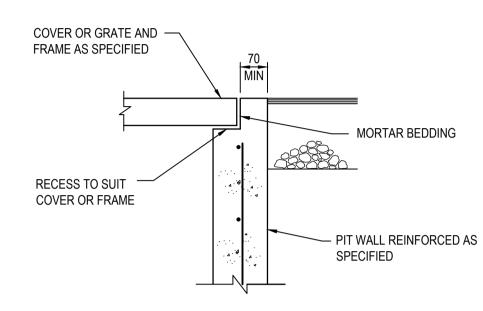


PIT EDGE DETAIL "B"

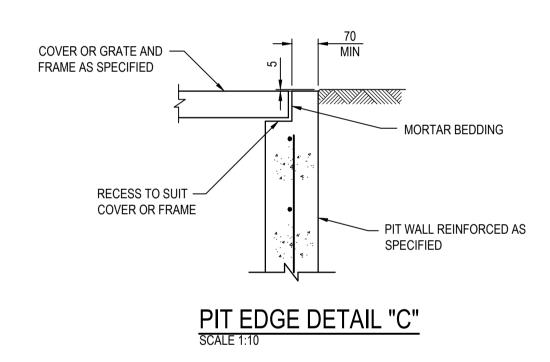

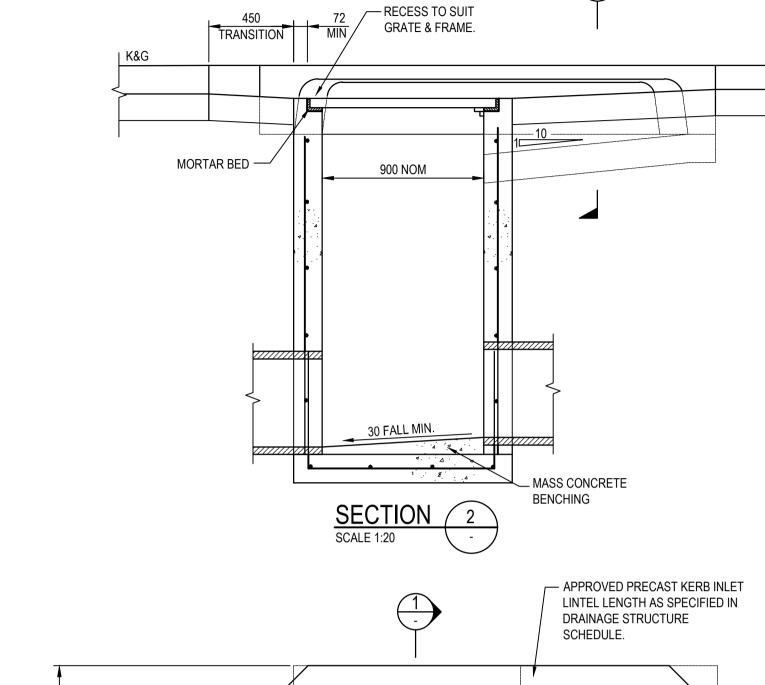

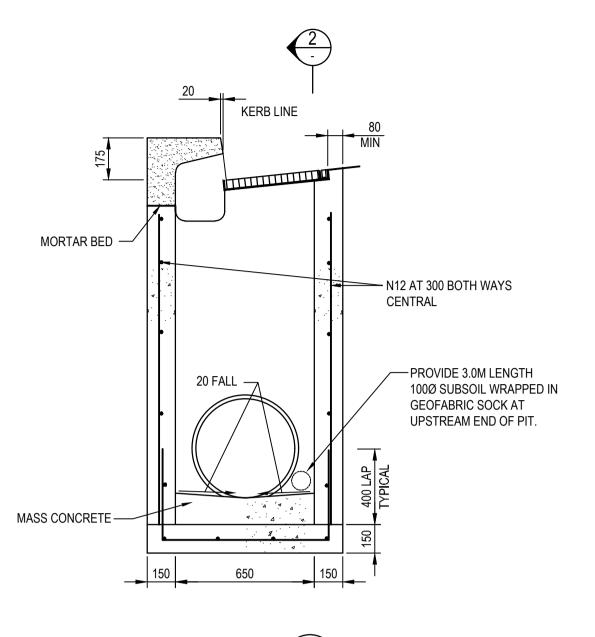

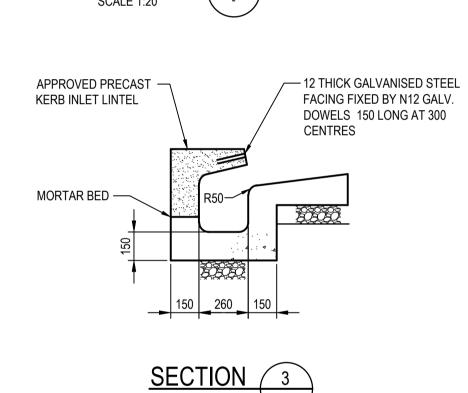

KERB INLET PIT TYPE "C"
SCALE 1:20

LINE

FLOW

 $\langle \Box$

EXPANSION JOINT —



Approved Application: SSD-11099584 Signed: NS

PROVIDE 3.0m LENGTH OF 100Ø — SUBSOIL WRAPPED IN GEOFABRIC

FLOW

SCALE 1:20

SOCK AT UPSTREAM END OF PIT


Sheet: 48 of 53 Granted on: 12 October 2021

© COPYRIGHT of this design and plan is the property of ACOR Consultants Pty Ltd, ACN 079 306 246 ABN 40 079 306 246, all rights reserved. It must

This drawing	has been assigned an electronic code that signifies the drawing has	s been checked and ap	proved by:		
	North				
В	ISSUE FOR DRAFT SSDA	13.11.20	DK	CR	
Α	ISSUE FOR SCHEMATIC DESIGN	07.08.20	DK	CR	
Issue.	Description	Date	Drawn	Approved	
0	1cm at full size	1 1	10cm		

not be used, modified, reproduced or copied wholly or in part without written permission from ACOR Consultants Pty Ltd.

NSW Infrastruct LEVEL 8, 77 PACIFIC HWY NORTH SYDNEY, NSW 2060 www.hinfra.health.nsw.gov.au

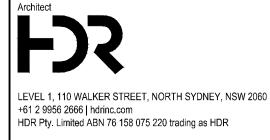



EXPANSION JOINT ———

NOMINAL 450x900

GALVANISED MILD STEEL GRATE HINGED TO FRAME

Suite 2, Level 1, 33 Herbert Street St Leonards NSW 2065 T +61 2 9438 5098

PLAN

ACOR Consultants Pty Ltd


Suita 2 Level 1 33 Herbert Street THE SUTHERLAND HOSPITAL OPERATING THEATRE UPGRADE PROJECT -MAIN BUILDING WORKS KINGSWAY & KAREENA RD,

Drawing Title
DETAILS SHEET 1 AS SHOWN Project No. SY191015 Designed CV-DG-1005

NOT FOR CONSTRUCTION


CONSULTANTS ENGINEERS | MANAGERS | INFRASTRUCTURE PLANNERS | DEVELOPMENT CONSULTANTS

LEVEL 1, 110 WALKER STREET, NORTH SYDNEY, NSW 2060

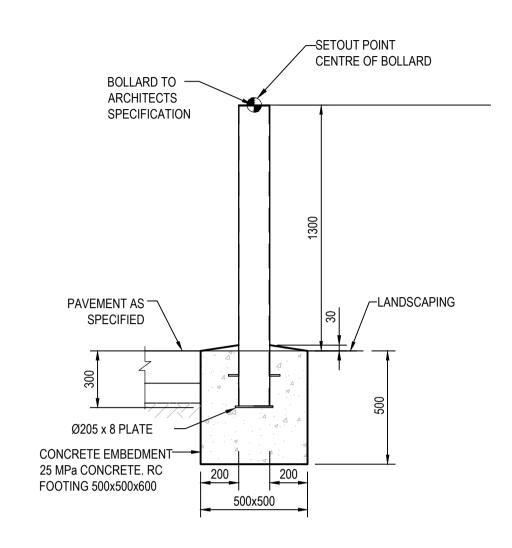


BOLLARD (B1)

NOTE: ALL ELEMENTS TO BE HOT DIP GALVANIZED. REFER TO CIVIL DRAWINGS FOR LOCATION. CONTRACTOR SHALL CO-ORDINATE BOLLARDS WITH SERVICES CONTRACTOR TO ENSURE NO INTERFERENCE WITH PROPOSED OR EXISTING SERVICES OCCUR.

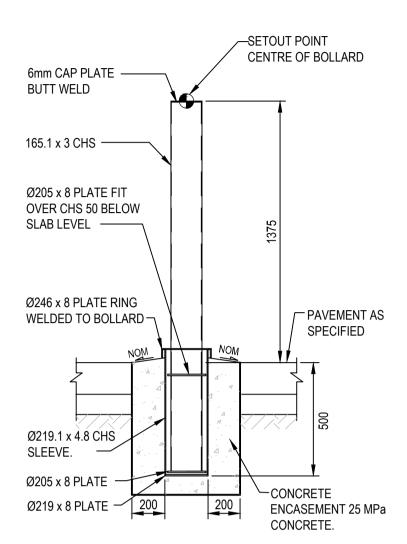


REMOVEABLE STEEL BOLLARD (B2)

NOTE: ALL ELEMENTS TO BE GALVANISED. CONTRACTOR SHALL CO-ORDINATE BOLLARDS WITH SERVICES CONTRACTOR TO ENSURE NO INTERFERENCE WITH PROPOSED OR EXISTING SERVICES OCCUR.

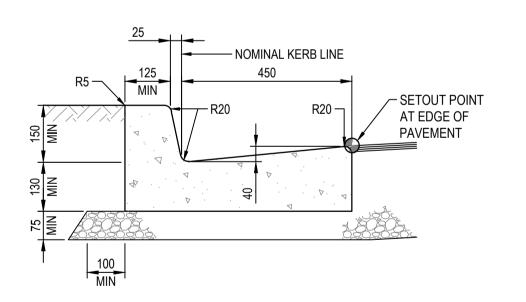


KERB & GUTTER

SHOWN AS 'K&G'

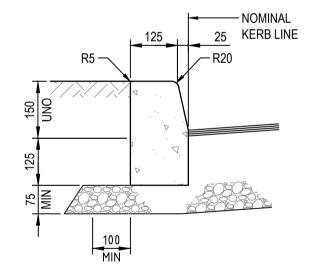

KERB ONLY SCALE 1:10 SHOWN AS "KO"

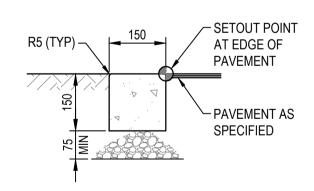

FLUSH KERB TYPE 1 SCALE 1:10 SHOWN AS "FK"



Granted on: 12 October 2021

Issued under the Environmental Planning and Assessment Act 1979

Approved Application: SSD-11099584 Signed: NS

Sheet: 49 of 53

NSW SOVERNMENT Infrastruct

LEVEL 1, 110 WALKER STREET, NORTH SYDNEY, NSW 2060 +61 2 9956 2666 | hdrinc.com HDR Pty. Limited ABN 76 158 075 220 trading as HDR



MAIN BUILDING WORKS KINGSWAY & KAREENA RD,

ACOR Consultants Pty Ltd
Suite 2, Level 1, 33 Herbert Street
St Leonards NSW 2065
T ±61 2 9/38 5098

Project
THE SUTHERLAND HOSPITAL OPERATING
THEATRE UPGRADE PROJECT -

NOT FOR CONSTRUCTION Drawing Title
DETAILS SHEET 2

AS SHOWN Project No. SY191015 Designed CV-DG-1006

CCOPYRIGHT of this design and plan is the property of ACOR Consultants Pty Ltd, ACN 079 306 246 ABN 40 079 306 246, all rights reserved. It must not be used, modified, reproduced or copied wholly or in part without written permission from ACOR Consultants Pty Ltd.

B ISSUE FOR DRAFT SSDA
A ISSUE FOR SCHEMATIC DESIGN 13.11.20 DK CR 07.08.20 DK CR

This drawing has been assigned an electronic code that signifies the drawing has been checked and approved by:

LEVEL 8, 77 PACIFIC HWY NORTH SYDNEY, NSW 2060 www.hinfra.health.nsw.gov.au


CONSULTANTS ENGINEERS | MANAGERS | INFRASTRUCTURE PLANNERS | DEVELOPMENT CONSULTANTS

CONSTRUCTION NOTES

CONSTRUCT SEDIMENT FENCE AS CLOSE AS POSSIBLE TO PARALLEL TO

- THE CONTOURS OF THE SITE.
- 2. DRIVE 1.5m LONG STAR PICKETS INTO GROUND, 2.5 METRES APART (MAX), ENSURE STAR PICKETS ARE FITTED WITH SAFETY CAPS.
- 3. DIG A 150mm DEEP TRENCH ALONG THE UPSLOPE LINE OF THE FENCE FOR THE BOTTOM OF THE FABRIC TO BE ENTRENCHED.
- BACKFILL TRENCH OVER BASE OF FABRIC.
- 5. FIX SELF-SUPPORTING GEOTEXTILE TO UPSLOPE SIDE OF POSTS WITH
- WIRE TIES OR AS RECOMMENDED BY GEOTEXTILE MANUFACTURER. 6. JOIN SECTIONS OF FABRIC AT A SUPPORT POST WITH A 150mm OVERLAP.

SEDIMENT CONTROL FENCE

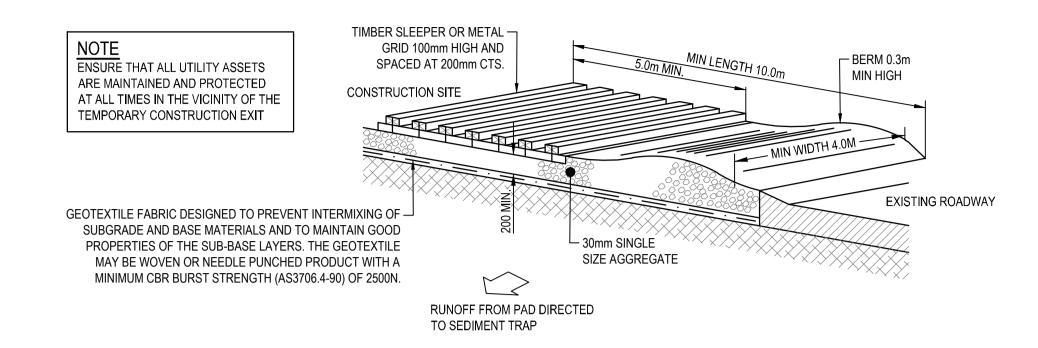

CONSTRUCTION NOTES

- STRIP TOPSOIL AND LEVEL SITE.
- COMPACT SUBGRADE.
- COVER AREA WITH NEEDLE-PUNCHED GEOTEXTILE. CONSTRUCT 200mm THICK PAD OVER GEOTEXTILE USING
- 30mm SINGLE SIZE AGGREGATE.

RUNOFF WATER

WITH SEDIMENT

CONSTRUCT HUMP IMMEDIATELY WITHIN BOUNDARY TO DIVERT WATER TO A SEDIMENT FENCE OR OTHER SEDIMENT TRAP WHERE THE SEDIMENT IS COLLECTED AND REMOVED.

MAINTENANCE NOTES

THE EXIT SHALL BE MAINTAINED IN A CONDITION WHICH PREVENTS TRACKING OR FLOWING OF SEDIMENT OFF THE CONSTRUCTION SITE. THIS MAY REQUIRE PERIODIC TOP DRESSING WITH ADDITIONAL GRAVEL AS CONDITIONS DEMAND AND REPAIR AND/OR CLEANOUT OF ANY MEASURES USED TO TRAP SEDIMENT. ALL SEDIMENT SPILLED, DROPPED, WASHED OR TRACKED OFF THE CONSTRUCTION SITE MUST BE REMOVED IMMEDIATELY.

TEMPORARY STABILISED CONSTRUCTION EXIT

RUNOFF WATER

WITH SEDIMENT

- NON-WOVEN GEOTEXTILE FILTER FABRIC WIRE TIED

TO GRATE IN ALL 4 **CORNERS & CENTRE**

PITS TO BE INSPECTED DAILY &

FILTERED WATER


INLET TRAP

NOTE
TO BE USED IN PAVED AREAS WHERE


TRAFFIC ACCESS IS REQUIRED

N.T.S.


CAPTURED SEDIMENT TO BE REMOVED

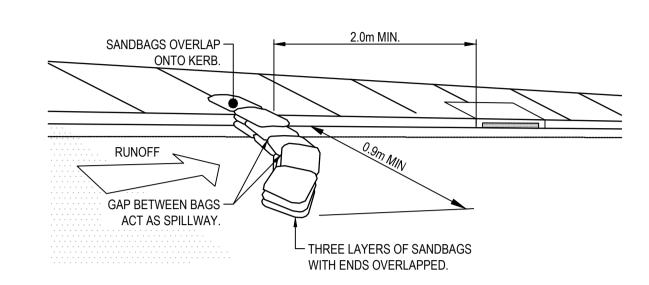

SANDBAG KERB INLET SEDIMENT TRAP

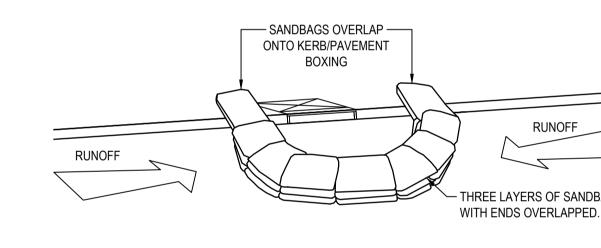

SANDBAG SEDIMENT TRAP - AT KERB SAG PIT

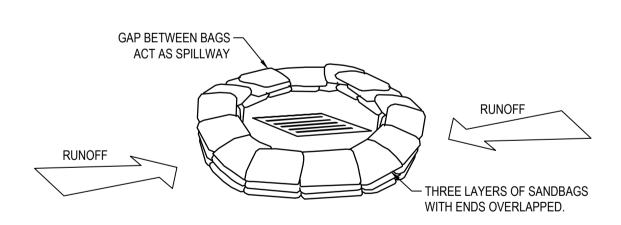

SANDBAG SEDIMENT TRAP - AT OTHER THAN KERB SAG PIT

SANDBAG SEDIMENT TRAP DETAILS



Issued under the Environmental Planning and Assessment Act 1979

Approved Application: SSD-11099584 Signed: NS


Sheet: 51 of 53 Granted on: 12 October 2021

not be used, modified, reproduced or copied wholly or in part without written permission from ACOR Consultants Pty Ltd.

COPYRIGHT of this design and plan is the property of ACOR Consultants Pty Ltd, ACN 079 306 246 ABN 40 079 306 246, all rights reserved. It must

This drawing has been assigned an electronic code that signifies the drawing has been checked and approved by: ISSUE FOR DRAFT SSDA 07.08.20 DK CR A ISSUE FOR SCHEMATIC DESIGN



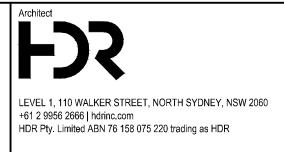



ACOR Consultants Pty Ltd Suite 2, Level 1, 33 Herbert Street St Leonards NSW 2065

THE SUTHERLAND HOSPITAL OPERATING THEATRE UPGRADE PROJECT -T +61 2 9438 5098

NOT FOR CONSTRUCTION DETAILS SHEET 3

Q.A. Check Designed SY191015 CV-DG-1007

CONSULTANTS ENGINEERS | MANAGERS | INFRASTRUCTURE PLANNERS | DEVELOPMENT CONSULTANTS

