





GENERAL NOTES

ALL DIMENSIONS AND EXISTING CONDITIONS

SHALL BE CHECKED AND VERIFIED BY THE CONTRACTOR BEFORE PROCEEDING WITH THE WORK. • ALL LEVELS RELATIVE TO 'AUSTRALIAN HEIGHT DATUM'. o DO NOT SCALE DRAWINGS. USE FIGURED DIMENSIONS ONLY.

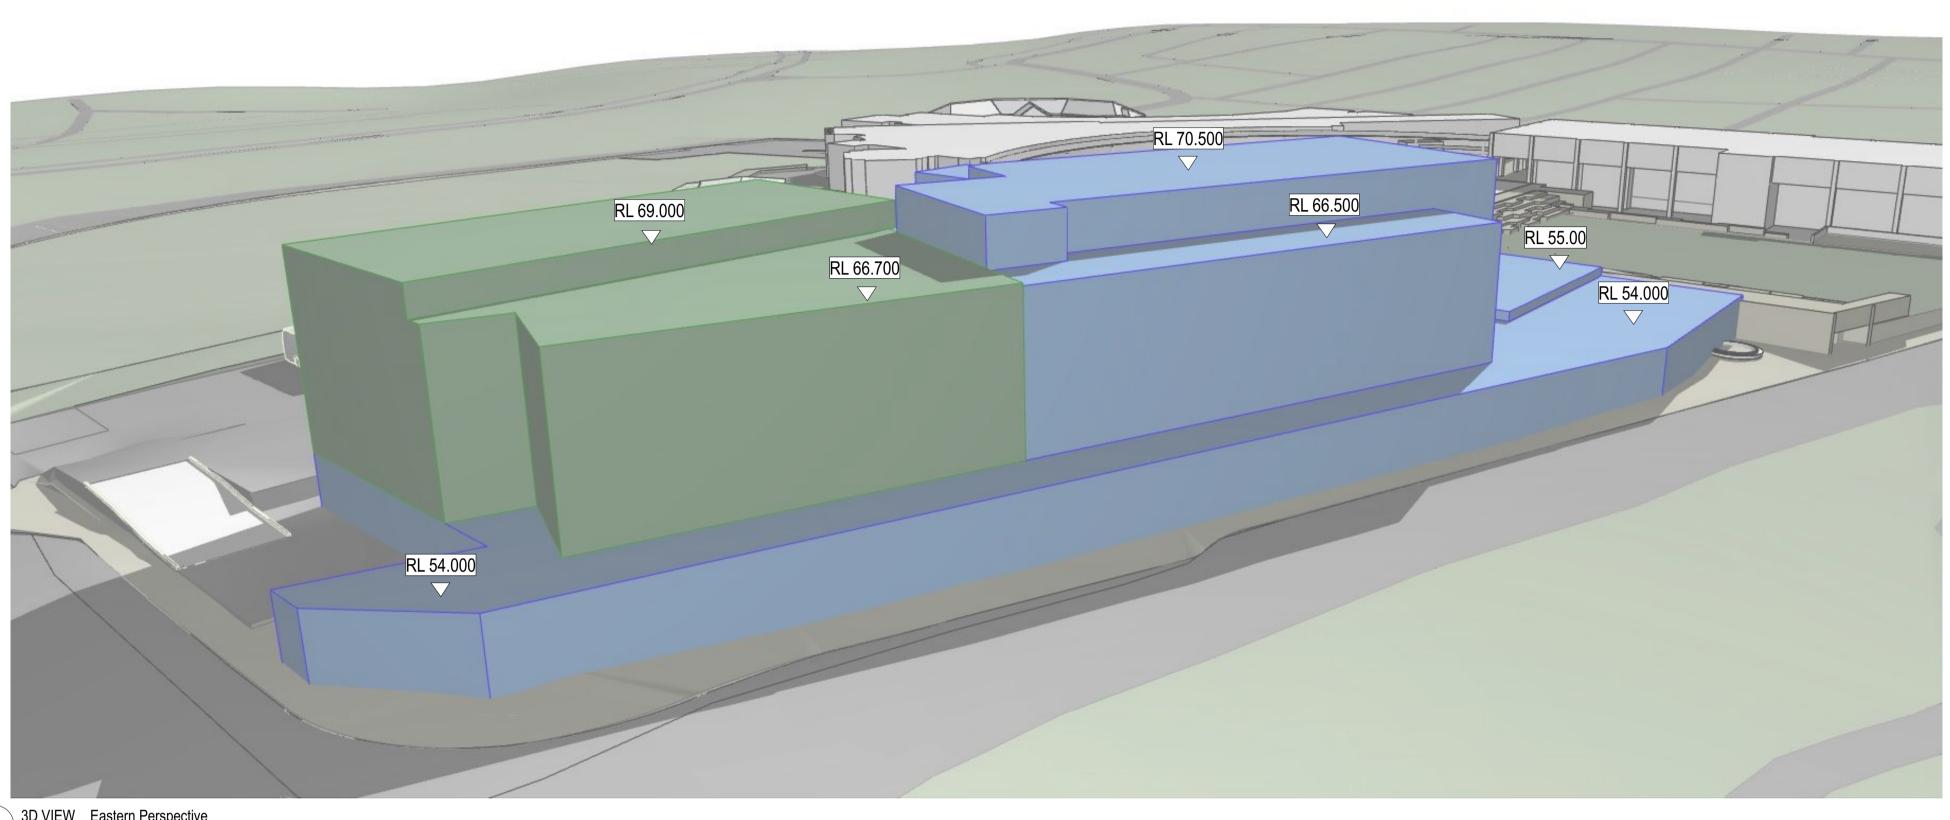

1 3D VIEW Eastern Perspective NTS

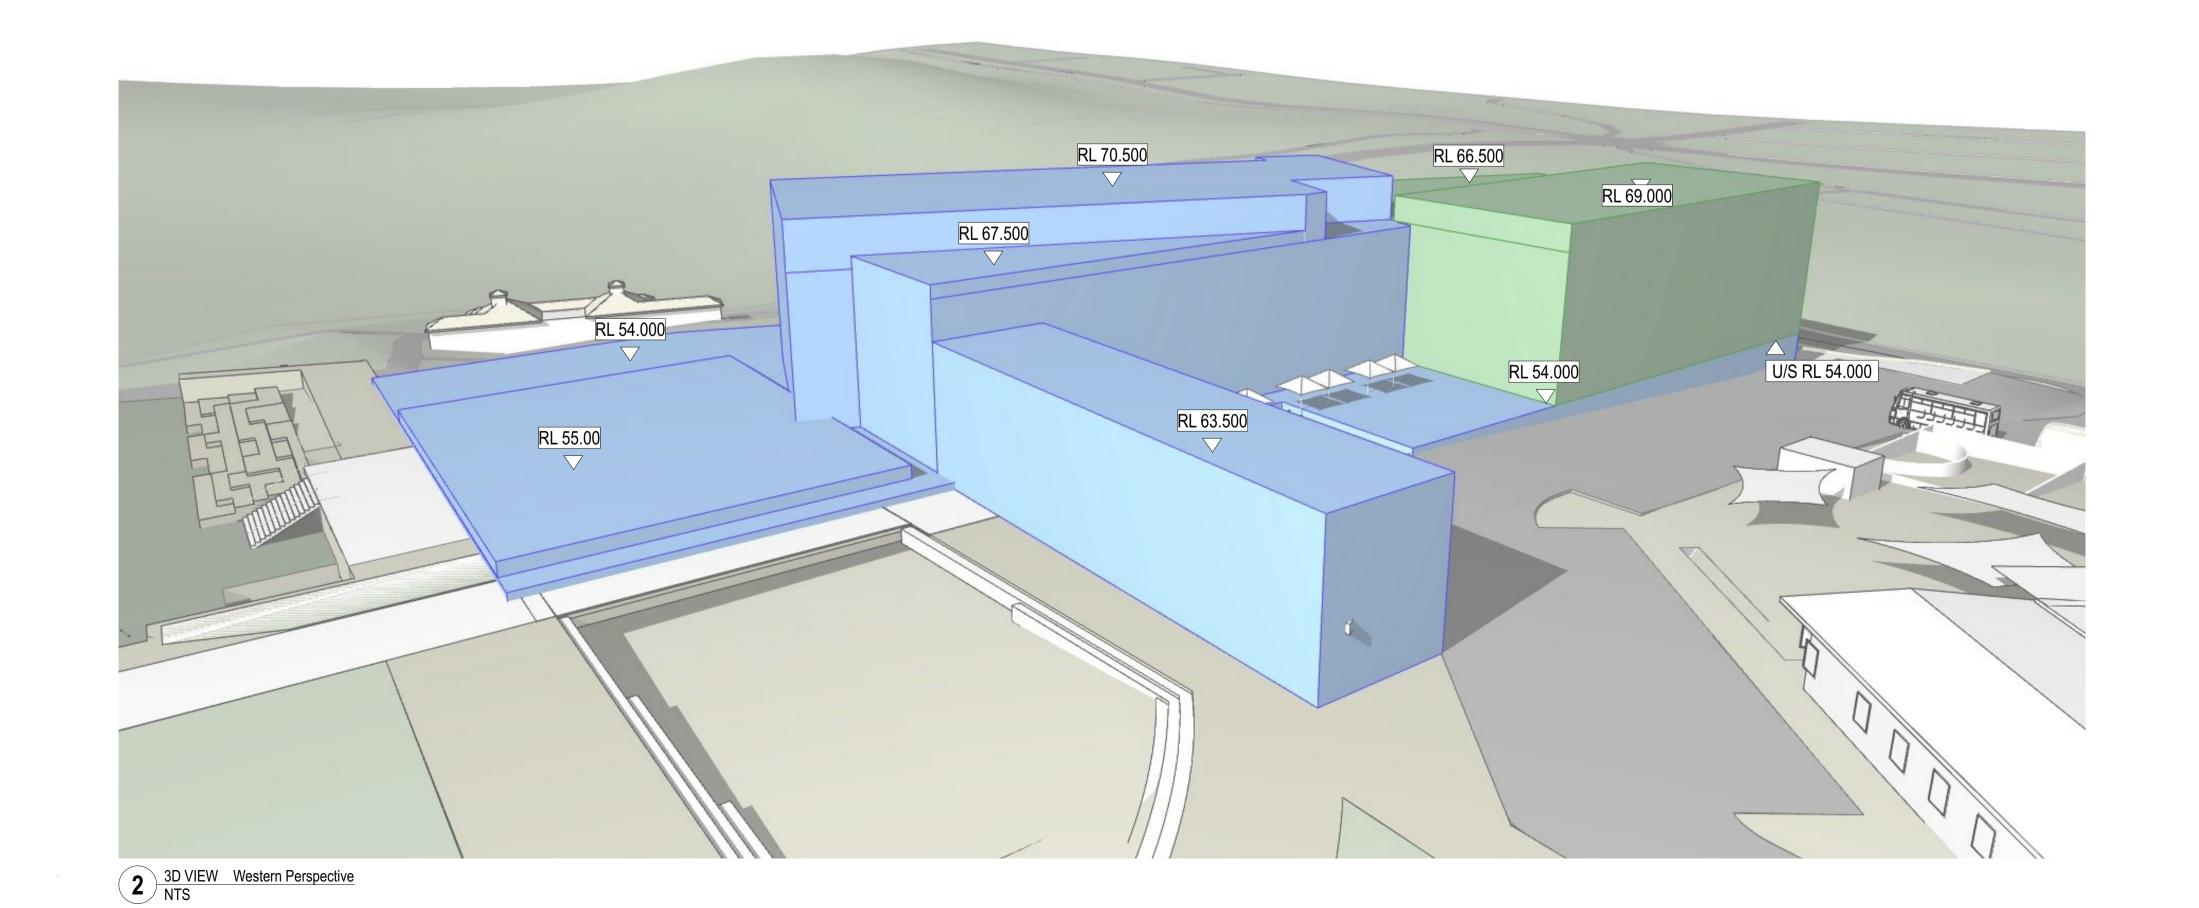



New South Wales Government Independent Planning Commission

Issued under the Environmental Planning and Assessment Act 1979

Approved Application No: SSD-10352 Signed

Sheet No: 3 of 13 Granted on the: 6 May 2021


_				
С	Revised Drawings for SSDA	12/2/21	JRS	
В	SSDA Response to Submissions	23/4/20	JRS	
Α	SSDA Submission	10/10/19	JRS	
rev	Issue Name	date	Issued By	ch
sydne	tudio architecture interiors landscape y melbourne uk 5, 70 King Street t +61 2 9251 7077 w fjr		fir	n
	ect			
proje				
	RIAH COLLEGE			
MO 1-3	RIAH COLLEGE Queens Park Road & 101 VERLY NSW 2022	York Road		
MO 1-3	Queens Park Road & 101	York Road		
MO 1-3 WA\	Queens Park Road & 101 /ERLY NSW 2022	York Road		
MO 1-3 WAV	Queens Park Road & 101			

DA-1208

C

scale Not to Scale 10/10/19

MSMSC

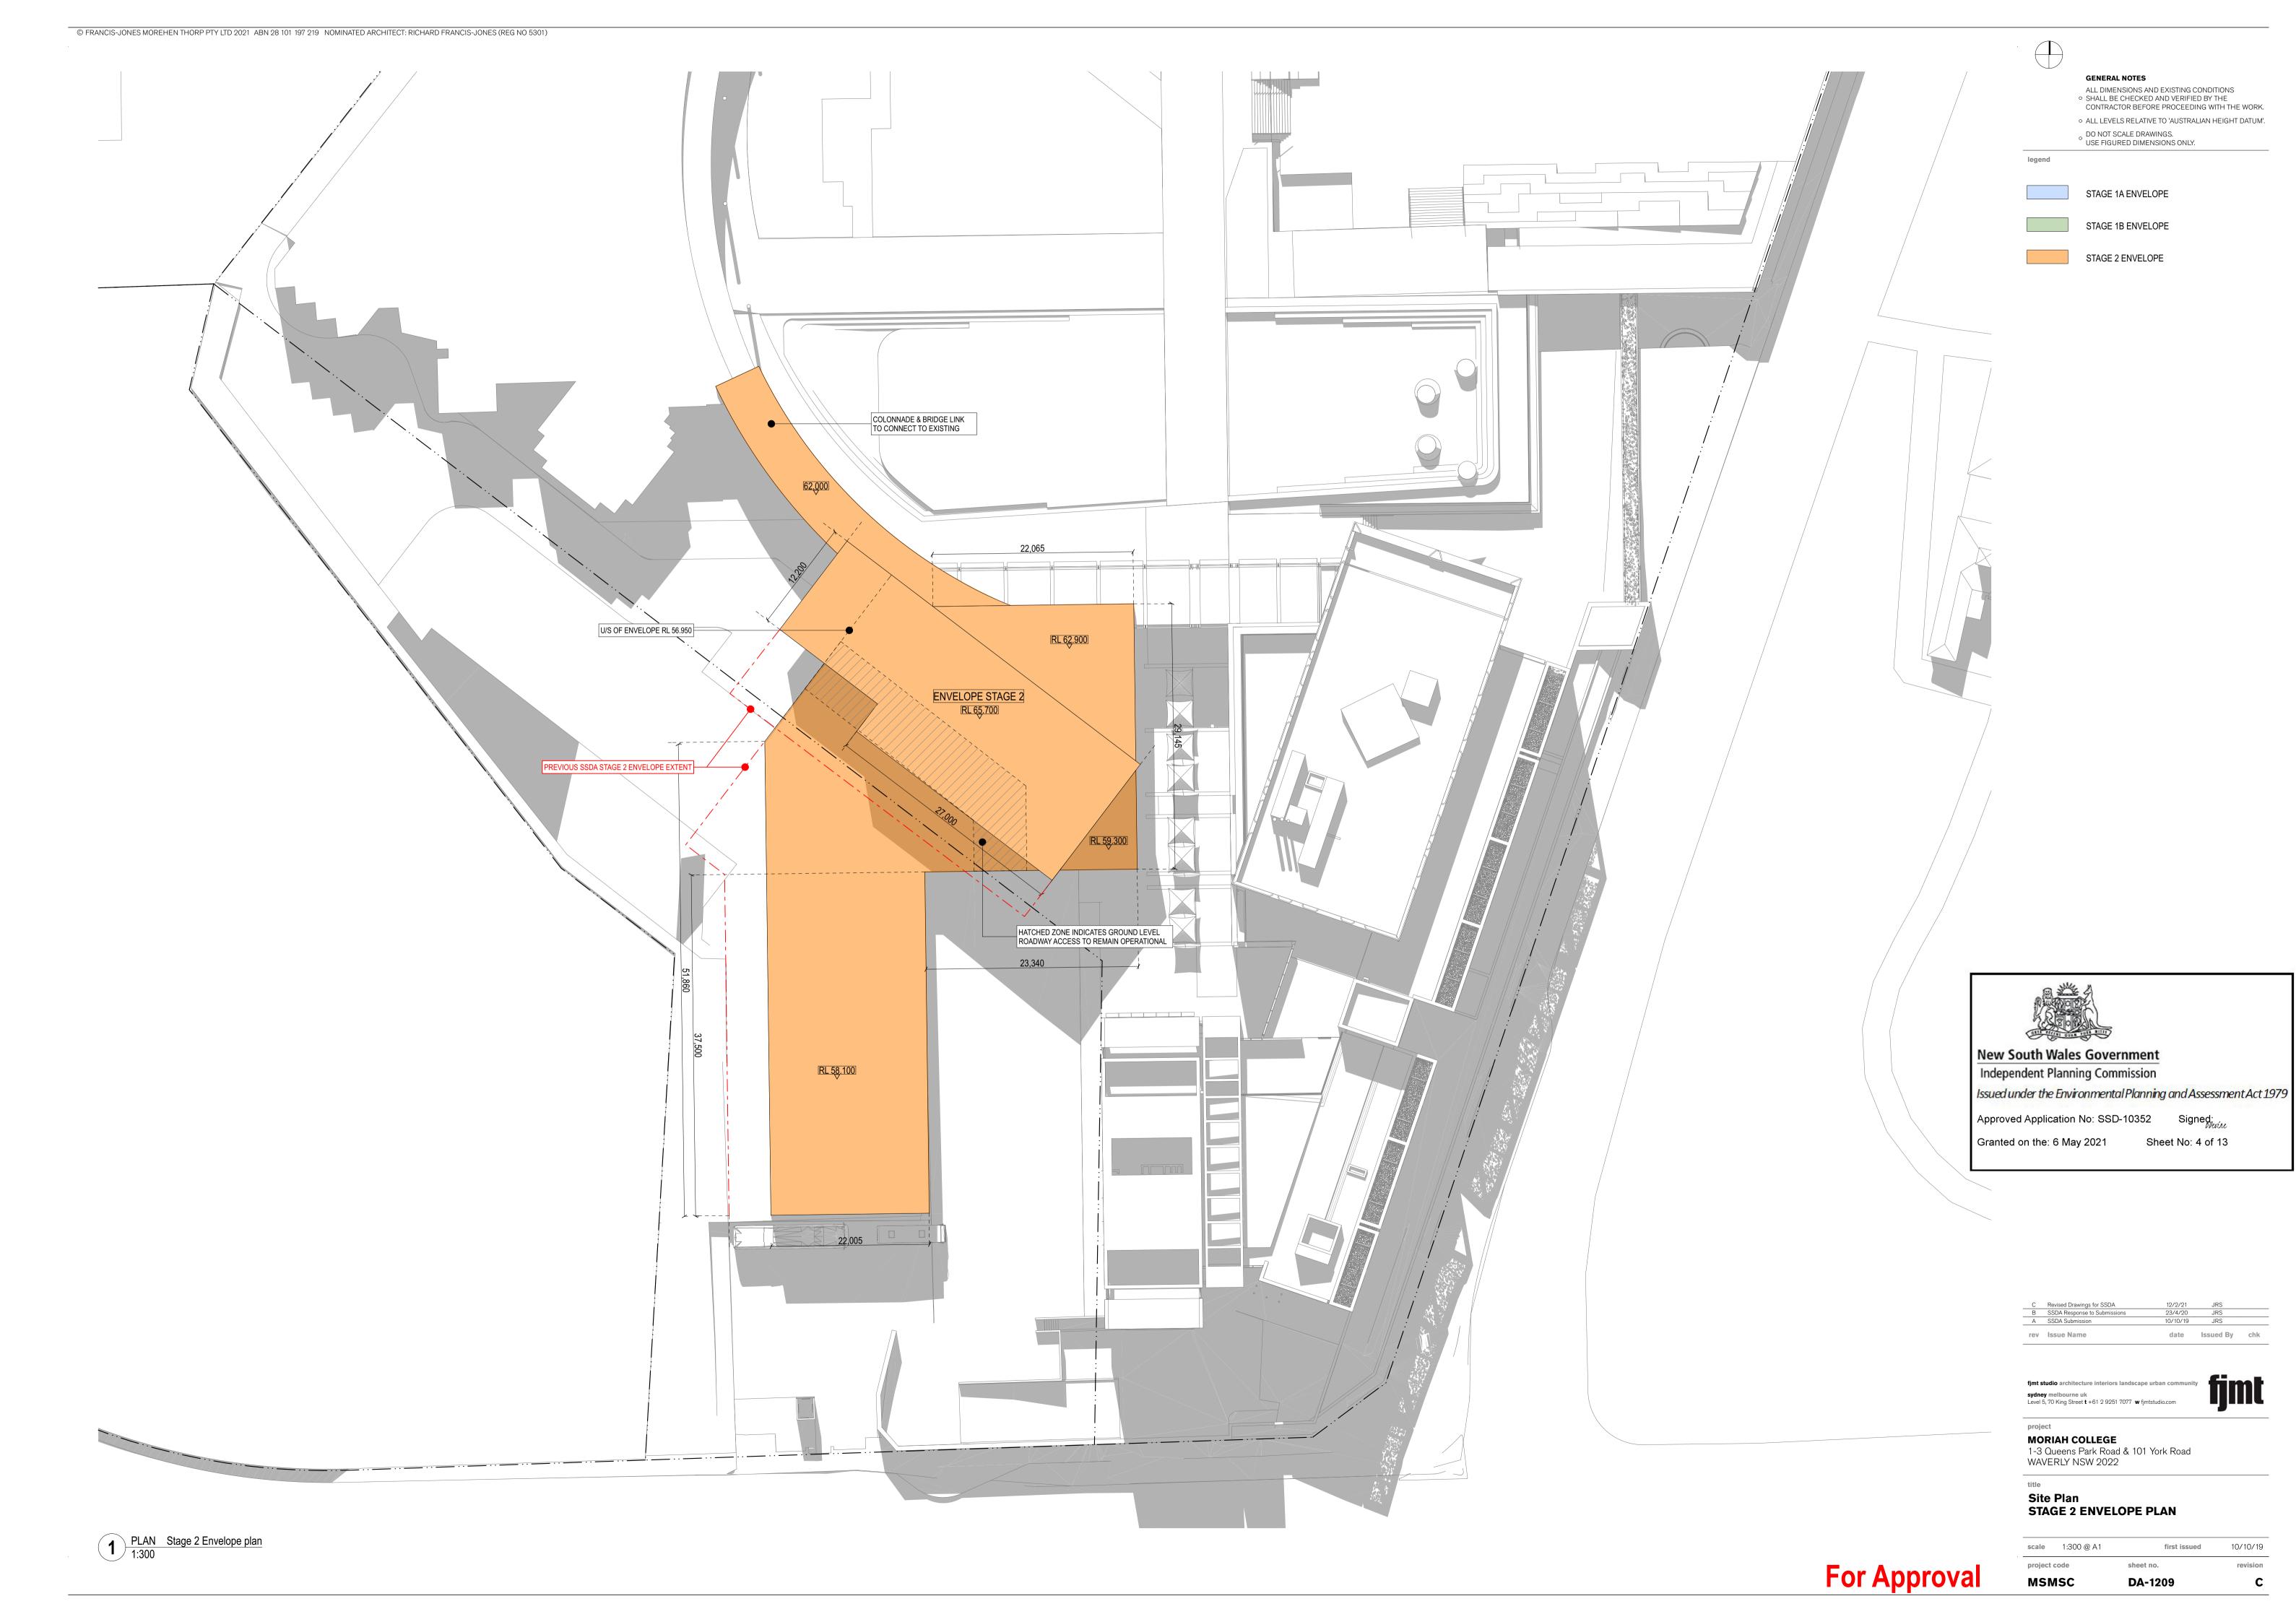




GENERAL NOTES

ALL DIMENSIONS AND EXISTING CONDITIONS

SHALL BE CHECKED AND VERIFIED BY THE CONTRACTOR BEFORE PROCEEDING WITH THE WORK. • ALL LEVELS RELATIVE TO 'AUSTRALIAN HEIGHT DATUM'. o DO NOT SCALE DRAWINGS. USE FIGURED DIMENSIONS ONLY.



1 3D VIEW South West Perspective NTS

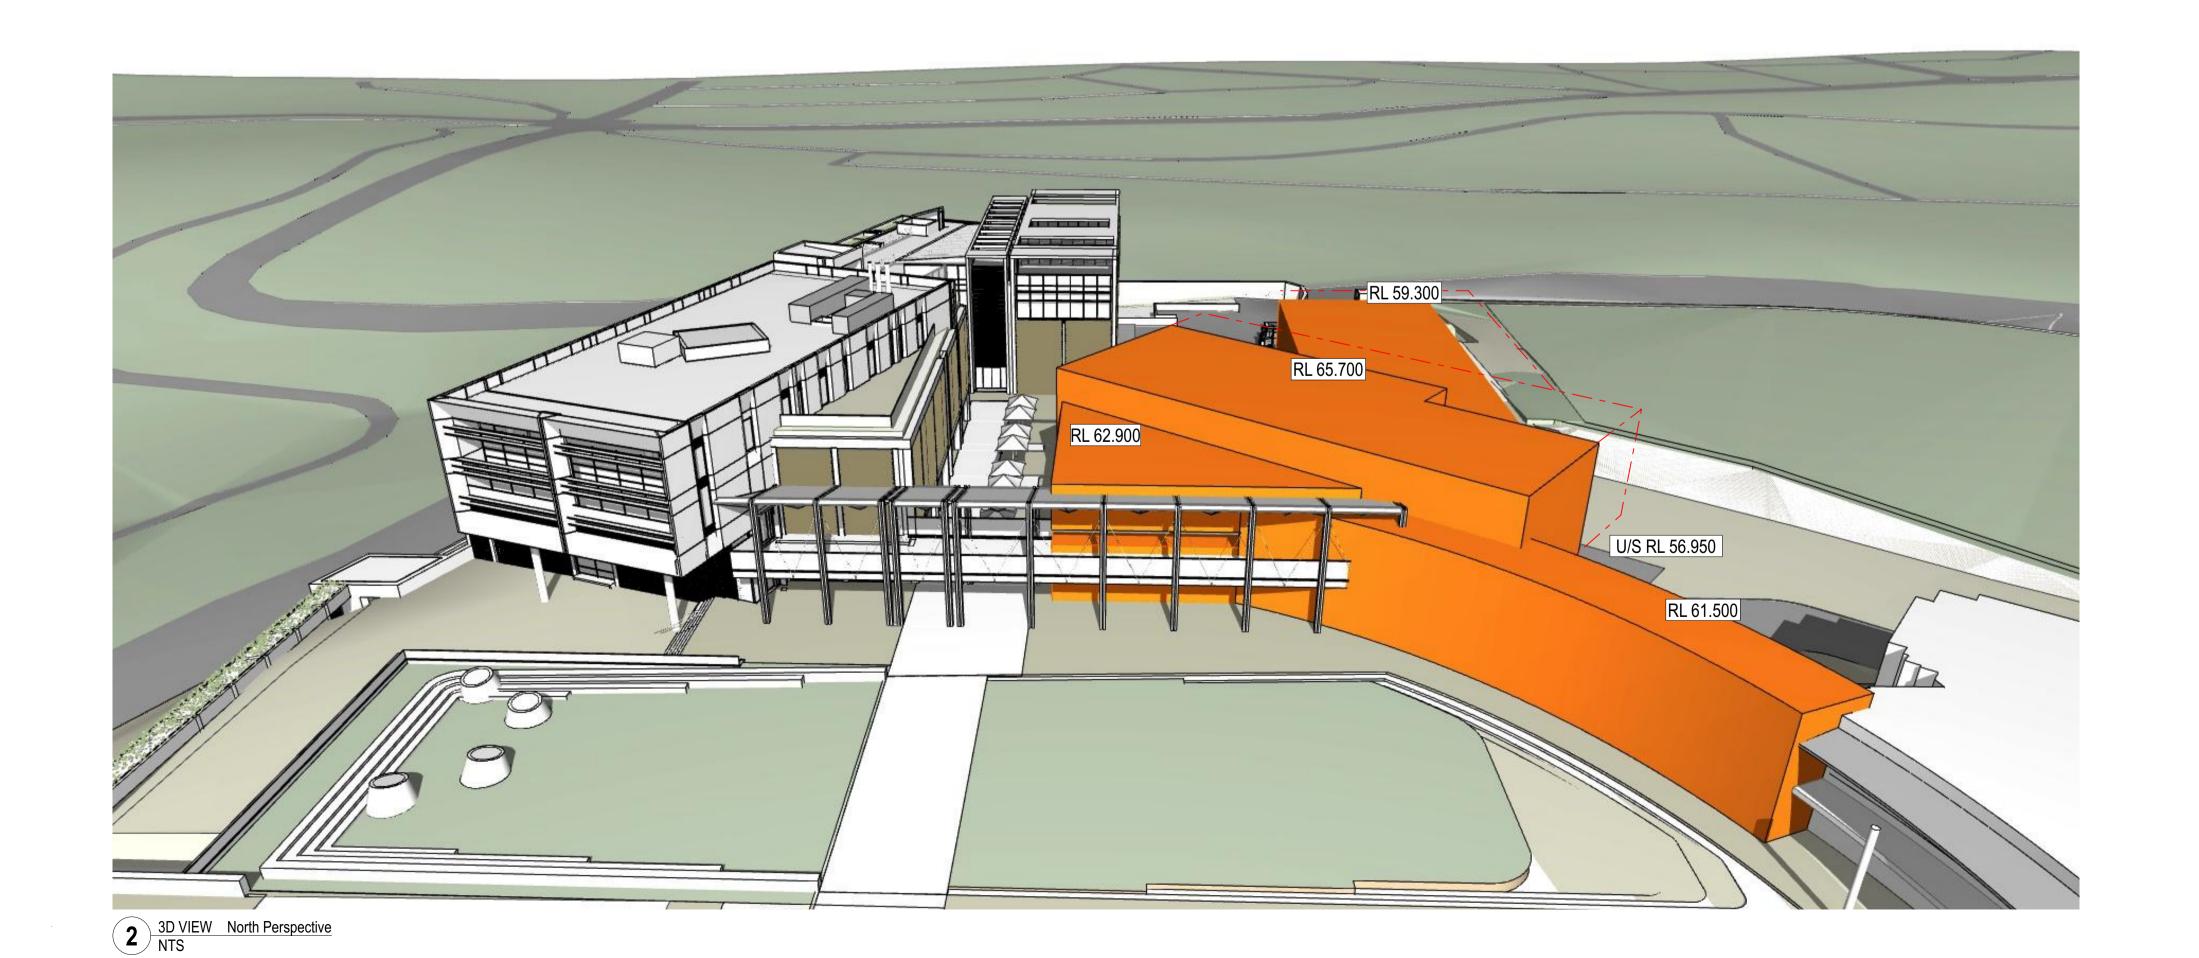



New South Wales Government Independent Planning Commission

Issued under the Environmental Planning and Assessment Act 1979

Approved Application No: SSD-10352 Signed:

Granted on the: 6 May 2021 Sheet No: 5 of 13


C B	Revised Drawings for SSDA SSDA Response to Submissions	12/2/21 23/4/20	JRS JRS	
Α	SSDA Submission	10/10/19	JRS	
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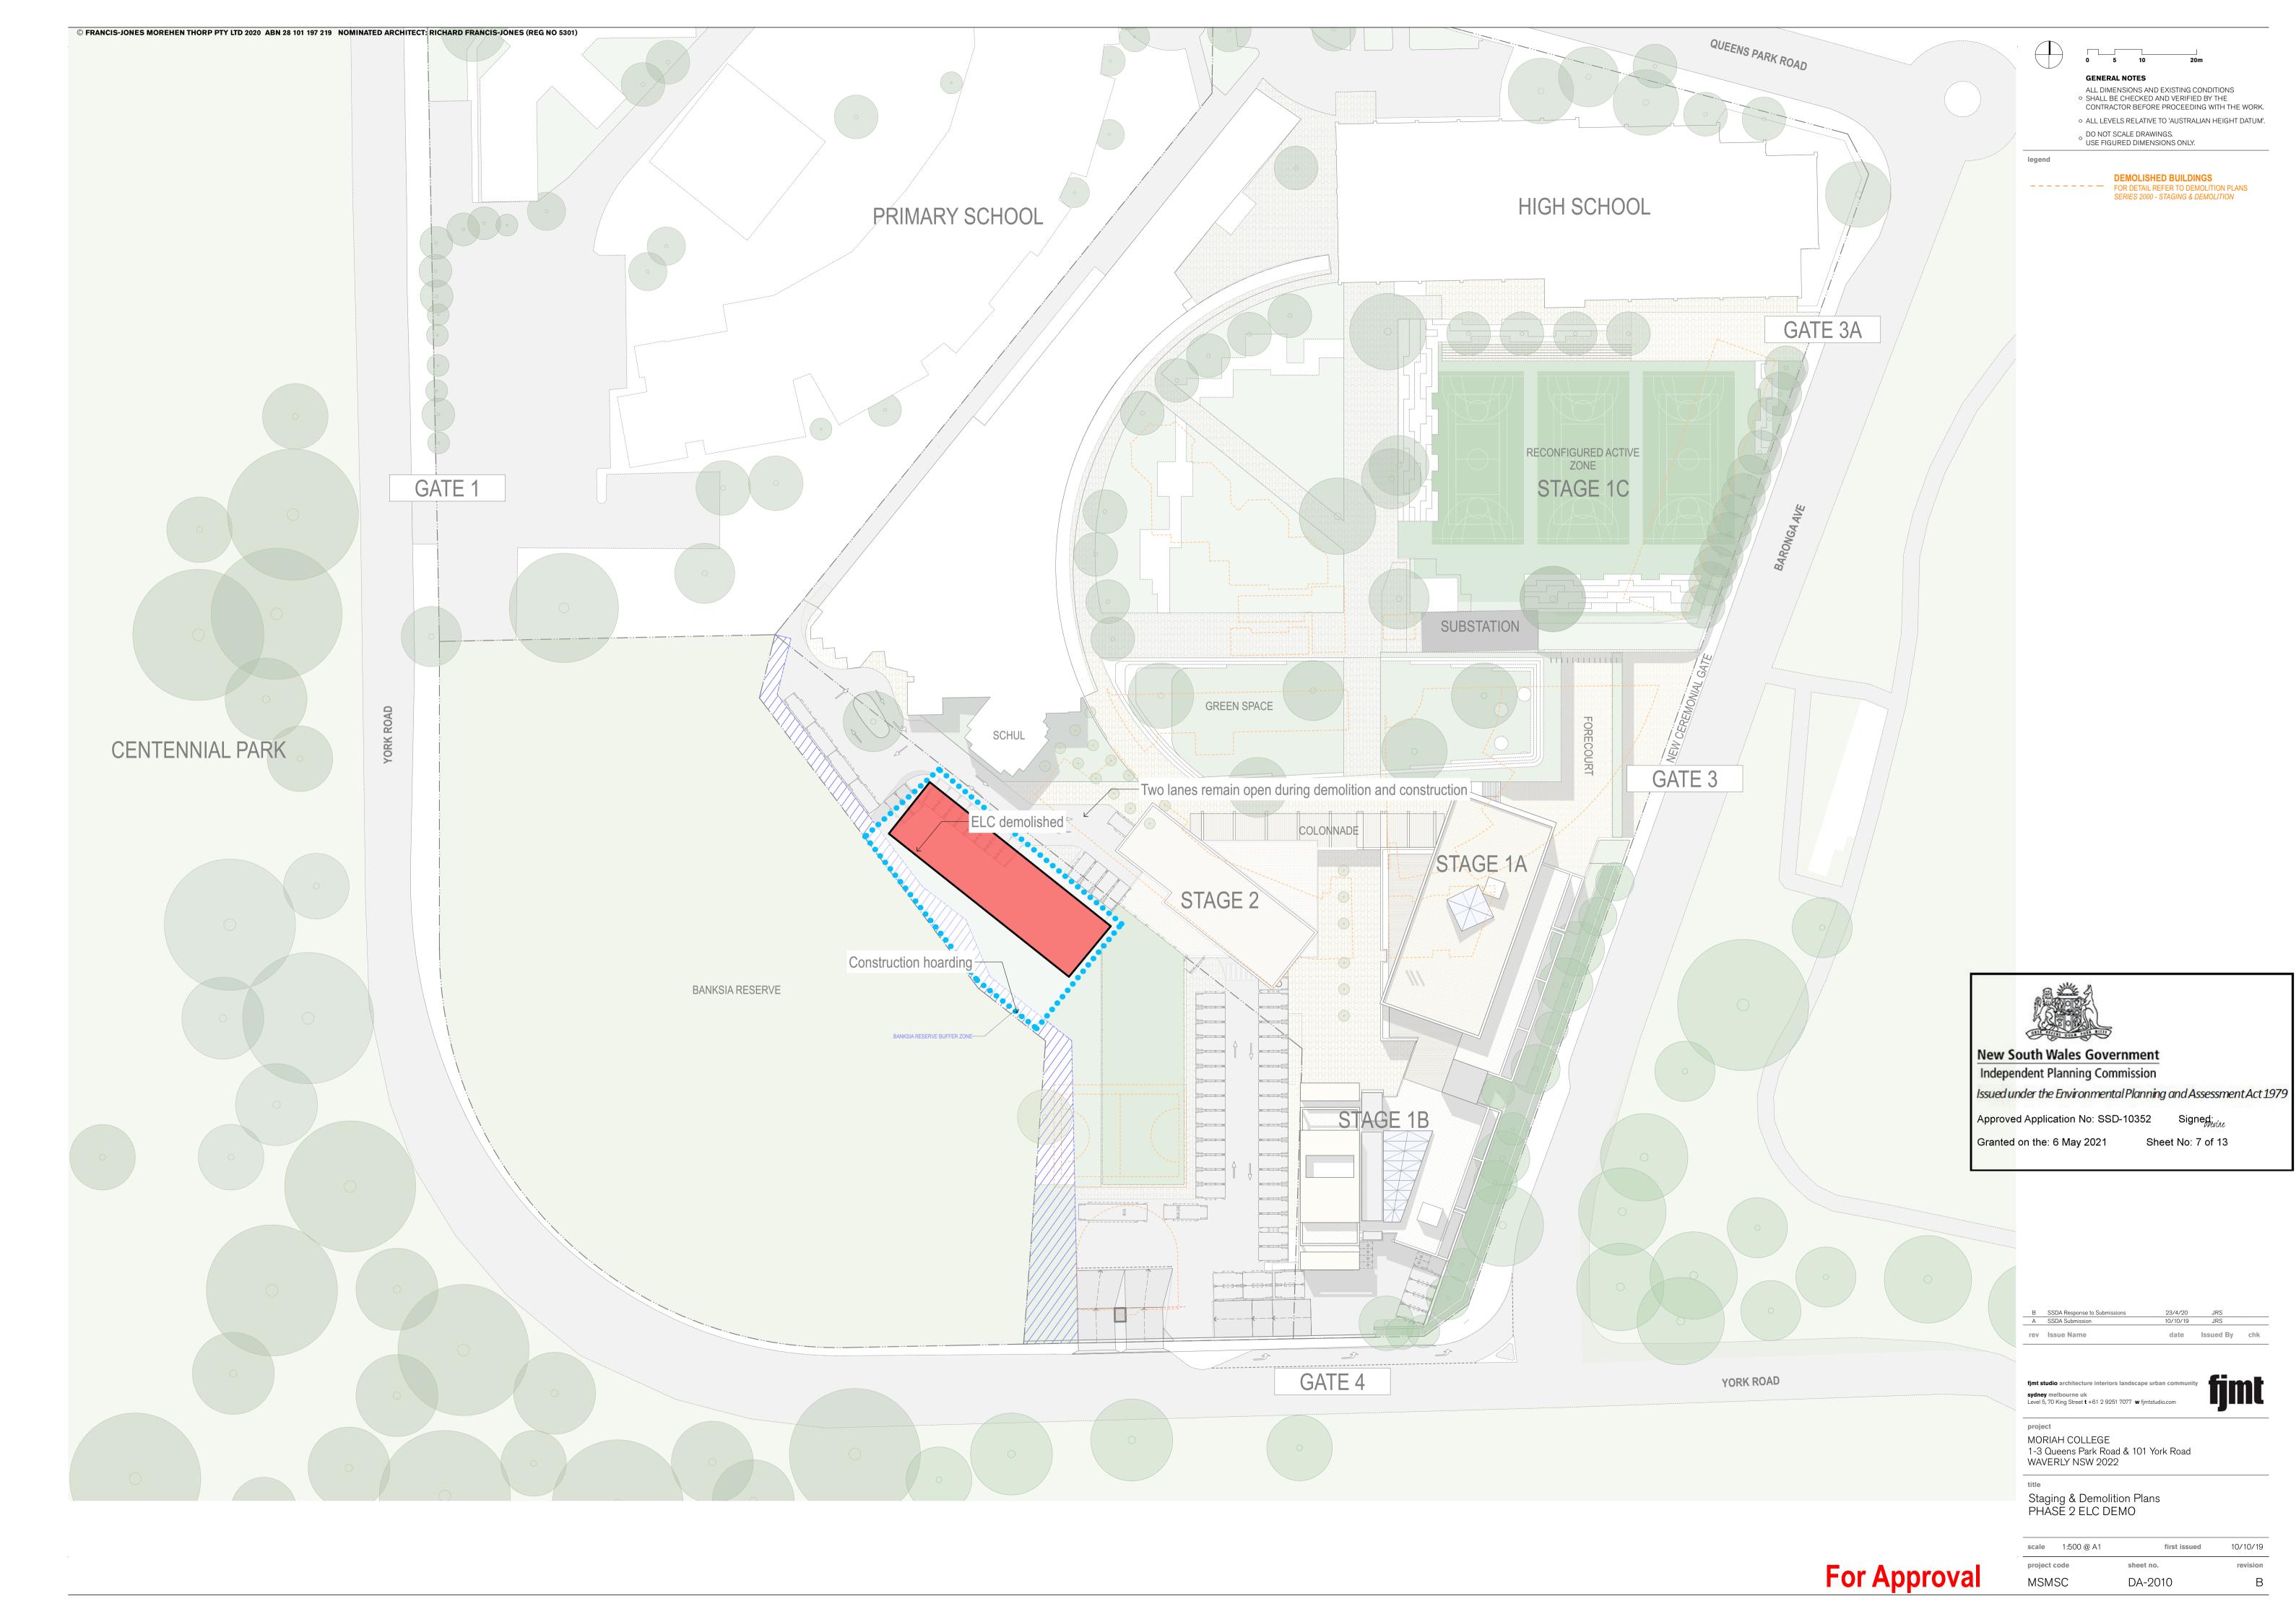
Level 5, 70 King Street **t** +61 2 9251 7077 **w** fjmtstudio.com


MORIAH COLLEGE
1-3 Queens Park Road & 101 York Road
WAVERLY NSW 2022


Site Plan
STAGE 2 ENVELOPE MASSING

scale Not to Scale **MSMSC DA-1210** C



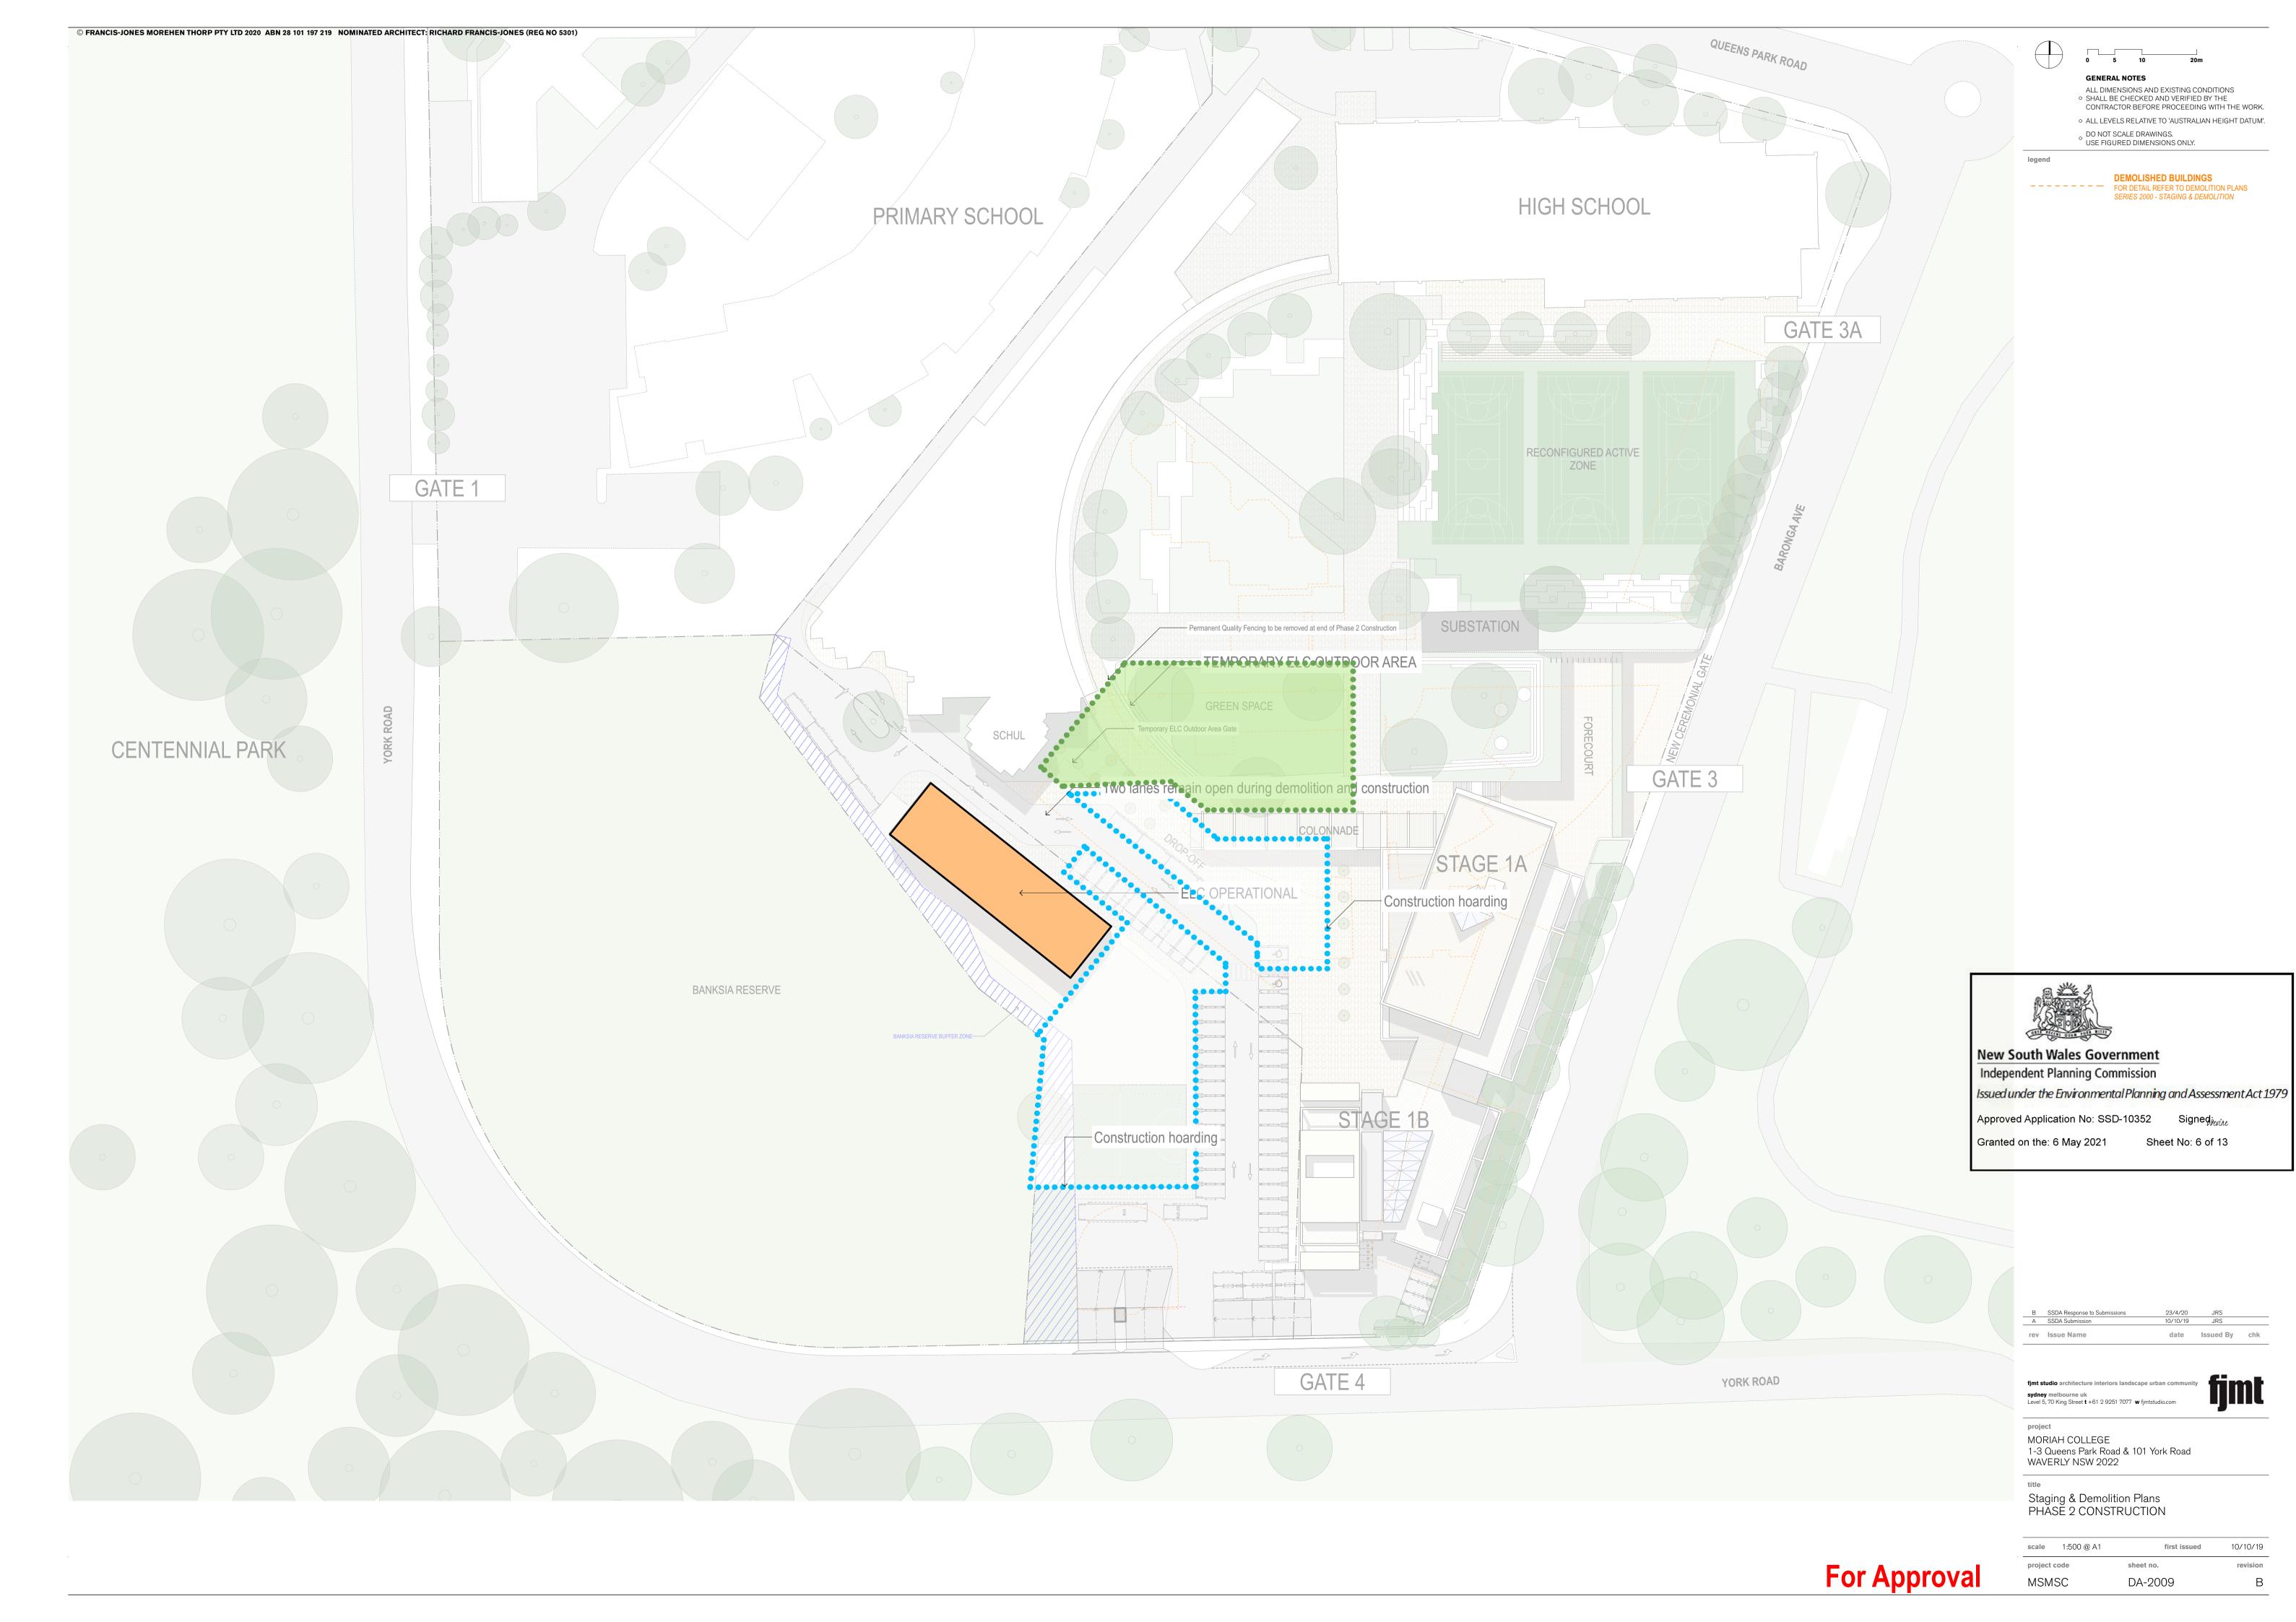


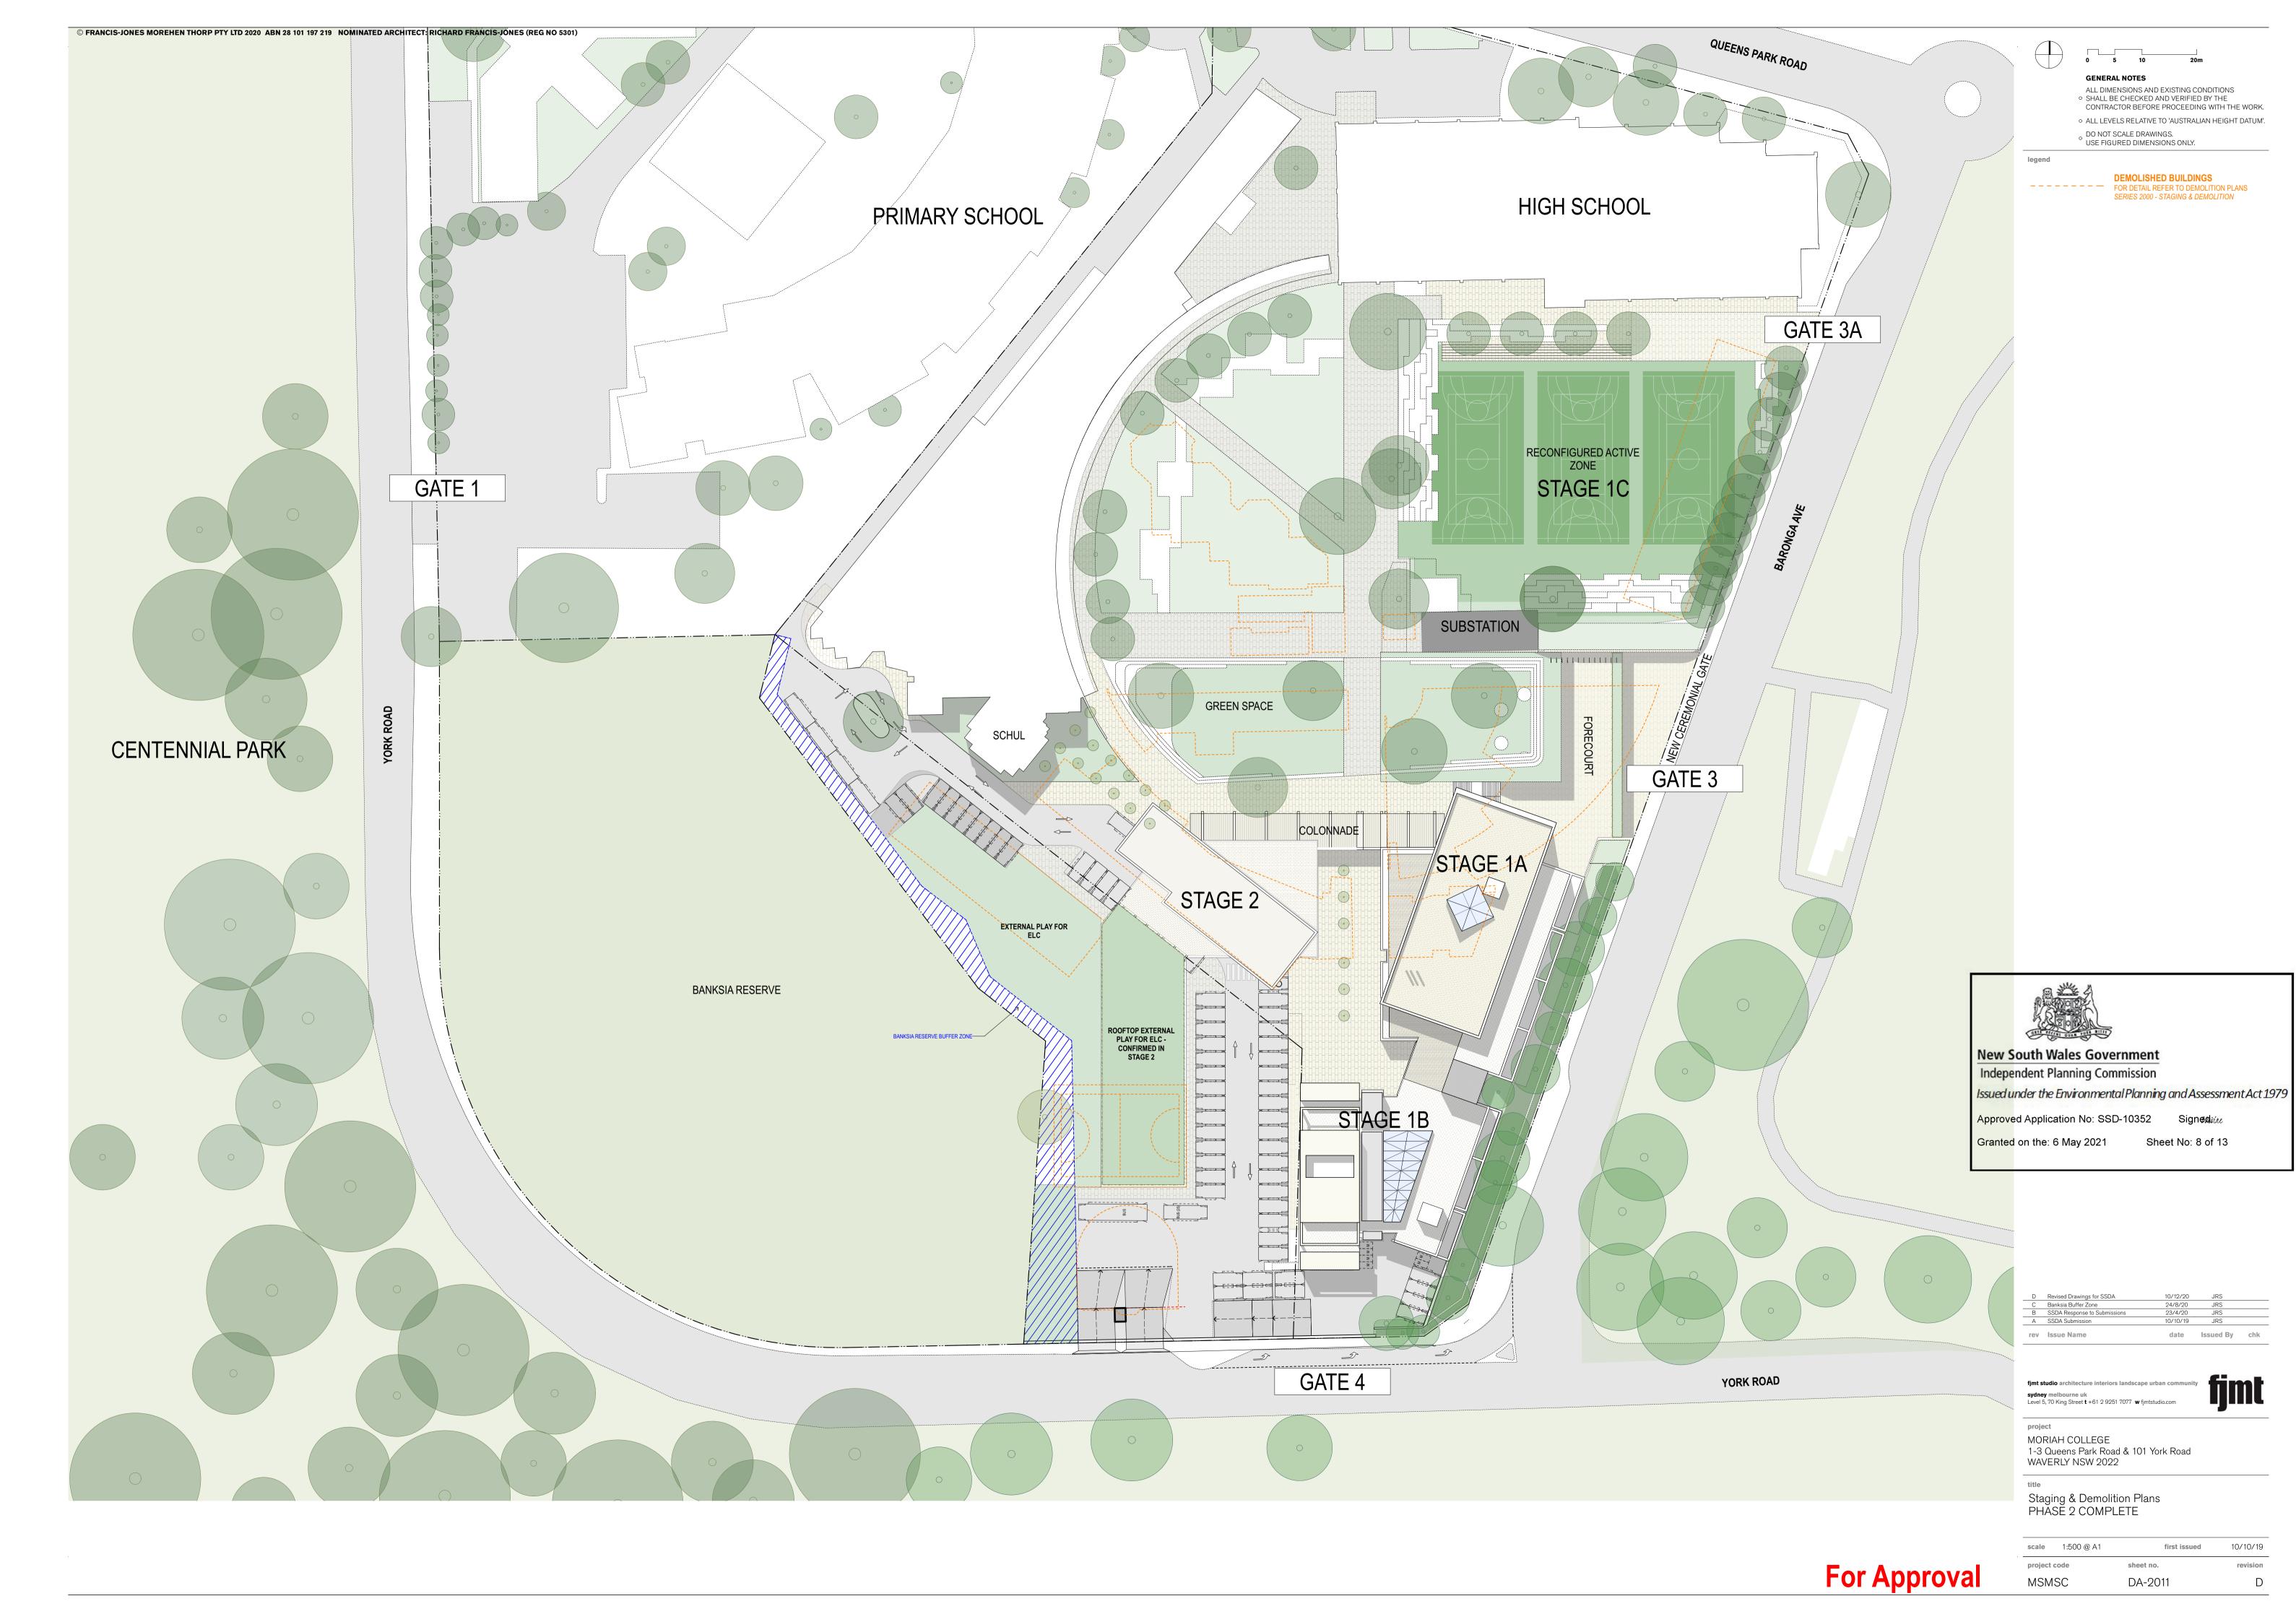


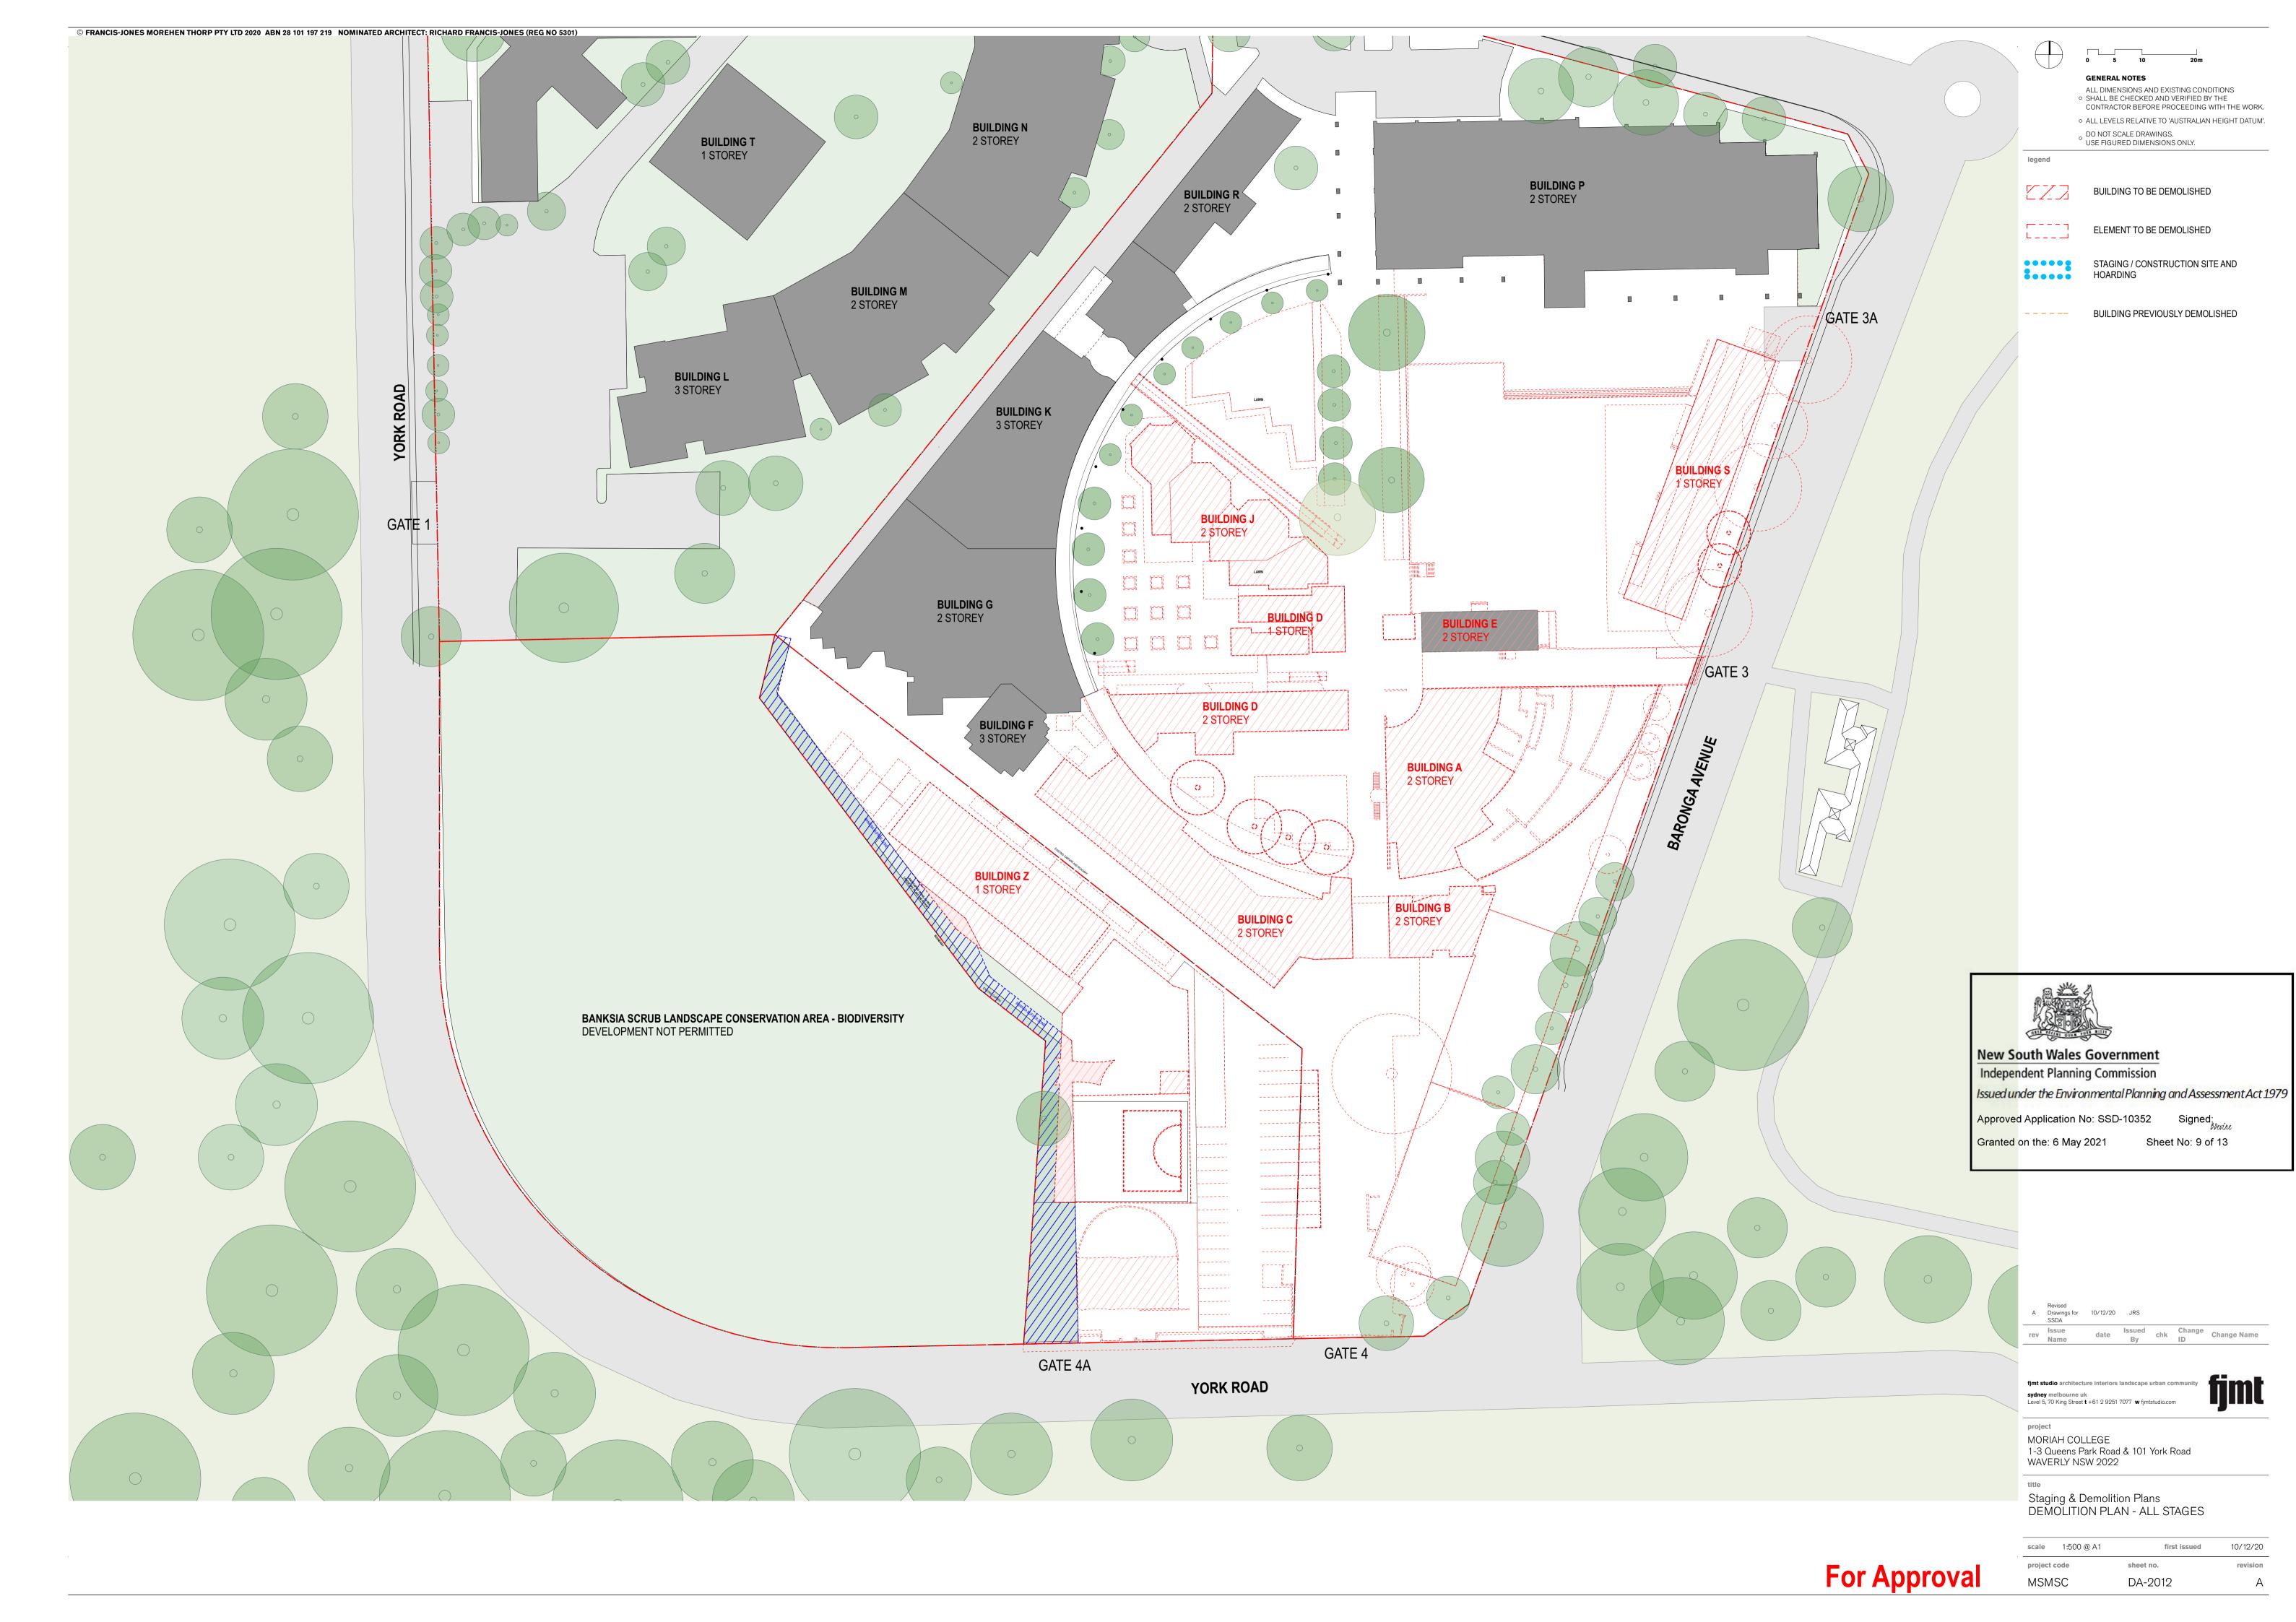






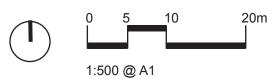

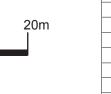

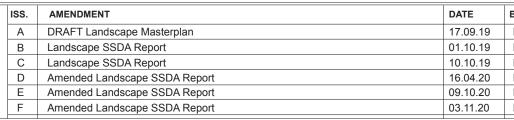

 DATE
 BY
 ARCHITECT

 17.09.19
 LB
 FJMT Architecture

 01.10.19
 LB
 Level 5, 70 King Street Sydney, NSW, 2000, AUS T +61 2 9251 7077

 09.10.20
 LB
 03.11.20
 LB



PORTANT NOTES:
scale from drawings
crepancies to be brought to the attention of the Landscape Architect
scale drawings and written dimensions take preference. All dimensions in mm unless otherwise stated.
e dimensions and RLs in metres.
gured dimensions only.
all dimensions on site before the commencement of any works.
ctors shall locate and protect all services prior to construction.
k shall be carried out in accordance with ASA, BCA and Local Government Regulations.
ural Details shall be subject to Engineer's Specifications.
ge & Water Feature Details shall be subject to Hydraulic Engineer's Specifications.
k shall be carried out in a professional manner by Qualified Tradesman according to Landscape Drawin

CLIENT		CHECKED		
MORIAH COLLEGE	LB			
Queens Park Rd,				
Queens Park NSW				
SCALE	DRAWN	ISSUE		
	DRAWN			
1:500	LB	SSDA		

STAGE 2 - LANDSCAPE MASTERPLAN


PROJECT


MCMSC - MORIAH COLLEGE







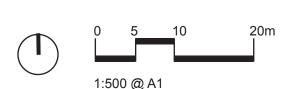

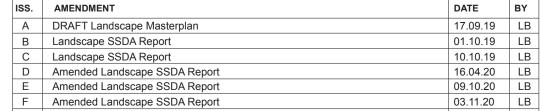

DATE BY ARCHITECT 17.09.19 LB FJMT Architecture 01.10.19 LB 10.10.19 LB 16.04.20 LB 09.10.20 LB CO. 14.00 LB




IMPORTANT NOTES:
Do not scale from drawings
All discrepancies to be brought to the attention of the Land
Larger scale drawings and written dimensions take prefere
All tree dimensions and RLs in metres.

wise stated.	CLIENT MORIAH COLLEGE Queens Park Rd, Queens Park NSW 2022		CHECKET LB	
ape Drawings and	SCALE	DRAWN	ISSUE	
	1:500	LB	SSDA	

STAGE 2 - TREE SPECIES MASTERPLAN MCMSC - MORIAH COLLEGE

TREES



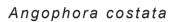




Banksia integrifolia



Banksia serrata

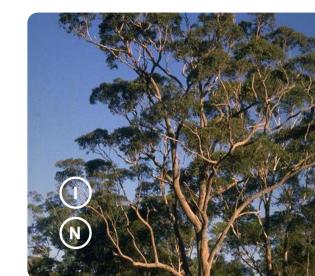

Corymbia gummifera





Elaeocarpus reticulatus

leptospermum laevigatum



Eucalyptus saligna



Eucalyptus sideroxylon

SHRUBS & GRASSES




Banksia ericifolia



Melaleuca nodosa



Banksia aemula

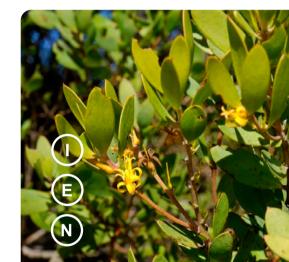

Persoonia lanceolata



Isopogon anemonifolius



Pimelea linifolia







Kunzea ambigua



Philorheca buxifolia



GRASSES, GROUNDCOVERS & CLIMBERS



Dianella revoluta

Moriah College



Xanthorrhoea resinosa



Lomandra longifolia

ISS. AMENDMENT

Amended Landscape SSDA Report



Myoporum parvifolium

03.11.20 LB



Dampieria stricta



KEY PLAN

J JEWISH CULTURAL SIGNIFICANCE

(I) INDIGENOUS CULTURAL SIGNIFICANCE

E EASTERN SUBURBS BANKSIA SCRUB

N LOCAL NATIVE / NATIVE



New South Wales Government Independent Planning Commission

Issued under the Environmental Planning and Assessment Act 1979

Approved Application No: SSD-10352 Signed: Nevine

Granted on the: 6 May 2021 Sheet No: 12 of 13

PLANT SCHEDULE

Botanical Name	Common Name	Pot Size	Mature Height	Quantity
TREES & PALMS				
Angophora costata*** Banksia integrifolia*** Banksia marginata *** Banksia serrata*** Corymbia gummifera*** Corymbia maculata*** Elaeocarpus reticulatus*** Eucalyptus saligna*** Eucalyptus sideroxylon***	Smooth-barked Apple Coast Banksia Silver Banksia Old Man Banksia Red Bloodwood Spotted Gum Blueberry Ash Sydney Blue Gum Mugga Ironbark	300L 100L 200mm 100L 300L 300L 200L 100L 100L	20m 4 - 15m 5m 3-15m 20m 30m 3-15m 30m 15m	3 1 4 1 3 2 2 1
SHRUBS				
Banksia aemula *** Banksia ericifolia *** Grevillea buxifolia*** Isopogon anemonifolius*** Kunzea ambigua*** Leptospermum laevigatum *** Melaleuca nodosa*** Philotheca buxifolia*** Pimelea linifolia*** Persoonia lanceolata***	Wallum Banksia Heath-Leaved Banksia Grey Spider Flower Broad-leaved Drumsticks Tick Bush Coastal Tea Tree Prickly-Leaved Paperbark Box Leaf Waxflower Slender Rice Flower Lance-Leaf Geebung	200mm 200mm 200mm 200mm 200mm 200mm 200mm 200mm 200mm	3 - 5m 2 - 7m 1 - 2m 1 - 1.5m 2-3m 4m 3m 0.3m 1m 2m	325 445 325 265 325 385 205 265 265 445
GRASSES & GROUNDCOVERS Dampiera stricta***	Divo Dominiono	150000	0.200	205
Lomandra longifolia*** Xanthorrhoea resinosa *** Myoporum parvifolium*	Blue Dampiera Spiny Mat-Rush Grass Tree Creeping Boobialla	150mm 150mm 200mm 150mm	0.3m 0.4 - 1m 0.6m 0.2m	285 1383 470 400

^{***} ESBS ** Annexure B2-1 Indigenous species / Local Native

ISSUE SSDA

IMPORTANT NOTES:

Do not scale from drawings DATE BY ARCHITECT MORIAH COLLEGE 17.09.19 LB FJMT Architecture PLANTING PALETTE - EARLY LEARNING CENTRE DRAFT Landscape Masterplan 01.10.19 LB 10.10.19 LB 16.04.20 LB 09.10.20 LB CO. 14.00 LB Queens Park Rd, Landscape SSDA Report Queens Park NSW 2022 Landscape SSDA Report Amended Landscape SSDA Report MCMSC - MORIAH COLLEGE Amended Landscape SSDA Report

TREES







Banksia integrifolia



Banksia serrata



Melaleuca nodosa

SHRUBS & GRASSES










Grevillea buxifolia



Kunzea ambigua

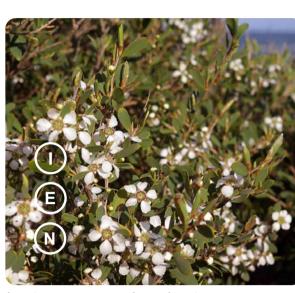

leptospermum laevigatum



Melaleuca nodosa



Persoonia lanceolata



Pimelea linifolia



Philorheca buxifolia

GRASSES, GROUNDCOVERS & CLIMBERS






Xanthorrhoea resinosa



Lomandra longifolia



Hibbertia scandens

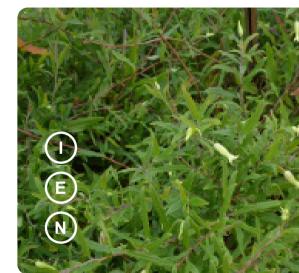

Billardiera scanden





KEY PLAN

- J JEWISH CULTURAL SIGNIFICANCE
- INDIGENOUS CULTURAL SIGNIFICANCE
- E EASTERN SUBURBS BANKSIA SCRUB
- N LOCAL NATIVE / NATIVE

NOTES.

A 'vegetation protection buffer zone' within Lot 22 along its common boundary with Lot 23 to buffer the Eastern Suburbs Banksia Scrub critically endangered ecological community has been incorporated in accordance with conditions associated with development application LD 282/00.

Planting within the 'vegetation protection buffer zone' will be completed in accordance with a revised Vegetation Management Plan (VMP) that is endorsed by Environment, Energy and Science Group of DPIE, Waverley Council, and Centennial Park and Moore Park Trust (CPMPT).

Revegetation will be undertaken by a suitably qualified bush regenerator with experience in restoring and maintaining the Eastern Suburbs Banksia Scrub in the Sydney Basin Bioregion (ESBS) vegetation community.

- Plants used are to be ESBS local provenance.
- ESBS plants are to be sourced from within a 10km range of the site.

The VMP Area will be managed, maintained and monitored in perpetuity by a suitably qualified bush regenerator with experience in restoring and maintaining the Eastern Suburbs Banksia Scrub in the Sydney Basin Bioregion (ESBS) vegetation community.

PLANT SCHEDULE

Botanical Name TREES & PALMS	Common Name	Pot Size	Mature Height	Quantity
Acacia longifolia***	Sydney Golden Wattle	100L	8m	4
Banksia integrifolia***	Coast Banksia	100L	4 - 15m	5
Banksia serrata***	Old Man Banksia	100L	3 - 15m	3
Melaleuca nodosa***	Prickly-leaved paperbark	100L	3m	3
SHRUBS Banksia aemula *** Banksia ericifolia *** Grevillea buxifolia*** Isopogon anemonifolius*** Kunzea ambigua*** Leptospermum laevigatum *** Melaleuca nodosa*** Philotheca buxifolia*** Pimelea linifolia*** Persoonia lanceolata***	Wallum Banksia Heath-Leaved Banksia Grey Spider Flower Broad-leaved Drumsticks Tick Bush Coastal Tea Tree Prickly-Leaved Paperbark Box Leaf Waxflower Slender Rice Flower Lance-Leaf Geebung	200mm 200mm 200mm 200mm 200mm 200mm 200mm 200mm 200mm 200mm	3 - 5m 2 - 7m 1 - 2m 1 - 1.5m 2-3m 4m 3m 0.3m 1m 2m	144 144 216 72 144 216 72 144 144
GRASSES & GROUNDCOVERS Billardiera scandens*** Dianella revoluta*** Lomandra longifolia*** Xanthorrhoea resinosa *** Hibbertia scandens*	Apple Berry	150mm	0.2 - 0.5m	720
	Blueberry Lily	150mm	0.3m	675
	Spiny Mat-Rush	150mm	0.4 - 1m	675
	Grass Tree	200mm	0.6m	450
	Creeping Boobialla	150mm	0.2m	1080

*** ESBS ** Annexure B2-1 Indigenous species / Local Native

MCMSC - MORIAH COLLEGE



DATE BY ARCHITECT 17.09.19 LB FJMT Architecture 01.10.19 LB 10.10.19 LB 16.04.20 LB 09.10.20 LB CO. 14.00 LB



RTANT NOTES: m drawings st to be throught to the attention of the Landscape Architect wings and written dimensions take preference. All dimensions in mm unless otherwise stated. ons and RLs in metres. enersions only, sions on site before the commencement of any works. all locate and protect all services prior to construction. e carried out in accordance with ASA, BCA and Local Government Regulations. is shall be subject to Engineer's Specifications. ter Feature Details shall be subject to hydraulic Engineer's Specifications. cerried out in a professional manner by Qualified Tradesman according to Landscape Drawings and	CLIENT MORIAH COLLEGE Queens Park Rd, Queens Park NSW	_	CHECKED LB
cifications. y will be taken by 360 degrees. for any variations in design, construction method, materials specified, and attoms without permission from the Project Engineer or Landscape Architect.	SCALE N/A	DRAWN	ISSUE