

ATC LEGER LAWN

LANDSCAPE ARCHITECTURAL DEVELOPMENT APPLICATION Issue: E Date: 22.01.2020


FOR: MOSTYN COPPER GROUP




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Approved Application NoSSD 10285	
13/07/2020	
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Sheet No 1 of	9



LOCATION & CONTEXT

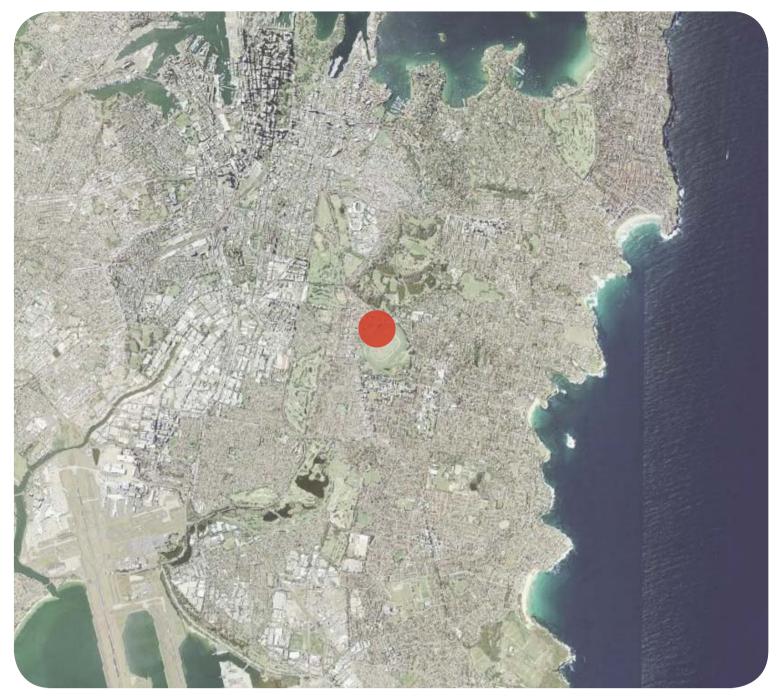

GREATER CONTEXT

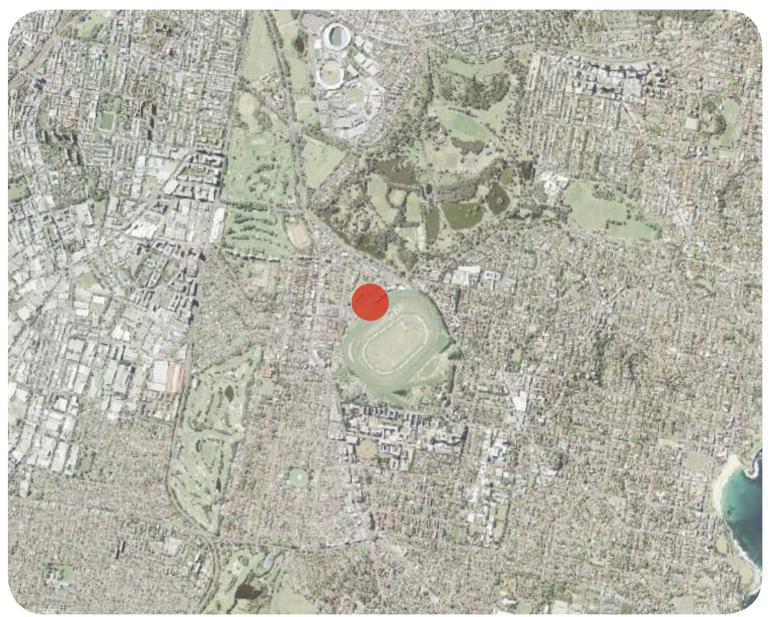


LOCAL CONTEXT

ATC Leger Lawn and proposed Winx Stand is located 5.5km South-East of Sydney CBD and is part of the Royal Randwick Racecourse.

The site sits between the Queen Elizabeth II Grandstand, the multideck carpark and the race track.

The proposed development is a 100m long grandstand called the 'Winx Stand' and will be two stories tall. Surrounding the building will be a landscape terrace for race viewing, the laneway and a long stretch of landscaped area that will be the location of portable eateries.

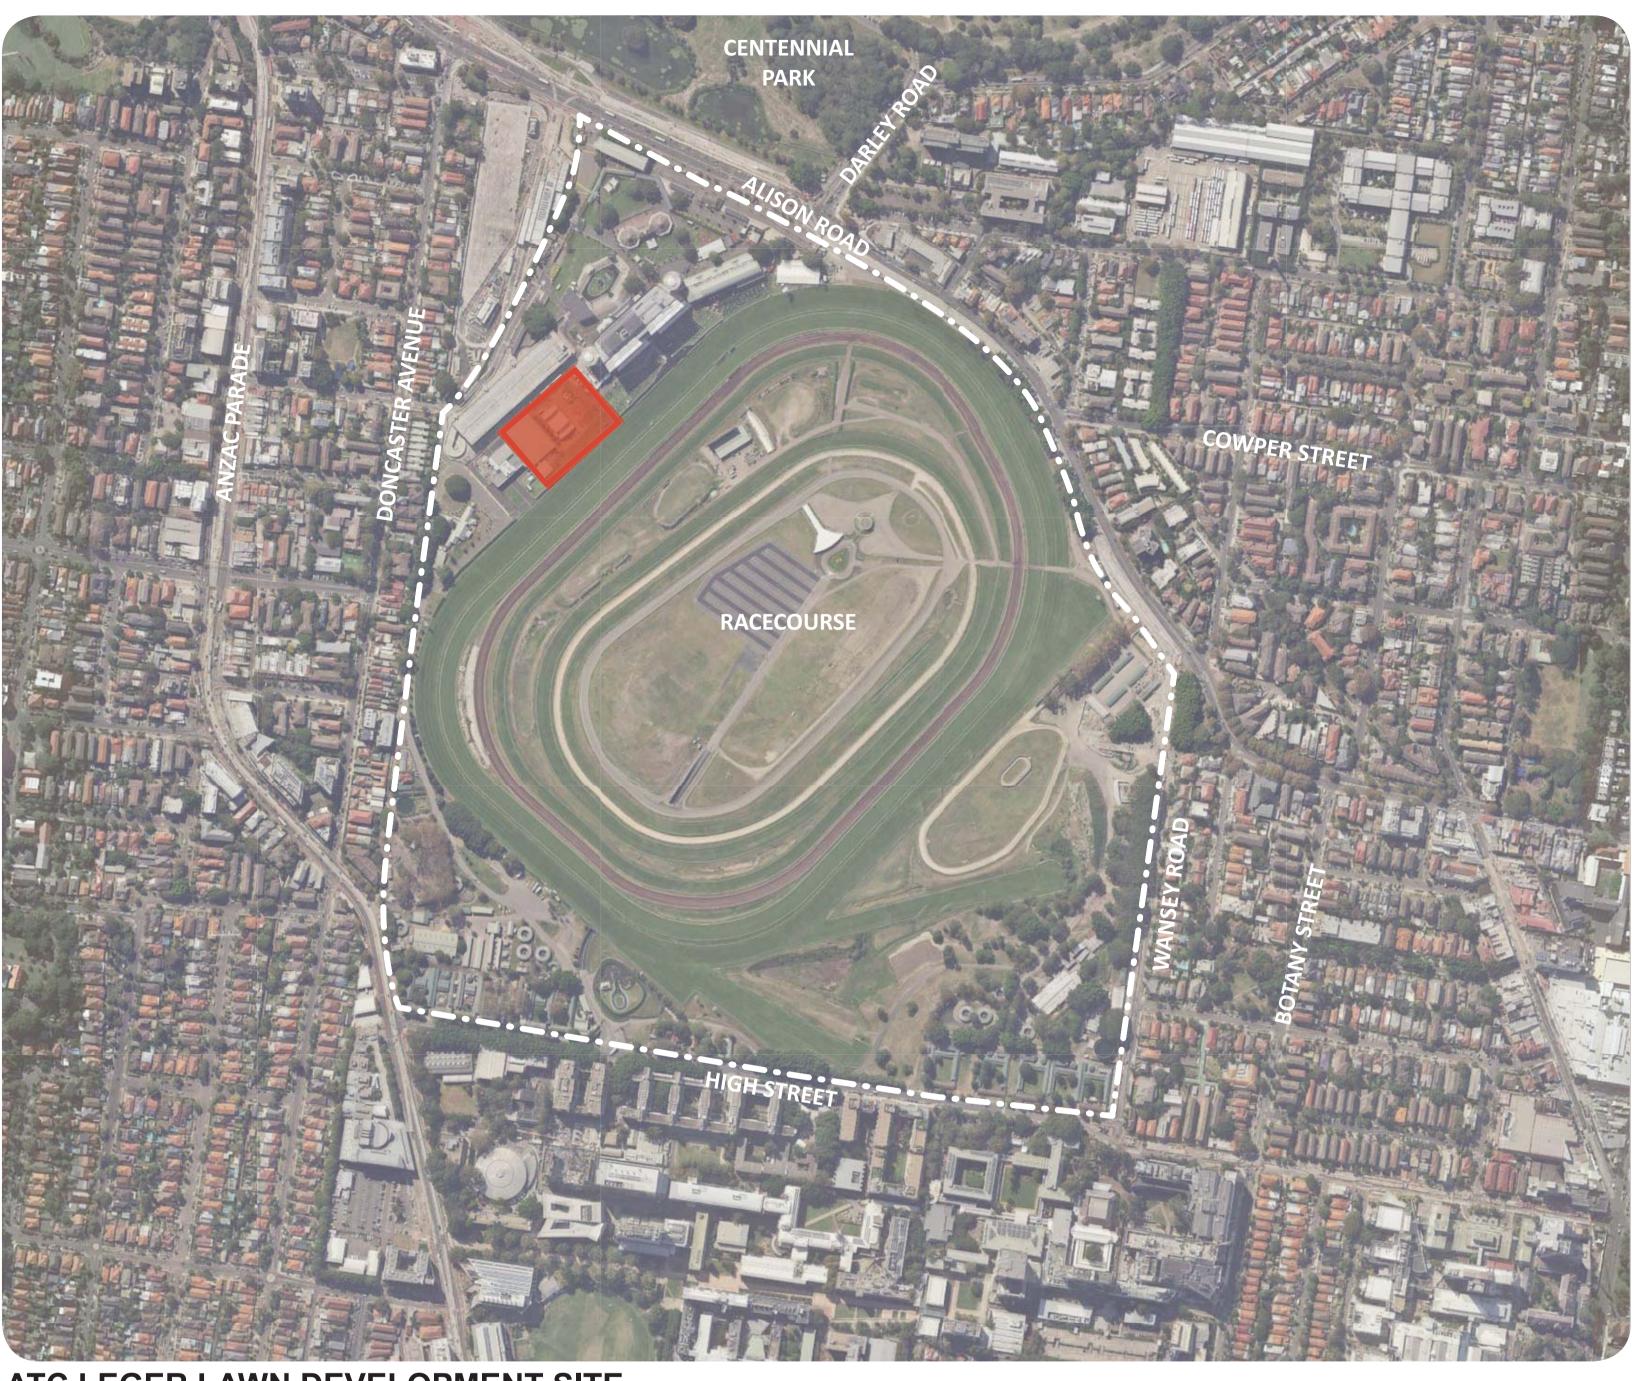

The landscape viewing terrace will comprise of in-situ concrete terraced steps oriented toward the finish line, which will allow a large volume of people to view the races, and create an atmosphere that facilitates socialising.

The landscaped zones will be integrated with lush low maintenance planting, in keeping with other areas of the spectators precinct at the racecourse. Flowering native vines to steel cables and cascading roof planters will provide greenery and ambiance. Further terraced areas

ATC LEGER LAWN DEVELOPMENT SITE

will be created through integrating planting and seating into stairways, which will create many multiple casual seating spaces that can be used for small gatherings of people, and compliment casual seating and utility adjacent to the laneway.

The planting palette will be consistent to other species found around Rand

Randwid	k Racecours	e, to create a landscape co
precinct.	ANYA	Planning,
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	GOVERNMENT	Environment

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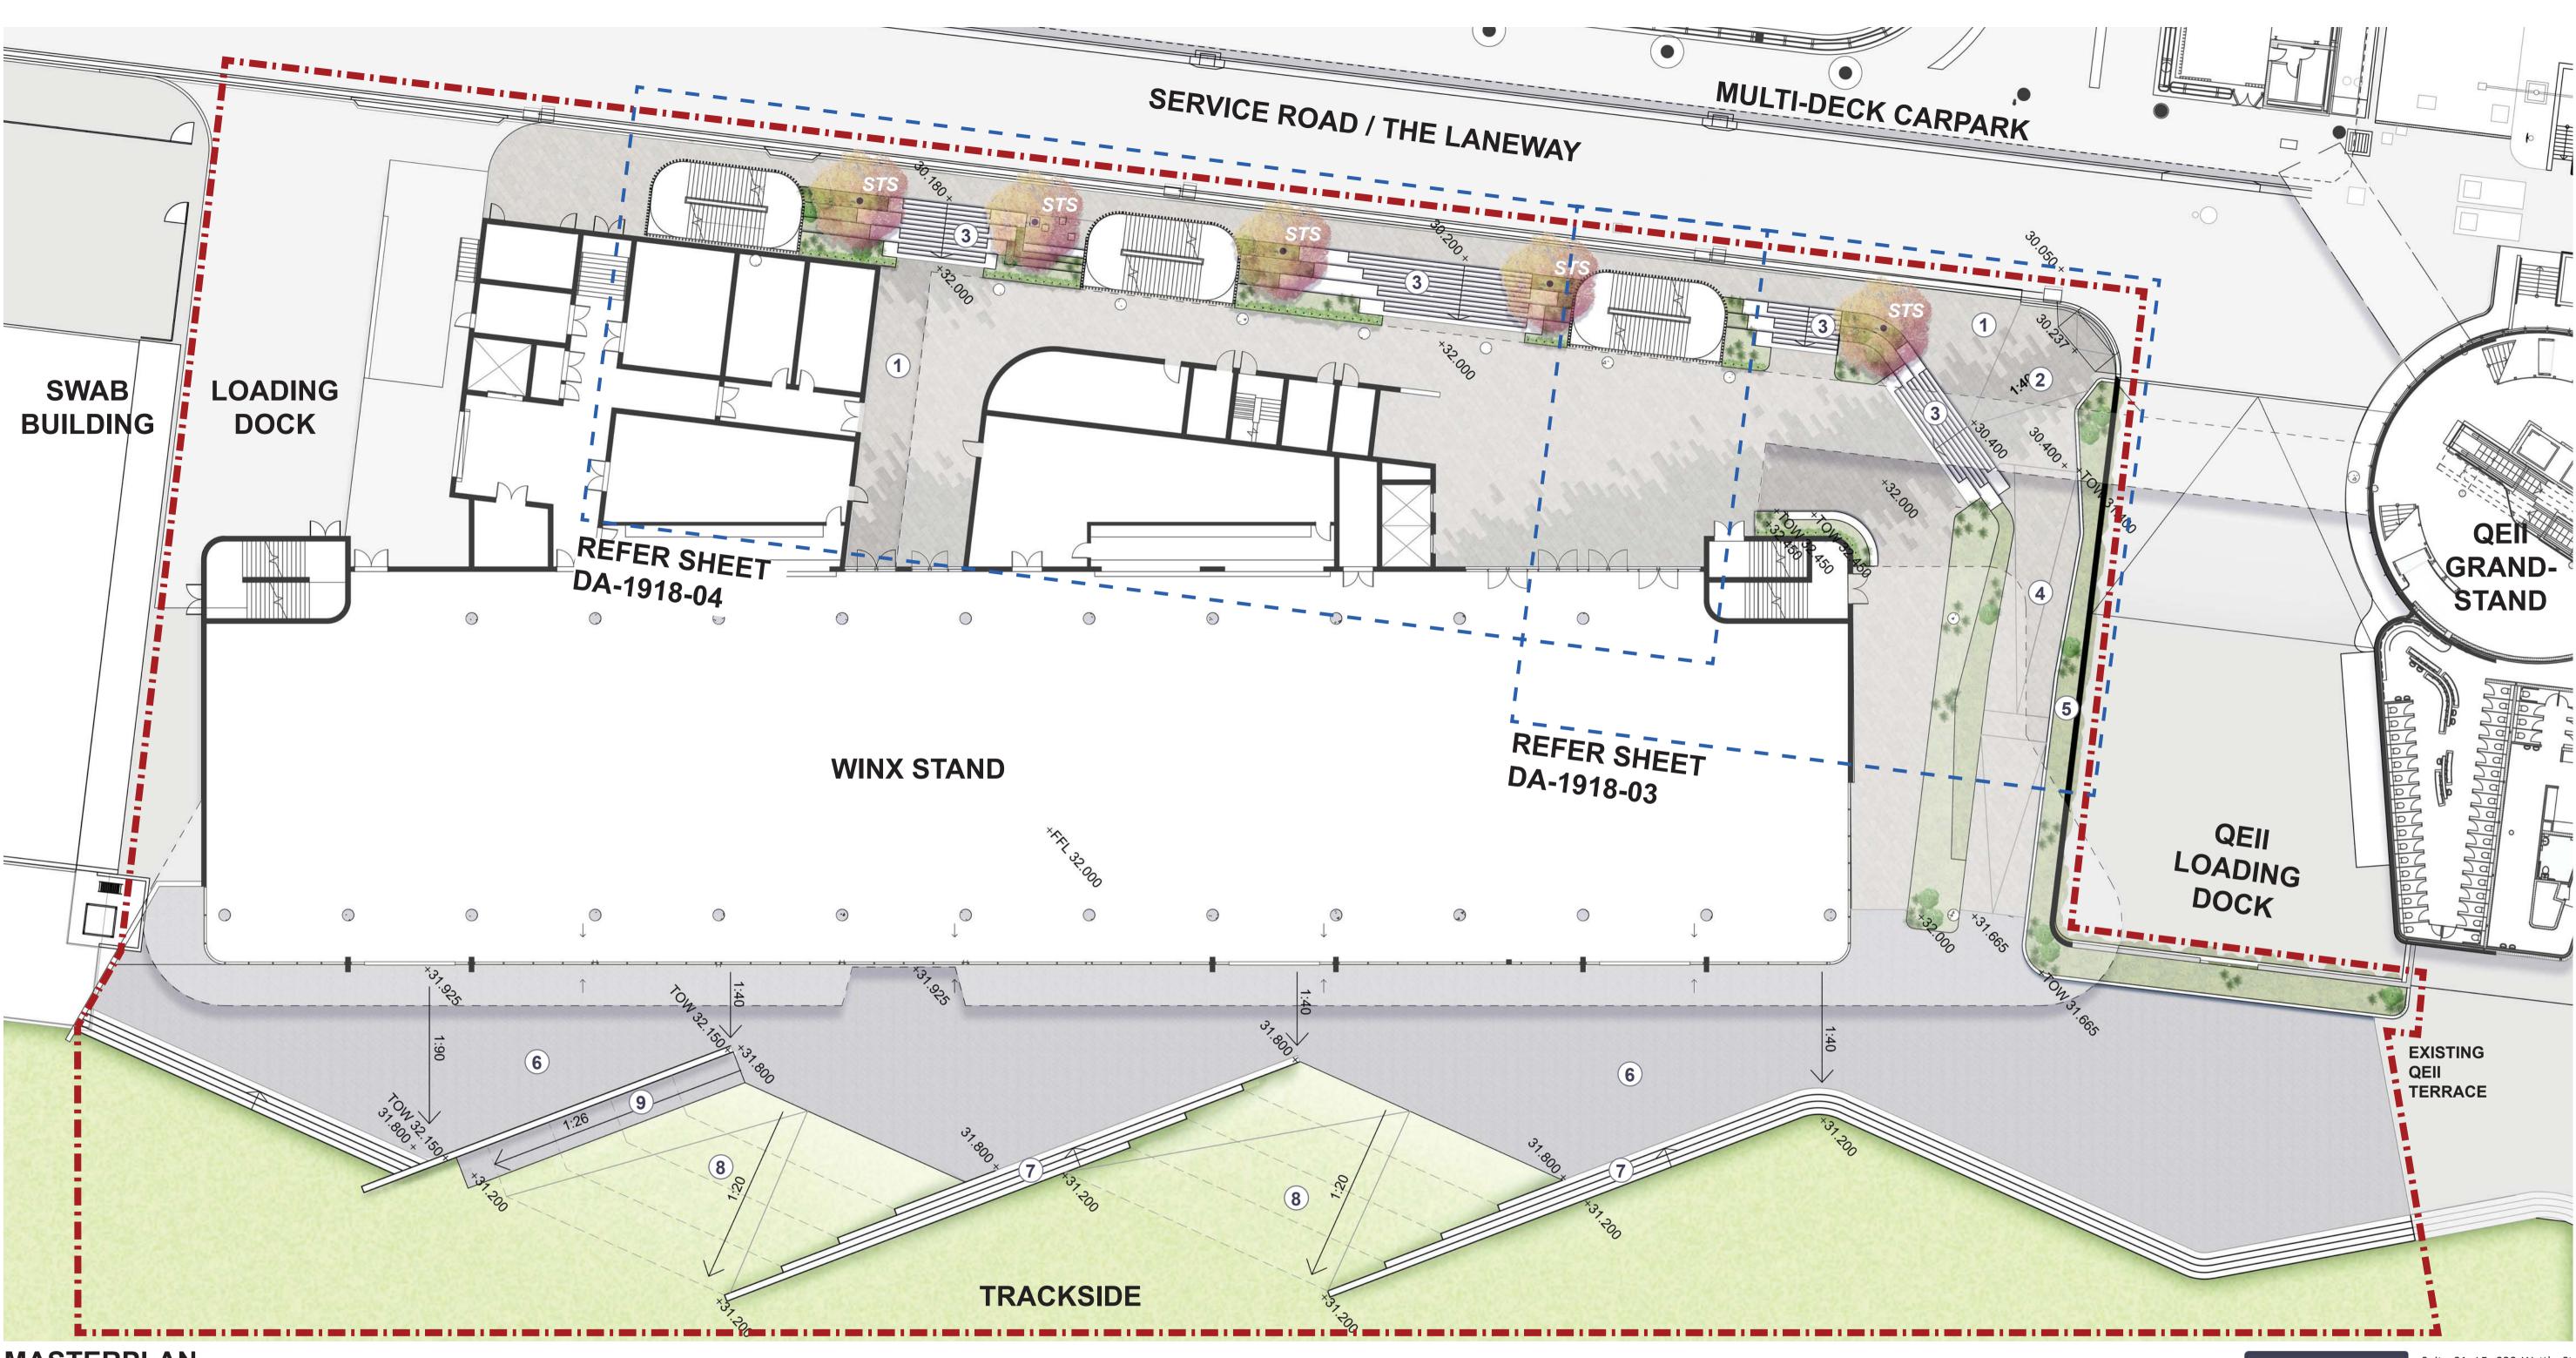
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DRAWING **LOCATION & CONTEXT**

RAWING N DA-1918-01 D jw/wl

DATE 30.10.2019

GROUND FLOOR



MASTERPLAN

NOTES

- 1. Unit paving to main entry
- 2. Two tone paving defines entry to the Winx Stand
- 3. Concrete stairs, seating edges and planting create active edges and entries
- 4. Access path
- 5. Raised planter creates green edge to path. Trailing plants green wall of the QEII loading dock
- 6. Asphalt terrace provides an outdoor spill space facing the race track and links into existing terrace in front of the QEII Grands
- 7. Terraced stairs define the outdoor terrace, create viewing edges oriented toward the line and provide access to the open lawn below
- 8. Graded lawn areas provide a link betweer the terrace and the open lawn for people maintenance vehicles

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out	9.	2m wide a	spheter the toutrackside lawn area		Site Bounda
the stand		(1:26 grade grade of pa	e Adjacent lawn te match	+98.000	Proposed le EX = Existin TOW = Top
finish			Issued under the Environmental Planning and Assessment Act 1979		Contours
areas			Approved Application NoSSD 10285	X:XX	Proposed fa
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and			Signed ^{MW}	XX	planting sch DA-1918-06
			Sheet No ³ of9	- C. Martine	



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levels ng level o of wall

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DRAWING **GROUND FLOOR MASTERPLAN**

DRAWING No DRAWN DA-1918-02 E jw/wl


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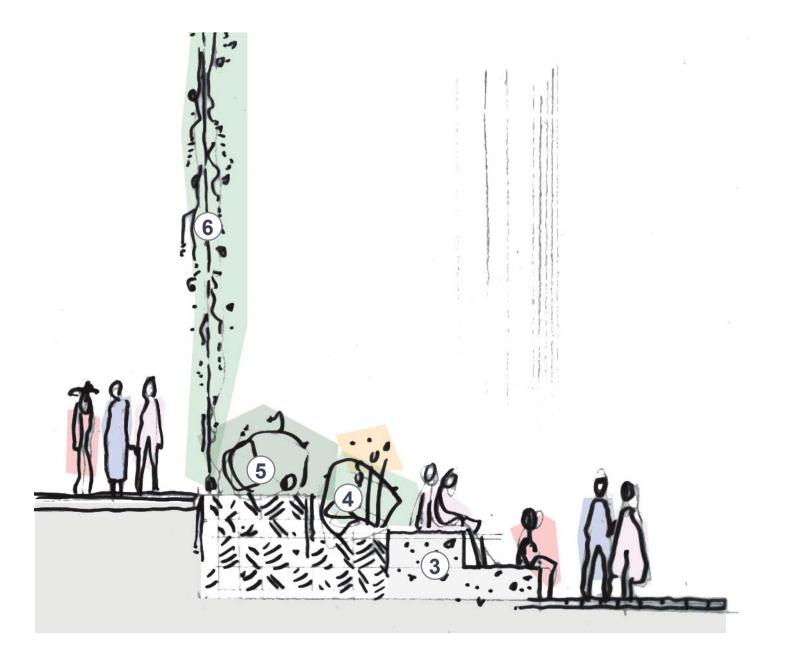
Scale

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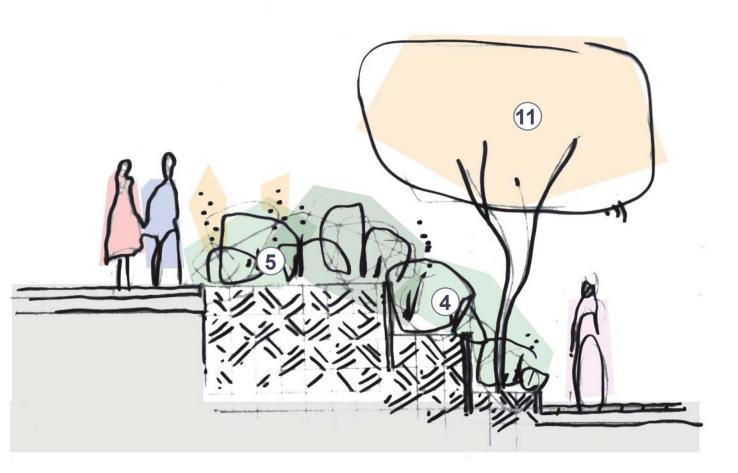
GROUND FLOOR



CORNER ENTRY DETAIL PLAN SCALE 1:100 @ A1

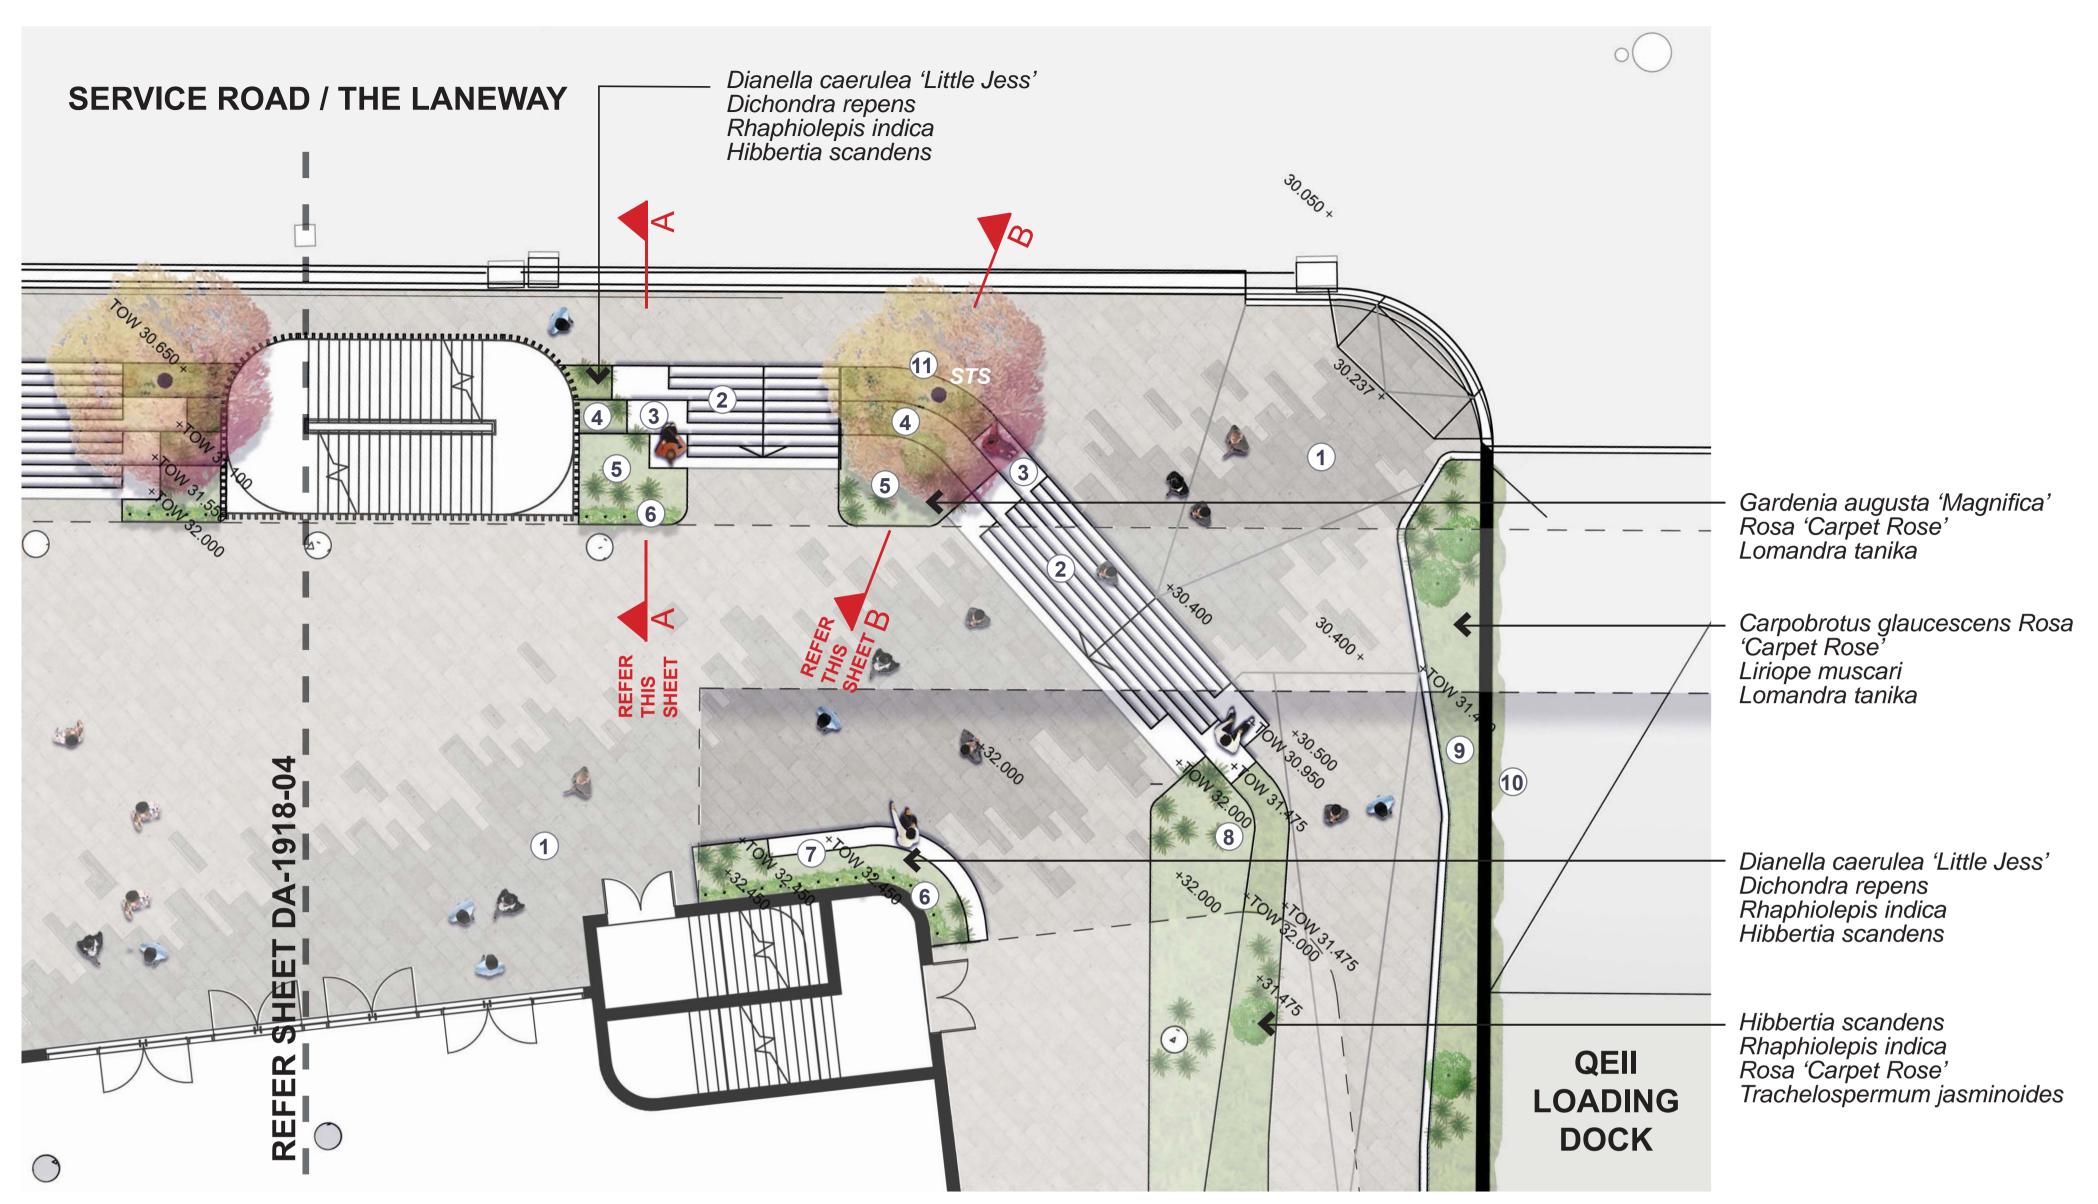

SECTION A-A SCALE 1:200 @ A1 REFER THIS SHEET



SECTION B-B

SCALE 1:200 @ A1 REFER THIS SHEET



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NOTES

- 1. Two tone paving defines entry to the Winx Stand
- 2. Wide entry stairs
- 3. Seating block ends to stairs provide informal seating areas
- 4. Planting and blade walls terrace down in line with seating blocks to the laneway, greening the change in level and providing edges to seating areas
- 5. Planting areas level with Winx Stand paving
- Stainless steel cables with native vines extend 6. from garden beds to the roof creating a flowering green curtain
- 7. Raised garden bed with lush planting and seating wall
- 8. Lush planting and blade walls create green terraces between the changes in paving level
- 9. 1m high raised planter creates green edge to path and helps direct pedestrians toward the racetrack.
- 10. Trailing plants green the wall of the QEII loading dock below
- 11. Medium sized feature tree provides seasonal interest



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DRAWING **GROUND FLOOR CORNER ENTRY**

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DATE 30.10.2019





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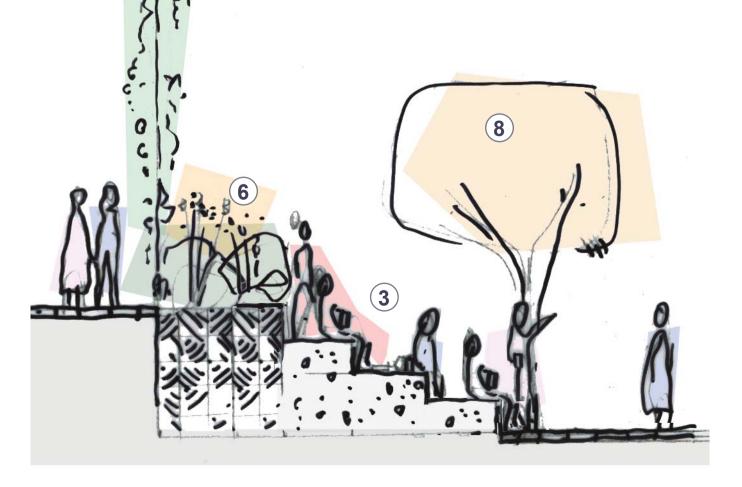
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GROUND FLOOR





SECTION C-C SCALE 1:200 @ A1 REFER THIS SHEET

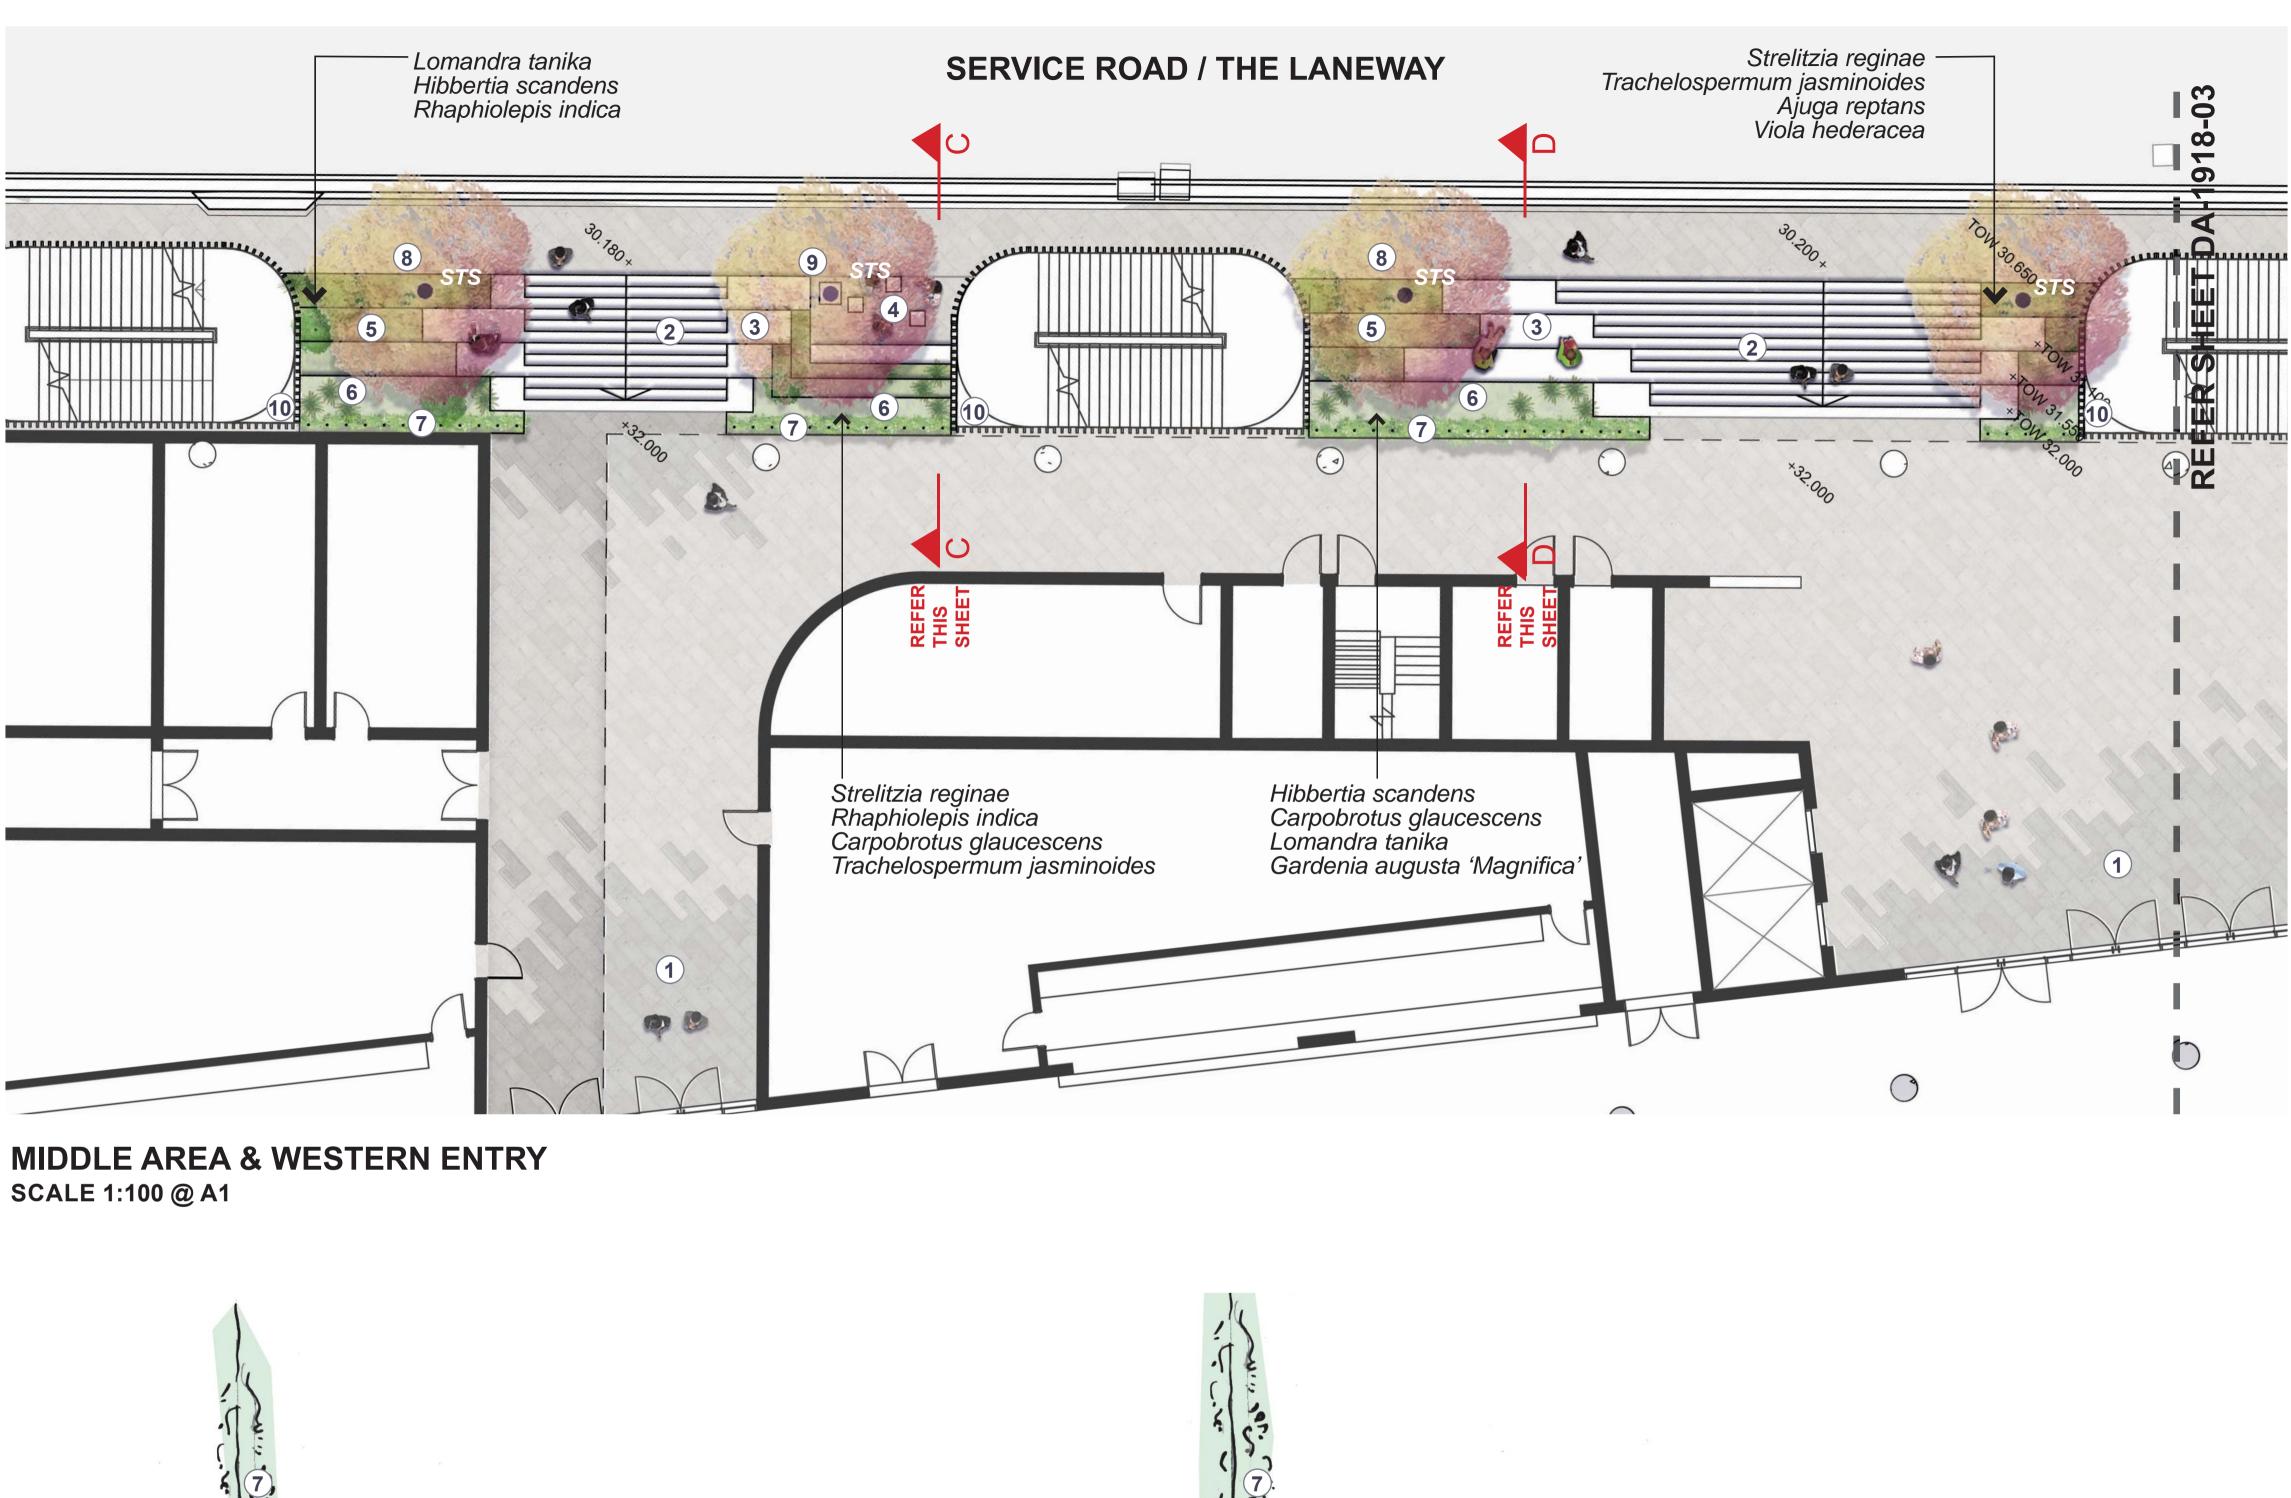

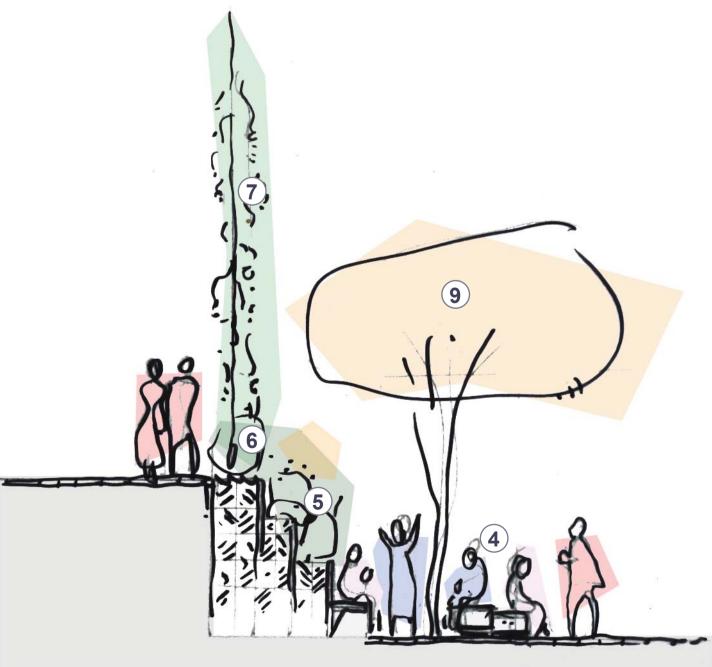SECTION D-D SCALE 1:200 @ A1 REFER THIS SHEET



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NOTES

- 1. Two tone paving defines entry to the Winx Stand
- 2. Wide entry stairs
- Seating block ends to stairs provide informal 3. seating areas
- Inset area with 900mm high standing / leaning 4. wall and block seats
- 5. Planting and blade walls terrace down in line with seating blocks to the laneway, greening the change in level and providing edges to seating areas
- 6. Planting areas level with Winx Stand paving
- Stainless steel cables with native vines extend 7. from garden beds to the roof creating a flowering green curtain
- 8. Medium sized feature tree provides seasonal interest
- 9. Medium sized feature tree set in tree grate in paved area
- 10. Runoff from fire stair roof top planters directed into ground area terraced garden beds



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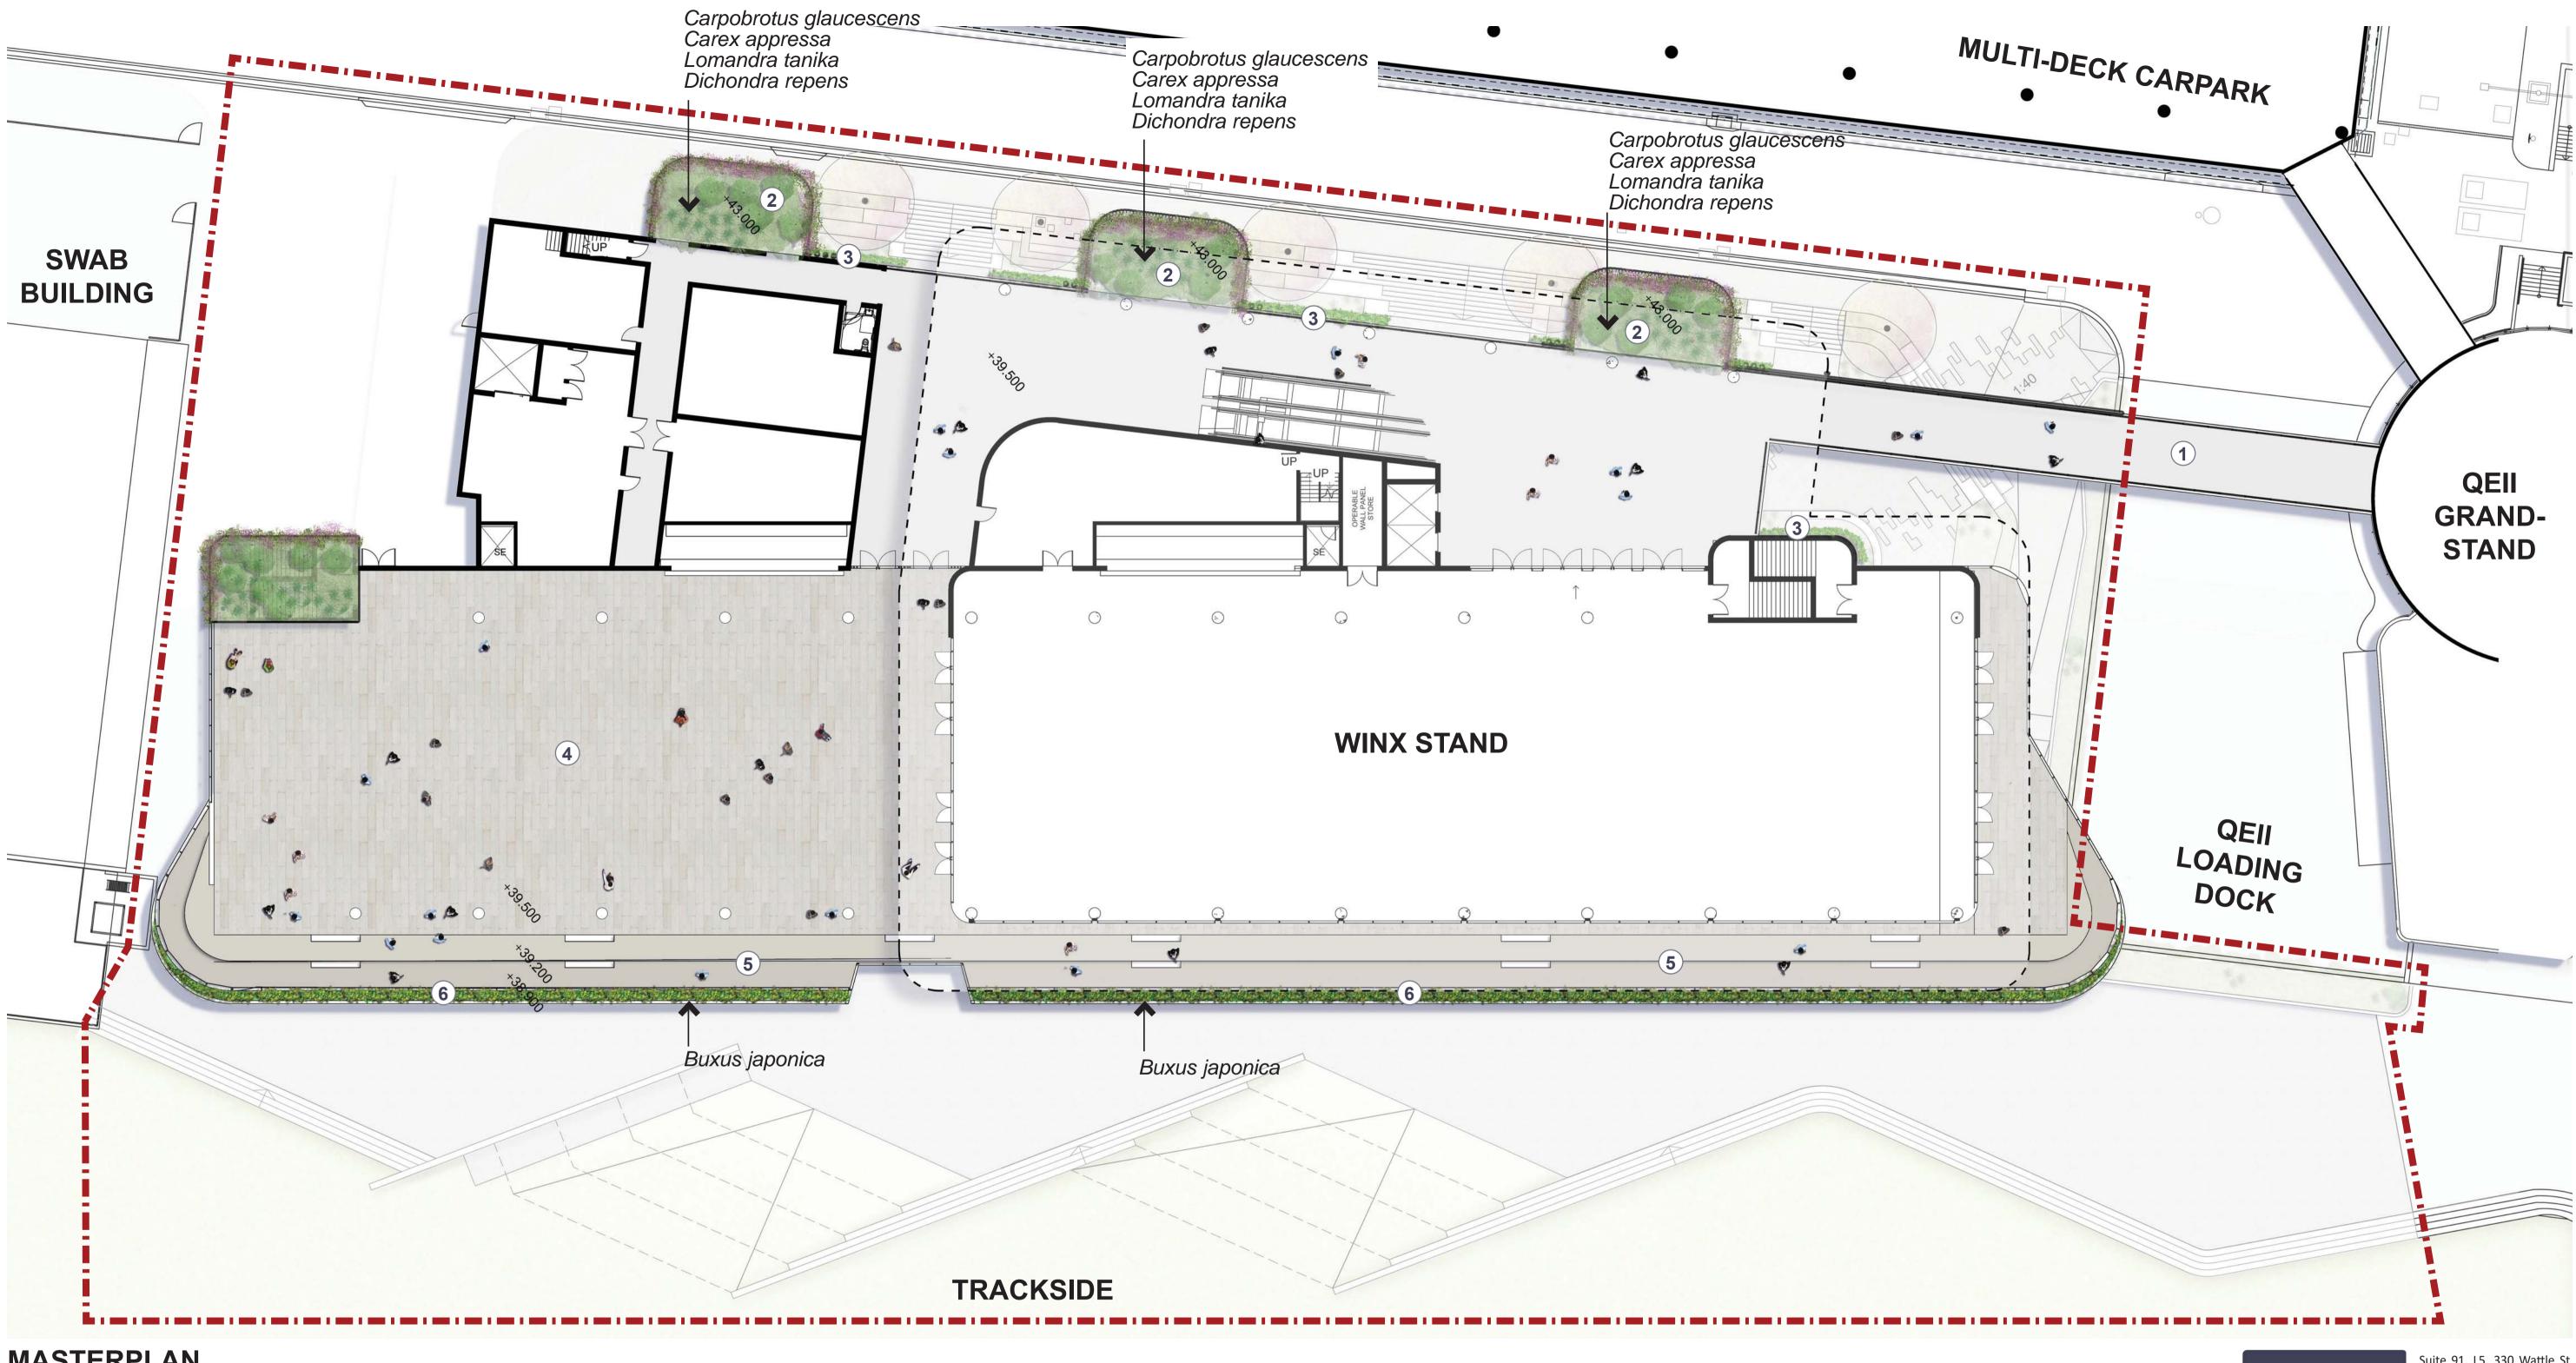
DRAWING **GROUND FLOOR - MIDDLE AREA AND** WESTERN ENTRY DRAWING No DRAWN DATE 30.10.2019 DA-1918-04 D jw/wl



1:100@A1



LEVEL 1 AND ROOF



MASTERPLAN

NOTES

- 1. Pedestrian bridge to QEII Grandstand
- 2. Roof top planting to fire stairs. Trailing plants to cascade over edges
- 3. Stainless steel cables with native vines extend from garden beds to the roof creating a flowering green curtain
- 4. Level 1 terrace
- 5. Stepped edge to level 1 terrace

6. Low clipped box hedge to edge of lev creates a green edge

vel 1 t	terrace
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LEGEND

Site Boundary



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DRAWING LEVEL 1 MASTERPLAN

DATE DRAWING No. DRAWN SSUF 22.01.2020 DA-1918-05 E jw/wl

Scale

10m 1:200@A1 1:400@A3

SKETCH PERSPECTIVE



LOOKING SOUTH DOWN THE LANEWAY



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NOTES

- 1. Wide entry stairs
- 2. Seating block ends to stairs provide informal seating areas
- 3. Planting and blade walls terrace down in line with seating blocks to the laneway, greening the change in level and providing edges to seating areas
- Medium sized feature tree provides seasonal 4. interest
- 5. Stainless steel cables with native vines extend from garden beds to the roof creating a flowering green curtain
- 6. Roof top planting to fire stairs. Trailing plants to cascade over edges
- 7. Pedestrian bridge to QEII Grandstand



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DRAWING SKETCH PERSPECTIVE


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DATE 30.10.2019


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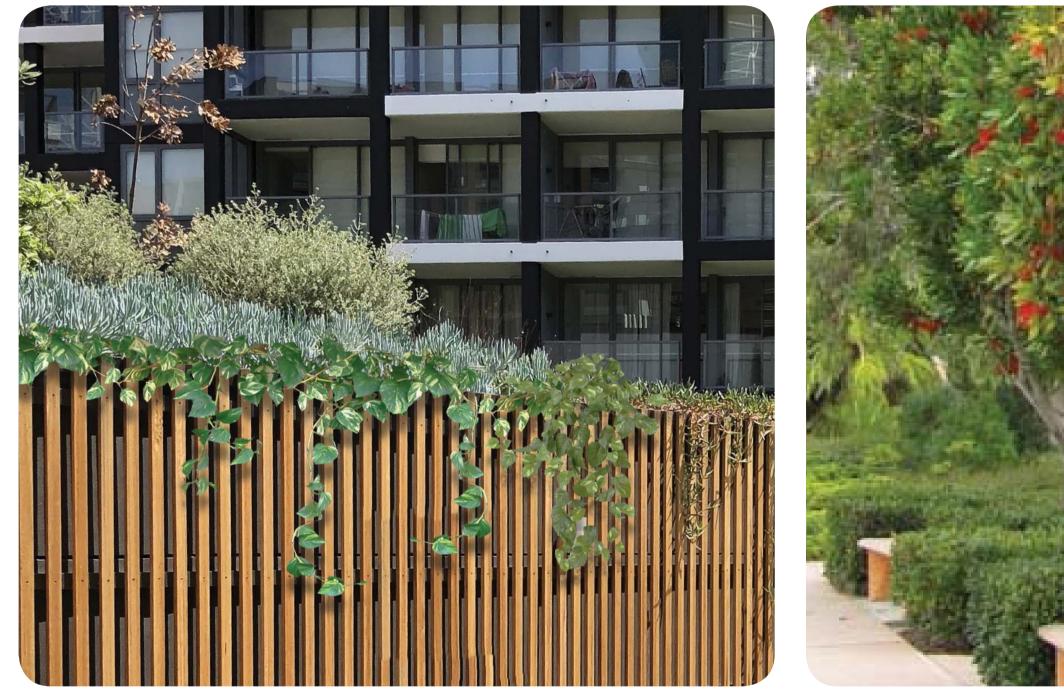


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DESIGN ELEVATION




THE LANEWAY ELEVATION

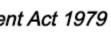

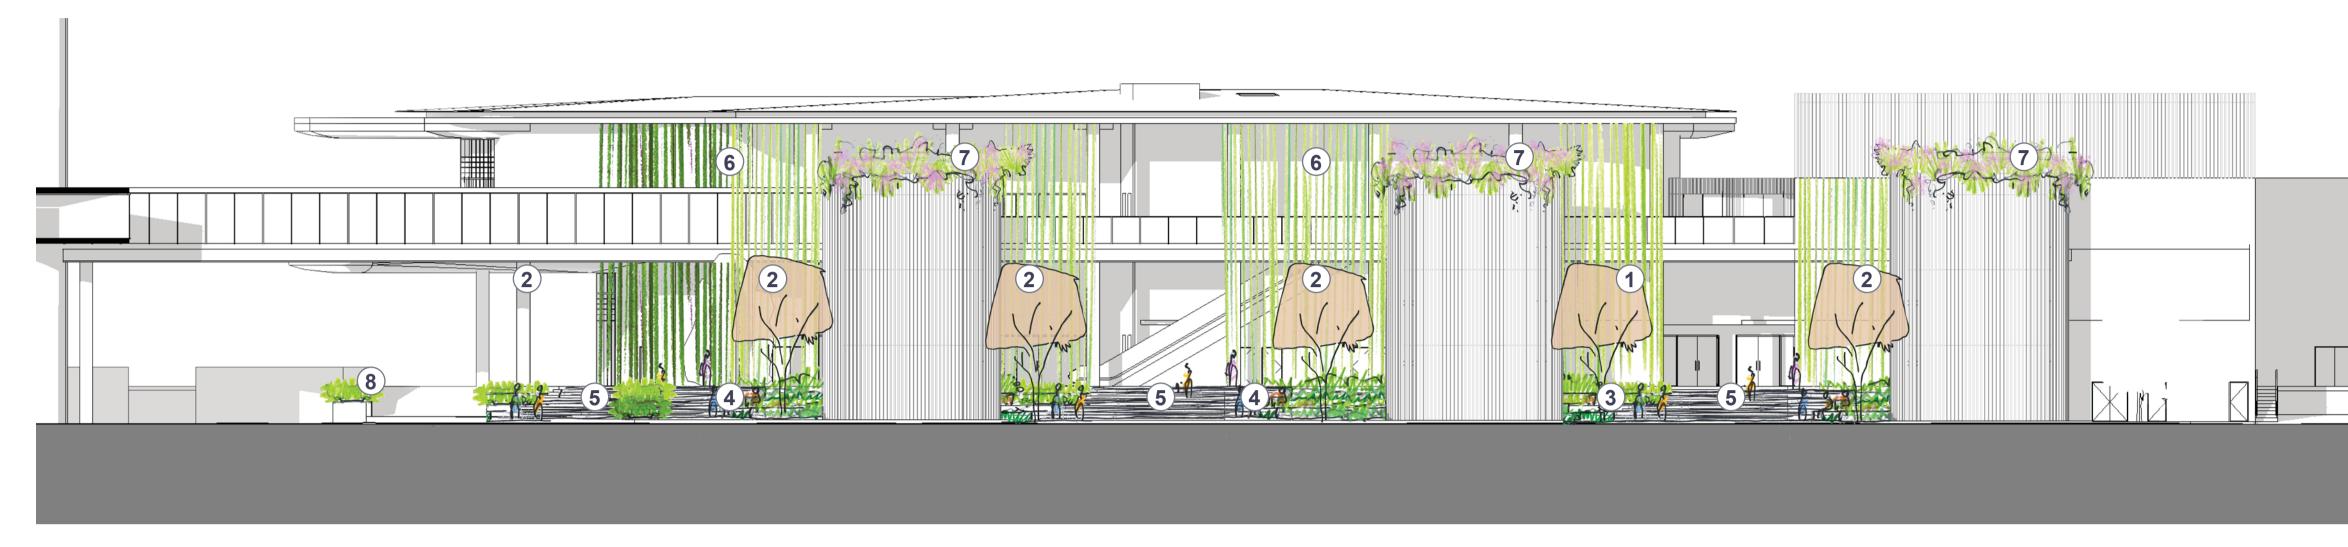Trailing plants to cascade over edges

Feature tree planting



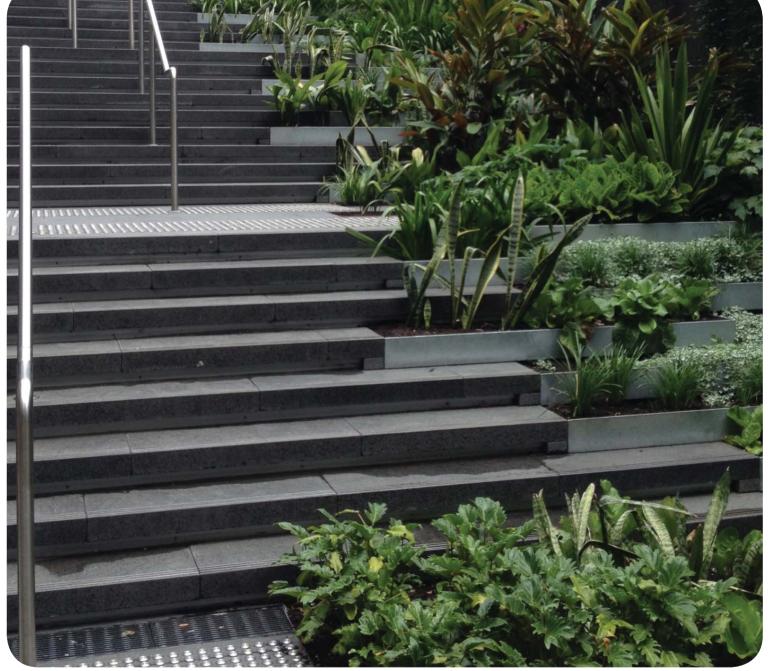

Planted terraces tie into stairs



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NOTES

- 1. Medium sized feature tree set in tree grate in paved area
- 2. Medium sized feature tree set in planting area provides seasonal interest
- 3. Inset area with 900mm high standing / leaning wall and block seats
- 4. Seating block ends to stairs provide informal seating areas
- 5. Wide entry stairs
- 6. Stainless steel cables with native vines extend from garden beds to the roof creating a flowering green curtain
- 7. Roof top planting to fire stairs. Trailing plants to cascade over edges
- 8. 1m high raised planter creates green edge to path and helps direct pedestrians toward the racetrack.



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DRAWING DESIGN ELEVATION

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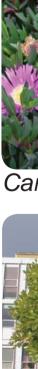
INDICATIVE PLANTING SCHEDULE

	BOTANICAL NAME	COMMON NAME	POT SIZE	SPACING	HEIGHT & WIDTH
	TREES				
STS	Stenocarpus sinuatus	Firewheel Tree	100L	A.S.	15 x 6m
	SHRUBS & GROUNDCOVERS				
	Ajuga reptans	Blue Bugle	150mm	0.3m	0.2 x 0.4m
	Buxus japonica	Japanese Box	5L	0.5m	1 x 0.5m
	Carex appressa	Tall Sedge	150mm	0.5m	0.8 x 0.7m
	Carpobrotus glaucescens	Pigface	150mm	0.3m	0.2 x 1m
	Dianella caerulea 'Little Jess'	Blue Flax-Lily	150mm	0.6m	0.4 x 0.4m
	Dichondra repens	Kidney Weed	Tube	0.2m	0.2 x 2m
	Gardenia augusta 'Magnifica'	Gardenia	5L	0.6m	1 x 0.5m
	Hibbertia scandens	Guinea flower	150mm	0.3m	4 x 1m
	<i>Liriope muscari</i> 'Evergreen Giant'	Liriope Evergreen Giant	150mm	0.5m	0.6 x 0.5m
	Lomandra longifolia 'Tanika'	Lomandra Tanika	150mm	0.5m	0.6 x 0.65m
	Rhaphiolepis indica 'Spingtime'	Indian Hawthorn	5L	0.7m	2 x 3m
	Rosa noatraum 'Carpet Rose'	Carpet Rose	5L	0.7m	0.9 x 0.9m
	Strelitzia reginae	Bird of Paradise	25L	0.6m	1.5 x 1.5m
	Trachelospermum jasminoides	Star Jasmine	5L	0.5m	0.6 x 1m
_	Viola hederacea	Native Violet	Tube	0.2m	0.13 x 1m



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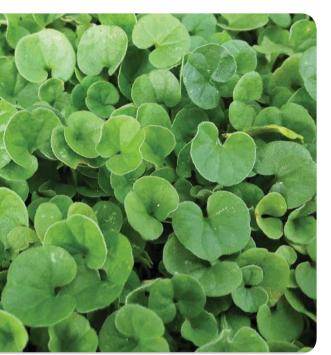
PLANTING



Hibbertia scandens



Trachelospermum jasminoides



Dichondra repens



Carpobrotus glaucescens



Stenocarpus sinuatus



Lomandra longifolia 'Tanika'



Viola hederacea



Dianella caerulea 'Little Jess'



Ajuga reptans




Gardenia augusta 'Magnifica'


PRECEDENT IMAGES



Two-tone paving

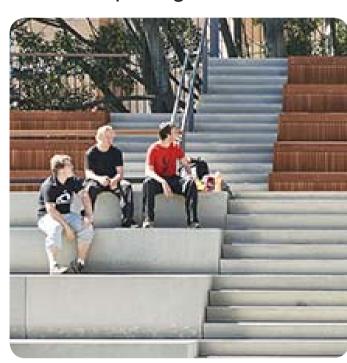

Seating steps

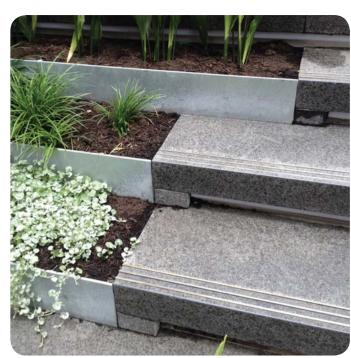





Terraced steps




Layered planting



Concrete seating wall





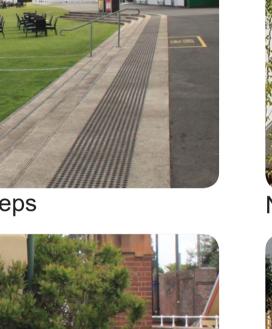

Planting terraces

Planting and seating steps



Native vines to steel cables

Green roof to fire stairs

Raised concrete planter



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DRAWING INDICATIVE PLANTING SCHEDULE

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