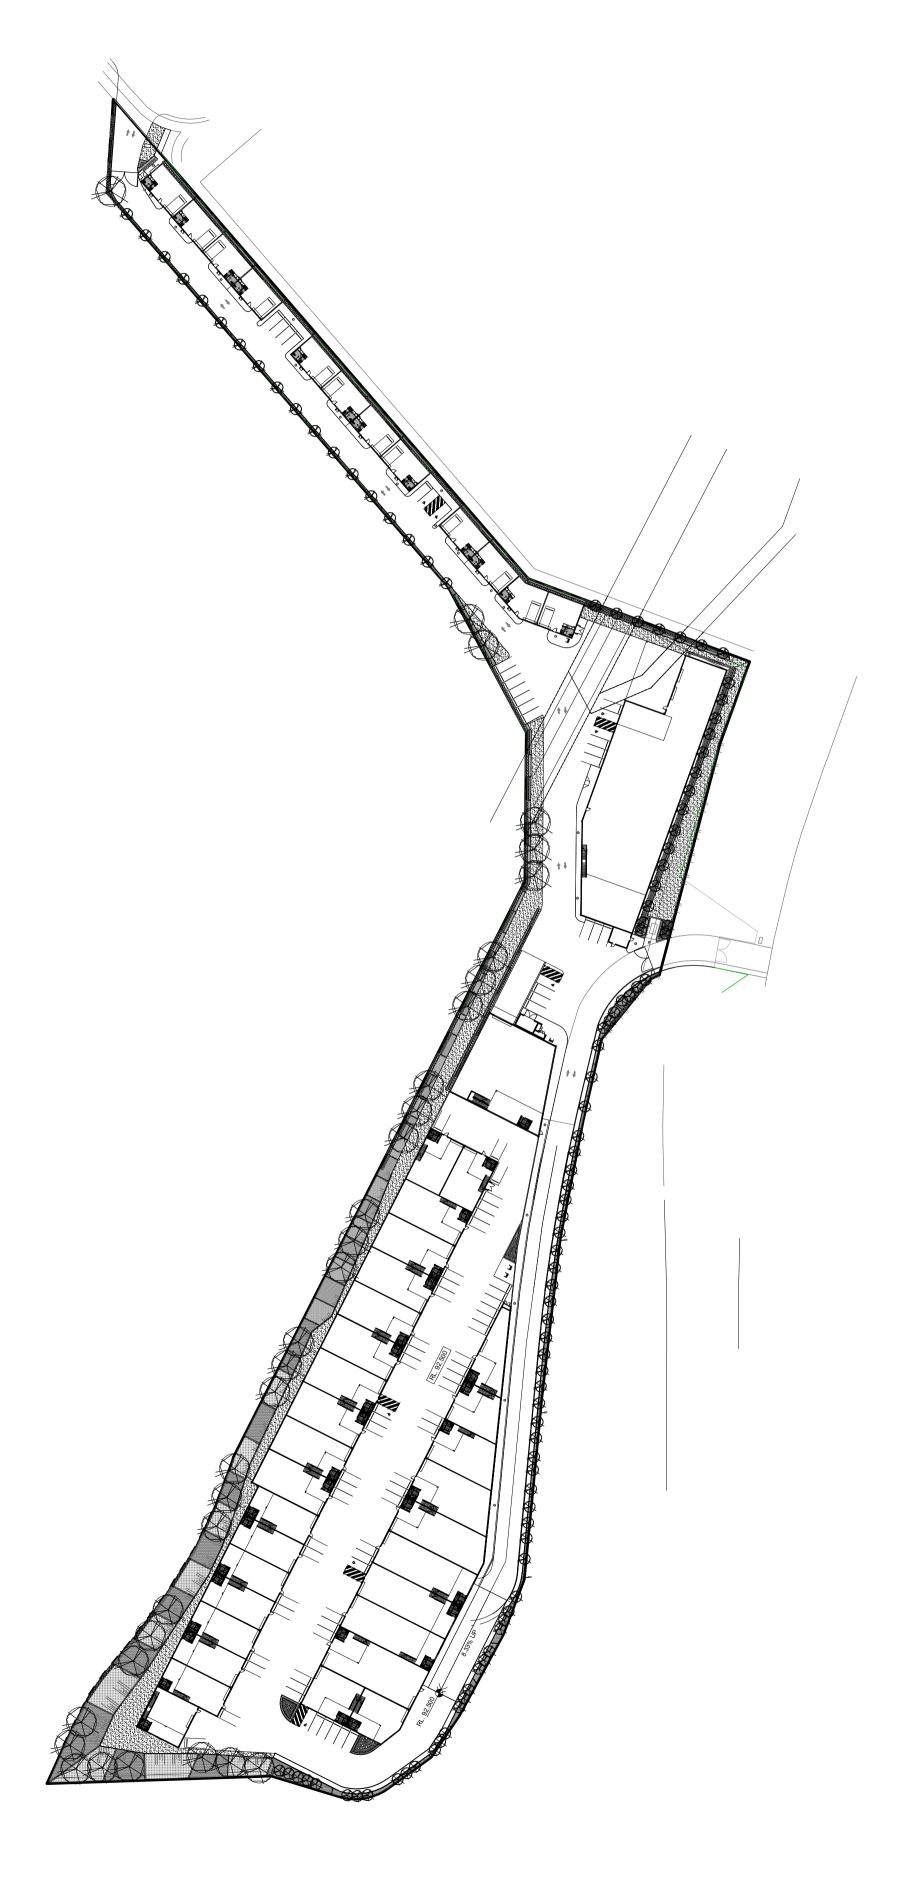
HANNAS Prospect Highway Greystanes

Lot 37 Prospect Highway, Greystanes NSW

Development Application

# **DRAWINGS**

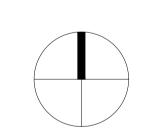
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000	COVER SHEET	
100	COLOUR LANDSCAPE PLAN	
101	LANDSCAPE PLAN 1	1:150
102	LANDSCAPE PLAN 2	1:150
103	LANDSCAPE PLAN 3	1:150
104	LANDSCAPE PLAN 4	1:150
105	LANDSCAPE PLAN 5	1:150
106	LANDSCAPE PLAN 6	1:150
107	LANDSCAPE PLAN 7	1:150
500	LANDSCAPE SPECIFICATIONS & PLANTING SCHEDULE	
502	LANDSCAPE DETAILS	AS SHOWN



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LEGEND



Hannas

Hannas Prospect Highway Greystanes

Lot 37 Prospect Highway, Greystanes NSW

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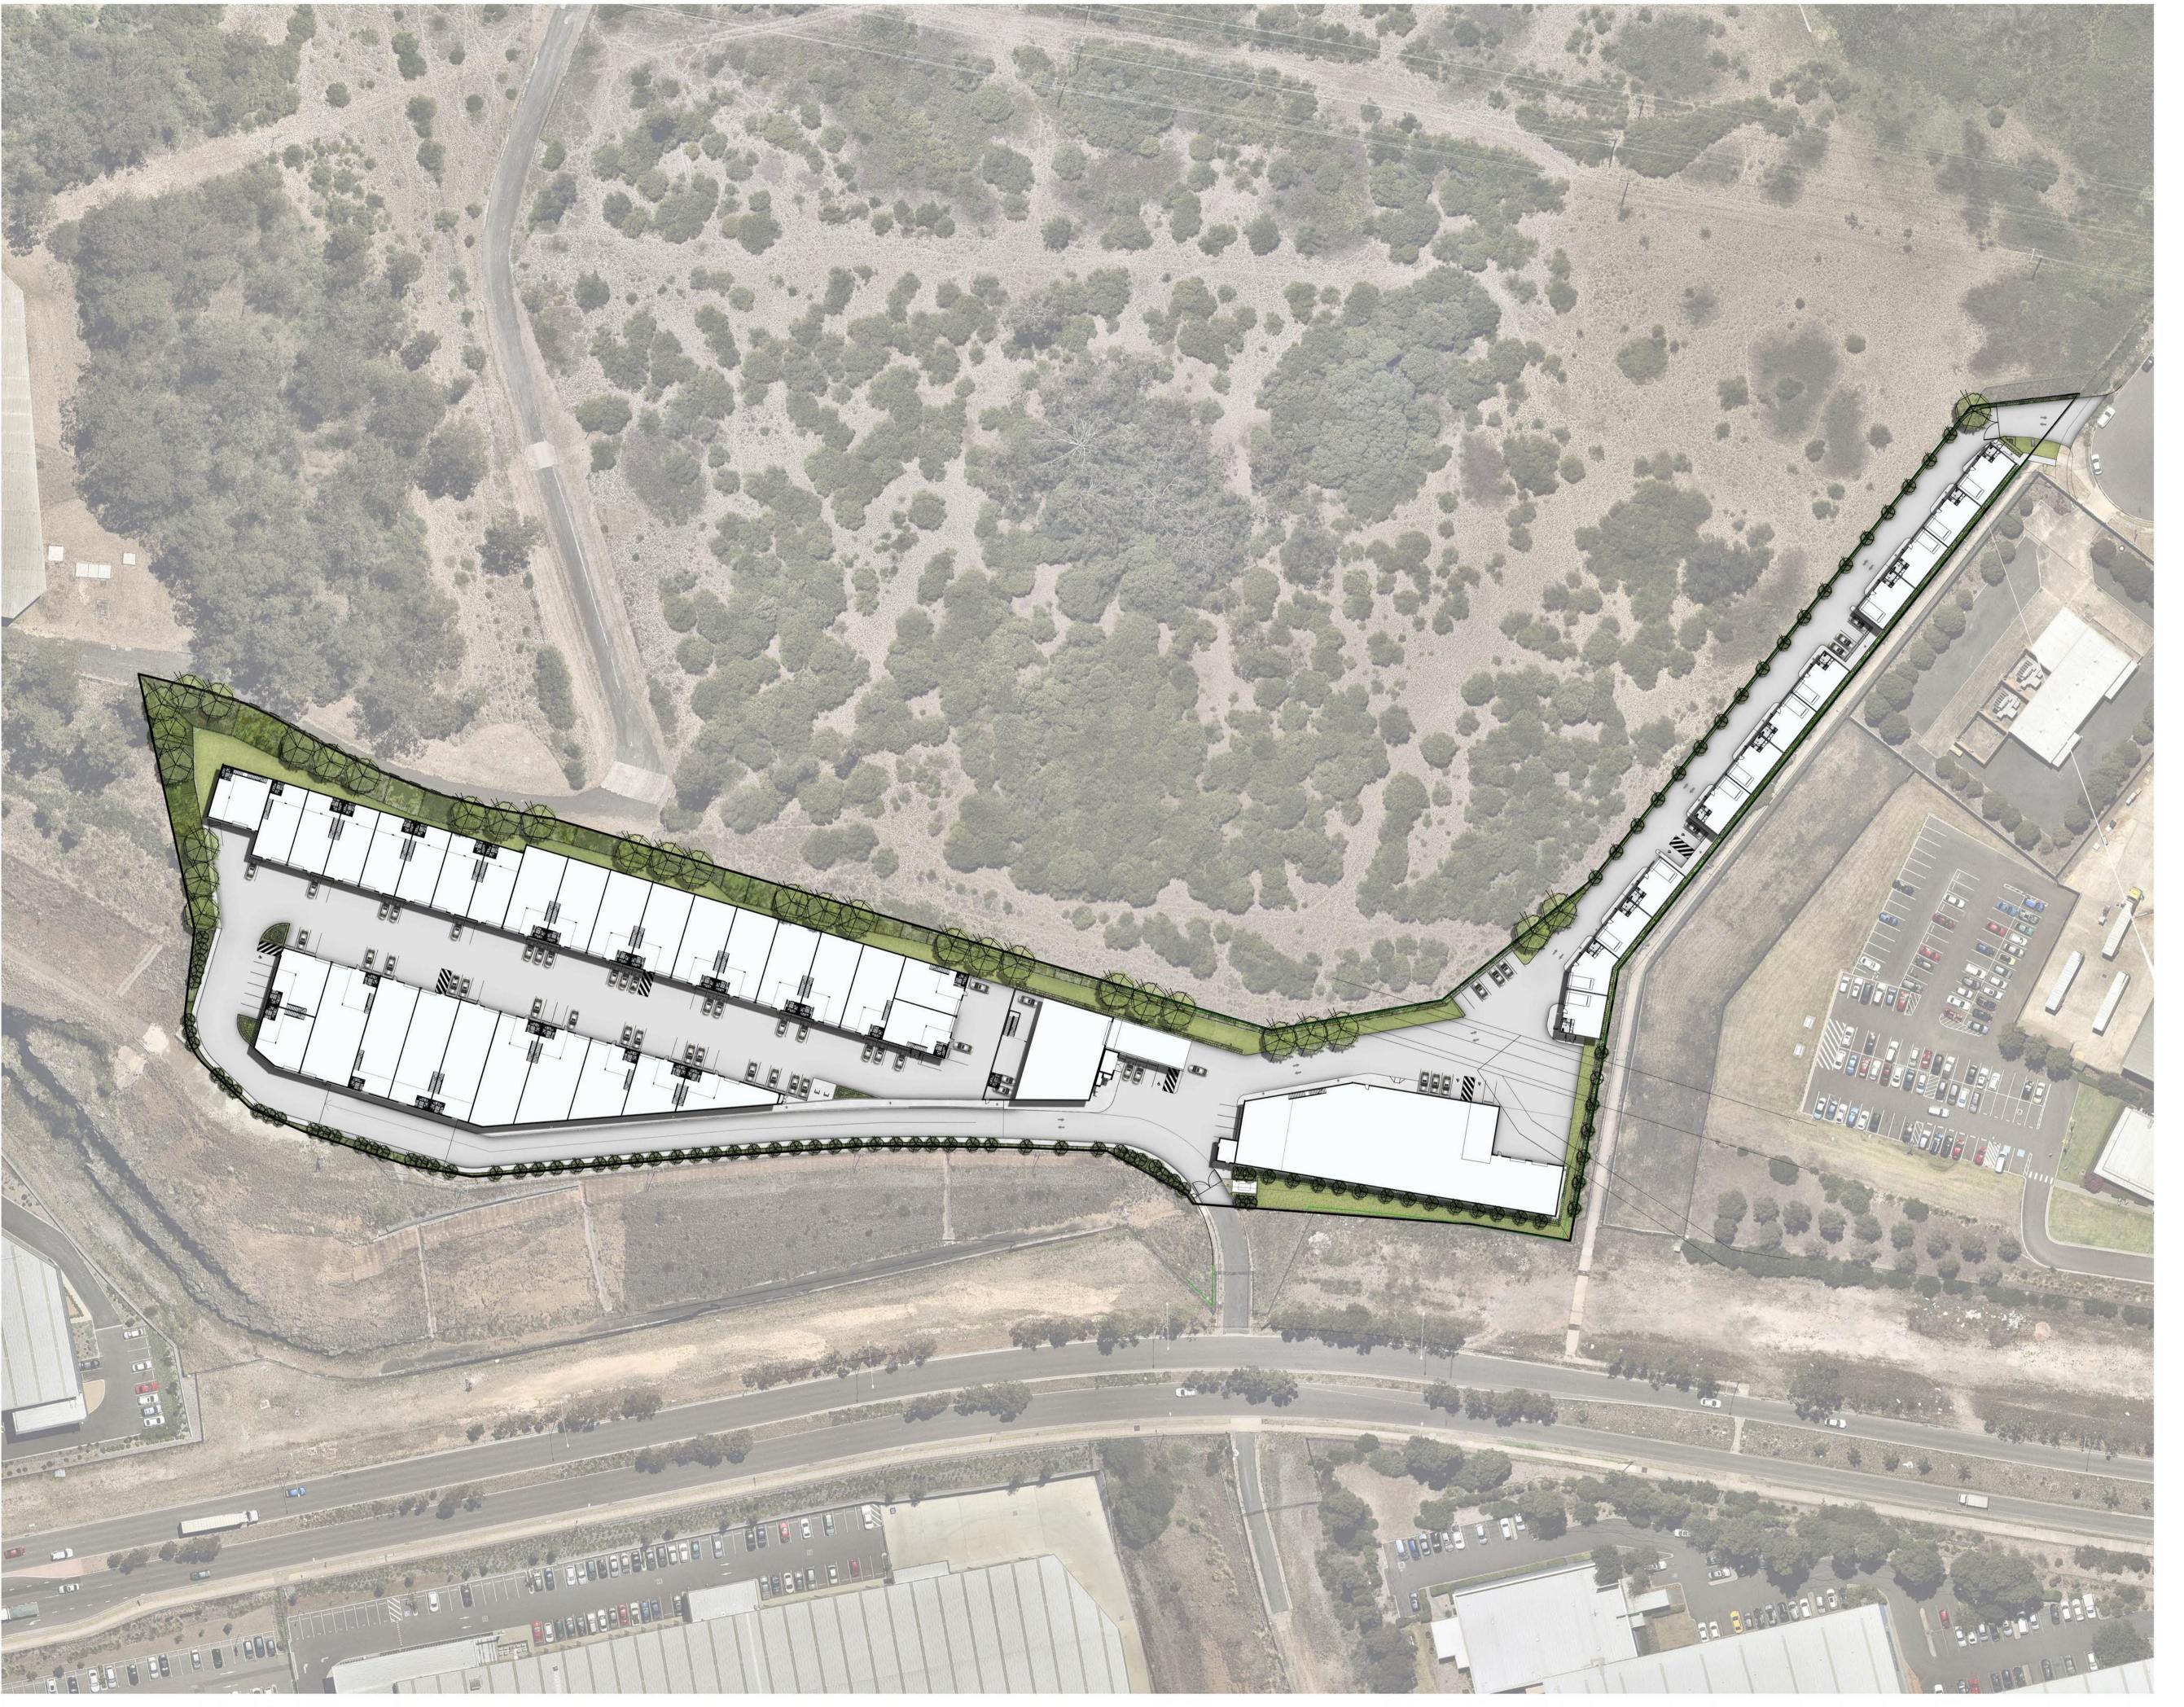
SITE IMAGE

# **DEVELOPMENT APPLICATION**

Drawing Name: **Cover Sheet** 

Scale: 1:1000 @ A1 000 E

SS17-3706



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NP RS 07.06.2019 Development Application **Development Application** NP RS 13.05.2019 NP RS 11.04.2018 Amended DA **Development Application** NH RS 07.02.2018 NH RS 05.02.2018 A Development Application Issue Revision Description Drawn Check Date

### **LEGEND**

**Proposed Trees** (Refer to Plant Schedule)

Proposed Accent & Shrubs

(Refer to Plant Schedule)

**Batter Planting** 

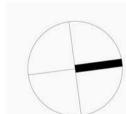
Proposed Groundcovers (Refer to Plant Schedule)

(Refer to Plant Schedule)

Insitu Concrete Path (Refer to Details)



Pebble Path (Refer to Details)



Hannas

# Hannas Prospect Highway Greystanes

Lot 37 Prospect Highway, Greystanes NSW

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DEVELOPMENT APPLICATION

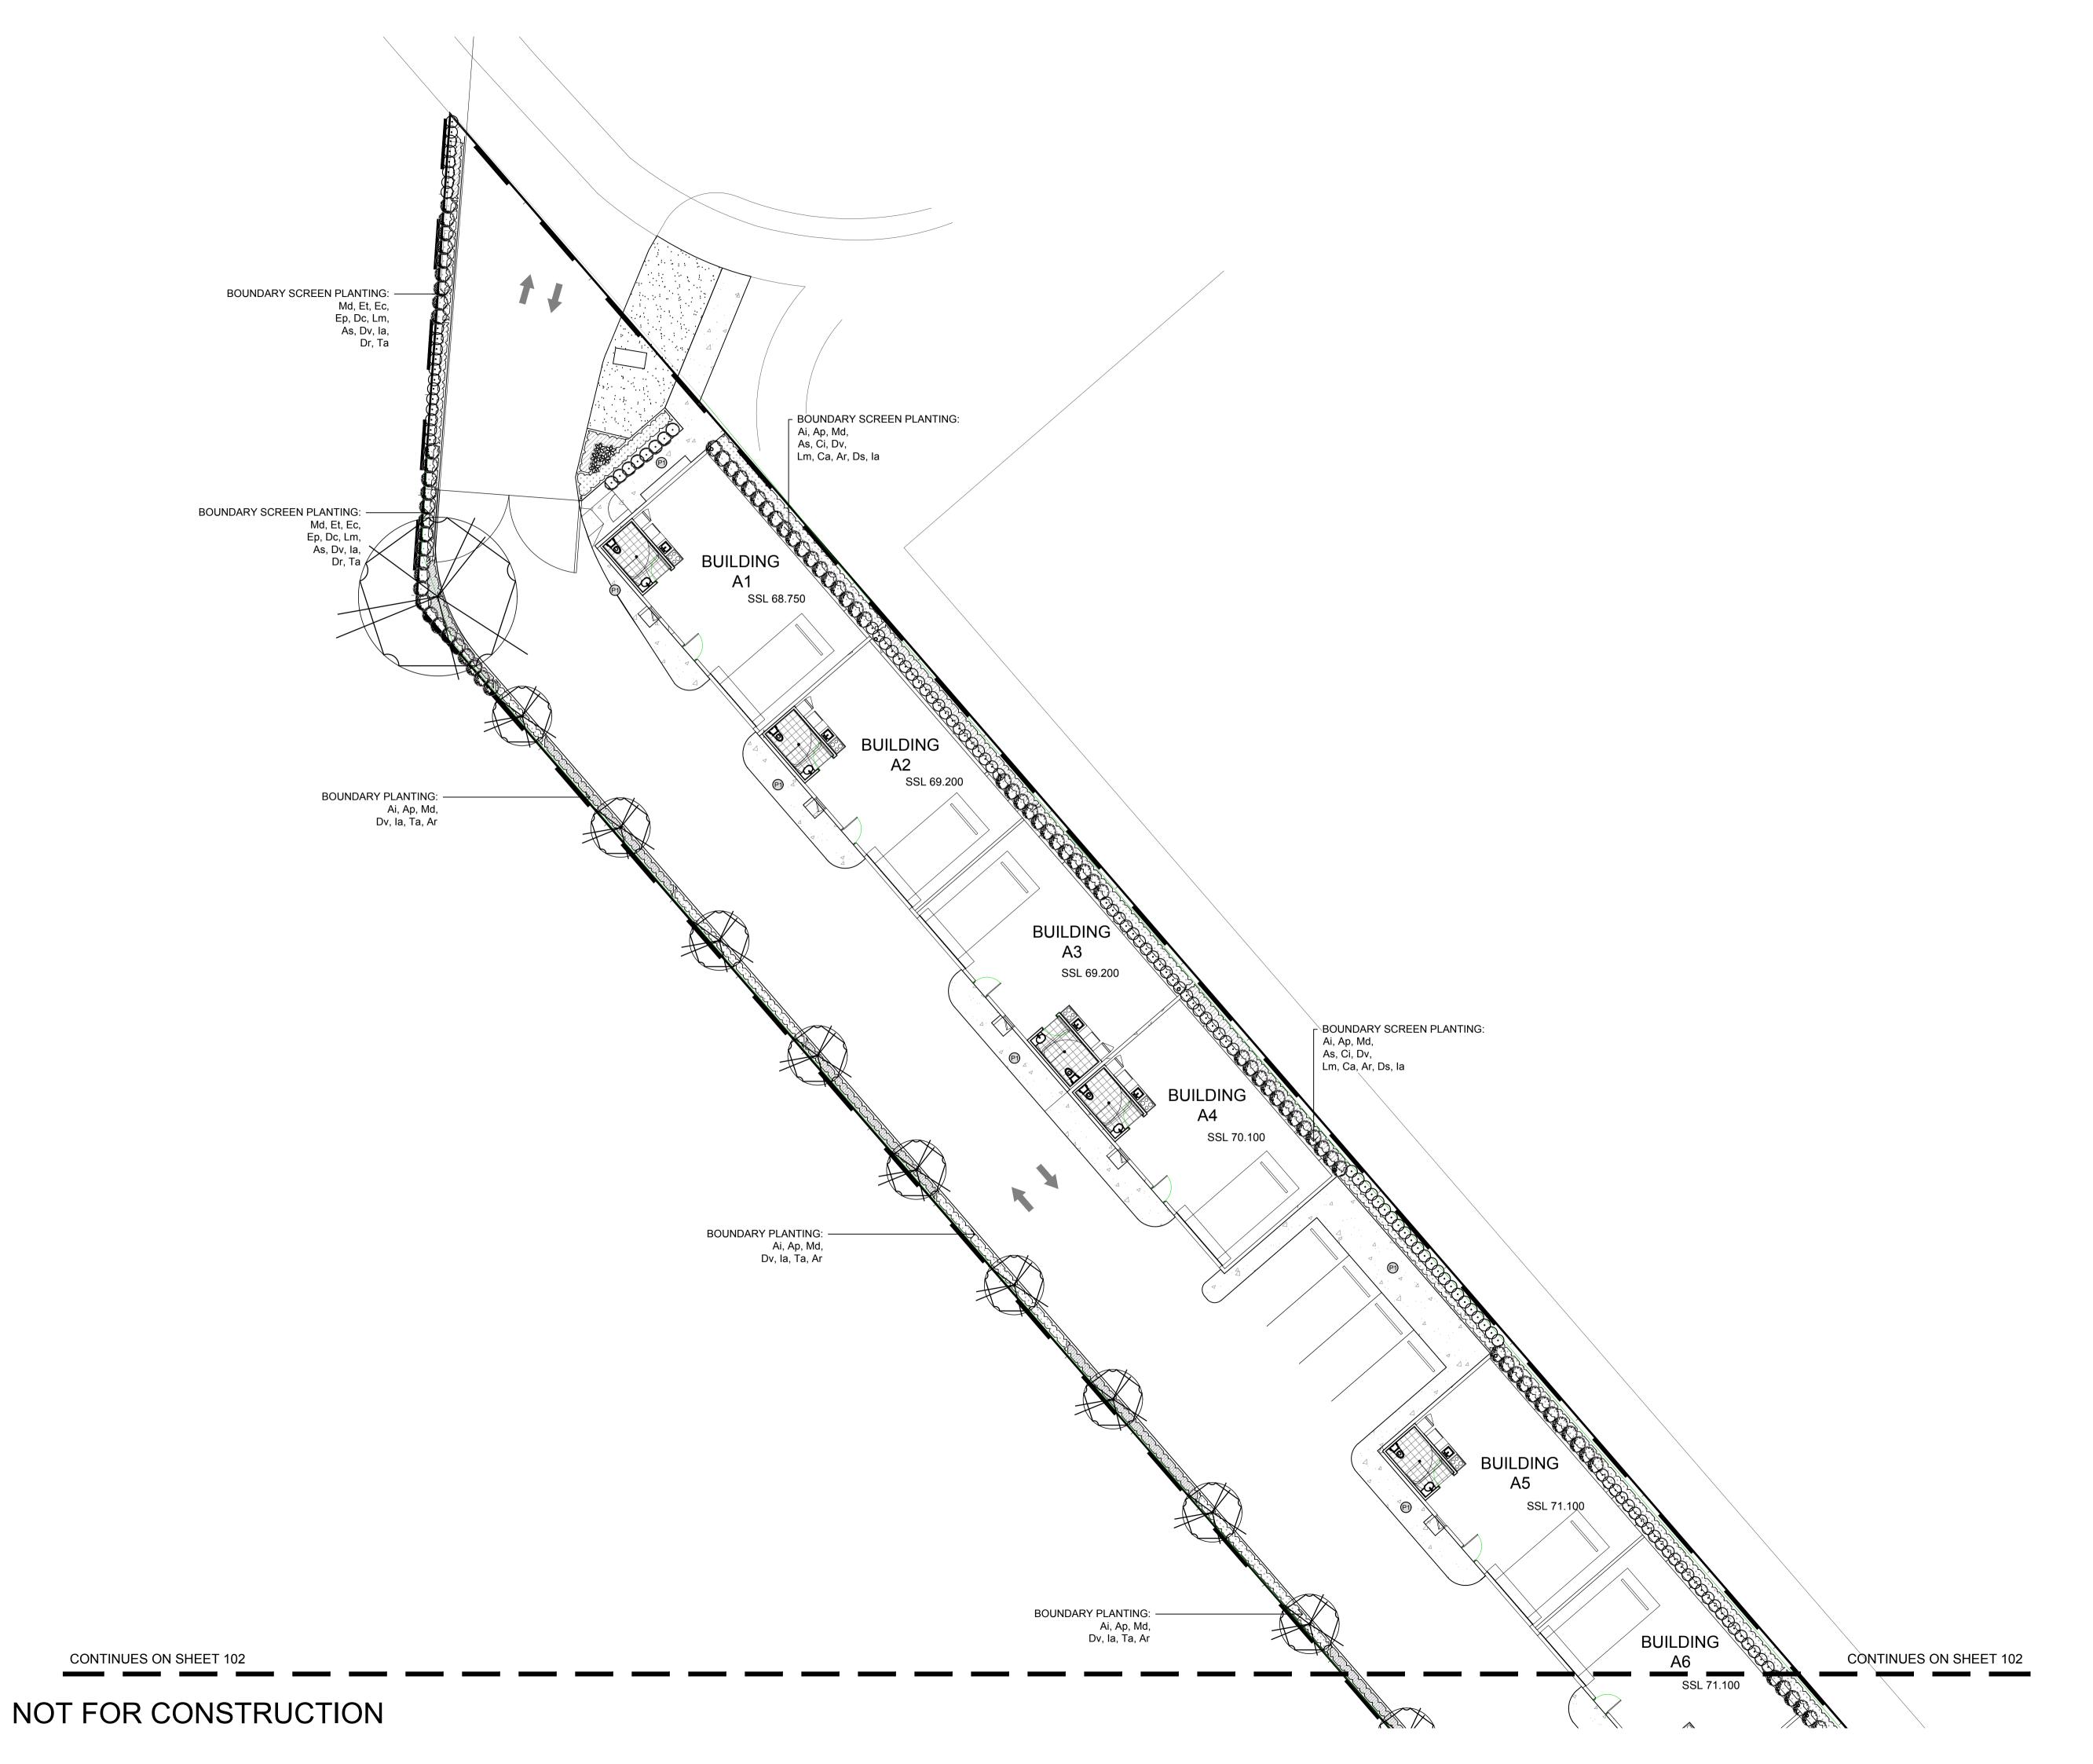
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Colour Landscape Plan

Scale: NTS Job Number:

C-100 E

SS17-3706



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E Development Application NP RS 07.06.2019 NP RS 13.05.2019 D Development Application C Amended DA NP RS 11.04.2018 B Development Application NH RS 07.02.2018 A Development Application NH RS 05.02.2018 Issue Revision Description Drawn Check Date

#### LEGEND



Proposed Trees (Refer to Plant Schedule)

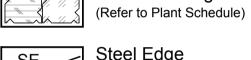


Proposed Accent & Shrubs (Refer to Plant Schedule)



(Refer to Plant Schedule) Batter Planting

Proposed Groundcovers



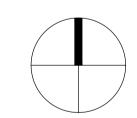
Steel Edge (Refer to Details)



P1 Insitu Concrete Path (Refer to Details)



Pebble Path (Refer to Details)



Hannas

# Hannas Prospect Highway Greystanes

Lot 37 Prospect Highway, Greystanes NSW

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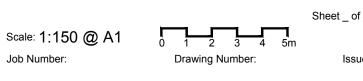


SITE IMAGE

# DEVELOPMENT APPLICATION

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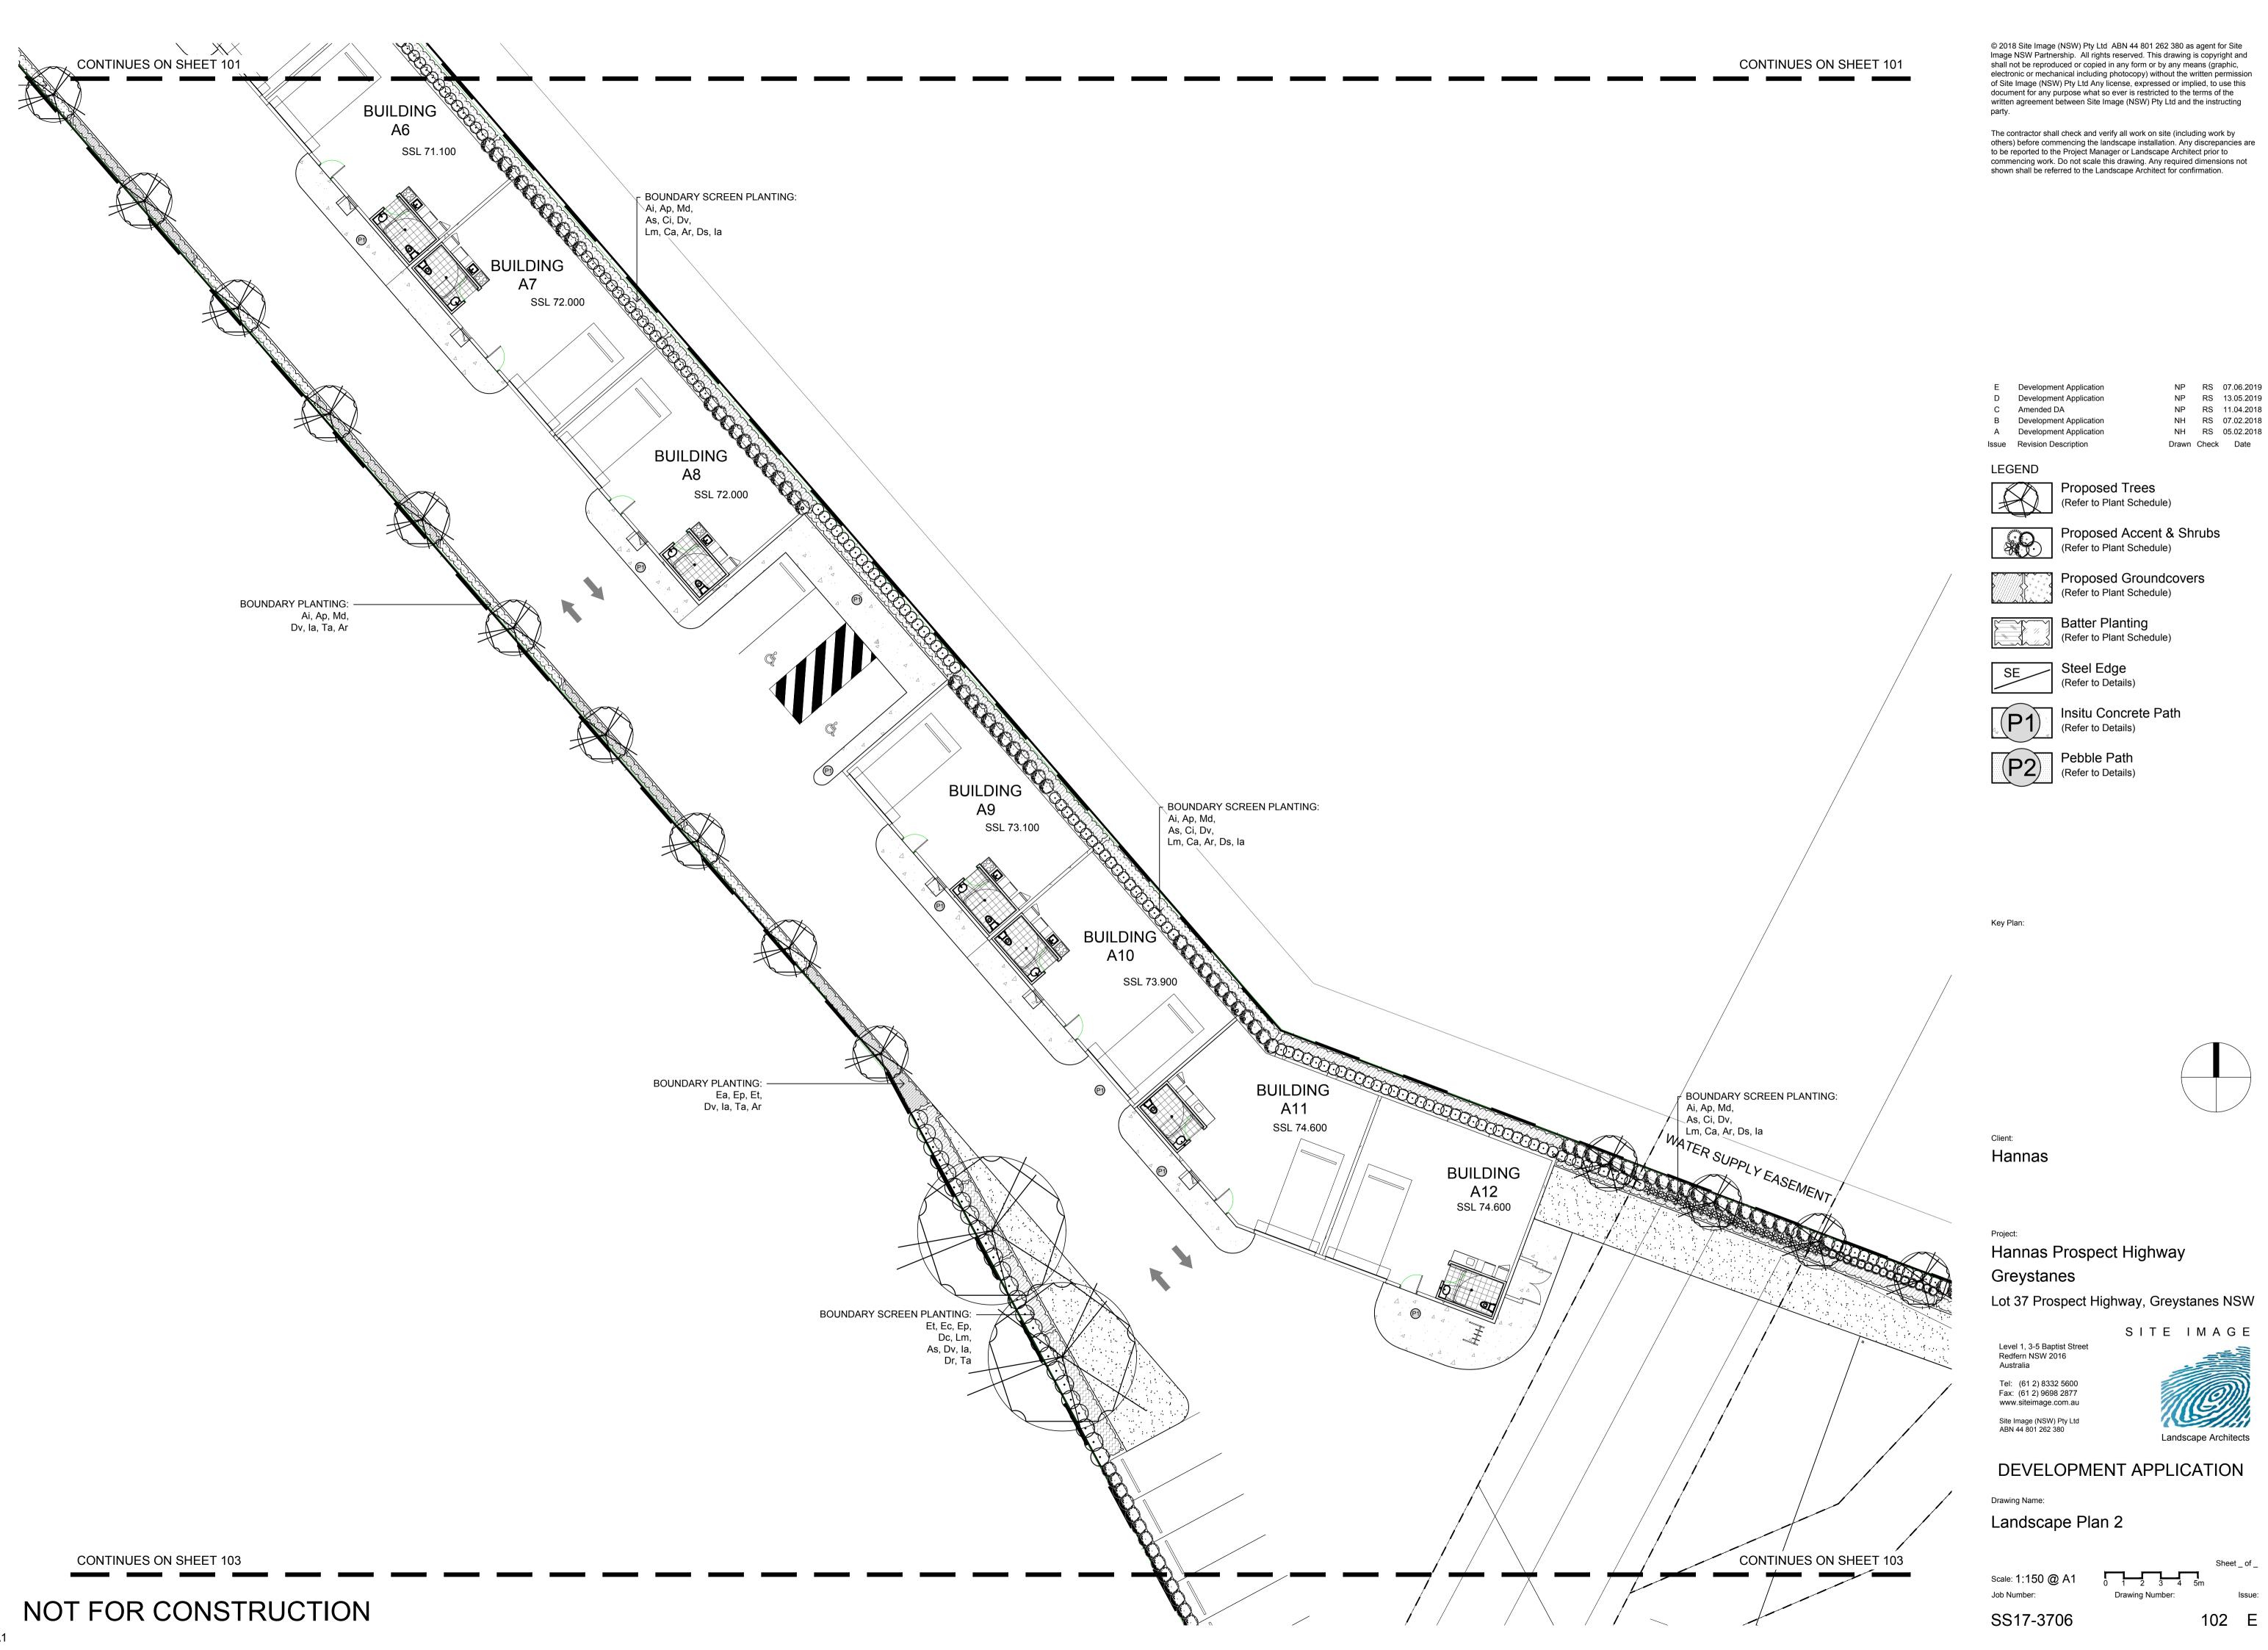
Landscape Plan 1



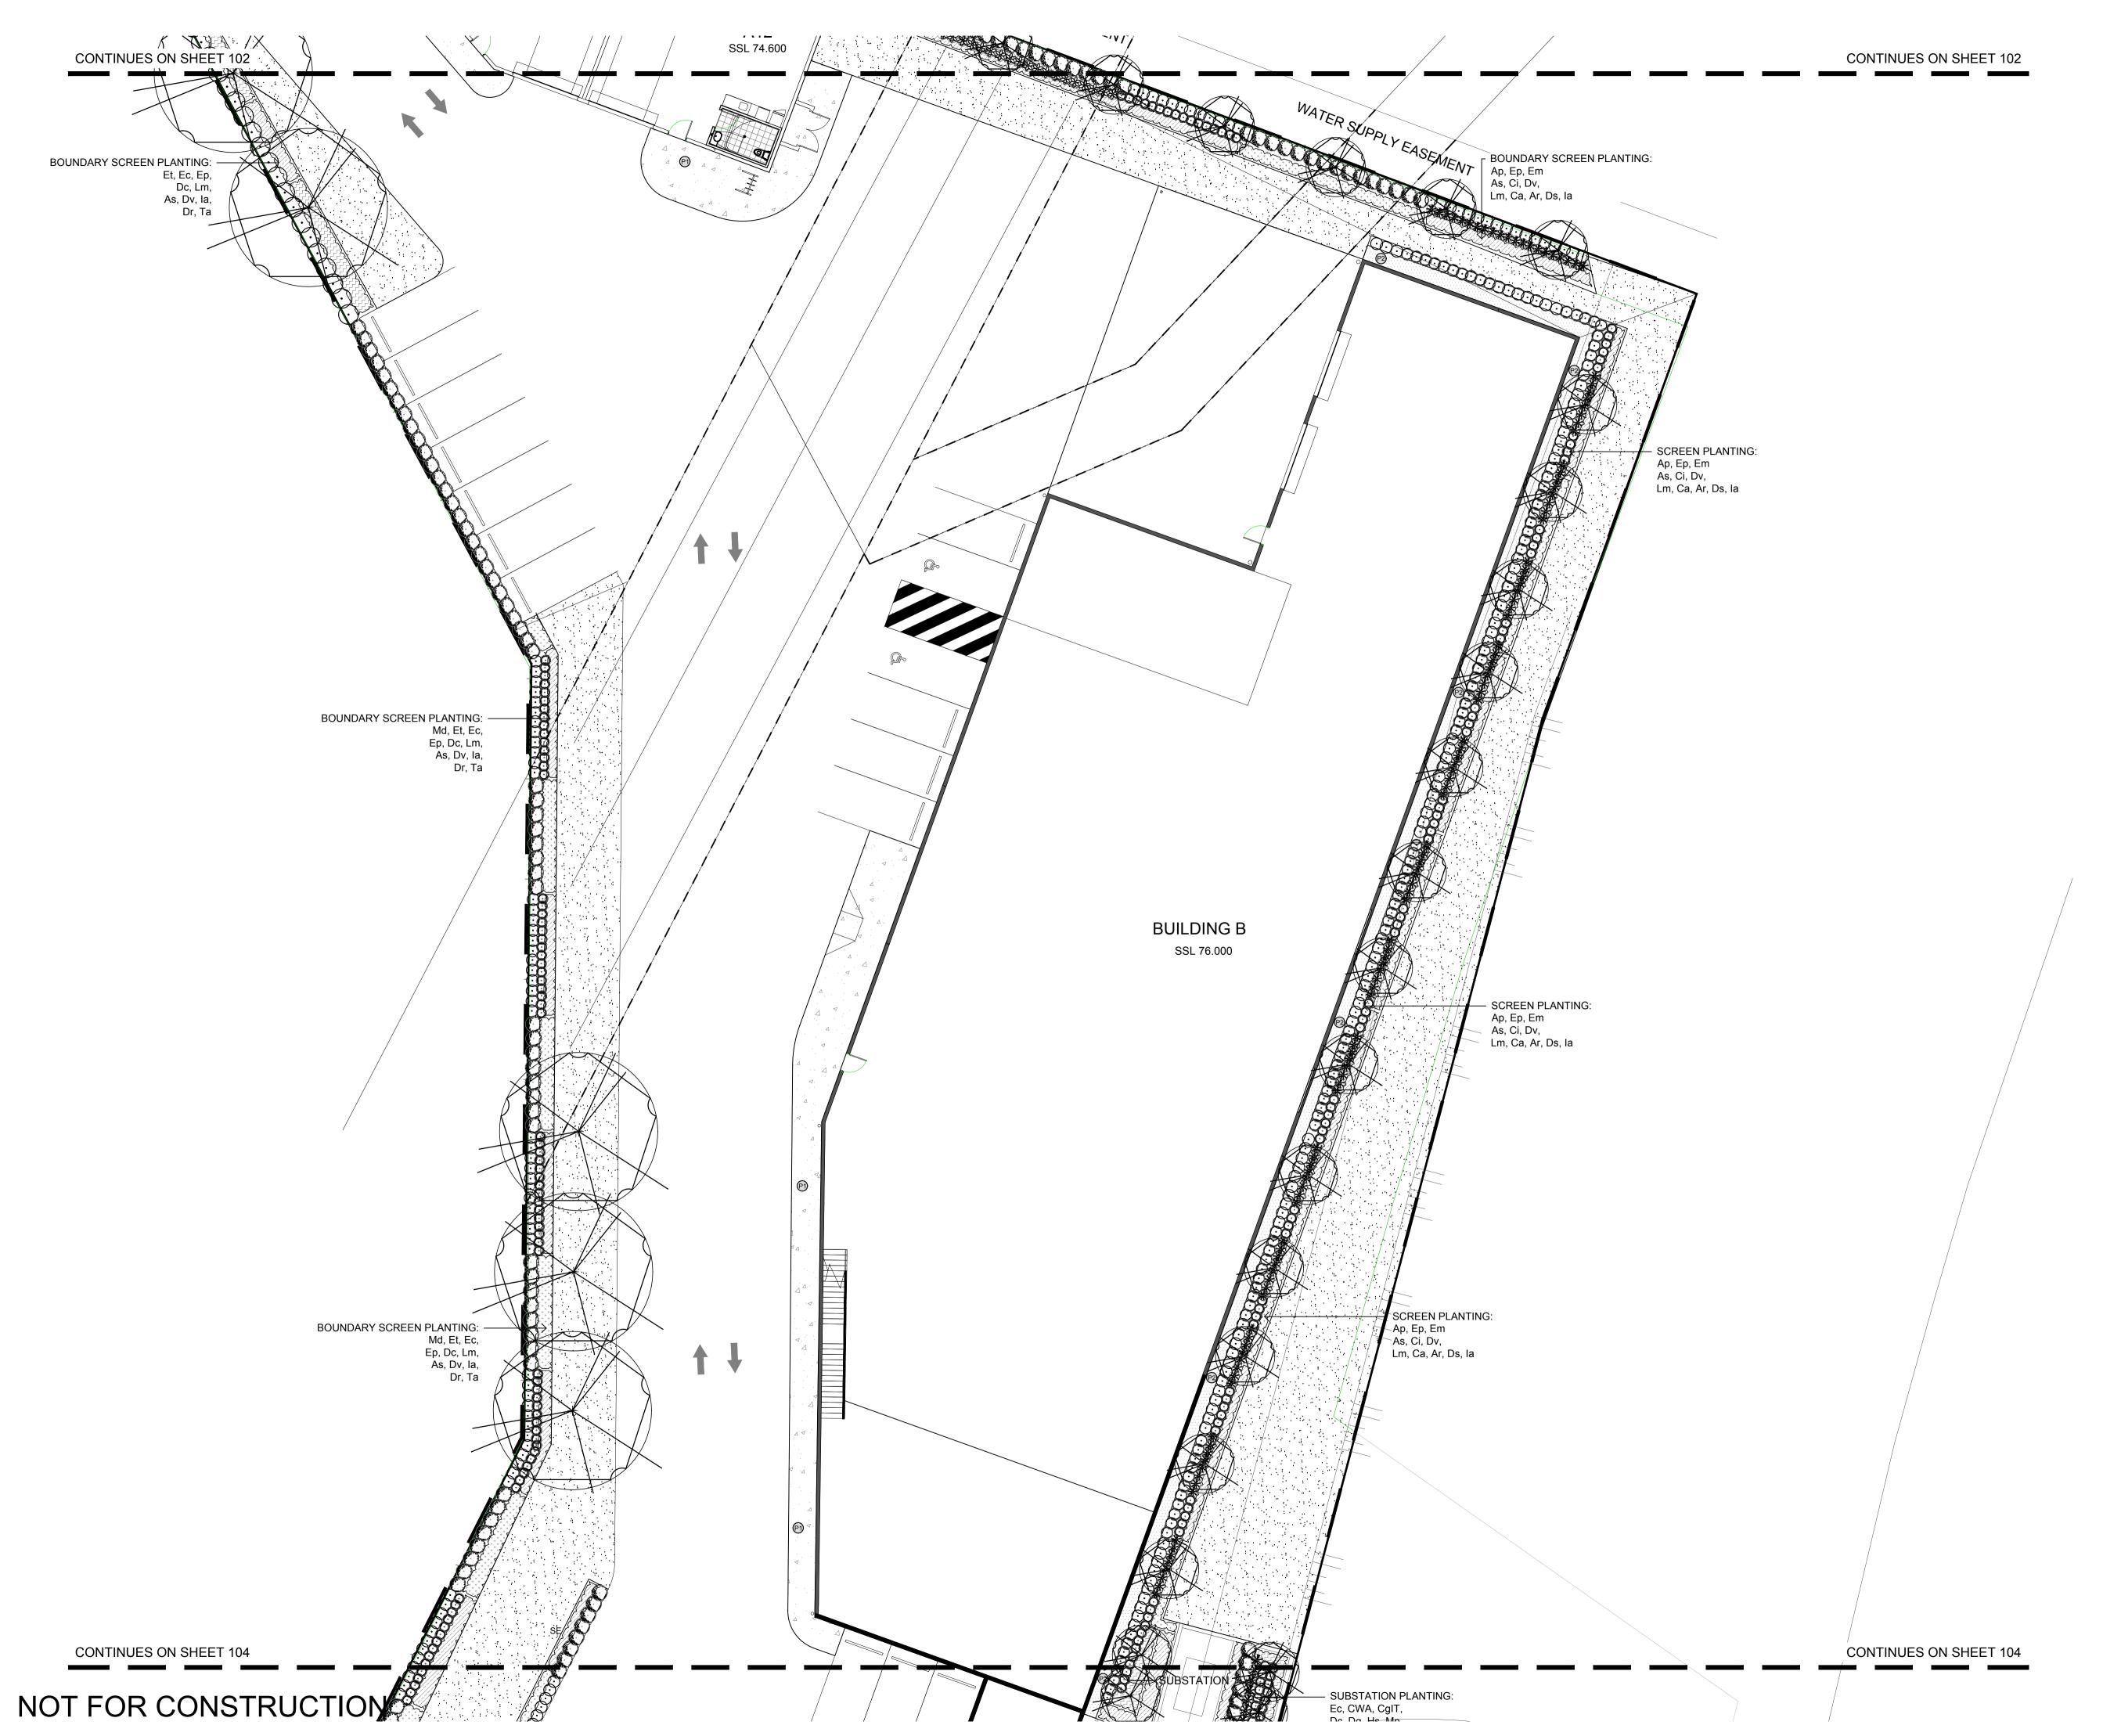
SS17-3706

Job Number:

101 E



А



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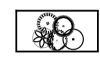
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NP RS 07.06.2019 Development Application **Development Application** NP RS 13.05.2019 Amended DA NP RS 11.04.2018 B Development Application NH RS 07.02.2018 NH RS 05.02.2018 A Development Application Drawn Check Date Issue Revision Description

#### LEGEND



Proposed Trees (Refer to Plant Schedule)



Proposed Accent & Shrubs (Refer to Plant Schedule)



Proposed Groundcovers (Refer to Plant Schedule)

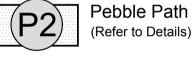


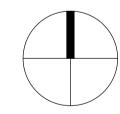
Steel Edge (Refer to Details)

**Batter Planting** (Refer to Plant Schedule)



Insitu Concrete Path (Refer to Details)





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Lot 37 Prospect Highway, Greystanes NSW

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DEVELOPMENT APPLICATION

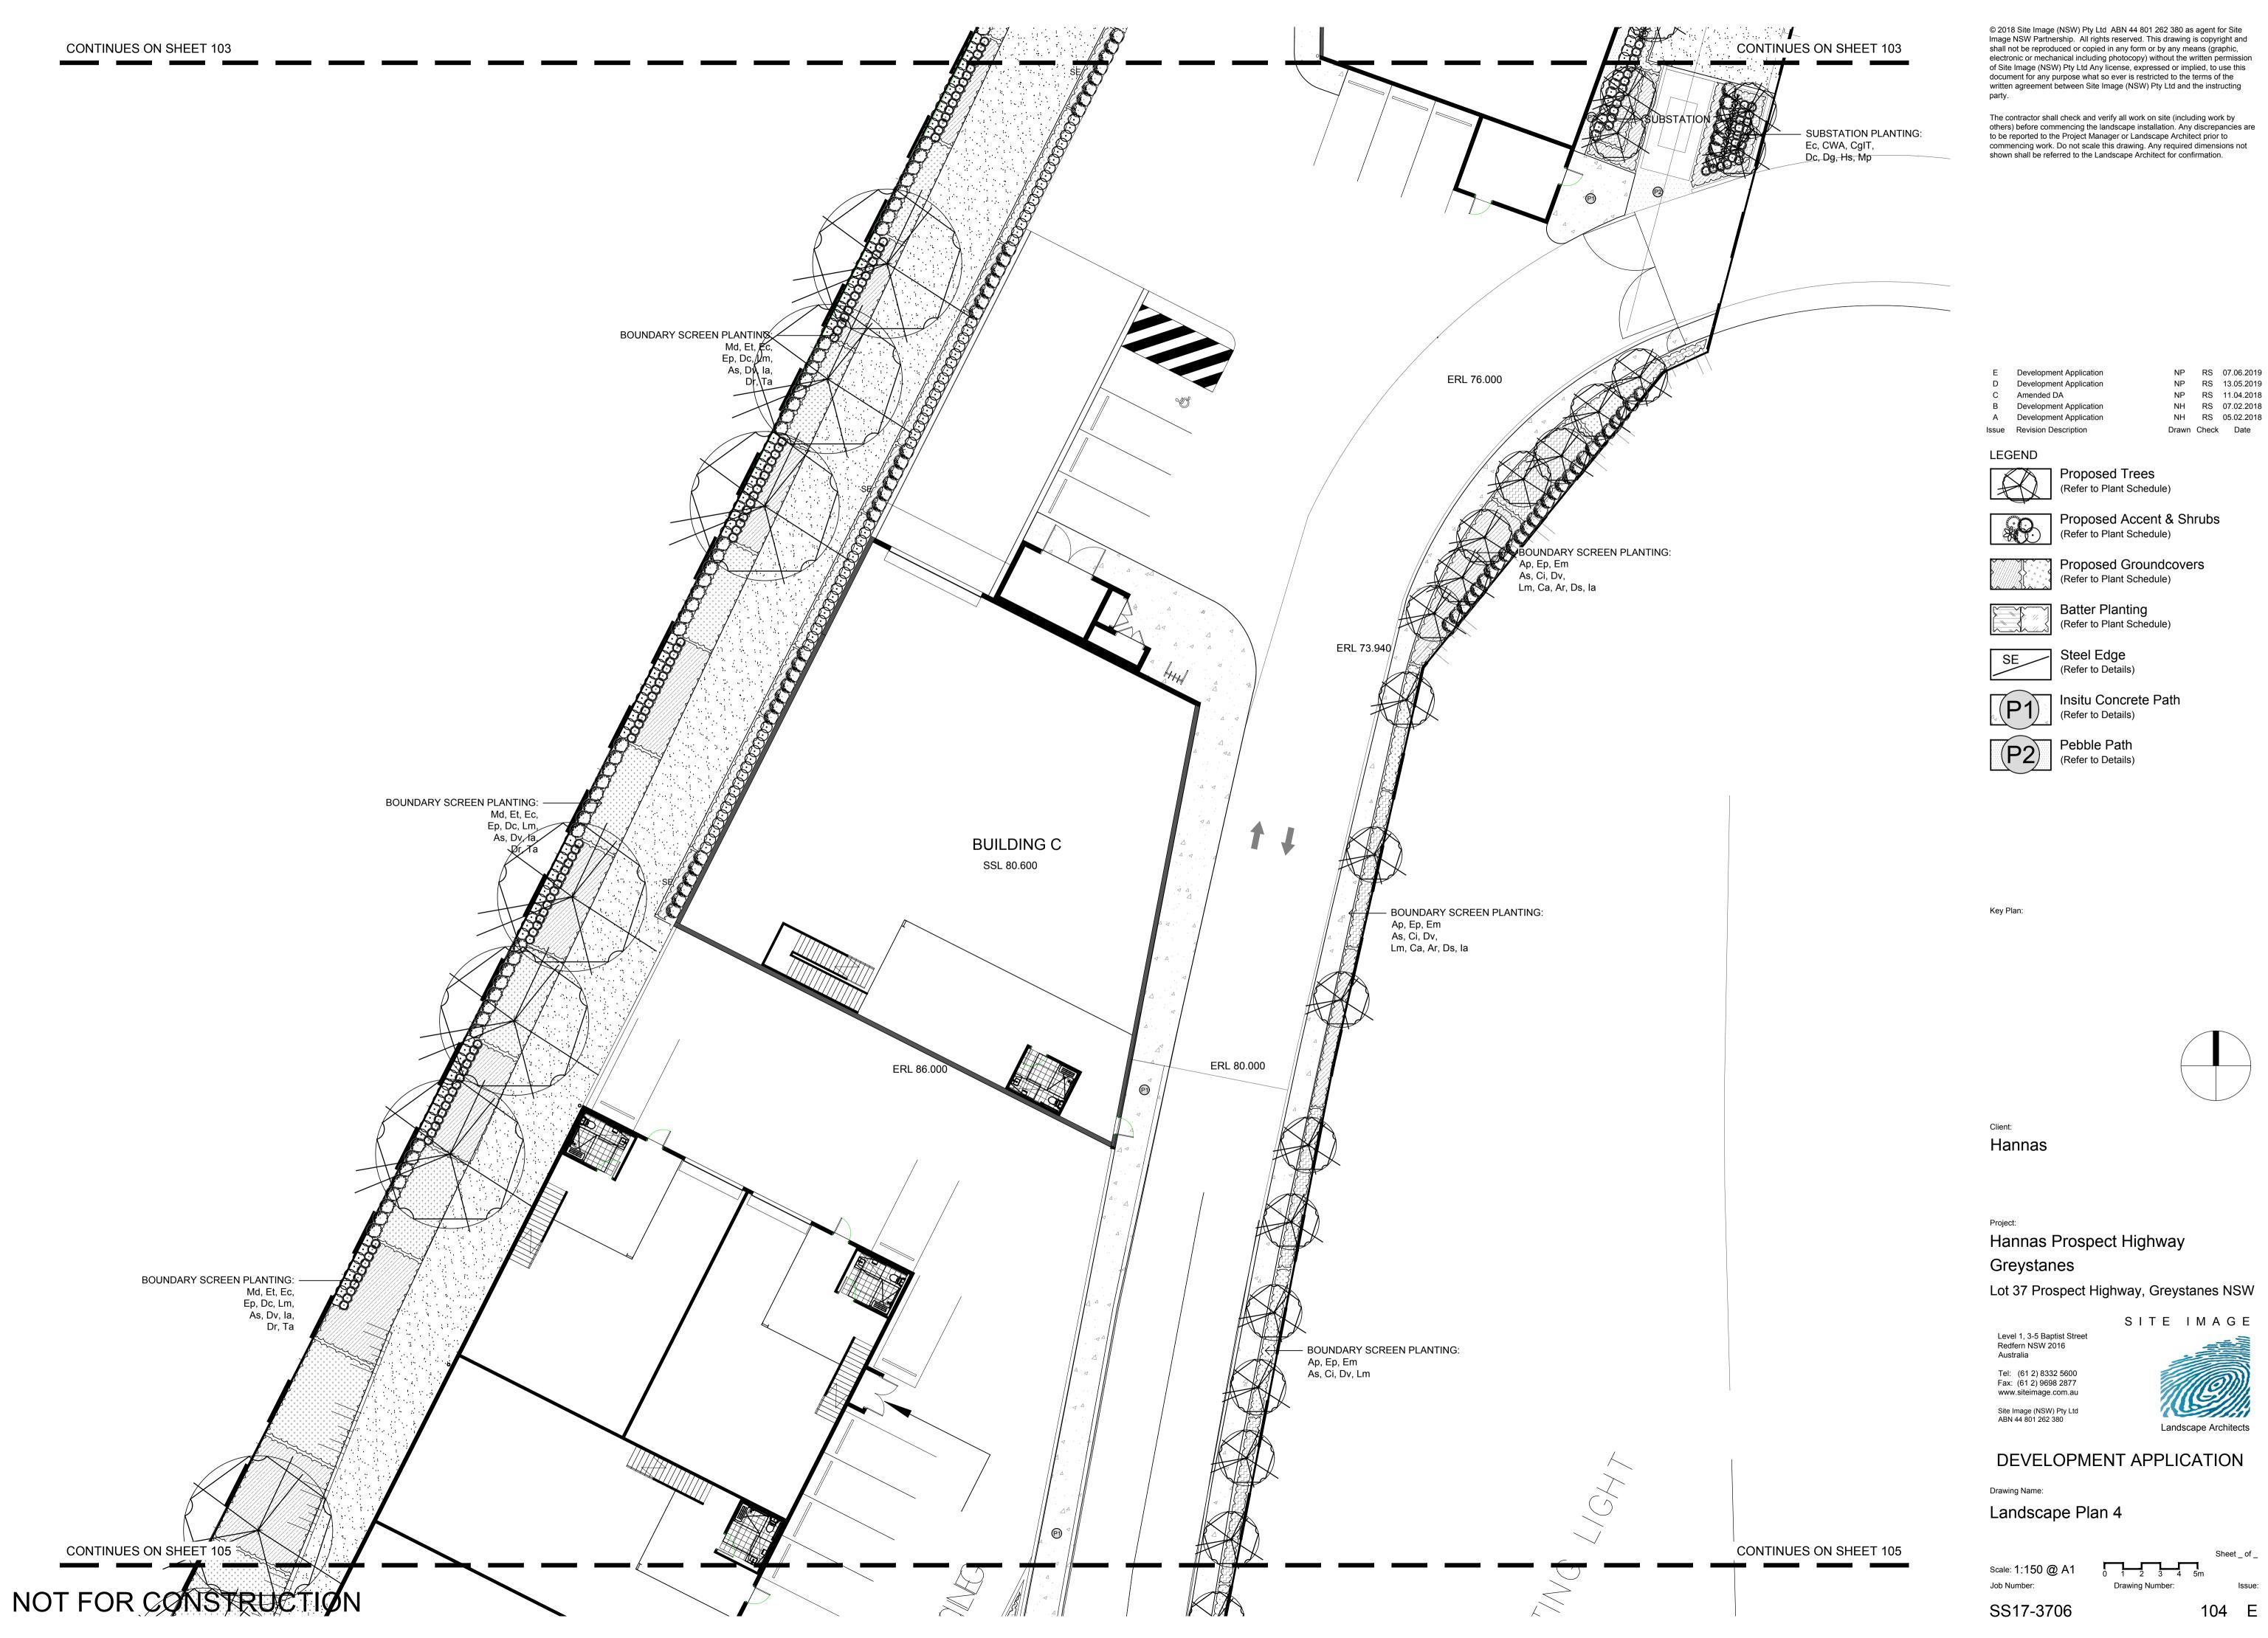
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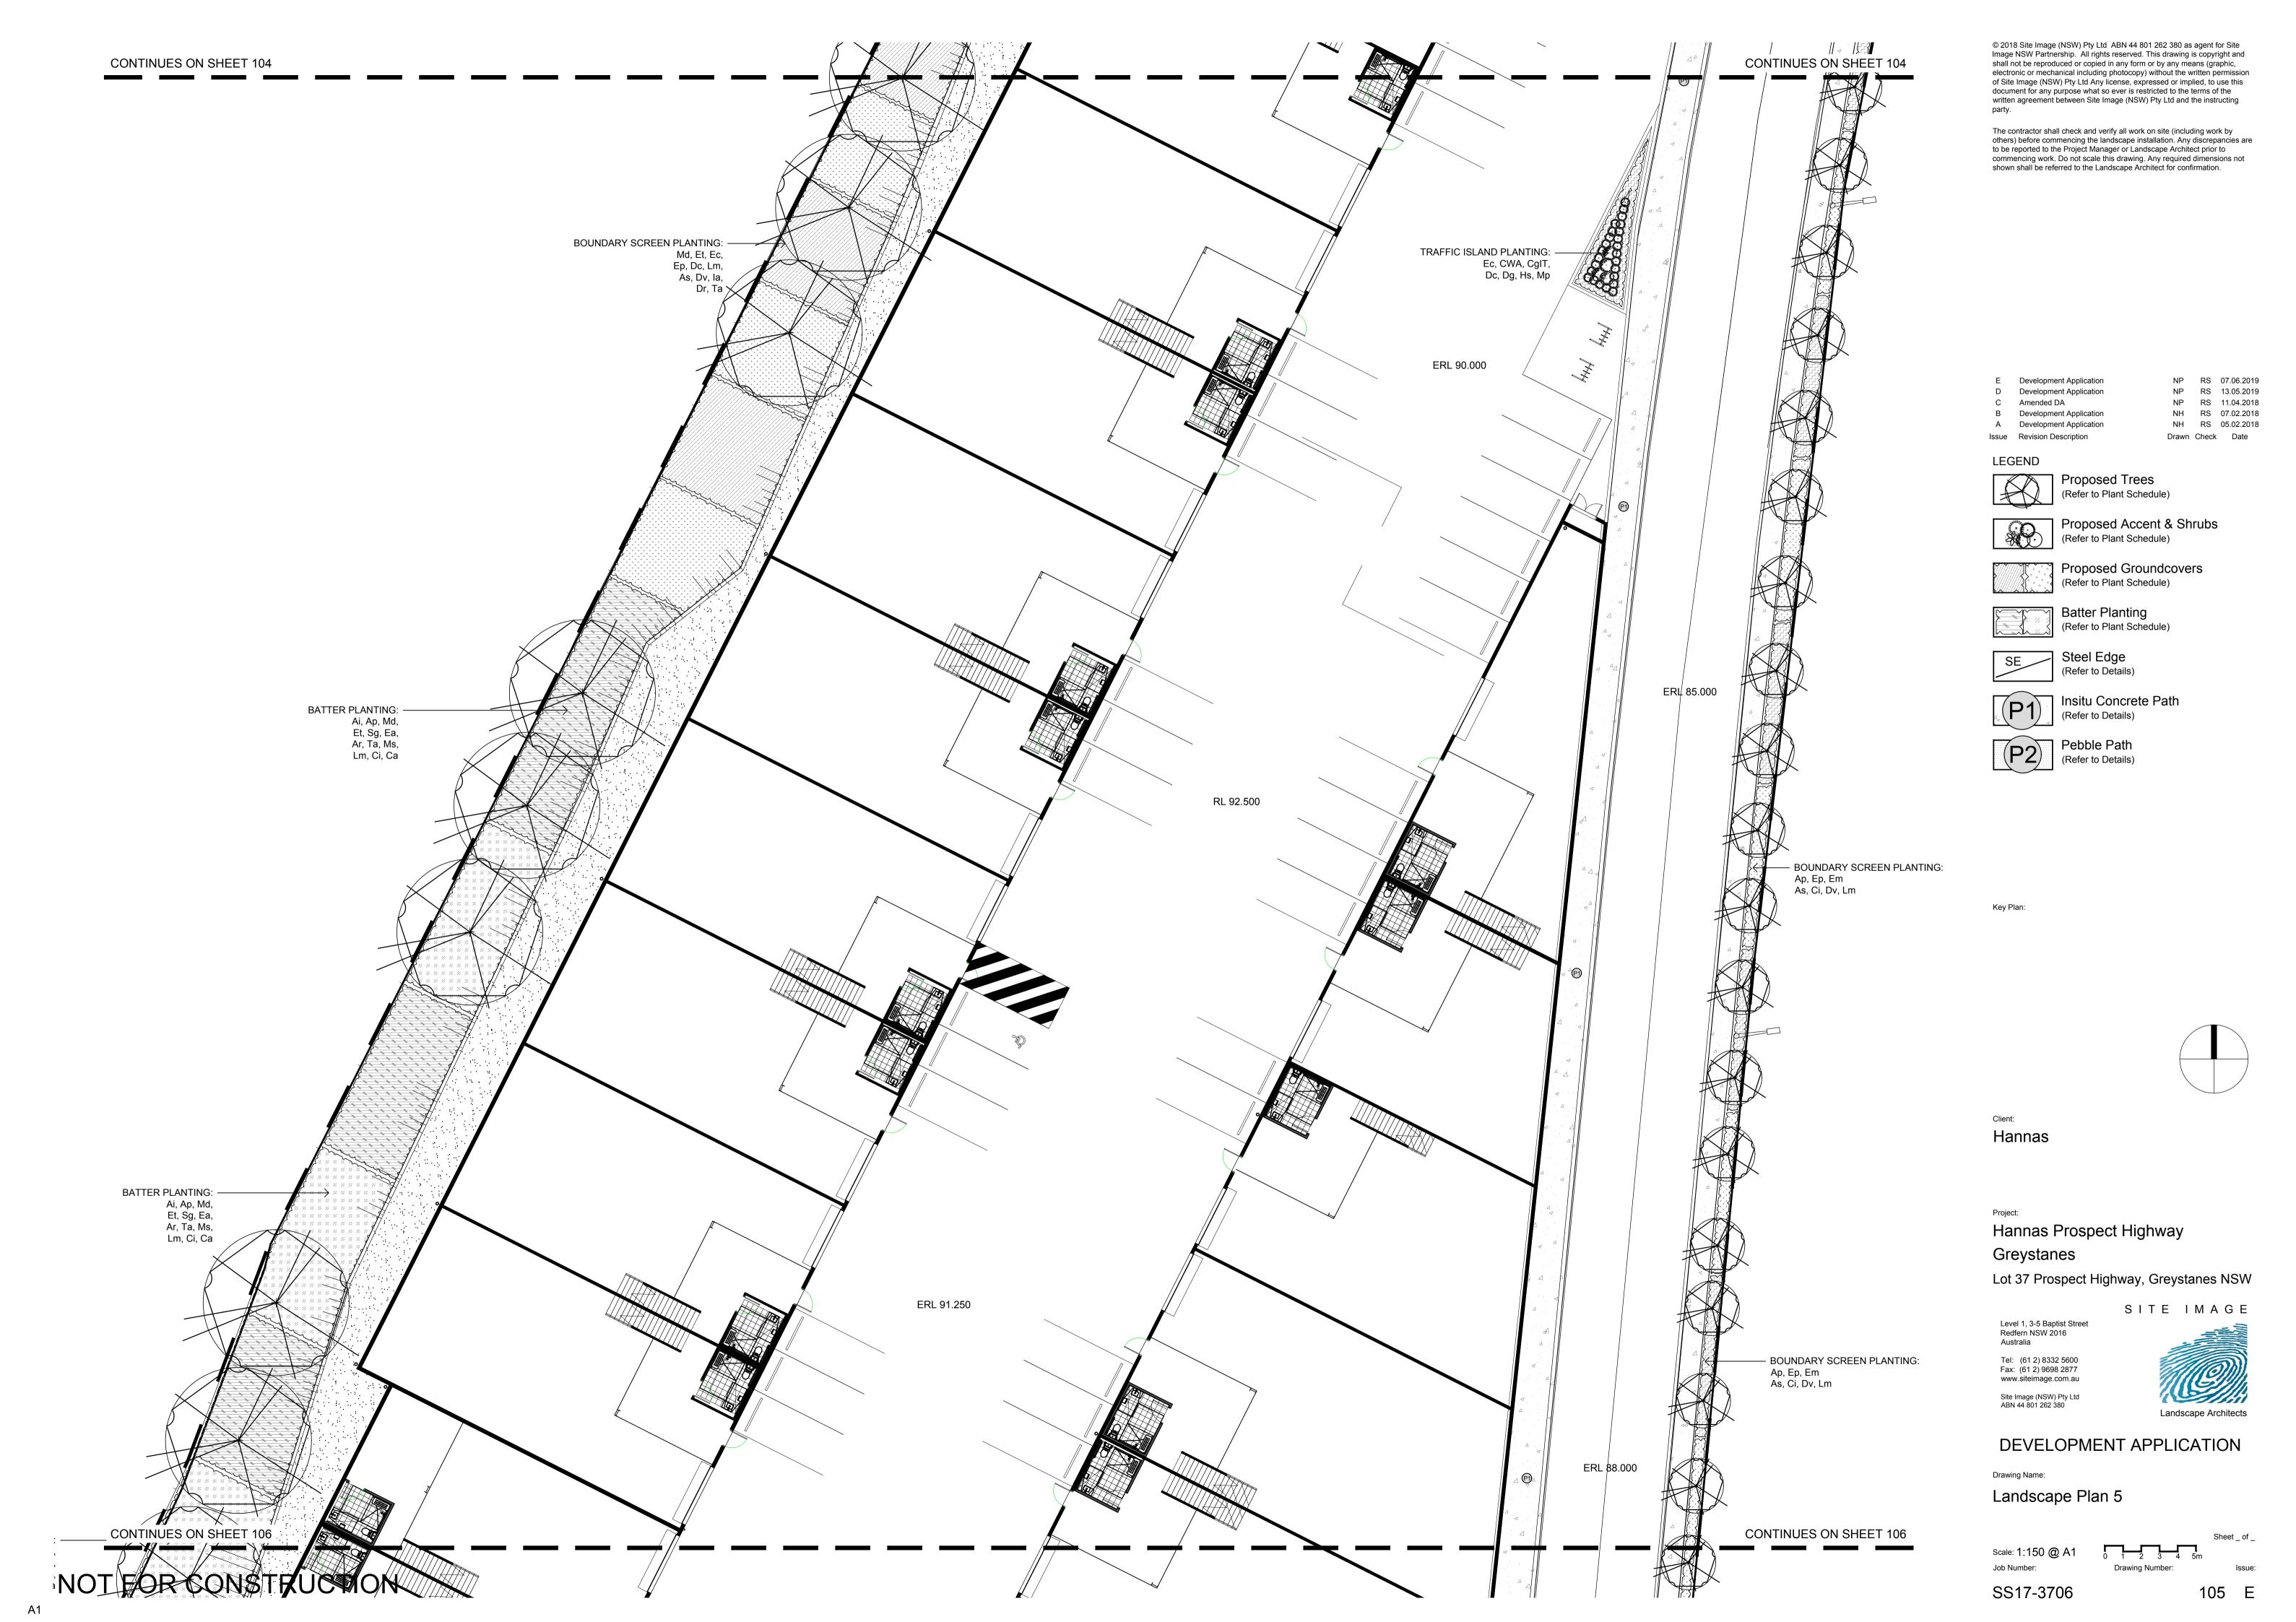
Landscape Plan 3

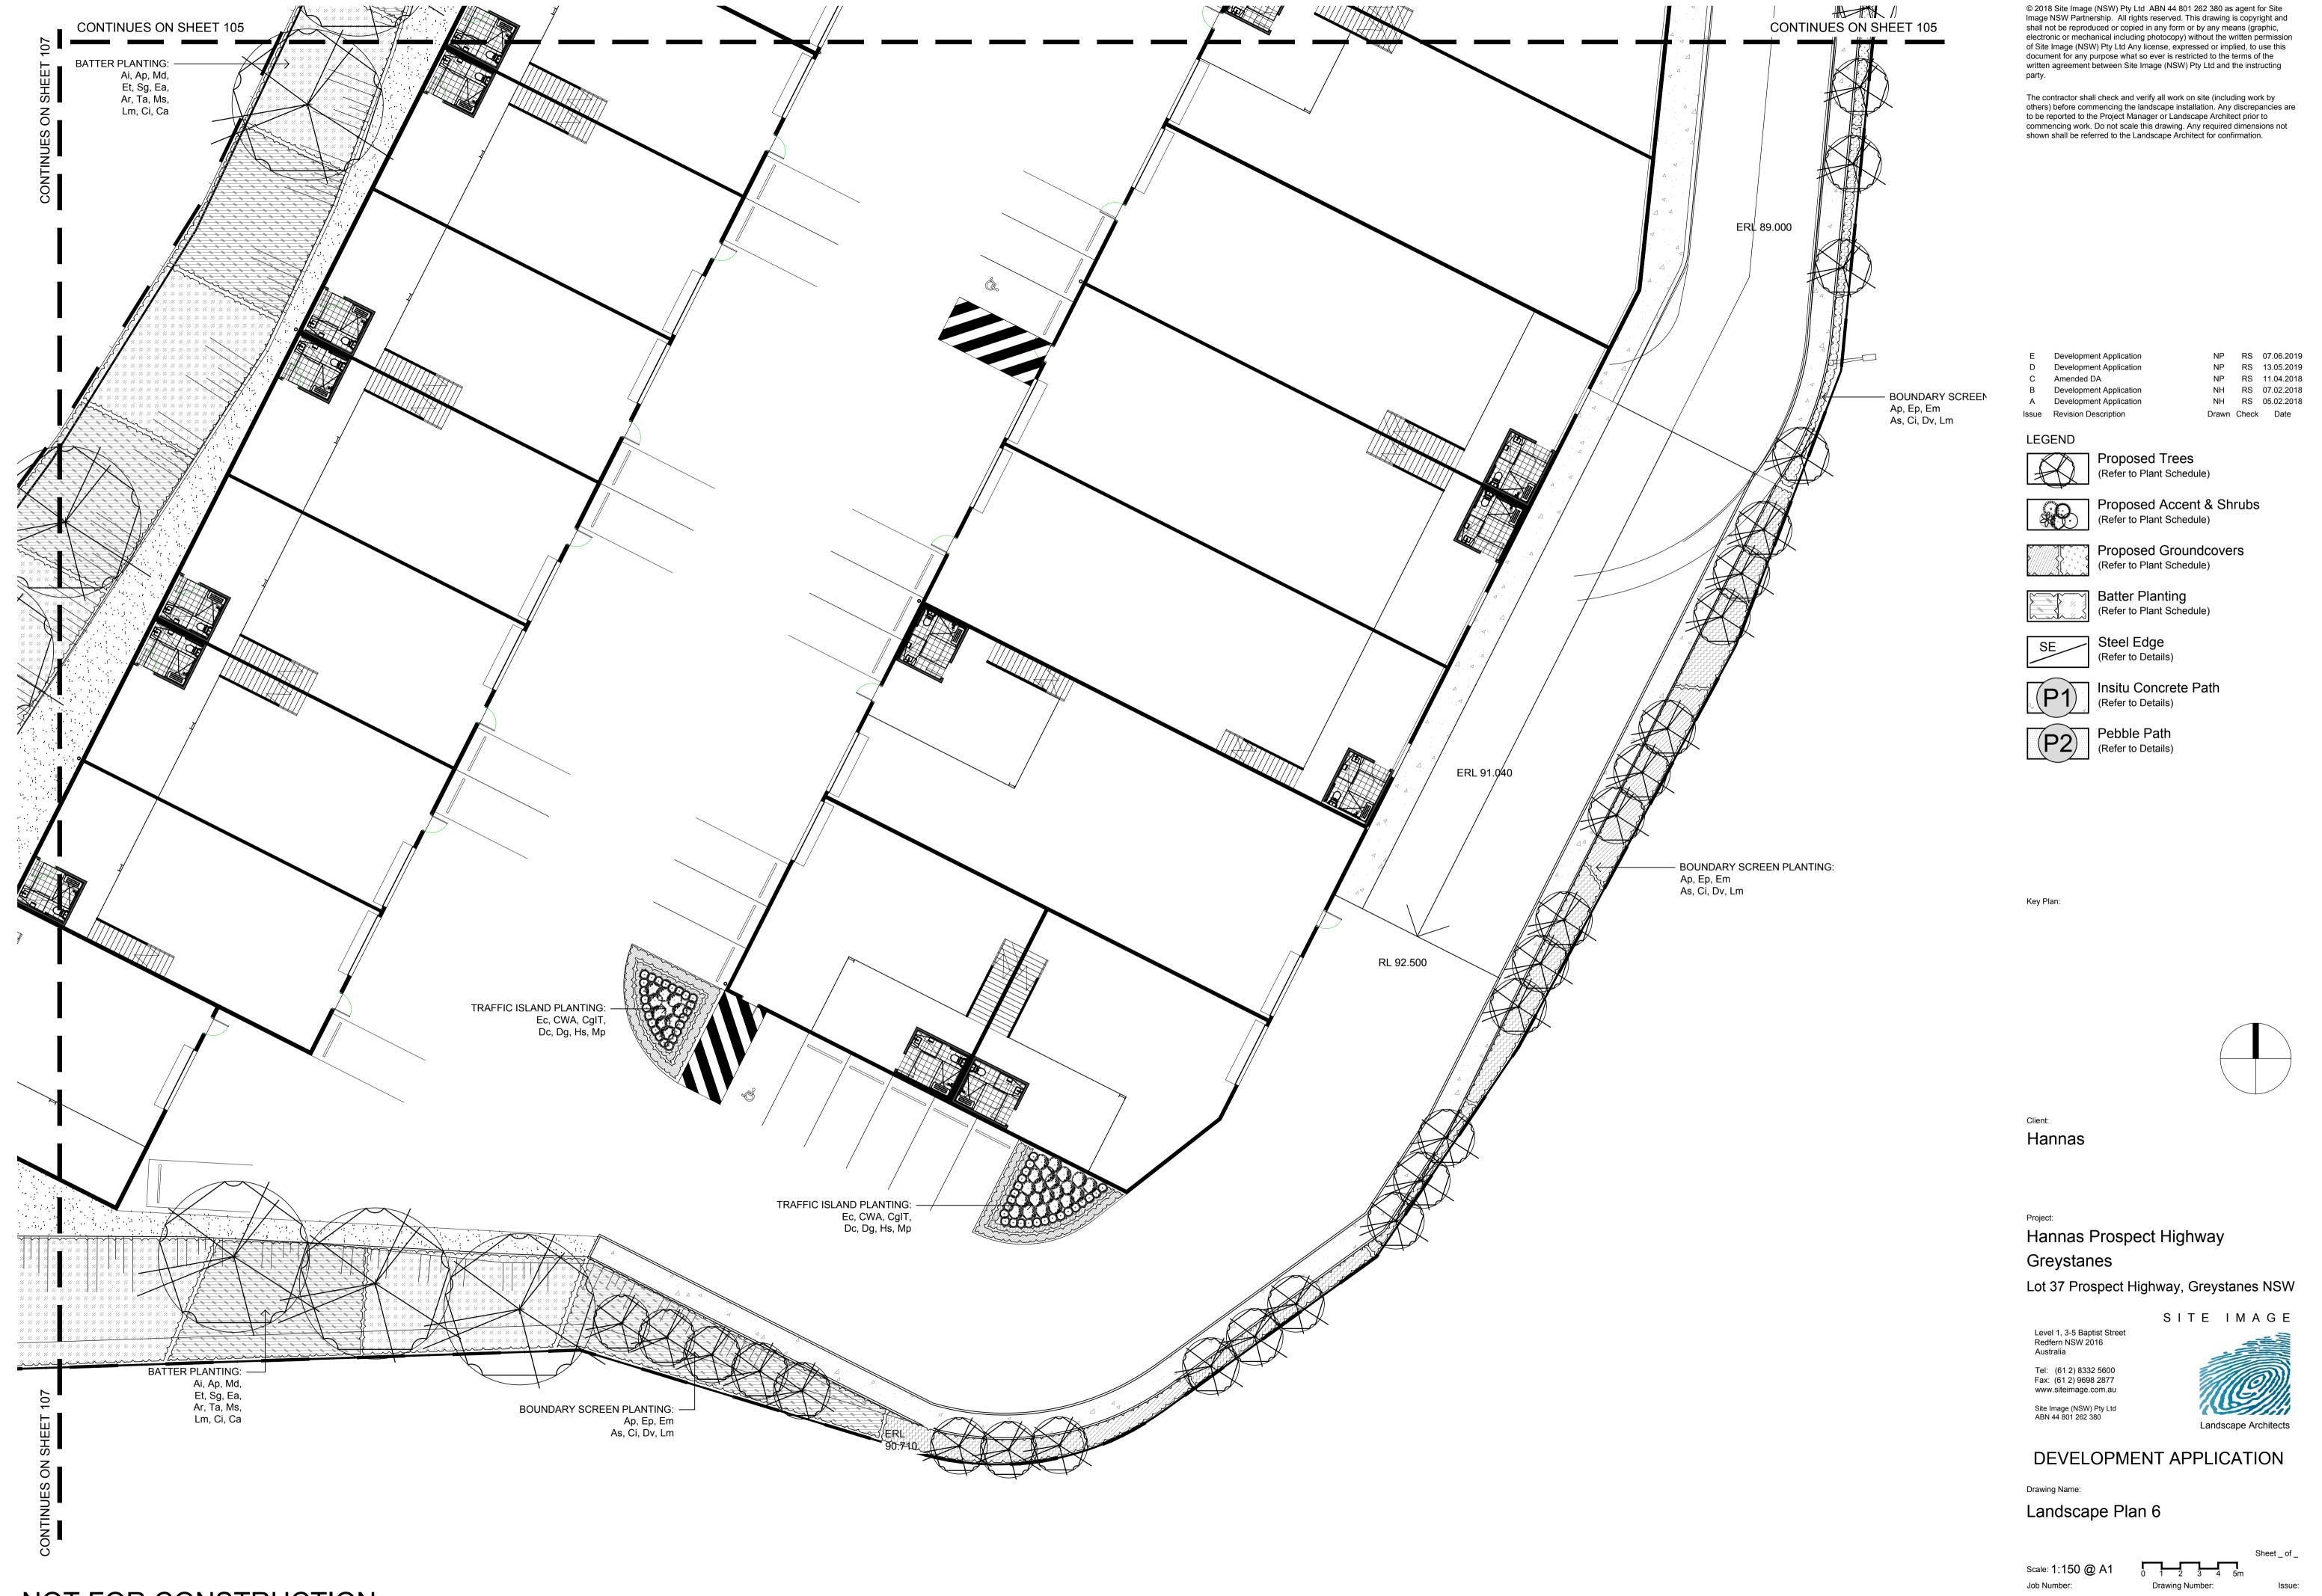
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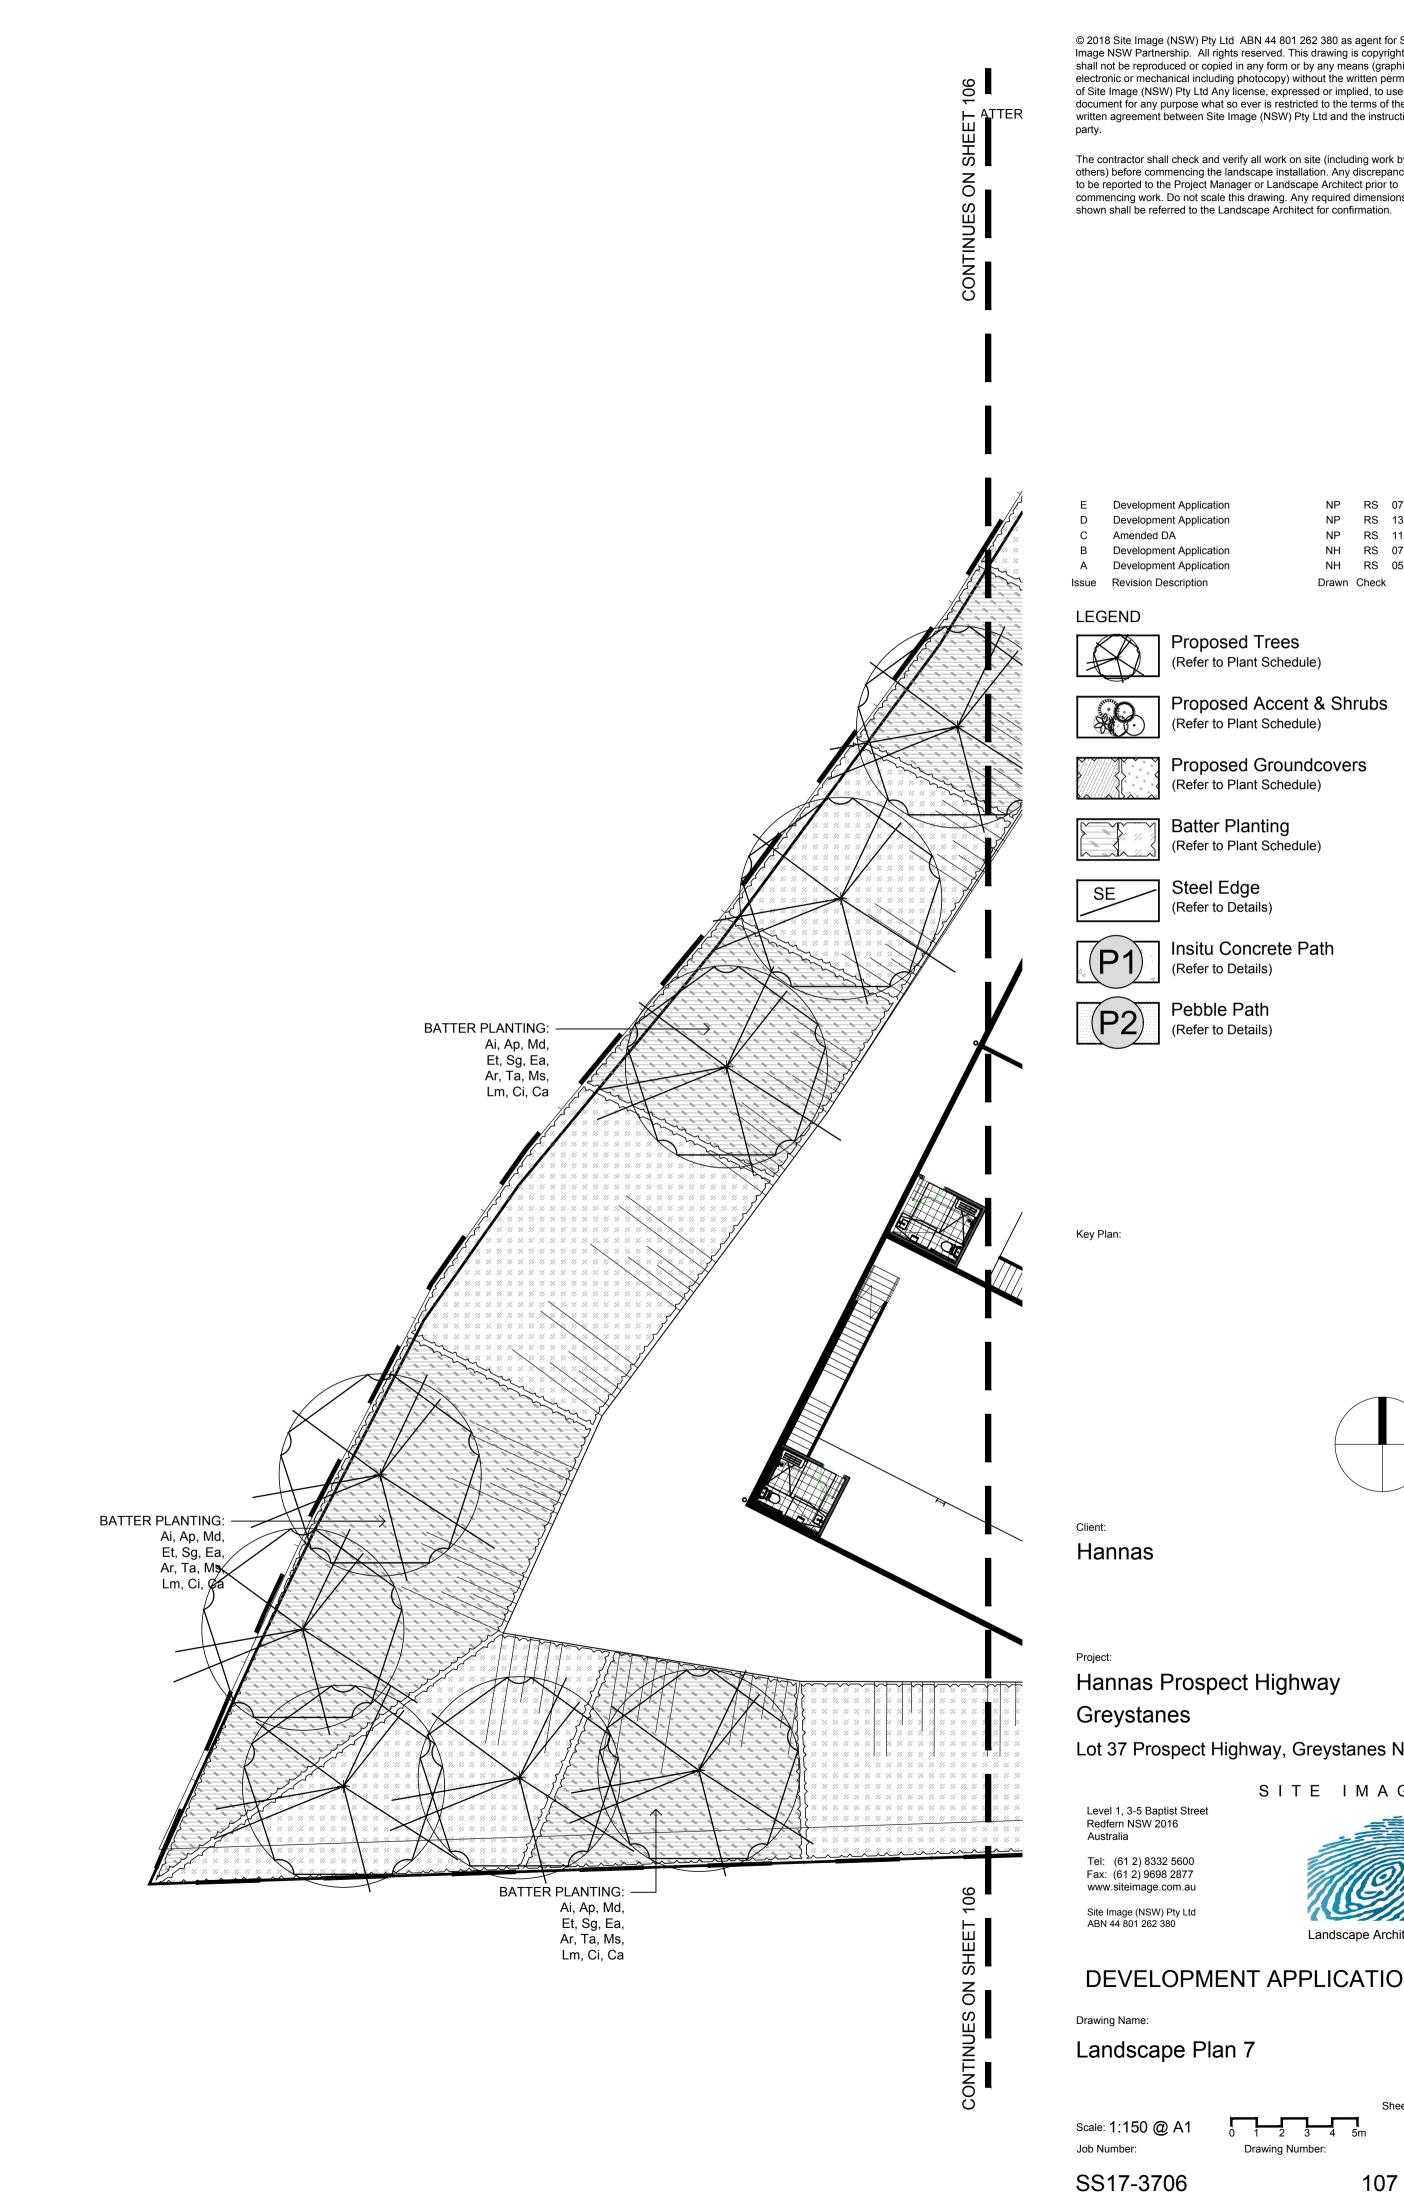
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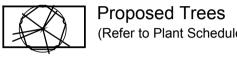




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(Refer to Plant Schedule)



Proposed Groundcovers (Refer to Plant Schedule)

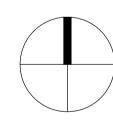


Steel Edge (Refer to Details)



Insitu Concrete Path (Refer to Details)





Hannas Prospect Highway

# Greystanes

# Lot 37 Prospect Highway, Greystanes NSW

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DEVELOPMENT APPLICATION

Drawing Name:

Landscape Plan 7

107 E

# References

All plans and details included in the project documents shall be read in conjunction with this specification. All structural and civil works components of the landscape design shall be engineers' details specifications. Read this specification in conjunction with the plant and materials schedules on the drawings. If in doubt about any detail or if conflicts are found in the documents, seek advice.

#### **Workmanship and Materials**

The whole of the landscape works shall be carried out by a competent, trained and qualified landscape contractor who is experienced in horticultural practices, landscape construction and planting techniques. The landscape contractor shall hold a current Building Contractors License and/or be a financial member of LNA Landscape Association NSW & ACT or equivalent organisations in other states.

#### **HARDWORKS**

#### Furniture, Handrails, Balustrades

Supply and install the scheduled items in the manufacturer's accordance recommendations, as detailed and in the locations shown on plan. Provide all footings and fixing required for the items to be stable and in accordance with applicable codes and standards.

# Garden Walls, Fences, Steps, TGSI and

Construct garden walls, fences, steps, TGSI and edging as shown on plan, as detailed and of the material scheduled. Provide footings, step with nosings, tactile surfaces to comply standards and applicable legislation. Refer to engineer's details for structural retaining walls, heavy duty slabs, concrete stairs, concrete strength, reinforcing and joint placement.

### Continuous, Unit and Loose Pavement

Install the scheduled material pavement to the locations shown on plan. Ensure that all subgrade/subsurface works are complete prior to Install in accordance with manufacturer's commencing paving. Confer with the engineer to ensure the structural integrity of the subgrade. Ensure that the base course under paved Mulch surfaces is a continuous plane offering a constant depth of bedding material not exceeding 50mm.

# SOFTWORKS

# Topsoil

Import topsoil for the garden and turf areas, unless the topsoil can be provided from material recovered from the site, as recommended in the soil testing results. Spread the topsoil on the prepared subsoil and grade evenly, compact lightly and uniformly in 150mm layers. Avoid differential subsidence and excess compaction and produce a finished topsoil surface which has the following characteristics:

- Finished to design levels, allowing for mulch or turf, which is to finish flush with adjoining hard surfaces such as paths and edges;
- Smooth and free from inorganic matter, stones or clods of soil;
- Graded to drain freely, without ponding, to catchment and/or sub-soil drains;
- Graded evenly to adjoining surfaces; and
- Ready for planting.

# Compost

Provide, in accordance with AS 4454, well rotted vegetative material or animal manure, free from harmful chemicals, inorganic matter, grass, weeds and the reproductive parts of unwanted plants.

#### **Fertiliser**

Provide proprietary fertilisers, delivered to the site in sealed containers marked to show manufacturer or vendor, weight, fertiliser type, N:P:K ratio, recommended uses, application rates and safety procedures. Apply appropriate fertiliser suited to the provenance of plants (indigenous or exotic) included in the design

Supply plants in accordance with the landscape design drawings and schedules, which have the following characteristics:

- Large healthy root systems, with no evidence of root curl, restriction or damage;
- Vigorous, well established, free from disease and pests, of good form consistent with the species/variety;
- Hardened off, not soft or forced, and suitable for planting in the natural climatic conditions prevailing at the site in full sun, partial shade or full shade conditions:
- Grown in final containers for not less than
- Trees, unless required to be multi-stemmed. shall have a single leading shoot; and
- Containers shall be free from weeds and of appropriate size in relation to the specified plant size.

### Plant Installation

Following excavation of the planting hole, place and spread 15qms of wetting agent pre-mixed with one (1) litre of water. Place the plant correctly orientated to north or for best presentation. Backfill the planting holes with specified topsoil mixture. Lightly tamp and water to eliminate air pockets. Ensure that the backfill soil is not placed over the top of the root ball and that the root ball is not higher than the soil in which it is planted. Apply fertiliser, as specified around the plants in the soil at the time of

#### **Root Barrier**

Supply and install root control barriers to all new tree plantings adjacent to walls, paths, kerbs and all service trenches, where their proximity poses a threat to the stability of the built infrastructure. recommendations.

Unless noted otherwise, mulch shall be approved proprietary recycled wood fibre or pine bark material. Place mulch in all garden beds to a depth of 75mm after all specified plants are installed. Keep mulch clear of all plant stems and rake to an even plane, flush with the surrounding surfaces evenly graded between design surface levels. Over fill to allow mulch to settle to the specified depth.

# Stakes and Ties

Stakes shall be durable hardwood, straight, free of knots and twists, pointed at one end, in the following quantities and sizes for each of the various plant pot sizes:

- Plants (>25 lt): 1 off 38 x 38 x 1200mm;
- Semi-advanced plants (>75 lt): 2 off 50x50x 1800mm:
- Advanced (>100 lt): 3 off 50 x 50 x 2400mm.

# IRRIGATION

All proposed landscape areas shall be irrigated.

The irrigation system shall be an automatic permanent system, with an irrigation controller self operated via a soil moisture sensor. The system shall be calibrated to deliver the optimum rate and volume of water appropriate to the type of plants in the design. The system shall be adjustable and fully serviceable. The layout of the entire irrigation system shall focus on o delivering the required amount of water to o maintain healthy and vigorous growth. The irrigation system shall be such that, component theft, vandalism, over-spray and wetting of paths shall be reduced to a minimum or completely eliminated by the use of drip, pop-up sprinklers and judiciously placed fixed spray emitters.

Generally do not use fine mist emitters that provide a drifting mist that may wet paths and the buildings unless specifically required by the

• Fertilising - Fertilise gardens with

fertilising including:

every 2 weeks

possible.

is essential.

proprietary slow release fertiliser applied in

accordance with the manufacturer's directions

and recommendations. Apply 6-12 monthly

Record in the logbook all relevant details of

OProduct brand / manufacturer's name.

Application quantity and rate, and

• Stakes and ties - Adjust and replace as required to ensure plants remain correctly

staked. Remove those not required at the end

of the planting establishment period (Defects

Liability Period). Inspect and act at least

a clean, tidy and weed free condition and

reinstate the mulch as necessary to ensure

correct depth as specified. Observe weekly

Mowing and top dressing - Mow the turf to

maintain a grass height of between 30-50mm.

Do not remove more than one third of the

grass height at any one time. Remove grass

clippings from the site after each mowing.

Top dress to a maximum of 10mm to fill

depressions and hollows in the surface. Mow

weekly/fortnightly in warmer months. Mow

monthly or as required in cooler months. Top

irrigation system to sure that each individual

plant receives the required amount of water to

maintain healthy and vigorous growth. Adjust and calibrate as required. Provide additional

watering, if necessary but inspect irrigation

the erosion control fabric in a tidy and weed

free condition and reinstate as necessary to

ensure control measures are effective where

deemed necessary. Inspect every 2 weeks

and act to repair any damage as soon as

Weeding and rubbish removal - During the

plant establishment period remove by hand

rubbish and weed growth that may occur or

re-occur throughout all planted, mulched and

paved areas. The contractor shall target

weeds that are capable of producing a major

infestation of unwanted plants by seed

distribution. Whenever possible, time weed

removal to precede flowering and seed set

Constant observation and removal of weeds

weekly and make repairs as necessary.

Erosion control - Where necessary, maintain

dress at approximately 6 monthly intervals.

• Irrigation and watering - Maintain the

and replenish mulch as required.

Maintaining mulch - Maintain the surface in

Date of application and location.

Fertiliser / product name,

### LANDSCAPE MAINTENANCE

The Landscape Contractor shall rectify defects during installation and that become apparent in o the works under normal use for the duration of the contract Defects Liability Period. Unless contracted otherwise, the Landscape Contractor shall maintain the contract areas by the implementation of industry accepted horticultural practices for 52 weeks from Practical Completion of the works. The landscape maintenance works shall include, but not be limited to:

- Replacing failed plants;
- Pruning;
- Insect and pest control;
- Fertilising:
- Maintaining and removing stakes and ties;
- Maintaining mulch;
- Mowing and top dressing: Irrigation and watering;
- Erosion control; and
- Weeding and rubbish removal.

#### Maintenance Log Book

Implement and keep a maintenance log book recording when and what maintenance work has been undertaken and what materials, actions and decisions have been used, implemented and concluded to keep the landscape always looking its best. Enter data daily and review information every 2 weeks. Observe trends and develop a maintenance regime around seasonal and observed event occurrences.

#### Maintenance Activities

During the defects maintenance period schedule the following activities to occur on a timely basis.

- **Plant replacement** Replace plants that have failed to mature, die or are damaged. Replacement plants shall be in a similar size and quality and identical species or variety to the plant that has failed. Replacement of plants shall be at the cost of the landscape contractor unless advised otherwise. If the cause of the failure is due to a controllable situation then correct the situation prior to replacing plants. Observe and replace failed plants within 2 weeks of observation.
- Pruning Prune dead wood, broken limbs, dead or infected foliage and as needed to develop strong, healthy plants to achieve the shape and form expected of the plant type. Observe daily and prune plants on a needs
- Insect, disease and pest control Avoid spraying:
- if ever possible;

in wet weather or if wet weather is imminent;

- if target plants are still wet after rain;
- in windy weather; and
- if non-target species are too close.

Immediately report to the Project Manager any evidence of intensive weed infestation, insect attack or disease amongst plant material. Submit all proposals to apply chemicals and obtain approval before starting this work. When approved, spray with insecticide, fungicide as appropriate in accordance with the manufacturers' recommendations. Observe daily and act as necessary to control any infestation or disease. Record in the logbook all relevant details of spraying activities including:

- Product brand / manufacturer's name,
- Chemical / product name,
- Chemical contents,
- Application quantity and rate,
- Date of application and location, Results of application, and
- Use approval authority.

# SS17-3706 Lot 37 Prospect Highway, Greystanes Plant Schedule

GRASSES & GROUNDCOVER PLANTING

SYMBOL	BOTANIC NAME	COMMON NAME	MATURE SIZE	SPACING	POT SIZE
			(h x w) (m)		
TREES					
Ai	Acacia implexa	Lightwood	12 x 5	As Shown	75L
Ap	Acacia parramattensis	Parramatta Wattle	10 x 5	As Shown	75L
Ea	Eucalyptus crebra	Ironbark	30 x 20	As Shown	75L
Em	Eucalyptus moluccana	Grey Box	25 x 8	As Shown	75L
Еp	Eucalyptus punctata	Grey Gum	22 x 8	As Shown	75L
Et	Eucalyptus teretecornis	Forest Red Gum	30 x 10	As Shown	75L
Ec	Exocarpus cupressiformis	Native Cherry	6 x 5	As Shown	75L
Md	Melaleuca decora	White feather Honeymyrtle	7 x 5	As Shown	75L
Sg	Syncarpia glomulifera	Turpentine	25 x 8	As Shown	75L

#### Shrubs & Accents Lilly Pilly 15 x 5 As Shown 300mm Acmena smithi Bursaria spinosa Blackthorn $2.5 \times 2$ As Shown 300mm Matted Bush-pea 1.5 x 2 As Shown 300mm |Dillwynia sieberi Dodonea viscosa Sticky Hop Bush 2 x 2 As Shown 300mm Indigofera australis Austral Indigo 2 x 2 As Shown 300mm

A <i>a</i>	Ajuga australis	Austrlaian bugle	0.15 x spreading	5 per m²	150
Ar	Aristida ramosa	Purple wiregrass	1 x .75	5 per m²	150
Ci	Carex inversa	Knob Sedge	1 x 0.5	5 per m²	150
Са	Centella asiatica	Asiatic Pennywort	0.2 x 1.5	5 per m²	150
Dc	Dianella longifolia	Blue Flax Lily	.75 x .75	5 per m²	150
Dr	Dichondra repens	Kidney Weed	0.5 x spreading	5 per m²	150
<u>L</u> m	Lomandra multiflora	Mat Rush	.75 x 1	5 per m²	150
VIs	Microlaena stipoides	Griffin Weeping Grass	0.3 x 1	5 per m²	150
Та	Themeda australis	Kangaroo Grass	0.2 x 2	5 per m²	150

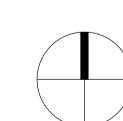
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	Development Application	NP	RS	07.06.2019
	Development Application	NP	RS	13.05.2019
	Amended DA	NP	RS	11.04.2018
	Development Application	NH	RS	07.02.2018
	Development Application	NH	RS	05.02.2018
	Revision Description	Drawn	Check	Date
_				

LEGEND

Key Plan:



Hannas

Greystanes

Hannas Prospect Highway

Lot 37 Prospect Highway, Greystanes NSW



Landscape Architects DEVELOPMENT APPLICATION

Landscape Specifications & Planting Schedule

Drawing Name:

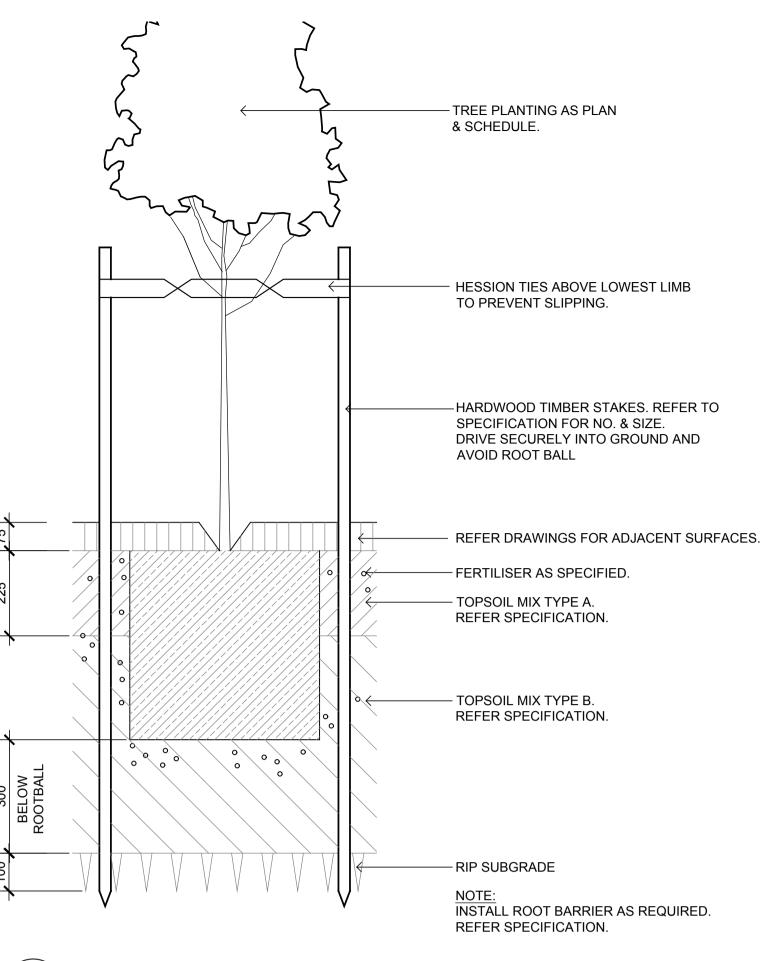
SS17-3706

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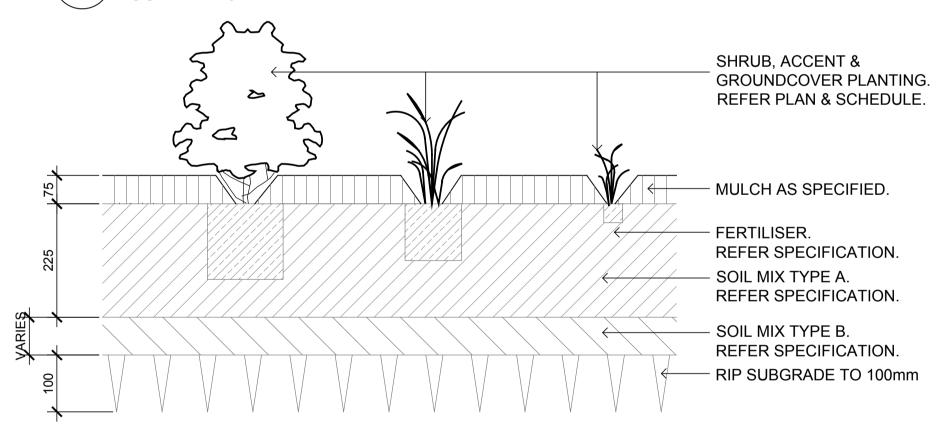
500 E

Sheet \_ of \_

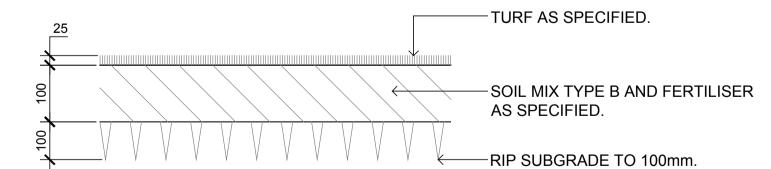
NOT FOR CONSTRUCTION



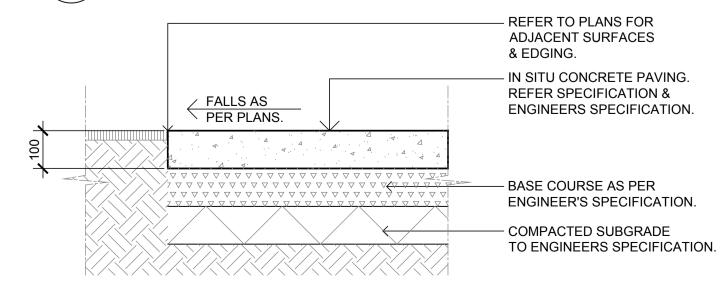
75-200L TREE PLANTING ON GRADE SCALE 1:10 501



02 SHRUB, ACCENT & GROUNDCOVER PLANTING ON GRADE 501 SCALE 1:10



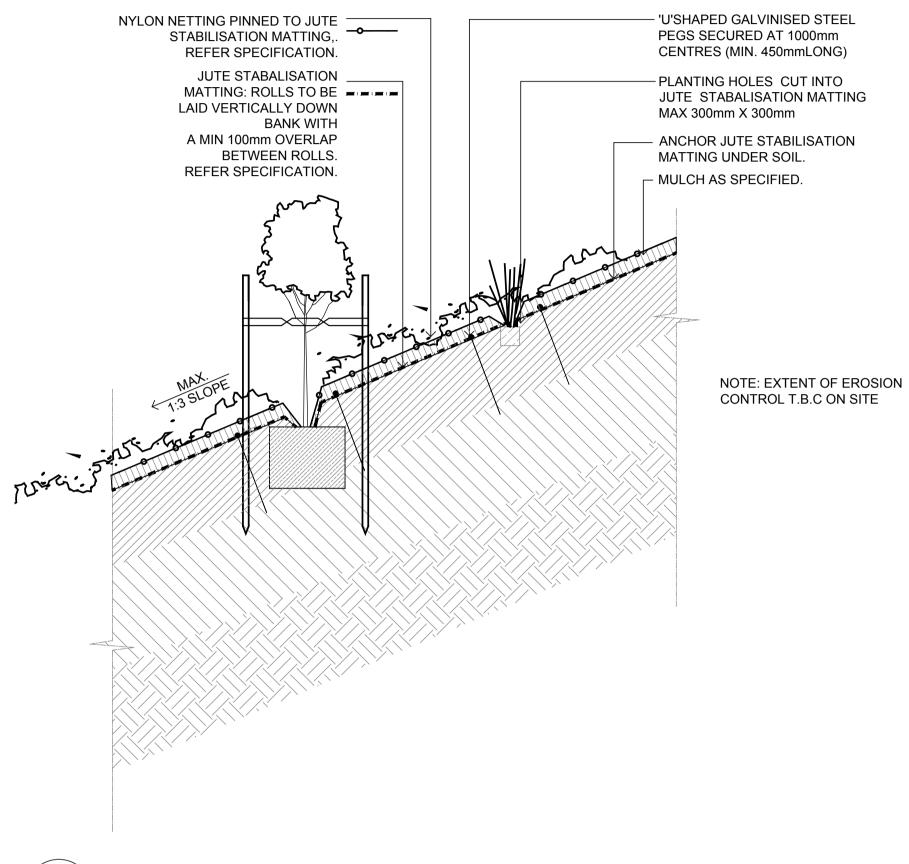
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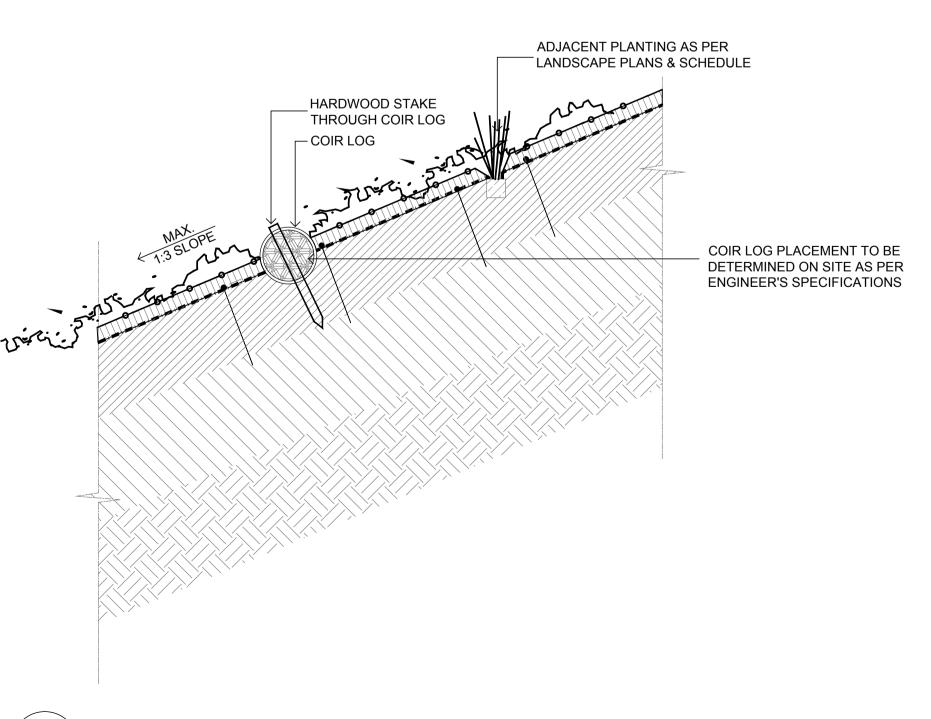
04 INSITU CONCRETE PAVING 501 SCALE 1:10 NOT FOR CONSTRUCTION

REFER TO PLANS FOR ADJACENT SURFACES & EDGING. - DECOMPOSED GRANITE PAVING. REFER SPECIFICATION. / FALLS AS PER PLANS. - BASE COURSE & RELATIVE F.C.R TO ENGINEER'S SPECIFICATION. - COMPACTED SUBGRADE TO ENGINEERS SPECIFICATION.

DECOMPOSED GRANITE PAVING ON GRADE SCALE 1:10



TYPICAL EMBANKMENT PLANTING DETAIL 501 SCALE 1:20



TYPICAL EMBANKMENT COIR LOG STABILISATION 501 SCALE 1:20

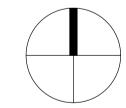
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The contractor shall check and verify all work on site (including work by others) before commencing the landscape installation. Any discrepancies are to be reported to the Project Manager or Landscape Architect prior to commencing work. Do not scale this drawing. Any required dimensions not shown shall be referred to the Landscape Architect for confirmation.

NP RS 07.06.2019 E Development Application NP RS 13.05.2019 Development Application C Amended DA NP RS 11.04.2018 NH RS 07.02.2018 B Development Application A Development Application NH RS 05.02.2018 Issue Revision Description Drawn Check Date

LEGEND

Key Plan:



Hannas

Hannas Prospect Highway

Greystanes

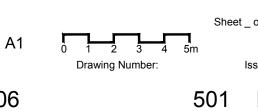
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**DEVELOPMENT APPLICATION** 

Drawing Name:

Landscape Details



SS17-3706