METCASH DISTRIBUTION CENTRE PROJECT MUSTANG

BUNGARRIBEE INDUSTRIAL ESTATE, HUNTINGWOOD NSW CIVIL WORKS PACKAGE FOR DEVELOPMENT APPLICATION

DRAWING LIST

Co9628.03-DA51

DRAWING NO. DRAWING TITLE Co9628.03-DA10 DRAWING LIST & GENERAL NOTES Co9628.03-DA15 SITE MASTER PLAN Co9628.03-DA20 **EROSION AND SEDIMENT CONTROL PLAN & DETAILS** Co9628.03-DA40 CONCEPT STORMWATER DRAINAGE PLAN - STAGE 5A/5B Co9628.03-DA41 CONCEPT STORMWATER DRAINAGE PLAN - STAGE 5C Co9628.03-DA45 CONCEPT STORMWATER DRAINAGE DETAILS Co9628.03-DA50 FINISHED LEVELS PLAN - STAGE 5A/5B

FINISHED LEVELS PLAN - STAGE 5C

GENERAL NOTES:

- THESE DRAWINGS SHALL BE READ IN CONJUNCTION WITH ALL DISCREPANCY SHALL BE REFERRED TO THE ENGINEER BEFORE PROCEEDING WITH THE WORK
- ALL MATERIALS AND WORKMANSHIP SHALL BE IN ACCORDANCE WITH THE RELEVANT AND CURRENT STANDARDS AUSTRALIA CODES AND WITH THE BY-LAWS AND ORDINANCES OF THE RELEVANT BUILDING
- ENGINEER'S DRAWINGS SHALL NOT BE SCALED FOR DIMENSIONS. ENGINEER'S DRAWINGS ISSUED IN ANY ELECTRONIC FORMAT MUST NOT BE USED FOR DIMENSIONAL SETOUT. REFER TO THE ARCHITECT'S DRAWINGS FOR ALL DIMENSIONAL SETOUT INFORMATION.
- DURING CONSTRUCTION THE STRUCTURE SHALL BE MAINTAINED IN A STABLE CONDITION AND NO PART SHALL BE OVERSTRESSED. TEMPORARY BRACING SHALL BE PROVIDED BY THE BUILDER TO KEEP THE WORKS AND EXCAVATIONS STABLE AT ALL TIMES.
- G5 UNLESS NOTED OTHERWISE ALL LEVELS ARE IN METRES AND ALL DIMENSIONS ARE IN MILLIMETRES.
- ALL WORKS SHALL BE UNDERTAKEN IN ACCORDANCE WITH ACCEPTABLE SAFETY STANDARDS & APPROPRIATE SAFETY SIGNS SHALL BE INSTALLED AT ALL TIMES DURING THE PROGRESS OF THE





Value in Engineering and Management

LOCATION PLAN
N.T.S

FOR DEVELOPMENT APPLICATION

FOR DEVELOPMENT APPLICATION 07.11.12 FOR DEVELOPMENT APPLICATION 24.10.12 FOR DEVELOPMENT APPLICATION 22.10.12 14.08.12 FOR INFORMATION ONLY AMENDMENTS DATE ISSUE AMENDMENTS DATE ISSUE

GILES TRIBE ARCHITECTS LEVEL 8, 263 CLARENCE STREET SYDNEY NSW 2000

LEVEL 10, 60 Castlereagh Street SYDNEY NSW, 2000, Australia Tel (02) 9230 7400 Fax (02) 9230 7444

METCASH DISTRIBUTION CENTRE PROJECT MUSTANG BUNGARRIBEE I.E, HUNTINGWOOD NSW

M.W. M.C. 07.08.12

CHECKED SIZE SCALE

B1 AS SHOWN

ACEA


Co9628.03-DA10


Costin Roe Consulting Pty Ltd. Consulting Engineers ACN 003 696 446 Level 1, 8 Windmill Street Walsh Bay, Sydney NSW 2000 Tel: (02) 9251-7699 Fax: (02) 9241-3731 email: mail@costinroe.com.au ©


Costin Roe Consulting NOTES

DRAWING LIST AND GENERAL

Co9628.03-DA10

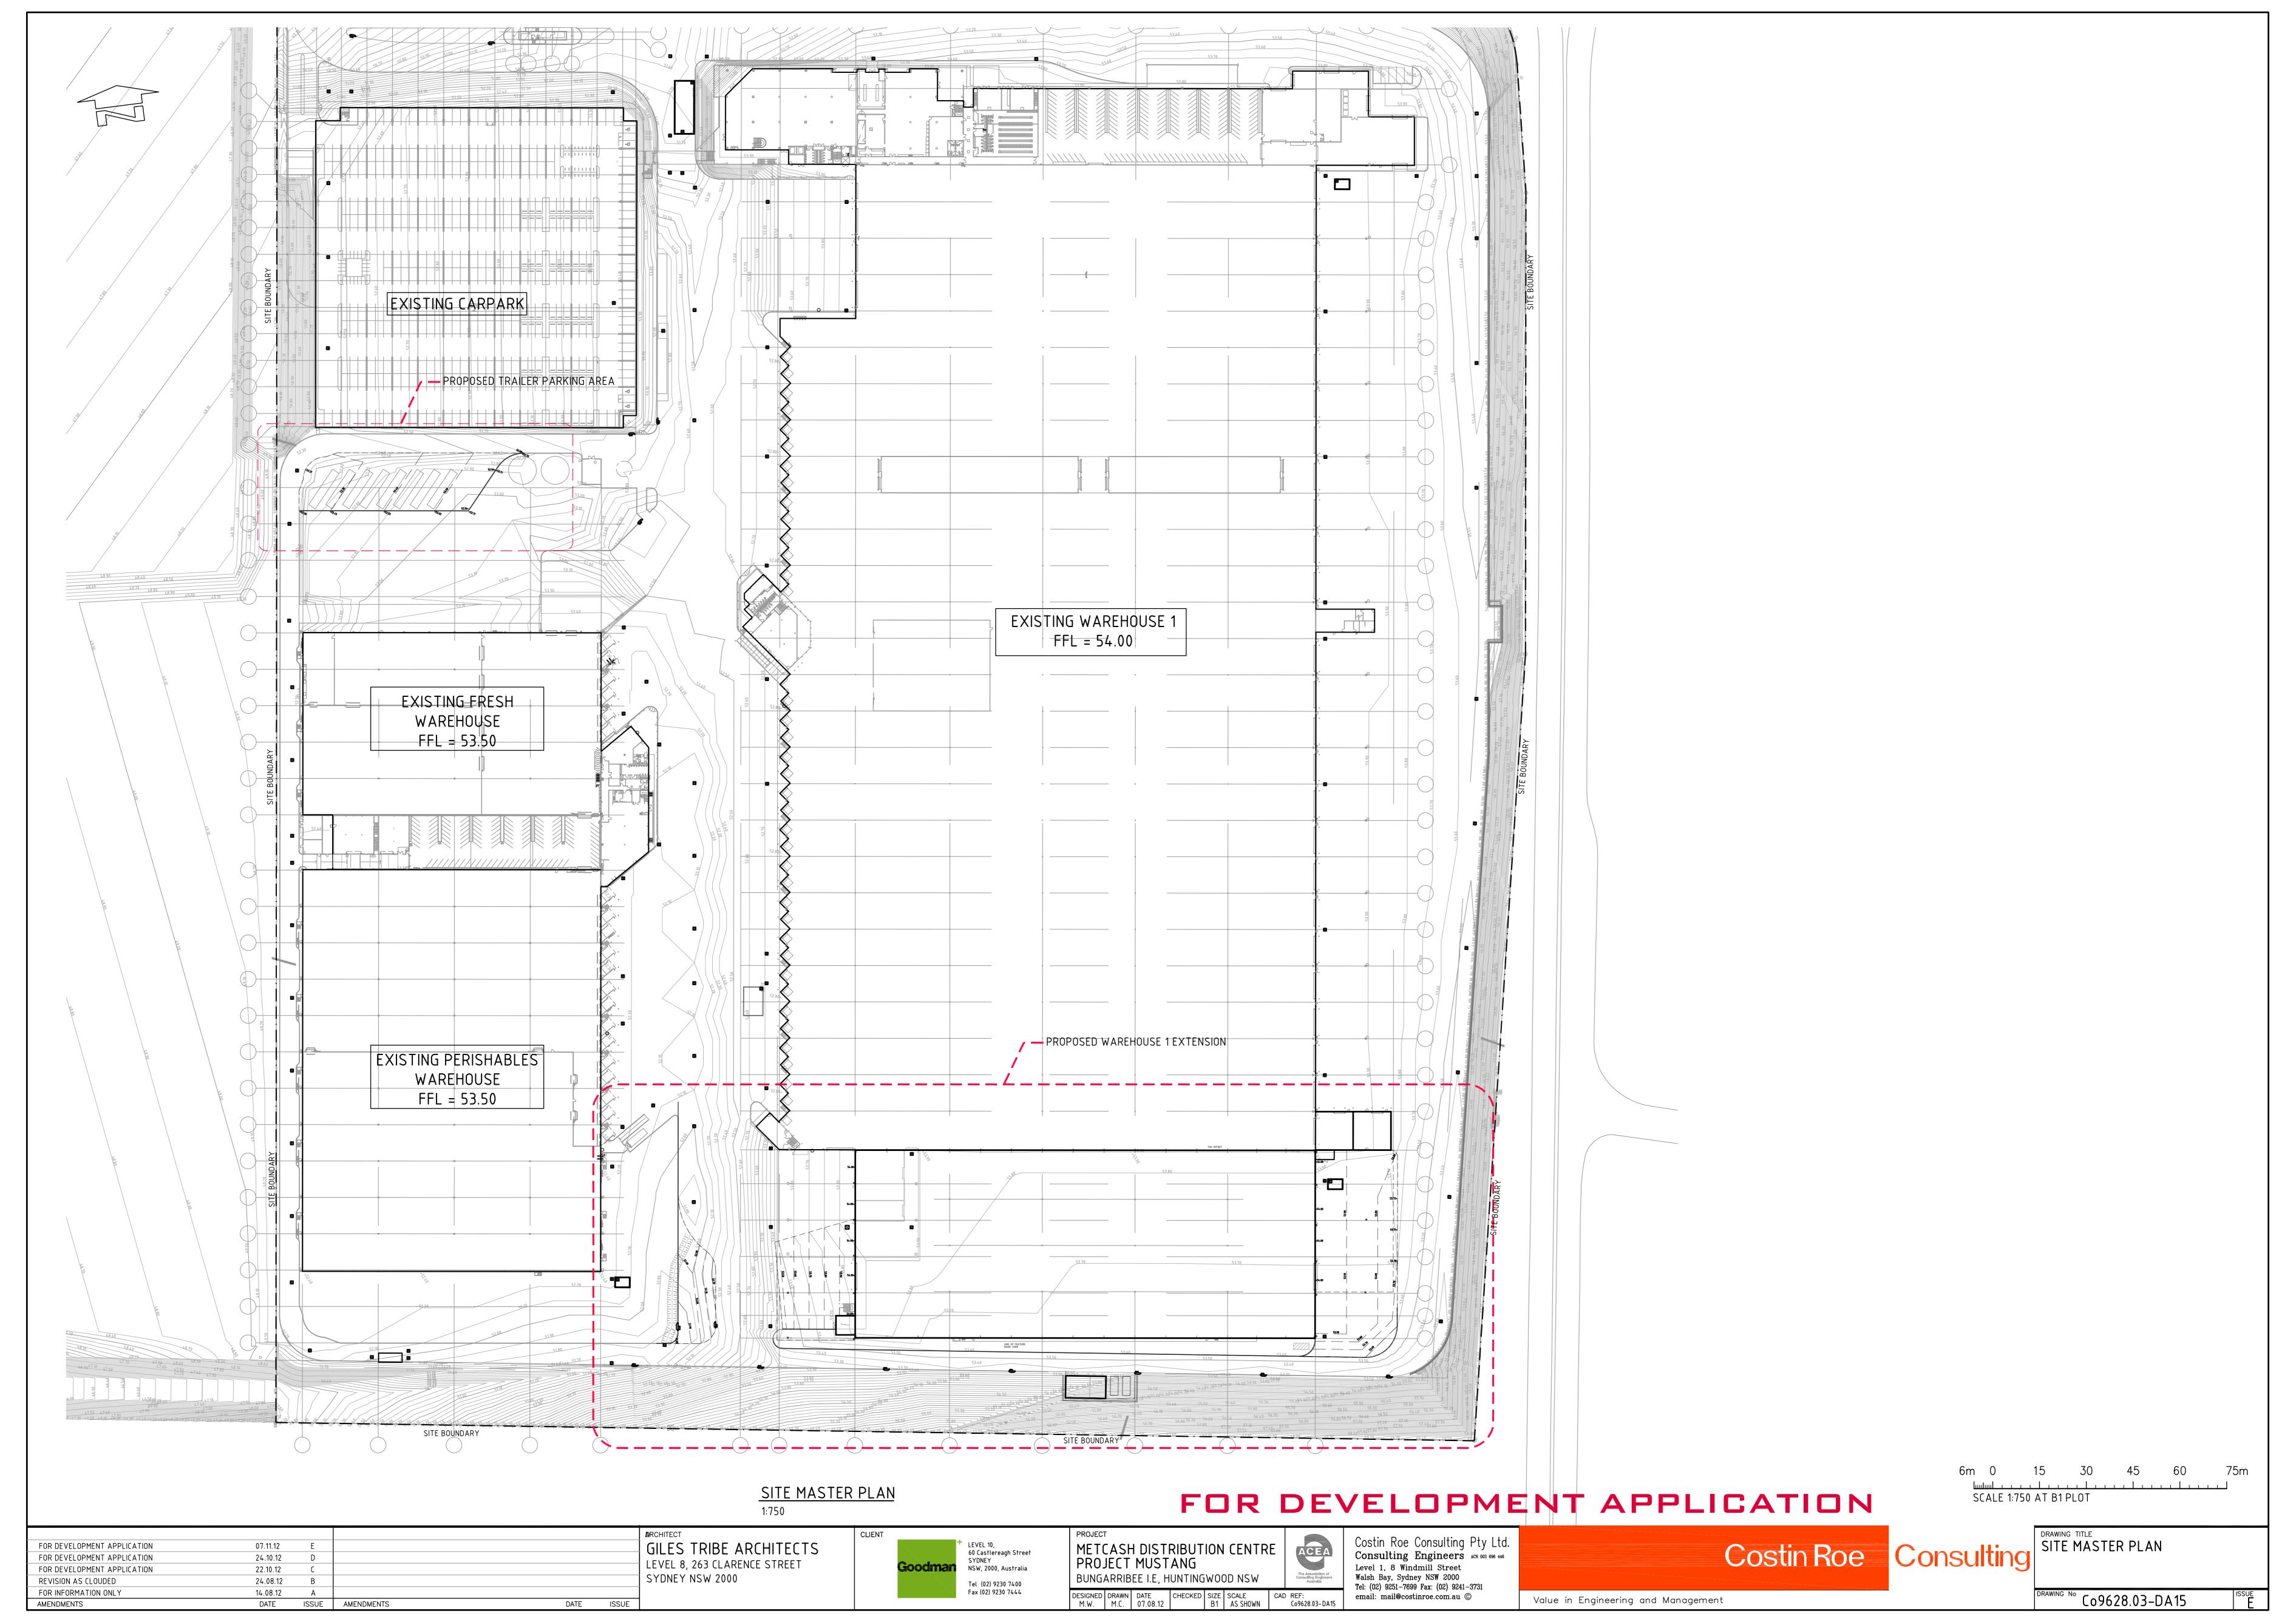

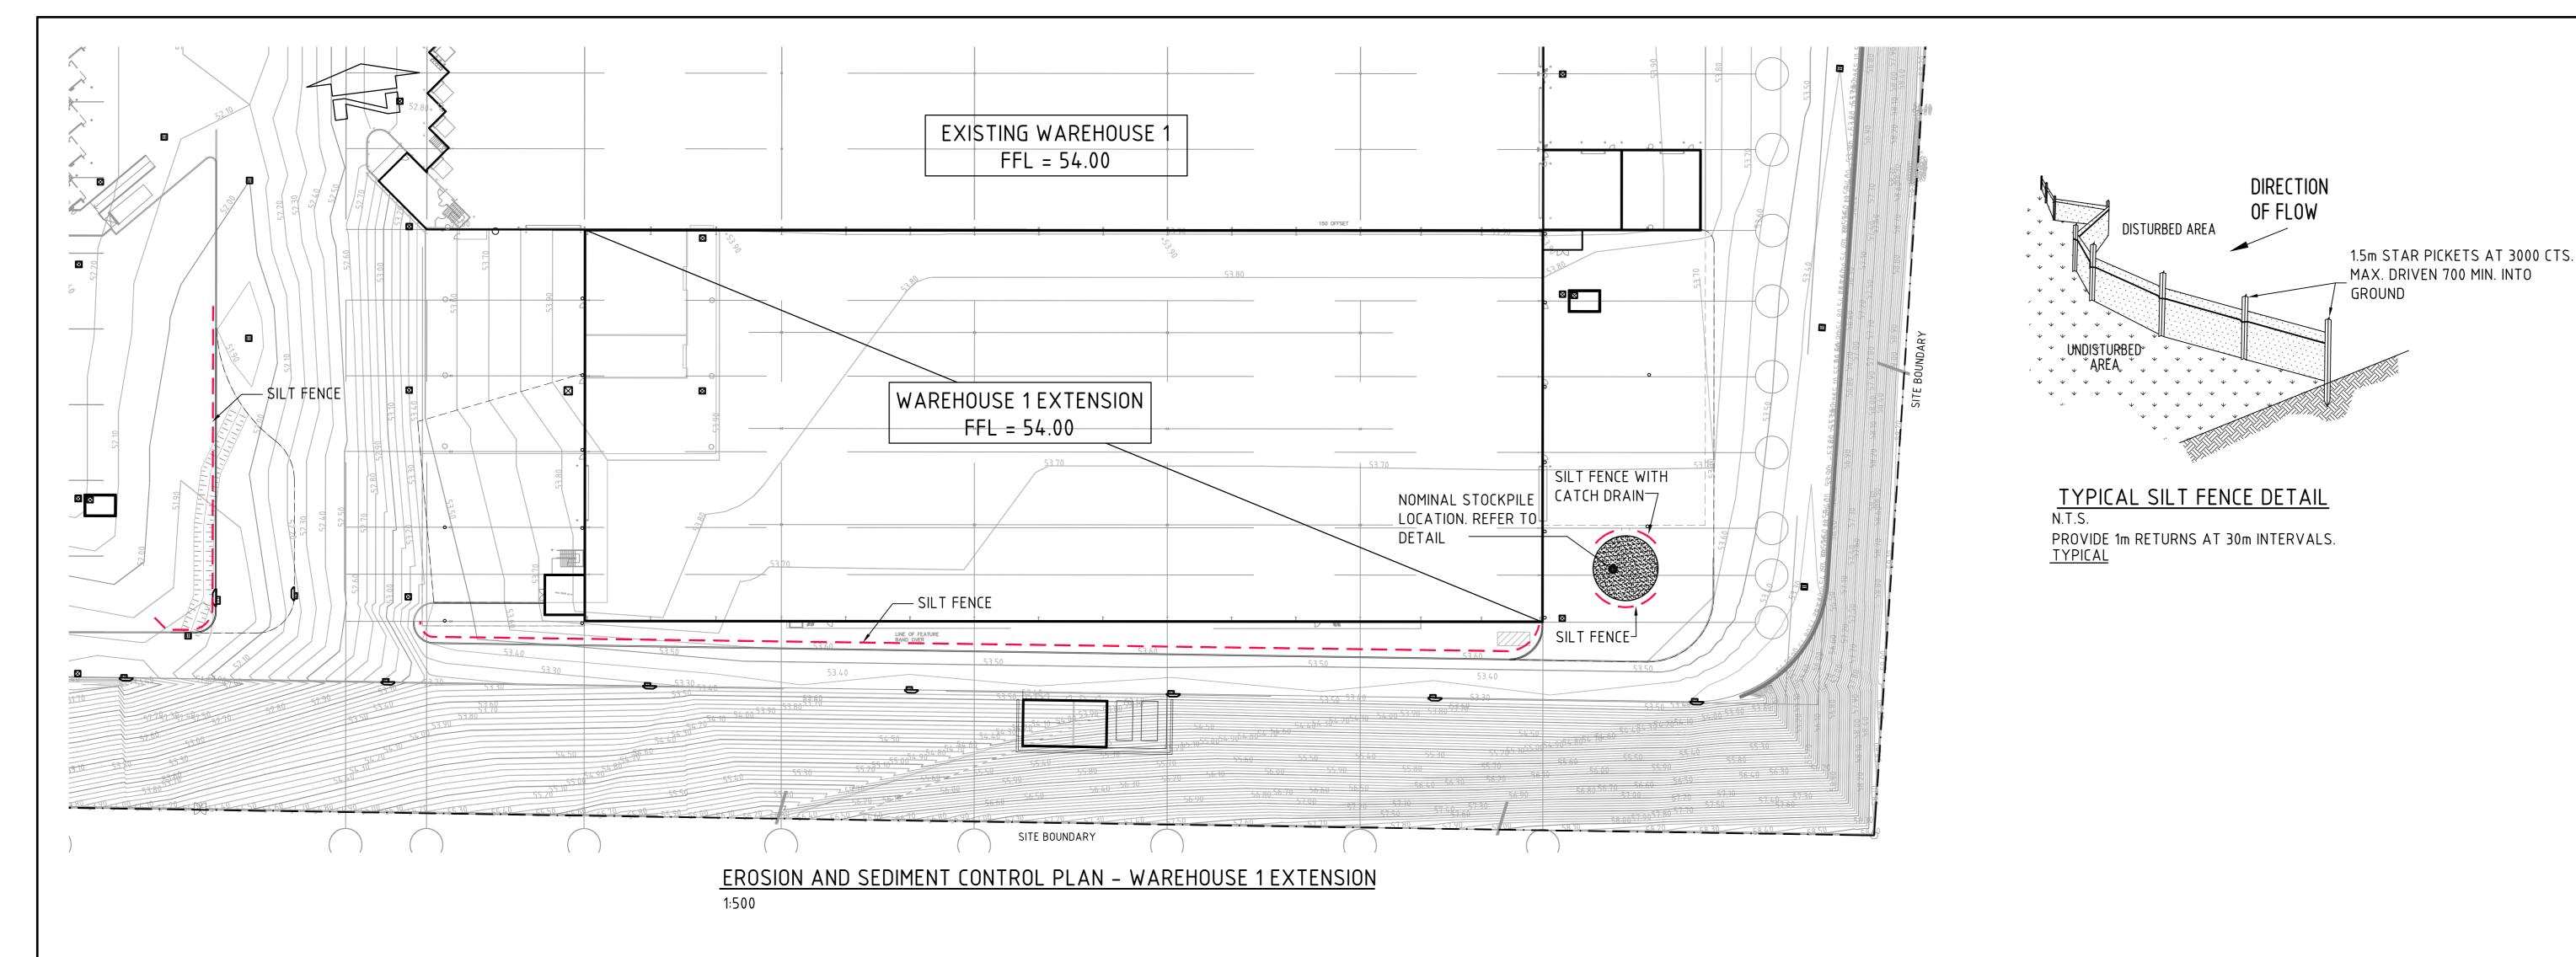


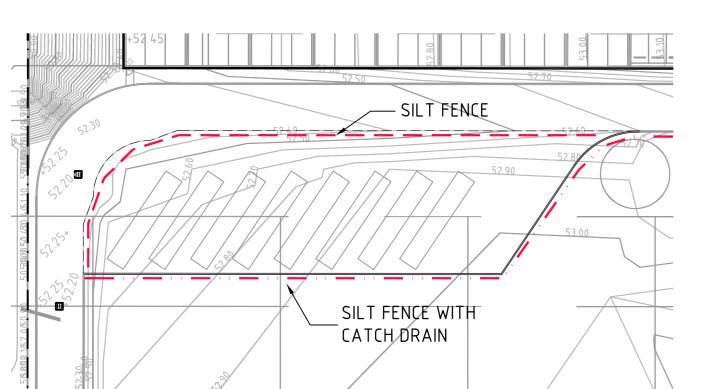

EROSION AND SEDIMENT CONTROL PLAN - TRAILER PARKING AREA


STOCKPILE NOTES

- I. PLACE ALL STOCKPILES IN LOCATIONS MORE THAN 5m FROM EXISTING VEGETATION, ROADS & HAZARD AREAS.
- 2. CONSTRUCT ON THE CONTOUR AS LOW, FLAT ELONGATED MOUNDS.
- SIDE SLOPE TO BE 1 V: 2 H MAX. 3. WHERE THERE IS SUFFICIENT AREA, TOPSOIL STOCKPILES SHALL BE
- LESS THAN 2m IN HEIGHT.
- 4. WHERE STOCKPILES ARE TO BE IN PLACE FOR MORE THAN 10 DAYS,
- STABILISE USING WOOD CHIP MULCH 16 TONNE/Ha.
- 5. CONSTRUCT SILT FENCE WITH CATCH DRAIN ON UPSLOPE SIDE TO DIVERT WATER AROUND STOCKPILES & SILT FENCE ONLY 1 TO 2m DOWNSLOPE AS SHOWN.

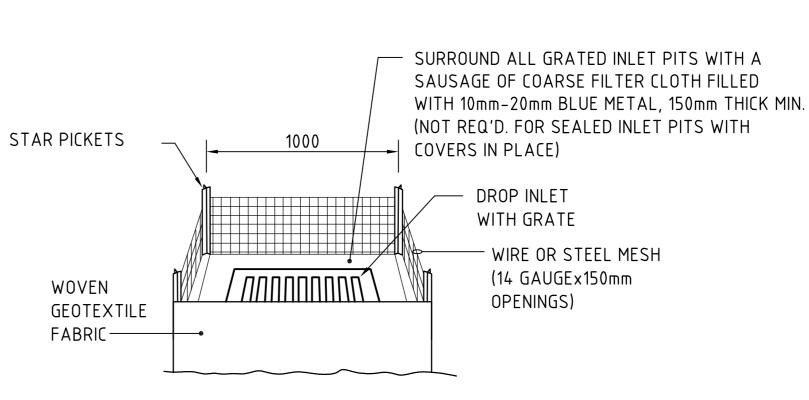

GRATED INLET PIT FILTER DETAIL

N.T.S

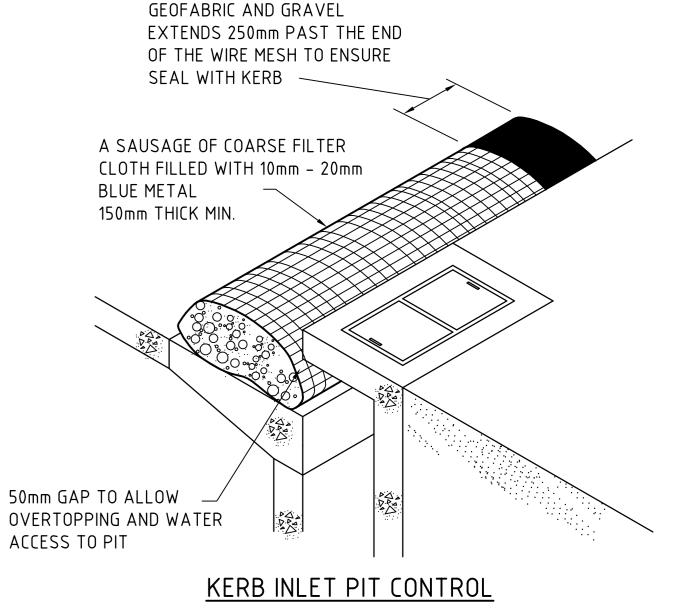

STAR PICKETS AT 3000 CTS.

MAX. DRIVEN 700 MIN. INTO

10mm - 20mm BLUE METAL

TYPICAL OPEN DRAIN & SILT FENCE

No. 8-10 WIRE, WITH FILTER

_ FABRIC TIED TO WIRE &

POSTS SECURELY

GROUND

200 MIN. HIGH

'HYDROMULCH

SCALE 1:20

LINING

NOTE: ADOPT ABOVE DETAILS AROUND ALL PITS WITHIN AREA ENCOMPASSED BY SILT FENCE & TO PITS ON THE ROAD ADJACENT TO SITE BOUNDARY.

EROSION CONTROL NOTES


AMENDMENTS

ALL CONTROL WORK INCLUDING DIVERSION BANKS AND CATCH DRAINS, V-DRAINS AND SILT FENCES SHALL BE COMPLETED DIRECTLY FOLLOWING THE COMPLETION OF THE EARTHWORKS.

- 1. SILT FENCES AND SILT FENCE RETURNS SHALL BE ERECTED CONVEX TO THE CONTOUR TO POND WATER.
- 2. HAY BALE BARRIERS AND GEOFABRIC FENCES ARE TO BE CONSTRUCTED TO TOE OF BATTER, PRIOR TO COMMENCEMENT OF EARTHWORKS, IMMEDIATELY AFTER CLEARING OF VEGETATION AND BEFORE REMOVAL OF TOP SOIL.
- 3. ALL TEMPORARY EARTH BERMS, DIVERSION AND SILT DAM EMBANKMENTS ARE TO BE MACHINE COMPACTED, SEEDED AND MULCHED FOR TEMPORARY VEGETATION COVER AS SOON AS THEY HAVE BEEN FORMED.
- 4. CLEAR WATER IS TO BE DIVERTED AWAY FROM DISTURBED GROUND AND INTO THE DRAINAGE SYSTEM.
- 5. THE CONTRACTOR IS RESPONSIBLE FOR MAINTAINING AND PROVIDING ON GOING ADJUSTMENT TO EROSION CONTROL MEASURES AS REQUIRED DURING CONSTRUCTION.
- 6. ALL SEDIMENT TRAPPING STRUCTURES AND DEVICES ARE TO BE INSPECTED AFTER STORMS FOR STRUCTURAL DAMAGE OR CLOGGING, TRAPPED MATERIAL IS TO BE REMOVED TO A SAFE, APPROVED
- LOCATION. 7. ALL FINAL EROSION PREVENTION MEASURES INCLUDING THE ESTABLISHMENT OF GRASSING ARE TO BE MAINTAINED UNTIL THE END OF THE DEFECTS LIABILITY PERIOD.
- 8. ALL EARTHWORKS AREAS SHALL BE ROLLED ON A REGULAR BASIS TO SEAL THE EARTHWORKS
- 9. ALL FILL AREAS ARE TO BE LEFT WITH A BUND AT THE TOP OF THE SLOPE AT THE END OF EACH DAYS EARTHWORKS. THE HEIGHT OF THE BUND SHALL BE A MINIMUM OF 200MM.
- 10. ALL CUT AND FILL SLOPES ARE TO BE SEEDED AND MULCHED WITHIN 10 DAYS OF COMPLETION OF FORMATION.
- 11. AFTER REVEGETATION OF THE SITE IS COMPLETE AND THE SITE IS STABLE IN THE OPINION OF A SUITABLY QUALIFIED PERSON ALL TEMPORARY WORK SUCH AS SILT FENCE. DIVERSION DRAINS ETC. SHALL BE REMOVED.
- 12. ALL TOPSOIL STOCKPILES ARE TO BE SUITABLY COVERED TO THE SATISFACTION OF THE CONTRACT ADMINISTRATOR TO PREVENT WIND AND WATER EROSION.
- 13. ANY AREA THAT IS NOT APPROVED BY THE CONTRACT ADMINISTRATOR FOR CLEARING OR DISTURBANCE BY THE CONTRACTOR'S ACTIVITIES SHALL BE CLEARLY MARKED AND SIGN POSTED, FENCED OFF OR OTHERWISE APPROPRIATELY PROTECTED AGAINST ANY SUCH DISTURBANCE
- 14. ALL STOCKPILE SITES SHALL BE SITUATED IN AREAS APPROVED FOR SUCH USE BY THE CONTRACT ADMINISTRATOR. A 6m BUFFER ZONE SHALL EXIST BETWEEN STOCKPILE SITES AND ANY STREAM OR FLOW PATH. ALL STOCKPILES SHALL BE ADEQUATELY PROTECTED FROM EROSION AND CONTAMINATION OF THE SURROUNDING AREA BY USE OF THE MEASURES APPROVED IN THE EROSION AND SEDIMENTATION CONTROL PLAN.
- 15. ACCESS AND EXIT AREAS SHALL INCLUDE SHAKE-DOWN OR OTHER METHODS APPROVED BY THE CONTRACT ADMINISTRATOR FOR THE REMOVAL OF SOIL MATERIALS FORM MOTOR VEHICLES.
- 16. THE CONTRACTOR IS TO ENSURE RUNOFF FROM ALL AREAS WHERE THE NATURAL SURFACE IS DISTURBED BY CONSTRUCTION, INCLUDING ACCESS ROADS, DEPOT AND STOCKPILE SITES, SHALL BE FREE OF POLLUTANTS BEFORE IT IS EITHER DISPERSED TO STABLE AREAS OR DIRECTED TO NATURAL WATERCOURSES.
- 17. THE CONTRACTOR SHALL PROVIDE AND MAINTAIN SLOPES, CROWNS AND DRAINS ON ALL EXCAVATIONS AND EMBANKMENTS TO ENSURE SATISFACTORY DRAINAGE AT ALL TIMES WATER SHALL NOT BE ALLOWED TO POND ON THE WORKS UNLESS SUCH PONDING IS PART OF AN APPROVED ESCP / SWMP.

DATE ISSUE

18. THE CONTRACTOR SHALL INCORPORATE THE MEASURES ON THIS PLAN WITHIN THE CONTRACTORS CONSTRUCTION MANAGEMENT PLAN.

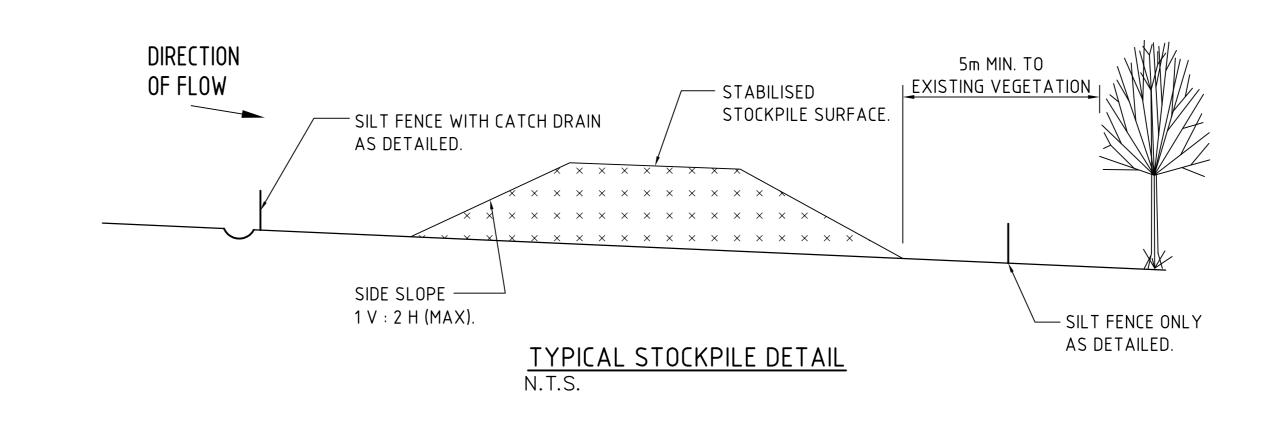

FOR DEVELOPMENT APPLICATION

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SCALE 1:750 AT B1 PLOT

- SILT FENCE ONLY

PROVIDE 1m RETURNS TO SILT FENCE AT 30m MAX. INTERVALS

- SILT FENCE WITH CATCH DRAIN.

FOR DEVELOPMENT APPLICATION 07.11.12 FOR DEVELOPMENT APPLICATION 24.10.12 FOR DEVELOPMENT APPLICATION 22.10.12 24.08.12 REVISION AS CLOUDED 14.08.12 FOR INFORMATION ONLY

DATE ISSUE AMENDMENTS

GILES TRIBE ARCHITECTS LEVEL 8, 263 CLARENCE STREET SYDNEY NSW 2000

Fax (02) 9230 7444

LEVEL 10, 60 Castlereagh Street SYDNEY NSW, 2000, Australia Tel (02) 9230 7400

METCASH DISTRIBUTION CENTRE PROJECT MUSTANG BUNGARRIBEE I.E, HUNTINGWOOD NSW

DESIGNED DRAWN DATE CHECKED SIZE SCALE M.W. M.C. 07.08.12 B1 AS SHOV

ACEA B1 AS SHOWN

Costin Roe Consulting Pty Ltd. Consulting Engineers ACN 003 696 446 Level 1, 8 Windmill Street Walsh Bay, Sydney NSW 2000 Tel: (02) 9251-7699 Fax: (02) 9241-3731 email: mail@costinroe.com.au ©


Costin Roe

LEGEND:

TYPICAL (N.S.O.P.)

EROSION AND SEDIMENT CONTROL Consulting PLAN AND DETAILS

Co 9628.03-DA20

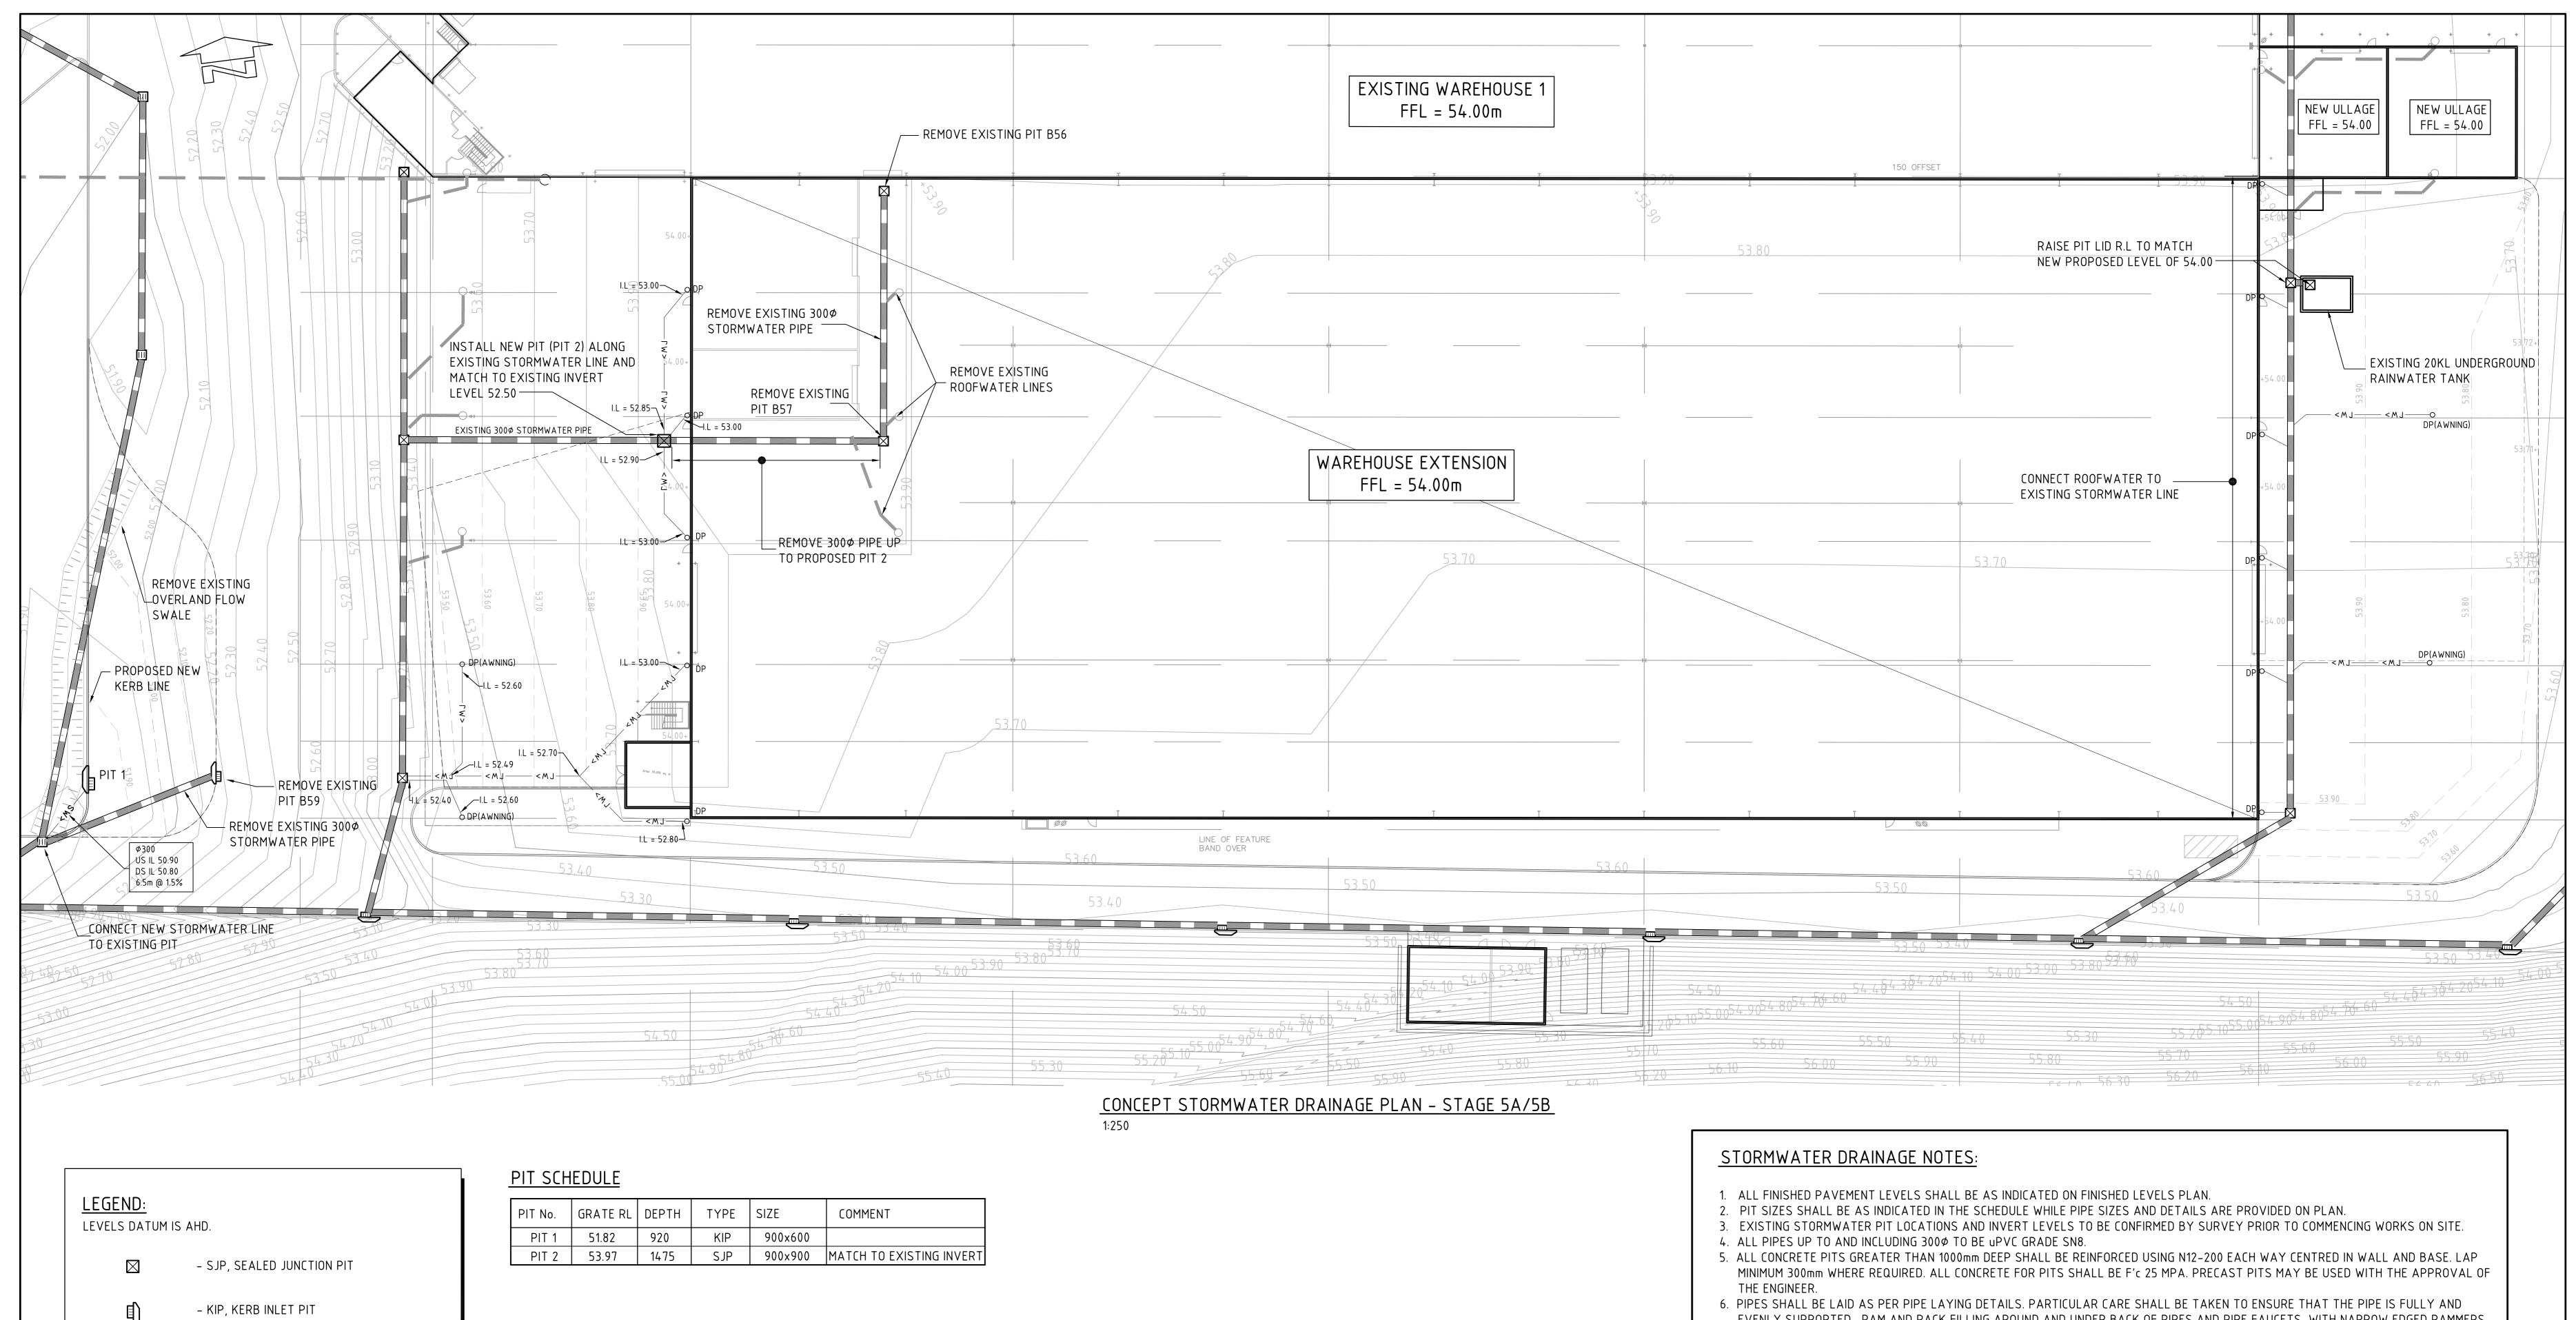

P – DOWNPIPE. REFER TO HYDRAULIC ENGINEERS DRAWINGS

- EXISTING DRAINAGE LINE

- EXISTING ROOFWATER LINE

— — 50.00 — — - FINISHED PAVEMENT CONTOUR (MAJOR)

0.5m INTERVALS

— — ^{50.10} — — FINISHED PAVEMENT CONTOUR (MINOR)

0.1m INTERVALS


- EVENLY SUPPORTED. RAM AND PACK FILLING AROUND AND UNDER BACK OF PIPES AND PIPE FAUCETS, WITH NARROW EDGED RAMMERS OR OTHER SUITABLE TAMPING DETAILS.
- 7. WHERE PIPE LINES ENTER PITS, PROVIDE 2m LENGTH OF STOCKING WRAPPED SLOTTED \$100 uPVC TO EACH SIDE OF PIPE.
- 8. ALL SUBSOIL DRAINAGE LINES SHALL BE Ø100 SLOTTED uPVC WITH APPROVED FILTER WRAP LAID IN 300mm WIDE GRANULAR FILTER UNLESS NOTED OTHERWISE. LAY SUBSOIL LINES TO MATCH FALLS OF LAND AND/OR 1 IN 200 MINIMUM. PROVIDE CAPPED CLEANING EYE (RODDING POINT) AT UPSTREAM END OF LINE AND AT 30m MAX. CTS. PROVIDE SUBSIOL LINES TO ALL PAVEMENT/ LANSCAPED INTERFACES, TO REAR OF RETAINING WALLS (AS NOMINATED BY STRUCUTRAL ENGINEER) AND AS SHOWN ON PLAN.
- 9. ALL PIPE GRADES 1 IN 100 MINIMUM UNO.
- 10. PROVIDE STEP IRONS IN PITS DEEPER THAN 1000mm.
- 11. MIN. 600 COVER TO PIPE OBVERT BENEATH ROADS & MIN. 400 COVER BENEATH LANDSCAPED AND PEDESTRIAN AREAS.
 12. PIT COVERS IN TRAFFICABLE PAVEMENT SHALL BE CLASS D 'HEAVY DUTY', THOSE LOCATED IN NON-TRAFFICABLE AREAS SHALL BE
- CLASS B 'MEDIUM DUTY' U.N.O.

 13. PROVIDE CLEANING EYES (RODDING POINTS) TO PIPES AT ALL CORNERS AND T-JUNCTIONS WHERE NO PITS ARE PRESENT.
- 14. DOWN PIPES TO BE AS PER HYDRAULIC ENGINEERS DETAILS WITH CONNECTOR TO MATCH DP SIZE U.N.O. ON PLAN. PROVIDE CLEANING
 EYE AT GROUND LEVEL.
- 15. PIPE LENGTHS NOMINATED ON PLAN OR LONGSECTIONS ARE MEASURED FROM CENTER OF PITS TO THE NEAREST 0.5m AND DO NOT REPRESENT ACTUAL LENGTH. THE CONTRACTOR IS TO ALLOW FOR THIS.

FOR DEVELOPMENT APPLICATION

2m 0 5 10 15 20 25

Costin Roe Consulting Pty Ltd.
Consulting Engineers ACN 003 696 446 CONCEPT STORMWATER DRAINAGE GILES TRIBE ARCHITECTS LEVEL 10, 60 Castlereagh Street METCASH DISTRIBUTION CENTRE ACEA Costin Roe Consulting PLAN - STAGE 5A/5B FOR DEVELOPMENT APPLICATION 07.11.12 PROJECT MUSTANG SYDNEY NSW, 2000, Australia LEVEL 8, 263 CLARENCE STREET Level 1, 8 Windmill Street Walsh Bay, Sydney NSW 2000 24.10.12 FOR DEVELOPMENT APPLICATION BUNGARRIBEE I.E. HUNTINGWOOD NSW SYDNEY NSW 2000 FOR DEVELOPMENT APPLICATION 22.10.12 Tel (02) 9230 7400 Tel: (02) 9251-7699 Fax: (02) 9241-3731 14.08.12 FOR INFORMATION ONLY Fax (02) 9230 7444 Co9628.03-DA40 DESIGNED DRAWN DATE
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- EXISTING ROOFWATER LINE

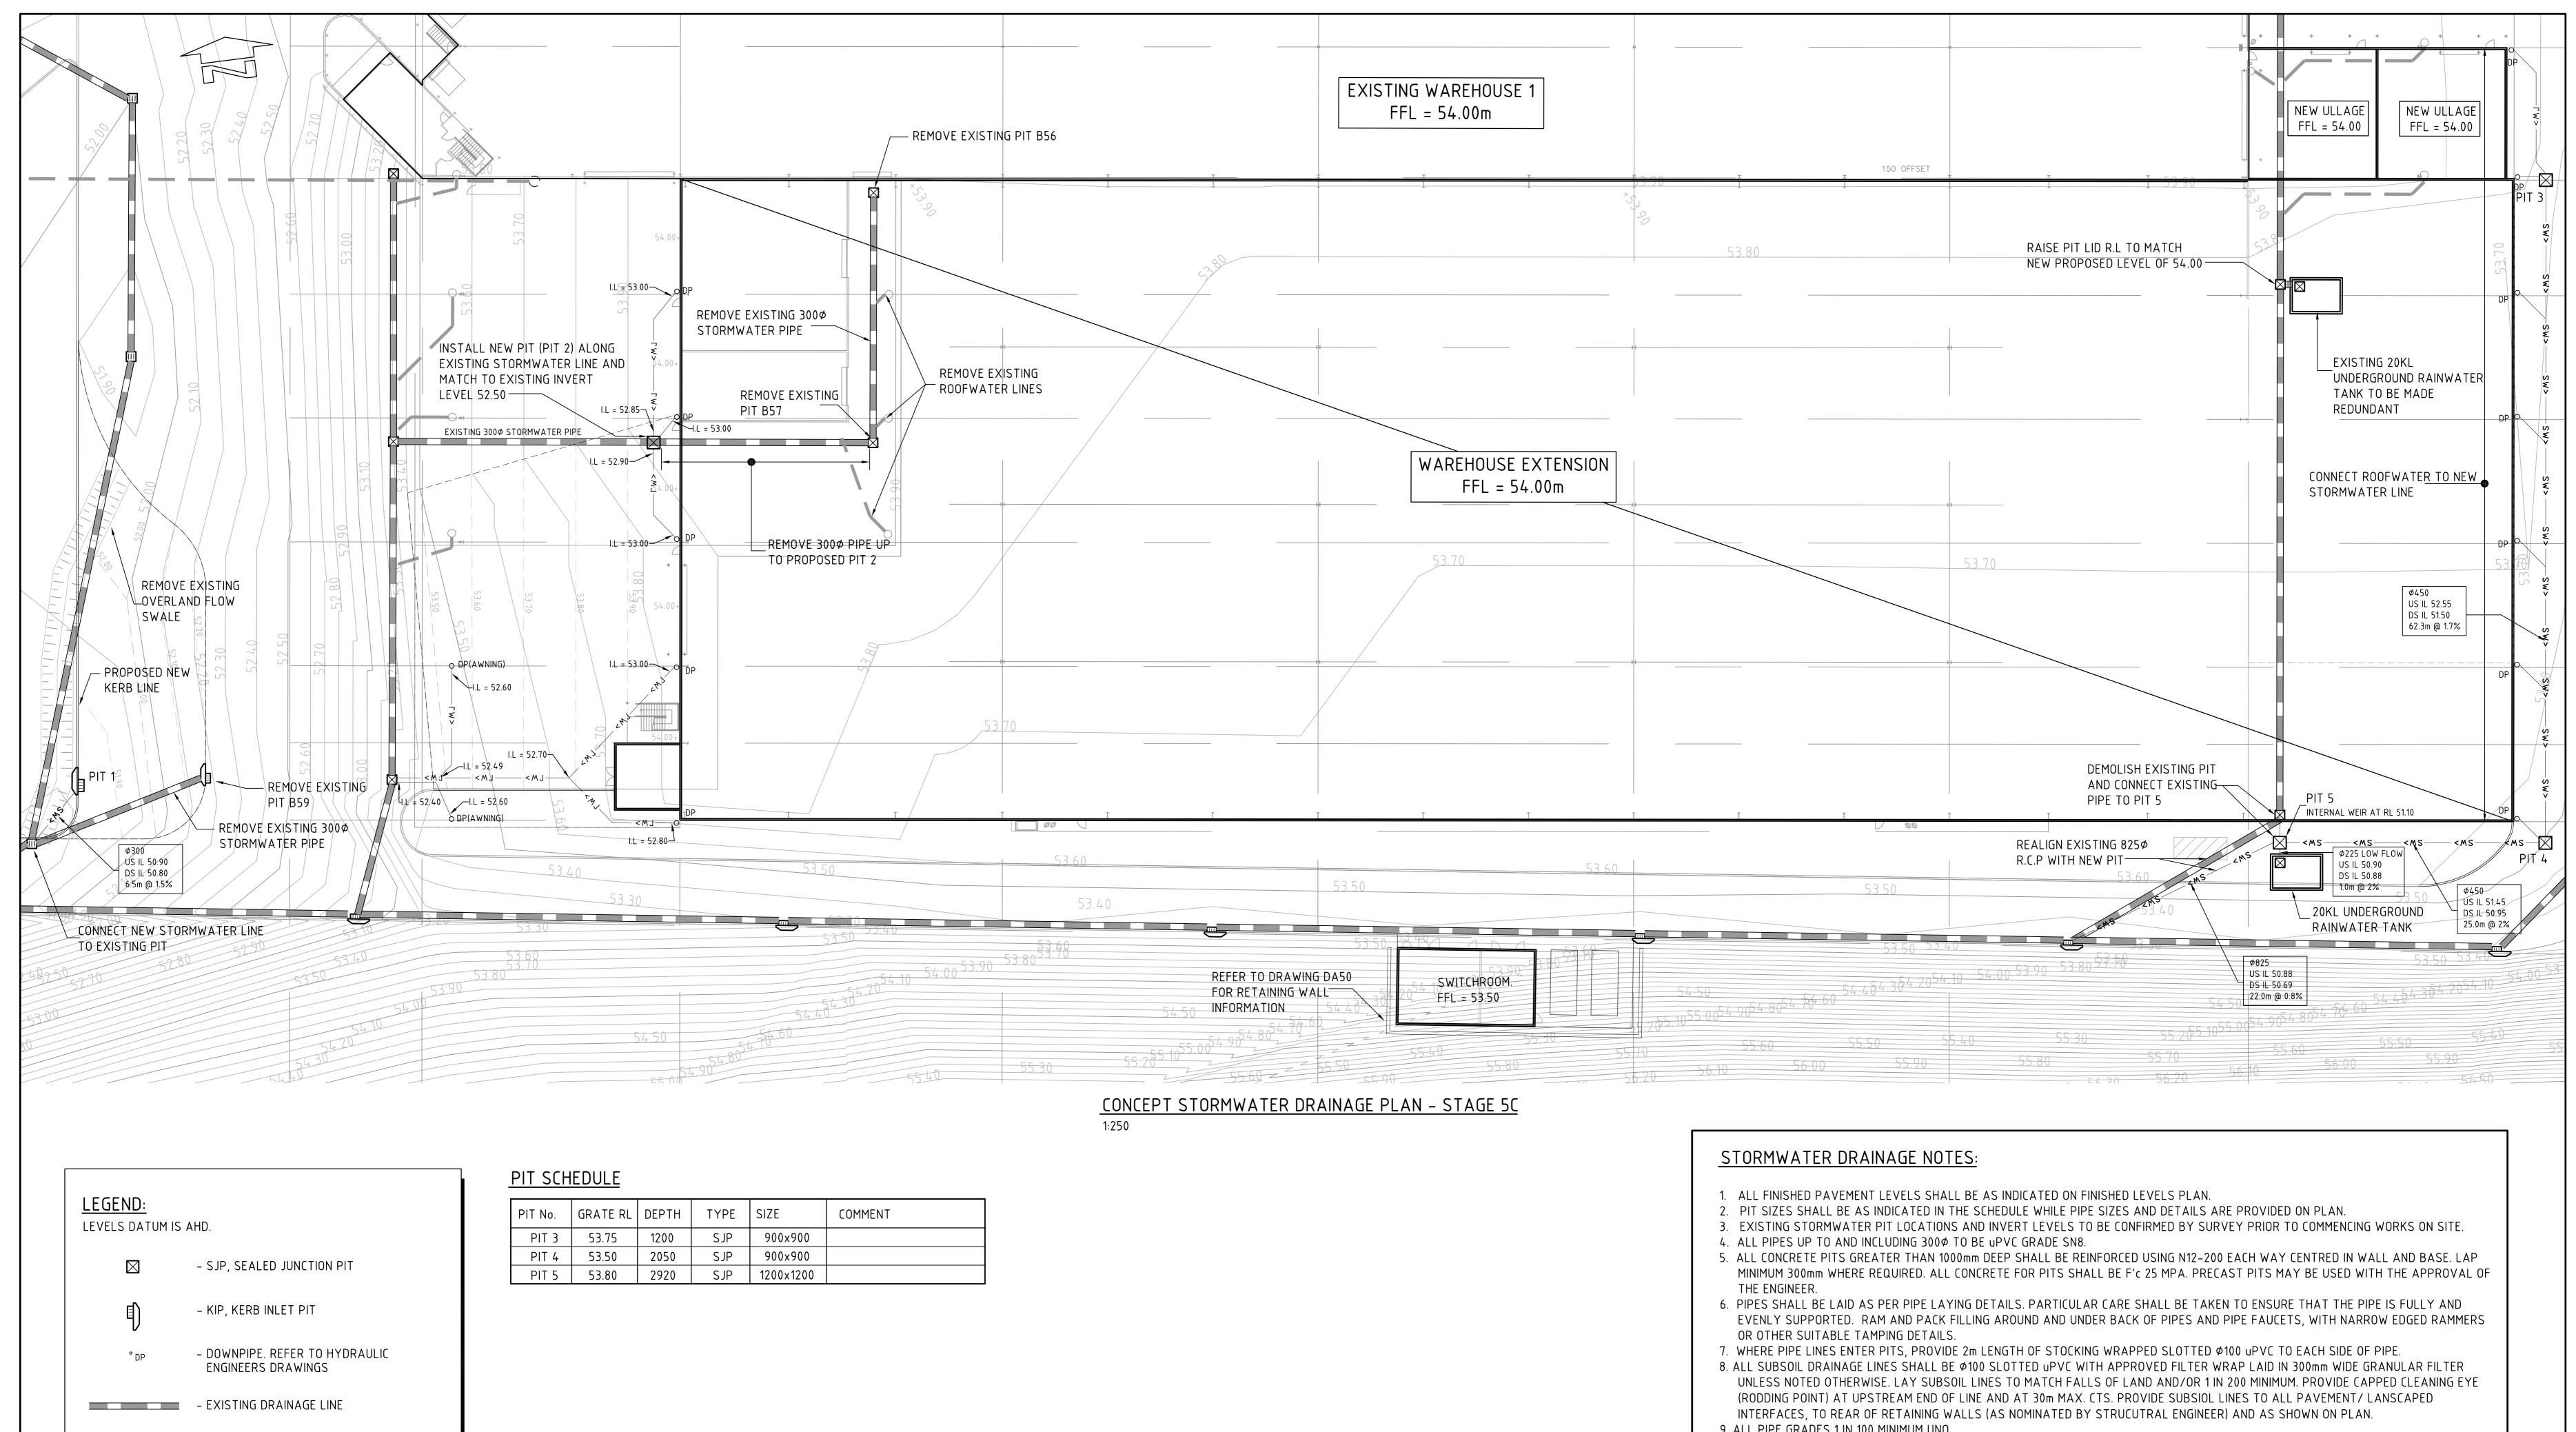— — ^{50.00} — — - FINISHED PAVEMENT CONTOUR (MAJOR) 0.5m INTERVALS

 $---\frac{50.10}{100}$ - FINISHED PAVEMENT CONTOUR (MINOR) 0.1m INTERVALS


_____rw> ____ - ROOFWATER LINE


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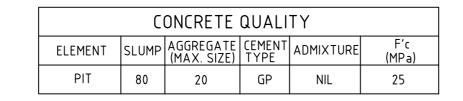
FOR DEVELOPMENT APPLICATION

SCALE 1:250 AT B1 PLOT

Costin Roe Consulting Pty Ltd.
Consulting Engineers ACN 003 696 446 Costin Roe Consulting CONCEPT STORMWATER DRAINAGE PLAN - STAGE 5C ACEA GILES TRIBE ARCHITECTS LEVEL 10, 60 Castlereagh Street METCASH DISTRIBUTION CENTRE PROJECT MUSTANG SYDNEY NSW, 2000, Australia LEVEL 8, 263 CLARENCE STREET Level 1, 8 Windmill Street Walsh Bay, Sydney NSW 2000 BUNGARRIBEE I.E, HUNTINGWOOD NSW SYDNEY NSW 2000 FOR DEVELOPMENT APPLICATION 07.11.12 Tel (02) 9230 7400 Tel: (02) 9251-7699 Fax: (02) 9241-3731 24.10.12 FOR DEVELOPMENT APPLICATION Fax (02) 9230 7444 Co9628.03-DA41 DESIGNED DRAWN DATE
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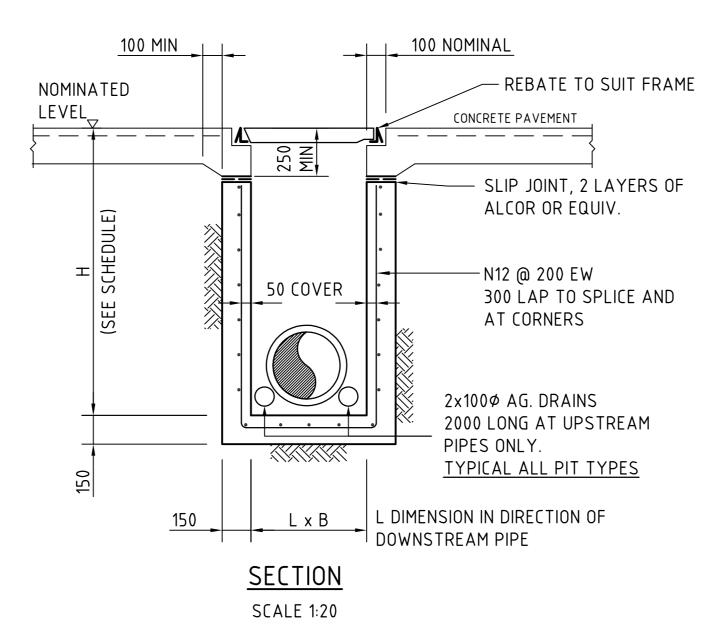




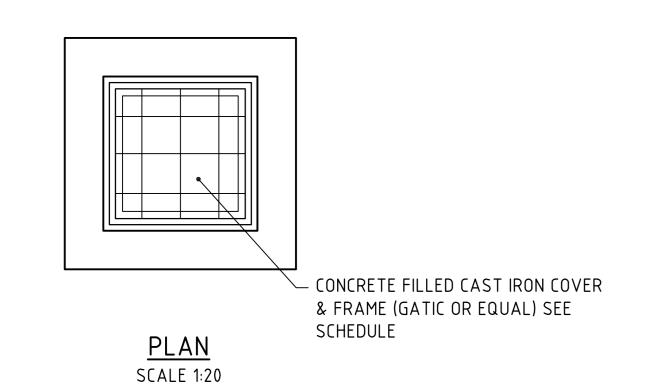

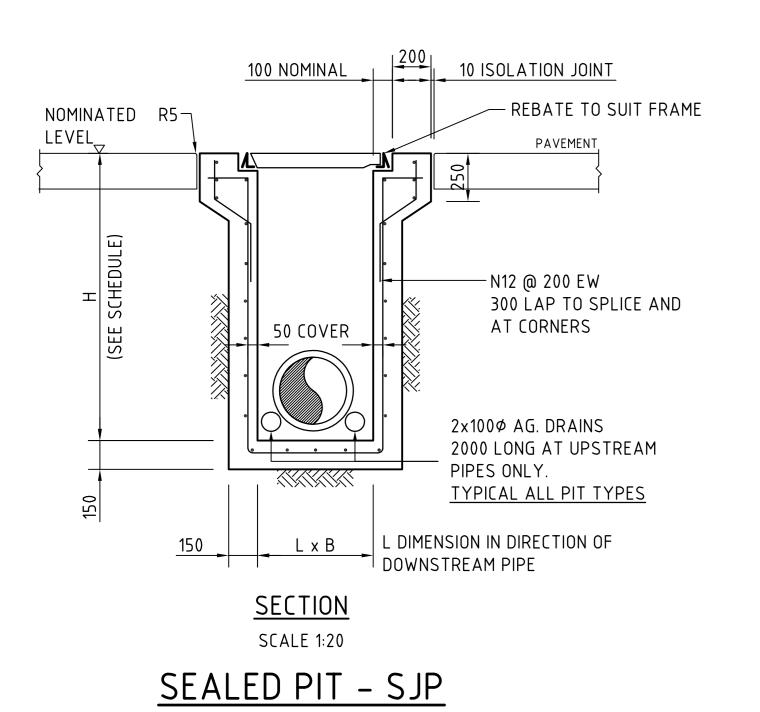
PIT NOTES:


- 1. WHERE GULLY PIT IS LOCATED ON KERB RETURNS OR BULB OF CUL-DE-SACS PROVIDE CURVED PRECAST CONCRETE LINTELS.
- 2. SAG PITS SHALL HAVE LINTEL PLACED CENTRALLY ABOUT THE GRATE.
- 3. ALL REINFORCING TO HAVE 30 MIN. CLEAR CONCRETE COVER.
- 4. FOR PITS DEEPER THAN 1000mm CLIMB RAILS SHALL BE PROVIDED.



ALTERNATIVE PIT DETAIL GRATE/COVER SUPPORT CAST-INTO PAVEMENT SLAB

(ADOPT AS REQUIRED FOR SGGP's & SJP's)

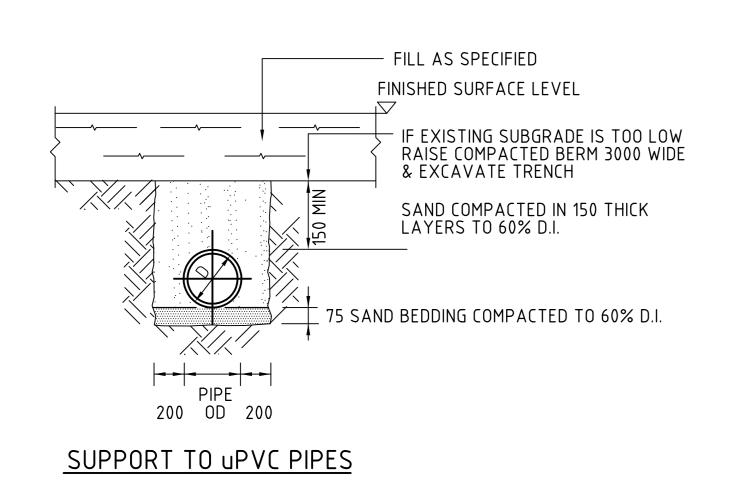

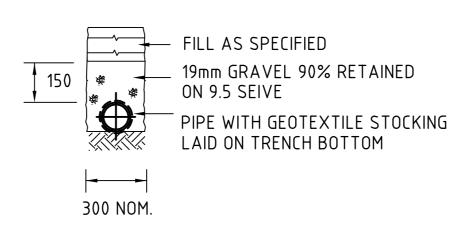



SUPPORT	ΤN	ΔG	DRAIN

BEDDING & HAUNCH MATERIAL GRADING			
SIEVE SIZE	WEIGHT PASSING(%)		
19	100		
2.36	100 TO 50		
0.60	90 TO 20		
0.30	60 TO 10		
0.15	25 TO 0		
0.075	10 TO 0		


SIDE ZONE MATERIAL GRADING		
SIEVE SIZE	WEIGHT PASSING(%)	
75 9.5 2.36 0.60 0.075	100 100 TO 50 100 TO 30 50 TO 15 25 TO 0	

SELECT FILL MATERIAL IN ACCORDANCE WITH TABLE 1 AS 3725

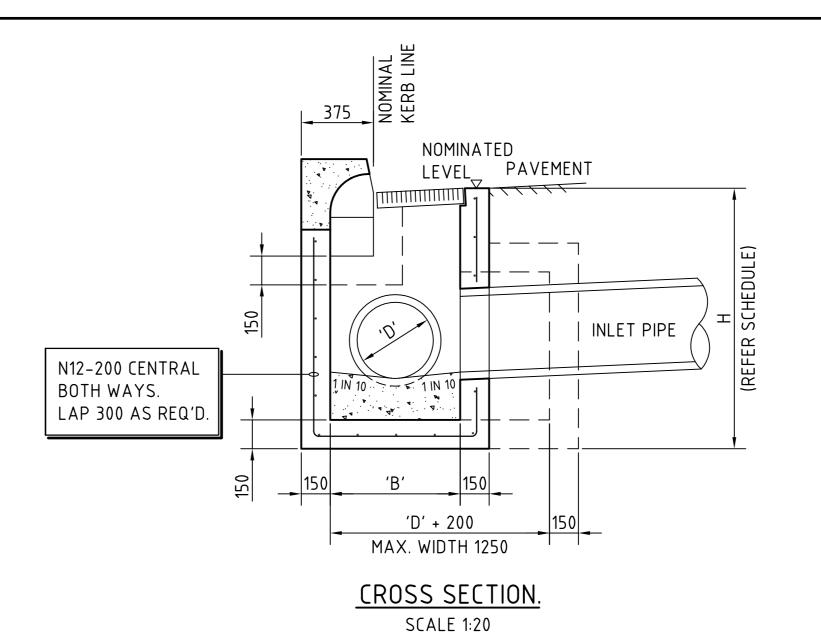

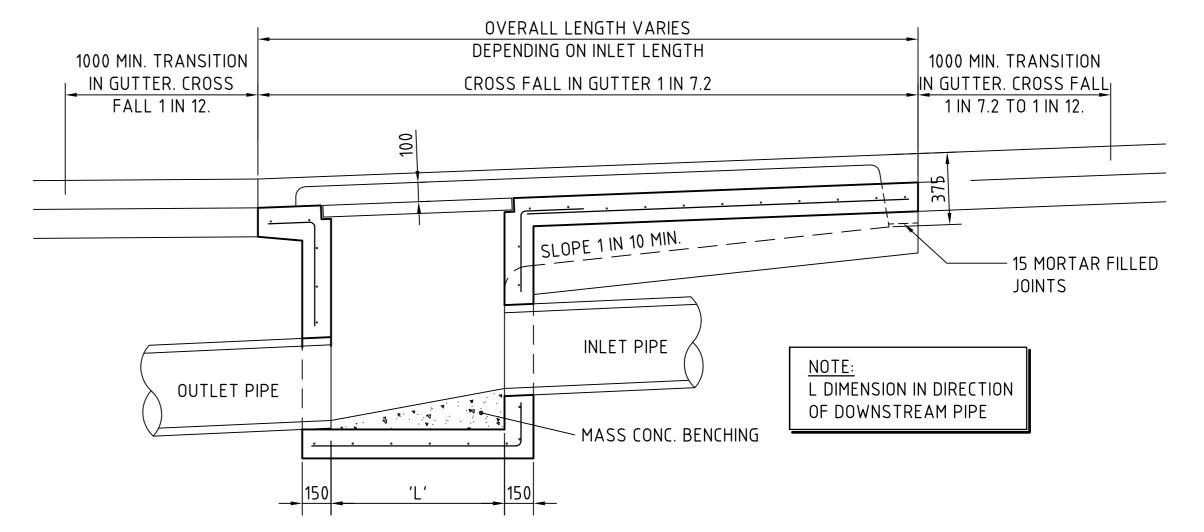

LONGITUDINAL SECTION SCALE 1:20

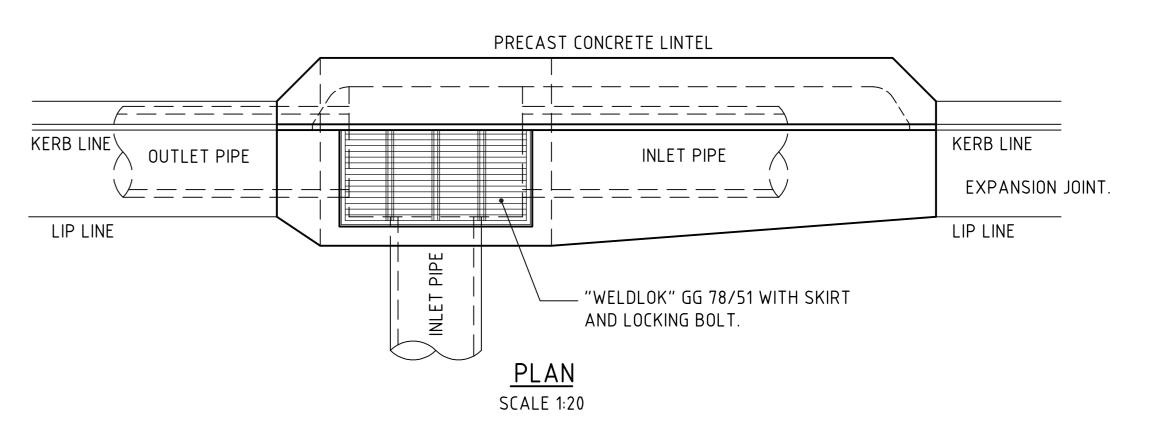

KERB INLET PIT - KIP

PIPE LAYING DETAILS

FOR DEVELOPMENT APPLICATION

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Costin Roe Consulting DETAILS

200mm 0

CONCEPT STORMWATER DRAINAGE

DRAWING No Co9628.03-DA45

ACEA

SCALE 1:20 AT B1 SIZE PLOT

B1 AS SHOWN

Co9628.03-DA45

