# Garden Centre and Hardware & Building Supplies, ENDFIELD

127 COSGROVE ROAD SOUTH STRATHFIELD NSW

LANDSCAPE PLAN 31 July 2017 RevC



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### LANDSCAPE MAINTENANCE

THE CONTRACTOR SHALL CONTINUOUSLY MAINTAIN ALL AREAS OF THE CONTRACT DURING THE PROGRESS OF THE WORKS. THE CONTRACTOR SHALL COMMENCE AND FULLY IMPLEMENT THE SHORT-TERM MAINTENANCE AND ESTABLISHMENT AFTER PRACTICAL

SITE CONTROL: REPORT TO THE PRINCIPAL'S DESIGNATED REPRESENTATIVE ON ARRIVING AT AND BEFORE LEAVING THE SITE PLANT ESTABLISHMENT PERIOD: THE PERIOD BETWEEN THE DATE OF PRACTICAL COMPLETION AND THE DATE OF FINAL COMPLETION. MAINTENANCE/ ESTABLISHMENT PERIOD: 12 MONTHS.

PLANT ESTABLISHMENT: MAINTAIN THE CONTRACT AREA DURING THE PLANT ESTABLISHMENT PERIOD. ENSURE THE GENERAL APPEARANCE AND PRESENTATION OF THE LANDSCAPE AND THE QUALITY OF PLANT MATERIAL AT DATE OF PRACTICAL COMPLETION IS MAINTAINED FOR THE FULL PLANTING ESTABLISHMENT PERIOD.

EXISTING PLANT MATERIAL: MAINTAIN EXISTING PLANTING WITHIN THE LANDSCAPE CONTRACT AREA AS SPECIFIED FOR NEW PLANTING. REPLACEMENTS: REPLACE FAILED, DEAD AND/OR DAMAGED PLANTS AT MINIMUM 3 WEEK INTERVALS AS NECESSARY THROUGHOUT THE FULL

REPORTING: SUBMIT REGULAR REPORTS BY THE LAST FRIDAY OF EACH MONTH SUMMARISING THE GENERAL STATUS OF WORKS. INCLUDE A MAINTENANCE SCHEDULE, A LOG BOOK OF MAINTENANCE ACTIVITY, SOIL TEST RESULTS AS REQUIRED FOR ANY FERTILISING PROGRAMS, AND PLANT REPLACEMENT REQUIREMENTS.

WATER RESTRICTIONS: COORDINATE THE WATER SUPPLY AND CONFIRM THE WATERING REGIME AGAINST RELEVANT GOVERNMENT LEGISLATION AND RESTRICTIONS AT THE TIME.

STAKES AND TIES: REMOVE AT THE END OF THE PLANTING ESTABLISHMENT PERIOD.
TEMPORARY FENCES: REMOVE TEMPORARY PROTECTIVE FENCES AT THE END OF THE PLANTING ESTABLISHMENT PERIOD.

COMPLIANCE: PLANT ESTABLISHMENT SHALL BE DEEMED COMPLETE, SUBJECT TO THE FOLLOWING: \* REPAIRS TO PLANTING MEDIA COMPLETED.

\* PESTS, DISEASE, OR NUTRIENT DEFICIENCIES OR TOXICITIES ARE NOT EVIDENT.

\* MULCHED SURFACES HAVE BEEN MAINTAINED IN A WEED FREE AND TIDY

CONDITION AND TO THE SPECIFIED DEPTH. \* VEGETATION IS ESTABLISHED AND WELL FORMED.

\* PLANTS HAVE HEALTHY ROOT SYSTEMS.

\* VEGETATION IS NOT RESTRICTING ESSENTIAL SIGHT LINES AND SIGNAGE.

\* COLLECTION AND REMOVAL OF LITTER COMPLETED. \* REMOVAL OF MULCH FROM DRAINAGE AND ACCESS AREAS COMPLETED.

\* ALL DEFECTS NOTIFICATIONS HAVE BEEN CLOSED OUT.

### DRIP IRRIGATION PERFORMANCE SPECIFICATION

All Garden Beds and Planter Boxes are to be provided with a drip irrigation system and two taps with removebale water keys, connected to a pump and the rainwater tank.

Design, supply and install a permanent, fully automated drip irrigation system. The system is to cover all new garden areas to the extent shown on the drawings. Water is to be delivered via sub surface drippers and/or drip lines. The system is to be capable of supplying 32mm of water/week over all irrigated areas. It is to be designed to operate for a minimum of 10 years. All lines are to be buried below the finished ground level. Pits are to be set on a 200mm deep bed of gravel. Pit covers are to be level with the soil surface. Avoid seepage onto pavement, buildings or other structures. Include plumbing connection to main, main valve and backflow prevention. Central controller/programmer to be located in a lockable box in nominated location to be approved prior to installation. A dedicated GPO is to be provided for the controller to be plugged into. All work is to be approved by the local regulatory authority. Prepare as installed drawings and


The Contractor is to submit documents of the design and specification for the irrigation system for approval prior to commencement of work. Equipment is to comply with AS 2698.1 & as 2698.3.

Connect to pumps connect to the rainwater tanks.

### **Planting Schedule**

<b>Botanical Name</b> TREES	Common Name	Pot Size	Height (m)	<u>Ouantity</u>
Acer palmatum Senkaki	Coral Bark Maple	100L	8	3
Cercis siliquastrum	Judas tree	75Lt	6	6
Elaeocarpus reticulatus	Blueberry Ash	45L	8	30
Farxinus raywoodii	Claret Ash	45L	8	1
Magnolia Soulangenea	Magnolia	45L	6	3
Magnolia stellata	Star Magnolia	45L	6	13
Prunus snofozam	Little gem	45L	4	7
Prunus blireana	Sweeper Foliage	45L	6	11
Pyrus calleryana	Capital Pear	45L	9	14
Zelkova serrata	Green Vase	100L	12	12
SHRUBS				
Callistemon endevour	Endevour Bottlebrush	200mm	2	9
Cordyline fruticosa	Ti Plant	200mm	1	80
Cordyline Red Sensation	Red Sensation	200mm	1.5	37
Doryanthes excelsa	Gymea Lilly	200mm	1.2	53
Gardenia augusta	Gardenia	200mm	1	29
Murraya paniculata	Orange Jassmine	200mm	2	10
Photinia robusta	Photinia	200mm	1.5	115
Raphiolepis 'Oriental Pearl'	Oriental Pearl	200mm	1	36
Viburnum odoratissimum	Sweet Viburnum	200mm	2	116
GROUNDCOVERS/ACCENTS				
Acacia cognata	Limelight Acacia	150mm	0.6	90
Ajuga reptans	Carpet Bugle	150mm	0.2	180
Alcantarea purpurea	Silver Plum	150mm	1	40
Angiozanthus sp	Red kangoroo Paw	150mm	0.6	12
Agapanthus africanus	African Lilly	150mm	0.6	130
Arthropodium cirratum	Renga Lilly	150mm	0.6	130
Baekea virgata nana	Dwarf Heath Myrtle	150mm	8.0	150
Banksia spinulosa	Birthday Candles	150mm	0.5	110
Bergenia x schmitdtii	Bergenia	150mm	0.5	90
Clivia minata	Clivia	150mm	0.6	300
Dianella caerullea	Flax Lilly	150mm	0.6	130
Dichondra silver falls	Silver Falls Kidney Weed	150mm	0.2	250
Hemerocallis stella	Daylilly	150mm	0.8	20
Liriope muscari	Turf Lilly Royale Purple	150mm	0.5	100
Lomandra hystrix	Slender Mat Rush	150mm	0.5	500
Lomandra Tanika	Fine Leafed Mat Rush	150mm	0.5	500
Myoporum parvivolium	Yareena Creeping Boobiala	150mm	0.5	100
Philodendron 'Xanadu'	Xanadu	150mm	1	90
Viola hederacea	Native Violet	150mm	0.1	50



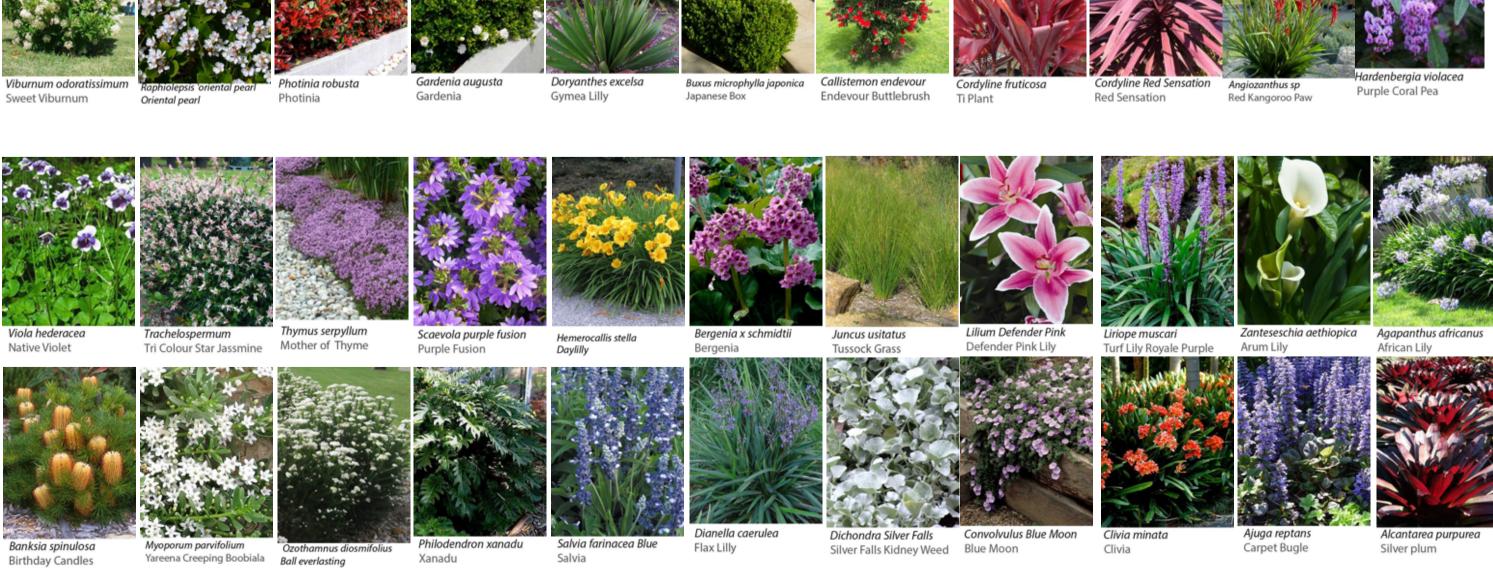

## FOR DEVELOPMENT APPLICATION ONLY

#### **AMENDMENTS** -

ISSUE DATE COMMENT

A/2 17.03.16 ISSUE FOR APPROVAL

GENERAL NOTES


All work to be carried out in accordance with the Building Code of Australia, all Local and State Government Ordinances, relevant Australian Standards, all Local and State Government Ordinances, relevant Australian Standards, Local Authorities Regulations and all other relevant Authorities concerned. All structural work and site drainage to be subject to Engineer's details or certification where required by Council. This shall include r.c. slabs and footings, r.c. and steel beams & columns, wind bracing to AS 1170 and AS4055, anchor rods or bolts, tie downs, fixings etc., drivings and designed to Councills and information and the control of the standard standard to the standard standa drainage to Council's satisfaction. All timbers to be in accordance with SAA Timber Structure Code AS1720 and SAA Timber Framing Code AS 1684. All work to be carried out in a professional and workman- shiplike manner according to the plans and specification.

Do not scale off the drawings unless otherwise stated and use figured dimensions in preference.

All dimensions are to be checked and verified on site before the commencement of any work, all dimensions and levels are subject to final survey and set-out

No responsibility will be accepted by Sitedesign for any variations in design builder's method of construction or materials used, deviation from specification without permission or accepted work practices resulting in inferior construction. Locate and protect all services prior to construction.

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LEGEND : As Selected Paver Building Area Retaining Wall creating gardens to live in and enjoy

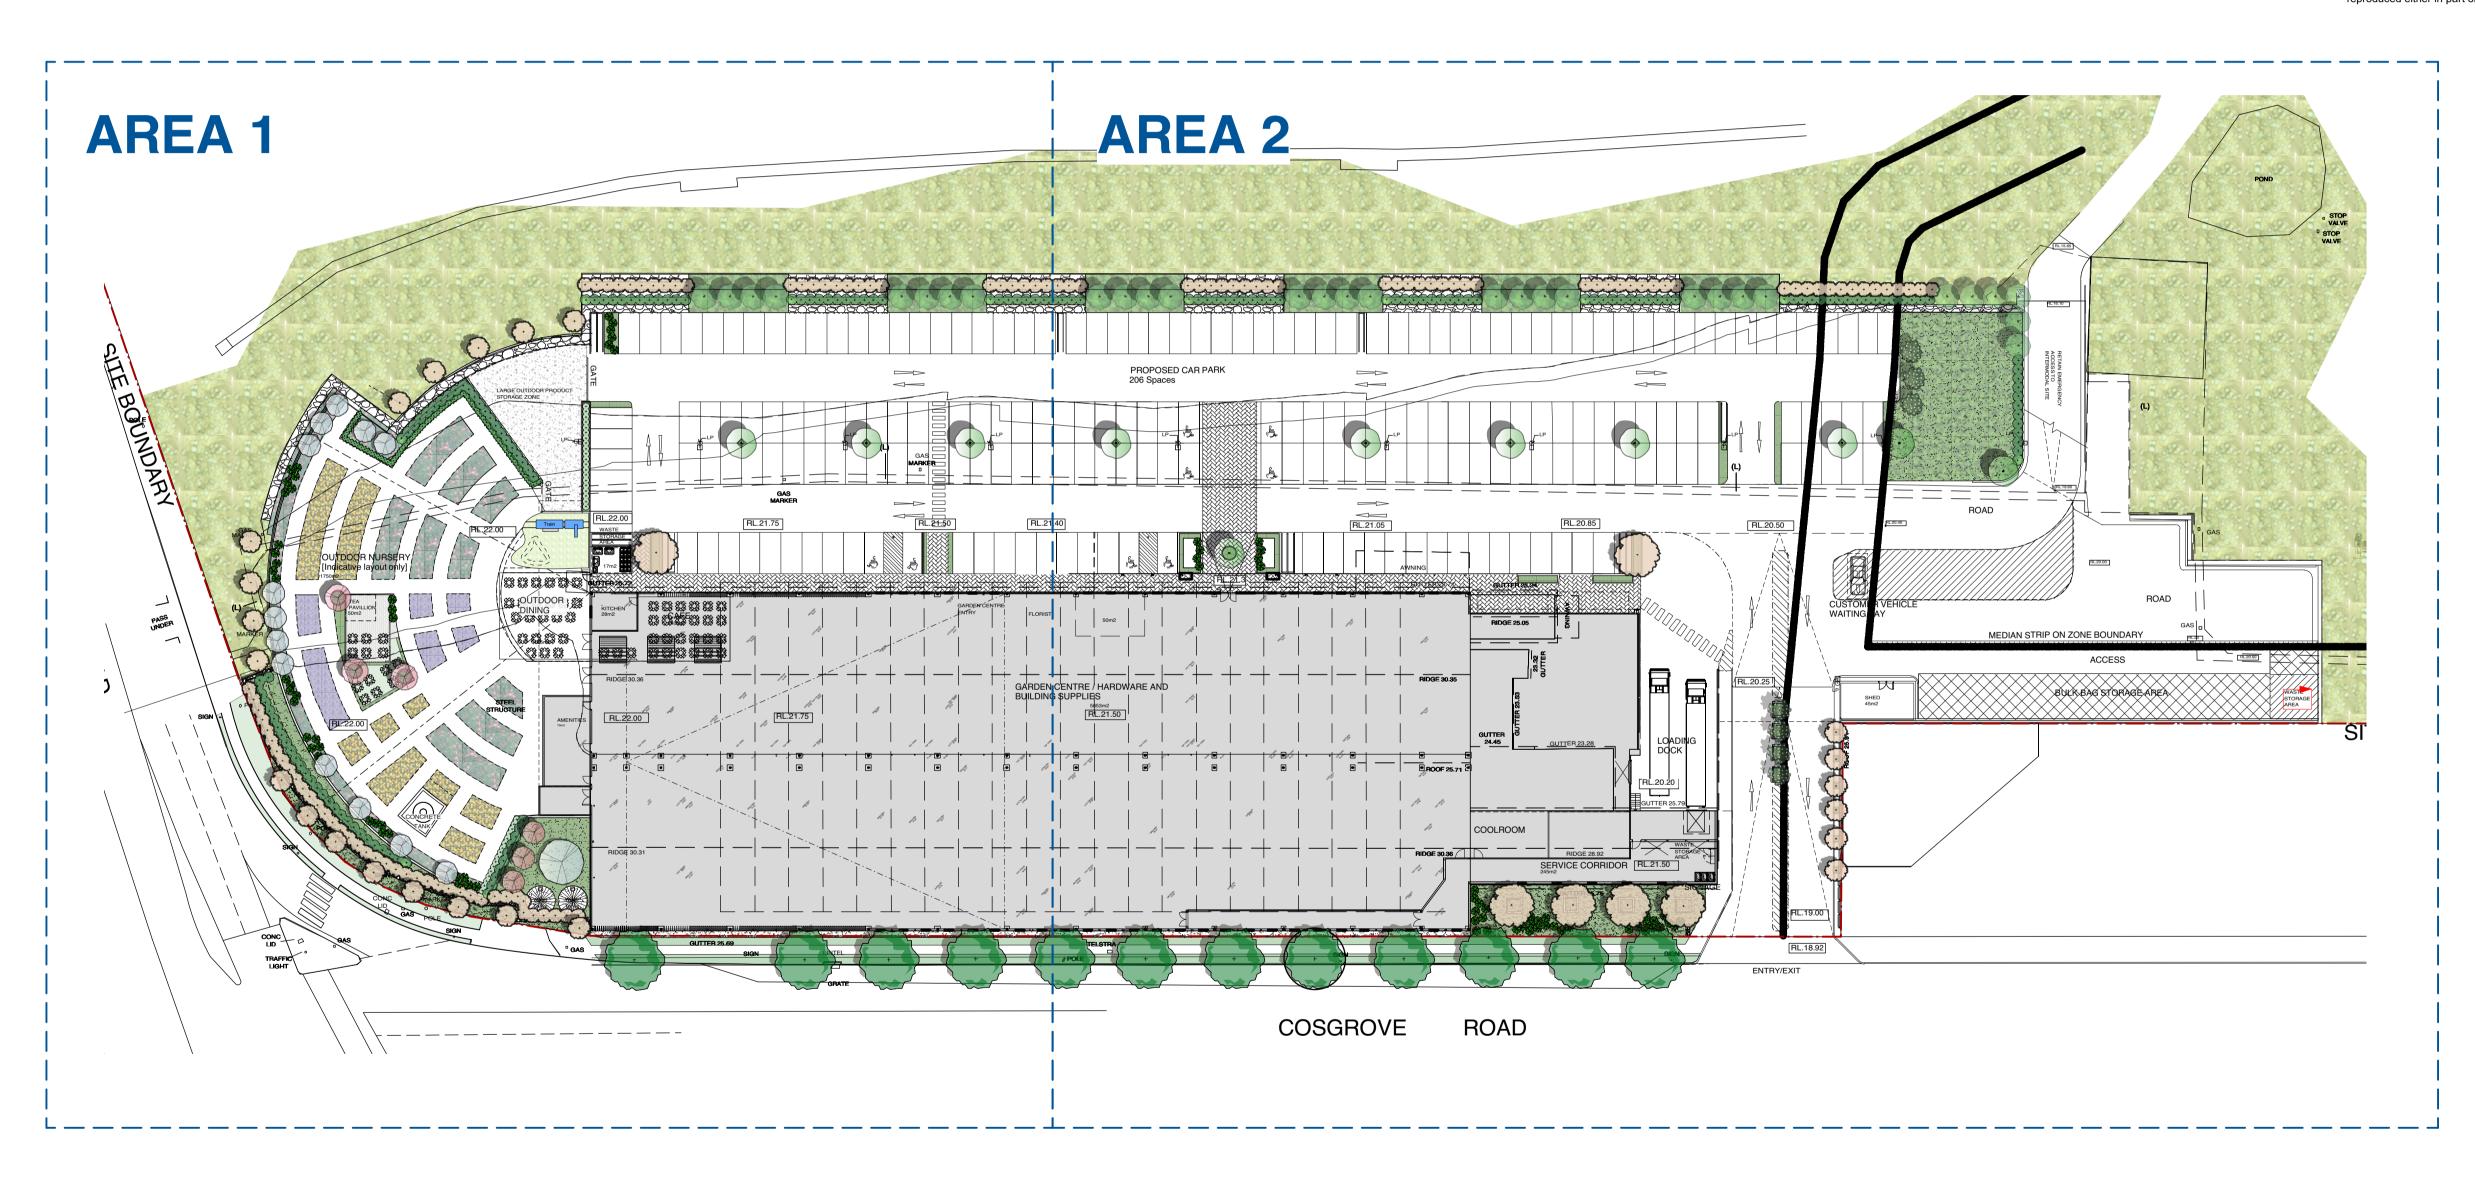

SITEDESIGN +STUDIOS

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Revision

Drawing No.

SITE LANDSCAPE PLAN **Drawing Title** 

Scale 1:500 @A1

17.03.16

A/3

