Sydney Metro Martin Place Integrated Station Development Stage 2 SSD DA North Site

Signage Strategy March 2019

dıadem


Sydney Metro Martin Place North Tower, Sydney

Building Signage Illustratives Issue 06

Macquarie Group

MACG20903 7 March 2019



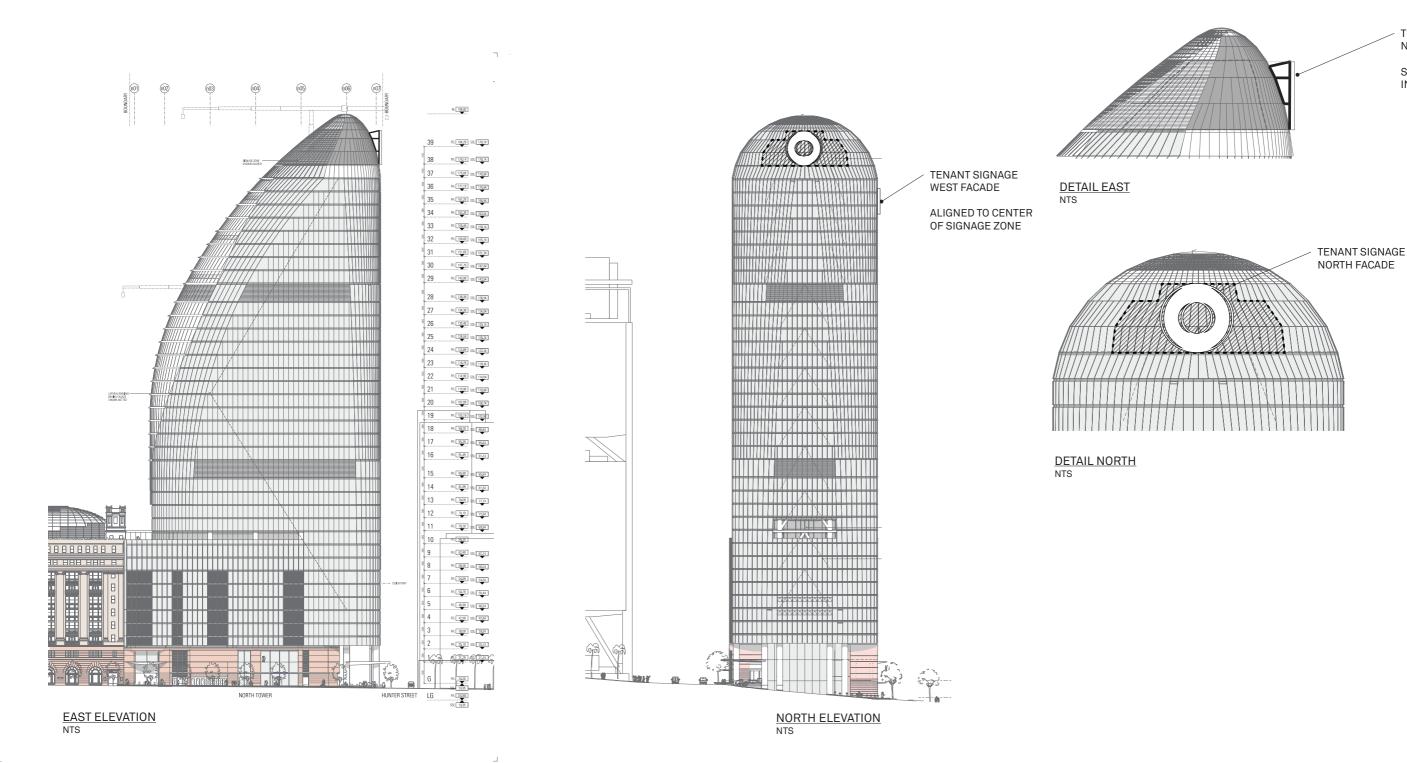


TENANT SIGNAGE NORTH FACADE


STRUCTURE SHOWN INDICATIVELY


INSTALLATION METHODOLOGY - WITHOUT COWLING THE PROPOSED INSTALLATION METHODOLOGY IS TO MOUNT THE HOLEY DOLLAR VERTICALLY, NOTING AS THE FAÇADE CURVES UP AND AWAY FROM THE VERTICALLY PLACED SIGN THIS FORMS A WEDGE SHAPED VOID BETWEEN REAR OF SIGN AND FÁÇADE AS INDICATED THE ELEVATIONS.


- HOLEY DOLLAR MOUNTED VERTICALLY WITH BOTTOM POSITIONED AS CLOSE AS POSSIBLE TO THE FAÇADE.
 STRUCTURAL CONNECTION BACK TO THE BUILDING VIA AN ENGINEERED FRAME SO AS NOT VISIBLE FROM FRONT VIEW.
- STRUCTURAL BRIDGING FRAME TO BE COLOUR MATCHED TO FAÇADE SO AS LESS VISIBLE FROM SIDE ON VIEWING

L5/405 Collins Street Melbourne 3000 DRAWING NO CLIENT MACQUARIE GROUP ISSUE DATE **07.03.2019** NOT FOR CONSTRUCTION REVISION DESCRIPTION DATE DRAWN ISSUE NO dıadem AS SHOWN @ A3 06 VIC Australia DRAWING TITLE
SKY SIGNAGE APPLICATION TO
NORTH FACADE T/03 9670 6767 CLIENT APPROVAL DRAWING REVISION PROJECT F/03 9670 6769 SYDNEY METRO - MARTIN PLACE NORTH TOWER diadem.co DATE GENERAL NOTE: THESE DRAWINGS ARE PREPARED TO COMMUNICATE DESIGN INTENT ONLY.
ALL MESSAGE CONTENT IS INDICATIVE. ALL STRUCTURAL FRAMES, FOOTINGS AND CONNECTIONS TO BE AS PER
ROIGINEER'S SPECIFICATIONS AND REQUIREMENTS. CONTRACTOR TO ENSURE ALL MATERIALS, MEASUREMENTS,
FIXING DETAILS AND METHODS ARE SUITABLE FOR THE SITE APPLICATION BEFORE MANUFACTURE. PACK FILE NAME SHEET NO DRAWN CHECKED RF PS 01 of 03

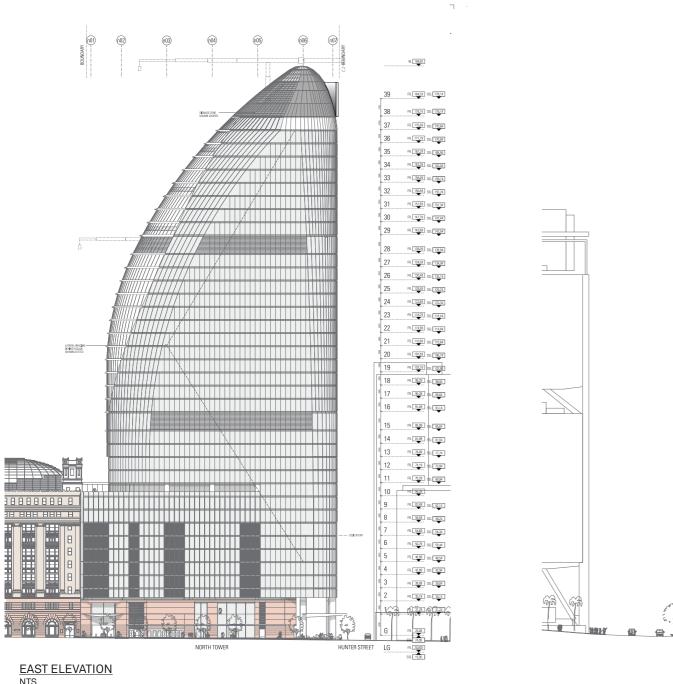

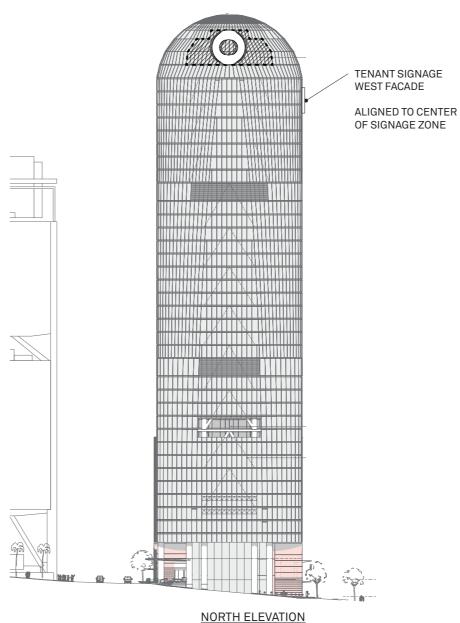

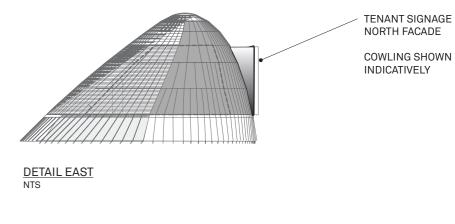

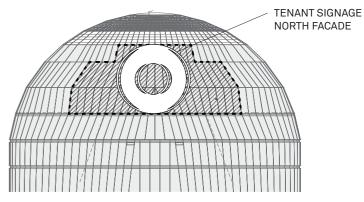

DETAIL NORTH NTS

INSTALLATION METHODOLOGY - WITHOUT COWLING


THE PROPOSED INSTALLATION METHODOLOGY IS TO MOUNT THE HOLEY DOLLAR VERTICALLY, NOTING AS THE FAÇADE CURVES UP AND AWAY FROM THE VERTICALLY PLACED SIGN THIS FORMS A WEDGE SHAPED VOID BETWEEN REAR OF SIGN AND FAÇADE AS INDICATED THE ELEVATIONS.

- HOLEY DOLLAR MOUNTED VERTICALLY WITH BOTTOM POSITIONED AS CLOSE AS POSSIBLE TO THE FAÇADE.
 STRUCTURAL CONNECTION BACK TO THE BUILDING VIA AN ENGINEERED FRAME SO AS NOT VISIBLE FROM FRONT VIEW.
- SHAPED COWLING TO BE APPLIED BETWEEN SIGN AND CURVED FAÇADE AS ILLUSTRATED TO ENCLOSE THE STRUCTURAL FRAMEWORK
- SHAPED COWLING TO BE COLOUR MATCHED TO FAÇADE

L5/405 Collins Street Melbourne 3000 VIC Australia T/03 9670 6767 F/03 9670 6769 diadem.co

dıadem

 1	NOT FOR CONSTRUCTION			REVISION DESCRIPTION -	DATE -	DRAWN -	CLIENT MACQUARIE	CLIENT MACQUARIE GROUP		ISSUE NO 06	ISSUE DATE 07.03.2019	SCALE AS SHOWN @ A3	DRAWING NO
•	CLIENT APPROVAL SIGNATURE NAME DATE						PROJECT SYDNEY METRO - MARTIN PLACE NORTH TOWER		DRAWING TITLE SKY SIGNAGE APPLICATION TO NORTH FACADE - COWELING			DRAWING REVISION	
	©Copyright Diadem Pty Ltd. Reproductions of the whole or part of this document constitutes an infringement of copyright. The information, ideas and concepts contained in this document are confidential. The recipient(s) of this document is prohibited from disclosing such information to any person without the prior written consent of Diadem. Figured dimensions shall take precedence to scaled.			GENERAL NOTE: THESE DRAWINGS ARE PREPARED TO COMMUNICATE DESIGN INTENT ONLY. ALL MESSAGE CONTENT IS INDICATIVE. ALL STRUCTURAL FRAMES, FOOTINGS AND CONNECTIONS TO BE AS PER EIGINEER'S SPECIFICATIONS AND REQUIREMENTS, CONTRACTOR TO ENSURE ALL MATERIALS, MEASUREMENTS, FIXING DETAILS AND METHODS ARE SUITABLE FOR THE SITE APPLICATION BEFORE MANUFACTURE.			PM RF	DRAWN PS	CHECKED RF	PACK FILE NAME	K FILE NAME		SHEET NO 02 of 03

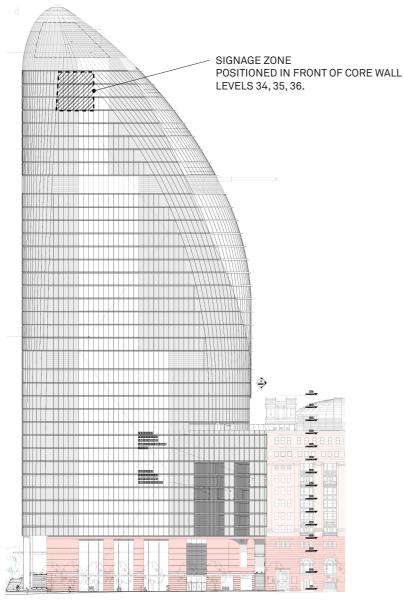


WEST ELEVATION SIGNAGE ZONE

INSTALLATION METHODOLOGY

THE PROPOSED INSTALLATION METHODOLOGY IS TO MOUNT THE HOLEY DOLLAR FLUSH TO FAÇADE, NOTING THE SIGNAGE ZONE HEIGHT AND WIDTH IS LIMITED TO THE EXTENT OF LIFT CORE BEHIND.

- HOLEY DOLLAR MOUNTED VERTICALLY AND FLUSH FIT TO FAÇADE MULLIONS
- STRUCTURAL CONNECTION BACK TO THE BUILDING VIA MULLION SIGNAGE BRACKETS (SUBJECT TO ENGINEERING)

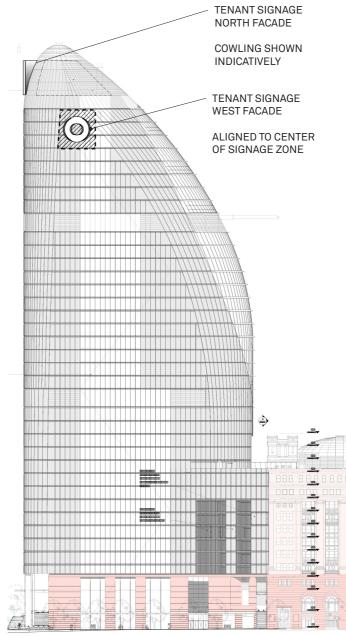

WEST ELEVATION INDICATIVE SIGNAGE PLACEMENT

L5/405 Collins Street Melbourne 3000 VIC Australia CLIENT MACQUARIE GROUP ISSUE DATE 07.03.2019 NOT FOR CONSTRUCTION REVISION DESCRIPTION DRAWN ISSUE NO DRAWING NO dıadem AS SHOWN @ A3 DRAWING TITLE
SKY SIGNAGE APPLICATION TO
WEST FACADE T/03 9670 6767 DRAWING REVISION PROJECT F/03 9670 6769 SYDNEY METRO - MARTIN PLACE NORTH TOWER diadem.co GENERAL NOTE: THESE DRAWINGS ARE PREPARED TO COMMUNICATE DESIGN INTENT ONLY.
ALL MESSAGE CONTENT IS INDICATIVE. ALL STRUCTURAL FRAMES, FOOTINGS AND CONNECTIONS TO BE AS PER
ENGINEER'S SPECIFICATIONS AND REQUIREMENTS. CONTRACTOR TO ENSURE ALL MATERIALS, MEASUREMENTS,
FIXING DETAILS AND METHODS ARE SUITABLE FOR THE SITE APPLICATION BEFORE MANUFACTURE. PACK FILE NAME DRAWN CHECKED SHEET NO RF 03 of 03

Melbourne Sydney Brisbane Adelaide Auckland Hong Kong

diadem.co

