

**OSD BUILDING 1** 

RESPONSE TO SUBMISSION SUPPLEMENTARY DESIGN REPORT



#### **00. Introduction**

## PROJECT OVERVIEW

## Waterloo Metro Quarter Northern Precinct OSD

## SSDA-10440

Commercial with Ground Retail GFA 34,734sqm 15 Storeys

## Agenda

- Provide responses and clarifications to the submissions from DPIE and City of Sydney
- Additional design updates



#### 00. Introduction

#### **AGENDA**

## 01 Visual Bulk & Scale

#### **DPIE Comments**

**Objective** 

- Mitigate the visual bulk of the building
- Illustrate how the bulk and scale of the proposed building is compatible with the evolving streetscape

## 02 Architectural Character

#### **City of Sydney Comments**

- 'Warehouse character' not achieved strongly
- Clarity on materiality
- Robustness of core cladding

# 03 Facade Performance

#### **City of Sydney Comments**

- The proposed is substantially glazed
- Unprotected west facing glazing and lack of sunshading
- Clarity on glazing specifications

## Objective

Seeking endorsement from the DRP of the current design massing and appropriateness of the building relative the site, streetscape and the surrounding area.
 Seeking endorsement from the DRP of the proposed materiality being of sufficient detail and provide clarity that design excellence can be maintained following DA approval.

## **Objective**

 Seeking endorsement from the DRP of the proposed the variety of facades conditions and core cladding provide sufficient solar shading to demonstrate excellent building performance

## 04 External Stair

#### **City of Sydney Comments**

- Raglan Walk is unnecessarily encumbered
- The expression of the stair on the outside of the building's upper levels does not assist in articulating volumes and minimising bulk

## 05 Design Update

• Atrium Redesign

#### **Objective**

 Seeking endorsement from the DRP of the removal of the external stair to the upper levels

#### **Objective**

 Seeking endorsement from the DRP of the redesign of the atrium

## **DPIE Comments**

Mitigate the visual bulk of the building

• Illustrate how the bulk and scale of the proposed building is compatible with the evolving streetscape

## **DRP Comments**

 The panels suggested that the design team to review the positioning of the recessed plant level to the northern most corner tower to confirm the overall proportions of the proposed built form.



#### **BUILDING ENVELOPE EVOLUTION**

## Response


- The visual bulk and scale have been carefully considered from the inception of the project. The overall massing has progressively evolved to minimise the visual impact on the surroundings.
- The built-form is lowered by 24m from the approved stage 1 envelope.
- The massing has progressively evolved to minimise the visual impact on the surroundings, as well as improving on the shadow impacts.

#### REDUCTION OF BUILDING HEIGHT


Stage 1 Approved Envelope **Buildings 3 + 4** Heritage Conservation Zone **Building 2 Building 1** RL 104.200 RL 71.600 RL 56.200

**Envelope Modification** 

**Proposed Envelope** 

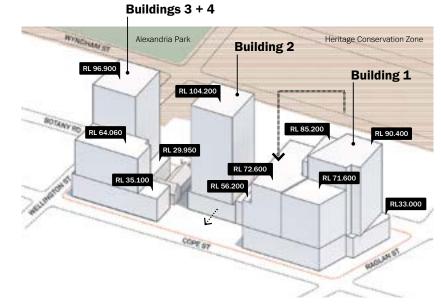


**Approved envelope, view from north-east** 

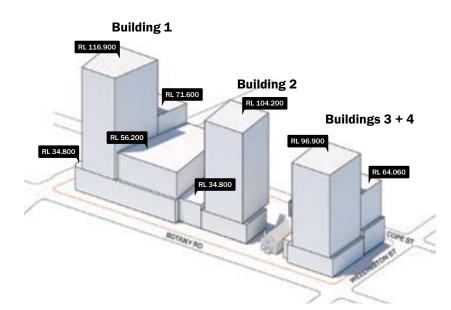

Approved envelope, view from south-west

Amended envelope, view from north-east

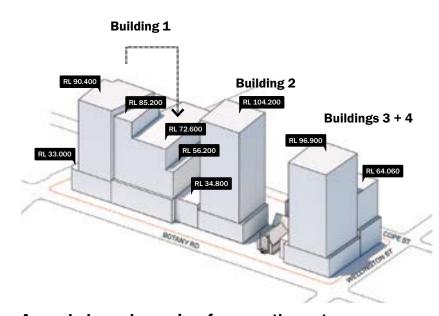


Amended envelope, view from south-west

## **BUILDING ENVELOPE EVOLUTION**

## Response

- The visual bulk and scale have been carefully considered from the inception of the project. The overall massing has progressively evolved to minimise the visual impact on the surroundings.
- The built-form is lowered by 24m from the approved stage 1 envelope.

#### **VIEW FROM BOTANY RD LOOKING SOUTH**

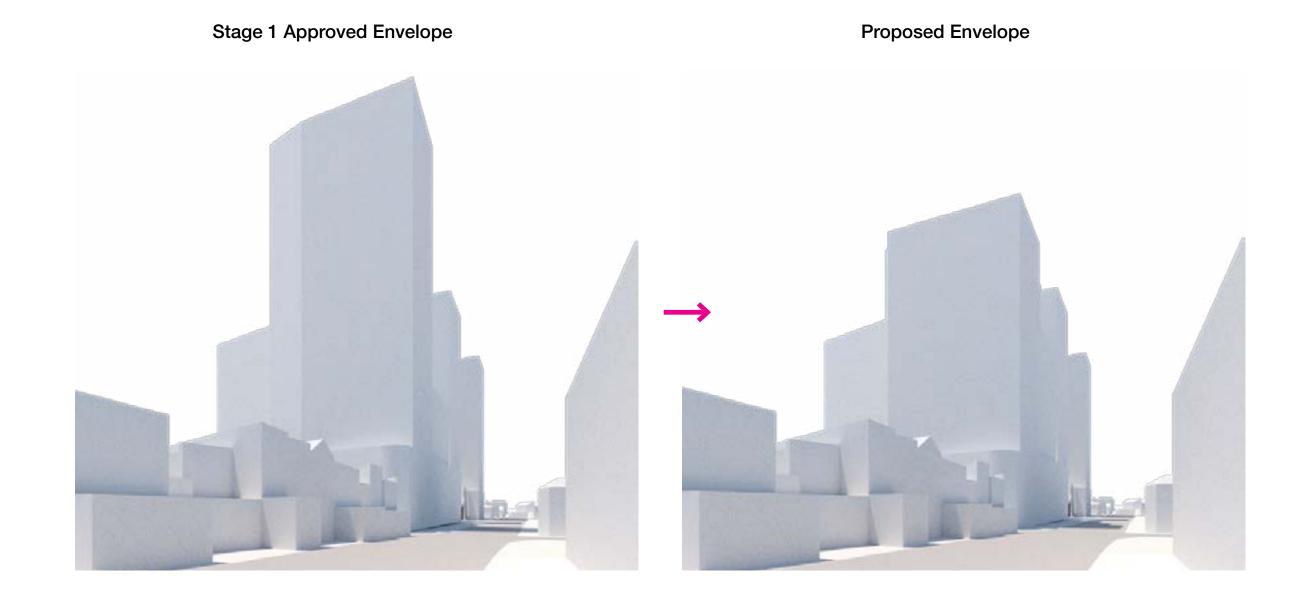


#### MASSING STRATEGY


## Response

• The design acknowledges the diversity of built-forms in the surrounding context. The massing is carefully carved and articulated to de-scale the building creating a coherent relationship to the adjacent built-forms.


## PROPOSED ENVELOPE IN CONTEXT

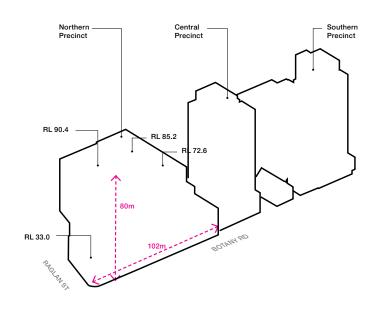

## **RELATING TO PRECINCT SCALE**

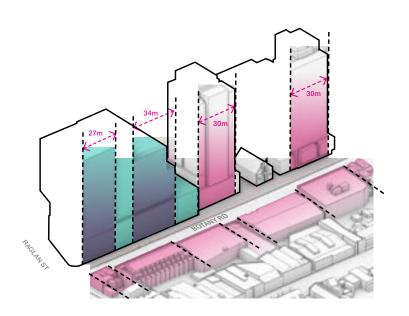

#### **RELATING TO STREET SCAPE**

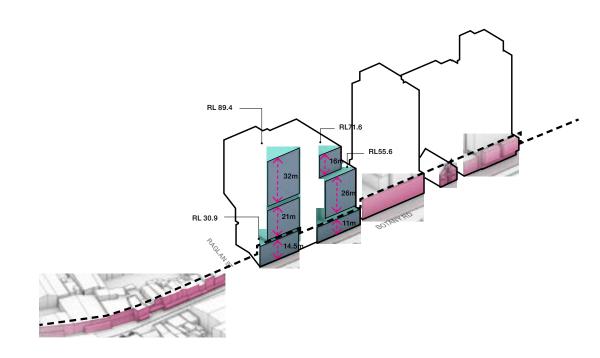


#### ADDRESSING EXISTING & FUTURE CONTEXT


## Response

• The building's overall composition considers the two opposing scales (streetscape of Botany and the towers of the future development). While maintaining the tower form as the primary reading, the articulated sub-datums break the buildings' scale down.

#### PODIUM RELATING TO STREET WALL

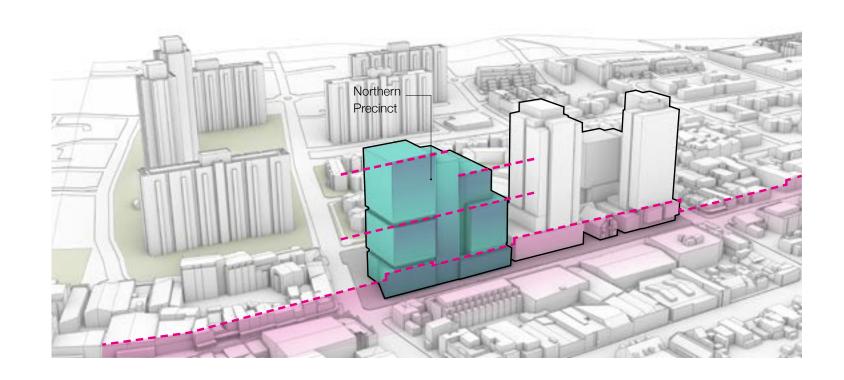

#### TOWER FORM RELATING TO THE FUTURE CONTEXT

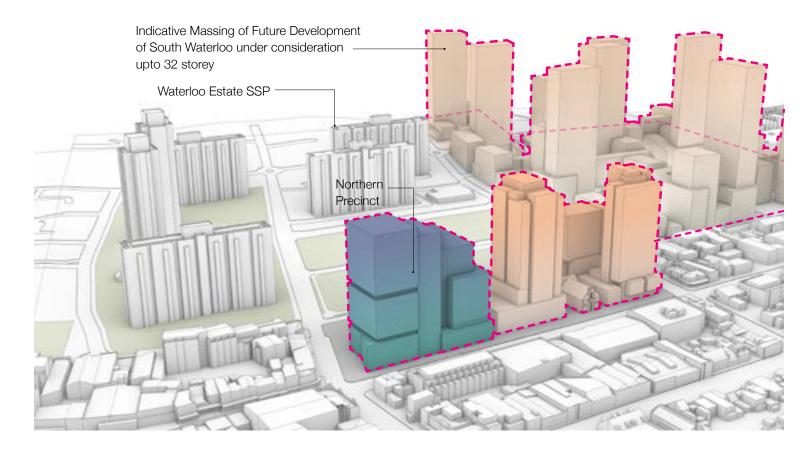


#### **MASSING STRATEGY**


## Response

- The form is broken into smaller communities forming four quadrants.
- The building also includes a through-site link and atria cutting though the building horizontally and vertically allowing visual interactions between the communities and the public.


#### **CREATING SCALABLE COMMUNITY**


#### Forming clusters of communities

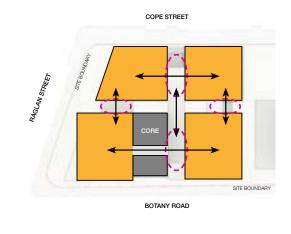

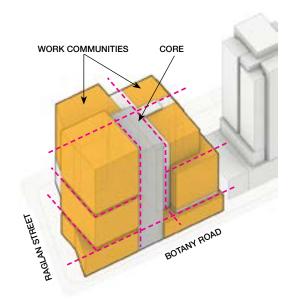



## Bringing nature into the building

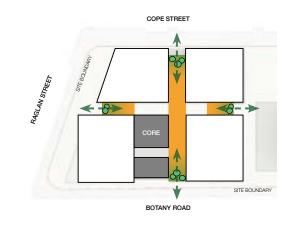

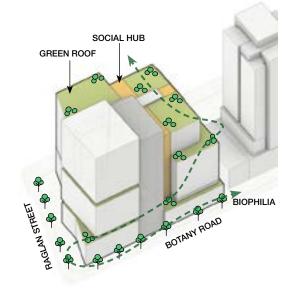



#### Connected and Interactive

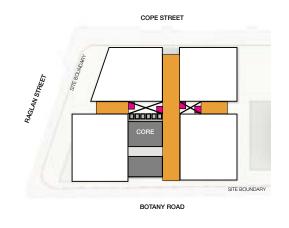

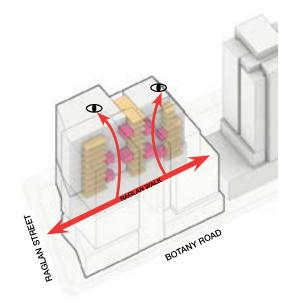



## **Integrated Ground Plane**

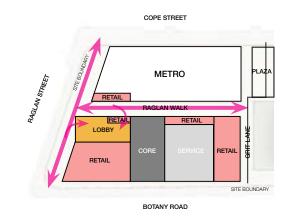

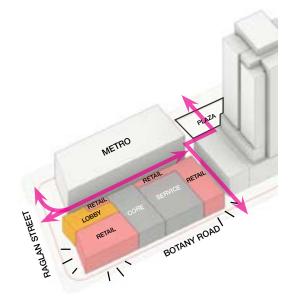

## **URBAN VIEWS**

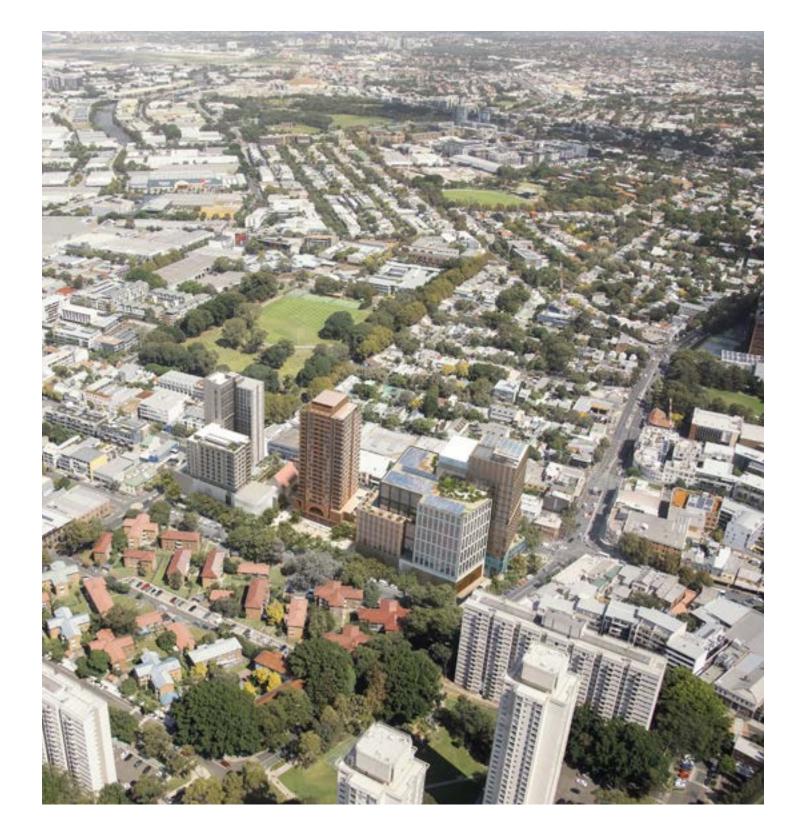

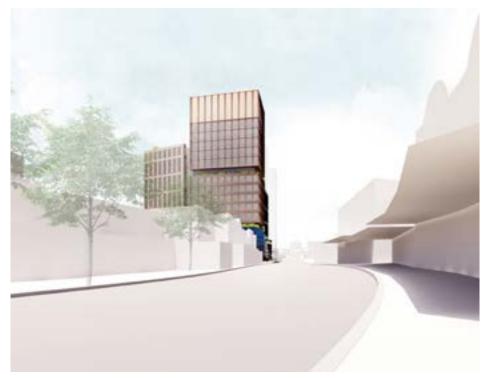

Botany Rd looking south



View from Alexandria Park



Henderson Rd looking east



Cope St looking South


## MASSING STRATEGY

## Response


• The design includes a legible podium layer consistent with the adjoining streetscape in its scale, datum, articulation and character.

## PODIUM ALIGNMENT TO STREET WALL

**Botany Rd** 

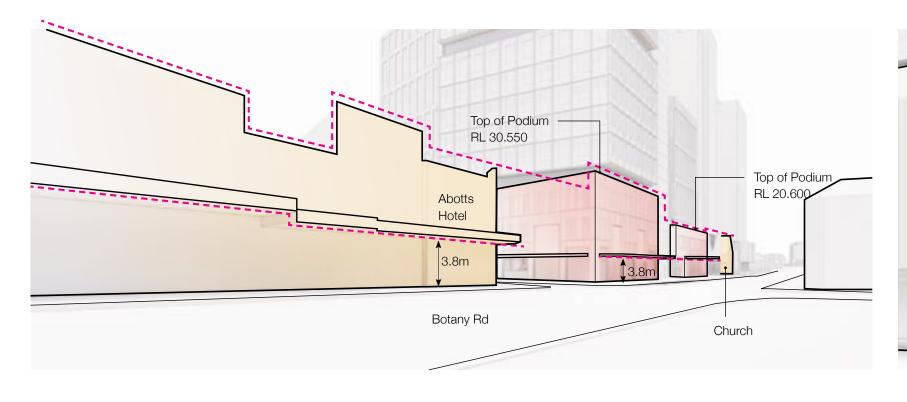

Cope St

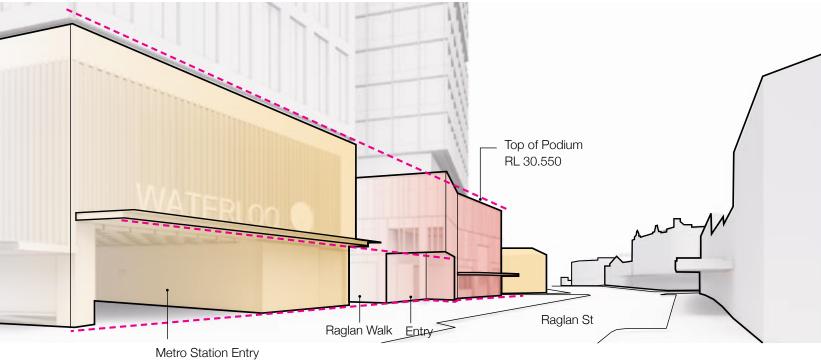

## MASSING STRATEGY

## Response

• The fine-grain embellishment of the podium facade further reinforces the existing Botany rd's human-scale street character.



**Botany Rd Elevation** 




Plan diagram of Facade Articulation

## PROPOSED FURTHER REDUCTION

## Response


- The proposed reduction of height by additional 5.3m from DA further reduces the visual impacts.
- A floor is removed, and floor to floor height is reduced.

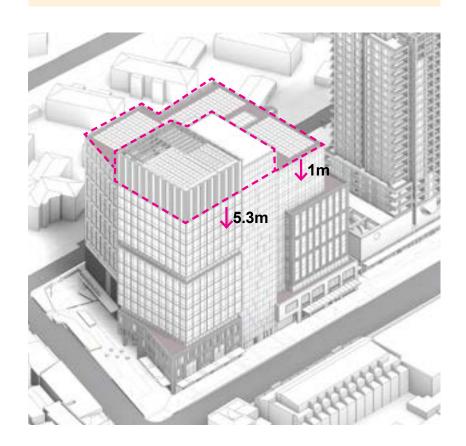

## **NORTH-WEST CORNER REDUCED BY 5.3M**





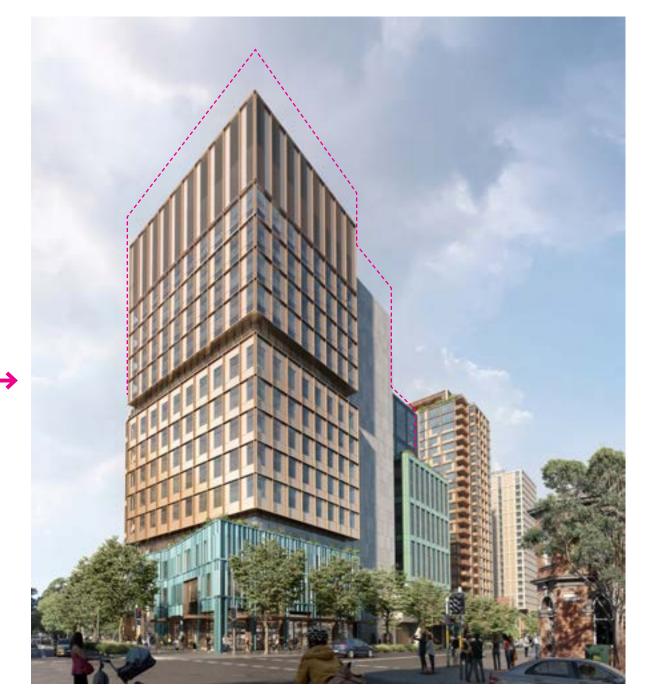


**Proposed Update** 


## PROPOSED FURTHER REDUCTION


## Response

- The proposed reduction of height by additional 5.3m from DA further reduces the visual impacts.
- A floor is removed, and floor to floor height is reduced.

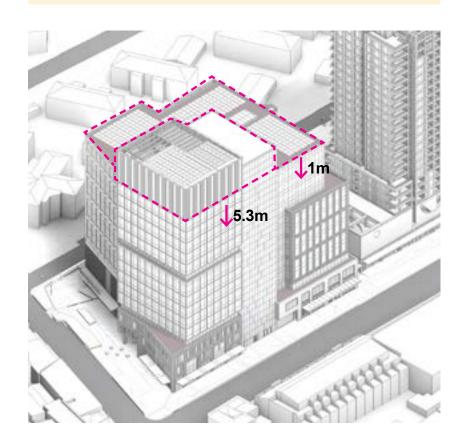

## **NORTH-WEST CORNER REDUCED BY 5.3M & L13 LOWERED BY 1M**

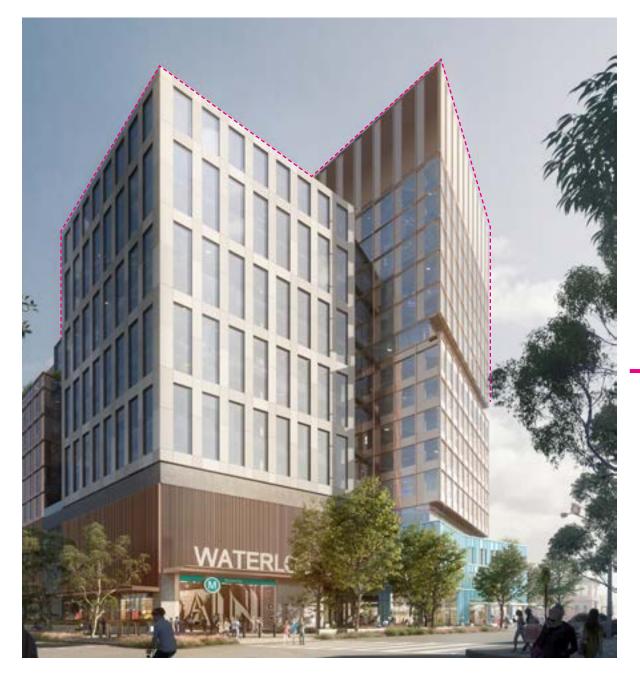

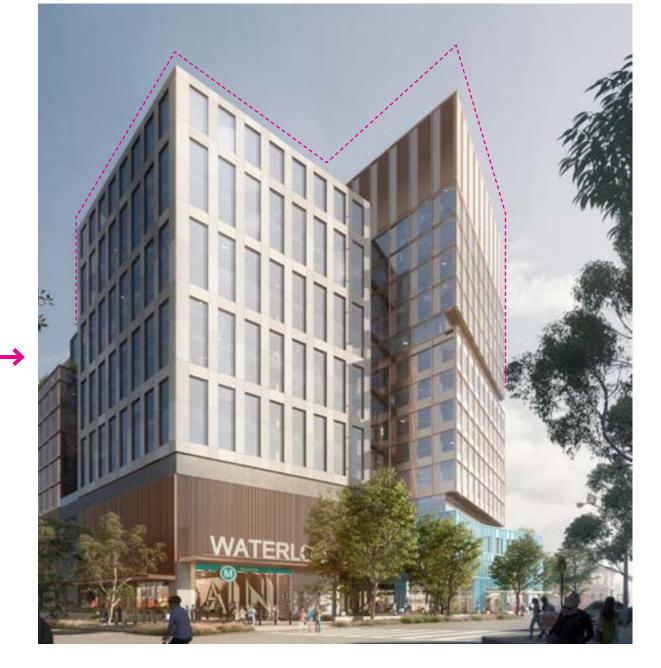

**DA Submission** 

**Proposed Update** 

#### PROPORTION STUDY - BOTANY ROAD ELEVATION

## Response

- The Design Team have reviewed the positioning of the recessed plant and confirmed the proposed position is most desirable
- The location on level 9 lines up with the roof of the southern volume creating a reference datum between varying heights as well as creating more consistent height to width ratio between the volume.



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## PROPORTION STUDY - BOTANY ROAD








Proposed

**Lowered Recess** 

Lifted Recess

## PROPORTION STUDY - RAGLAN STREET

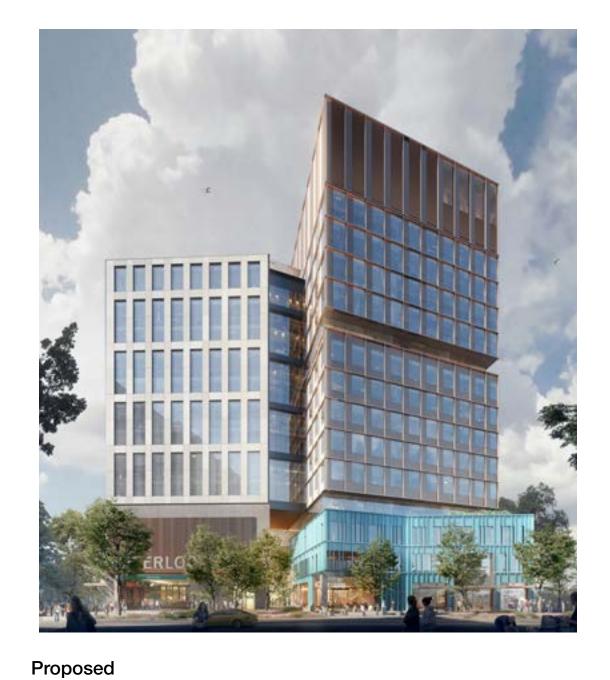







## **City of Sydney Comments**

- 'Warehouse character' not achieved strongly
- Clarity on materiality
- Robustness of core cladding



#### MULTI-LAYERED EXPERIENCE

## Response

- The proposal draws its inspirations from the rich and resilient history of Waterloo.
- The layering of history, local character and local texture is evident in the overall design expressed through architectural detailing and materials choices.

## **Layered Experience**

## **Historical Character**







## Local Character




















## Local Palette







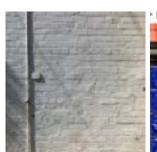








#### MULTY LAYERED EXPERIENCE

## Response

- The proposal draws its inspirations from the rich and resilient history of Waterloo.
- The layering of history, local character and local texture is evident in the overall design expressed through architectural detailing and materials choices.

## **Materiality & Experience at different scales**

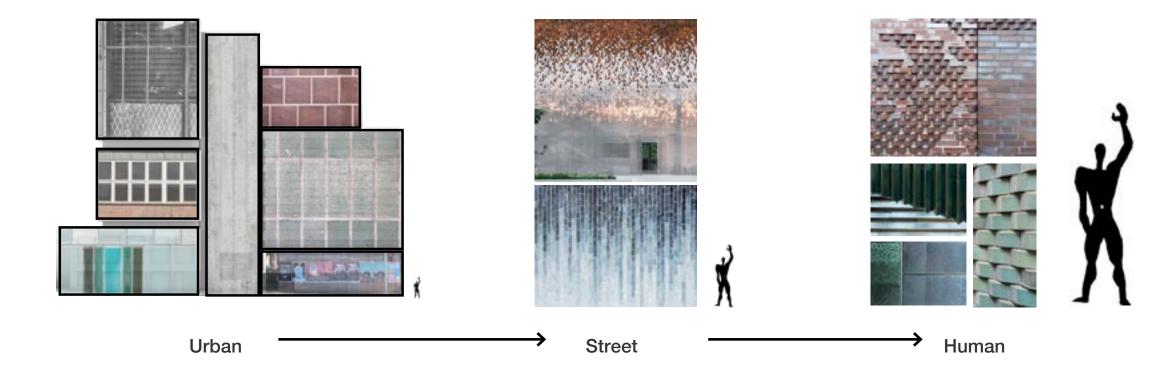

## **Facade articulation Concept**



## STREET ELEVATION



## **MATERIALITY**

## Response

- The materials concept was to create an 'eclectic mixture' of the material inspired by the local palette's diversity.
- Further description of the materials are provided in the follow pages.



#### **Local Materials**



## STREETSCAPE




## STREETSCAPE



## MATERIAL DESCRIPTION - NORTH WEST TOWER



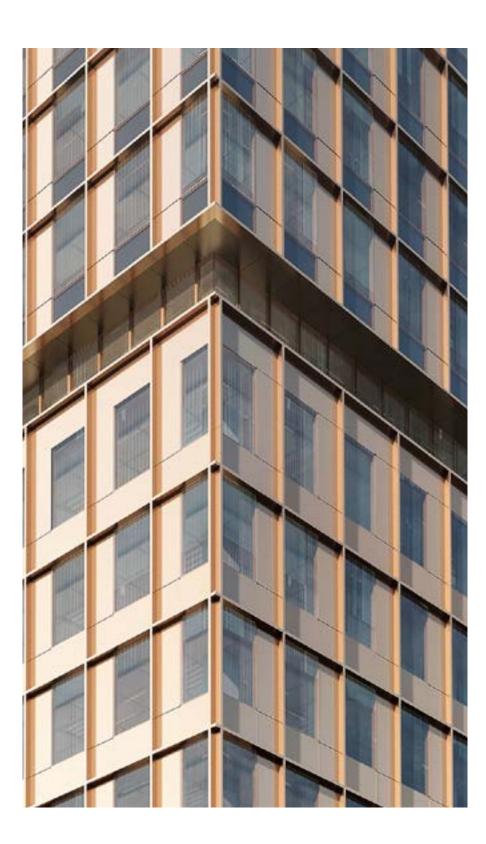



Reference image



Indicative Sample Photos of PVDF and Metalic Powdercoat - Natural Copper Colour


## Response

 PVDF or Metalic Powdercoat Aluminium - Natural Copper

## MATERIAL DESCRIPTION - NORTH WEST PODIUM





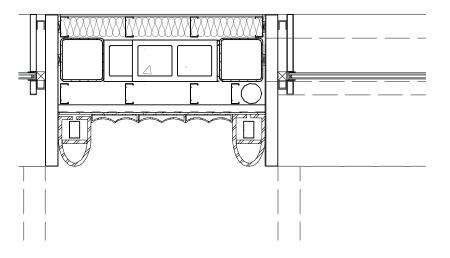



Reference of Ceramic Cladding

## Response


• Glazed Ceramic Cladding - Turquoise colour

## MATERIAL DESCRIPTION - NORTH EAST TOWER



## MATERIAL DESCRIPTION - SOUTH WEST TOWER



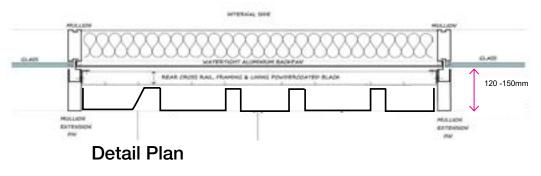



Reference of Copper Coloured Metal Cladding - Ravenswood College, Gordon

## Response

 PVDF or Metalic Powdercoat Aluminium - Green Copper

## MATERIAL DESCRIPTION - SOUTH WEST PODIUM



## Response

 Brickwork - Dry-pressed light beige colour




View from South West - Proposed



## CORE

## Response

- The improvement to the core cladding is proposed with additional brick layer to the podium levels enhancing masonry character of streetscape as well as providing robustness.
- Fenestration is added to the core wall providing light and views to the amenities.

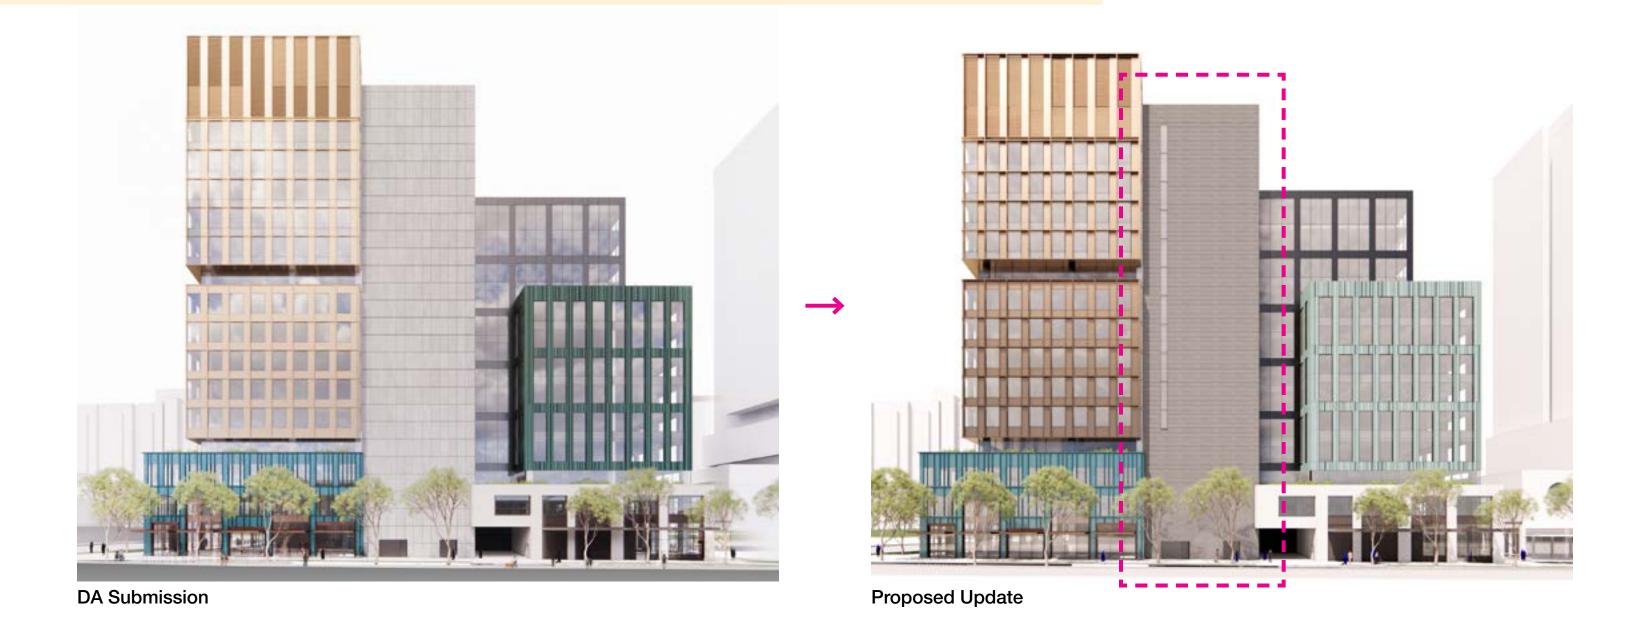

## ADDITIONAL CHARACTER IMPROVEMENTS








Textured Brick Reference

## Response

• Brickwork - Dry-pressed Dark Grey Colour

## ADDITIONAL CHARACTER IMPROVEMENTS

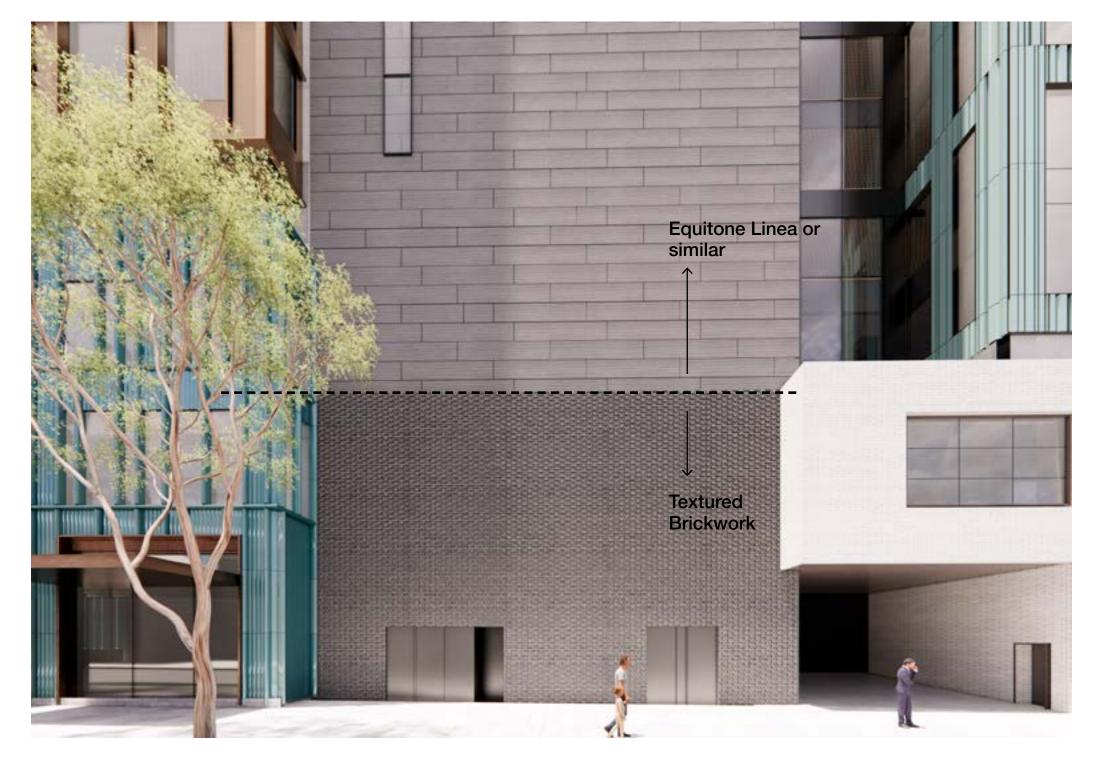







**Equitone Linea** 


## Response

• Equitone Linea or similar - Dark Grey Colour

#### **BUILDING SIGNAGE**





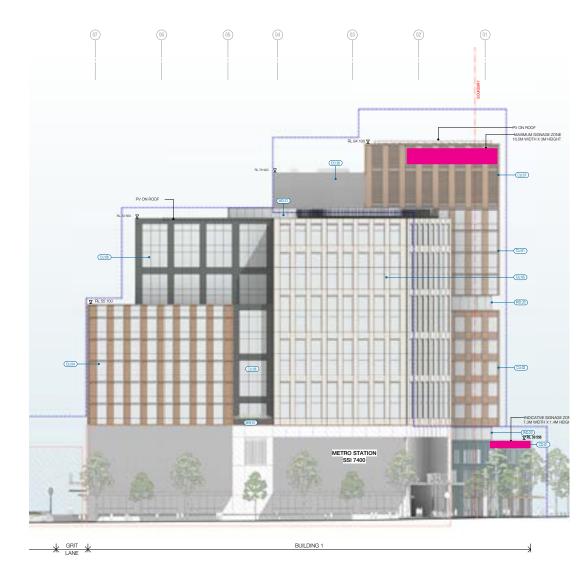

• Signage will be illuminated and architecturally integrated into the building envelope

Maximum Signage Zone

Locations for the building signage zones, including sky signage, are outlined in the elevations to the side; nominally on the West, North and East elevations at the plant level of the tower.

These are intended to be clearly visible ensuring building identification, as well as being of an appropriate size and scale to the context.

Additional signage zones are also provided at street level above the building entry and top of the podium on Raglan St.

The proposed signage shall be subject to separate DA and include the following:

- maximum size of 50 sqm for the tower (eg. 16.5 x 3m per sign)
- 10 sqm for podium (eg. 7.3 x1.4m per sign)
- maximum height of 3m
- illuminated
- integrated with overall building design
- integrated with building details for any fixings and coordinated with the structure
- coordinated with any air flow required for the plant rooms

#### **BUILDING SIGNAGE - RETAIL**

The proposed retail signage is indicative only and requires the development of a coordinated precinct wide strategy.


Some key common elements to be identified and agreed on include:

- common line of height throughout the various buildings and in line with awnings
- maximum size and type of signage


For now and with in mind the character of the Northern Precinct, the proposal envisages the use of boutique-like signage for retail tenancies that hangs off the podium facade without fixing directly on the rich glazed terracotta.

Signage will sit below the awning line and independent from the awning structure (ie. not hung), however sit above the pedestrian line with adequate head clearance.

The proposal is for all retail tenancies to have signage of this type including fronting Botany Road, Raglan Street, Raglan Walk, Grit Lane. Access to the EOT facilities from Botany Road will also be sign posted using a similar methodology.

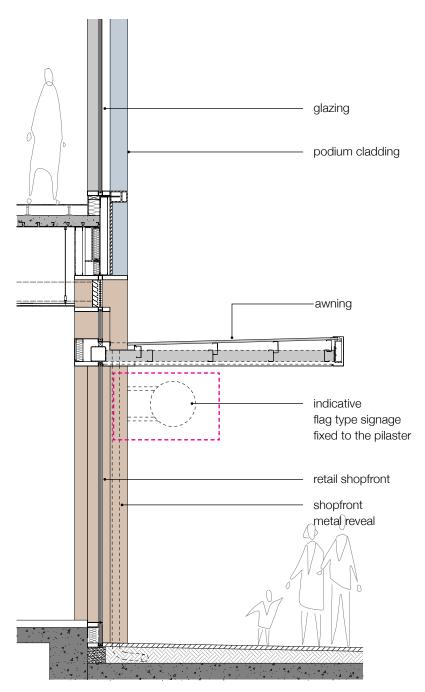

Typical Section Through Podium Shopfront

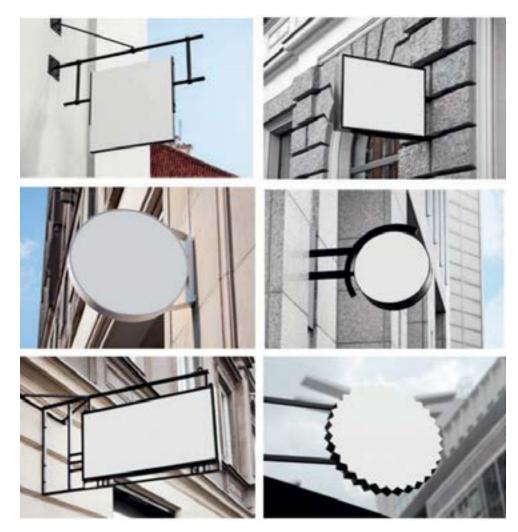

Precedents of Flag-type Signage


#### **AWNING STRATEGY**

As part of a coordinated precinct wide strategy, awnings are provided along all street frontages for wind and weather protection (except along Raglan Walk) also generating greater visual interest and pedestrian amenity, especially along Botany Road. The awnings provide intuitive wayfinding for pedestrians to and from the metro station and around the Northern Precinct, and are designed to work with the rhythm of shopfronts and façade materials at podium.

Datum lines take direct reference from the surrounding context, including canopies over the Waterloo Metro Station entries, generating a continuous linearity between buildings that contributes to the design objective for an integrated development.

In order to break the long continuous banks of awnings, the design includes clear glass panels that will also provide opportunities to look up at the sky and have a perception of the tower above, maintaining a visual connection between the pedestrian plane and the commercial floors.

Generally constructed with steel and glass in line with the framing of shopfronts below, the architectural intent is to use a finer craft in the design of the awnings generating diversity between zones where the awnings are applied to. This will bring textural refinement at street level in keeping with the local context.

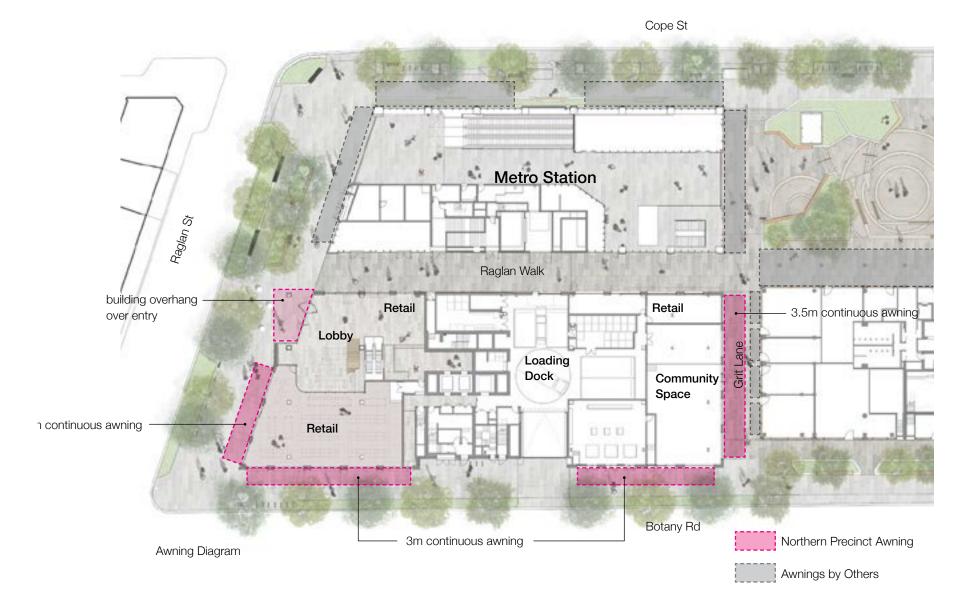








Grit Lane

Botany Rd South North

Botany Rd South

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## AWNING STRATEGY

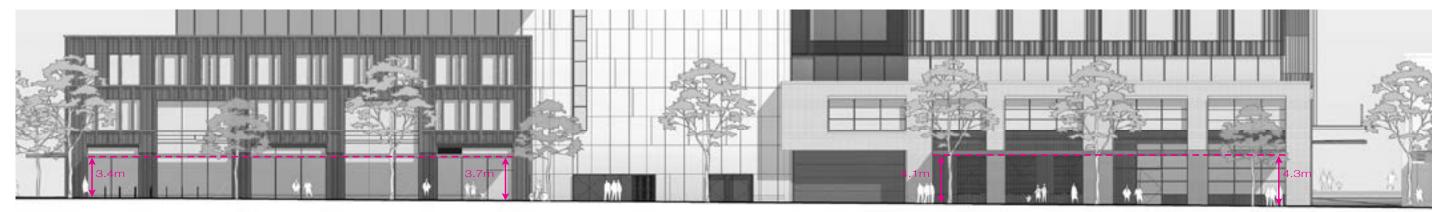

Podium Elevation - West



5.4m 4.7m

Podium Elevation - South



Artist's impression - Botany Rd

## **City of Sydney Comments**

- The proposed is substantially glazed
- Unprotected west facing glazing and lack of sunshading
- Clarity on glazing specifications

#### **DRP Comments**

 The Panel recommends that the 200mm facade projection depth is reviewed during design development to improve its solar shading effectiveness

#### SOLID TO WINDOW RATIO

#### Response


- The overall ESD strategy, including building envelopes and mechanical systems, is based on achieving a high standard of energy efficiency and comfort.
- The facade includes a large portion of insulated solid panels (circa 40% window to wall ratio) improving the building's thermal performance, which exceeds section J requirement.



Typical Interior - Office Levels



**West Elevation** 

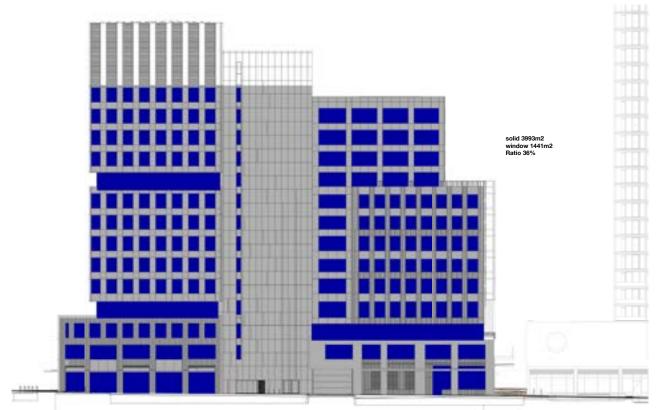

**West Elevation Vision Panel Areas** 




#### Window to Wall Ratio

West Elevation 36% Windows
North Elevation 46% Windows
East Elevation 40% Windows
South Elevation 44% Windows

**Total Average 41% Windows** 

#### **SOLAR GAIN ANALYSIS**

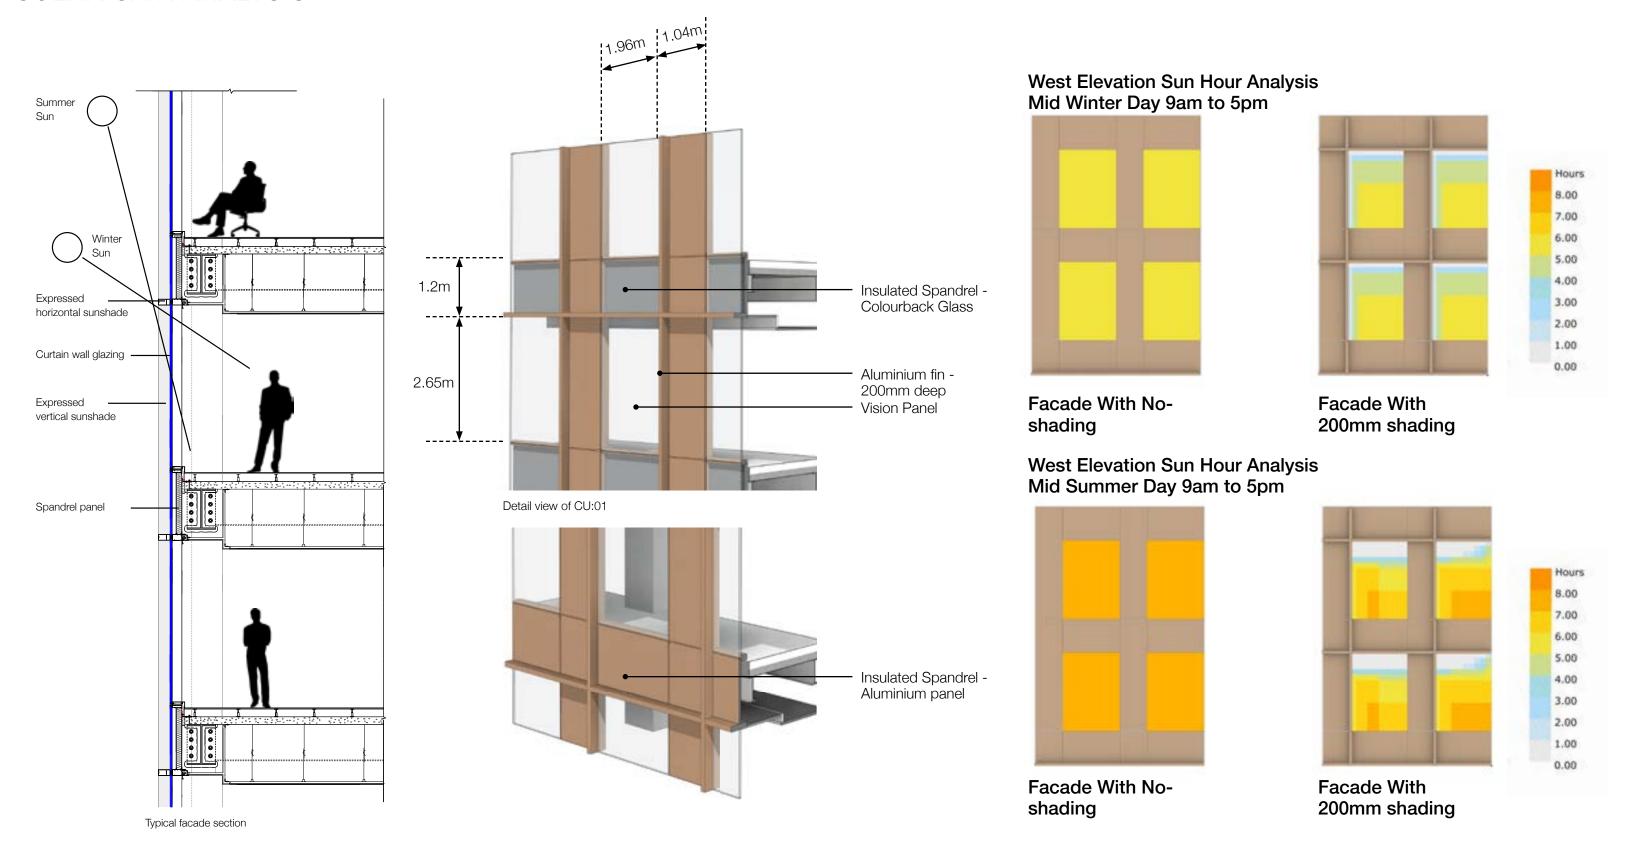


#### **SOLAR GAIN ANALYSIS**



- The 200mm projection provides good balance of energy/comfort and daylight
- With marginal difference to energy/comfort levels, more priority is given to the better daylight given the size of the floor plate

## Result Summary – North Facade

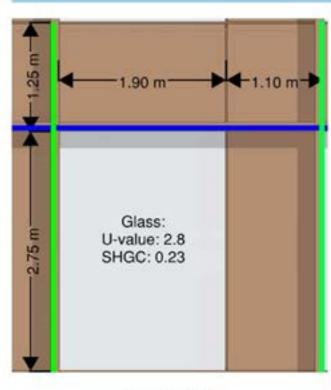

WWR = 44%
Glazing reduction compared to full width glazing = 37%


Option	Annual Cooling Load (kWh/m2)	Peak Cooling Load (W/m²)	Annual PMV -1 to +1 (%)	Floor Area % with Daylight Factor >2% (%)
Option 1 150mm-vs 150mm-hs	201.1 (0.6%)	53.6 (0.2%)	92.0% (-0.1%)	61.5% (0.8%)
Option 2 (Preferred) 200mm-vs 200mm-hs	200.0	53.5	92.1%	61.0%
Option 3 250mm-vs 250mm-hs	198.8 (-0.6%)	53.3 (-0.4%)	92.2% (0.1%)	58.3% (-2.0%)
Option 4 300mm-vs 300mm-hs	197.4 (-1.3%)	53.0 (-0.9%)	92.2% (0%)	58.3% (-4.4%)

Note: Peak Cooling Load is for comparative façade loads only.

#### **SOLAR GAIN ANALYSIS**



## Result Summary – West Facade

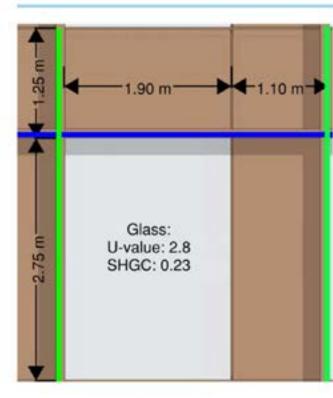

WWR = 44%
Glazing reduction compared to full width glazing = 37%

Option	Annual Cooling Load (kWh/m2)	Peak Cooling Load (W/m²)	Annual PMV -1 to +1 (%)	Floor Area % with Daylight Factor >2% (%)
Option 1 150mm-vs 150mm-hs	197.3 (0.4%)	55.1 (0.7%)	92.9% (0.0%)	61.5% (0.8%)
Option 2 (Preferred) 200mm-vs 200mm-hs	196.5	54.7	92.9%	61.0%
Option 3 250mm-vs 250mm-hs	195.6 (-0.5%)	54.4 (-0.5%)	93.0% (0.1%)	58.3% (-2.0%)
Option 4 300mm-vs 300mm-hs	194.5 (-1.0%)	54.0 (-1.3%)	93.0% (0.1%)	58.3% (-4.4%)

Note: Peak Cooling Load is for comparative façade loads only.

#### CUNDALL

#### **GLAZING SPECIFICATION**

## Response

## **Glass Specification**

- Triple low E coated
- SHGC = 0.23
- VLT = 50%
- Reflectivity < 20%
- Reflected solar energy mostly below 650 w/ m2 which has minimal impact on creating heat loads



Benchmark Precedent - 5 Martin Place



## **City of Sydney Comments**

- Raglan Walk is unnecessarily encumbered
- The expression of the stair on the outside of the building's upper levels does not assist in articulating volumes and minimising bulk


#### EXTERNAL STAIR ON RAGLAN WALK

## Response

- The external stair for the first two levels are internalised.
- A vestibule is created to act as an independent entry to the podium levels.
- The stair moves to the outside on level 2 to create a breakout balcony.
- A pass door is provided for emergency situations




**DA Submission** 

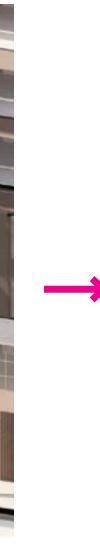

Proposed Update



## EXTERNAL STAIR ON RAGLAN WALK

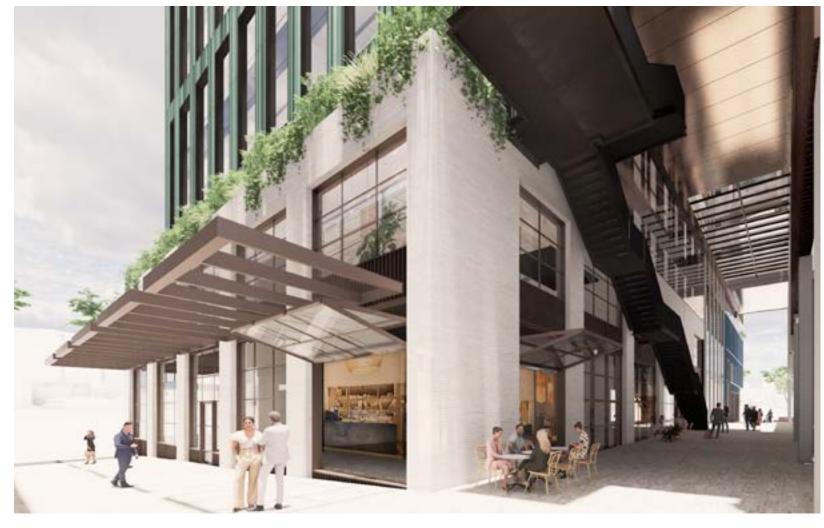






Proposed Update

#### EXTERNAL STAIR ON RAGLAN WALK



Proposed Update

#### EXTERNAL STAIR ON RAGLAN WALK

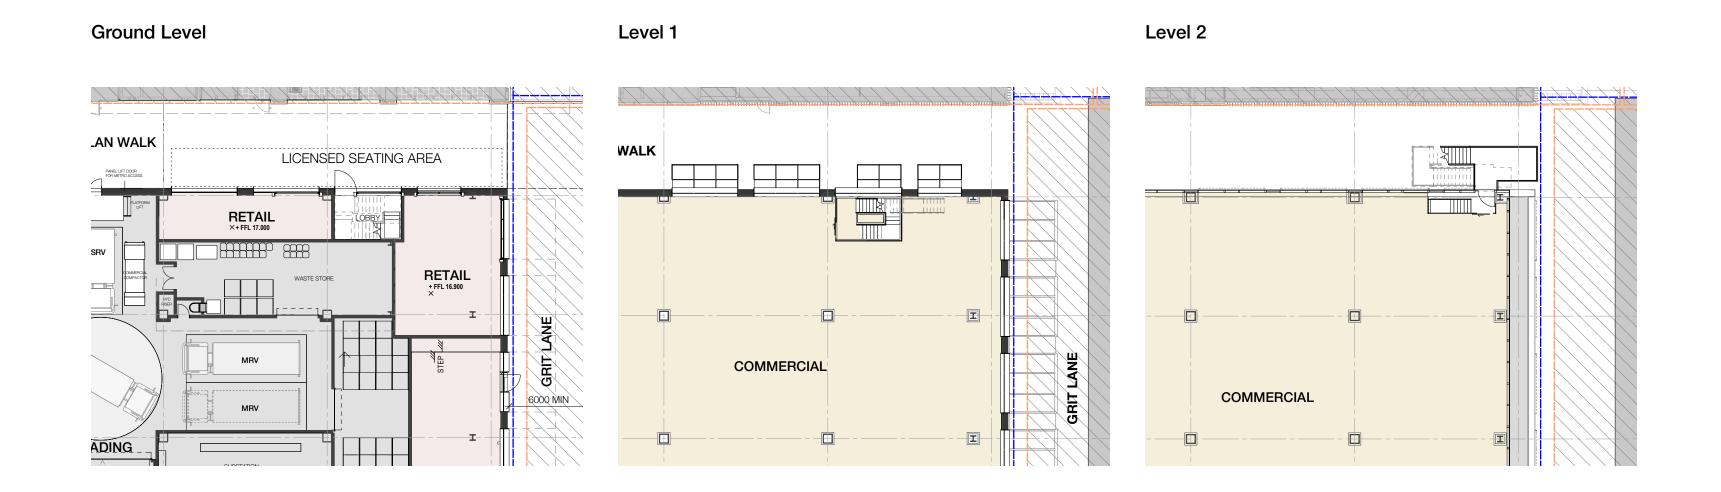



#### **EXTERNAL STAIR TOWER LEVELS**

## Response

- The southern stair is removed by fire engineering solution
- The floor plate benefits from clear and obstructed outlook from inside and provides improved floor plate contiguity



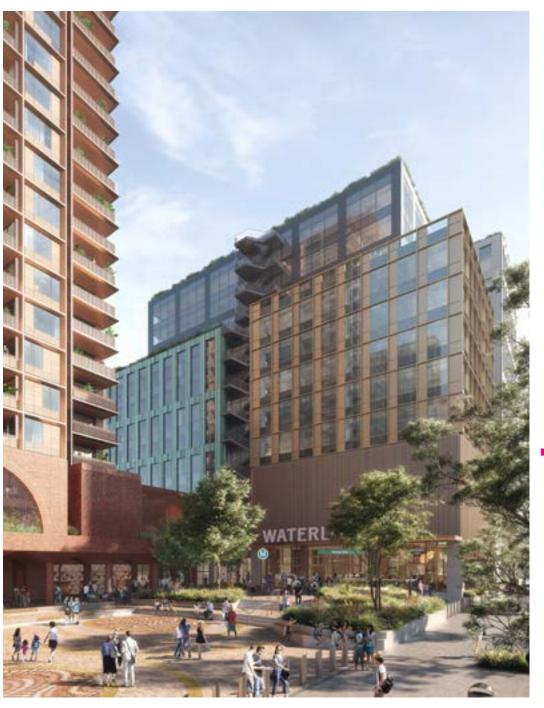

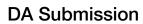




Proposed Update

**ATRIUM** 



## **ATRIUM**

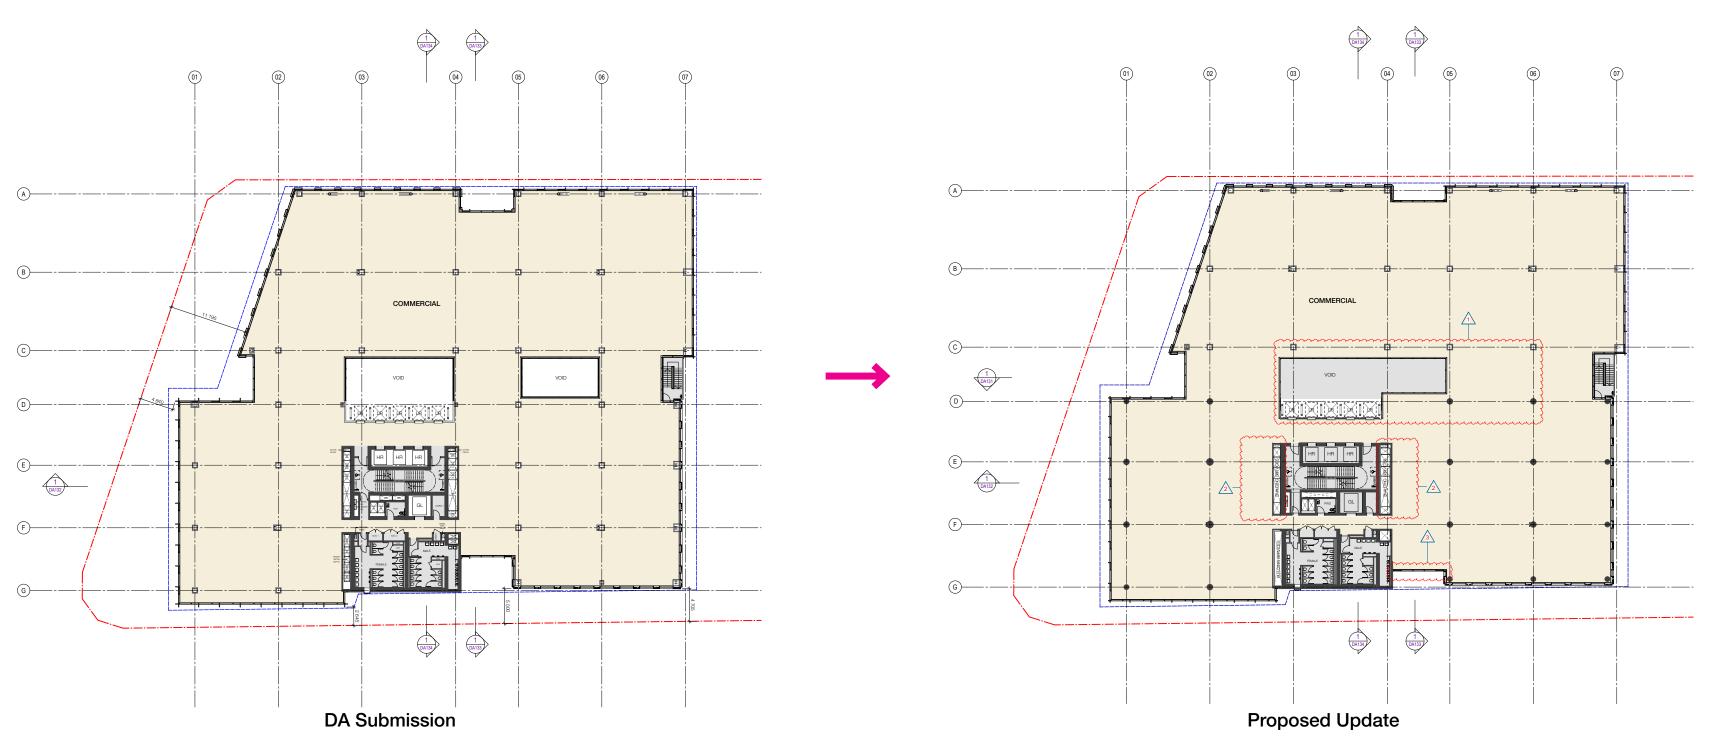

## ATRIUM







Proposed Update

ATRIUM - SUBDIVISIBILITY


Single Tenant

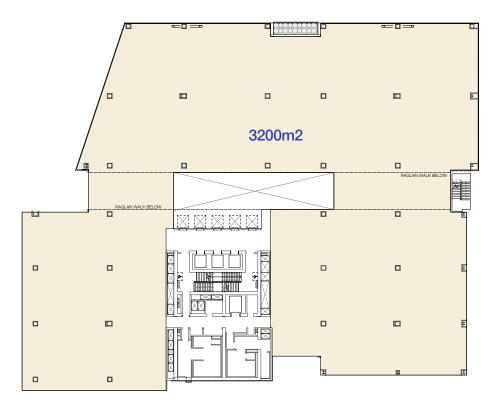

Three Tenants

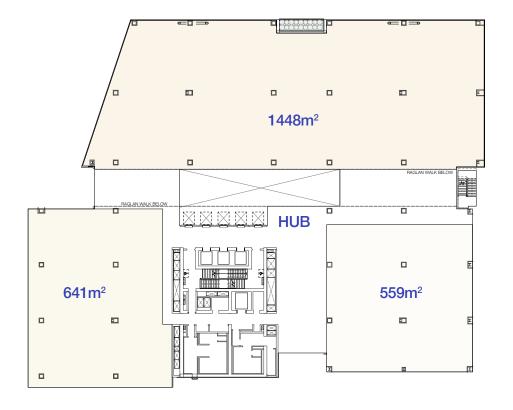


Two Tenants

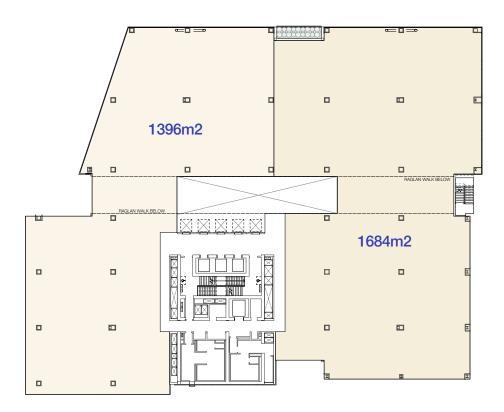

Four Tenants



## ATRIUM

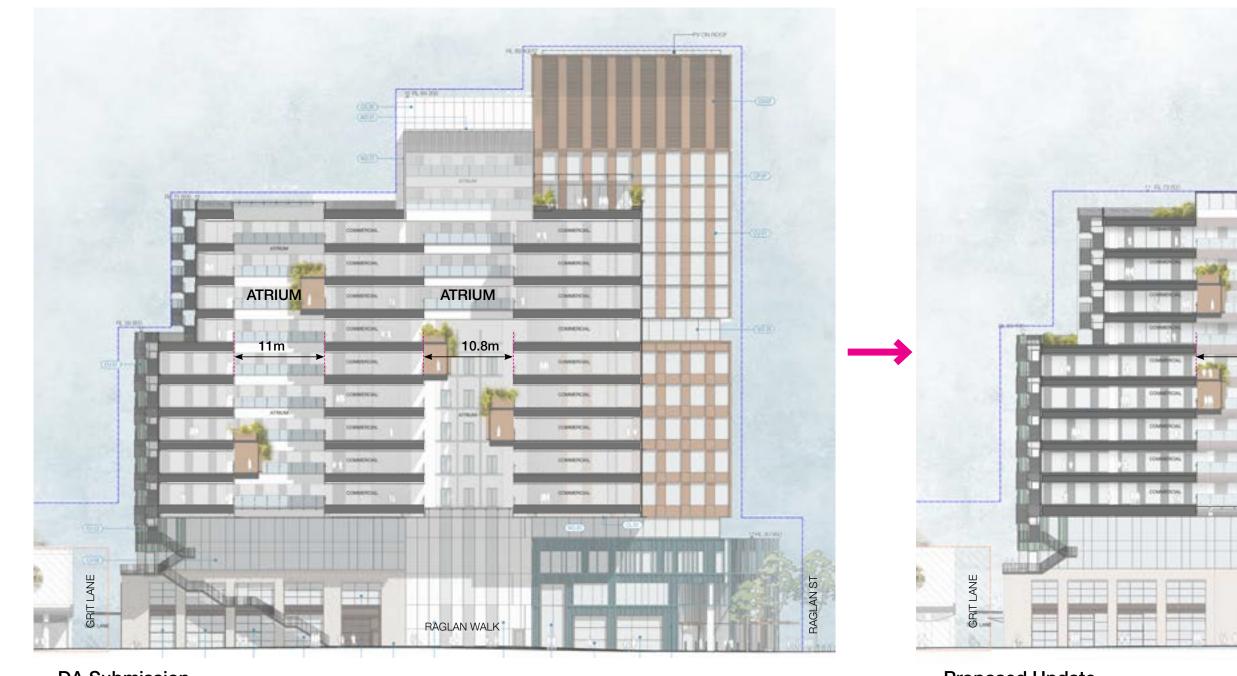

DA Submission Proposed Update

ATRIUM

RAGLAN WALK

24m



## DPIE COMMENTS

Comments	Response
b. Mitigate the visual bulk of the building, particularly when viewed from the north-west, south-west and west, including further consideration of:	<b>&gt;</b>
the proportion and distribution of building mass across the base, middle and top of the building"	
the composition of the facade and building articulation.	
c. Illustrate how the bulk and scale of the proposed building is compatible with the evolving streetscape in the surrounding area and other proposed buildings at the Waterloo Metro Quarter. "	<b>✓</b>

## COS COMMENTS

Comments	Response
(a) External fire stair – Raglan Walk is unnecessarily encumbered by the proposed external fire stair. The application does not justify why this cannot be fully enclosed within the building line. The expression of the stair on the outside of the building's upper levels does not assist in articulating volumes and minimising bulk. It is recommended that the stair is redesigned to fall within the footprint of the building, without reducing the width of Raglan Street and removing active frontage to the adjacent retail tenancy. Should the stair need to be external at higher levels, a more expressive and high design quality form should be considered;	
(b) Building Expression – The Design Report notes that 'the northern precinct has been identified as 'Warehouse conversions' character" in response to the local context. It is unfortunate that this idea was not more strongly achieved in the proposed design, as the result may have utilised more masonry, and a larger solid to void ratio in the elevations. The proposed substantially glazed, aluminium clad curtain wall facades do not adequately address the orientation of the building, particularly the large expanse of unprotected west facing glazing. On this elevation, a very minor (say 150mm) projection is proposed at a height equivalent to ceiling height. A similar vertical projection is provided to protect a 1.5 metre width of glazing. At summer afternoon, the altitude of the sun is low, and at one point, perpendicular to the west facade. These minor projections will have no perceptible shading impact;	
(c) Active frontages – Almost 50% of the Botany Road frontage is occupied by non-active uses;	Addressed at CoS Meeting

Comments	Response
(d) Sun-Shading and Urban Heat – Although passive shading is nominated as one of the measures in the Project's Sustainability Framework (refer to page 36 App M, initiative 9.11.3), it is not delivered. The initiative is: Passive design of facades to improve thermal performance and reduce impact of extreme weather days. While the proposed design may achieve the requirements of the applicable energy rating systems, these govern internal thermal performance only, and do not consider occupant comfort for extreme weather days. Additionally, unshaded facades tend to rely on performance glazing to reduce internal heat load which has the negative impact of reflecting heat and glare back into the public domain, causing both a nuisance and excessive heating of the public domain (Urban Heat Island effect). The proposed buildings have essentially a fully glazed facade, particularly the west elevations which have no substantial external shading devices. Best practice design should target the achievement of 100% shading through operable devices to combat extreme heat events. The development is inconsistent with the Waterloo Metro Design and Amenity Guideline Section 3R Sustainability – Objective 3: reduce energy consumption, emissions and urban heat island effect;	Addressed at CoS Meeting
(e) Glazing – Further clarity should be sought on the proposed glazing – "performance vision glass" is specified and no information is provided to describe any tint, reflectivity or urban heat issues associated with this selection. Clear glazing is always preferred;	<b>\</b>
(f) Materials – 'Prefinished fibre cement panel' is proposed for the vast blank frontage to Botany Road, where non-habitable spaces are located at the perimeter of the tower. This does not represent a robust, high quality material fit for the intended location and use and the consideration of alternatives is encouraged. A view from the south west to the southern elevation should be requested to demonstrate acceptable visual appearance in views from the south along Botany Road;	<b>\</b>

Comments	Response
(g) Materials – There is a general lack of certainty or clarity of the finishes. Actual products must be specified rather than generic descriptions such as "light grey brick appearance" and "Oxidised copper coloured metal". Materials must be described by a product or manufacturer's details, and contain information on the material, finish, colour etc. For example, is the 'oxidised copper coloured metal' oxidised copper sheeting with a varied and interesting patina; or aluminium sheeting with an anodised finish; or aluminium sheeting with a flat, monotone powder-coated finish? These three options will provide entirely different outcomes and varying degrees of design excellence. Without adequate detail and certainty of the outcome, the department should not be satisfied that the project will deliver design excellence.	
The roof terrace to level 13 of Building 1 includes an accessible area that has been indicatively designed (subject to tenant fitout), and an expanse of gravel roof with photovoltaics. Studies show that co-locating photovoltaics and green roofs can greatly improve the performance of the PVs, whilst supporting habitat and biodiversity. This should be considered for this roof.	Addressed at CoS Meeting
No landscape information has been provided for the (presumably inaccessible) green roofs to levels 2, 3, 4 & 9 of building 1. This is required	To be provided in RTS

## DRP COMMENTS

Comments	Response
The Panel suggested that the design team to review the positioning of the recessed plant level to the northern-most corner tower and confirm the overall proportions of the proposed built form.	<b>\</b>
The Panel recommends that the 200mm facade projection depth is reviewed during design development to improve its solar shading effectiveness."	<b>~</b>

## 07. DA Drawings



# WATERLOO METRO QUARTER DEVELOPMENT NORTH PRECINCT



## NORTH PRECINCT DA DRAWING LIST - SSD10440

SHEET NUMBER	SHEET NAME	SHEET ISSUE DATE	REVISION
		~~~~~~~~~~~~~~~~~~~~~~~~~~~~~~~~~~~~~~	~~~~~~~~~~~~~~~~~~~~~~~~~~~~~~~~~~~~~~
WMQ-BLD1-WBG-AR-DRG-DA000	BUILDING 1 - COVER SHEET	15/03/21	E
WMQ-BLD1-WBG-AR-DRG-DA001	BUILDING 1 - SITE PLAN (GROUND LEVEL)	15/03/21	E
WMQ-BLD1-WBG-AR-DRG-DA002	BUILDING 1 - SITE PLAN (ROOF LEVEL)	15/03/21	Е
WMQ-BLD1-WBG-AR-DRG-DA003	BUILDING 1 - SITE ANALYSIS	15/03/21	Е
WMQ-BLD1-WBG-AR-DRG-DA100	BUILDING 1 - FLOOR PLAN - LEVEL GROUND	15/03/21	F
WMQ-BLD1-WBG-AR-DRG-DA100M	BUILDING 1 - FLOOR PLAN - LEVEL MEZZANINE	15/03/21	F
WMQ-BLD1-WBG-AR-DRG-DA101	BUILDING 1 - FLOOR PLAN - LEVEL 01	15/03/21	F
WMQ-BLD1-WBG-AR-DRG-DA102	BUILDING 1 - FLOOR PLAN - LEVEL 02	15/03/21	F
WMQ-BLD1-WBG-AR-DRG-DA103	BUILDING 1 - FLOOR PLAN - LEVEL 03	15/03/21	F
WMQ-BLD1-WBG-AR-DRG-DA104	BUILDING 1 - FLOOR PLAN - LEVEL 04	15/03/21	F
WMQ-BLD1-WBG-AR-DRG-DA105	BUILDING 1 - FLOOR PLAN - LEVEL 05-07	15/03/21	F
WMQ-BLD1-WBG-AR-DRG-DA108	BUILDING 1 - FLOOR PLAN - LEVEL 08	15/03/21	F
WMQ-BLD1-WBG-AR-DRG-DA109	BUILDING 1 - FLOOR PLAN - LEVEL 09	15/03/21	F
WMQ-BLD1-WBG-AR-DRG-DA110	BUILDING 1 - FLOOR PLAN - LEVEL 10-12	15/03/21	F
WMQ-BLD1-WBG-AR-DRG-DA113	BUILDING 1 - FLOOR PLAN - LEVEL 13 - ROOF TERRACE	15/03/21	F
WMQ-BLD1-WBG-AR-DRG-DA115	BUILDING 1 - FLOOR PLAN - LEVEL 14	15/03/21	F
WMQ-BLD1-WBG-AR-DRG-DA116	BUILDING 1 - FLOOR PLAN - LEVEL 15	15/03/21	F
WMQ-BLD1-WBG-AR-DRG-DA117	BUILDING 1 - FLOOR PLAN - LEVEL ROOF PLAN	15/03/21	F
WMQ-BLD1-WBG-AR-DRG-DA121	BUILDING 1 - WEST ELEVATION - BOTANY ROAD	15/03/21	F
WMQ-BLD1-WBG-AR-DRG-DA122	BUILDING 1 - NORTH ELEVATION - RAGLAN STREET	15/03/21	F
WMQ-BLD1-WBG-AR-DRG-DA123	BUILDING 1 - EAST ELEVATION - COPE STREET	15/03/21	F
WMQ-BLD1-WBG-AR-DRG-DA124	BUILDING 1 - SOUTH ELEVATION - GRIT LANE	15/03/21	F
WMQ-BLD1-WBG-AR-DRG-DA131	BUILDING 1 - LONGITUDINAL SECTION 01 - RAGLAN WALK	15/03/21	G
WMQ-BLD1-WBG-AR-DRG-DA132	BUILDING 1 - LONGITUDINAL SECTION 02	15/03/21	F
WMQ-BLD1-WBG-AR-DRG-DA133	BUILDING 1 - CROSS SECTION 01	15/03/21	E
WMQ-BLD1-WBG-AR-DRG-DA134	BUILDING 1 - CROSS SECTION 02	15/03/21	Е
WMQ-BLD1-WBG-AR-DRG-DA141	BUILDING 1 - CU01 TOWER FACADE DETAILS	15/03/21	E
WMQ-BLD1-WBG-AR-DRG-DA142	BUILDING 1 - CU02 TOWER FACADE DETAILS	15/03/21	E
WMQ-BLD1-WBG-AR-DRG-DA143	BUILDING 1 - CU03 TOWER FACADE DETAILS	15/03/21	E
WMQ-BLD1-WBG-AR-DRG-DA144	BUILDING 1 - CU04 TOWER FACADE DETAILS	15/03/21	Е
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WMQ-BLD1-WBG-AR-DRG-DA148	BUILDING 1 - CD01 PODIUM FACADE DETAILS	25/09/20	D
WMQ-BLD1-WBG-AR-DRG-DA149	BUILDING 1 - CD02 PODIUM FACADE DETAILS	25/09/20	D
WMQ-BLD1-WBG-AR-DRG-DA150	BUILDING 1 - FACADE MATERIAL COLOUR PALETTE	15/03/21	E
WMQ-BLD1-WBG-AR-DRG-DA190	BUILDING 1 - AREA PLAN 01 - GFA	15/03/21	Е
WMQ-BLD1-WBG-AR-DRG-DA191	BUILDING 1 - AREA PLAN 02 - GFA	15/03/21	E



E 1 REVISION UPDATED

Contractor must verify all dimensions on site before commencing work or preparing shop drawings. Do not scale drawings.





**WOODS BAGOT** 


WATERLOO METRO QUARTER DEVELOPMENT

SSD10440

**BUILDING 1 - COVER SHEET** 

FOR APPROVAL

WMQ-BLD1-WBG-AR-DRG-DA000 E

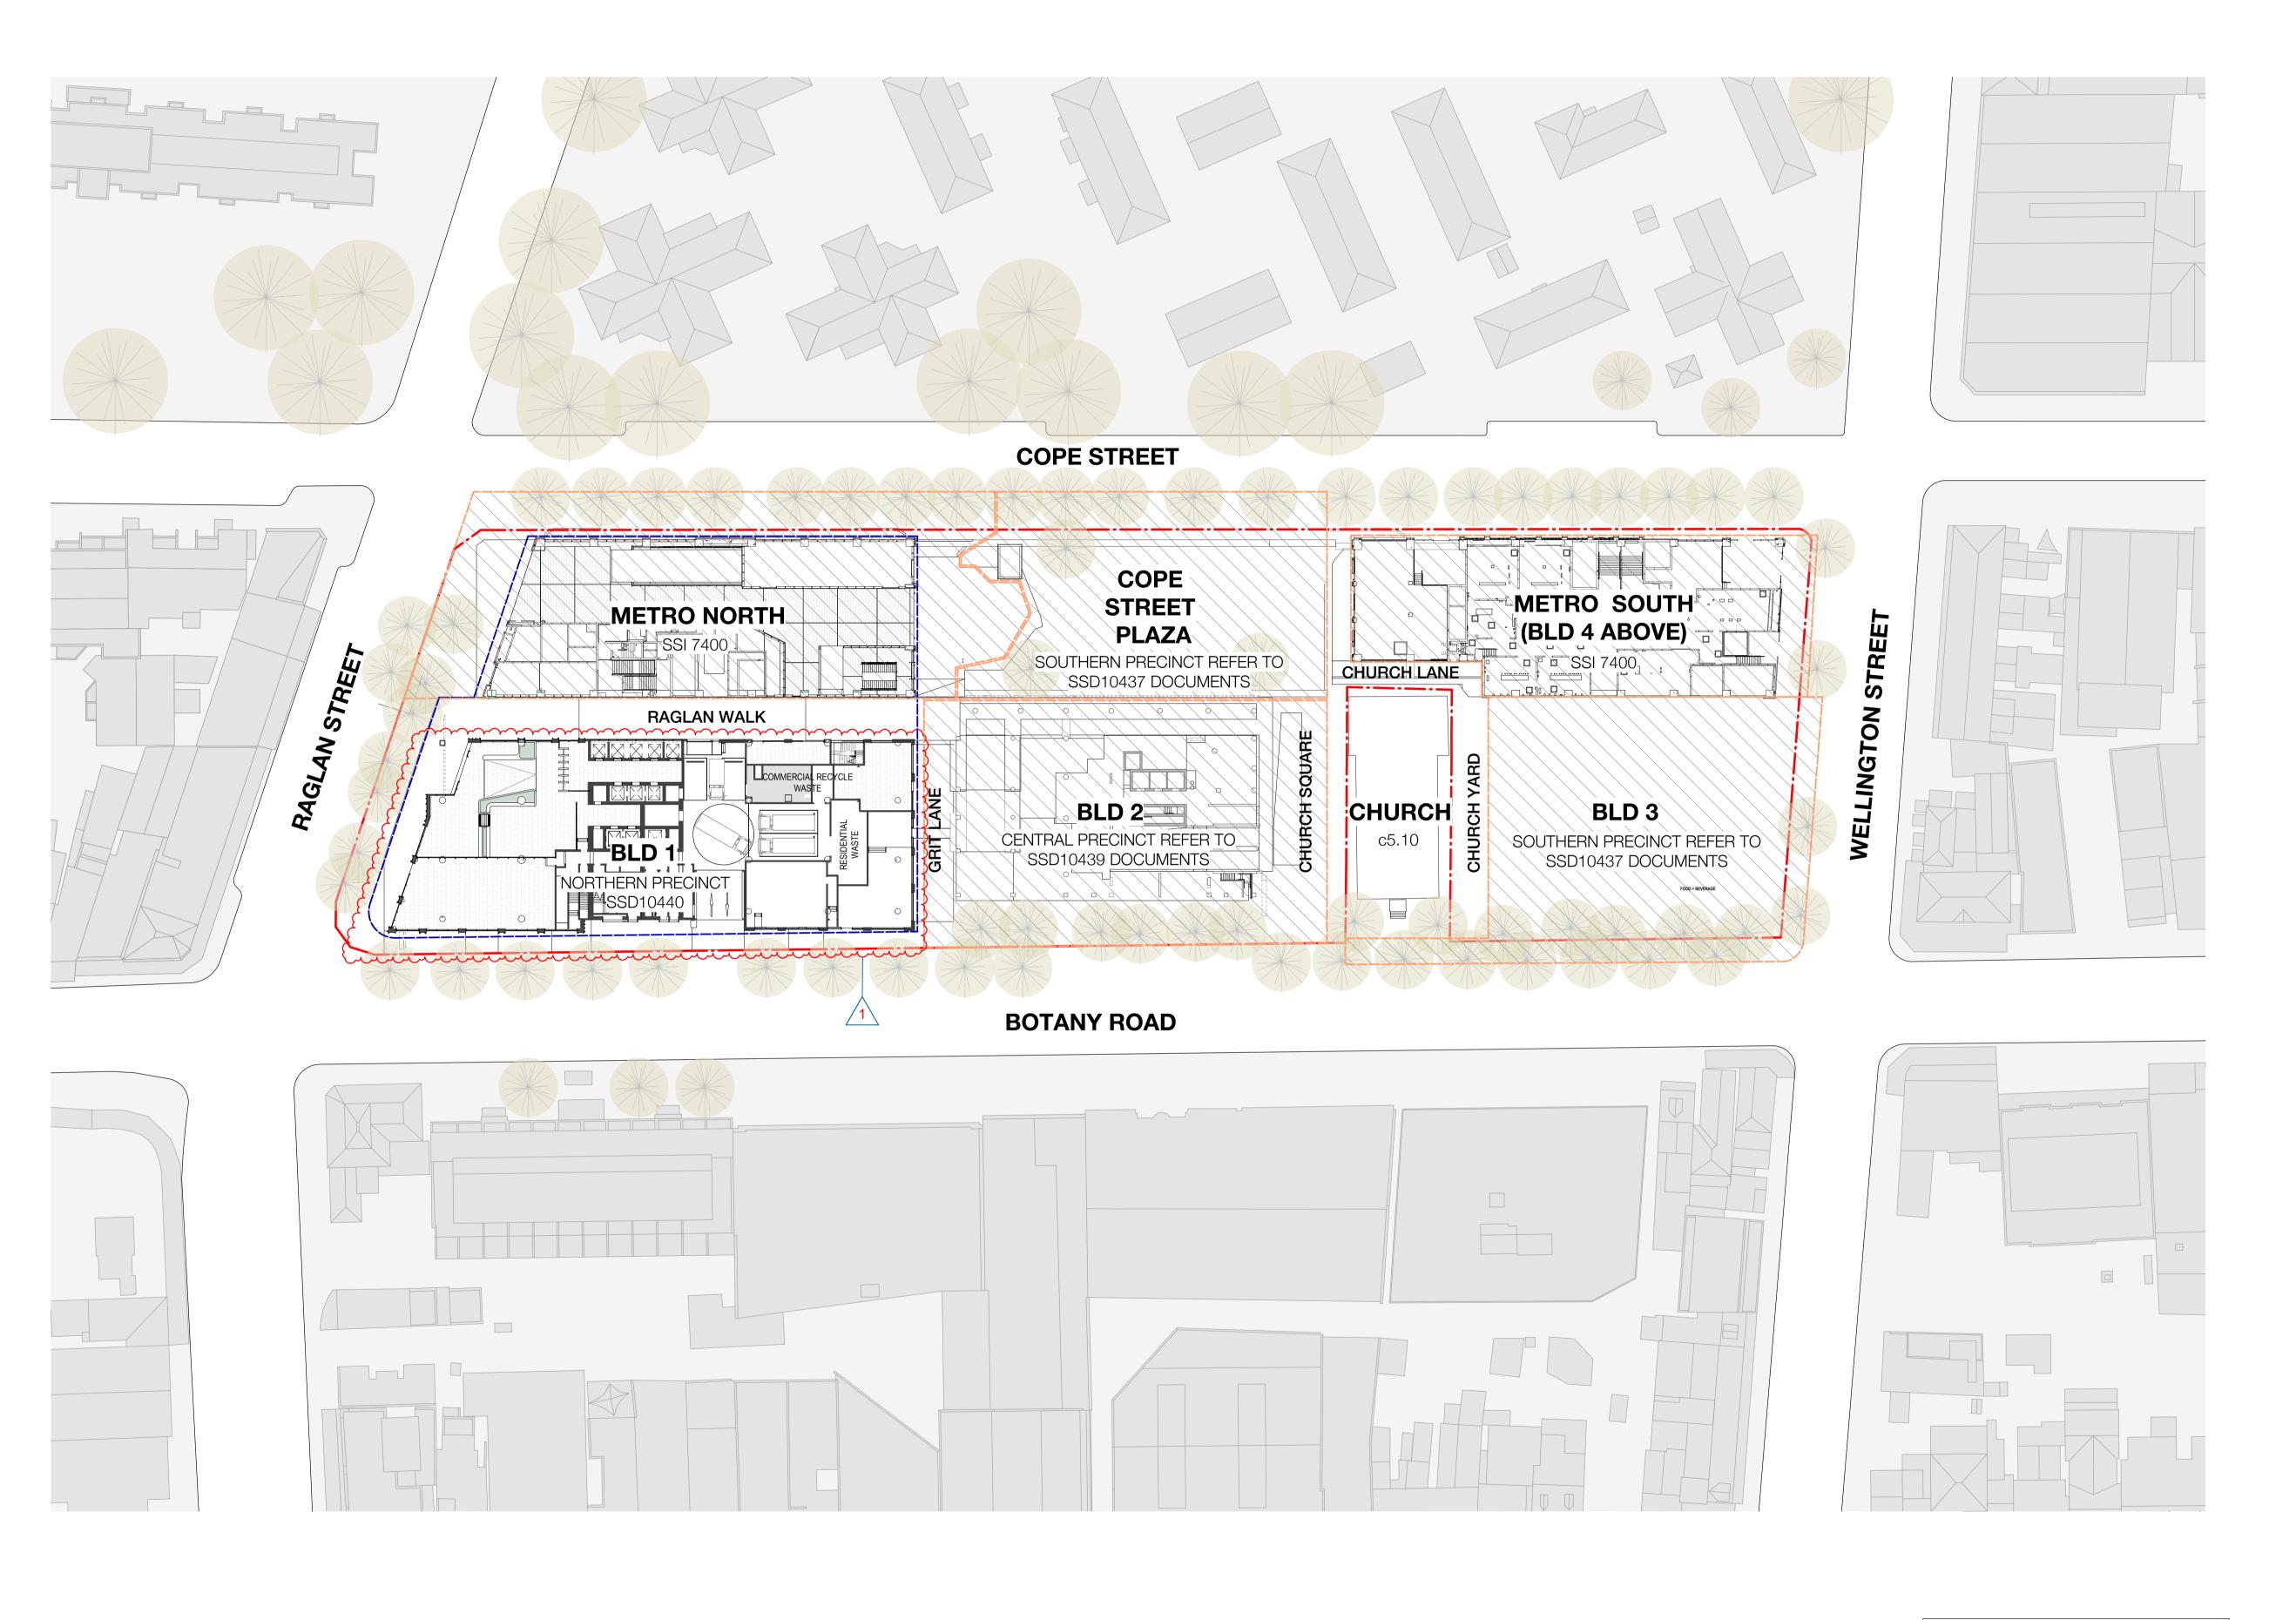

## LEGEND

--- PROPERTY LINE

--- PLANNING ENVELOPE PROFILE

SSD DA PRECINCT BOUNDARY

A FOR INFORMATION (DA) 15.07.20
B FOR APPROVAL 31.07.20
C FOR APPROVAL 28.08.20
D FOR APPROVAL 25.09.20
E FOR APPROVAL 15.03.21


Current Revision Amendments
# Mark Comments
E 1 LAYOUT UPDATED

Recent revision history

Notes

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Project
WATERLOO METRO QUARTER DEVELOPMENT


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Checked JP	Approved PM	Sheet size	Scale 1 : 500

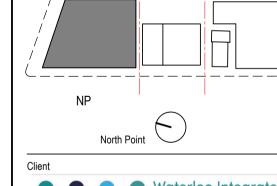Sheet title
SSD10440
BUILDING 1 - SITE PLAN (GROUND LEVEL)

Status FOR APPROVAL

Sheet number Revision

WMQ-BLD1-WBG-AR-DRG-DA001 E

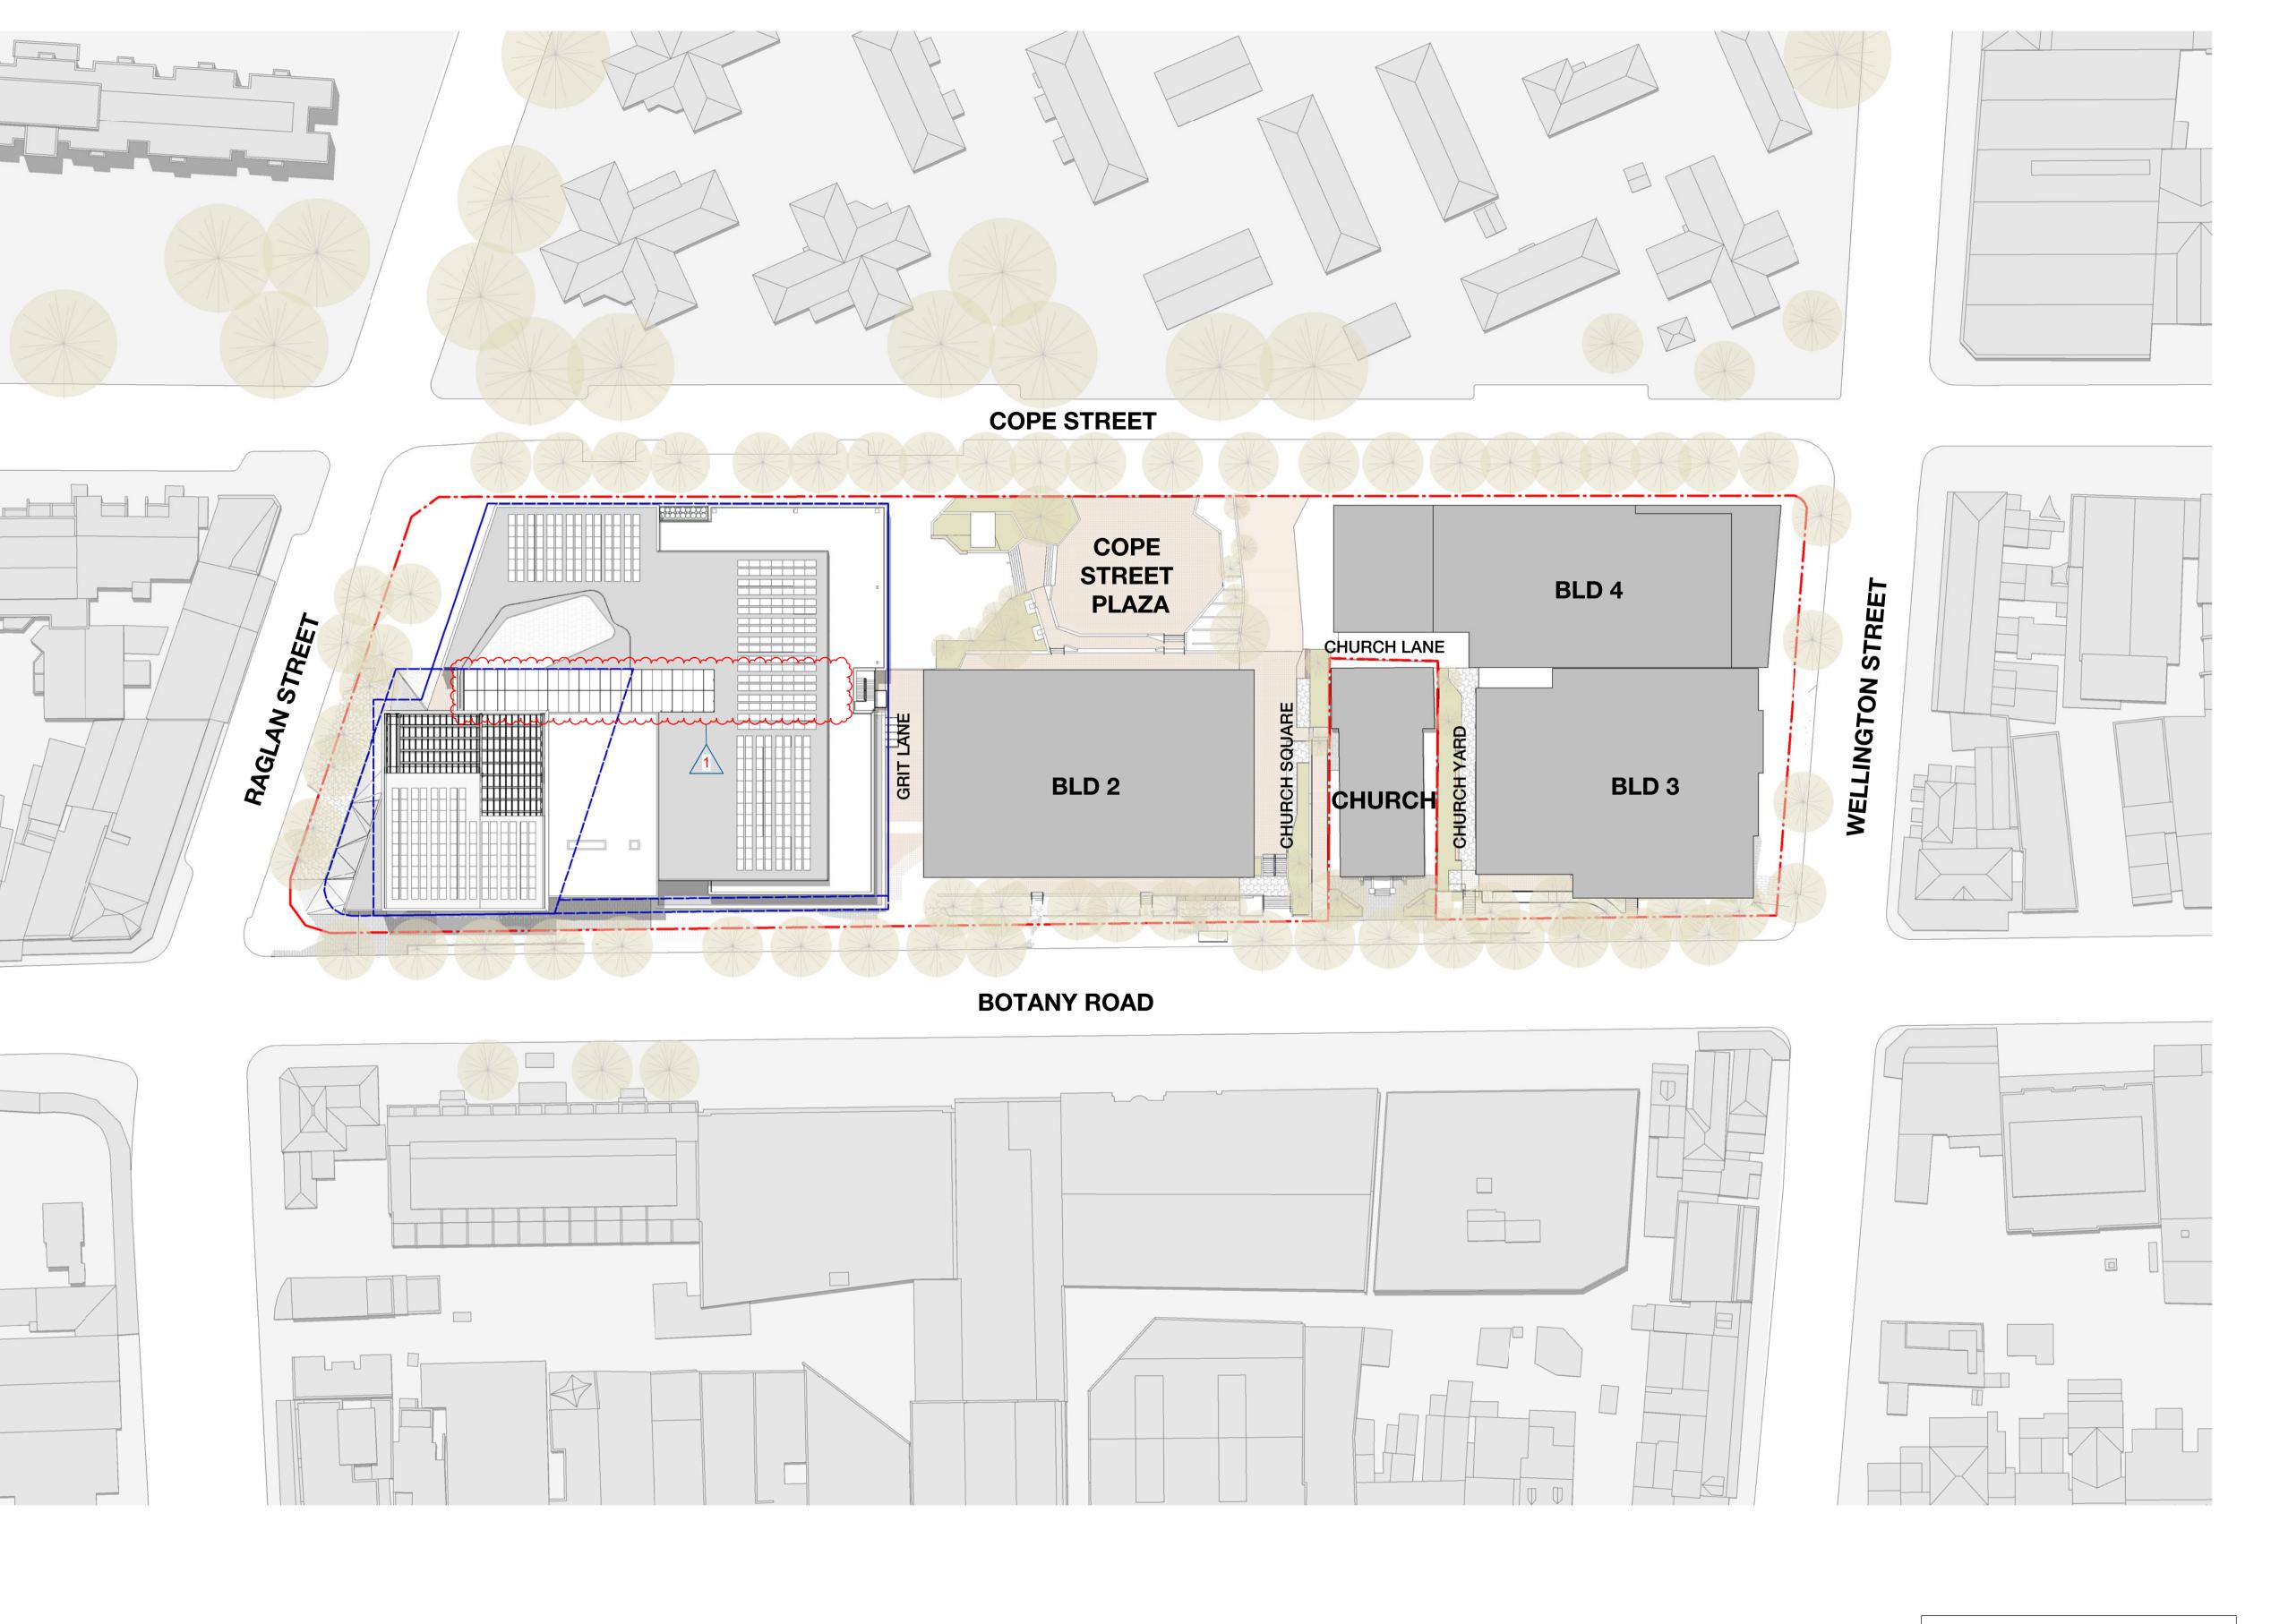

## LEGEND

--- PROPERTY LINE

--- PLANNING ENVELOPE PROFILE

SSD DA PRECINCT BOUNDARY

Status FOR APPROVAL

WOODS BAGOT

Project number

Sheet title SSD10440

WATERLOO METRO QUARTER DEVELOPMENT

Recent revision history

Current Revision Amendments # Mark Comments

FOR INFORMATION (DA)

FOR APPROVAL

FOR APPROVAL FOR APPROVAL FOR APPROVAL

E 1 GLASS ROOF AND FIRE STAIR UPDATED

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15.07.20


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28.08.20 25.09.20 15.03.21

WMQ-BLD1-WBG-AR-DRG-DA002 E

BUILDING 1 - SITE PLAN (ROOF LEVEL)

North Point

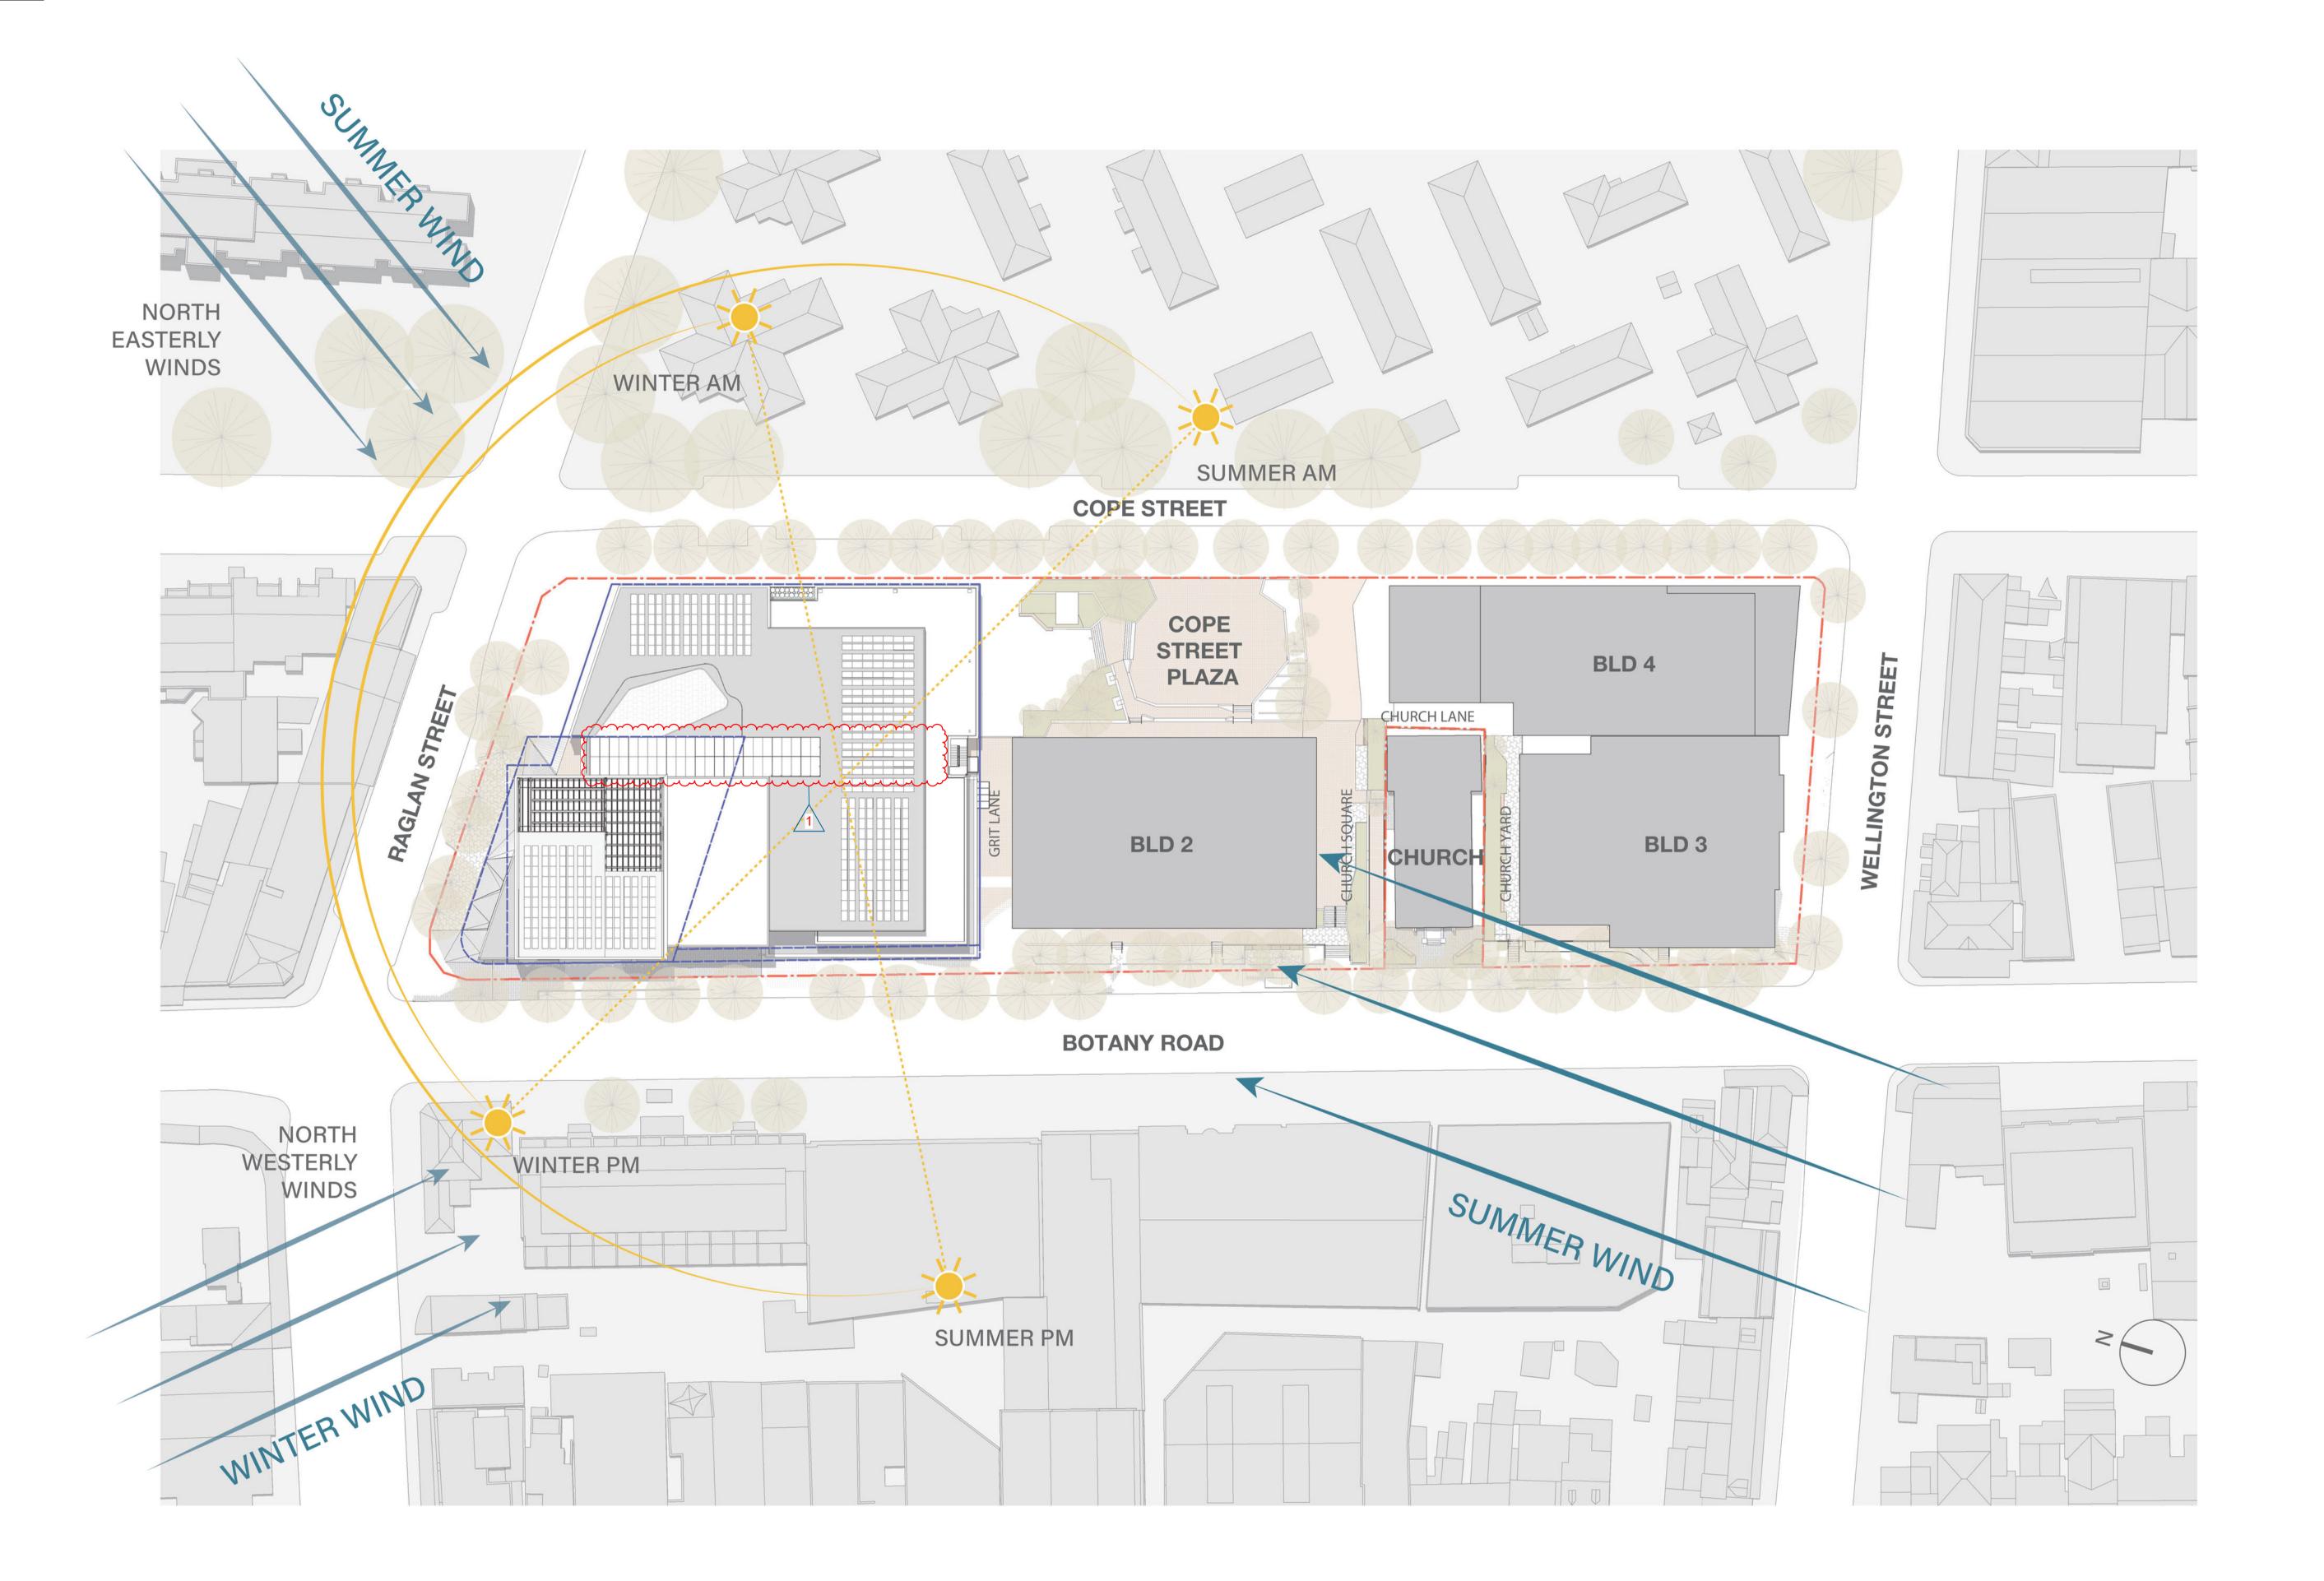

## LEGEND

--- PROPERTY LINE

--- PLANNING ENVELOPE PROFILE

SSD DA PRECINCT BOUNDARY

Status
FOR APPROVAL

BUILDING 1 - SITE ANALYSIS

**WOODS BAGOT** 

Project number

Sheet title SSD10440

WATERLOO METRO QUARTER DEVELOPMENT

North Point

Recent revision history

Current Revision Amendments
# Mark Comments

FOR INFORMATION (DA)

FOR APPROVAL

FOR APPROVAL

FOR APPROVAL

E 1 GLASS ROOF AND FIRE STAIR UPDATED

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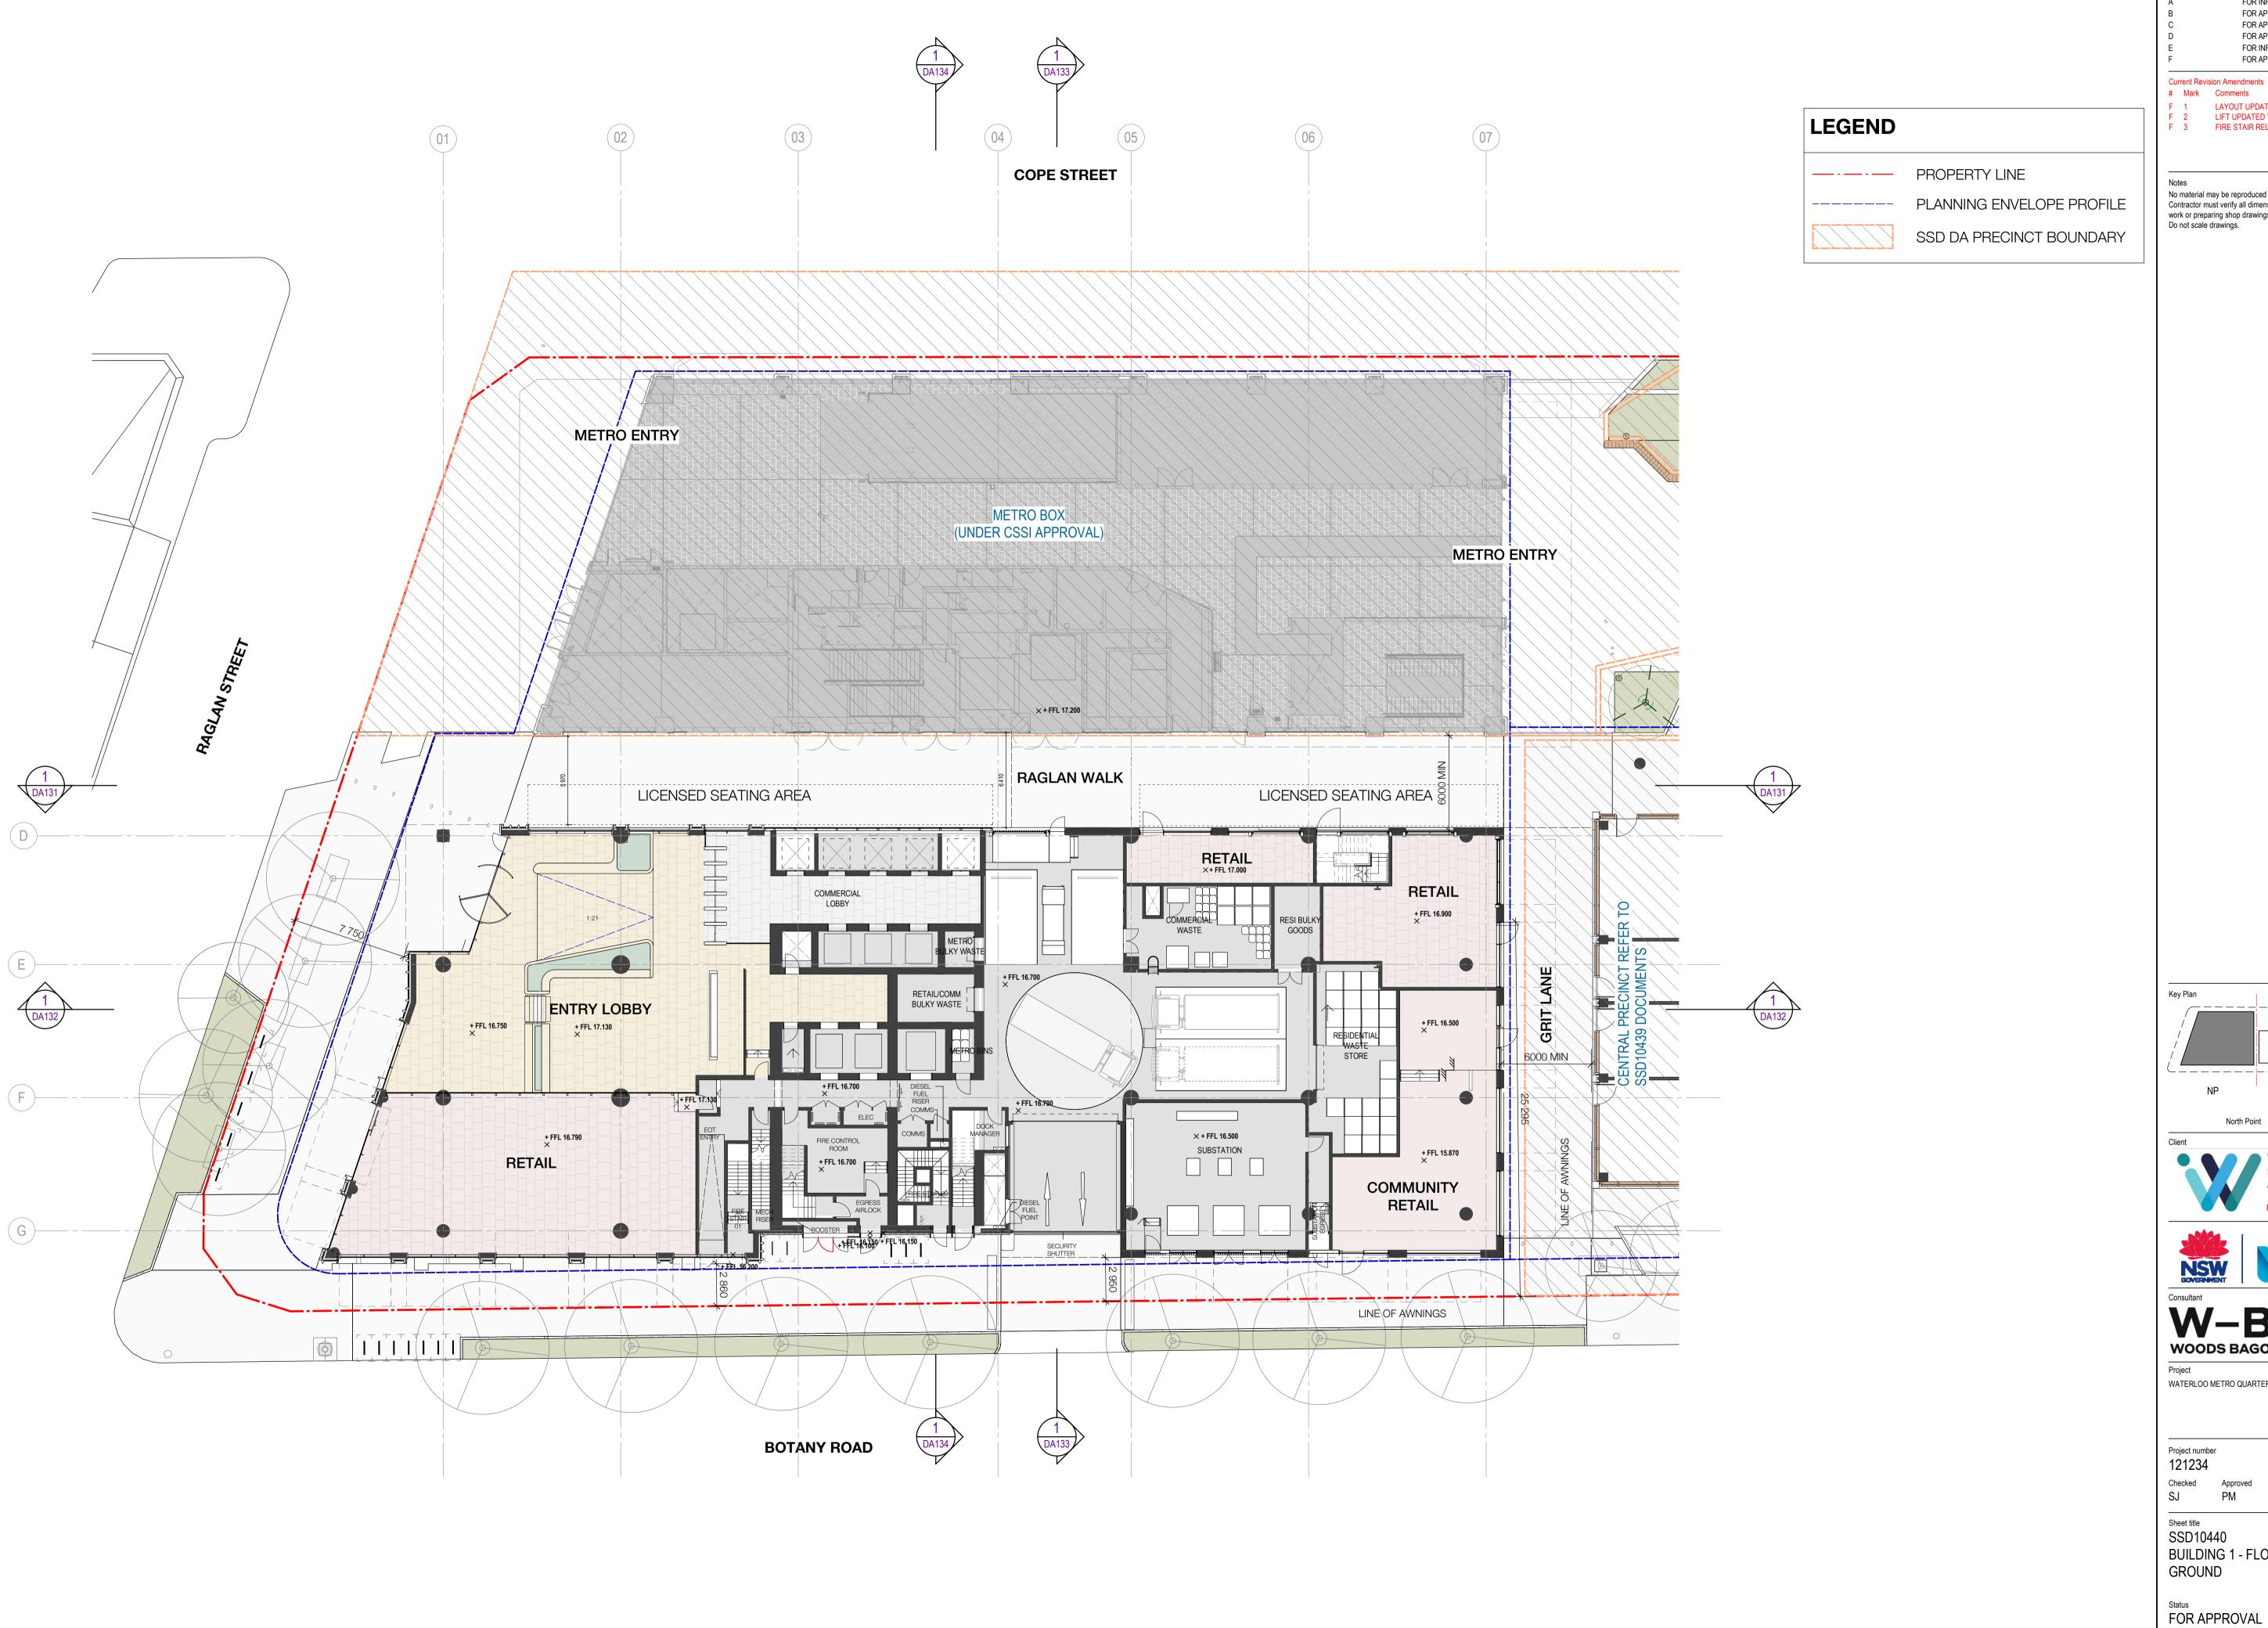
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Sheet number Revision WMQ-BLD1-WBG-AR-DRG-DA003 E




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# Mark Comments

F 1 LAYOUT UPDATED
F 2 LIFT UPDATED TO GROUND
F 3 FIRE STAIR RELOCATED

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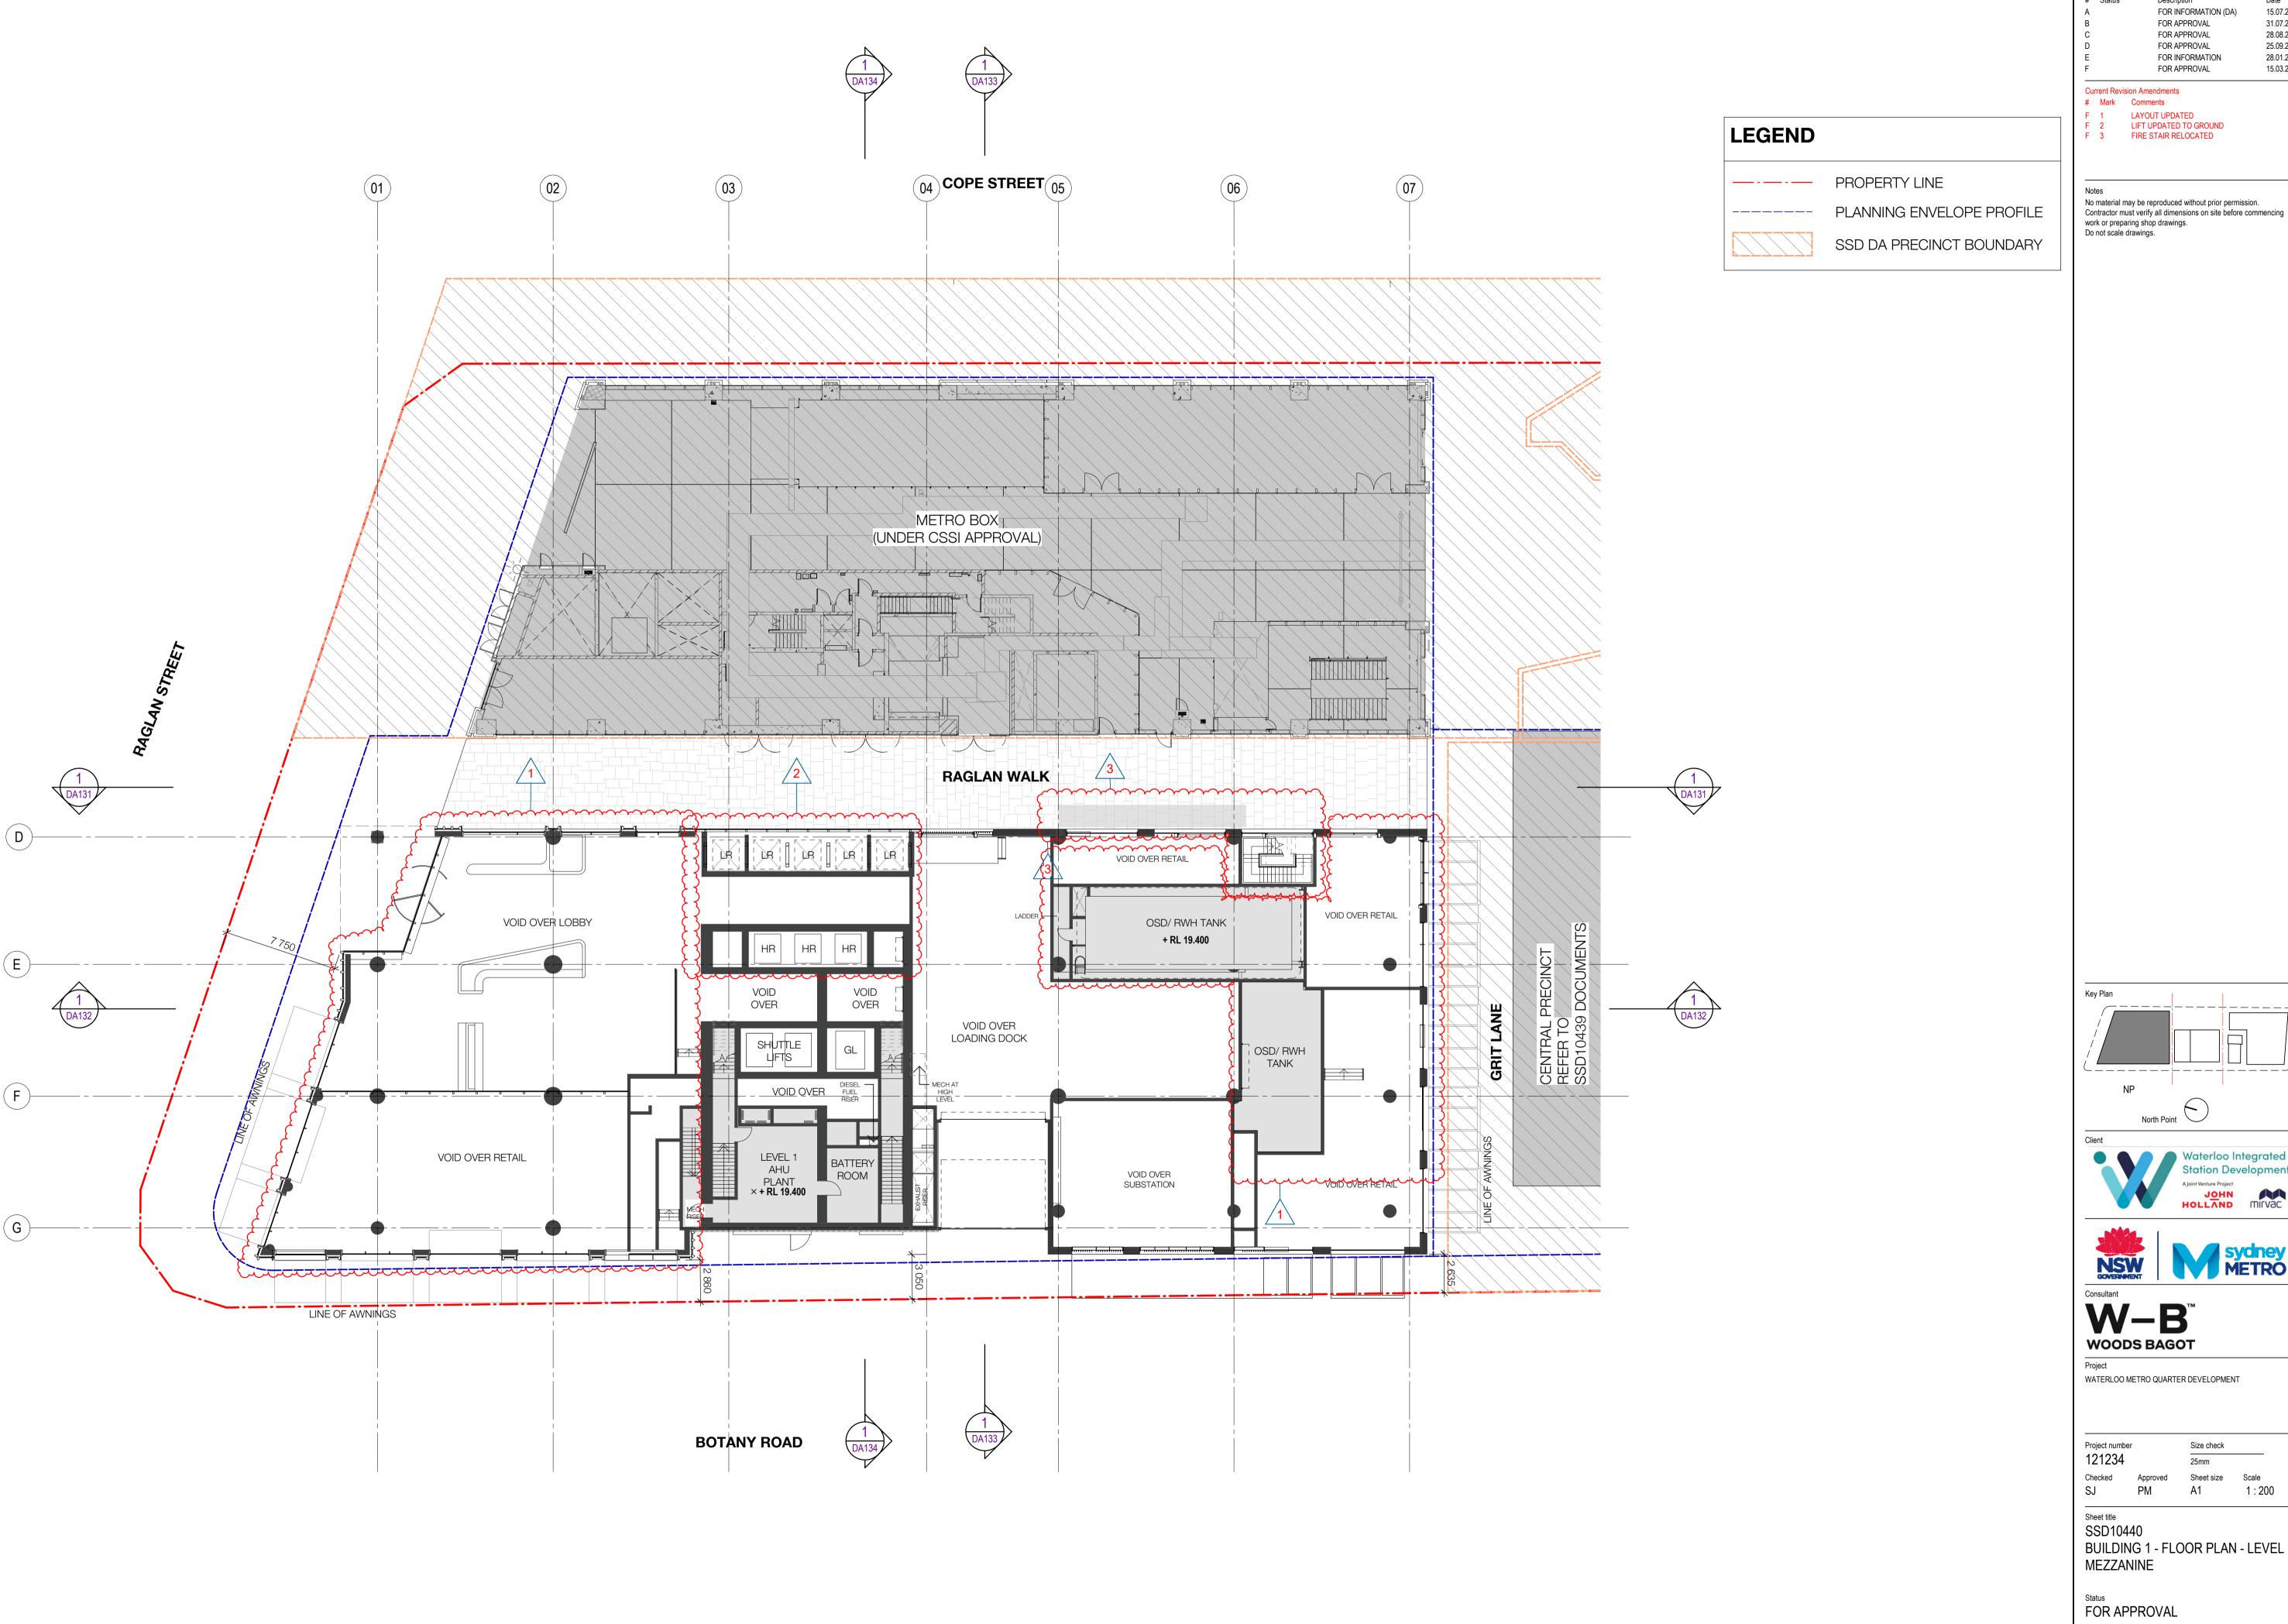


WATERLOO METRO QUARTER DEVELOPMENT

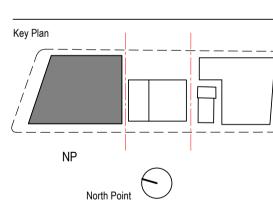BUILDING 1 - FLOOR PLAN - LEVEL

WMQ-BLD1-WBG-AR-DRG-DA100 F

A1



Recent revision history # Status FOR INFORMATION (DA) 15.07.20 FOR APPROVAL 31.07.20 FOR APPROVAL 28.08.20 FOR APPROVAL 25.09.20 FOR INFORMATION 28.01.21 15.03.21 FOR APPROVAL

Current Revision Amendments

F 1 LAYOUT UPDATED
F 2 LIFT UPDATED TO GROUND
F 3 FIRE STAIR RELOCATED

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North Point








WATERLOO METRO QUARTER DEVELOPMENT

A1

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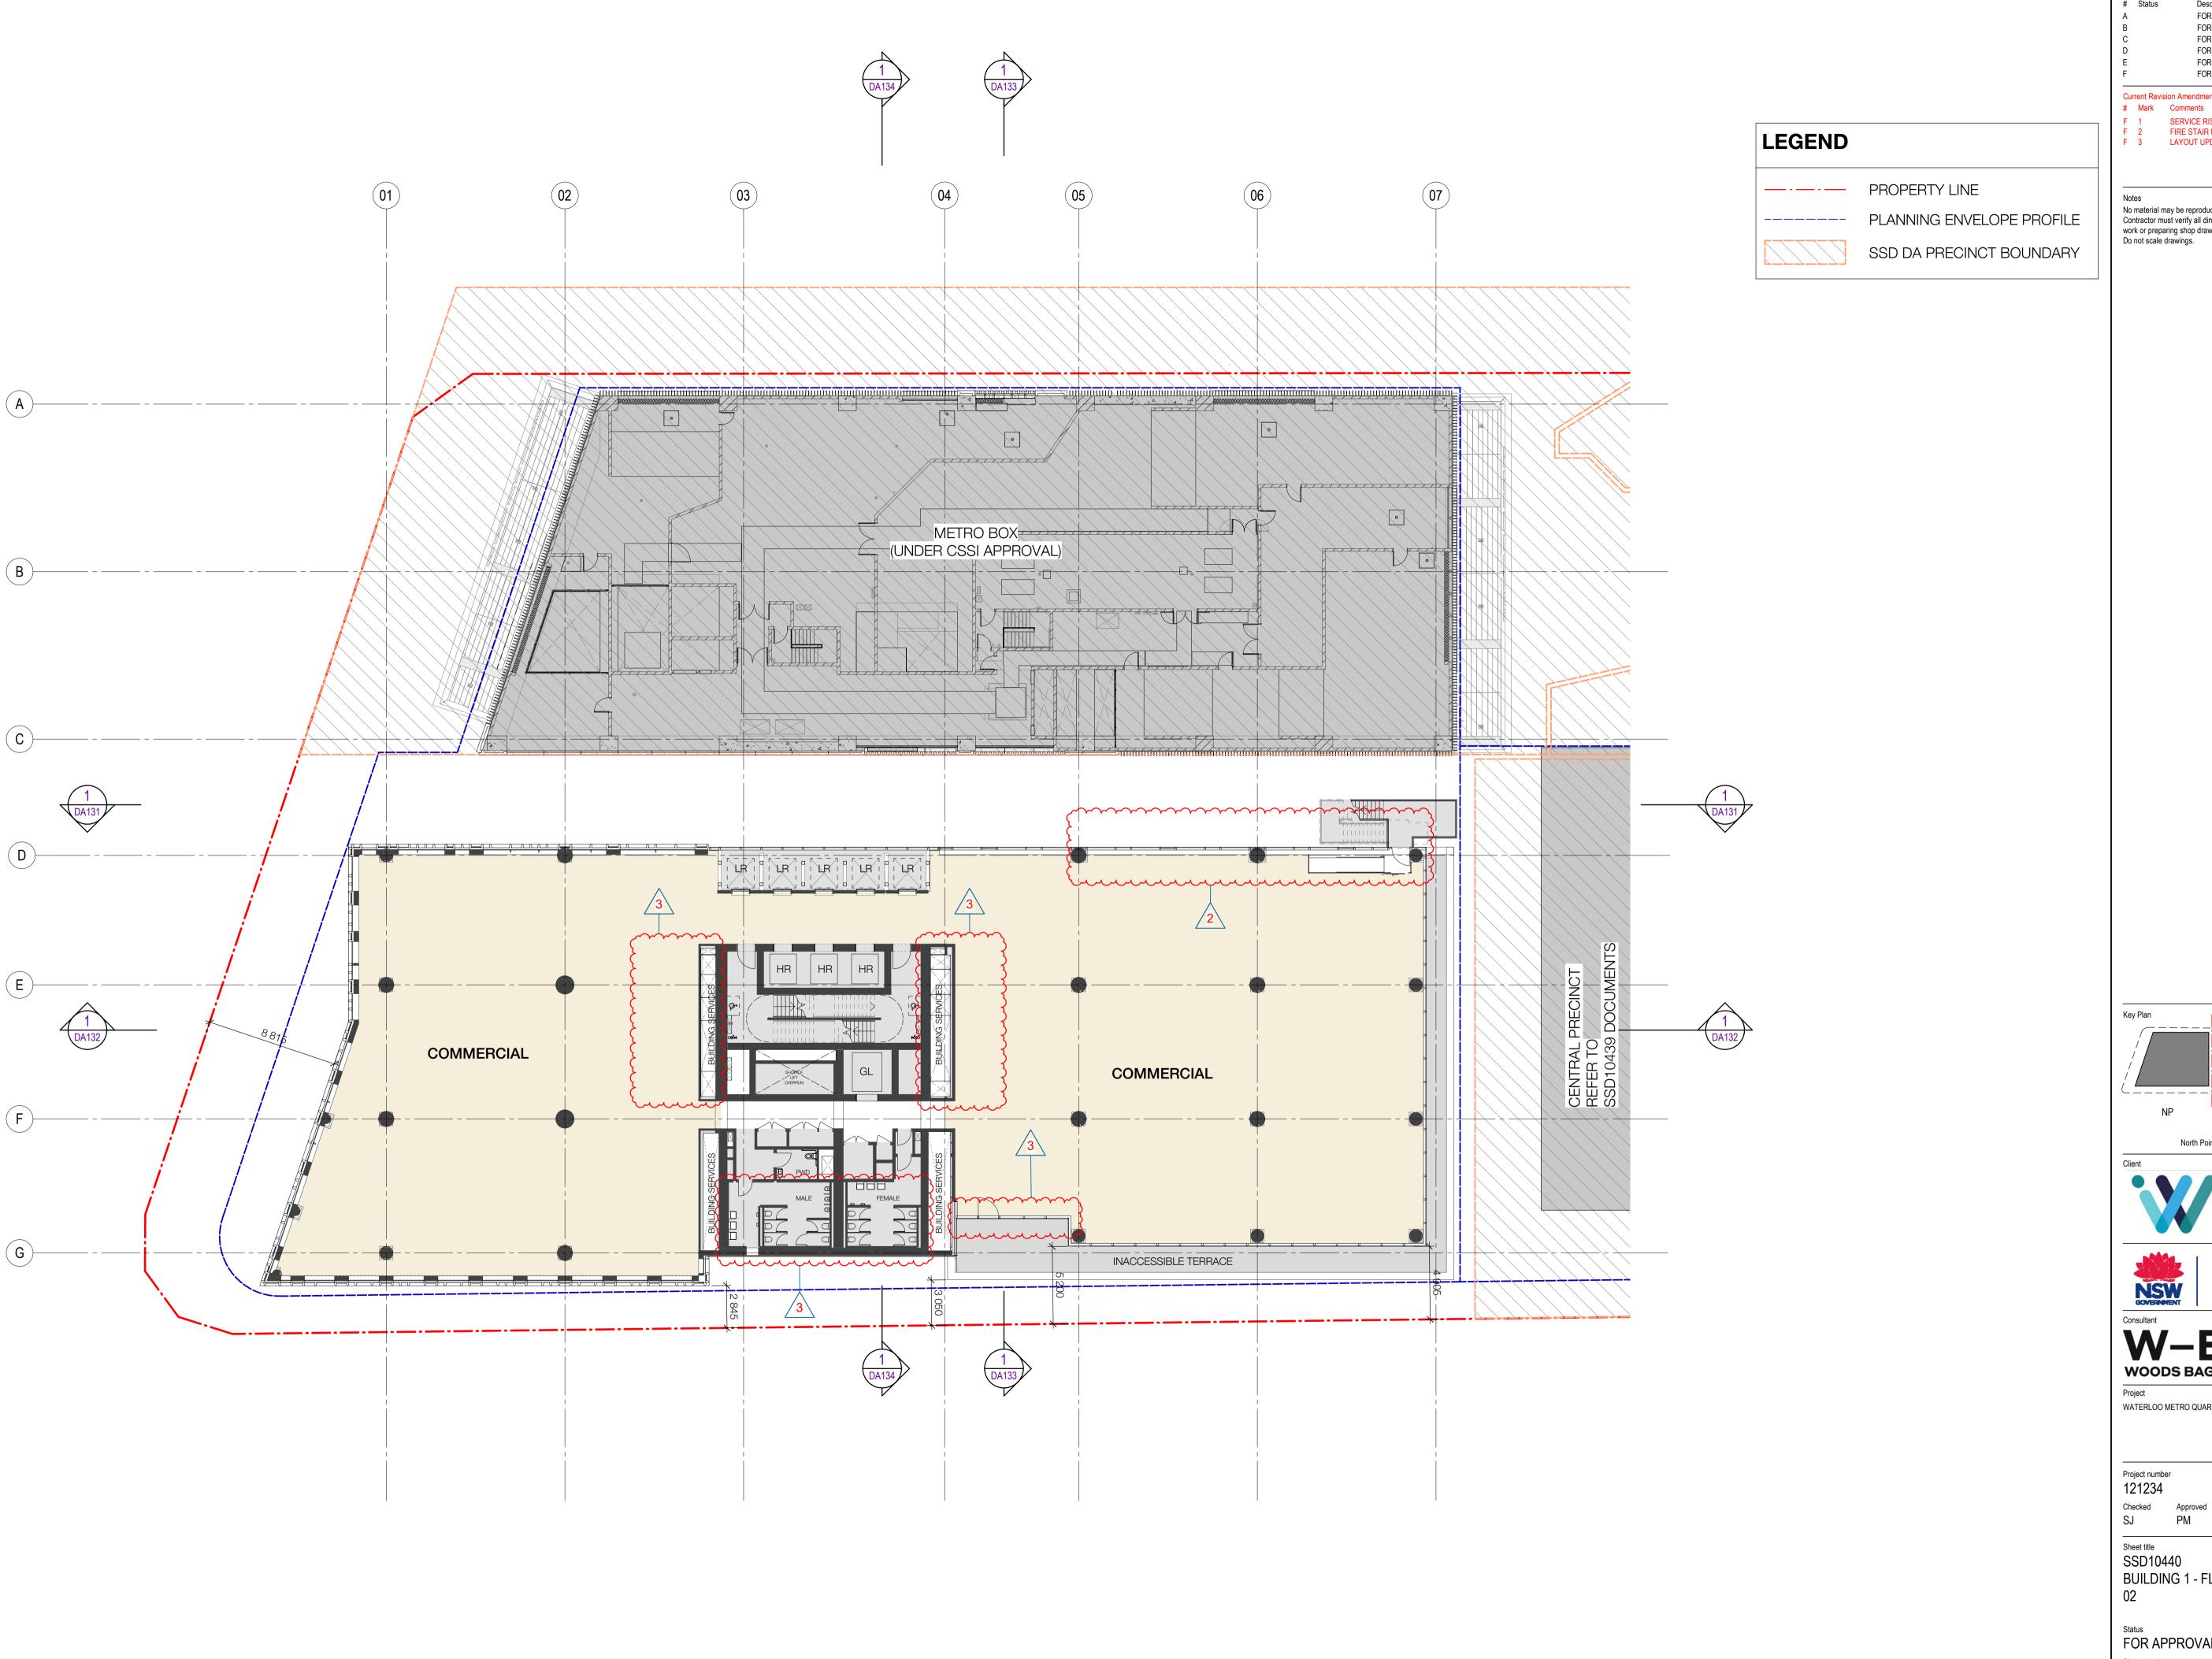
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28.01.21 15.03.21

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Current Revision Amendments

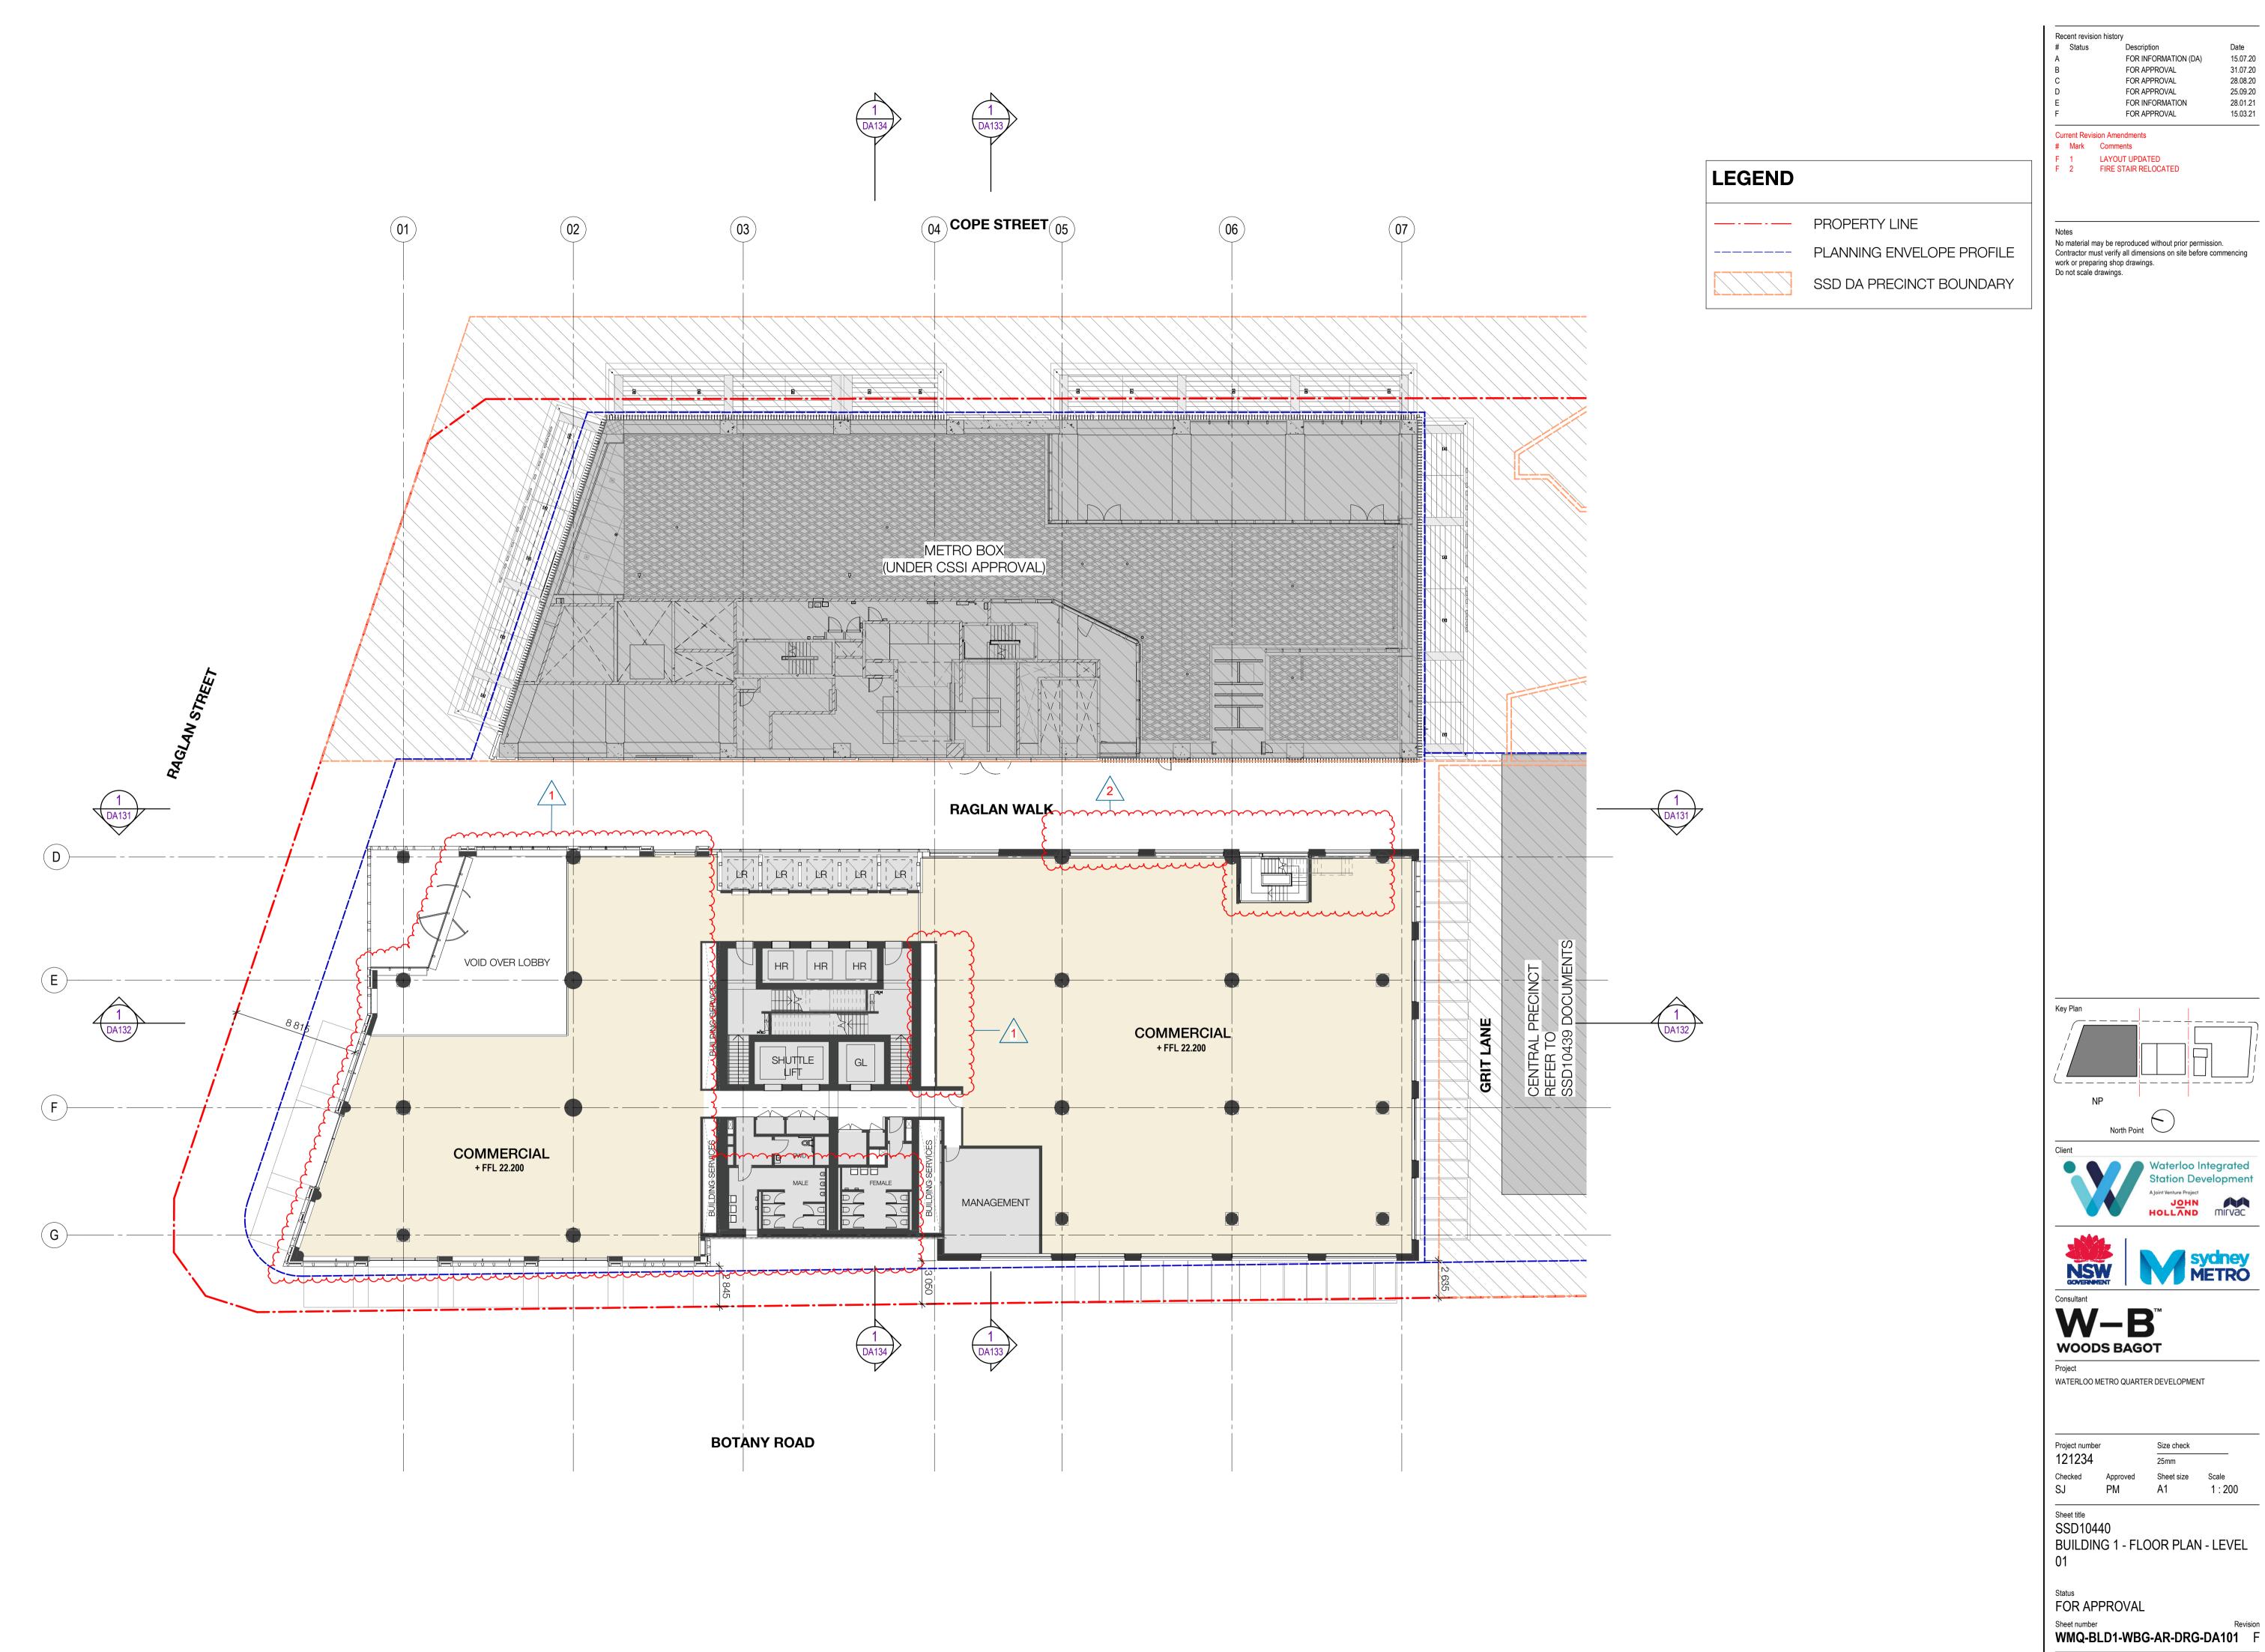F 1 SERVICE RISER UPDATED
F 2 FIRE STAIR UPDATED
F 3 LAYOUT UPDATED

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North Point







WATERLOO METRO QUARTER DEVELOPMENT


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BUILDING 1 - FLOOR PLAN - LEVEL

Status FOR APPROVAL

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Current Revision Amendments

F 1 SERVICE RISER UPDATED F 2 FIRE STAIR UPDATED F 3 LAYOUT UPDATED

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North Point

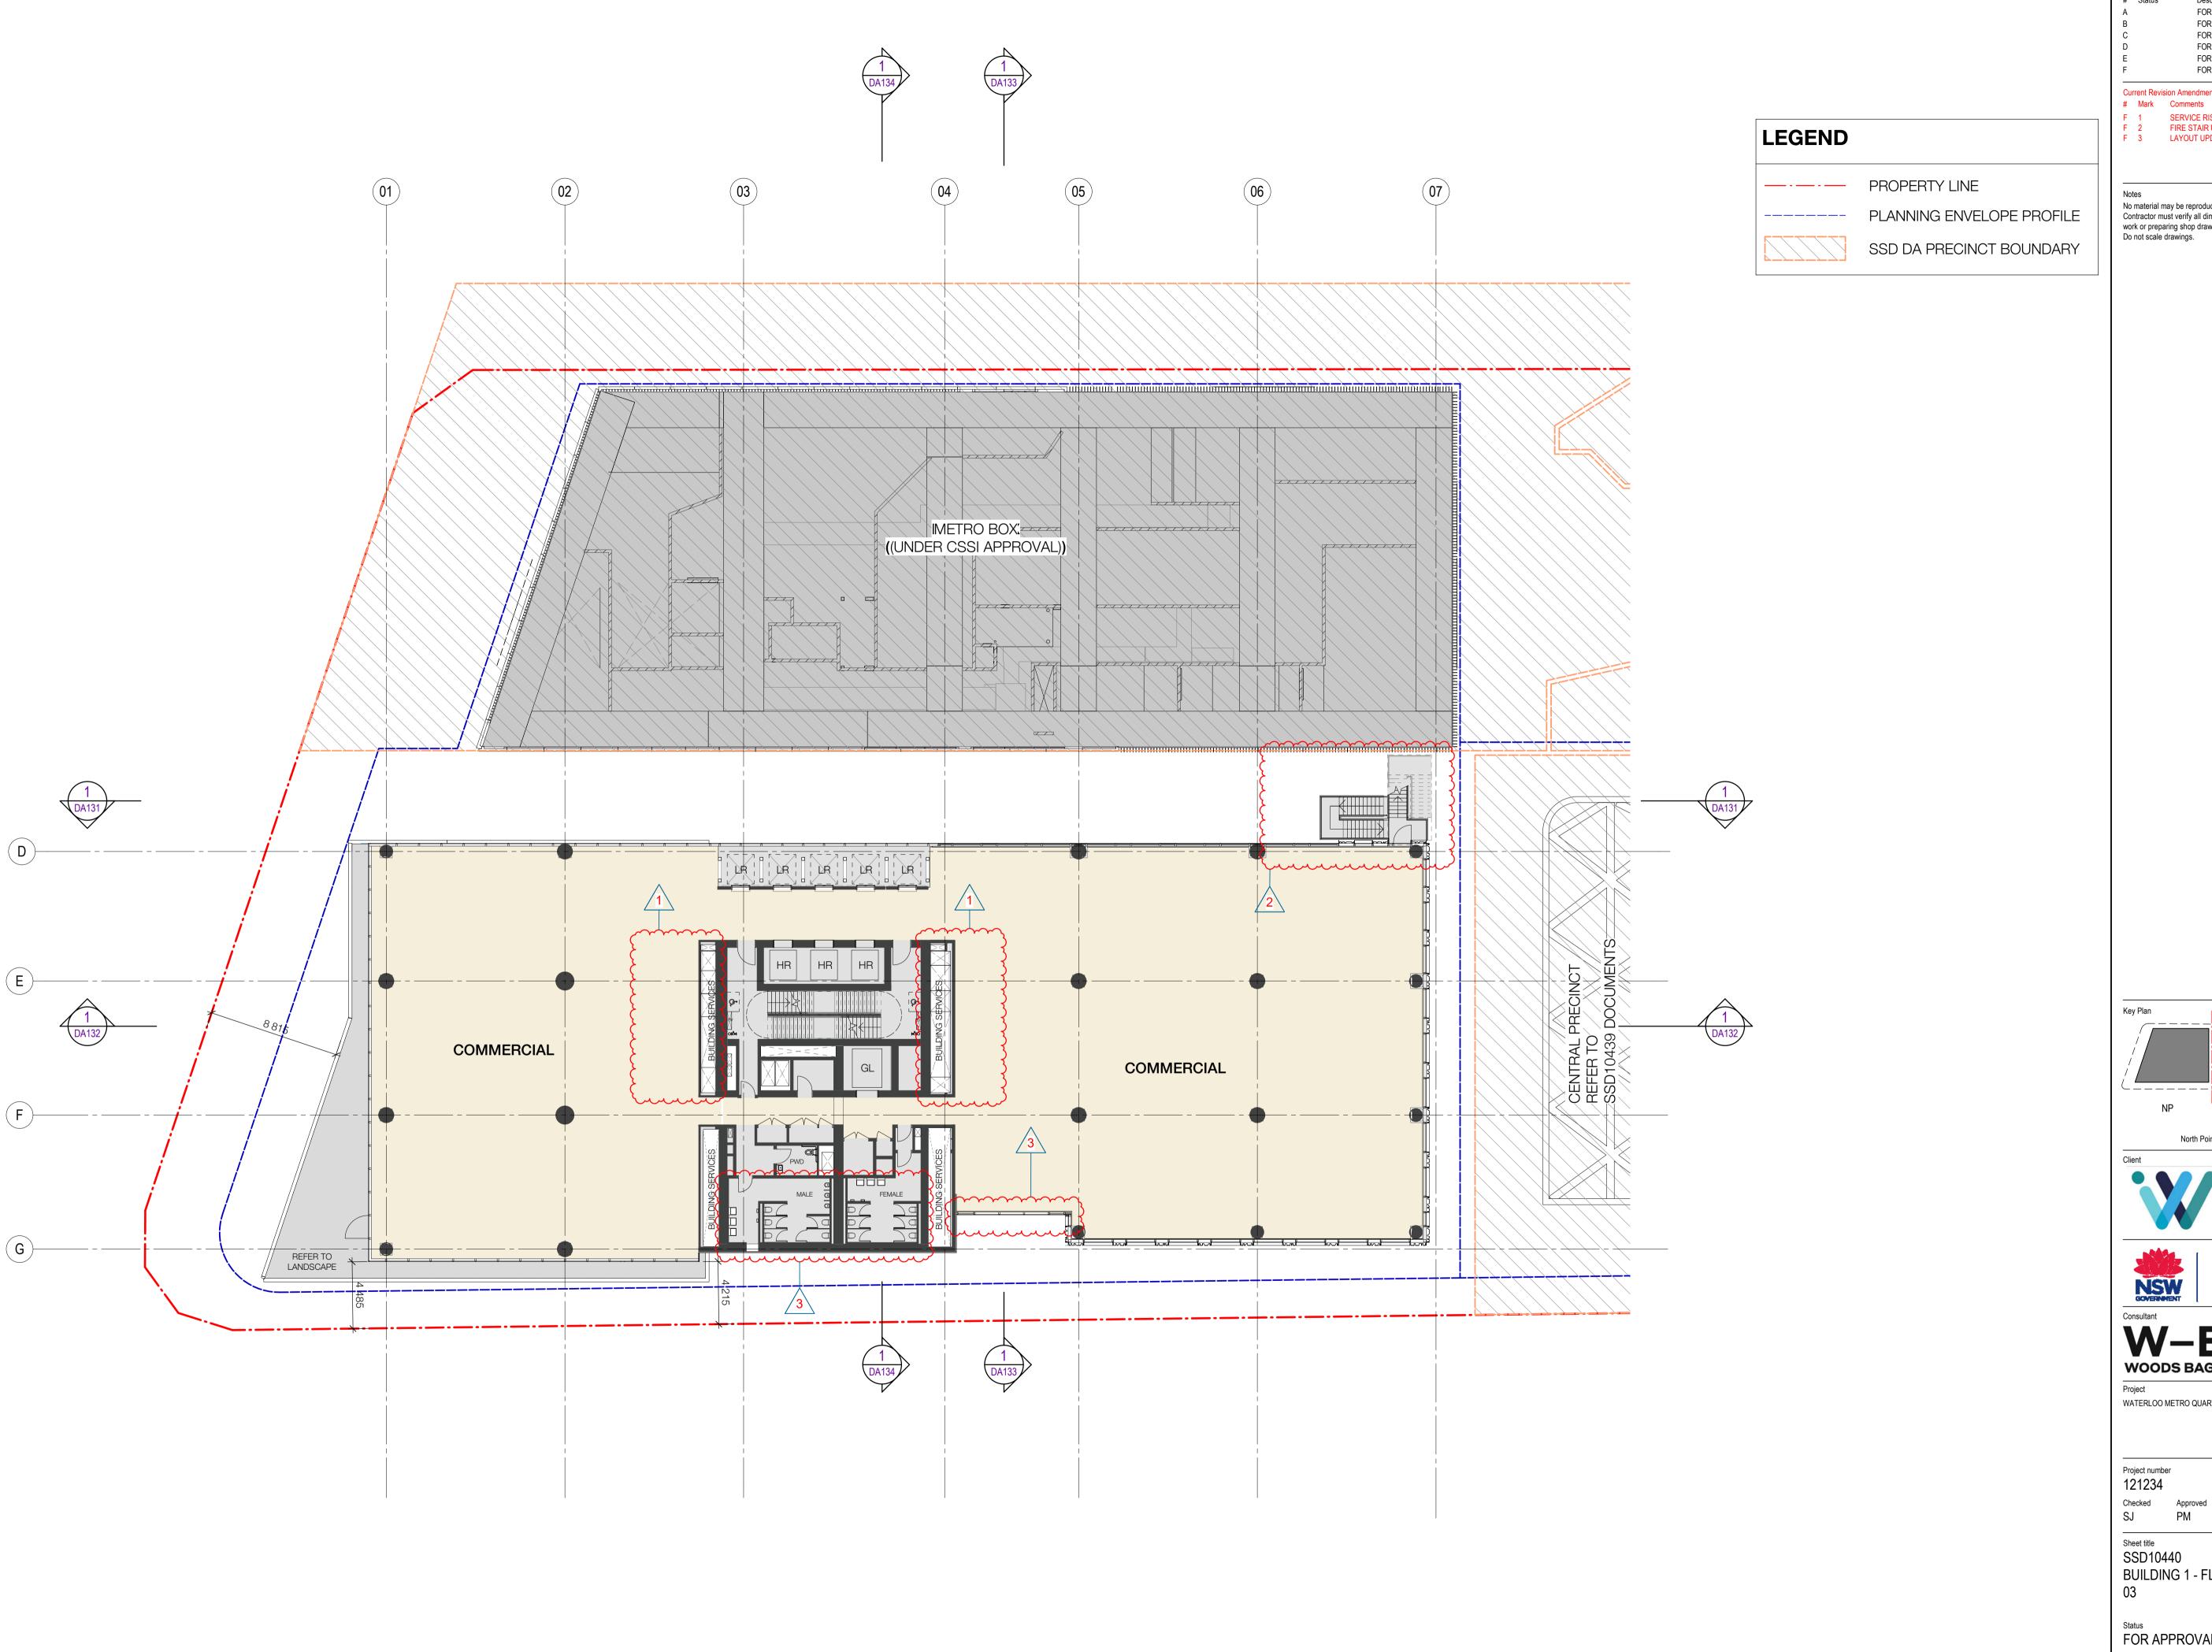






WATERLOO METRO QUARTER DEVELOPMENT

BUILDING 1 - FLOOR PLAN - LEVEL

Status FOR APPROVAL

WMQ-BLD1-WBG-AR-DRG-DA103 F

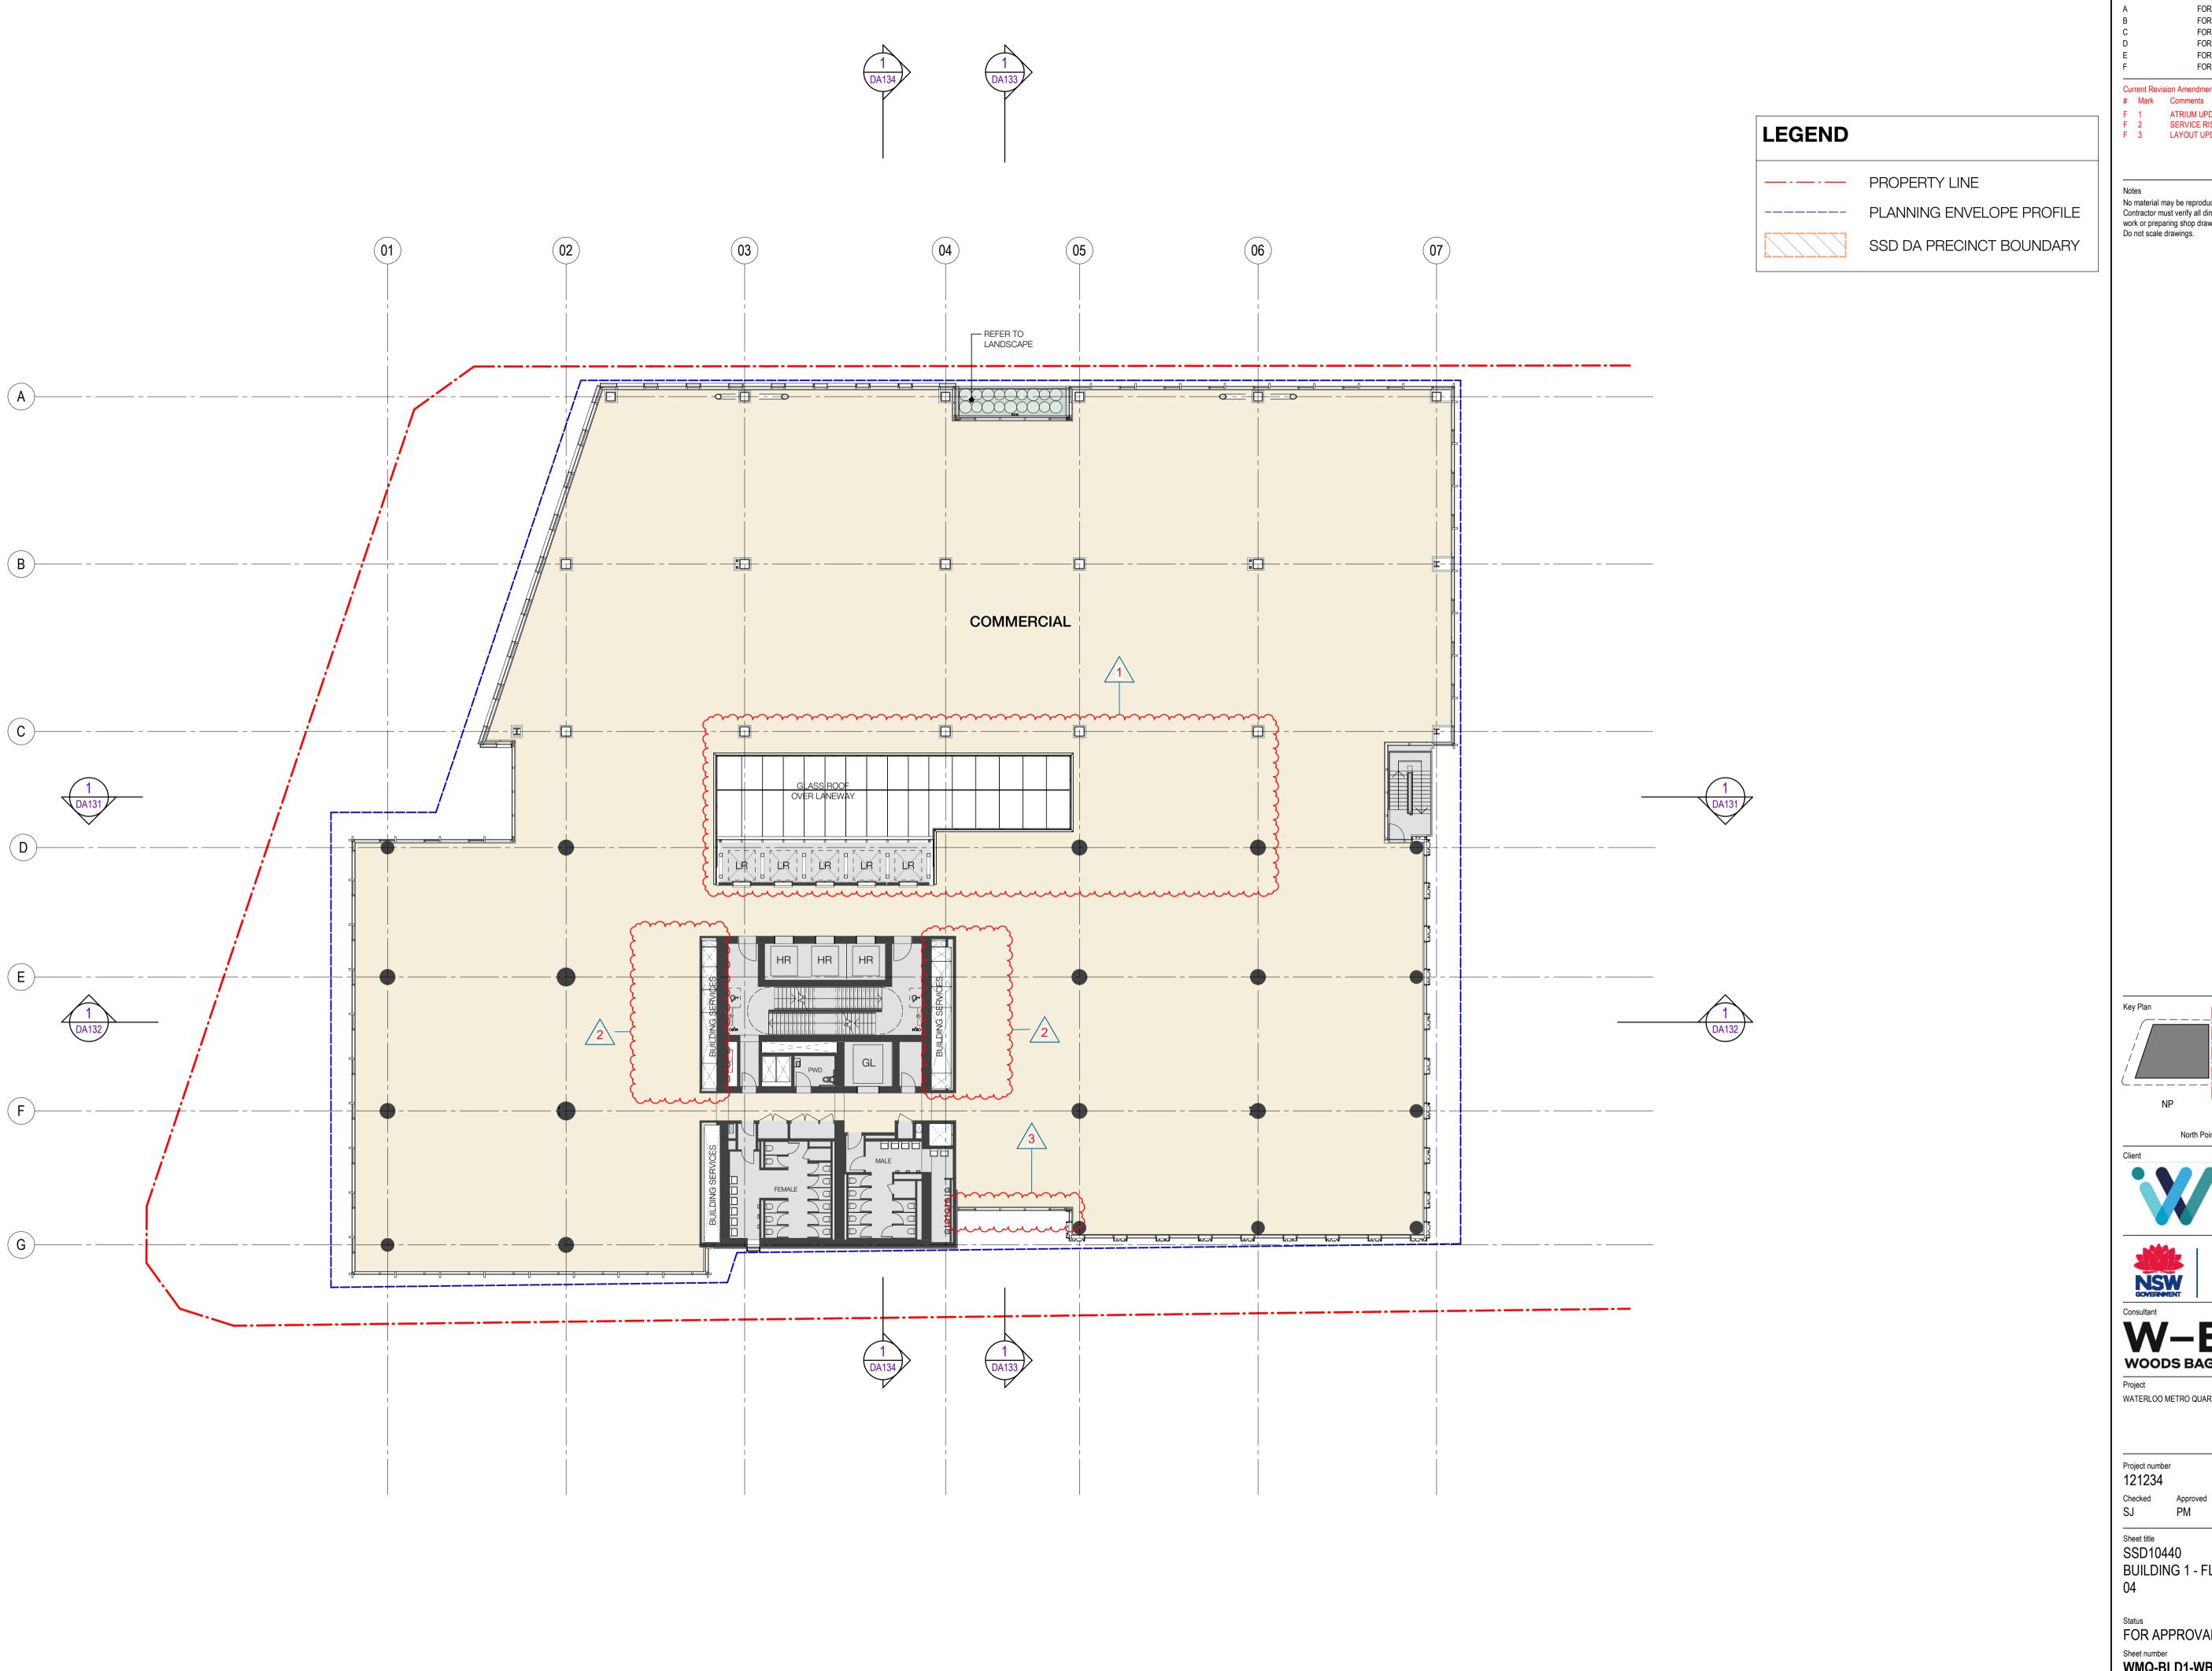

Recent revision history # Status FOR INFORMATION (DA) 15.07.20 FOR APPROVAL 31.07.20 28.08.20 FOR APPROVAL FOR APPROVAL 25.09.20 FOR INFORMATION 28.01.21 15.03.21 FOR APPROVAL

Current Revision Amendments

F 1 ATRIUM UPDATED
F 2 SERVICE RISER UPDATED
F 3 LAYOUT UPDATED

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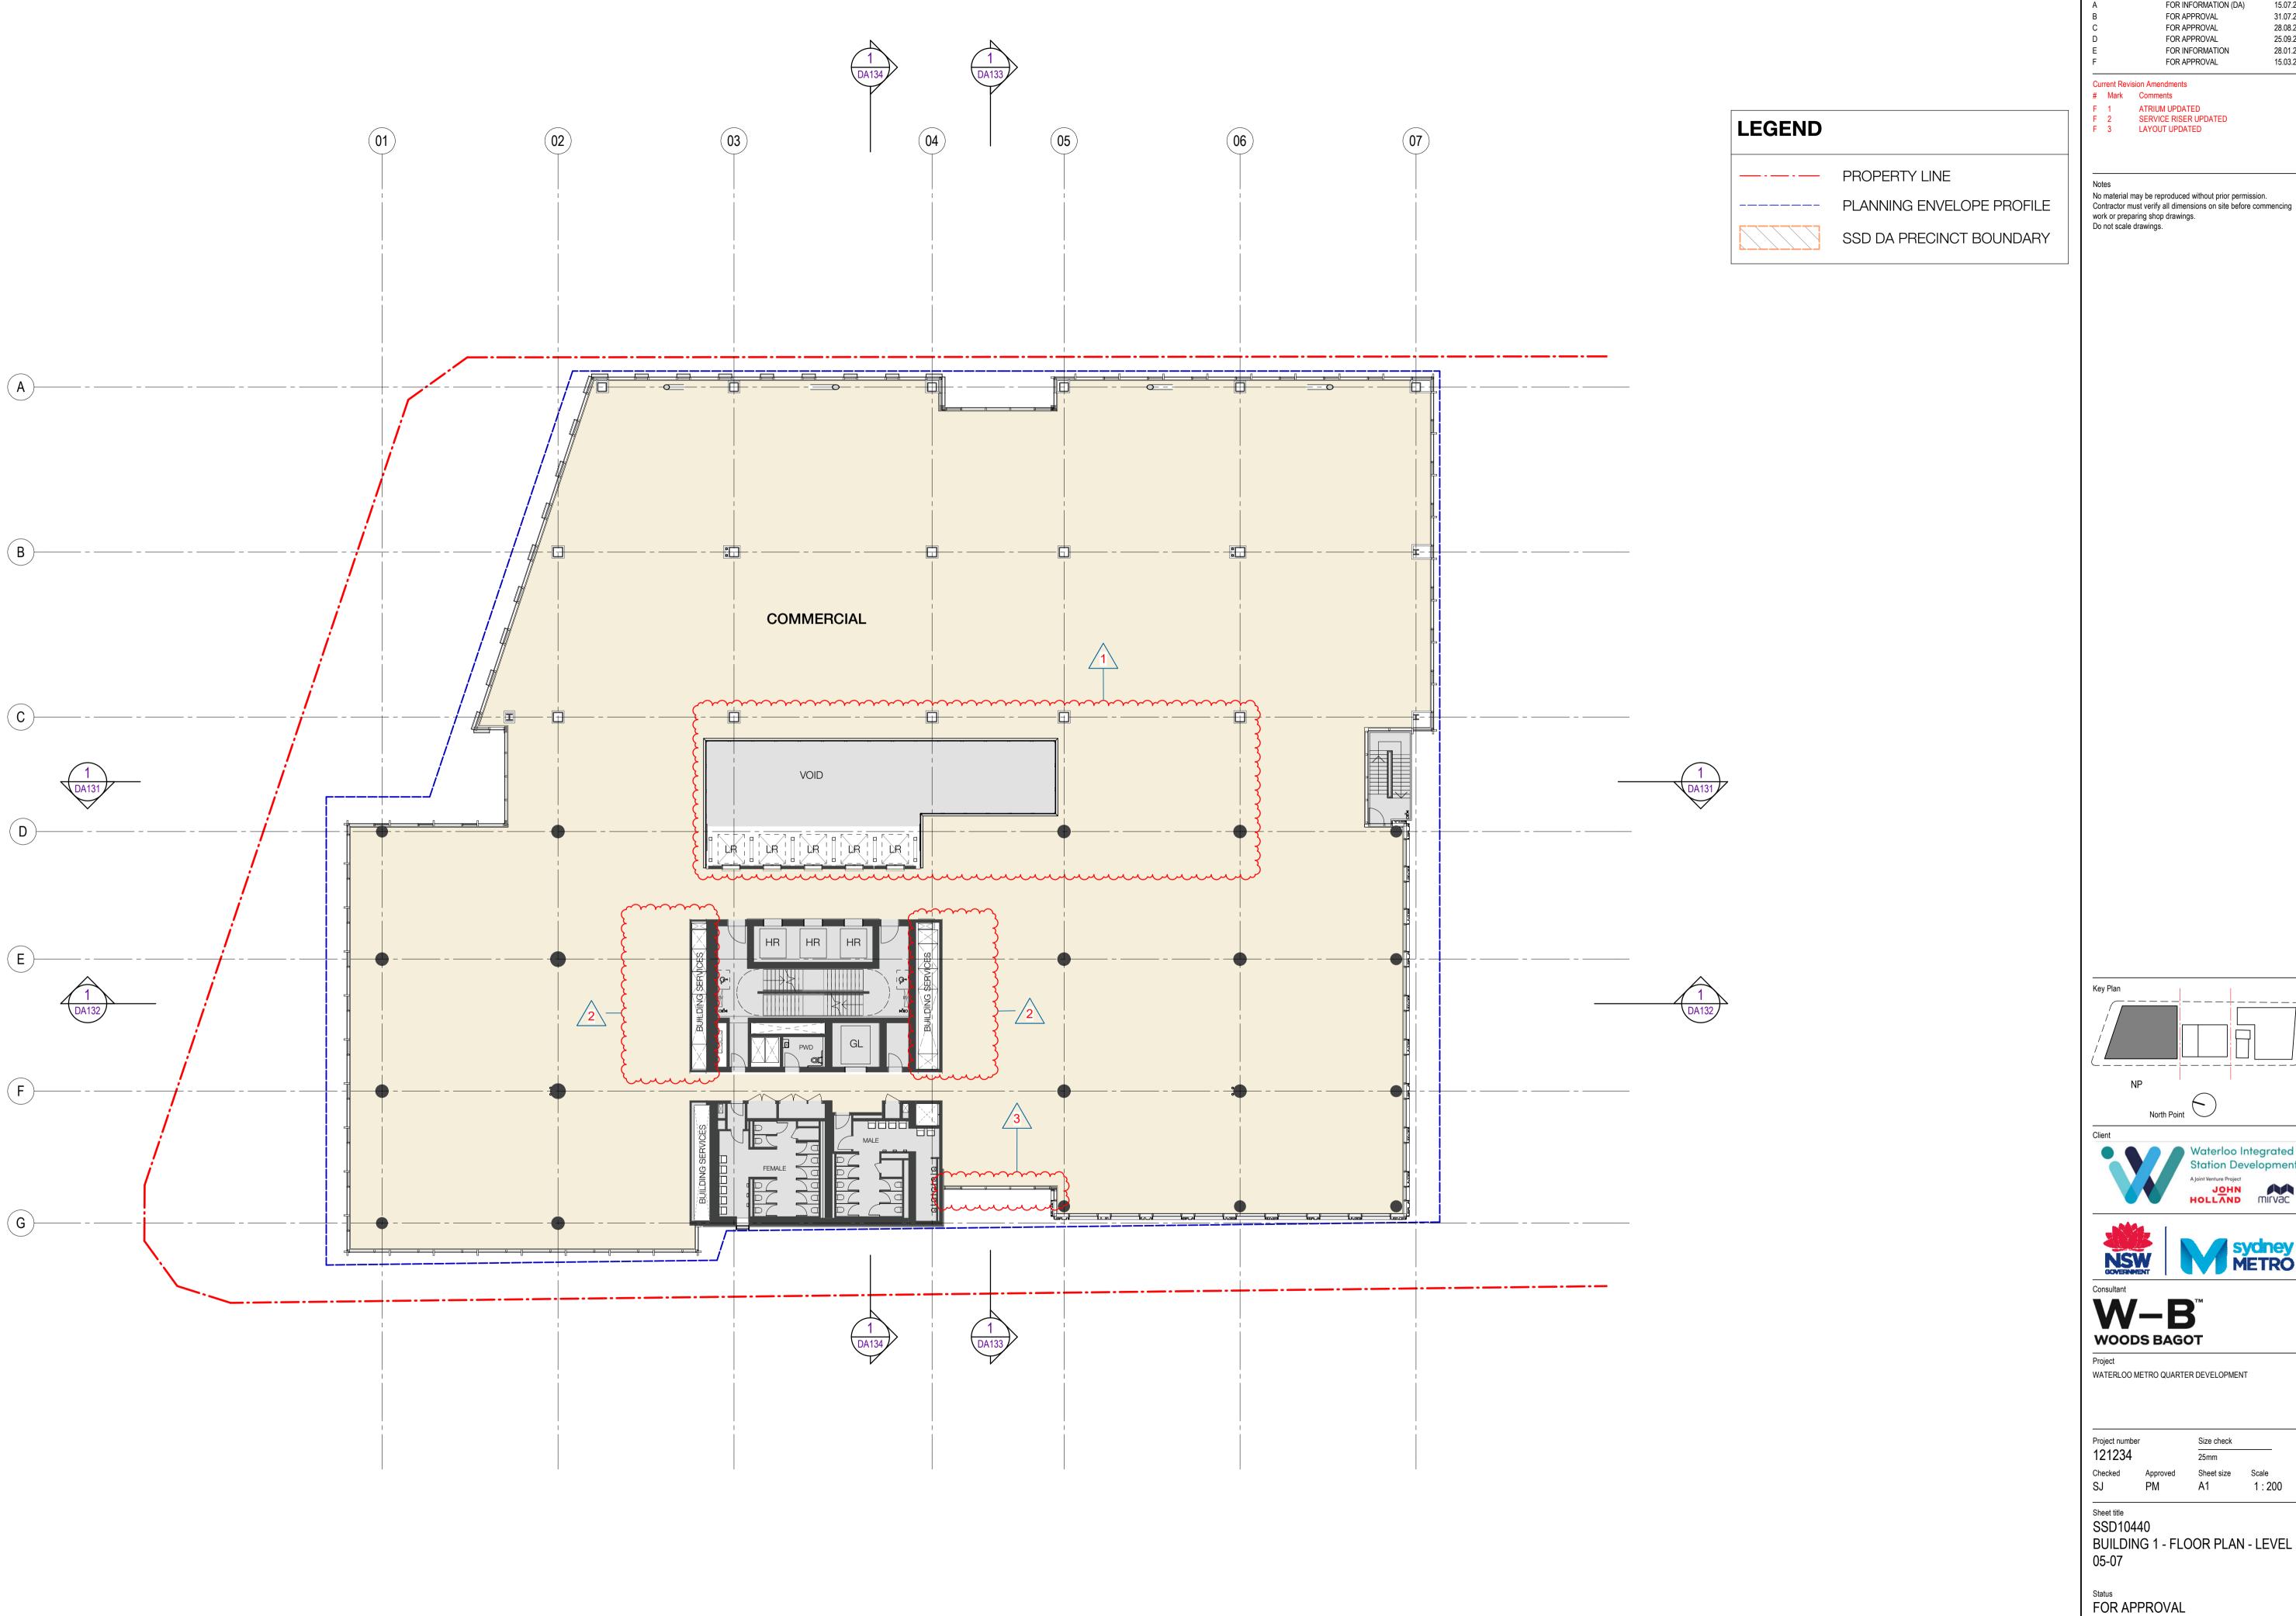
WATERLOO METRO QUARTER DEVELOPMENT

Project number		Size check	
121234		25mm	
Checked	Approved	Sheet size	Scale
SJ	PM	A1	1:2

BUILDING 1 - FLOOR PLAN - LEVEL

Status FOR APPROVAL

WMQ-BLD1-WBG-AR-DRG-DA104 F




Recent revision history # Status FOR INFORMATION (DA) 15.07.20 31.07.20 28.08.20 25.09.20 28.01.21 15.03.21

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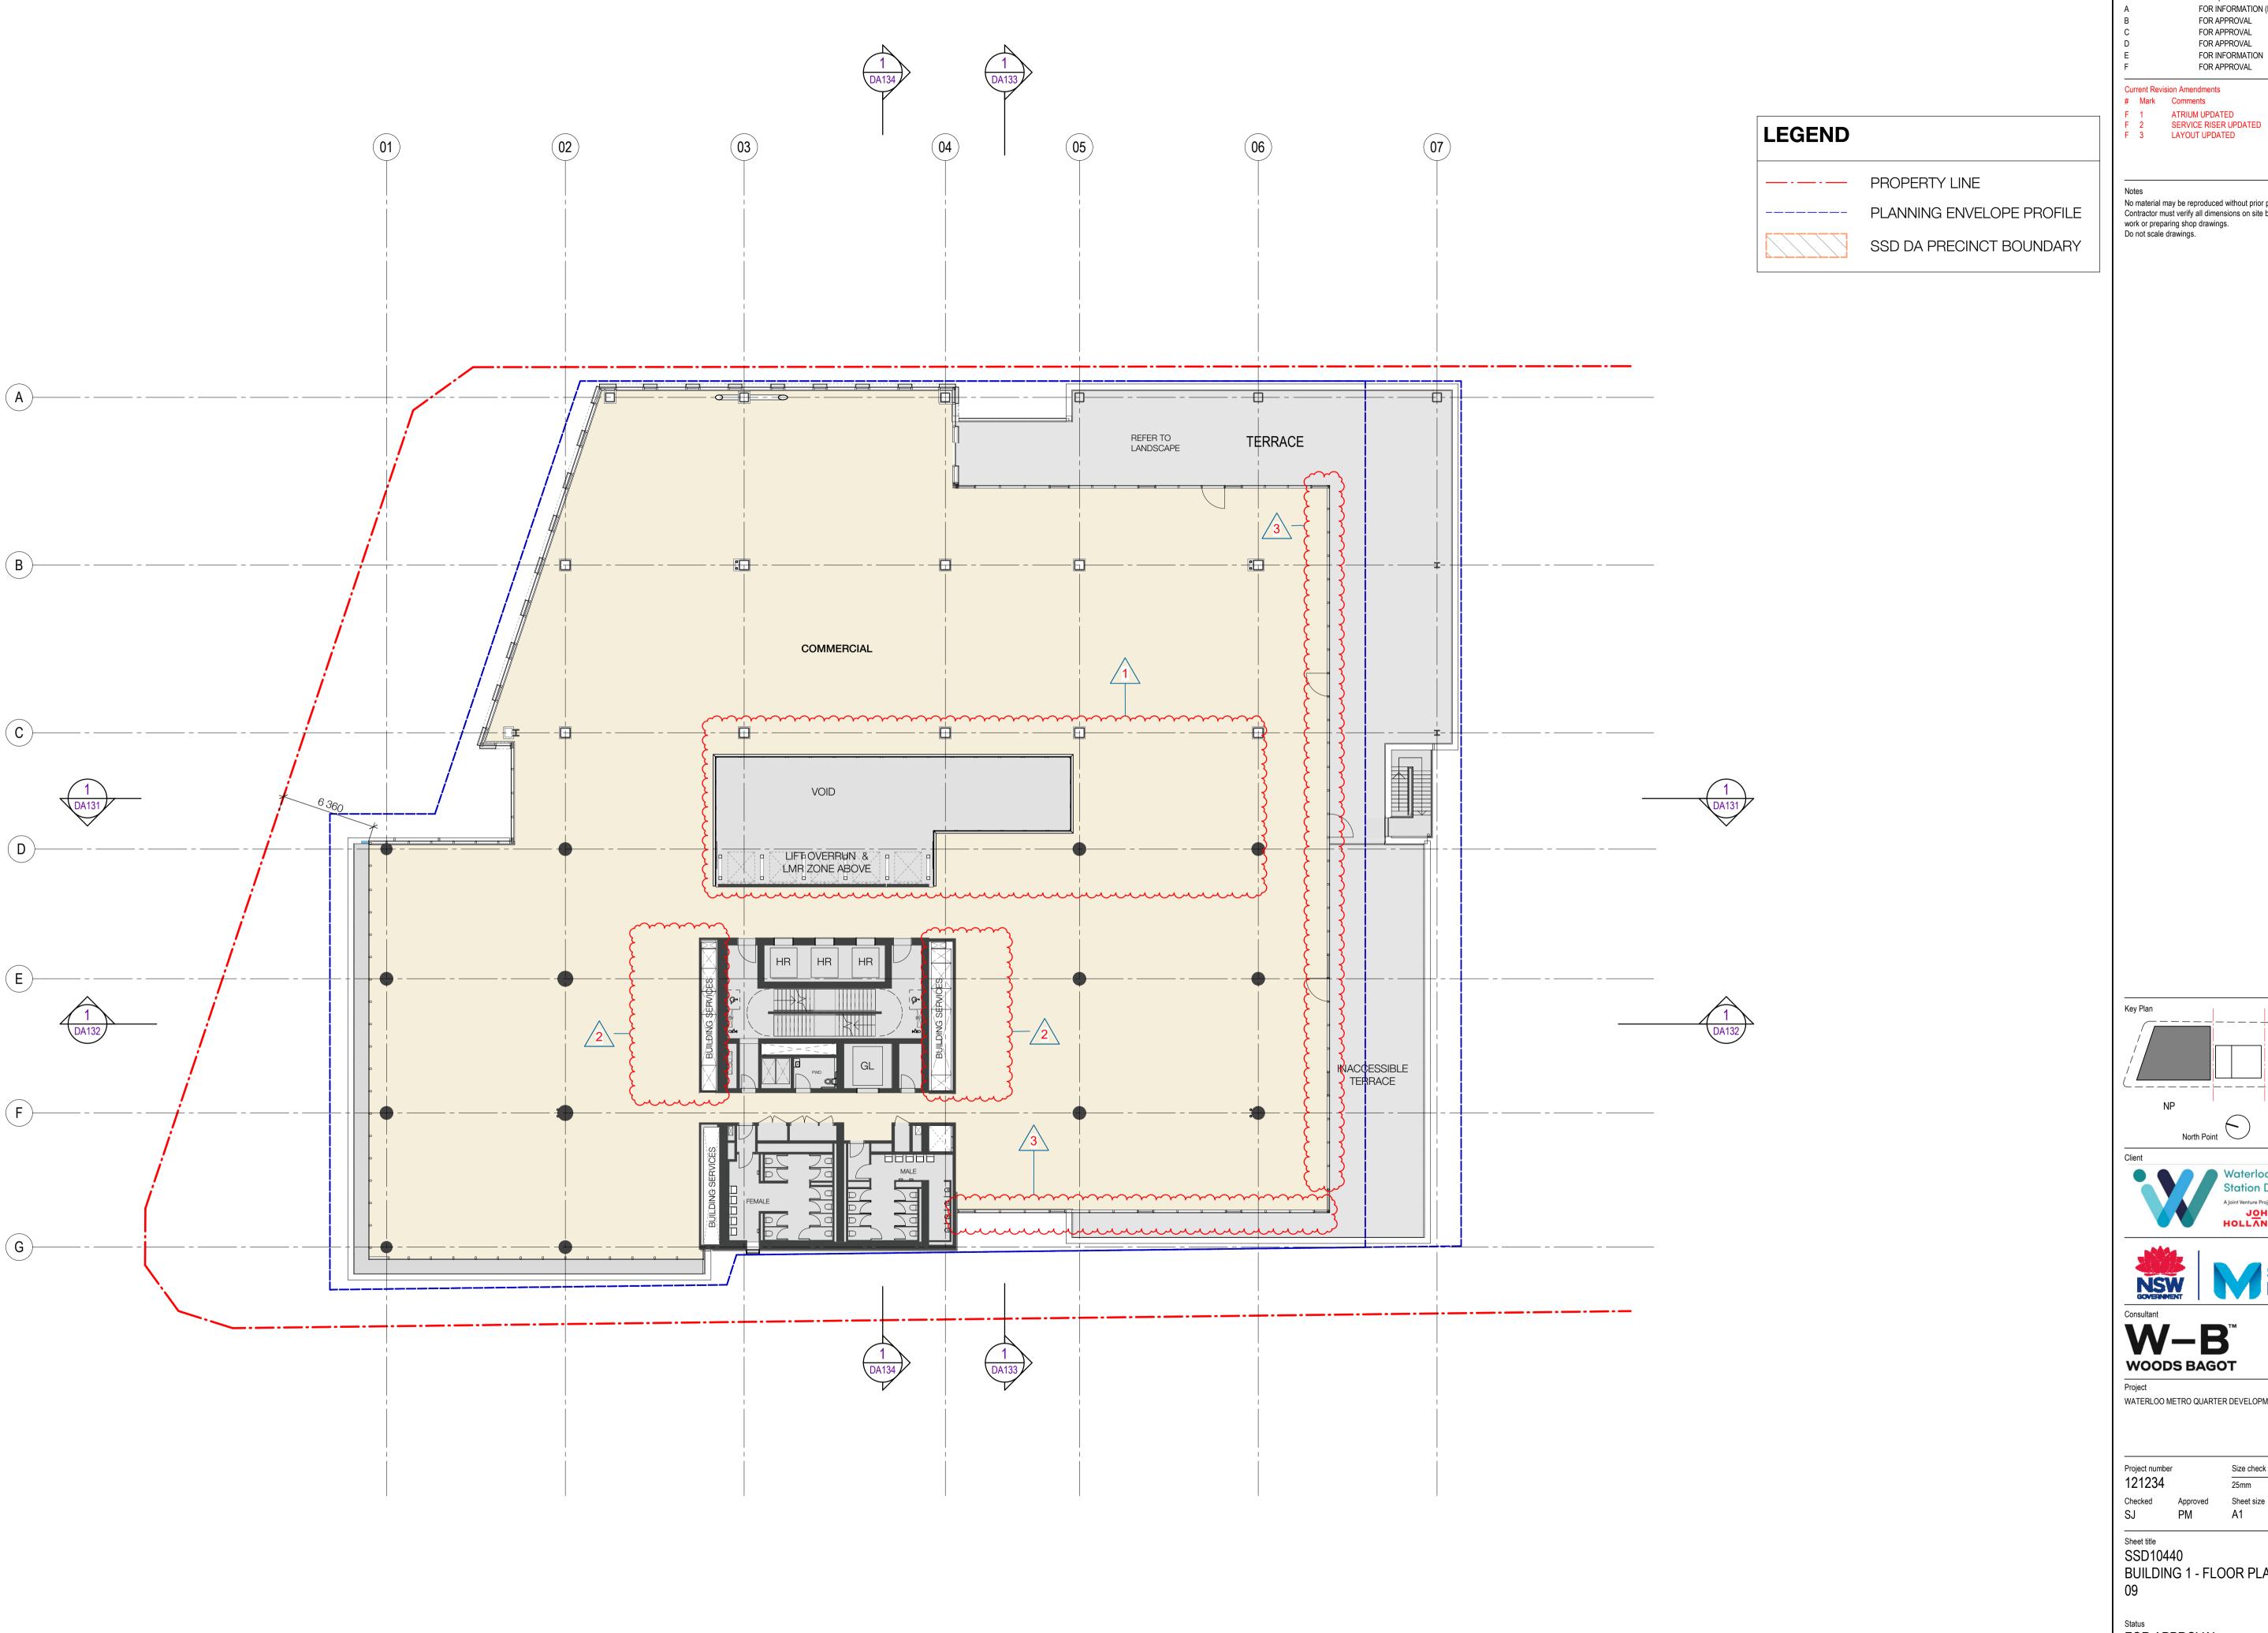


WATERLOO METRO QUARTER DEVELOPMENT

BUILDING 1 - FLOOR PLAN - LEVEL

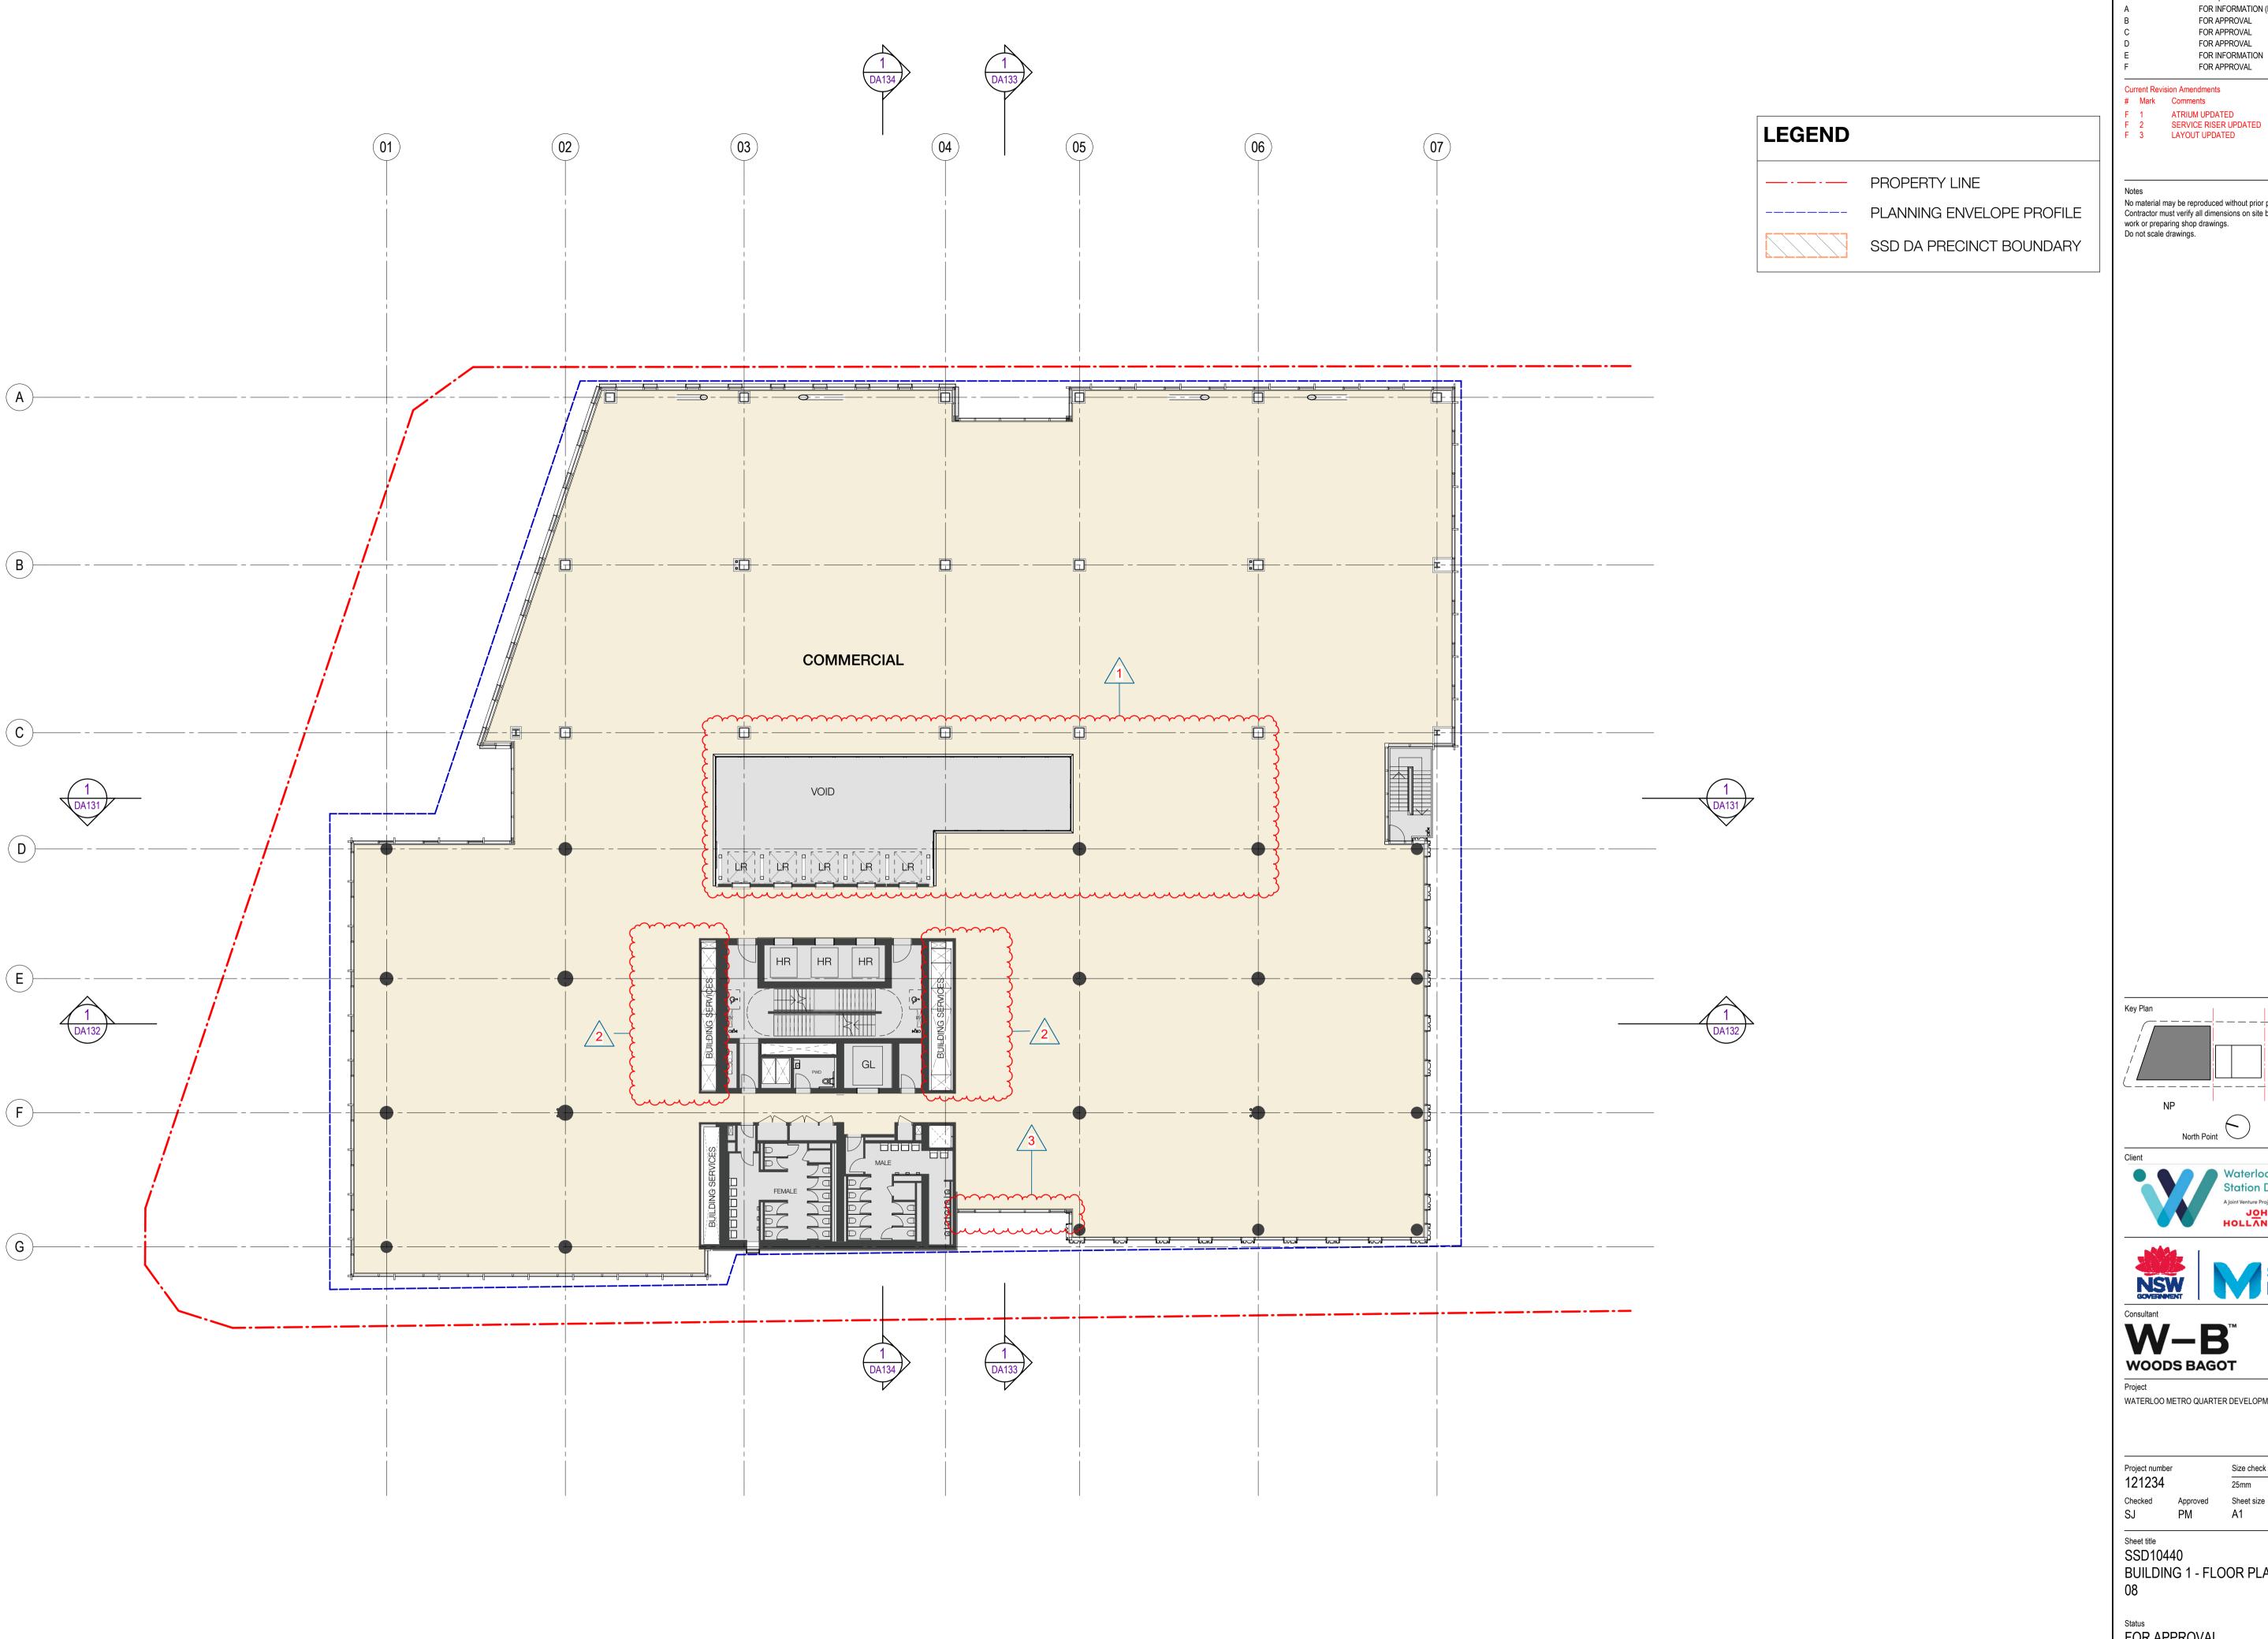FOR APPROVAL

WMQ-BLD1-WBG-AR-DRG-DA108 F



Recent revision history # Status FOR INFORMATION (DA) 15.07.20 FOR APPROVAL 31.07.20 FOR APPROVAL 28.08.20 FOR APPROVAL 25.09.20 FOR INFORMATION 28.01.21 15.03.21 FOR APPROVAL

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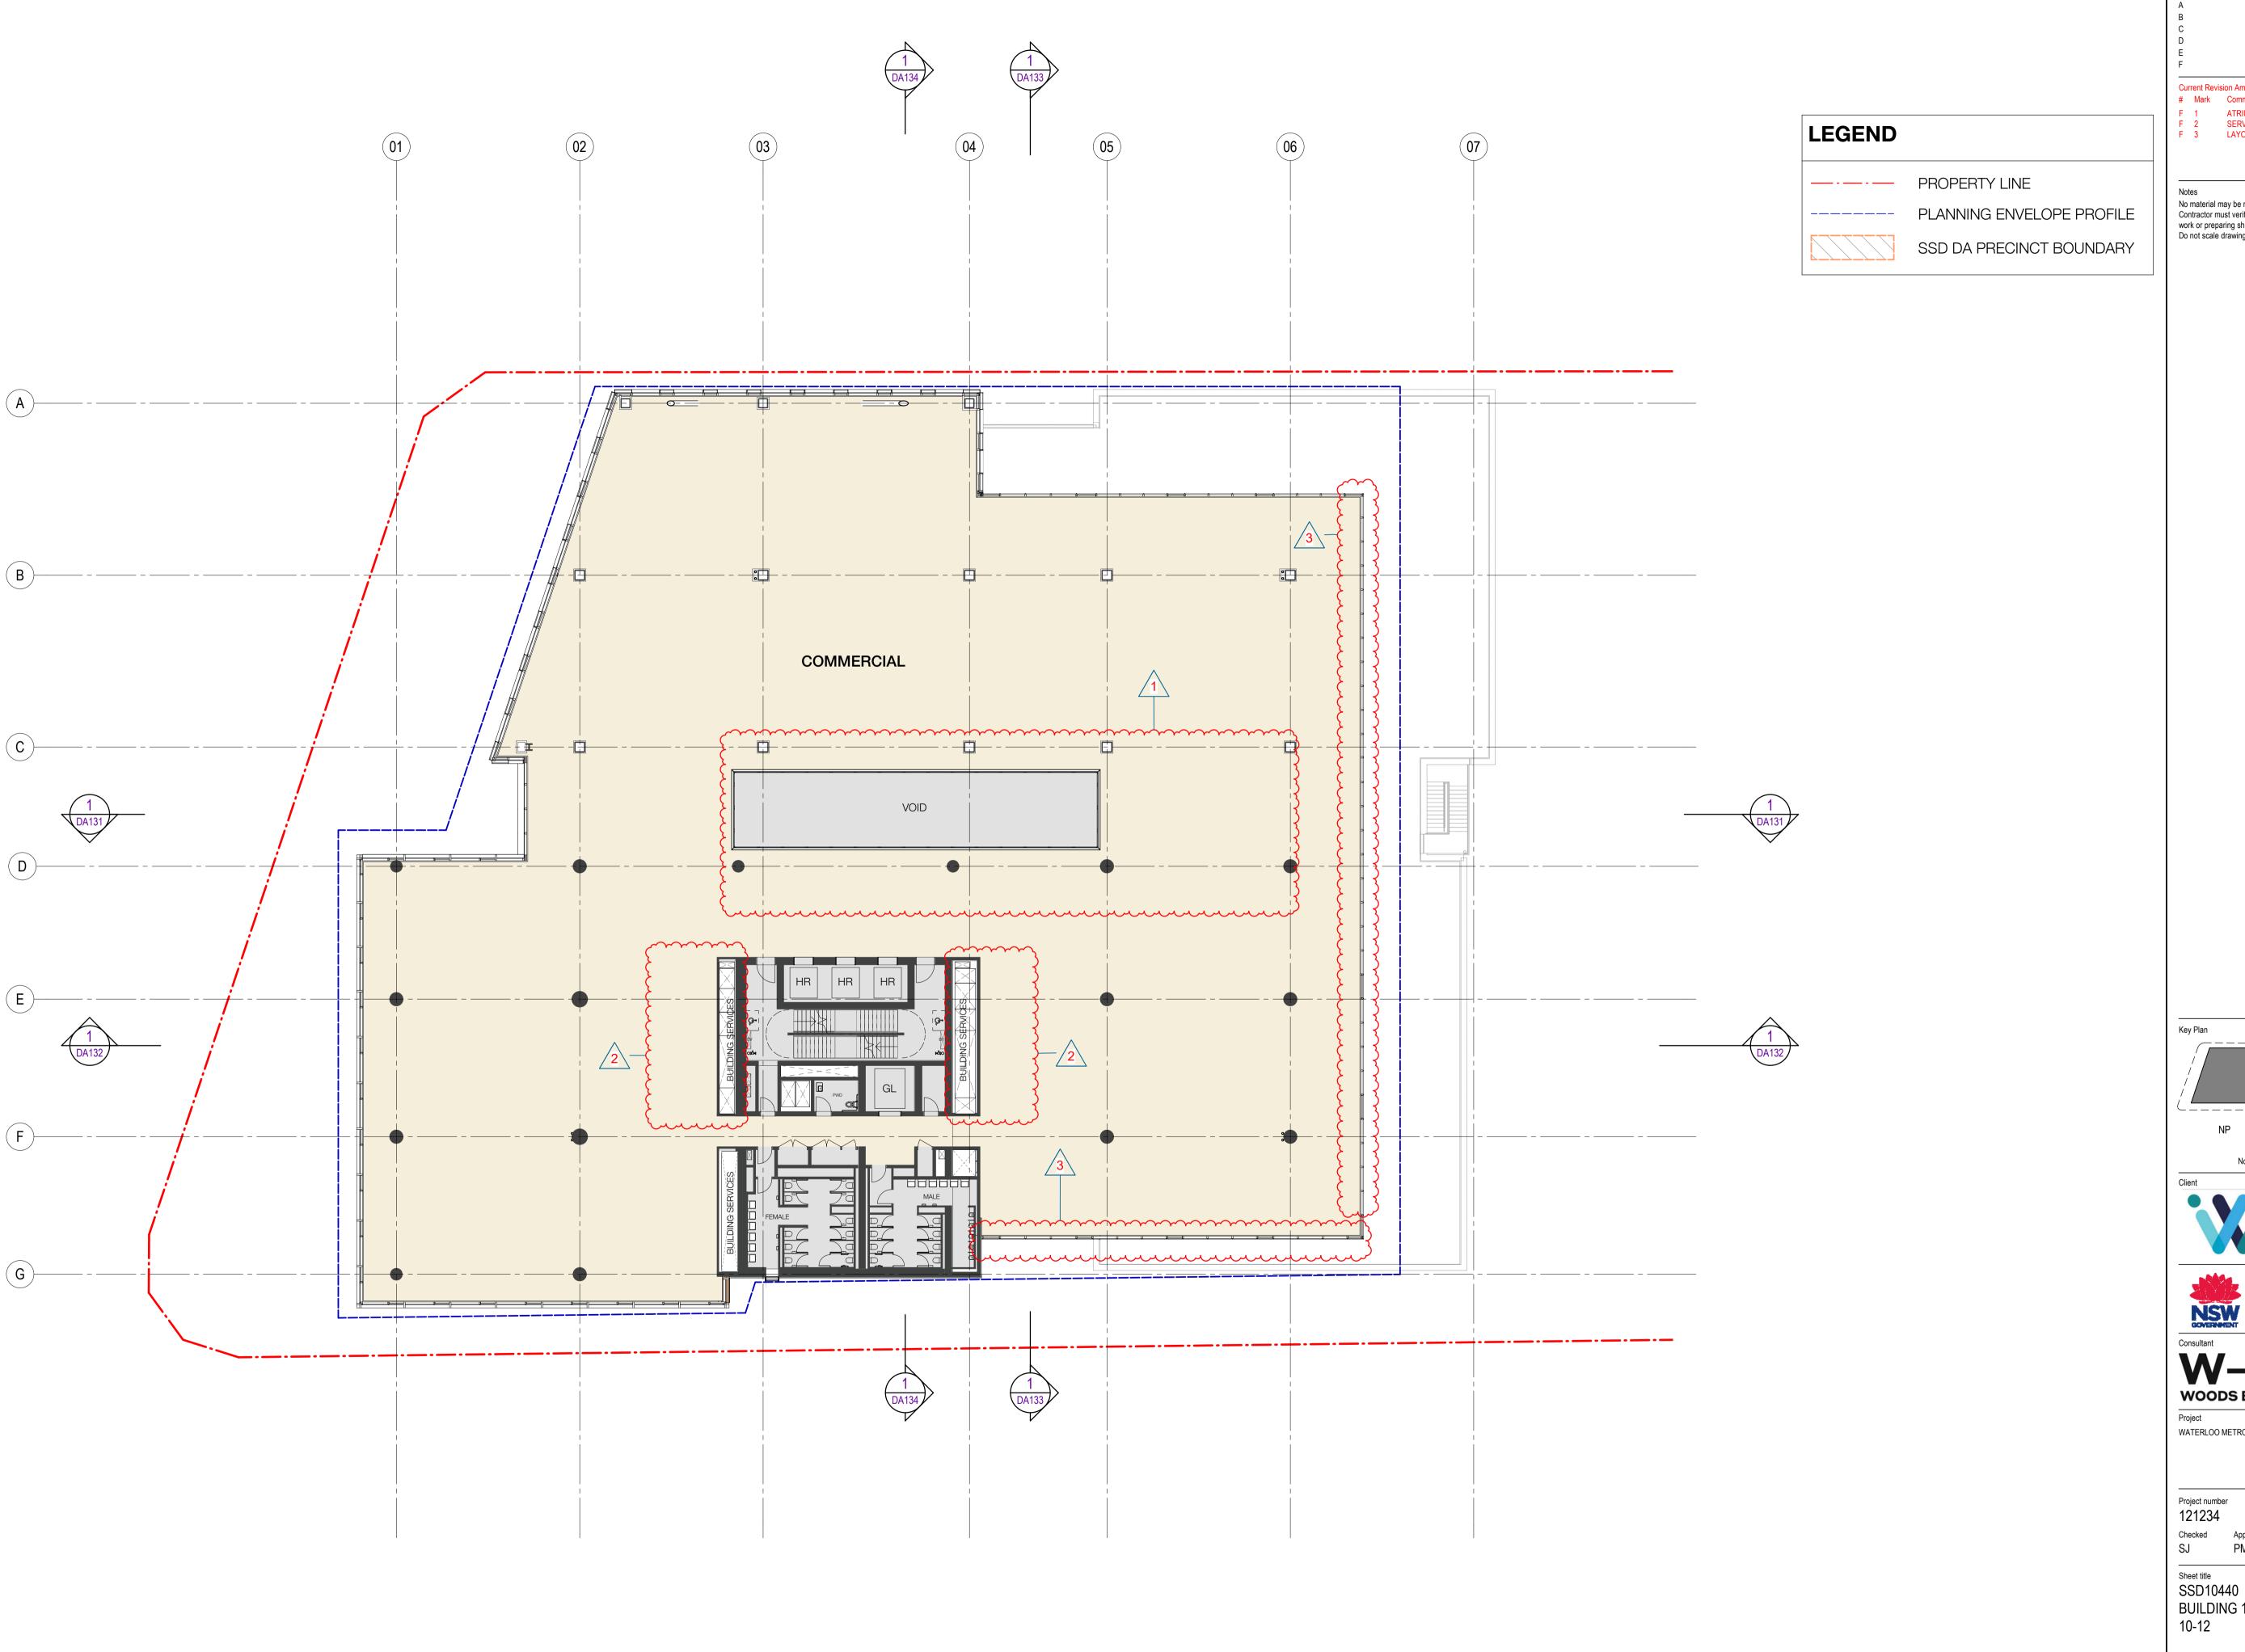


WATERLOO METRO QUARTER DEVELOPMENT

BUILDING 1 - FLOOR PLAN - LEVEL

Status FOR APPROVAL

WMQ-BLD1-WBG-AR-DRG-DA109 F



Recent revision history # Status FOR INFORMATION (DA) 15.07.20 FOR APPROVAL 31.07.20 28.08.20 FOR APPROVAL FOR APPROVAL 25.09.20 FOR INFORMATION 28.01.21 15.03.21 FOR APPROVAL

Current Revision Amendments # Mark Comments

F 1 ATRIUM UPDATED F 2 SERVICE RISER UPDATED F 3 LAYOUT UPDATED

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Do not scale drawings.






WATERLOO METRO QUARTER DEVELOPMENT

BUILDING 1 - FLOOR PLAN - LEVEL

Status FOR APPROVAL

WMQ-BLD1-WBG-AR-DRG-DA110 F

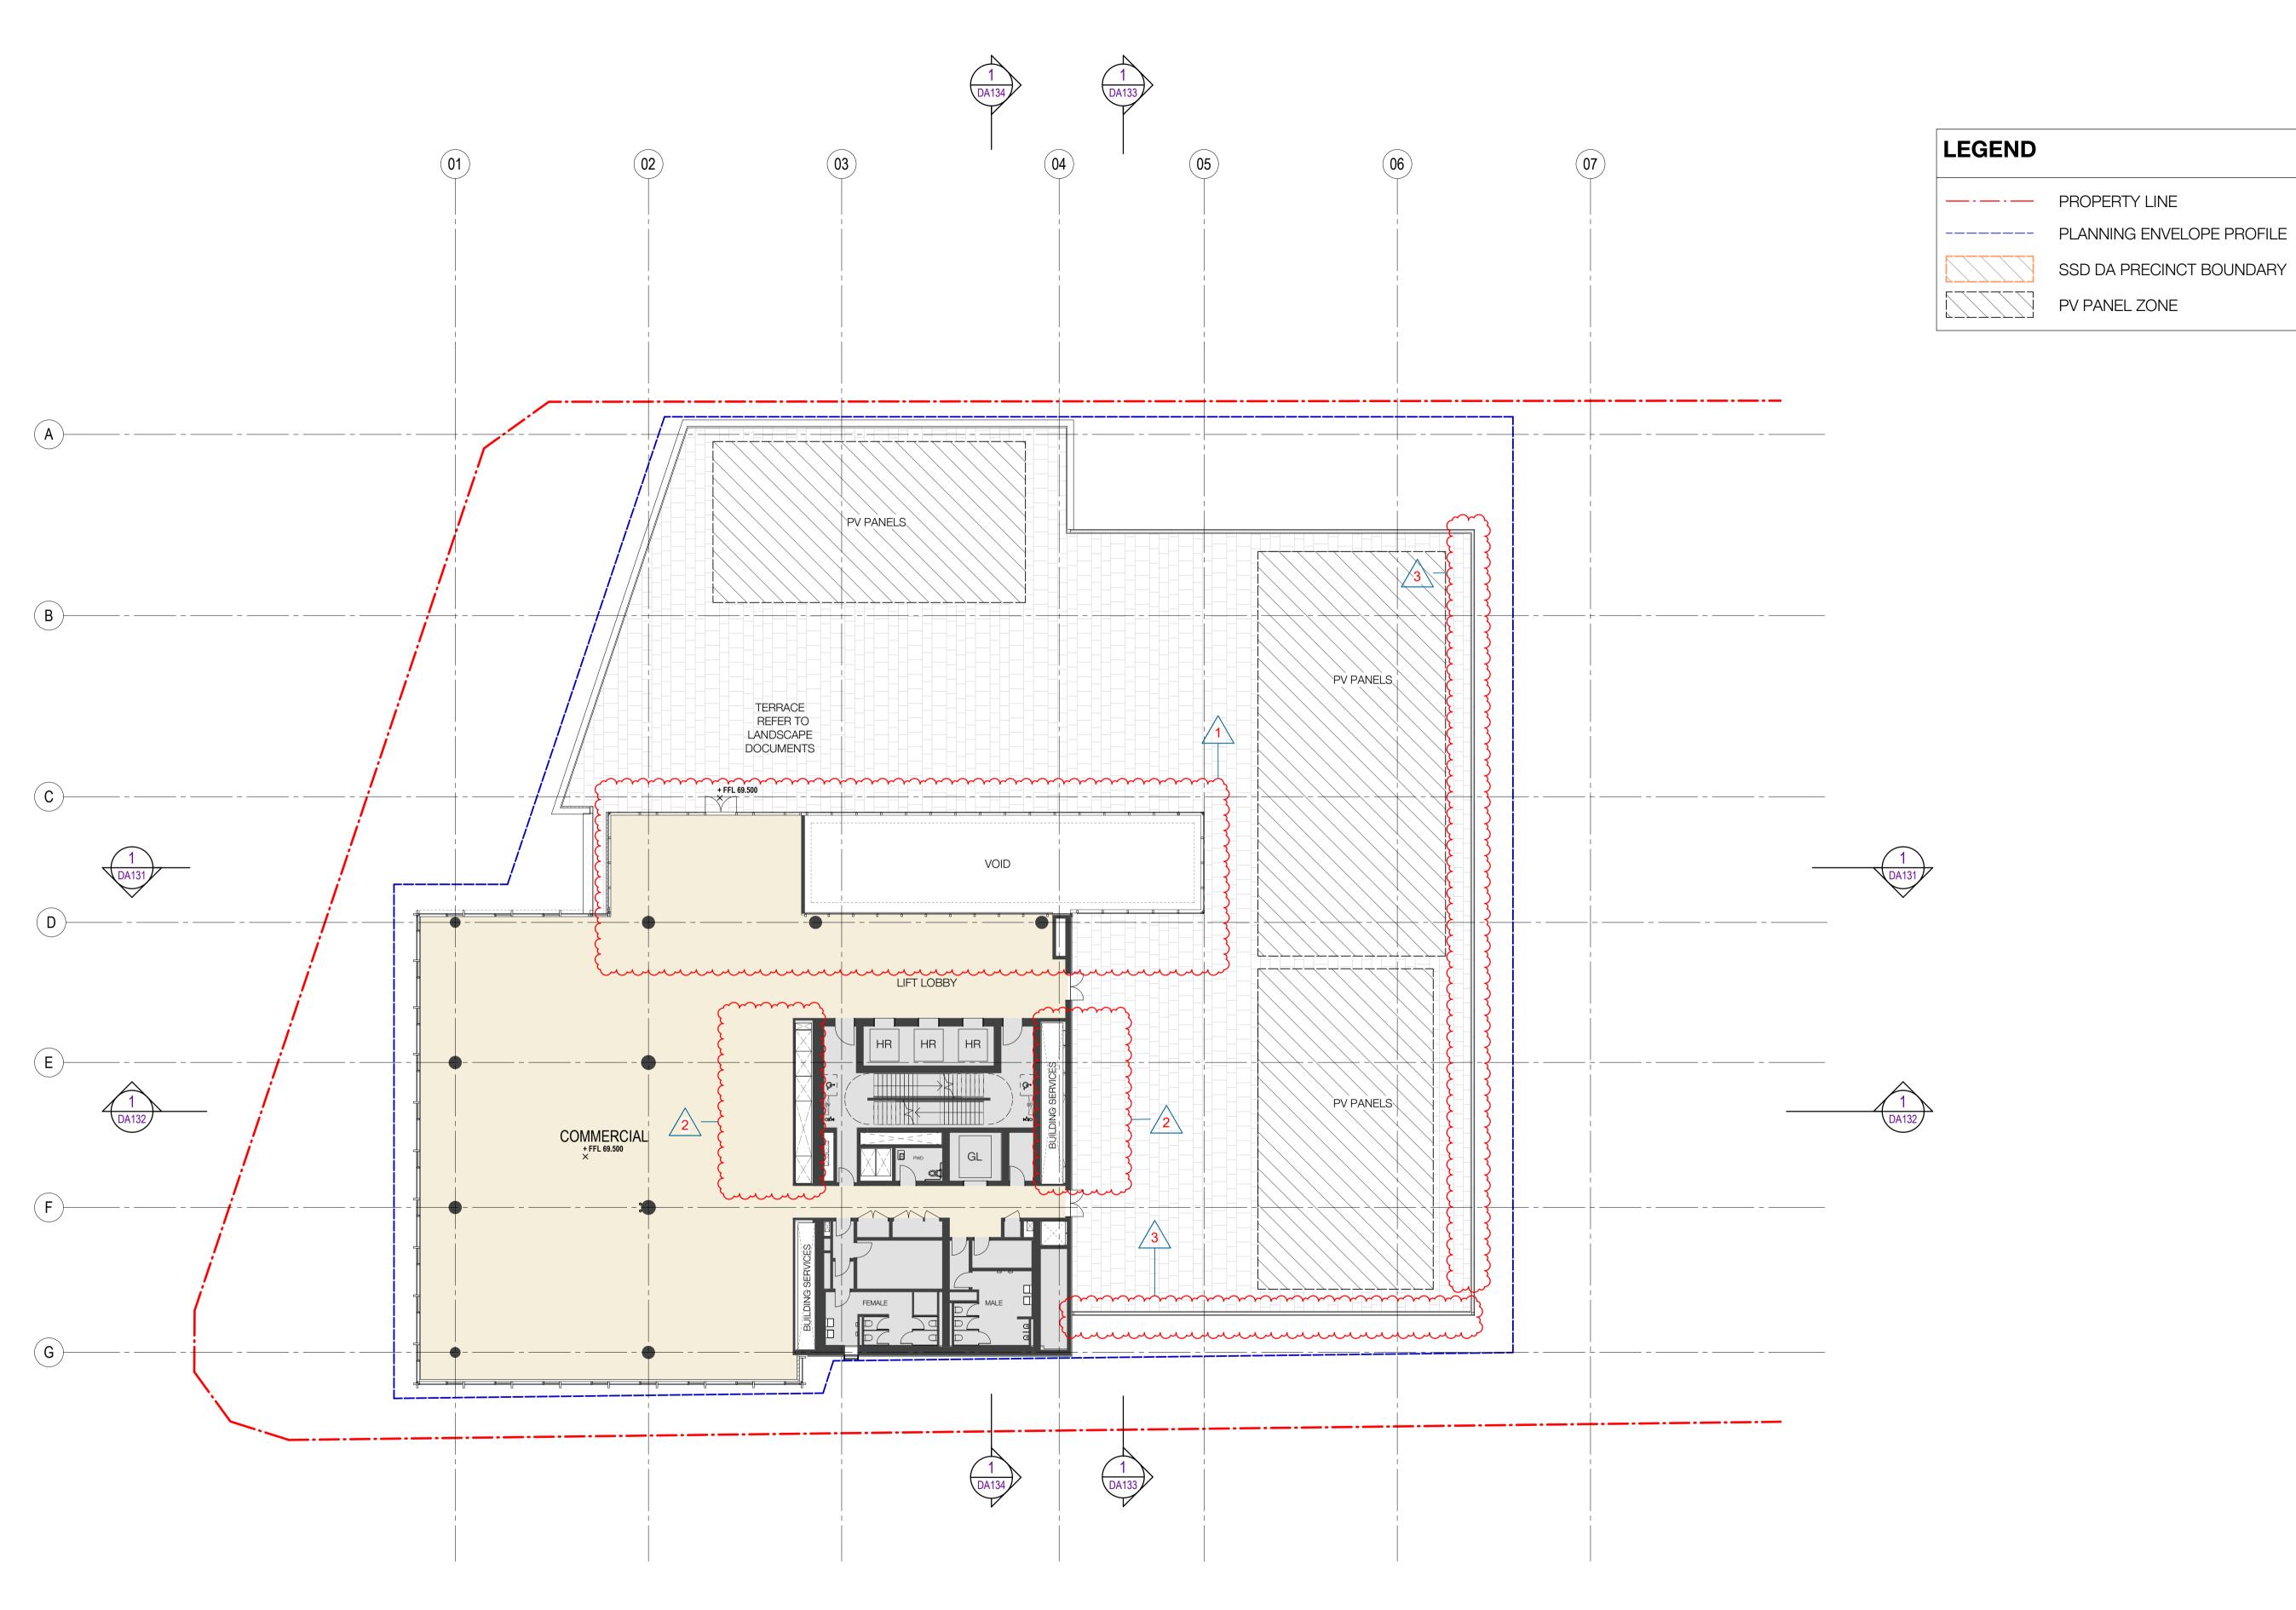

 Recent revision history

 #
 Status
 Description
 Date

 A
 FOR INFORMATION (DA)
 15.07.20

 B
 FOR APPROVAL
 31.07.20

 C
 FOR APPROVAL
 28.08.20

 D
 FOR APPROVAL
 25.09.20

 E
 FOR INFORMATION
 28.01.21


 F
 FOR APPROVAL
 15.03.21

Current Revision Amendments # Mark Comments

F 1 ATRIUM UPDATED
F 2 SERVICE RISER UPDATED
F 3 LAYOUT UPDATED

Notes

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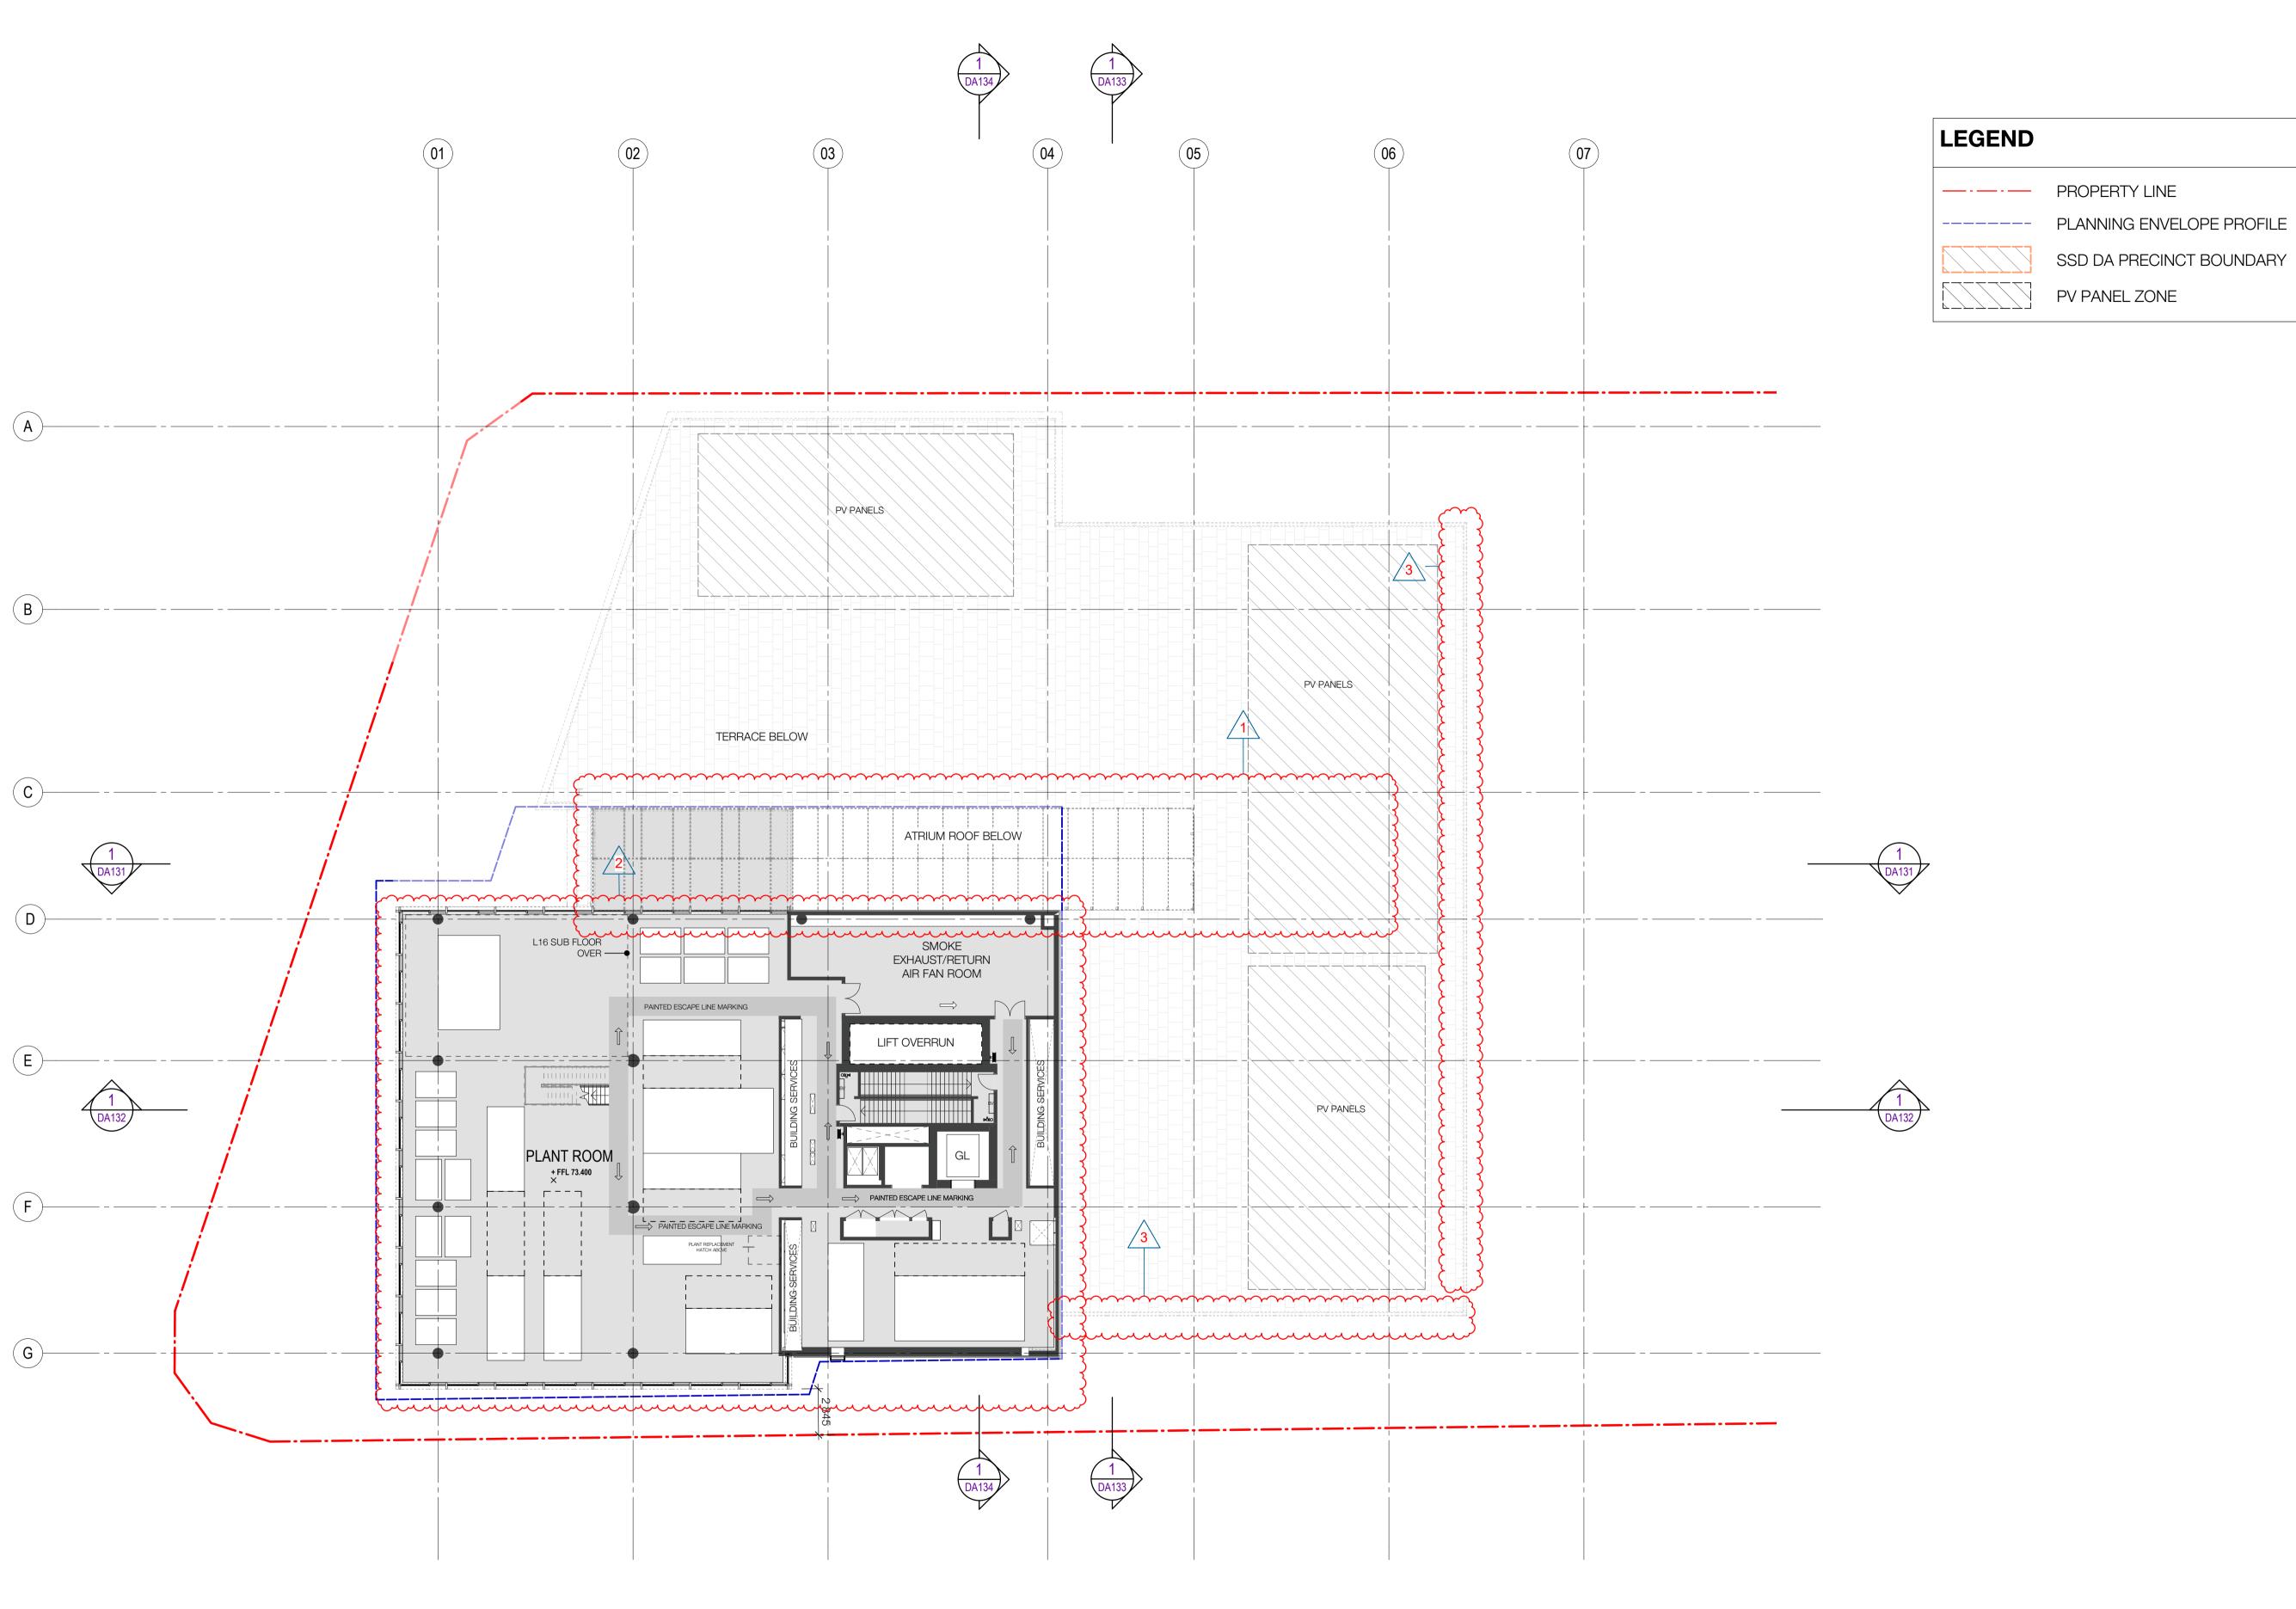
Project
WATERLOO METRO QUARTER DEVELOPMENT

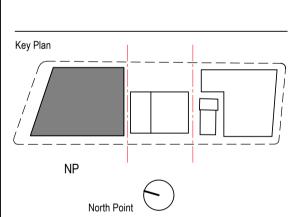Project number 121234		Size check 25mm	
Checked		Sheet size	Caala
SJ	Approved <b>PM</b>	A1	Scale 1:200

BUILDING 1 - FLOOR PLAN - LEVEL 13 - ROOF TERRACE

Status
FOR APPROVAL

WMQ-BLD1-WBG-AR-DRG-DA113 F




Current Revision Amendments # Mark Comments

F 1 ATRIUM UPDATED
F 2 LEVEL 15 BECOME LEVEL 14
F 3 LAYOUT UPDATED

Notes

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Do not scale drawings.



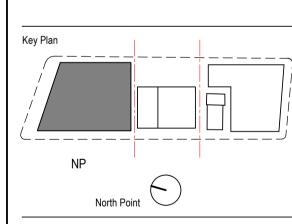






Project
WATERLOO METRO QUARTER DEVELOPMENT

FOR APPROVAL
Sheet number Revision
WMQ-BLD1-WBG-AR-DRG-DA114 F

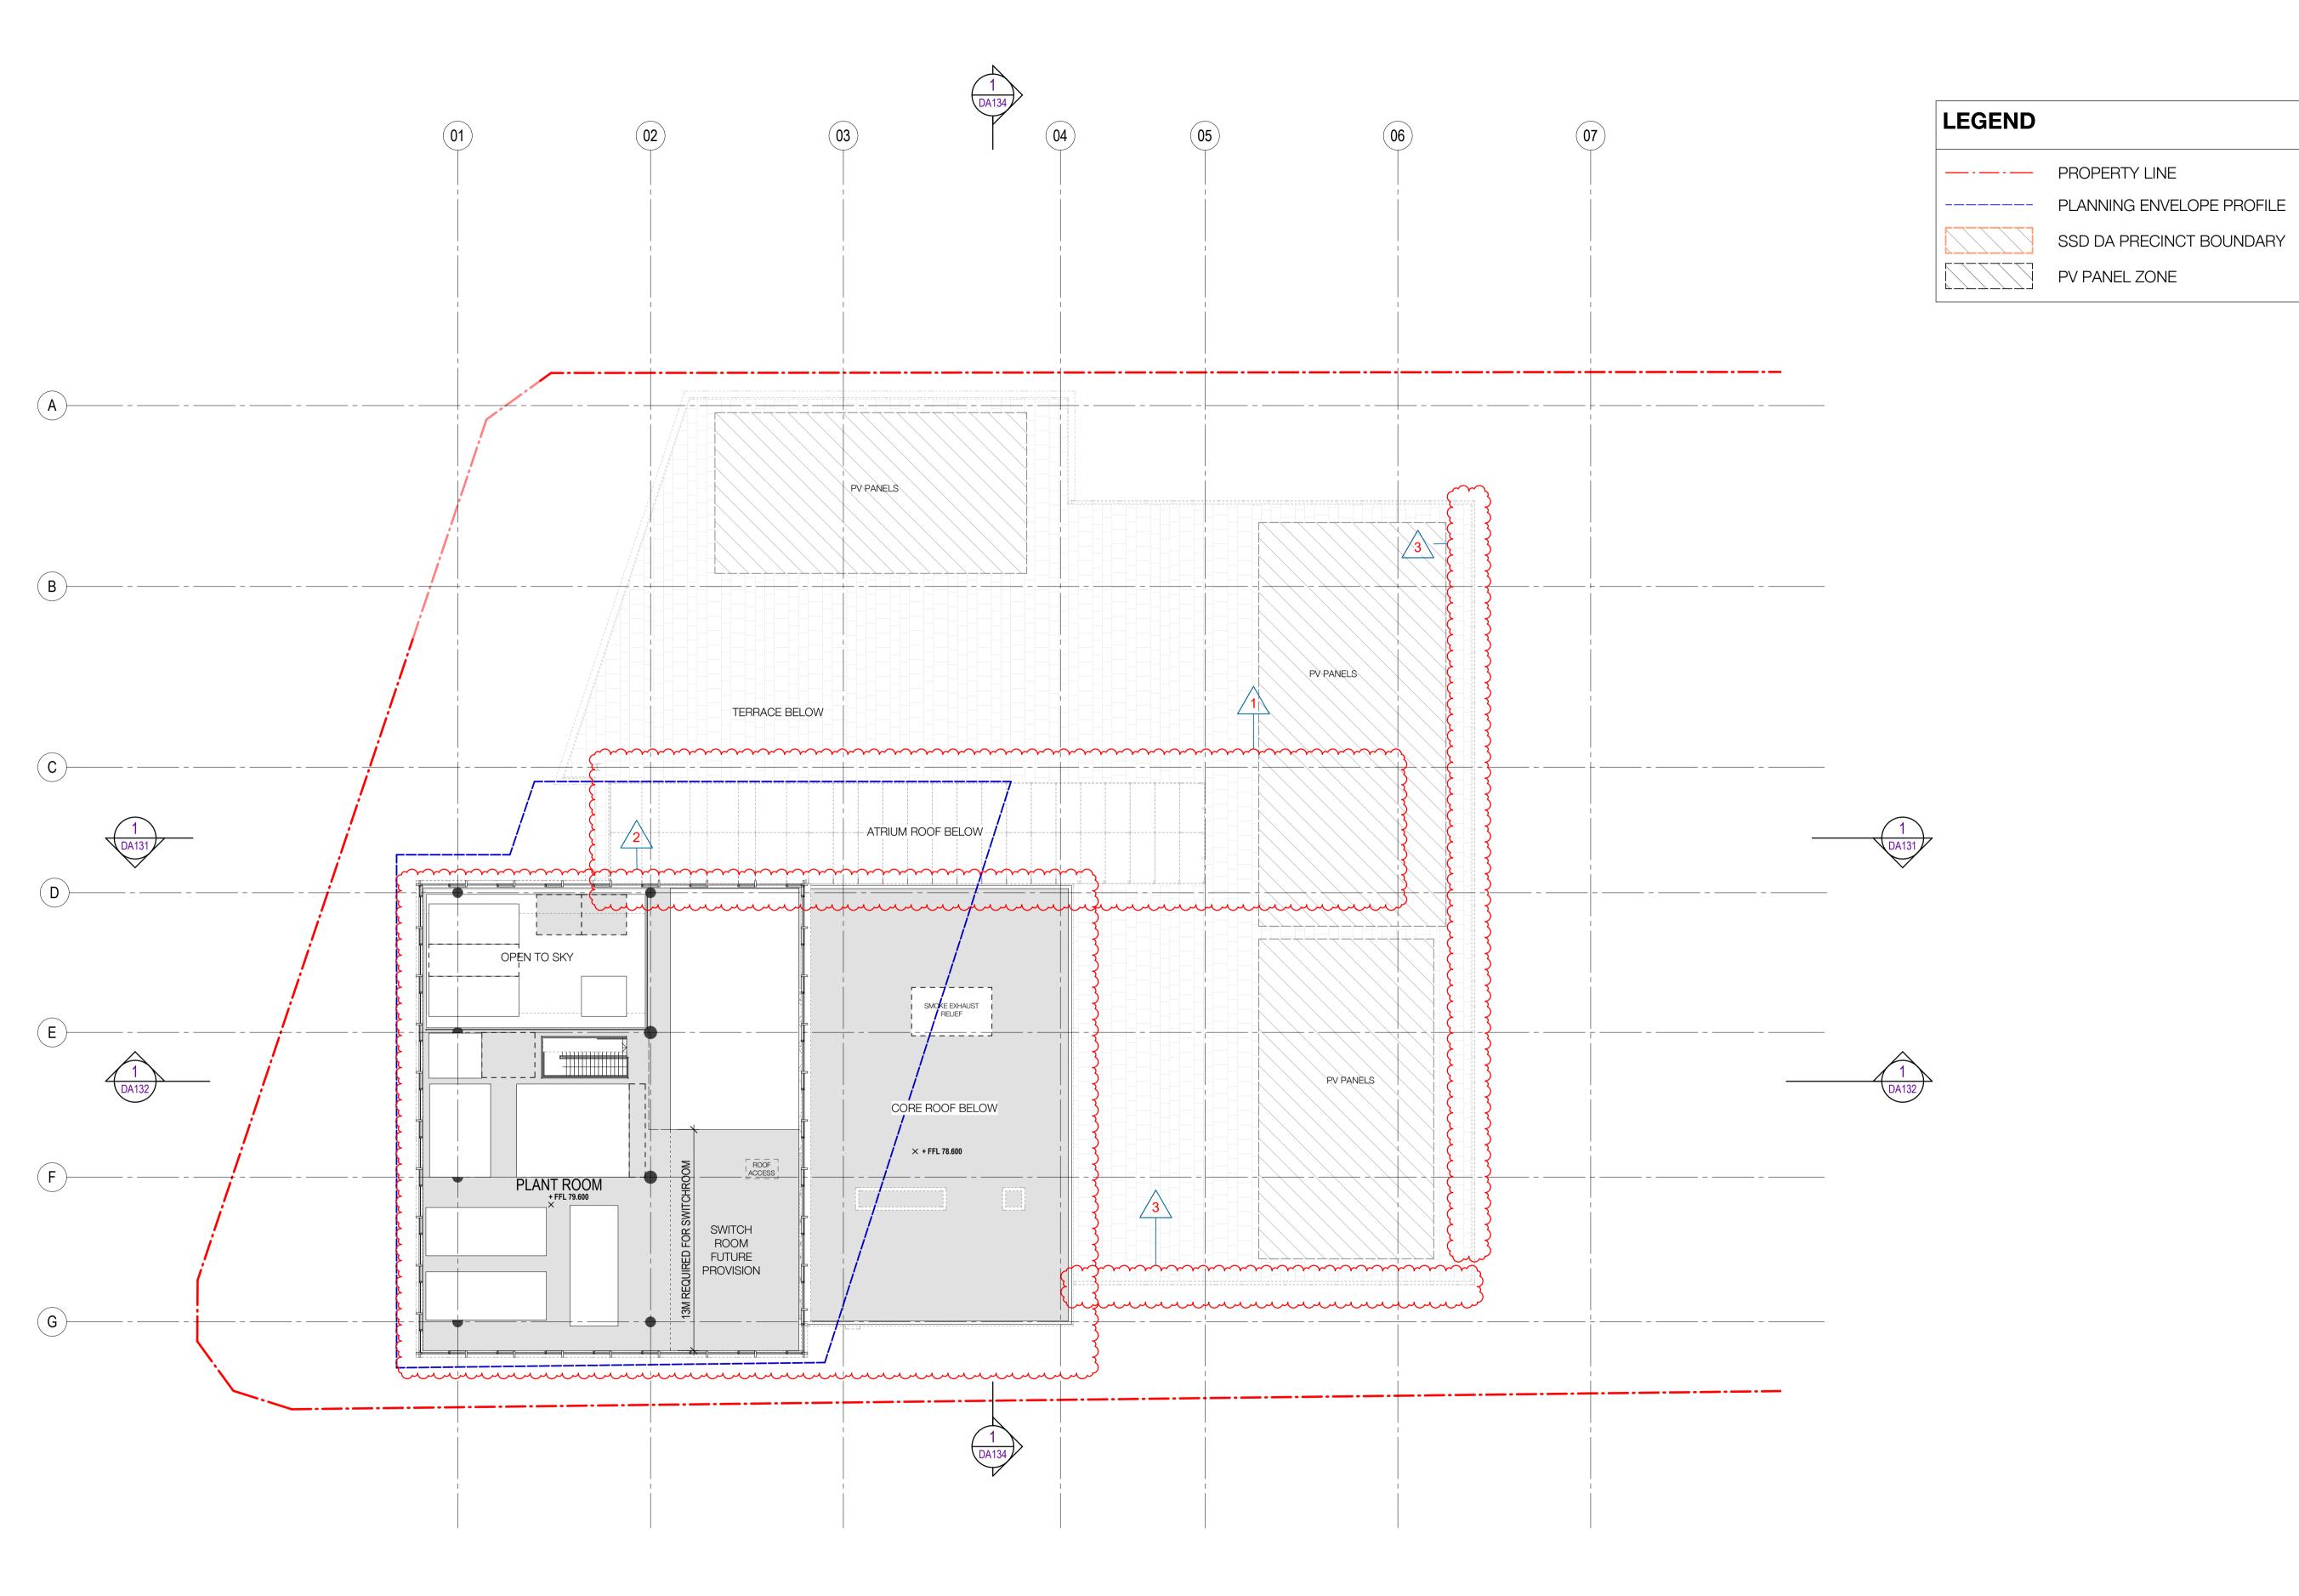

 Recent revision history

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 Status
 Description
 Date

 A
 FOR INFORMATION (DA)
 15.07.20

 B
 FOR APPROVAL
 31.07.20

 C
 FOR APPROVAL
 28.08.20

 D
 FOR APPROVAL
 25.09.20

 E
 FOR INFORMATION
 28.01.21


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 FOR APPROVAL
 15.03.21

Current Revision Amendments
# Mark Comments

F 1 ATRIUM UPDATED
F 2 LEVEL 16 BECOME LEVEL 15
F 3 LAYOUT UPDATED

Notes

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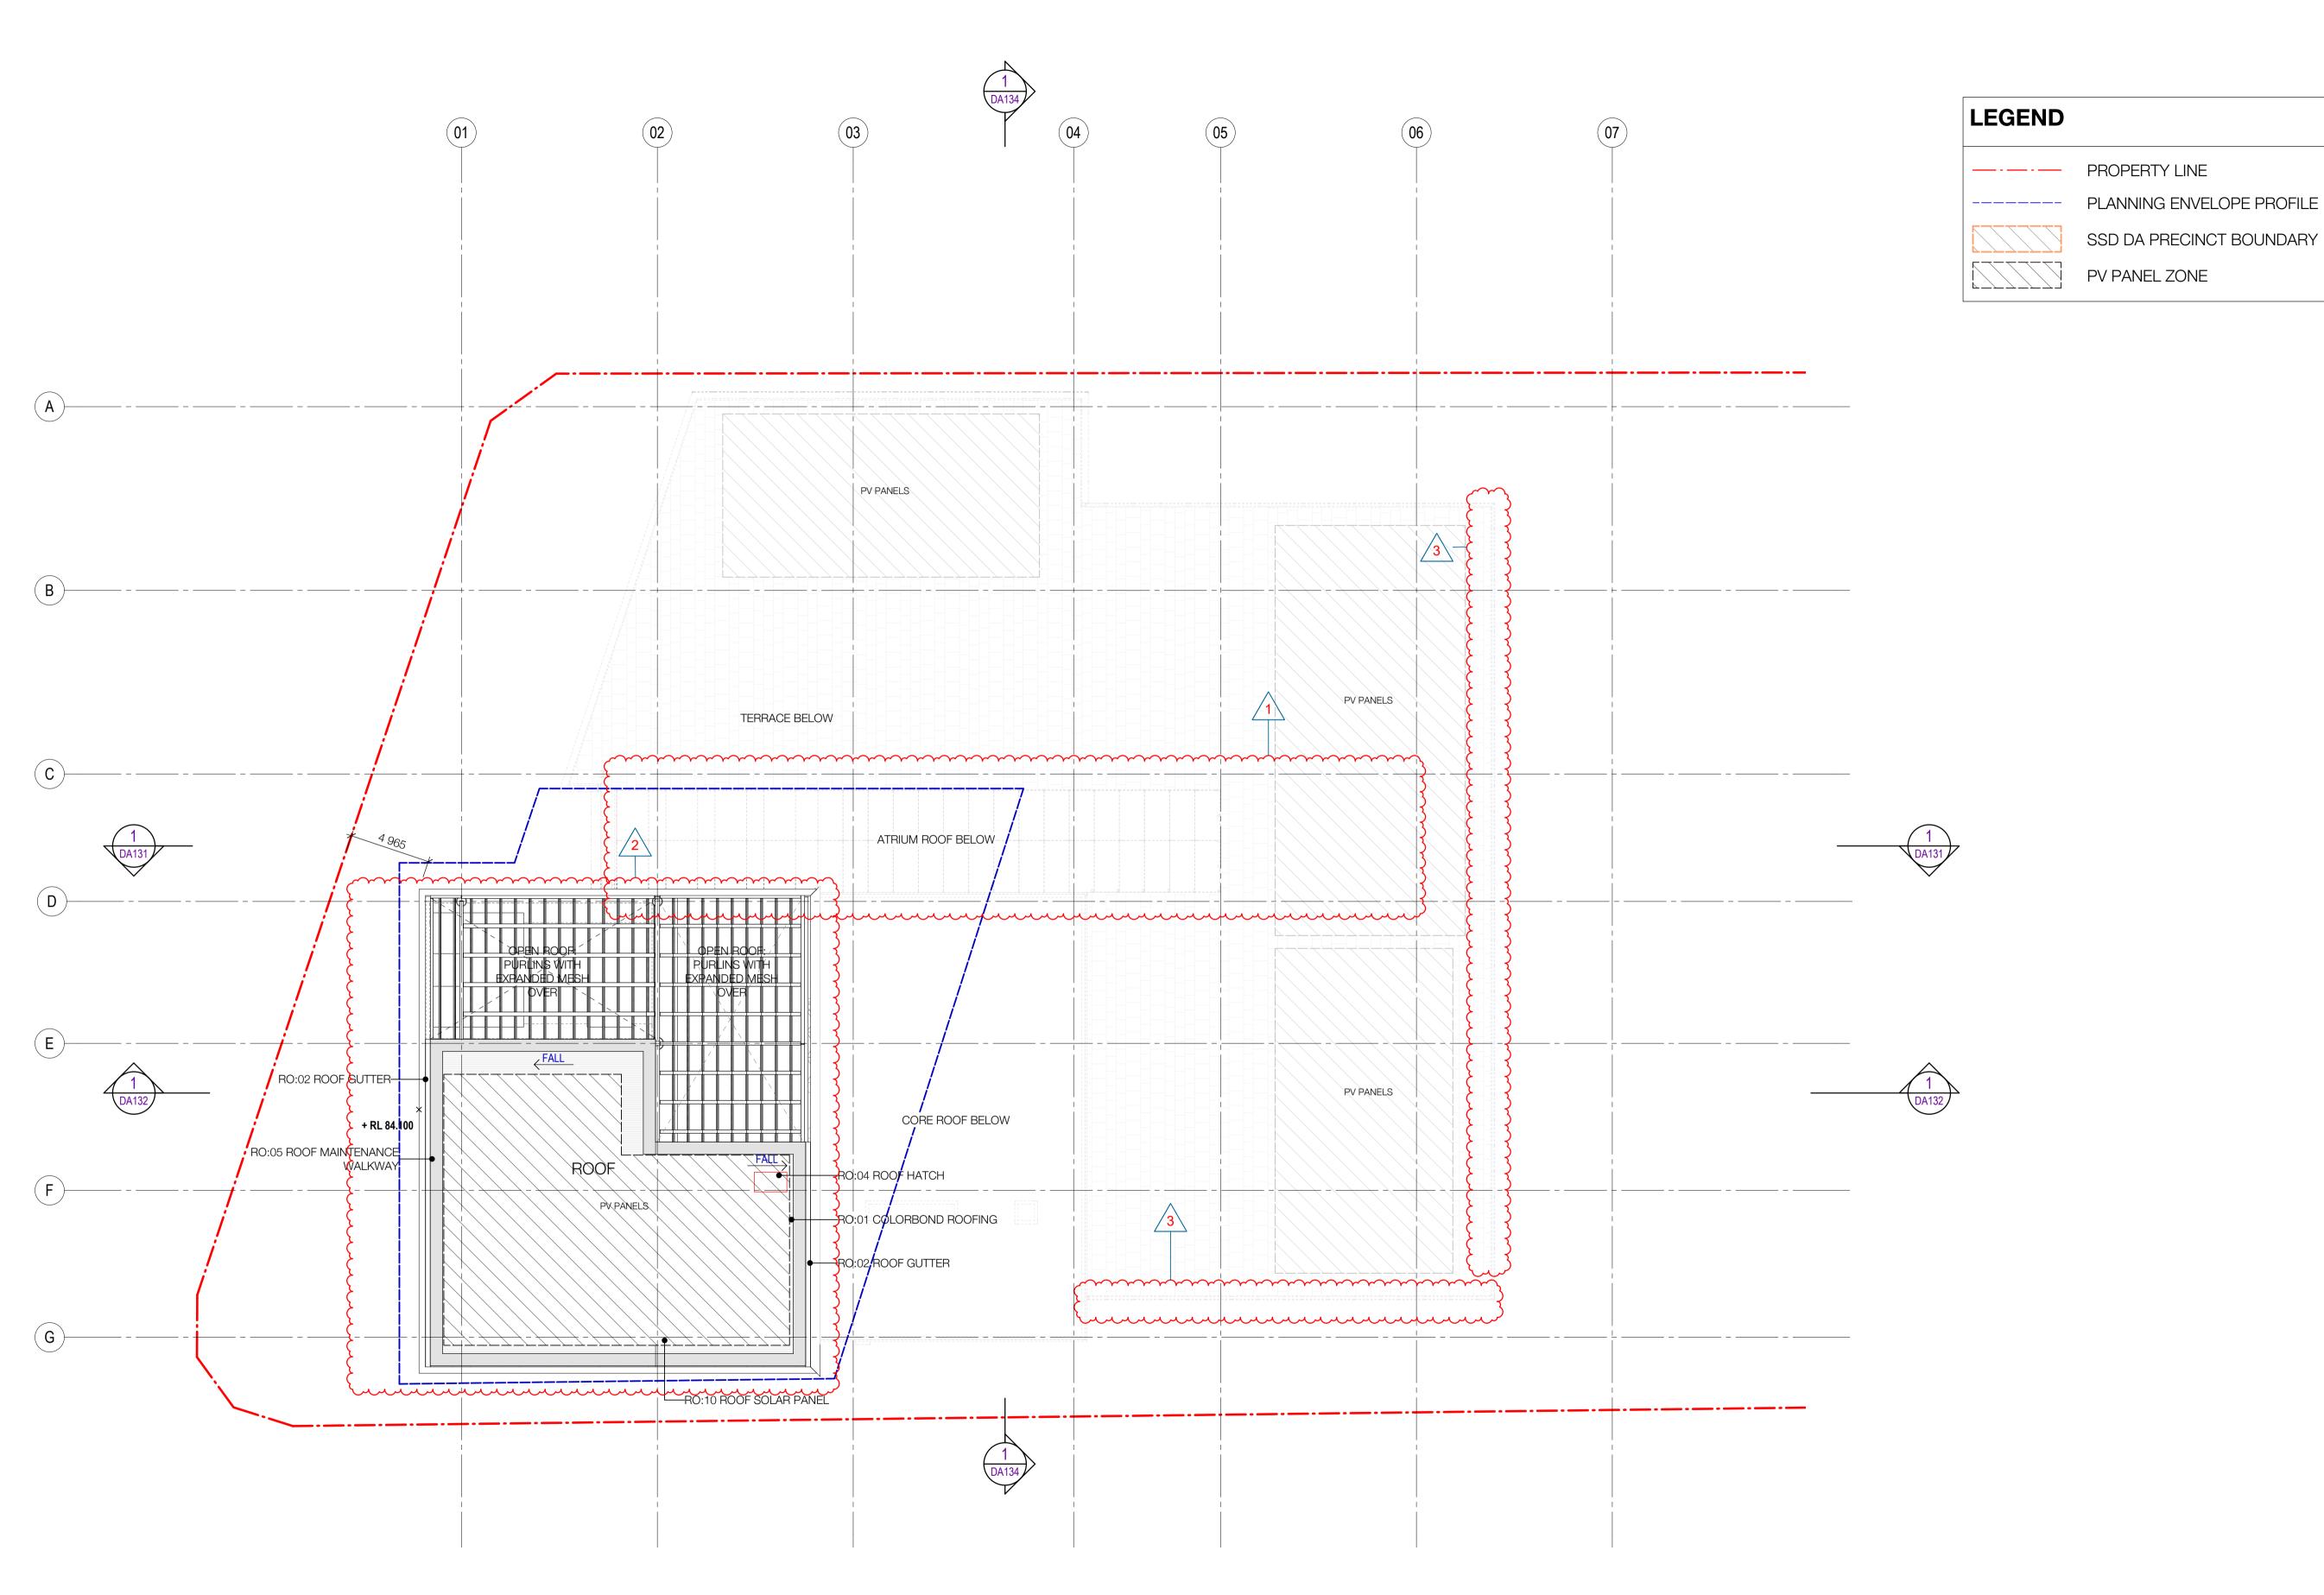


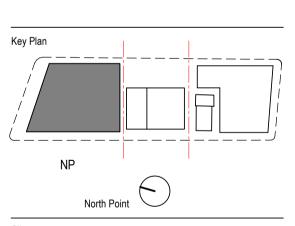Project
WATERLOO METRO QUARTER DEVELOPMENT

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Checked	Approved PM	Sheet size	Scale
SJ		A1	1 : 200

BUILDING 1 - FLOOR PLAN - LEVEL

FOR APPROVAL
Sheet number Revision
WMQ-BLD1-WBG-AR-DRG-DA115 F




Current Revision Amendments # Mark Comments

F 1 ATRIUM UPDATED F 2 LEVEL 17 BECOME LEVEL 16 F 3 LAYOUT UPDATED

Notes

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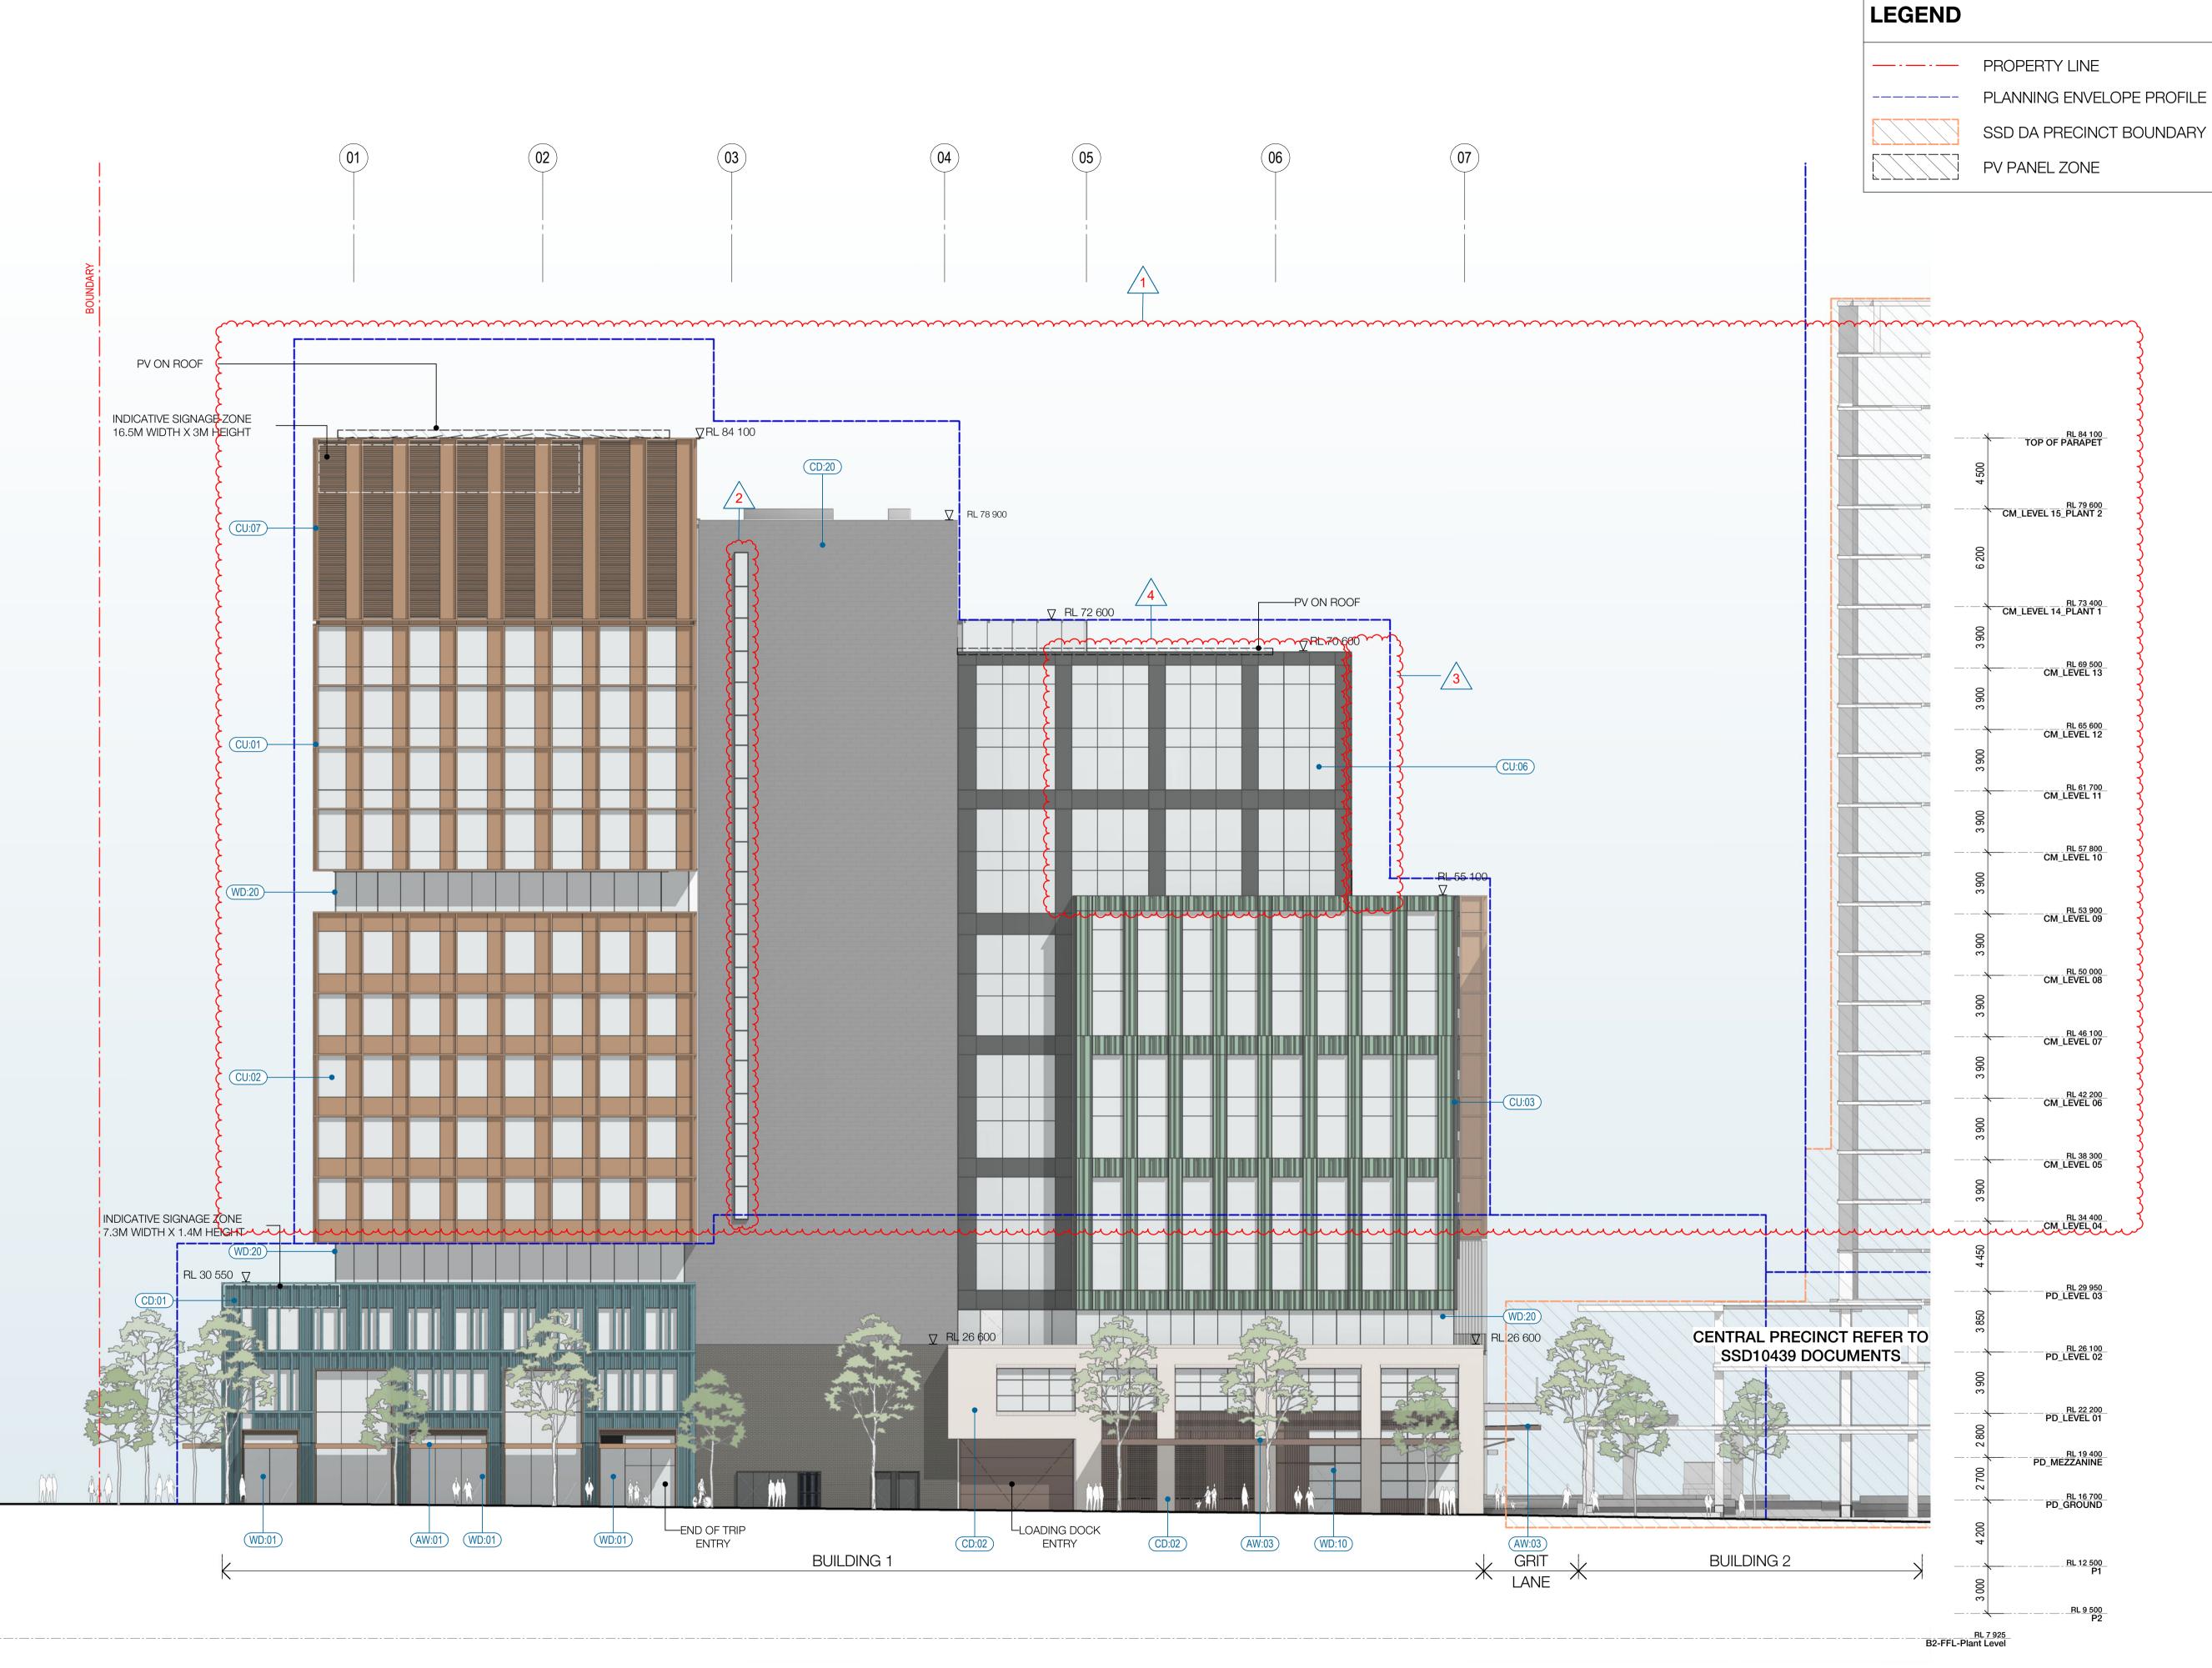
Project
WATERLOO METRO QUARTER DEVELOPMENT


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ROOF PLAN
Status

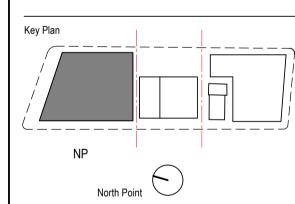
FOR APPROVAL
Sheet number Revision
WMQ-BLD1-WBG-AR-DRG-DA116 F

BUILDING 1 - FLOOR PLAN - LEVEL



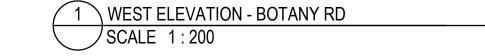

Recent revision history # Status FOR INFORMATION (DA) 15.07.20 FOR APPROVAL 31.07.20 28.08.20 FOR APPROVAL FOR APPROVAL 25.09.20 FOR INFORMATION 28.01.21 15.03.21 FOR APPROVAL Current Revision Amendments Mark Comments HEIGHT REDUCED WINDOWS ADDED STAIR REMOVED FACADE UPDATED No material may be reproduced without prior permission. Contractor must verify all dimensions on site before commencing work or preparing shop drawings. Do not scale drawings. **FACADE - TOWER** CU:01 CURTAIN WALL WITH EXPRESSED VERTICAL & HORIZONTAL FINS WITH GLASS SPANDREL CU:02 CURTAIN WALL WITH EXPRESSED VERTICAL & HORIZONTAL FINS WITH METAL SPANDREL CU:03 CURTAIN WALL WITH FOLDED ALUMINIUM CLADDING CU:04 CURTAIN WALL WITH EXPRESSED VERTICAL & HORIZONTAL FINS WITH GLASS & METAL SPANDREL CU:05 PREFINISHED FIBRE CEMENT PANEL CU:06 CURTAIN WALL WITH EXPRESSED VERTICAL & HORIZONTAL FINS WITH GLASS & METAL SPANDREL CU:07 CURTAIN WALL WITH ARCHITECTURAL LOUVRE AND PROFILED METAL (WD:20) STRUCTURAL GLAZED FRAMED WINDOWS WD:21 ATRIUM SKYLIGHT WITH PERFORMANCE SHADING GLAZED FACADE - PODIUM NORTH CD:01 CERAMIC CLADDING - INTERNAL WALL:
BLOCKWALL GRD LVL & METAL FRAME L1 & ABOVE WD:01) SHOPFRONT WINDOW WITH METAL REVEAL WD:02 REVOLVING DOOR WITH LIGHT FRAME (WD:03) PODIUM LANEWAY OPERABLE SHOPFRONT GLAZING WD:20 STRUCTURAL GLAZED FRAMED WINDOWS WD:22 PRE-FINISHED FIBRE CEMENT PANELS LINING THE SHAFTS **FACADE - PODIUM SOUTH** CD:02 FACE BRICK - INTERNAL WALL: BLOCKWALL GRD LVL & METAL FRAME L1 & ABOVE WD:10 SHOP FRONT GLAZING WITH EXPRESSED POWDERCOATED STEEL FRAMED WD:11 OPERABLE SHOP FRONT GLAZING WITH EXPRESSED POWDERCOATED STEEL FRAMED CD:03 SOLID FOLDED METAL PANEL CD:20 COMPRESSED FIBRE CEMENT PANEL CU:08 CURTAIN WALL WINDOW WITH GLASS SPANDREL AND SMOKE RELIEF LOUVRES WHERE SHOWN (WD:30) CORE SLOT WINDOW **AWNINGS & CANOPIES** (AW:01) NORTH RETAIL AWNING (AW:02) NORTH FOYER ENTRY CANOPY (AW:03) SOUTH RETAIL AWNING CP:01 ROOF TERRACE GLAZED CANOPY WITH PAINTED STEEL FRAME **EXTERNAL SOFFIT** CL:01 LANEWAY CEILING METALWORK MW:01 FABRICATED ALUMINIUM PLANTER POWDERCOAT FINISH

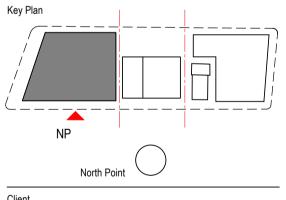



Station Development
A Joint Venture Project

JOHN
HOLLAND
MICVaC





Project
WATERLOO METRO QUARTER DEVELOPMENT

Project number Size check

121234

Checked Approved Sheet size Scale


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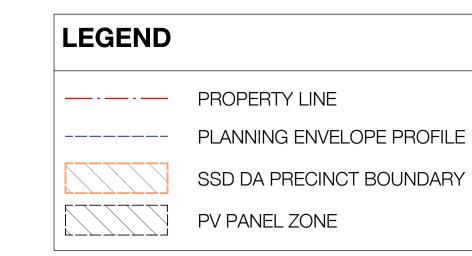
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SSD10440
BUILDING 1 - WEST ELEVATION -

BOTANY ROAD

Status FOR APPROVAL

Sheet number Revision WMQ-BLD1-WBG-AR-DRG-DA121 F



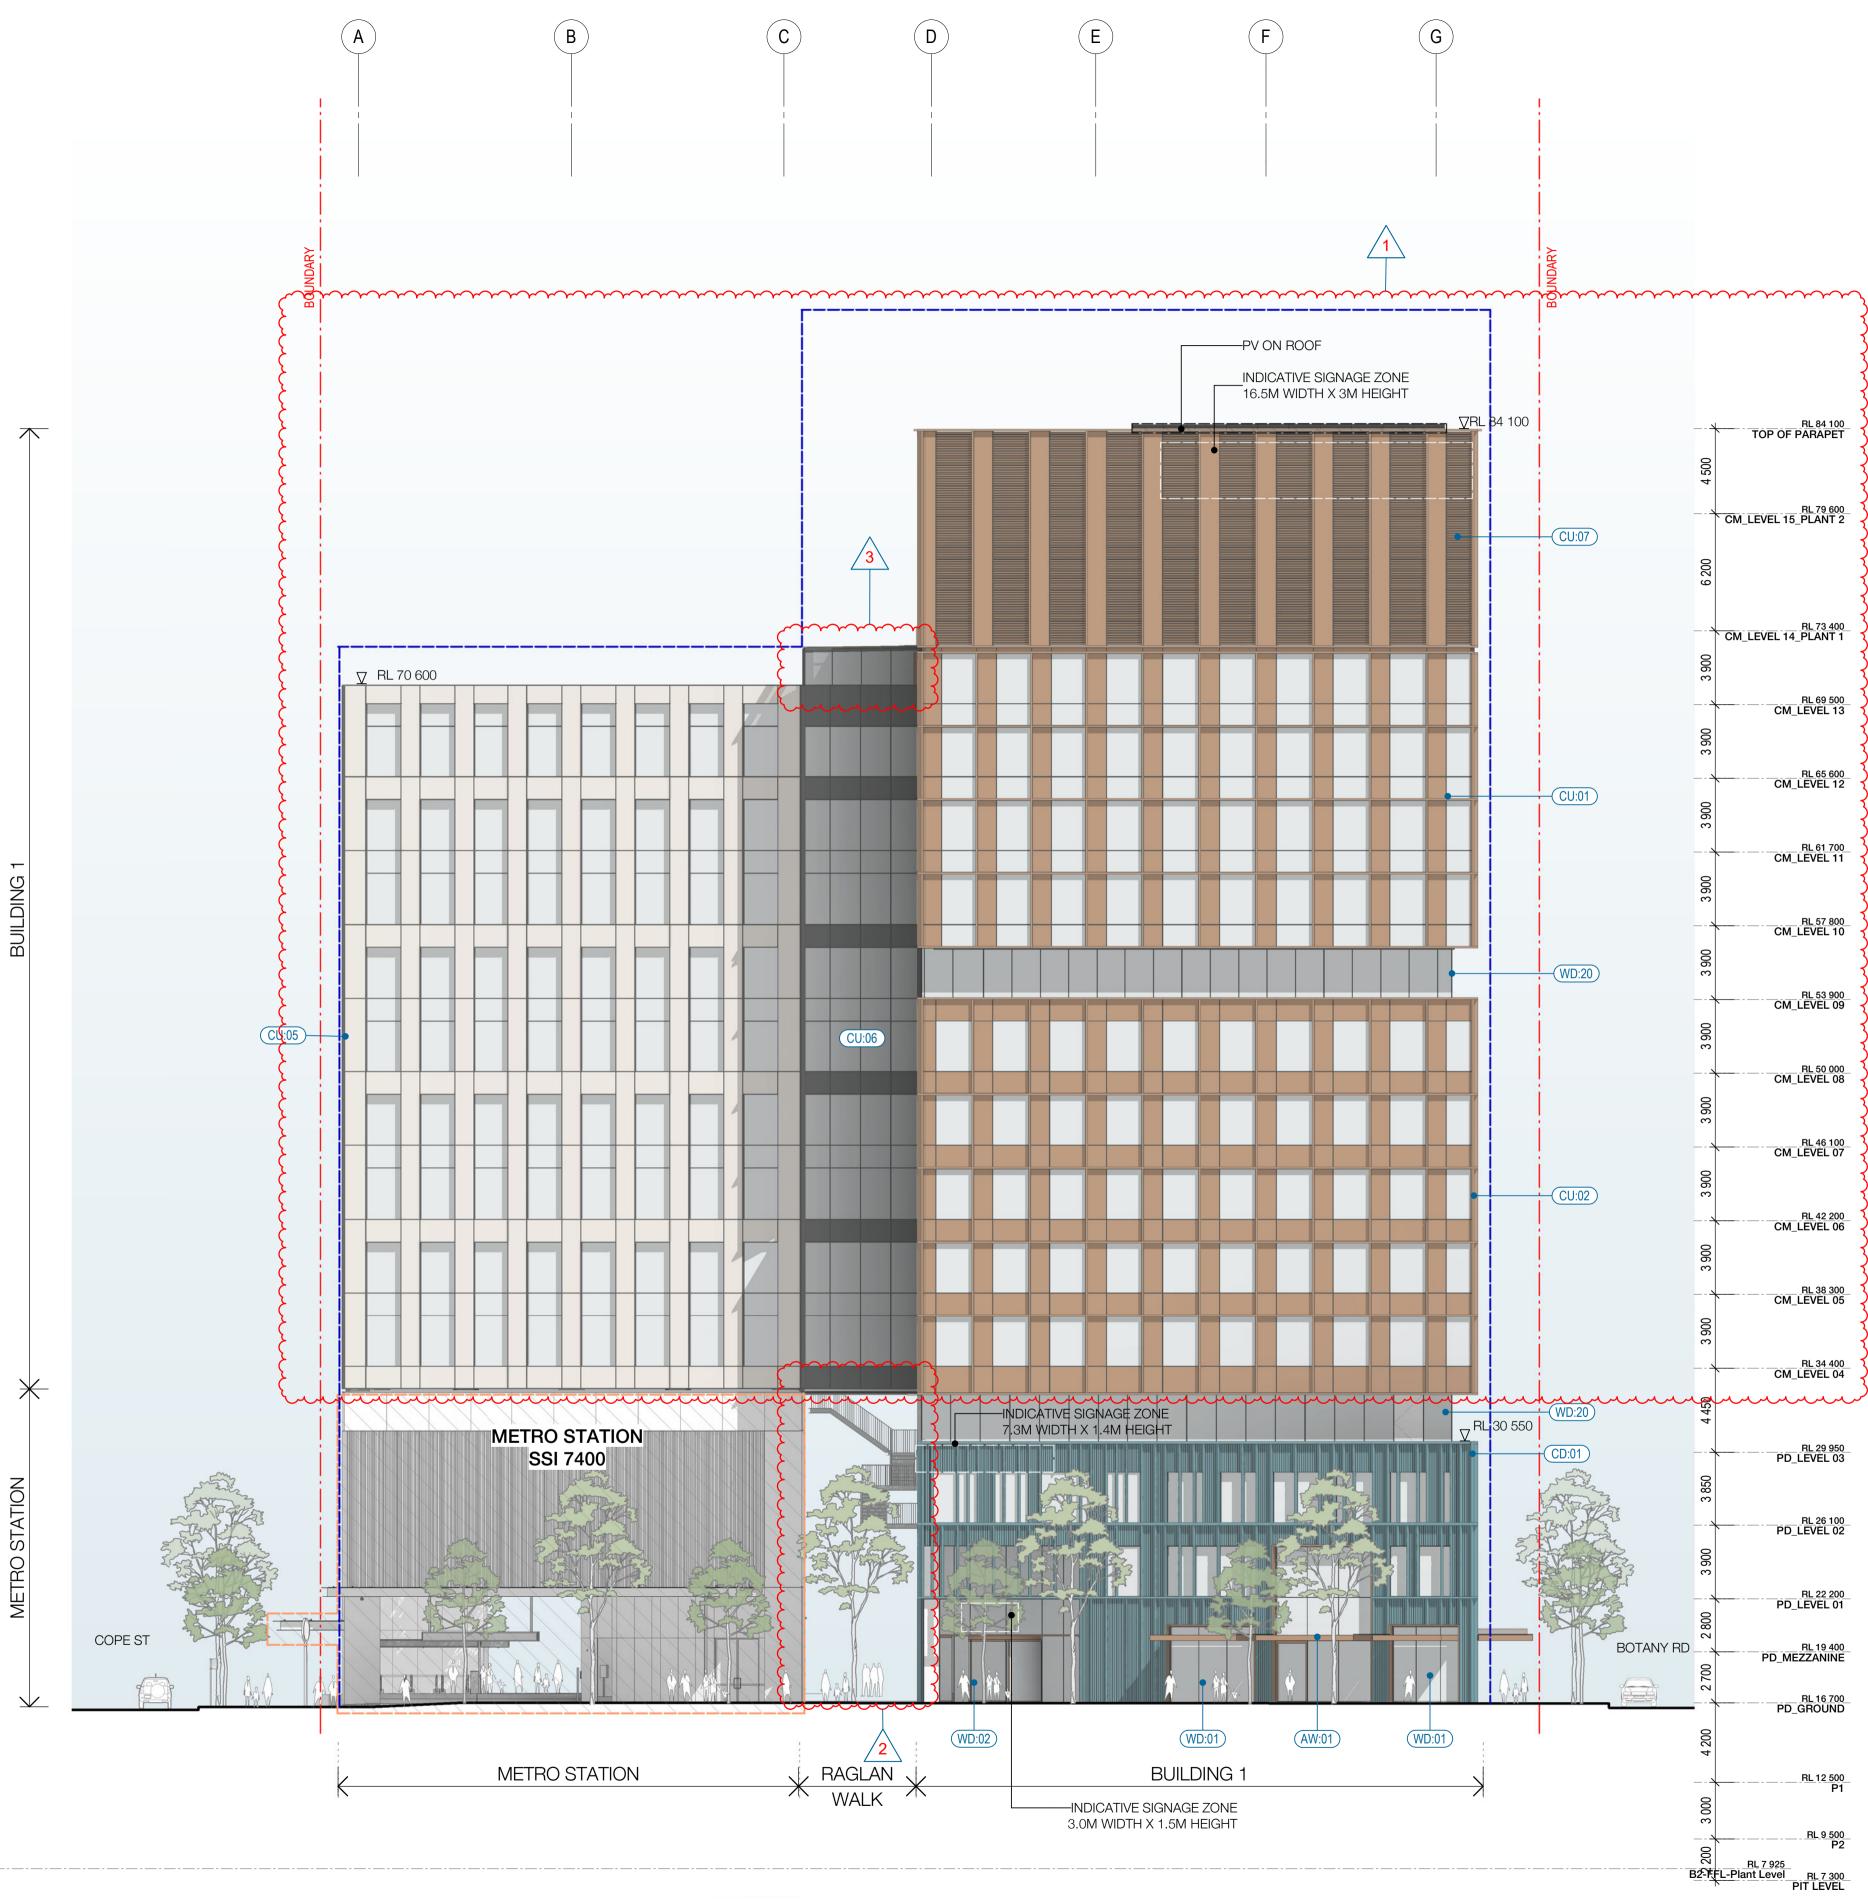

Recent revision history # Status FOR INFORMATION (DA) 15.07.20 FOR APPROVAL 31.07.20 28.08.20 FOR APPROVAL FOR APPROVAL 25.09.20 FOR INFORMATION 28.01.21 15.03.21 FOR APPROVAL Current Revision Amendments

# Mark Comments

F 1 HEIGHT REDUCED FIRE STAIR UPDATED F 3 SKYLIGHT UPDATED

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**FACADE - TOWER** 

CU:01 CURTAIN WALL WITH EXPRESSED VERTICAL & HORIZONTAL FINS WITH GLASS SPANDREL

CU:02 CURTAIN WALL WITH EXPRESSED VERTICAL & HORIZONTAL FINS WITH METAL SPANDREL

CU:03 CURTAIN WALL WITH FOLDED ALUMINIUM CLADDING

CU:04 CURTAIN WALL WITH EXPRESSED VERTICAL & HORIZONTAL FINS WITH GLASS & METAL SPANDREL

CU:05 PREFINISHED FIBRE CEMENT PANEL

CU:06 CURTAIN WALL WITH EXPRESSED VERTICAL & HORIZONTAL FINS WITH GLASS & METAL SPANDREL

CU:07 CURTAIN WALL WITH ARCHITECTURAL LOUVRE AND PROFILED METAL

(WD:20) STRUCTURAL GLAZED FRAMED WINDOWS

WD:21 ATRIUM SKYLIGHT WITH PERFORMANCE SHADING GLAZED

FACADE - PODIUM NORTH

CD:01 CERAMIC CLADDING - INTERNAL WALL:
BLOCKWALL GRD LVL & METAL FRAME L1 & ABOVE WD:01) SHOPFRONT WINDOW WITH METAL REVEAL

WD:02 REVOLVING DOOR WITH LIGHT FRAME (WD:03) PODIUM LANEWAY OPERABLE SHOPFRONT GLAZING

WD:20 STRUCTURAL GLAZED FRAMED WINDOWS

WD:22 PRE-FINISHED FIBRE CEMENT PANELS LINING THE SHAFTS

FACADE - PODIUM SOUTH

CD:02 FACE BRICK - INTERNAL WALL: BLOCKWALL GRD LVL & METAL FRAME L1 & ABOVE

WD:10 SHOP FRONT GLAZING WITH EXPRESSED POWDERCOATED STEEL FRAMED

WD:11 OPERABLE SHOP FRONT GLAZING WITH

EXPRESSED POWDERCOATED STEEL FRAMED

CORE

CD:03 SOLID FOLDED METAL PANEL CD:20 COMPRESSED FIBRE CEMENT PANEL

CU:08 CURTAIN WALL WINDOW WITH GLASS SPANDREL AND SMOKE RELIEF LOUVRES

WHERE SHOWN (WD:30) CORE SLOT WINDOW

**AWNINGS & CANOPIES** 

(AW:01) NORTH RETAIL AWNING

(AW:02) NORTH FOYER ENTRY CANOPY


(AW:03) SOUTH RETAIL AWNING

CP:01 ROOF TERRACE GLAZED CANOPY WITH PAINTED STEEL FRAME

**EXTERNAL SOFFIT** 

(CL:01) LANEWAY CEILING METALWORK

MW:01 FABRICATED ALUMINIUM PLANTER POWDERCOAT FINISH

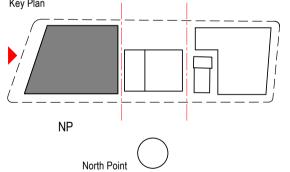









WATERLOO METRO QUARTER DEVELOPMENT


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SSD10440 BUILDING 1 - NORTH ELEVATION -RAGLAN STREET

FOR APPROVAL


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Recent revision history # Status FOR INFORMATION (DA) 15.07.20 FOR APPROVAL 31.07.20 28.08.20 FOR APPROVAL FOR APPROVAL 25.09.20 FOR INFORMATION 28.01.21 15.03.21 FOR APPROVAL Current Revision Amendments

HEIGHT REDUCED STAIR UPDATED STAIR REMOVED FACADE UPDATED

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**FACADE - TOWER** CU:01 CURTAIN WALL WITH EXPRESSED VERTICAL & HORIZONTAL FINS WITH GLASS SPANDREL

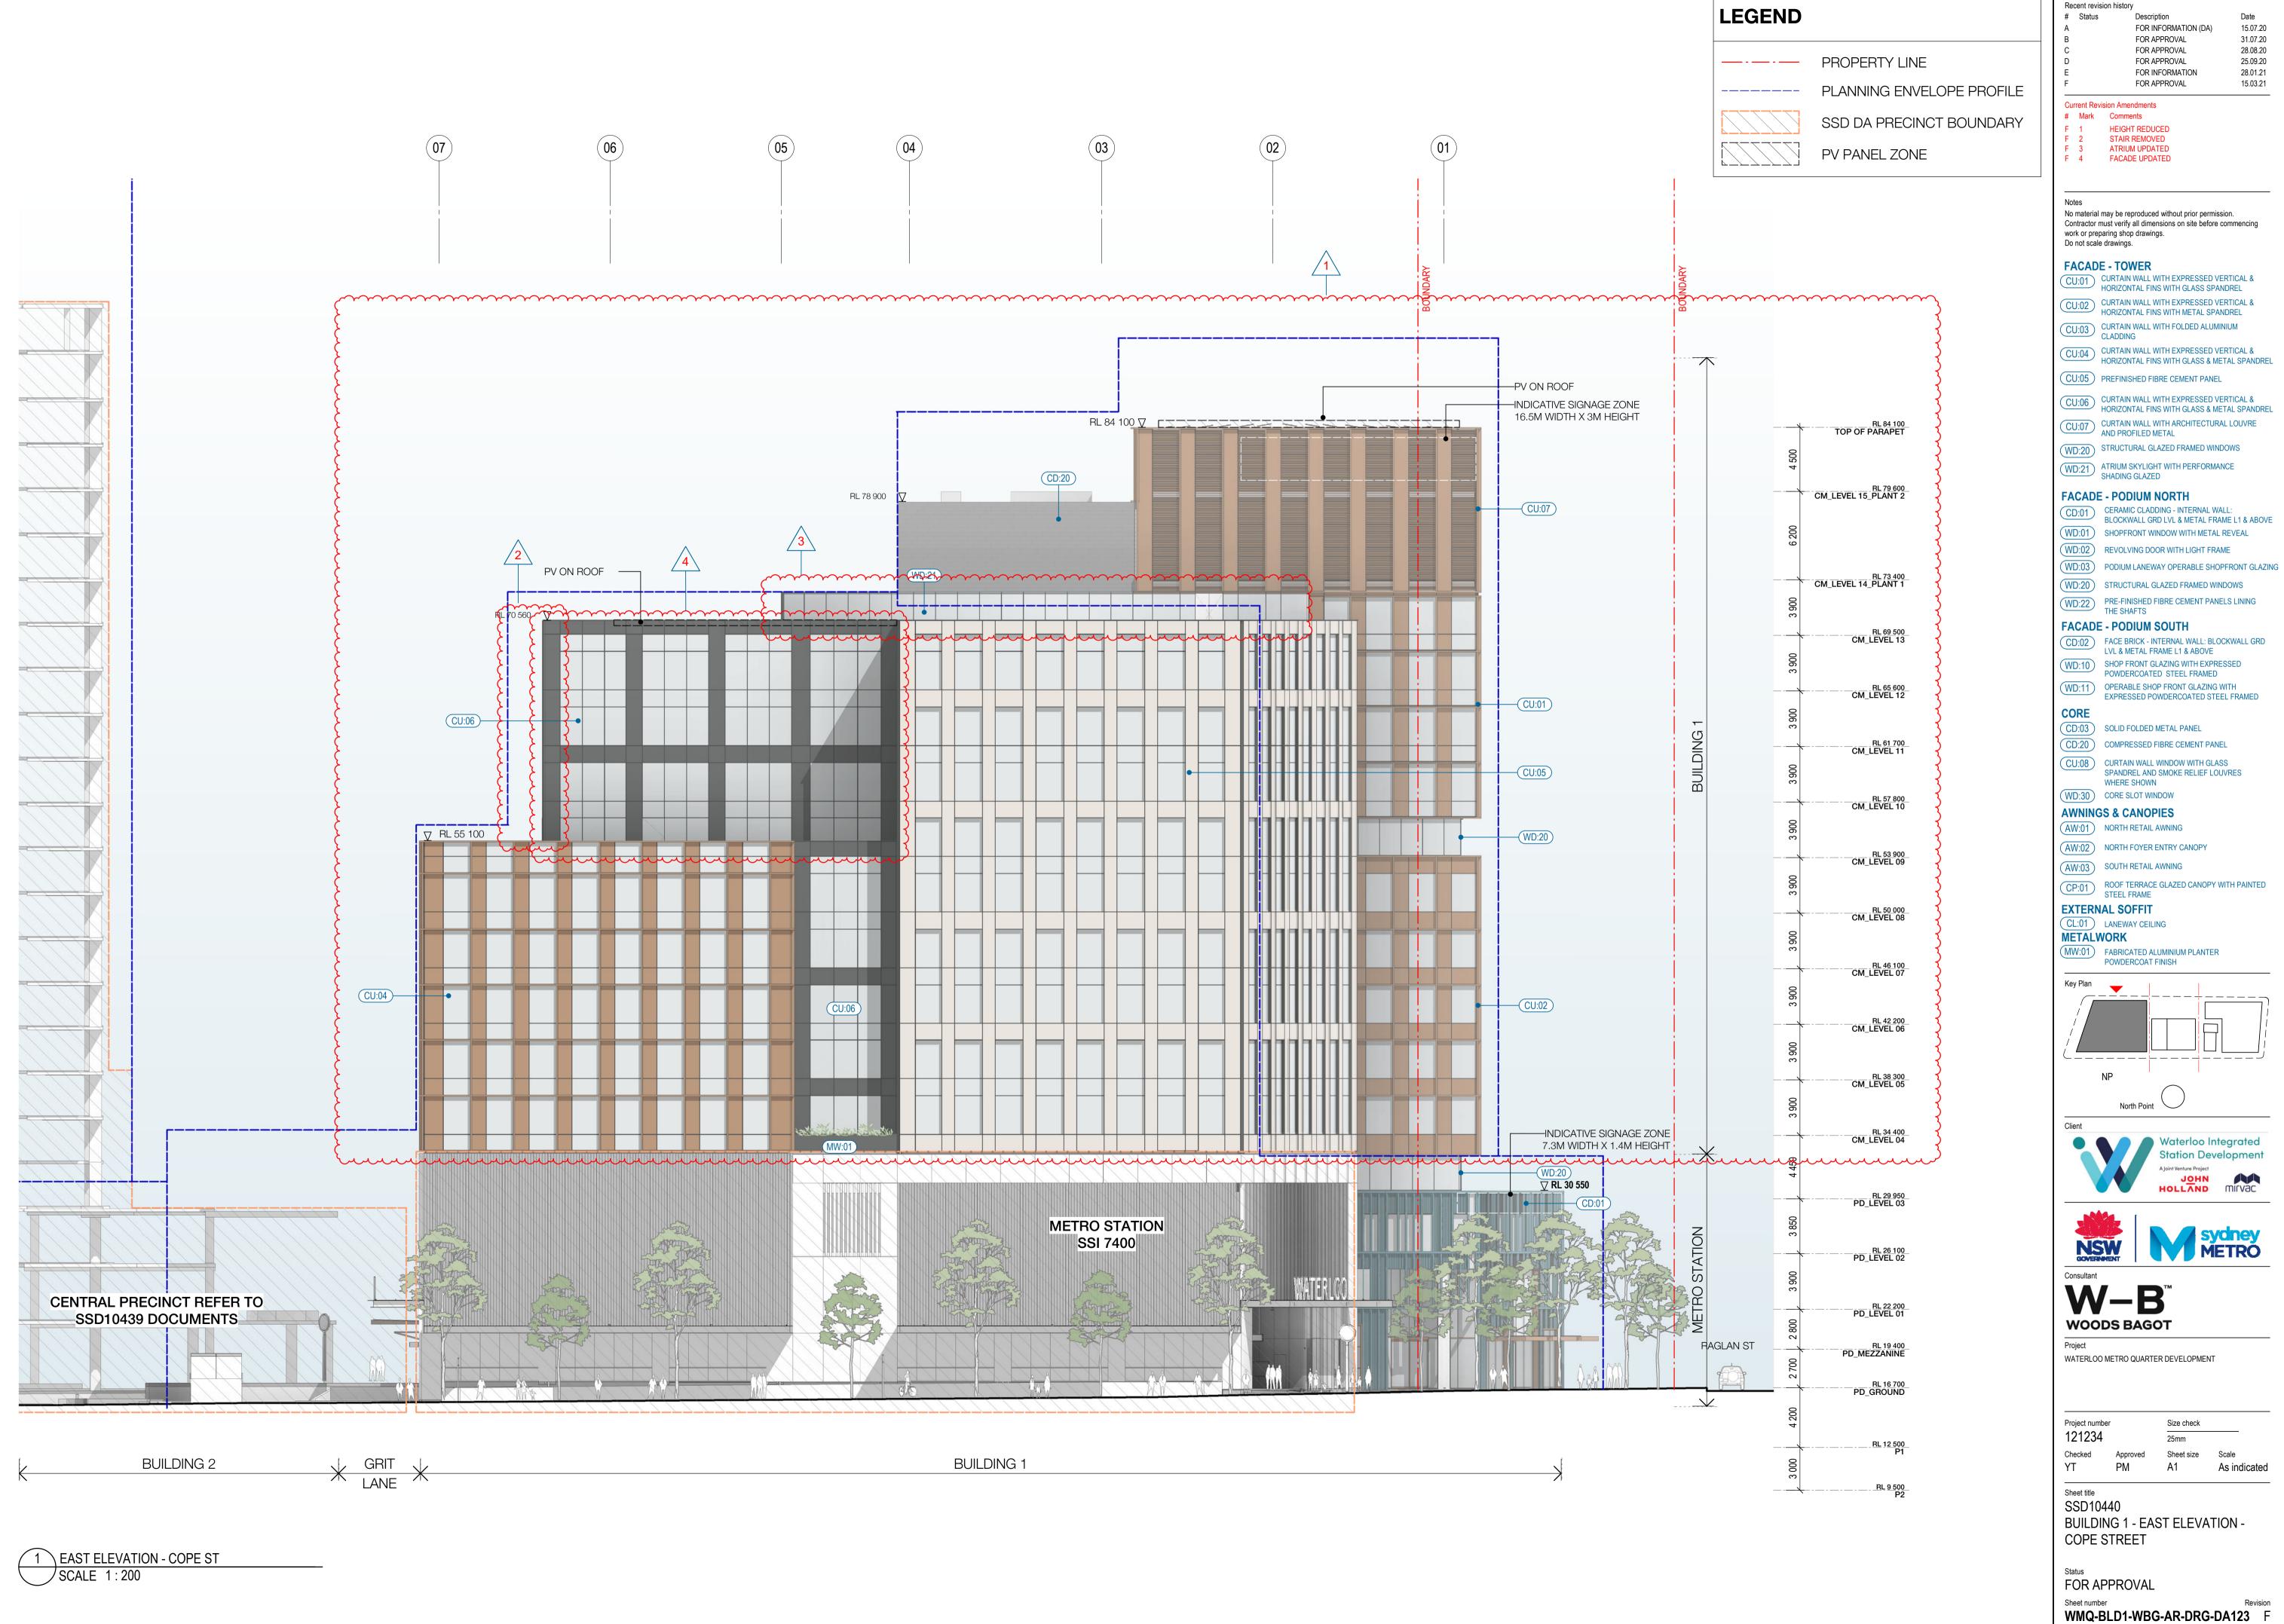CU:02 CURTAIN WALL WITH EXPRESSED VERTICAL & HORIZONTAL FINS WITH METAL SPANDREL

CU:03 CURTAIN WALL WITH FOLDED ALUMINIUM CLADDING

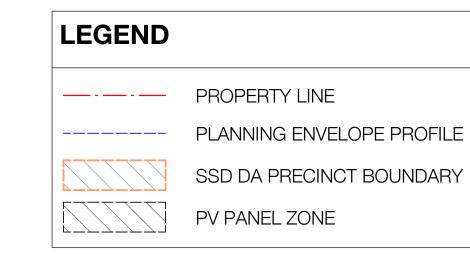CU:04 CURTAIN WALL WITH EXPRESSED VERTICAL & HORIZONTAL FINS WITH GLASS & METAL SPANDREL

CU:05 PREFINISHED FIBRE CEMENT PANEL

CU:06 CURTAIN WALL WITH EXPRESSED VERTICAL & HORIZONTAL FINS WITH GLASS & METAL SPANDREL

CU:07 CURTAIN WALL WITH ARCHITECTURAL LOUVRE AND PROFILED METAL

(WD:20) STRUCTURAL GLAZED FRAMED WINDOWS

WD:21 ATRIUM SKYLIGHT WITH PERFORMANCE SHADING GLAZED

FACADE - PODIUM NORTH

CD:01 CERAMIC CLADDING - INTERNAL WALL:
BLOCKWALL GRD LVL & METAL FRAME L1 & ABOVE

WD:01) SHOPFRONT WINDOW WITH METAL REVEAL

WD:02 REVOLVING DOOR WITH LIGHT FRAME

(WD:03) PODIUM LANEWAY OPERABLE SHOPFRONT GLAZING

WD:20 STRUCTURAL GLAZED FRAMED WINDOWS

WD:22 PRE-FINISHED FIBRE CEMENT PANELS LINING THE SHAFTS

**FACADE - PODIUM SOUTH** 

CD:02 FACE BRICK - INTERNAL WALL: BLOCKWALL GRD LVL & METAL FRAME L1 & ABOVE

WD:10 SHOP FRONT GLAZING WITH EXPRESSED POWDERCOATED STEEL FRAMED

WD:11 OPERABLE SHOP FRONT GLAZING WITH EXPRESSED POWDERCOATED STEEL FRAMED

CD:03 SOLID FOLDED METAL PANEL

CD:20 COMPRESSED FIBRE CEMENT PANEL

CU:08 CURTAIN WALL WINDOW WITH GLASS SPANDREL AND SMOKE RELIEF LOUVRES WHERE SHOWN

(WD:30) CORE SLOT WINDOW

**AWNINGS & CANOPIES** (AW:01) NORTH RETAIL AWNING

(AW:02) NORTH FOYER ENTRY CANOPY


AW:03 SOUTH RETAIL AWNING

CP:01 ROOF TERRACE GLAZED CANOPY WITH PAINTED STEEL FRAME

**EXTERNAL SOFFIT** 

(CL:01) LANEWAY CEILING **METALWORK** 

MW:01 FABRICATED ALUMINIUM PLANTER POWDERCOAT FINISH

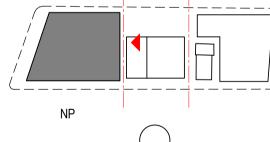









WATERLOO METRO QUARTER DEVELOPMENT


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SSD10440

BUILDING 1 - SOUTH ELEVATION -**GRIT LANE** 

FOR APPROVAL

Sheet number WMQ-BLD1-WBG-AR-DRG-DA124 F

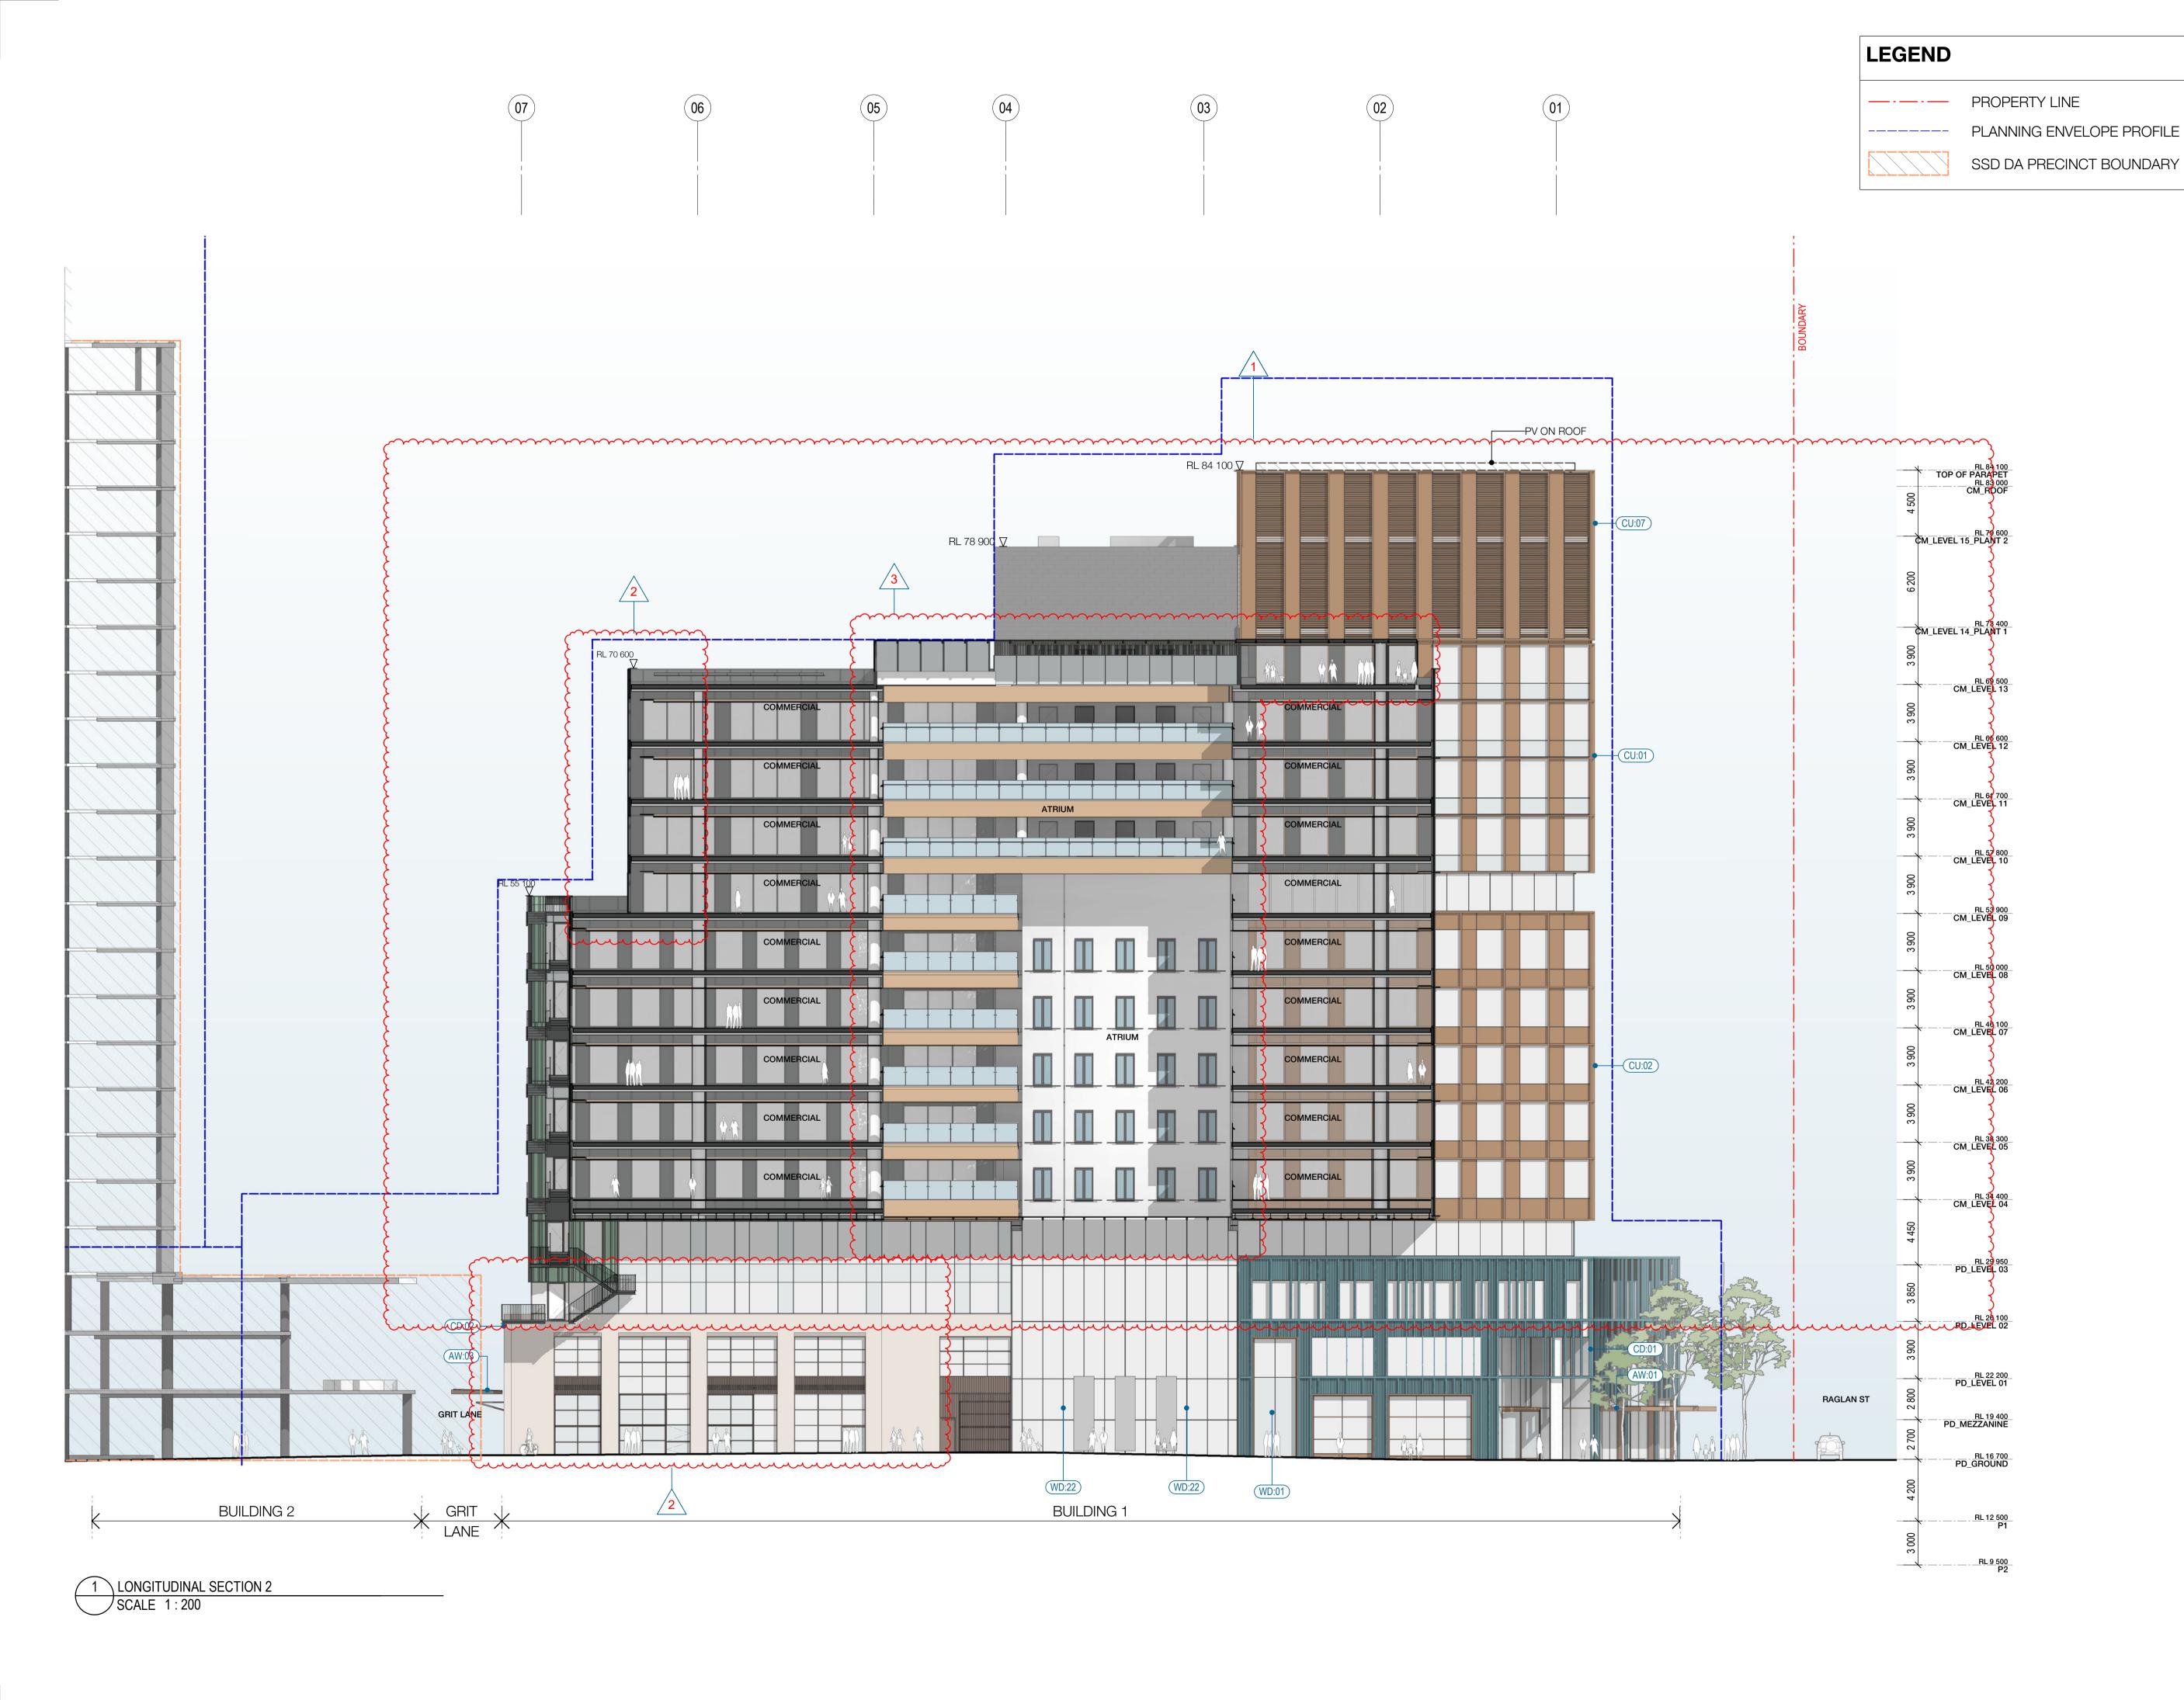

Recent revision history # Status FOR APPROVAL 31.07.20 FOR APPROVAL 28.08.20 25.09.20 FOR APPROVAL FOR APPROVAL 15.12.20 FOR INFORMATION 28.01.21 15.03.21 FOR APPROVAL

Current Revision Amendments # Mark Comments

HEIGHT REDUCED STAIR REMOVED ATRIUM UPDATED

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**FACADE - TOWER** CU:01 CURTAIN WALL WITH EXPRESSED VERTICAL & HORIZONTAL FINS WITH GLASS SPANDREL

CU:02 CURTAIN WALL WITH EXPRESSED VERTICAL & HORIZONTAL FINS WITH METAL SPANDREL

CU:03 CURTAIN WALL WITH FOLDED ALUMINIUM CLADDING

CU:04 CURTAIN WALL WITH EXPRESSED VERTICAL & HORIZONTAL FINS WITH GLASS & METAL SPANDREL

CU:05 PREFINISHED FIBRE CEMENT PANEL

CU:06 CURTAIN WALL WITH EXPRESSED VERTICAL & HORIZONTAL FINS WITH GLASS & METAL SPANDREL CU:07 CURTAIN WALL WITH ARCHITECTURAL LOUVRE AND PROFILED METAL

WD:20 STRUCTURAL GLAZED FRAMED WINDOWS

WD:21 ATRIUM SKYLIGHT WITH PERFORMANCE SHADING GLAZED

**FACADE - PODIUM NORTH** 

CD:01 CERAMIC CLADDING - INTERNAL WALL:
BLOCKWALL GRD LVL & METAL FRAME L1 & ABOVE WD:01) SHOPFRONT WINDOW WITH METAL REVEAL

WD:02 REVOLVING DOOR WITH LIGHT FRAME

(WD:03) PODIUM LANEWAY OPERABLE SHOPFRONT GLAZING

WD:20 STRUCTURAL GLAZED FRAMED WINDOWS

WD:22 PRE-FINISHED FIBRE CEMENT PANELS LINING THE SHAFTS

FACADE - PODIUM SOUTH

CD:02 FACE BRICK - INTERNAL WALL: BLOCKWALL GRD

LVL & METAL FRAME L1 & ABOVE WD:10 SHOP FRONT GLAZING WITH EXPRESSED

POWDERCOATED STEEL FRAMED WD:11 OPERABLE SHOP FRONT GLAZING WITH

EXPRESSED POWDERCOATED STEEL FRAMED

CD:03 SOLID FOLDED METAL PANEL CD:20 COMPRESSED FIBRE CEMENT PANEL

CU:08 CURTAIN WALL WINDOW WITH GLASS

SPANDREL AND SMOKE RELIEF LOUVRES WHERE SHOWN (WD:30) CORE SLOT WINDOW

**AWNINGS & CANOPIES** 

(AW:01) NORTH RETAIL AWNING

(AW:02) NORTH FOYER ENTRY CANOPY

AW:03) SOUTH RETAIL AWNING


CP:01 ROOF TERRACE GLAZED CANOPY WITH PAINTED STEEL FRAME

**EXTERNAL SOFFIT** CL:01 LANEWAY CEILING

**METALWORK** 

MW:01 FABRICATED ALUMINIUM PLANTER

POWDERCOAT FINISH

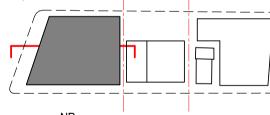

North Point








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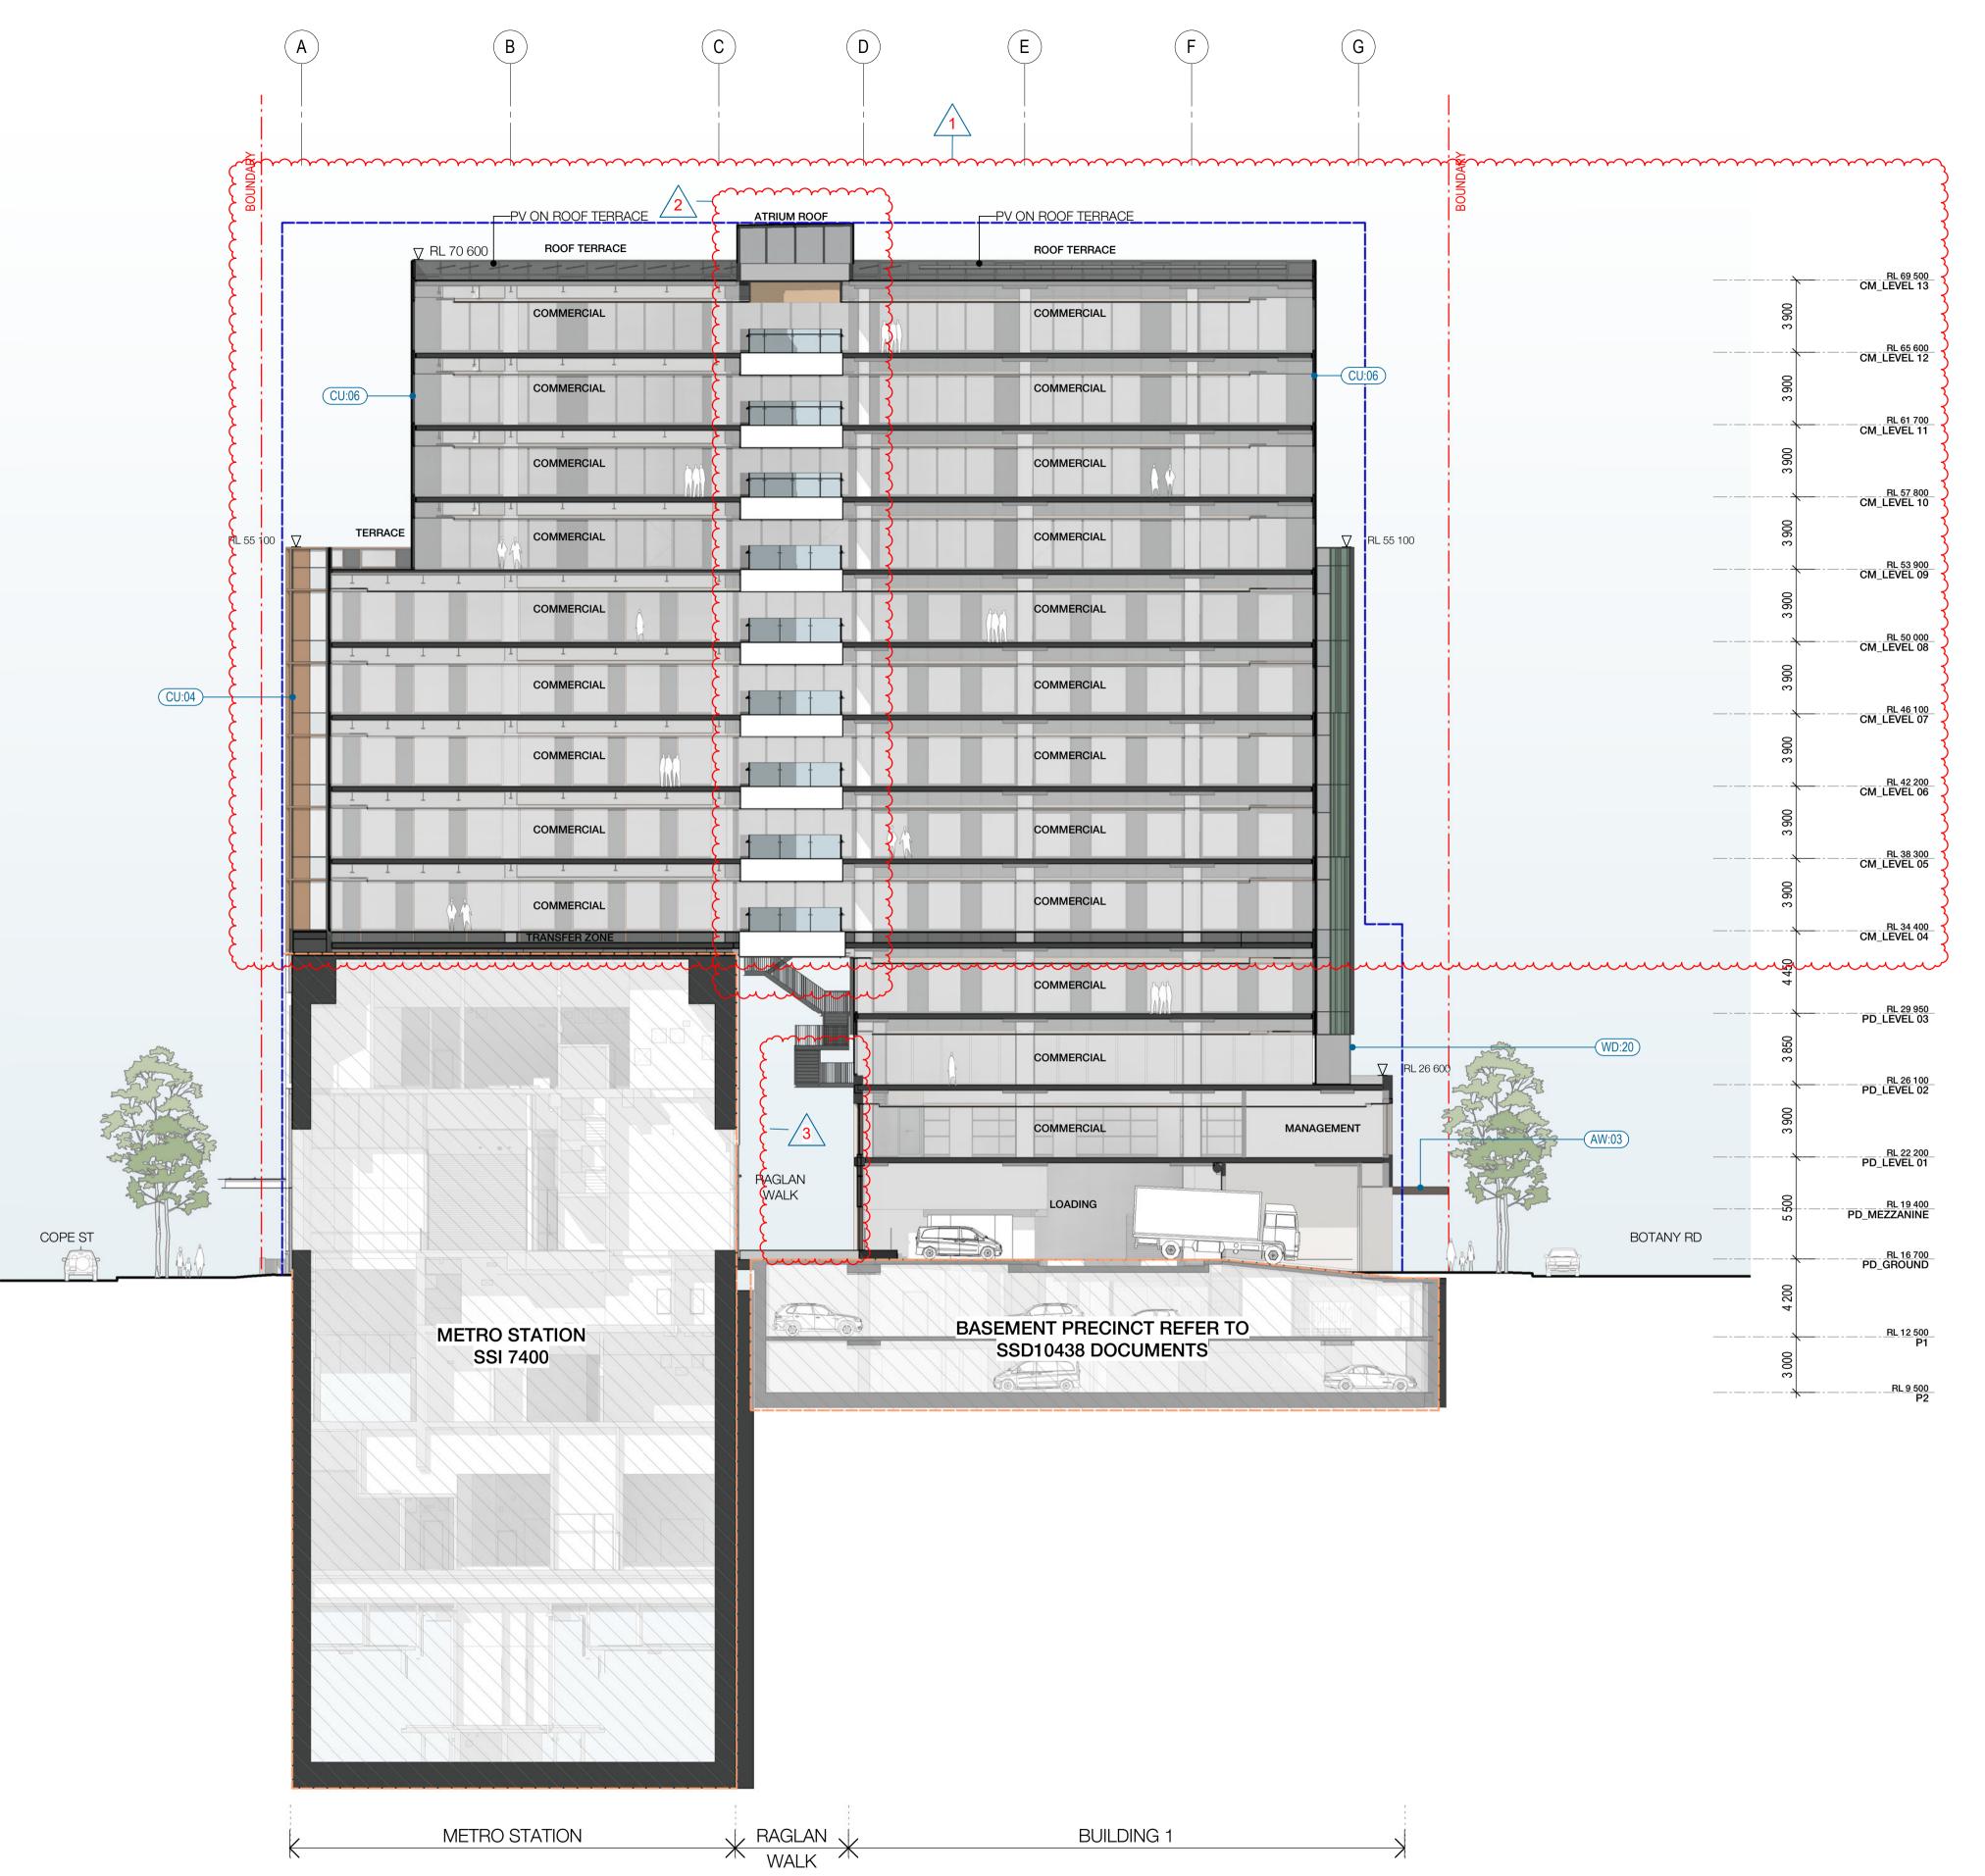
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SSD10440 BUILDING 1 - LONGITUDINAL SECTION 01 - RAGLAN WALK

FOR APPROVAL

WMQ-BLD1-WBG-AR-DRG-DA131 G



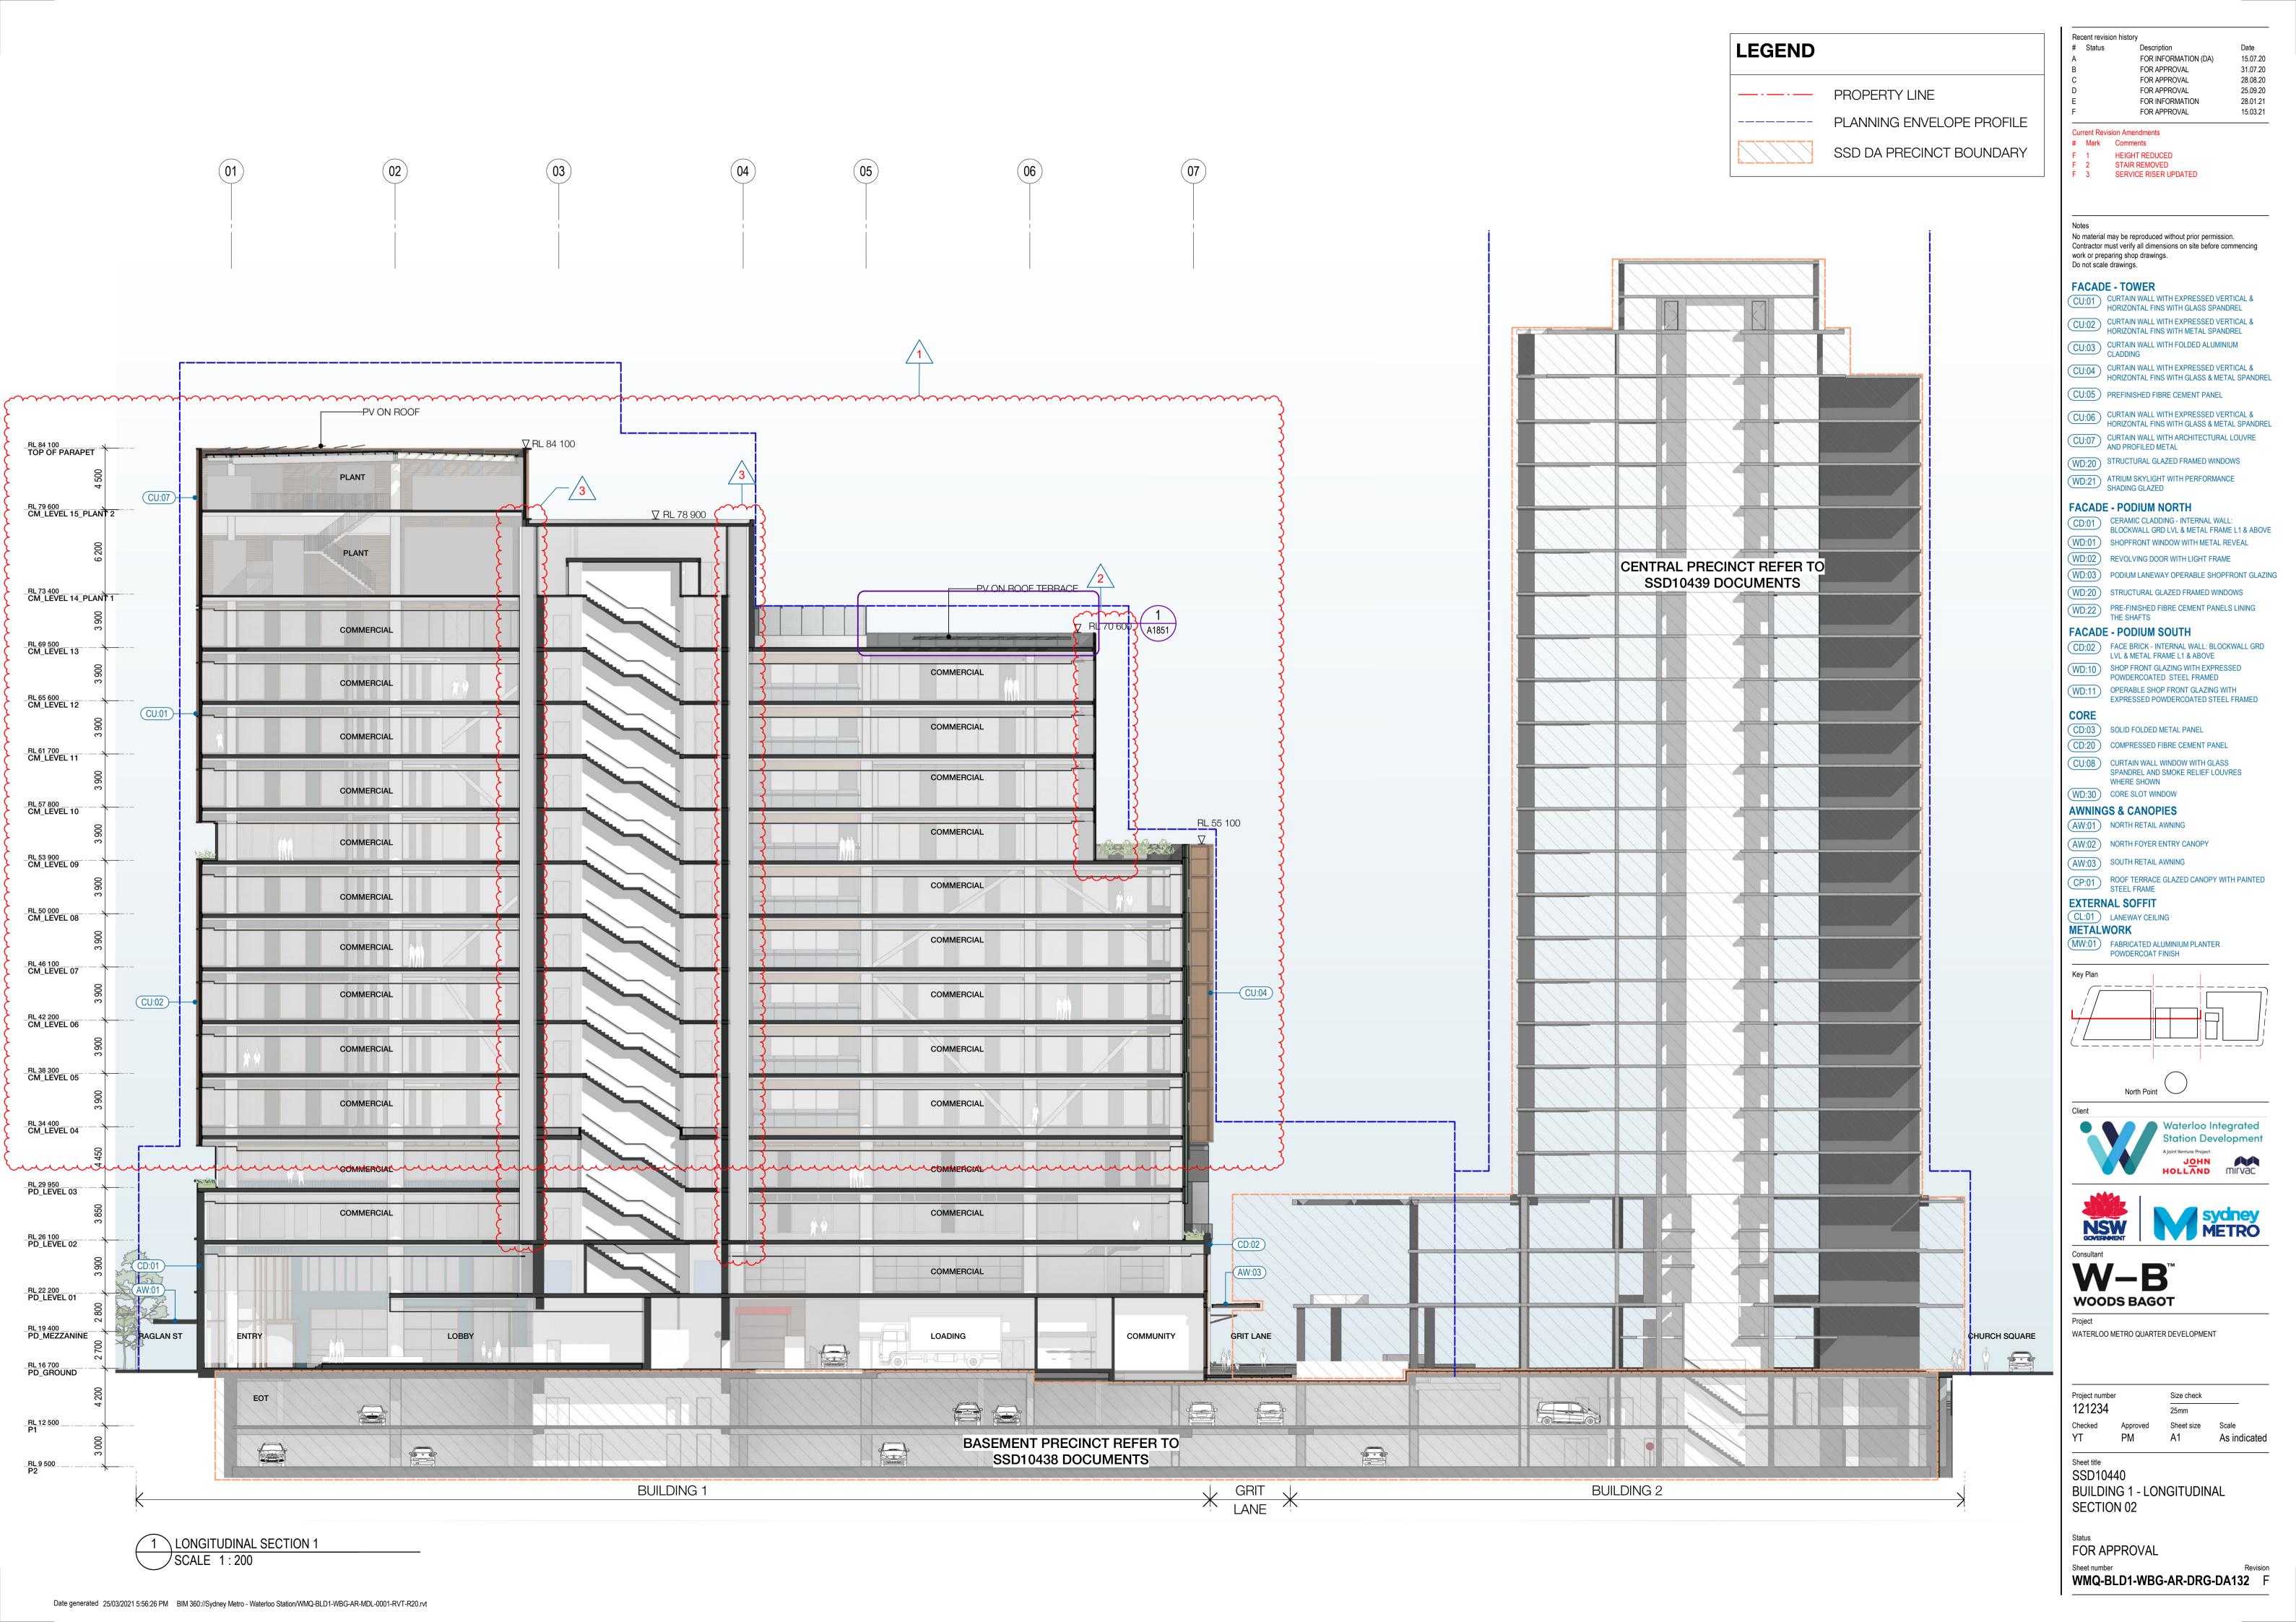

1 CROSS SECTION 1 SCALE 1:200

## **LEGEND**

— · — · — PROPERTY LINE

PLANNING ENVELOPE PROFILE

SSD DA PRECINCT BOUNDARY

Recent revision history # Status FOR INFORMATION (DA) 15.07.20 FOR APPROVAL 31.07.20 FOR APPROVAL 28.08.20 FOR APPROVAL 25.09.20 FOR APPROVAL 15.03.21

Current Revision Amendments # Mark Comments

F 1 HEIGHT REDUCED ATRIUM UPDATED F 3 STAIR UPDATED

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**FACADE - TOWER** CU:01 CURTAIN WALL WITH EXPRESSED VERTICAL & HORIZONTAL FINS WITH GLASS SPANDREL

CU:02 CURTAIN WALL WITH EXPRESSED VERTICAL & HORIZONTAL FINS WITH METAL SPANDREL

CU:03 CURTAIN WALL WITH FOLDED ALUMINIUM CLADDING

CU:04 CURTAIN WALL WITH EXPRESSED VERTICAL & HORIZONTAL FINS WITH GLASS & METAL SPANDREL

CU:05 PREFINISHED FIBRE CEMENT PANEL

CU:06 CURTAIN WALL WITH EXPRESSED VERTICAL & HORIZONTAL FINS WITH GLASS & METAL SPANDREL

CU:07 CURTAIN WALL WITH ARCHITECTURAL LOUVRE AND PROFILED METAL

(WD:20) STRUCTURAL GLAZED FRAMED WINDOWS

WD:21 ATRIUM SKYLIGHT WITH PERFORMANCE SHADING GLAZED

### FACADE - PODIUM NORTH

CD:01 CERAMIC CLADDING - INTERNAL WALL:
BLOCKWALL GRD LVL & METAL FRAME L1 & ABOVE WD:01) SHOPFRONT WINDOW WITH METAL REVEAL

WD:02 REVOLVING DOOR WITH LIGHT FRAME (WD:03) PODIUM LANEWAY OPERABLE SHOPFRONT GLAZING

WD:20 STRUCTURAL GLAZED FRAMED WINDOWS

WD:22 PRE-FINISHED FIBRE CEMENT PANELS LINING THE SHAFTS

## **FACADE - PODIUM SOUTH**

CD:02 FACE BRICK - INTERNAL WALL: BLOCKWALL GRD LVL & METAL FRAME L1 & ABOVE

WD:10 SHOP FRONT GLAZING WITH EXPRESSED POWDERCOATED STEEL FRAMED

WD:11 OPERABLE SHOP FRONT GLAZING WITH EXPRESSED POWDERCOATED STEEL FRAMED

CD:03 SOLID FOLDED METAL PANEL CD:20 COMPRESSED FIBRE CEMENT PANEL

CU:08 CURTAIN WALL WINDOW WITH GLASS

SPANDREL AND SMOKE RELIEF LOUVRES WHERE SHOWN (WD:30) CORE SLOT WINDOW

**AWNINGS & CANOPIES** (AW:01) NORTH RETAIL AWNING

(AW:02) NORTH FOYER ENTRY CANOPY


(AW:03) SOUTH RETAIL AWNING

CP:01 ROOF TERRACE GLAZED CANOPY WITH PAINTED STEEL FRAME **EXTERNAL SOFFIT** 

## CL:01 LANEWAY CEILING

**METALWORK** 

MW:01 FABRICATED ALUMINIUM PLANTER POWDERCOAT FINISH

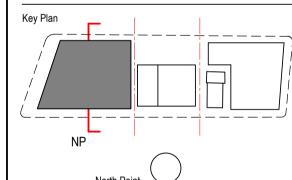









WATERLOO METRO QUARTER DEVELOPMENT


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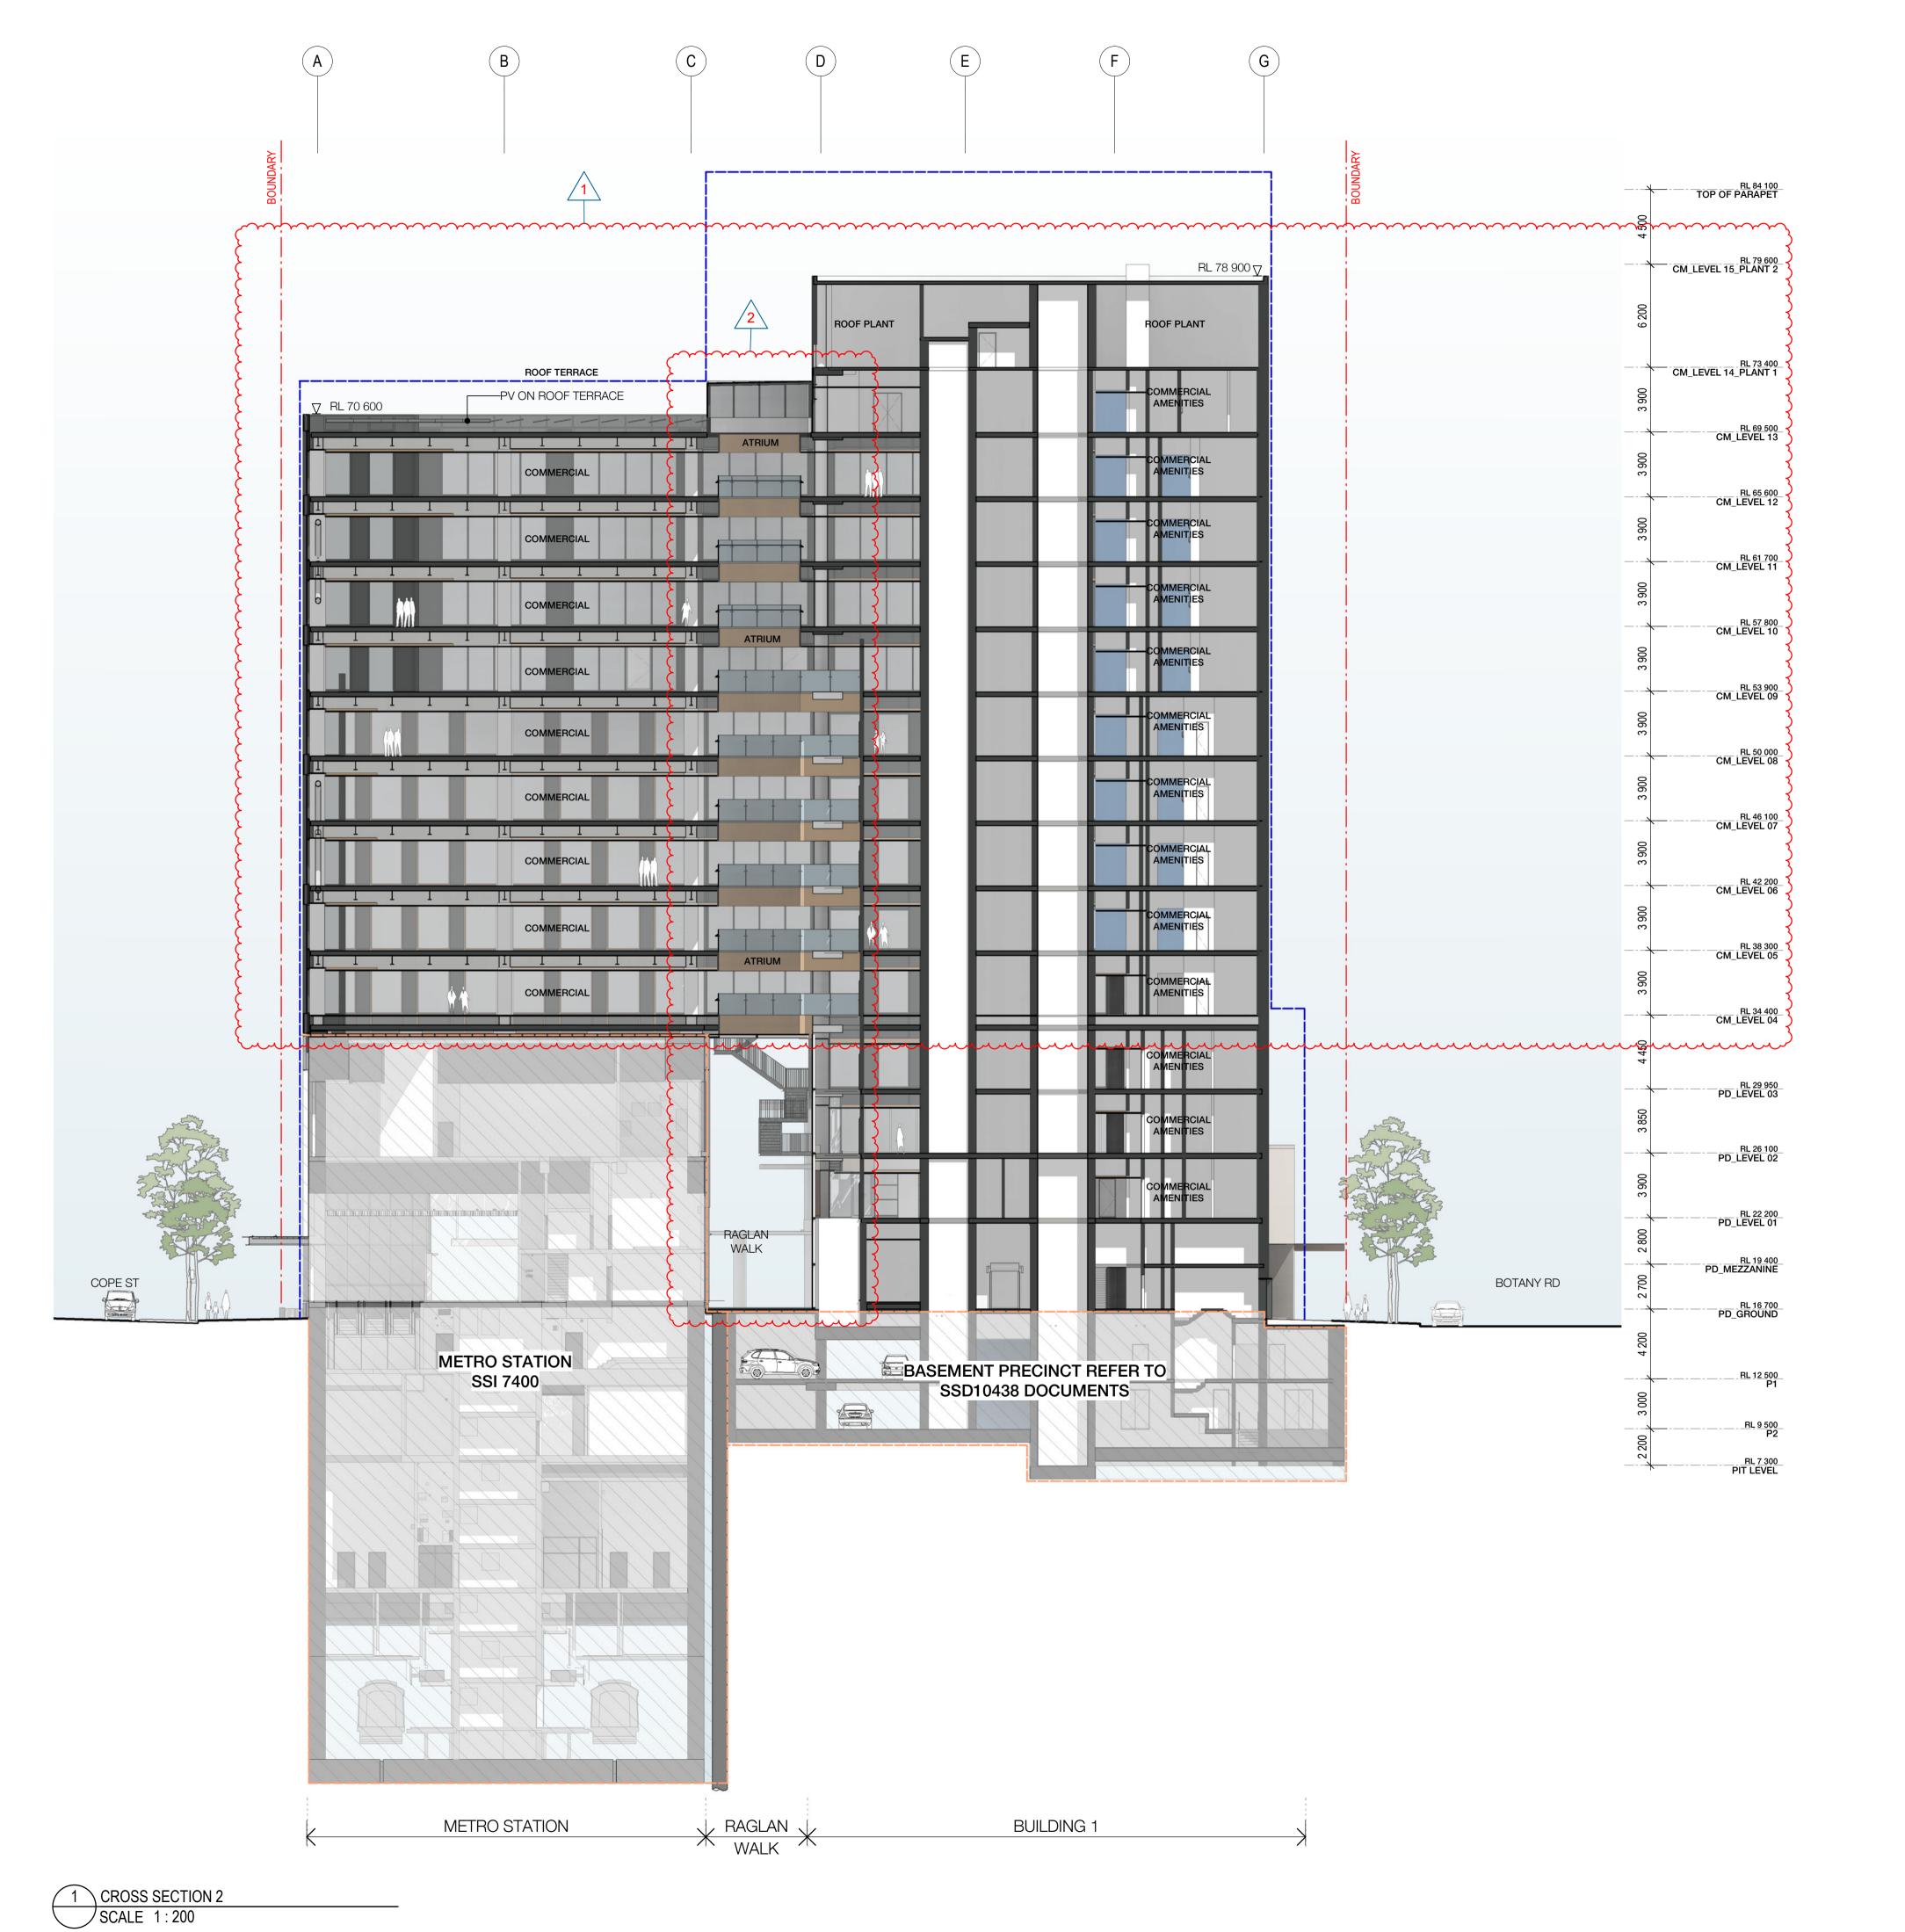
SSD10440

BUILDING 1 - CROSS SECTION 01

FOR APPROVAL

WMQ-BLD1-WBG-AR-DRG-DA133 E



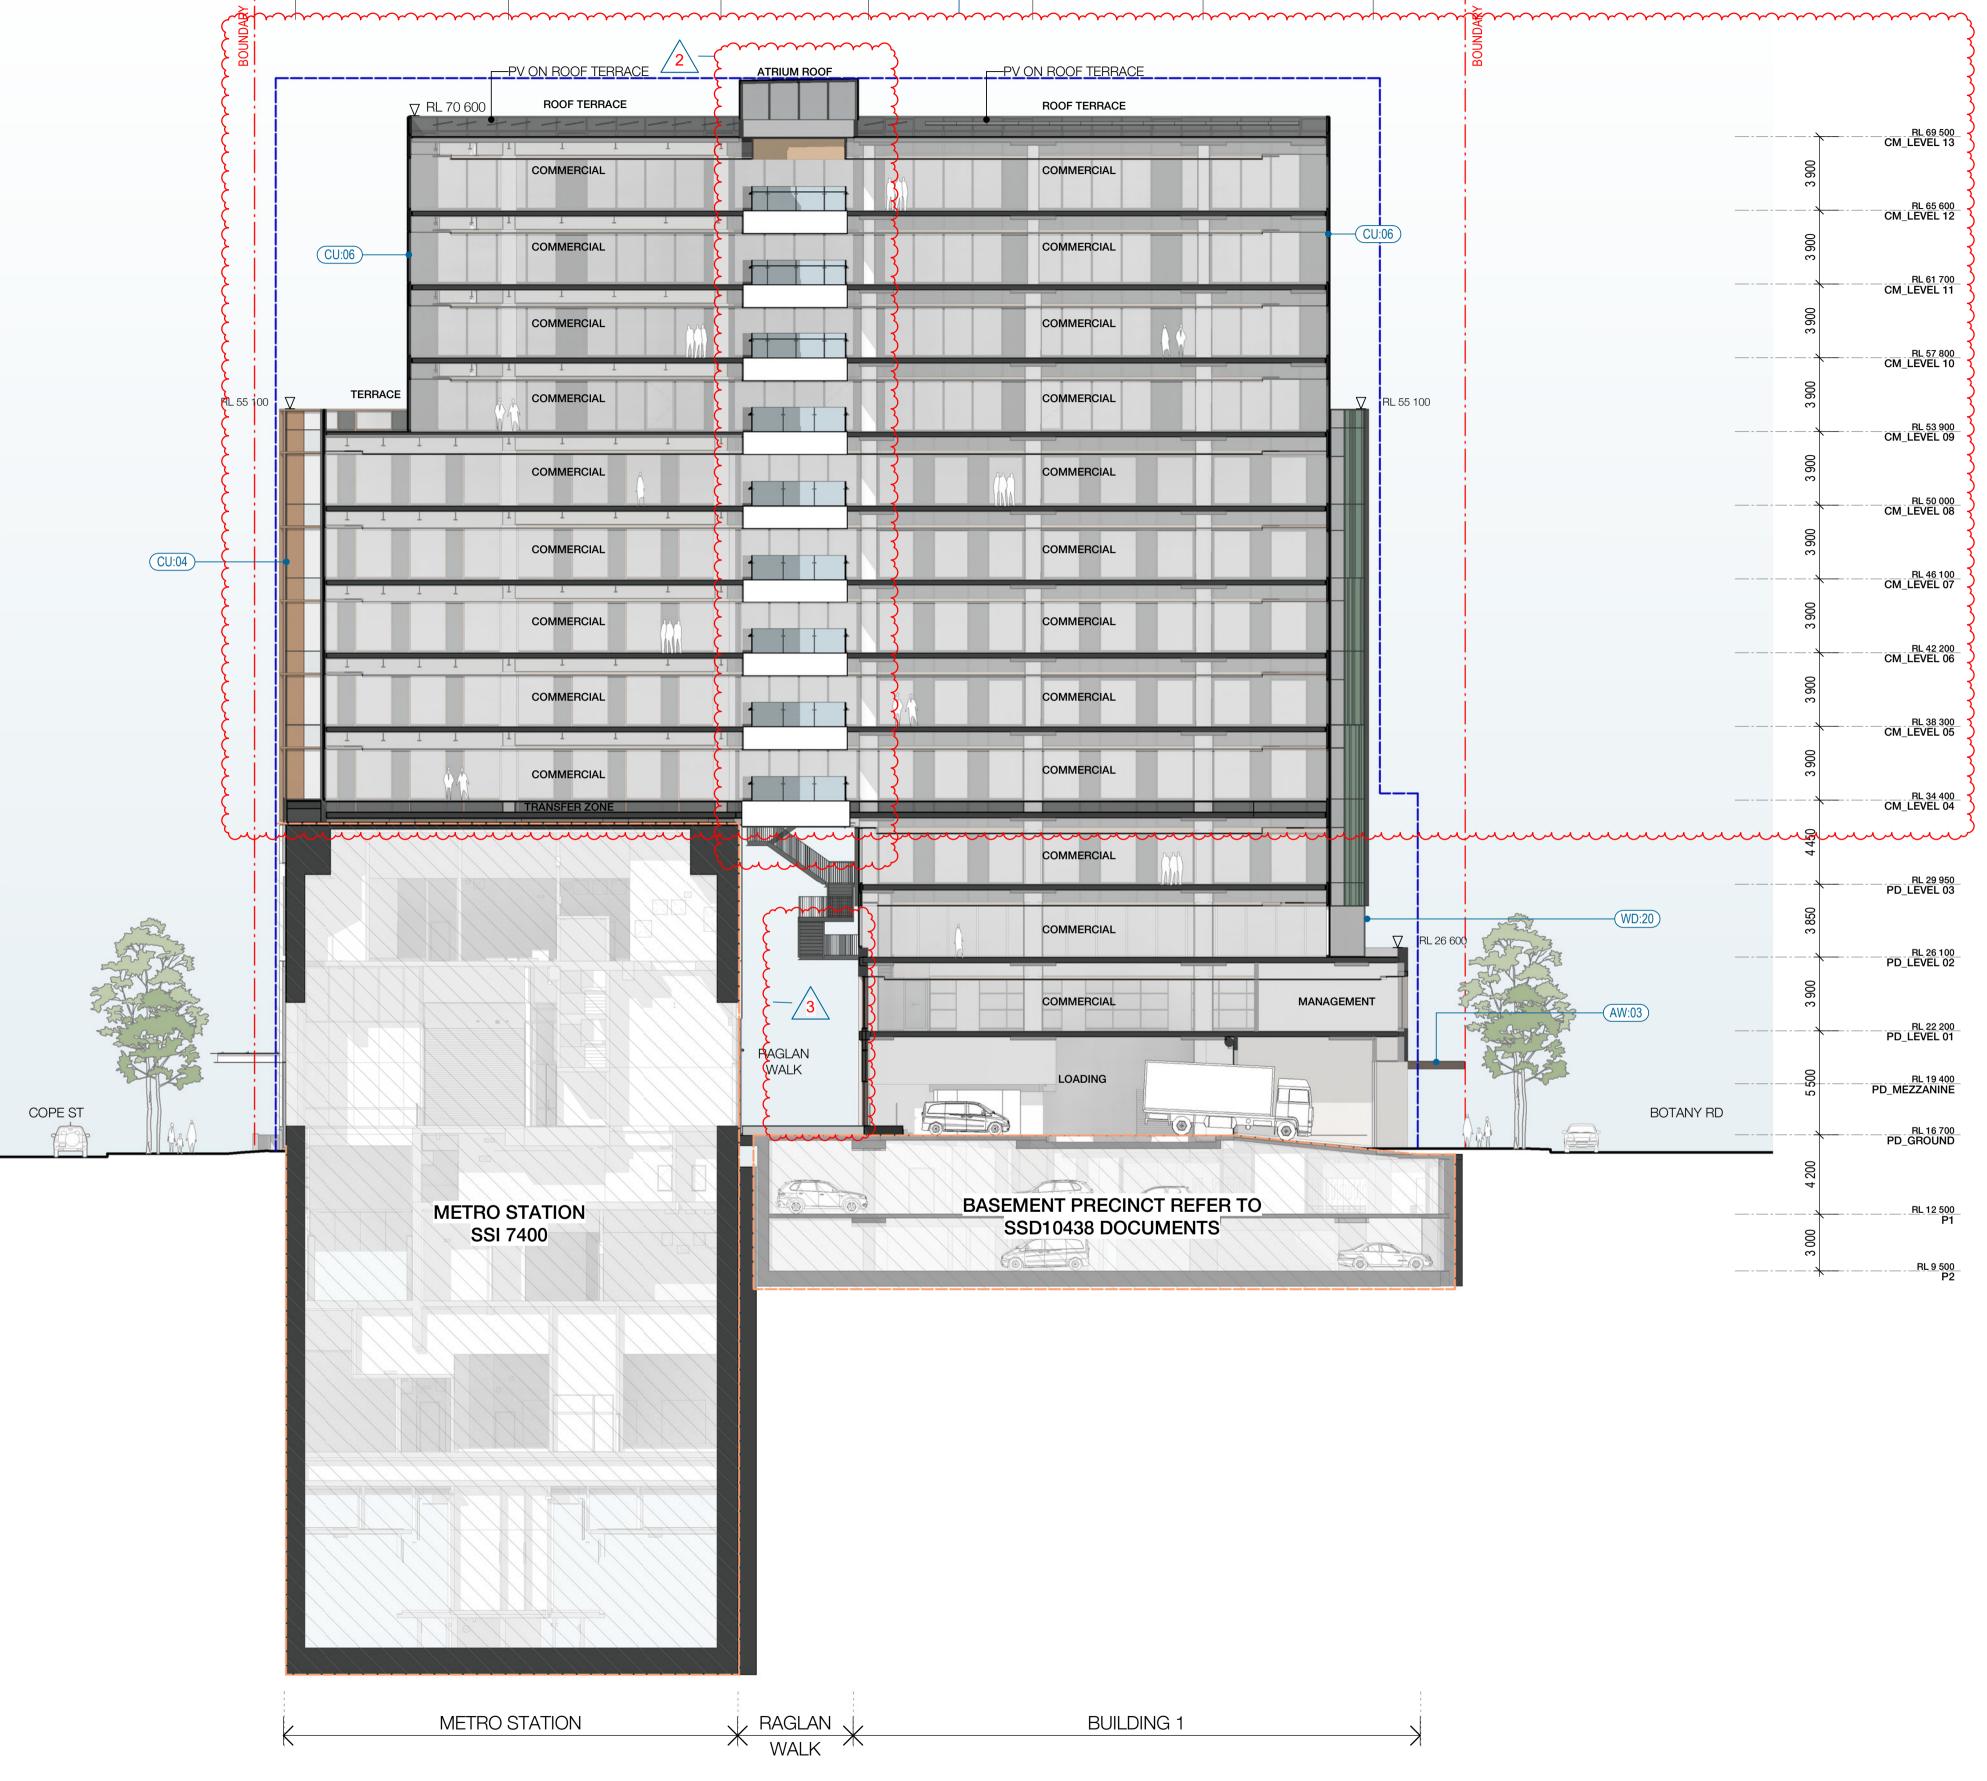

**LEGEND** 

— · — · — PROPERTY LINE

PLANNING ENVELOPE PROFILE SSD DA PRECINCT BOUNDARY Recent revision history # Status FOR INFORMATION (DA) 15.07.20 FOR APPROVAL 31.07.20 28.08.20 FOR APPROVAL FOR APPROVAL 25.09.20 FOR APPROVAL 15.03.21

Current Revision Amendments # Mark Comments F 1 HEIGHT REDUCED

F 2 ATRIUM & STAIR UPDATED

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**FACADE - TOWER** CU:01 CURTAIN WALL WITH EXPRESSED VERTICAL & HORIZONTAL FINS WITH GLASS SPANDREL

CU:02 CURTAIN WALL WITH EXPRESSED VERTICAL & HORIZONTAL FINS WITH METAL SPANDREL

CU:03 CURTAIN WALL WITH FOLDED ALUMINIUM CLADDING

CU:04 CURTAIN WALL WITH EXPRESSED VERTICAL & HORIZONTAL FINS WITH GLASS & METAL SPANDREL

CU:05 PREFINISHED FIBRE CEMENT PANEL

CU:06 CURTAIN WALL WITH EXPRESSED VERTICAL & HORIZONTAL FINS WITH GLASS & METAL SPANDREL

CU:07 CURTAIN WALL WITH ARCHITECTURAL LOUVRE AND PROFILED METAL

(WD:20) STRUCTURAL GLAZED FRAMED WINDOWS

WD:21 ATRIUM SKYLIGHT WITH PERFORMANCE SHADING GLAZED

FACADE - PODIUM NORTH

CD:01 CERAMIC CLADDING - INTERNAL WALL:
BLOCKWALL GRD LVL & METAL FRAME L1 & ABOVE

WD:01) SHOPFRONT WINDOW WITH METAL REVEAL

WD:02 REVOLVING DOOR WITH LIGHT FRAME (WD:03) PODIUM LANEWAY OPERABLE SHOPFRONT GLAZING

WD:20 STRUCTURAL GLAZED FRAMED WINDOWS

WD:22 PRE-FINISHED FIBRE CEMENT PANELS LINING THE SHAFTS

FACADE - PODIUM SOUTH

CD:02 FACE BRICK - INTERNAL WALL: BLOCKWALL GRD LVL & METAL FRAME L1 & ABOVE

WD:10 SHOP FRONT GLAZING WITH EXPRESSED POWDERCOATED STEEL FRAMED

WD:11 OPERABLE SHOP FRONT GLAZING WITH EXPRESSED POWDERCOATED STEEL FRAMED

CD:03 SOLID FOLDED METAL PANEL

CD:20 COMPRESSED FIBRE CEMENT PANEL

CU:08 CURTAIN WALL WINDOW WITH GLASS

SPANDREL AND SMOKE RELIEF LOUVRES WHERE SHOWN

(WD:30) CORE SLOT WINDOW **AWNINGS & CANOPIES** 

(AW:01) NORTH RETAIL AWNING

(AW:02) NORTH FOYER ENTRY CANOPY

AW:03 SOUTH RETAIL AWNING


CP:01 ROOF TERRACE GLAZED CANOPY WITH PAINTED STEEL FRAME

**EXTERNAL SOFFIT** 

(CL:01) LANEWAY CEILING

**METALWORK** 

MW:01 FABRICATED ALUMINIUM PLANTER POWDERCOAT FINISH

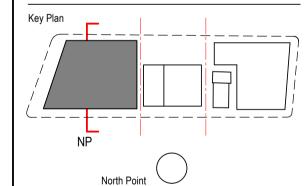







WATERLOO METRO QUARTER DEVELOPMENT


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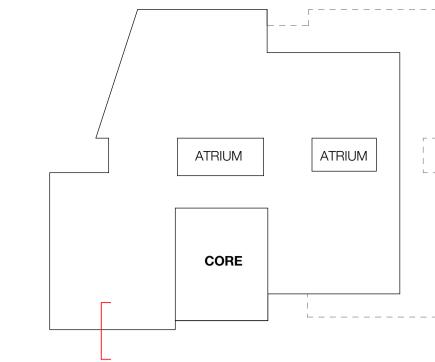
SSD10440

BUILDING 1 - CROSS SECTION 02

FOR APPROVAL

Sheet number WMQ-BLD1-WBG-AR-DRG-DA134 E



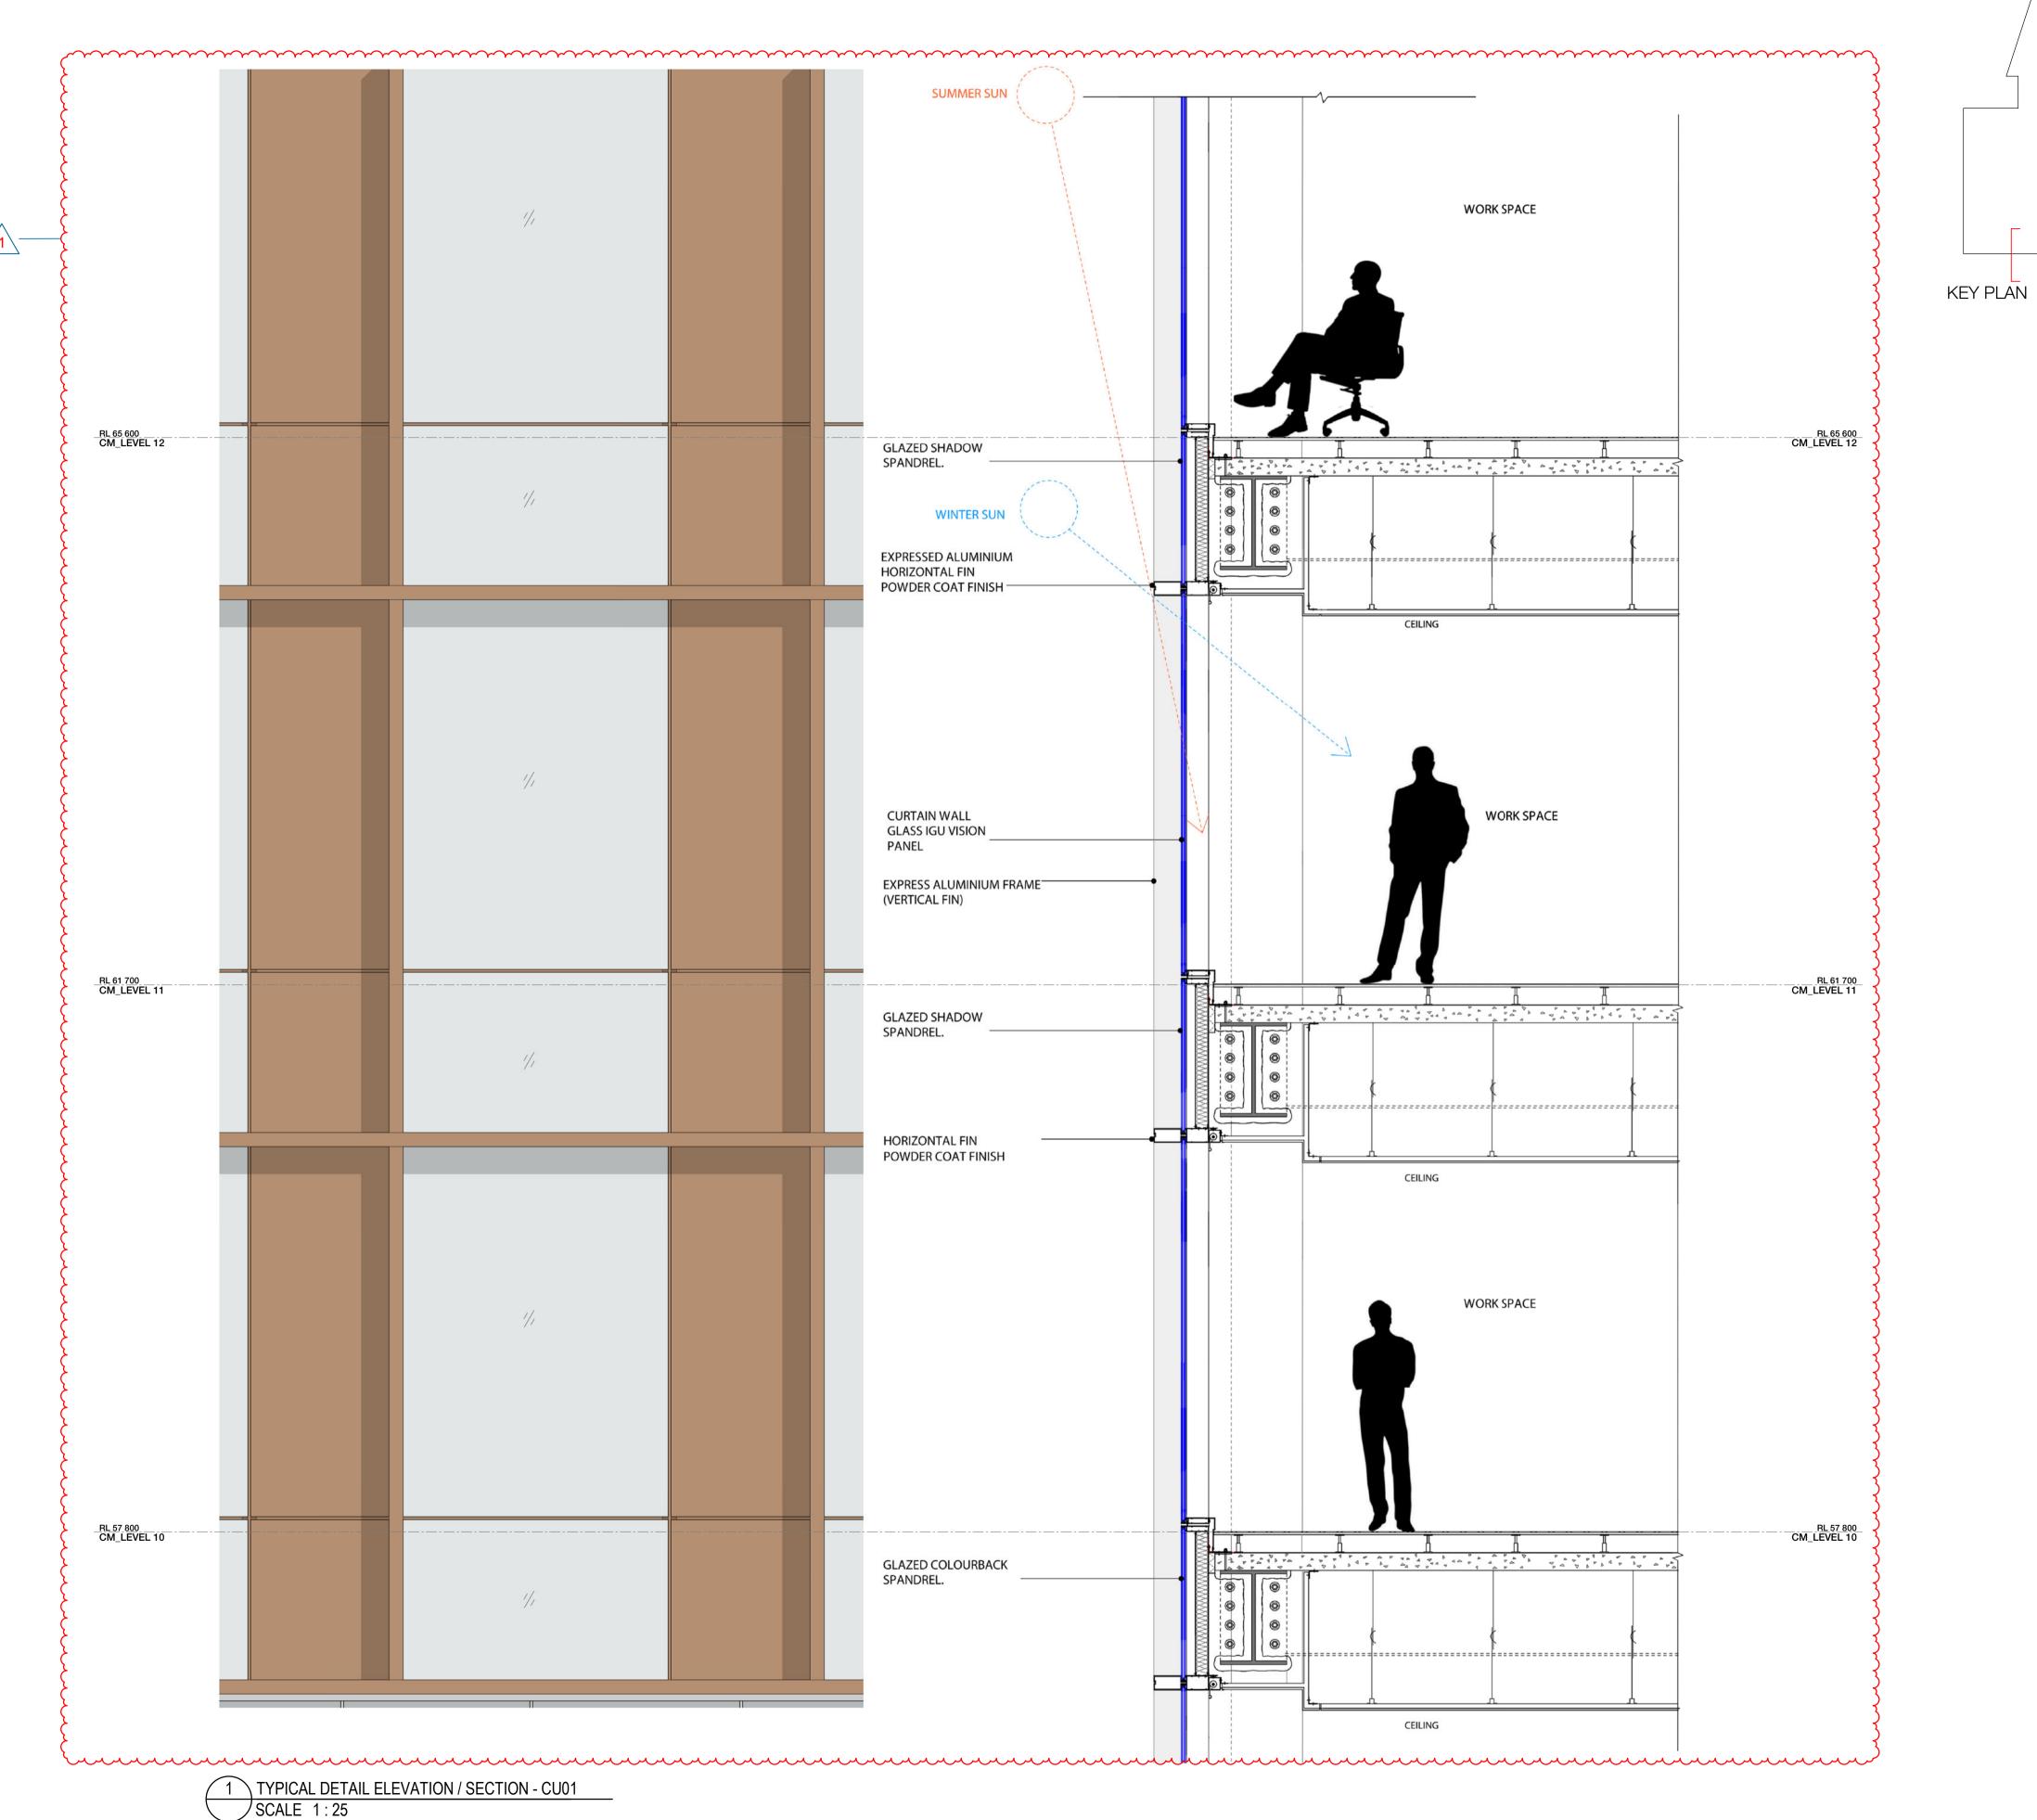

Recent revision history # Status FOR INFORMATION (DA) 15.07.20 FOR APPROVAL 31.07.20 FOR APPROVAL 28.08.20 FOR APPROVAL 25.09.20 FOR APPROVAL 15.03.21

Current Revision Amendments # Mark Comments

E 1 FLOOR TO FLOOR HEIGHT REDUCED

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**FACADE - TOWER** 

CU:01 CURTAIN WALL WITH EXPRESSED VERTICAL & HORIZONTAL FINS WITH GLASS SPANDREL CU:02 CURTAIN WALL WITH EXPRESSED VERTICAL & HORIZONTAL FINS WITH METAL SPANDREL

CU:03 CURTAIN WALL WITH FOLDED ALUMINIUM CLADDING

CU:04 CURTAIN WALL WITH EXPRESSED VERTICAL & HORIZONTAL FINS WITH GLASS & METAL SPANDREL

CU:05 PREFINISHED FIBRE CEMENT PANEL

CU:06 CURTAIN WALL WITH EXPRESSED VERTICAL & HORIZONTAL FINS WITH GLASS & METAL SPANDREL

CU:07 CURTAIN WALL WITH ARCHITECTURAL LOUVRE AND PROFILED METAL

(WD:20) STRUCTURAL GLAZED FRAMED WINDOWS

WD:21 ATRIUM SKYLIGHT WITH PERFORMANCE SHADING GLAZED

# FACADE - PODIUM NORTH

CD:01 CERAMIC CLADDING - INTERNAL WALL:
BLOCKWALL GRD LVL & METAL FRAME L1 & ABOVE WD:01 SHOPFRONT WINDOW WITH METAL REVEAL

WD:02 REVOLVING DOOR WITH LIGHT FRAME (WD:03) PODIUM LANEWAY OPERABLE SHOPFRONT GLAZING

WD:20 STRUCTURAL GLAZED FRAMED WINDOWS

WD:22 PRE-FINISHED FIBRE CEMENT PANELS LINING THE SHAFTS

## **FACADE - PODIUM SOUTH**

CD:02 FACE BRICK - INTERNAL WALL: BLOCKWALL GRD LVL & METAL FRAME L1 & ABOVE

WD:10 SHOP FRONT GLAZING WITH EXPRESSED POWDERCOATED STEEL FRAMED

WD:11 OPERABLE SHOP FRONT GLAZING WITH EXPRESSED POWDERCOATED STEEL FRAMED

**CORE** 

## CD:03 SOLID FOLDED METAL PANEL

CD:20 COMPRESSED FIBRE CEMENT PANEL

CU:08 CURTAIN WALL WINDOW WITH GLASS SPANDREL AND SMOKE RELIEF LOUVRES WHERE SHOWN

(WD:30) CORE SLOT WINDOW

**AWNINGS & CANOPIES** (AW:01) NORTH RETAIL AWNING

(AW:02) NORTH FOYER ENTRY CANOPY

(AW:03) SOUTH RETAIL AWNING


CP:01 ROOF TERRACE GLAZED CANOPY WITH PAINTED STEEL FRAME

# **EXTERNAL SOFFIT**

(CL:01) LANEWAY CEILING **METALWORK** 

MW:01 FABRICATED ALUMINIUM PLANTER

POWDERCOAT FINISH

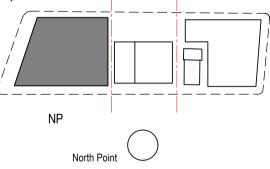











WATERLOO METRO QUARTER DEVELOPMENT


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SSD10440 BUILDING 1 - CU01 TOWER FACADE

**DETAILS** 

FOR APPROVAL

Sheet number WMQ-BLD1-WBG-AR-DRG-DA141 E

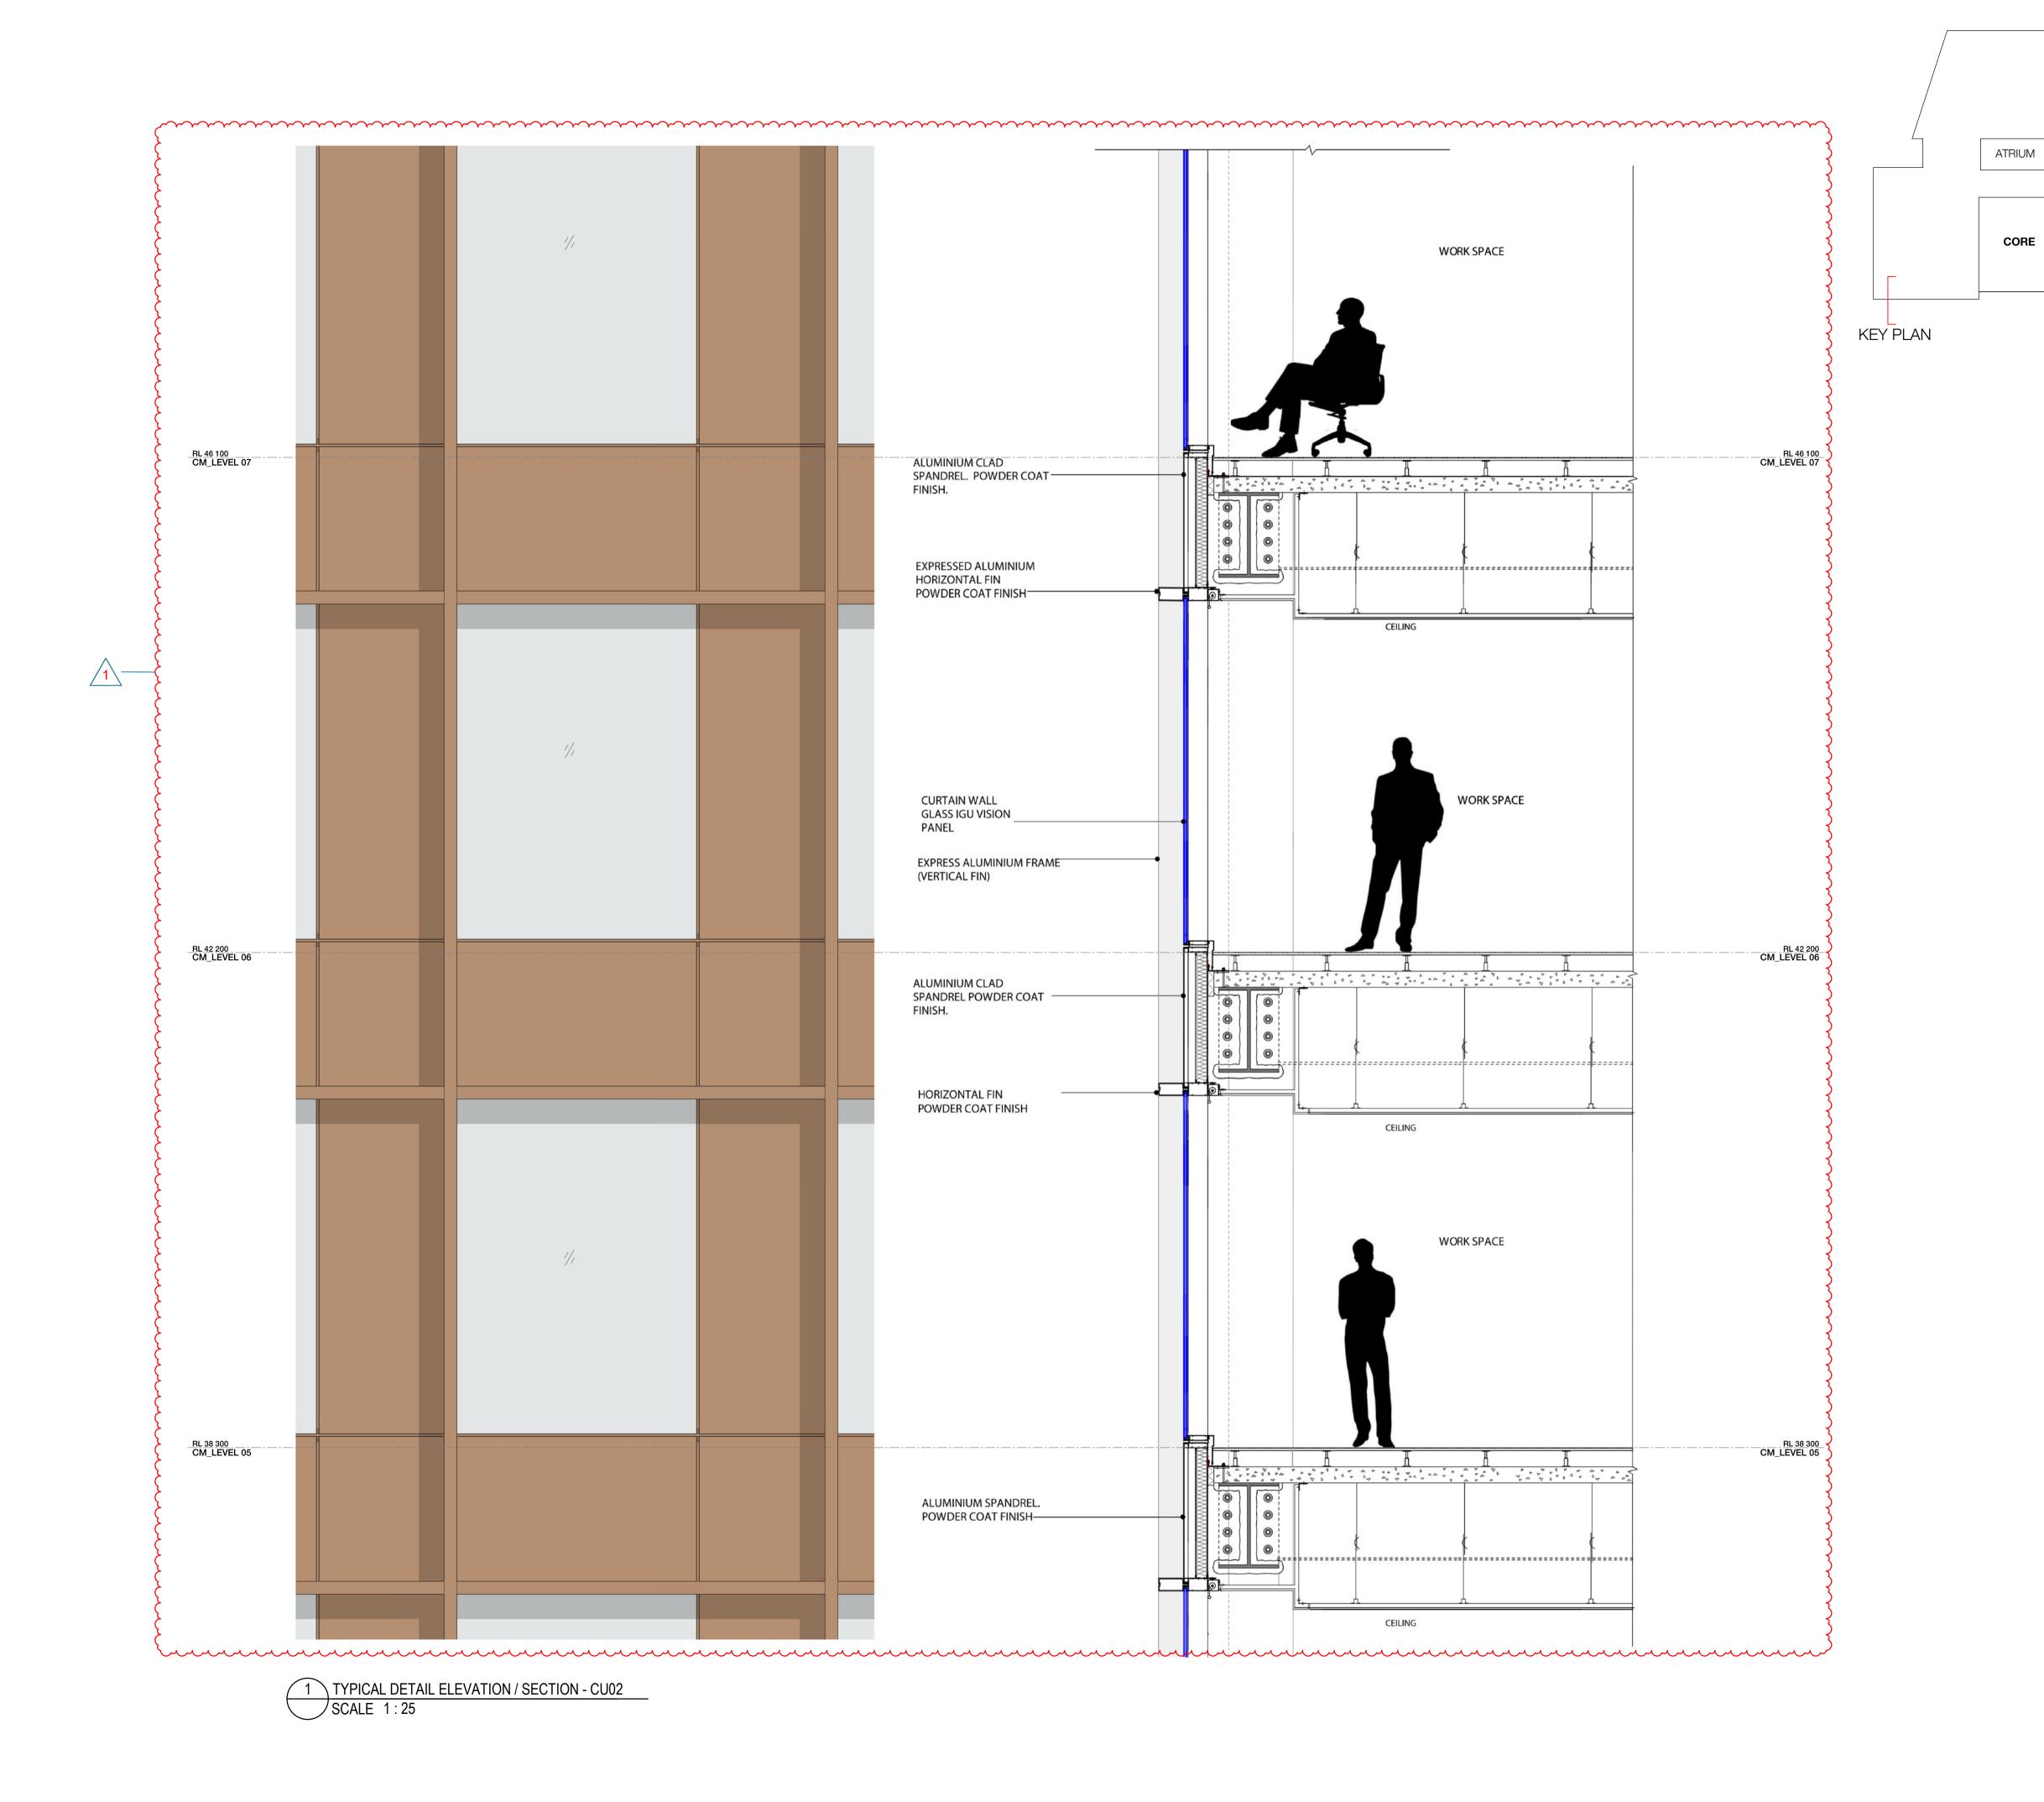

Recent revision history # Status FOR INFORMATION (DA) 15.07.20 FOR APPROVAL 31.07.20 FOR APPROVAL 28.08.20 FOR APPROVAL 25.09.20 FOR APPROVAL 15.03.21 Current Revision Amendments # Mark Comments E 1 FLOOR TO FLOOR HEIGHT REDUCED Contractor must verify all dimensions on site before commencing Do not scale drawings.

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ATRIUM

**FACADE - TOWER** CU:01 CURTAIN WALL WITH EXPRESSED VERTICAL & HORIZONTAL FINS WITH GLASS SPANDREL

CU:02 CURTAIN WALL WITH EXPRESSED VERTICAL & HORIZONTAL FINS WITH METAL SPANDREL

CU:03 CURTAIN WALL WITH FOLDED ALUMINIUM CLADDING

CU:04 CURTAIN WALL WITH EXPRESSED VERTICAL & HORIZONTAL FINS WITH GLASS & METAL SPANDREL

CU:05 PREFINISHED FIBRE CEMENT PANEL

CU:06 CURTAIN WALL WITH EXPRESSED VERTICAL & HORIZONTAL FINS WITH GLASS & METAL SPANDREL

CU:07 CURTAIN WALL WITH ARCHITECTURAL LOUVRE AND PROFILED METAL

(WD:20) STRUCTURAL GLAZED FRAMED WINDOWS

WD:21 ATRIUM SKYLIGHT WITH PERFORMANCE SHADING GLAZED

# FACADE - PODIUM NORTH

CD:01 CERAMIC CLADDING - INTERNAL WALL:
BLOCKWALL GRD LVL & METAL FRAME L1 & ABOVE WD:01) SHOPFRONT WINDOW WITH METAL REVEAL

WD:02 REVOLVING DOOR WITH LIGHT FRAME (WD:03) PODIUM LANEWAY OPERABLE SHOPFRONT GLAZING

(WD:20) STRUCTURAL GLAZED FRAMED WINDOWS

WD:22 PRE-FINISHED FIBRE CEMENT PANELS LINING THE SHAFTS

# FACADE - PODIUM SOUTH

CD:02 FACE BRICK - INTERNAL WALL: BLOCKWALL GRD LVL & METAL FRAME L1 & ABOVE

WD:10 SHOP FRONT GLAZING WITH EXPRESSED POWDERCOATED STEEL FRAMED

WD:11 OPERABLE SHOP FRONT GLAZING WITH EXPRESSED POWDERCOATED STEEL FRAMED

**CORE** 

# CD:03 SOLID FOLDED METAL PANEL

CD:20 COMPRESSED FIBRE CEMENT PANEL

CU:08 CURTAIN WALL WINDOW WITH GLASS SPANDREL AND SMOKE RELIEF LOUVRES WHERE SHOWN (WD:30) CORE SLOT WINDOW

**AWNINGS & CANOPIES** 

(AW:01) NORTH RETAIL AWNING

(AW:02) NORTH FOYER ENTRY CANOPY


(AW:03) SOUTH RETAIL AWNING

CP:01 ROOF TERRACE GLAZED CANOPY WITH PAINTED STEEL FRAME **EXTERNAL SOFFIT** 

# (CL:01) LANEWAY CEILING

**METALWORK** 

MW:01 FABRICATED ALUMINIUM PLANTER POWDERCOAT FINISH

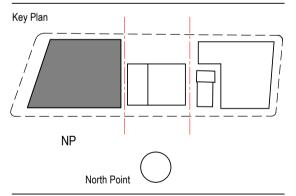










WATERLOO METRO QUARTER DEVELOPMENT

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SSD10440 BUILDING 1 - CU02 TOWER FACADE **DETAILS** 

FOR APPROVAL

Sheet number WMQ-BLD1-WBG-AR-DRG-DA142 E

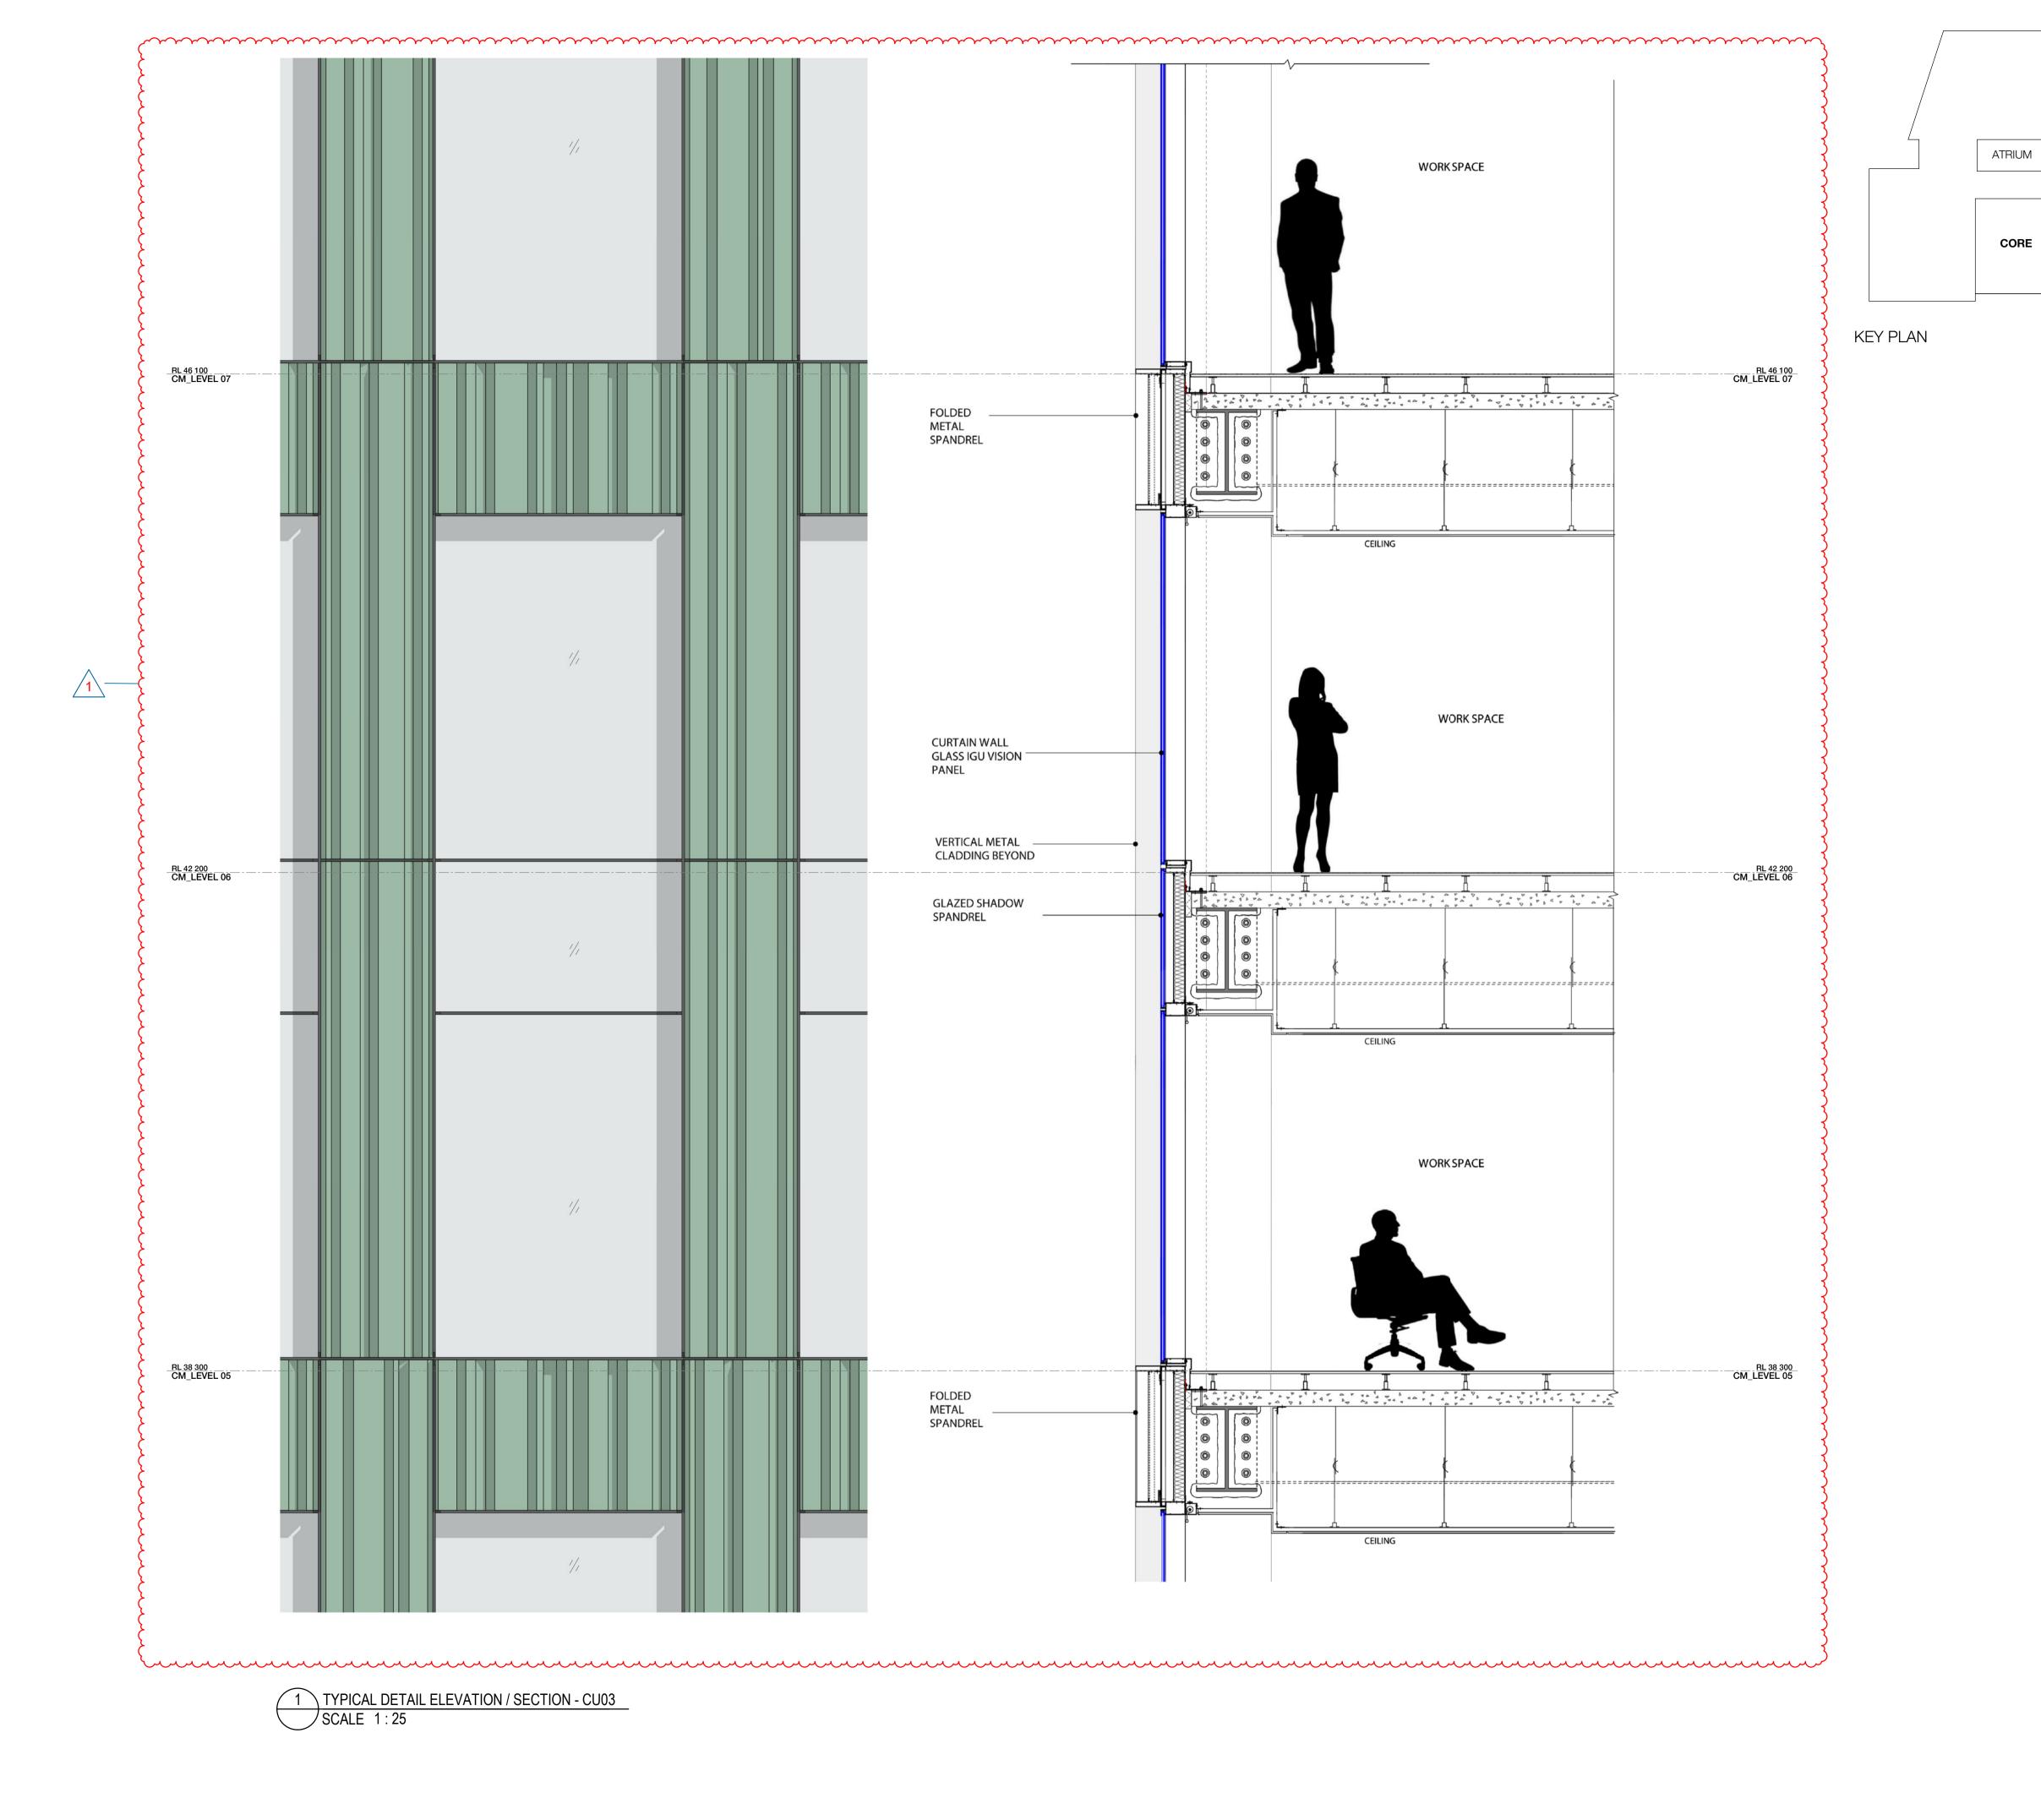

Recent revision history FOR INFORMATION (DA) FOR APPROVAL FOR APPROVAL FOR APPROVAL FOR APPROVAL Current Revision Amendments # Mark Comments E 1 FLOOR TO FLOOR HEIGHT REDUCED No material may be reproduced without prior permission. Contractor must verify all dimensions on site before commencing

ATRIUM

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15.07.20

31.07.20 28.08.20

25.09.20

15.03.21

**FACADE - TOWER** CU:01 CURTAIN WALL WITH EXPRESSED VERTICAL & HORIZONTAL FINS WITH GLASS SPANDREL

CU:02 CURTAIN WALL WITH EXPRESSED VERTICAL & HORIZONTAL FINS WITH METAL SPANDREL

CU:03 CURTAIN WALL WITH FOLDED ALUMINIUM CLADDING

CU:04 CURTAIN WALL WITH EXPRESSED VERTICAL & HORIZONTAL FINS WITH GLASS & METAL SPANDREL

CU:05 PREFINISHED FIBRE CEMENT PANEL

CU:06 CURTAIN WALL WITH EXPRESSED VERTICAL & HORIZONTAL FINS WITH GLASS & METAL SPANDREL CU:07 CURTAIN WALL WITH ARCHITECTURAL LOUVRE AND PROFILED METAL

(WD:20) STRUCTURAL GLAZED FRAMED WINDOWS

WD:21 ATRIUM SKYLIGHT WITH PERFORMANCE SHADING GLAZED

# FACADE - PODIUM NORTH

CD:01 CERAMIC CLADDING - INTERNAL WALL:
BLOCKWALL GRD LVL & METAL FRAME L1 & ABOVE WD:01 SHOPFRONT WINDOW WITH METAL REVEAL

WD:02 REVOLVING DOOR WITH LIGHT FRAME (WD:03) PODIUM LANEWAY OPERABLE SHOPFRONT GLAZING

WD:20 STRUCTURAL GLAZED FRAMED WINDOWS

WD:22 PRE-FINISHED FIBRE CEMENT PANELS LINING THE SHAFTS

### FACADE - PODIUM SOUTH

CD:02 FACE BRICK - INTERNAL WALL: BLOCKWALL GRD LVL & METAL FRAME L1 & ABOVE

WD:10 SHOP FRONT GLAZING WITH EXPRESSED POWDERCOATED STEEL FRAMED

WD:11 OPERABLE SHOP FRONT GLAZING WITH EXPRESSED POWDERCOATED STEEL FRAMED

CD:03 SOLID FOLDED METAL PANEL CD:20 COMPRESSED FIBRE CEMENT PANEL

CU:08 CURTAIN WALL WINDOW WITH GLASS

SPANDREL AND SMOKE RELIEF LOUVRES WHERE SHOWN (WD:30) CORE SLOT WINDOW

**AWNINGS & CANOPIES** 

(AW:01) NORTH RETAIL AWNING

(AW:02) NORTH FOYER ENTRY CANOPY

(AW:03) SOUTH RETAIL AWNING


CP:01 ROOF TERRACE GLAZED CANOPY WITH PAINTED STEEL FRAME

**EXTERNAL SOFFIT** 

# CL:01 LANEWAY CEILING

METALWORK

MW:01 FABRICATED ALUMINIUM PLANTER POWDERCOAT FINISH

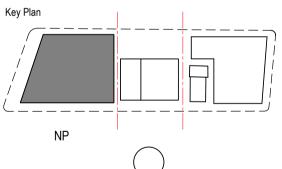

North Point







WATERLOO METRO QUARTER DEVELOPMENT


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SSD10440

BUILDING 1 - CU03 TOWER FACADE **DETAILS** 

FOR APPROVAL

Sheet number WMQ-BLD1-WBG-AR-DRG-DA143 E

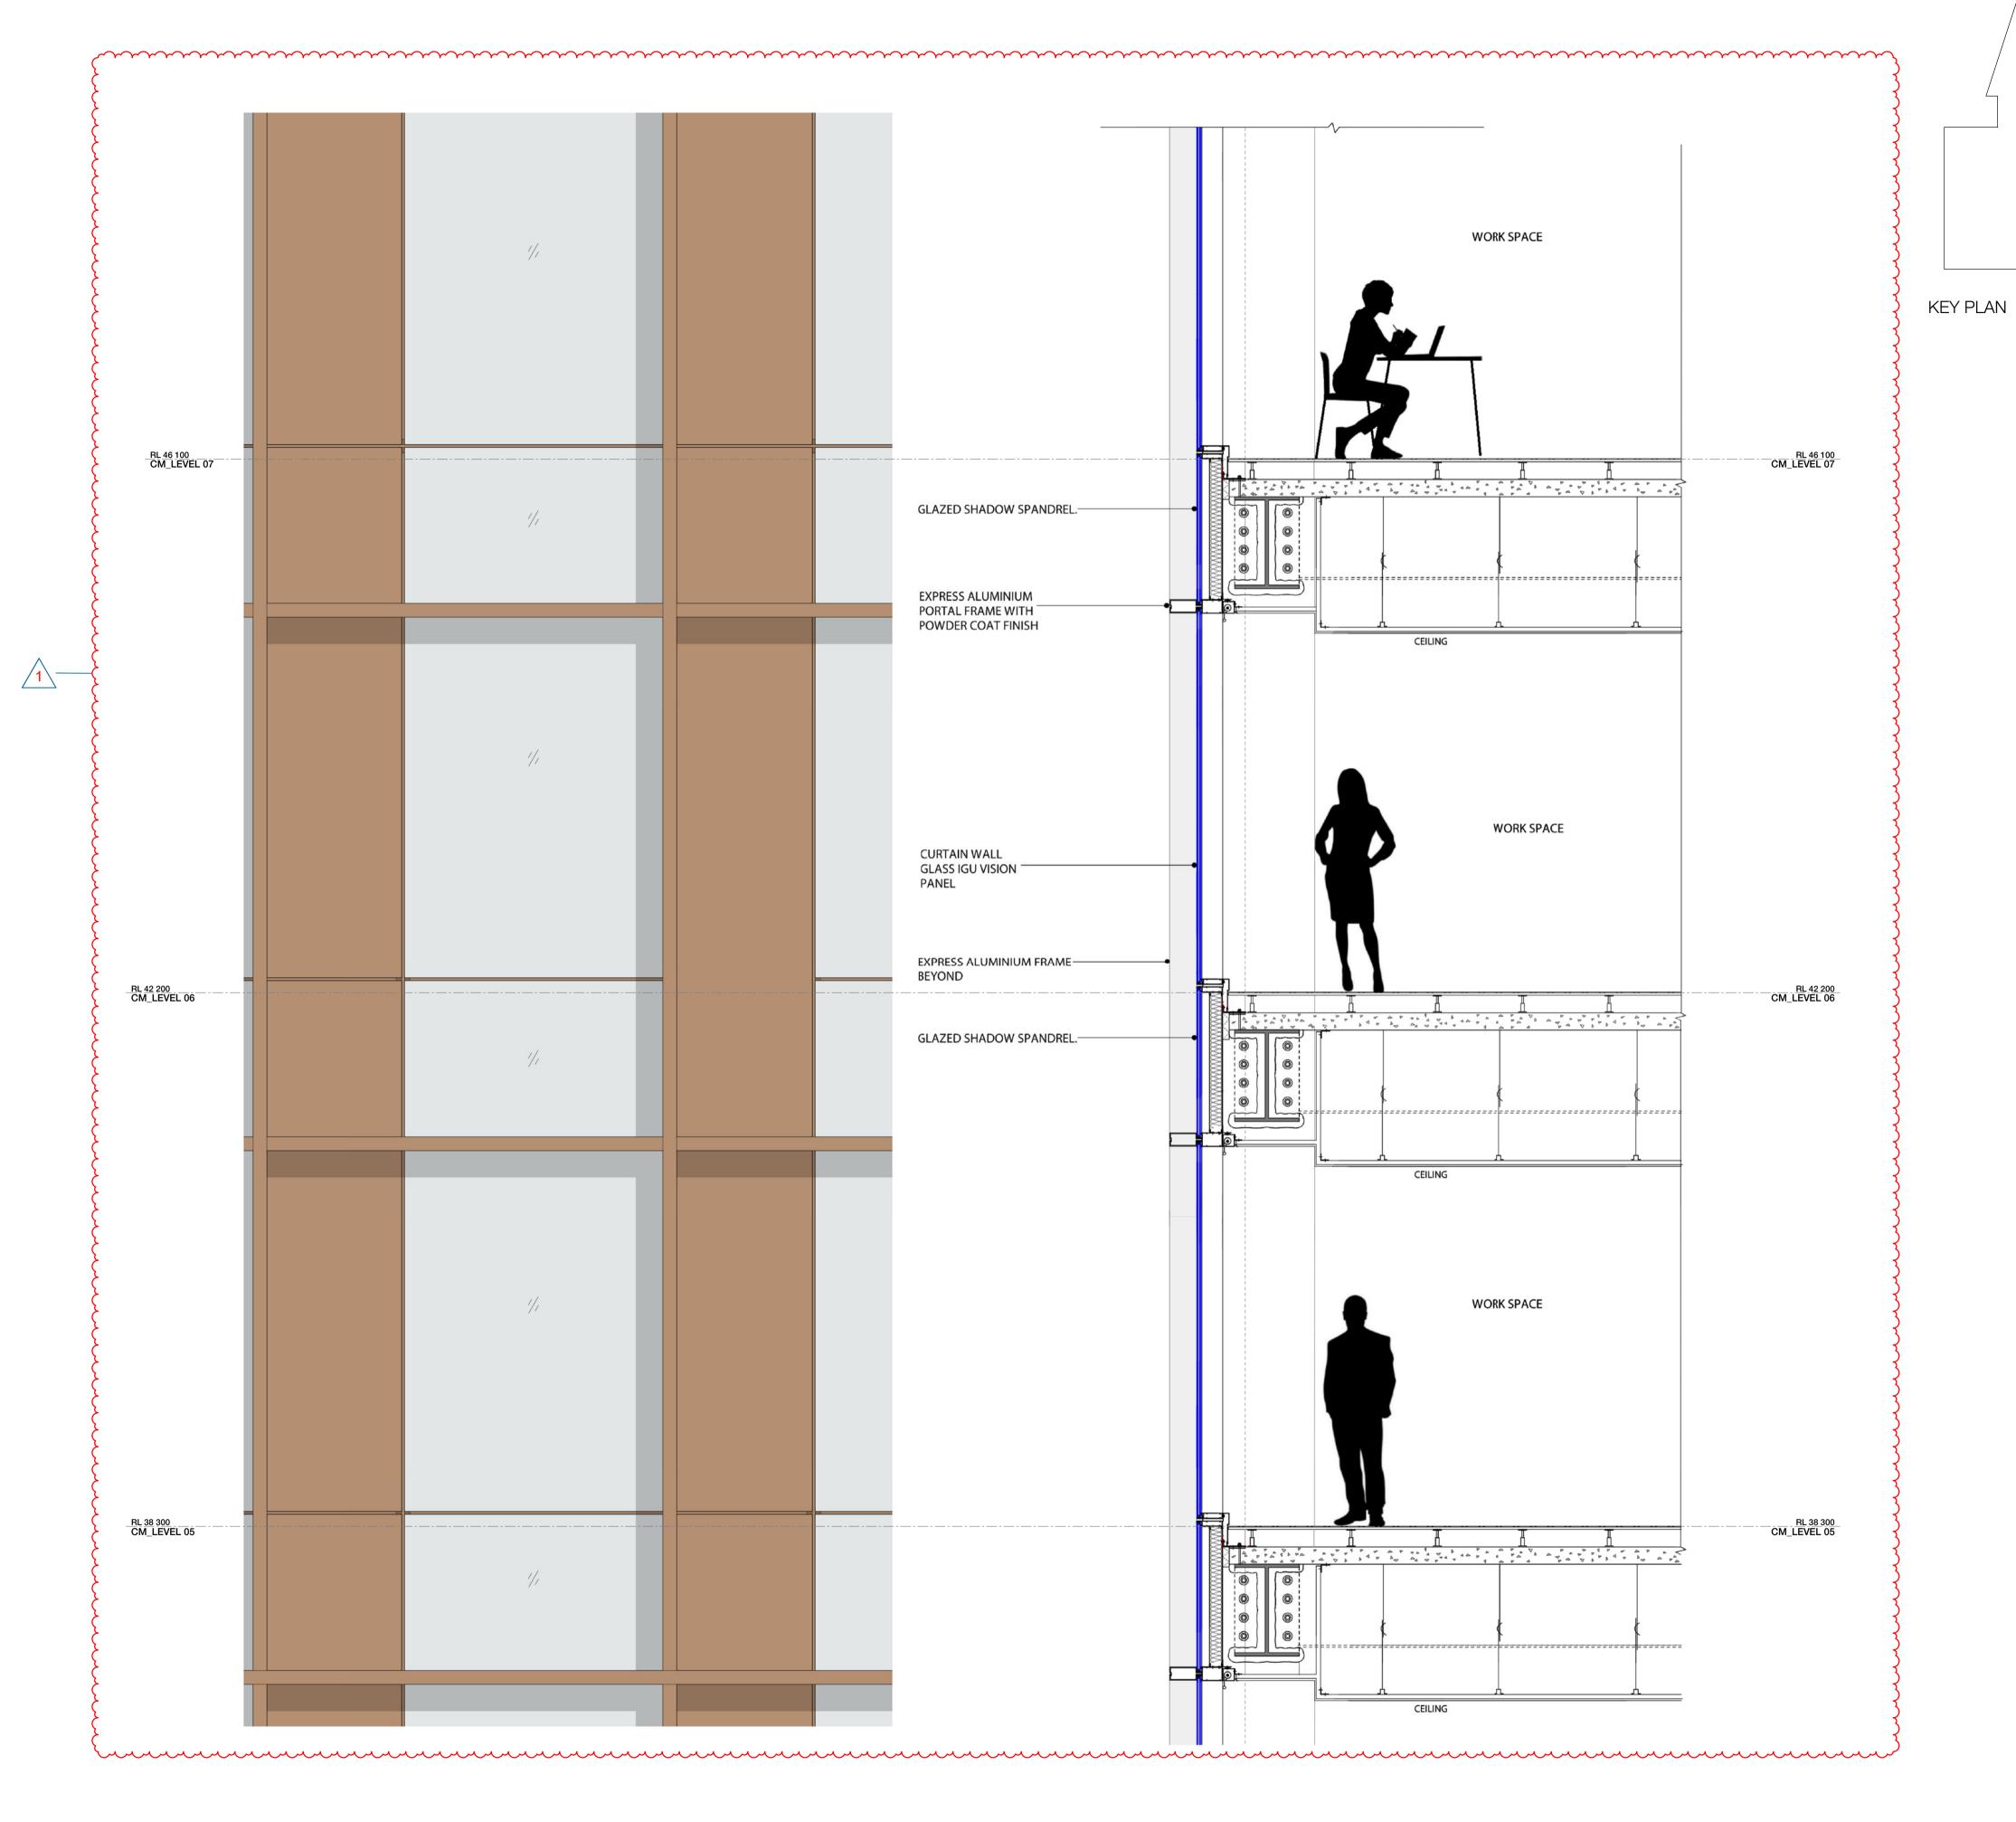

1 TYPICAL DETAIL ELEVATION / SECTION - CU04 SCALE 1:25

Recent revision history # Status FOR INFORMATION (DA) 15.07.20 FOR APPROVAL 31.07.20 FOR APPROVAL 28.08.20 FOR APPROVAL 25.09.20 FOR APPROVAL 15.03.21

Current Revision Amendments

# Mark Comments E 1 FLOOR TO FLOOR HEIGHT REDUCED

ATRIUM

CORE

ATRIUM

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**FACADE - TOWER** 

CU:01 CURTAIN WALL WITH EXPRESSED VERTICAL & HORIZONTAL FINS WITH GLASS SPANDREL CU:02 CURTAIN WALL WITH EXPRESSED VERTICAL & HORIZONTAL FINS WITH METAL SPANDREL

CU:03 CURTAIN WALL WITH FOLDED ALUMINIUM CLADDING

CU:04 CURTAIN WALL WITH EXPRESSED VERTICAL & HORIZONTAL FINS WITH GLASS & METAL SPANDREL

CU:05 PREFINISHED FIBRE CEMENT PANEL

CU:06 CURTAIN WALL WITH EXPRESSED VERTICAL & HORIZONTAL FINS WITH GLASS & METAL SPANDREL

CU:07 CURTAIN WALL WITH ARCHITECTURAL LOUVRE AND PROFILED METAL

(WD:20) STRUCTURAL GLAZED FRAMED WINDOWS

WD:21 ATRIUM SKYLIGHT WITH PERFORMANCE SHADING GLAZED

FACADE - PODIUM NORTH

CD:01 CERAMIC CLADDING - INTERNAL WALL:
BLOCKWALL GRD LVL & METAL FRAME L1 & ABOVE

WD:01) SHOPFRONT WINDOW WITH METAL REVEAL

WD:02 REVOLVING DOOR WITH LIGHT FRAME (WD:03) PODIUM LANEWAY OPERABLE SHOPFRONT GLAZING

(WD:20) STRUCTURAL GLAZED FRAMED WINDOWS

WD:22 PRE-FINISHED FIBRE CEMENT PANELS LINING THE SHAFTS

FACADE - PODIUM SOUTH

CD:02 FACE BRICK - INTERNAL WALL: BLOCKWALL GRD LVL & METAL FRAME L1 & ABOVE

WD:10 SHOP FRONT GLAZING WITH EXPRESSED POWDERCOATED STEEL FRAMED

WD:11 OPERABLE SHOP FRONT GLAZING WITH EXPRESSED POWDERCOATED STEEL FRAMED

**CORE** 

CD:03 SOLID FOLDED METAL PANEL

CD:20 COMPRESSED FIBRE CEMENT PANEL

CU:08 CURTAIN WALL WINDOW WITH GLASS SPANDREL AND SMOKE RELIEF LOUVRES WHERE SHOWN

(WD:30) CORE SLOT WINDOW

**AWNINGS & CANOPIES** (AW:01) NORTH RETAIL AWNING

(AW:02) NORTH FOYER ENTRY CANOPY

(AW:03) SOUTH RETAIL AWNING

CP:01 ROOF TERRACE GLAZED CANOPY WITH PAINTED STEEL FRAME

**EXTERNAL SOFFIT** 

CL:01 LANEWAY CEILING **METALWORK** 

MW:01 FABRICATED ALUMINIUM PLANTER POWDERCOAT FINISH







WATERLOO METRO QUARTER DEVELOPMENT


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YT	PM	A1	As indicated


SSD10440

BUILDING 1 - CU04 TOWER FACADE **DETAILS** 


FOR APPROVAL

WMQ-BLD1-WBG-AR-DRG-DA144 E

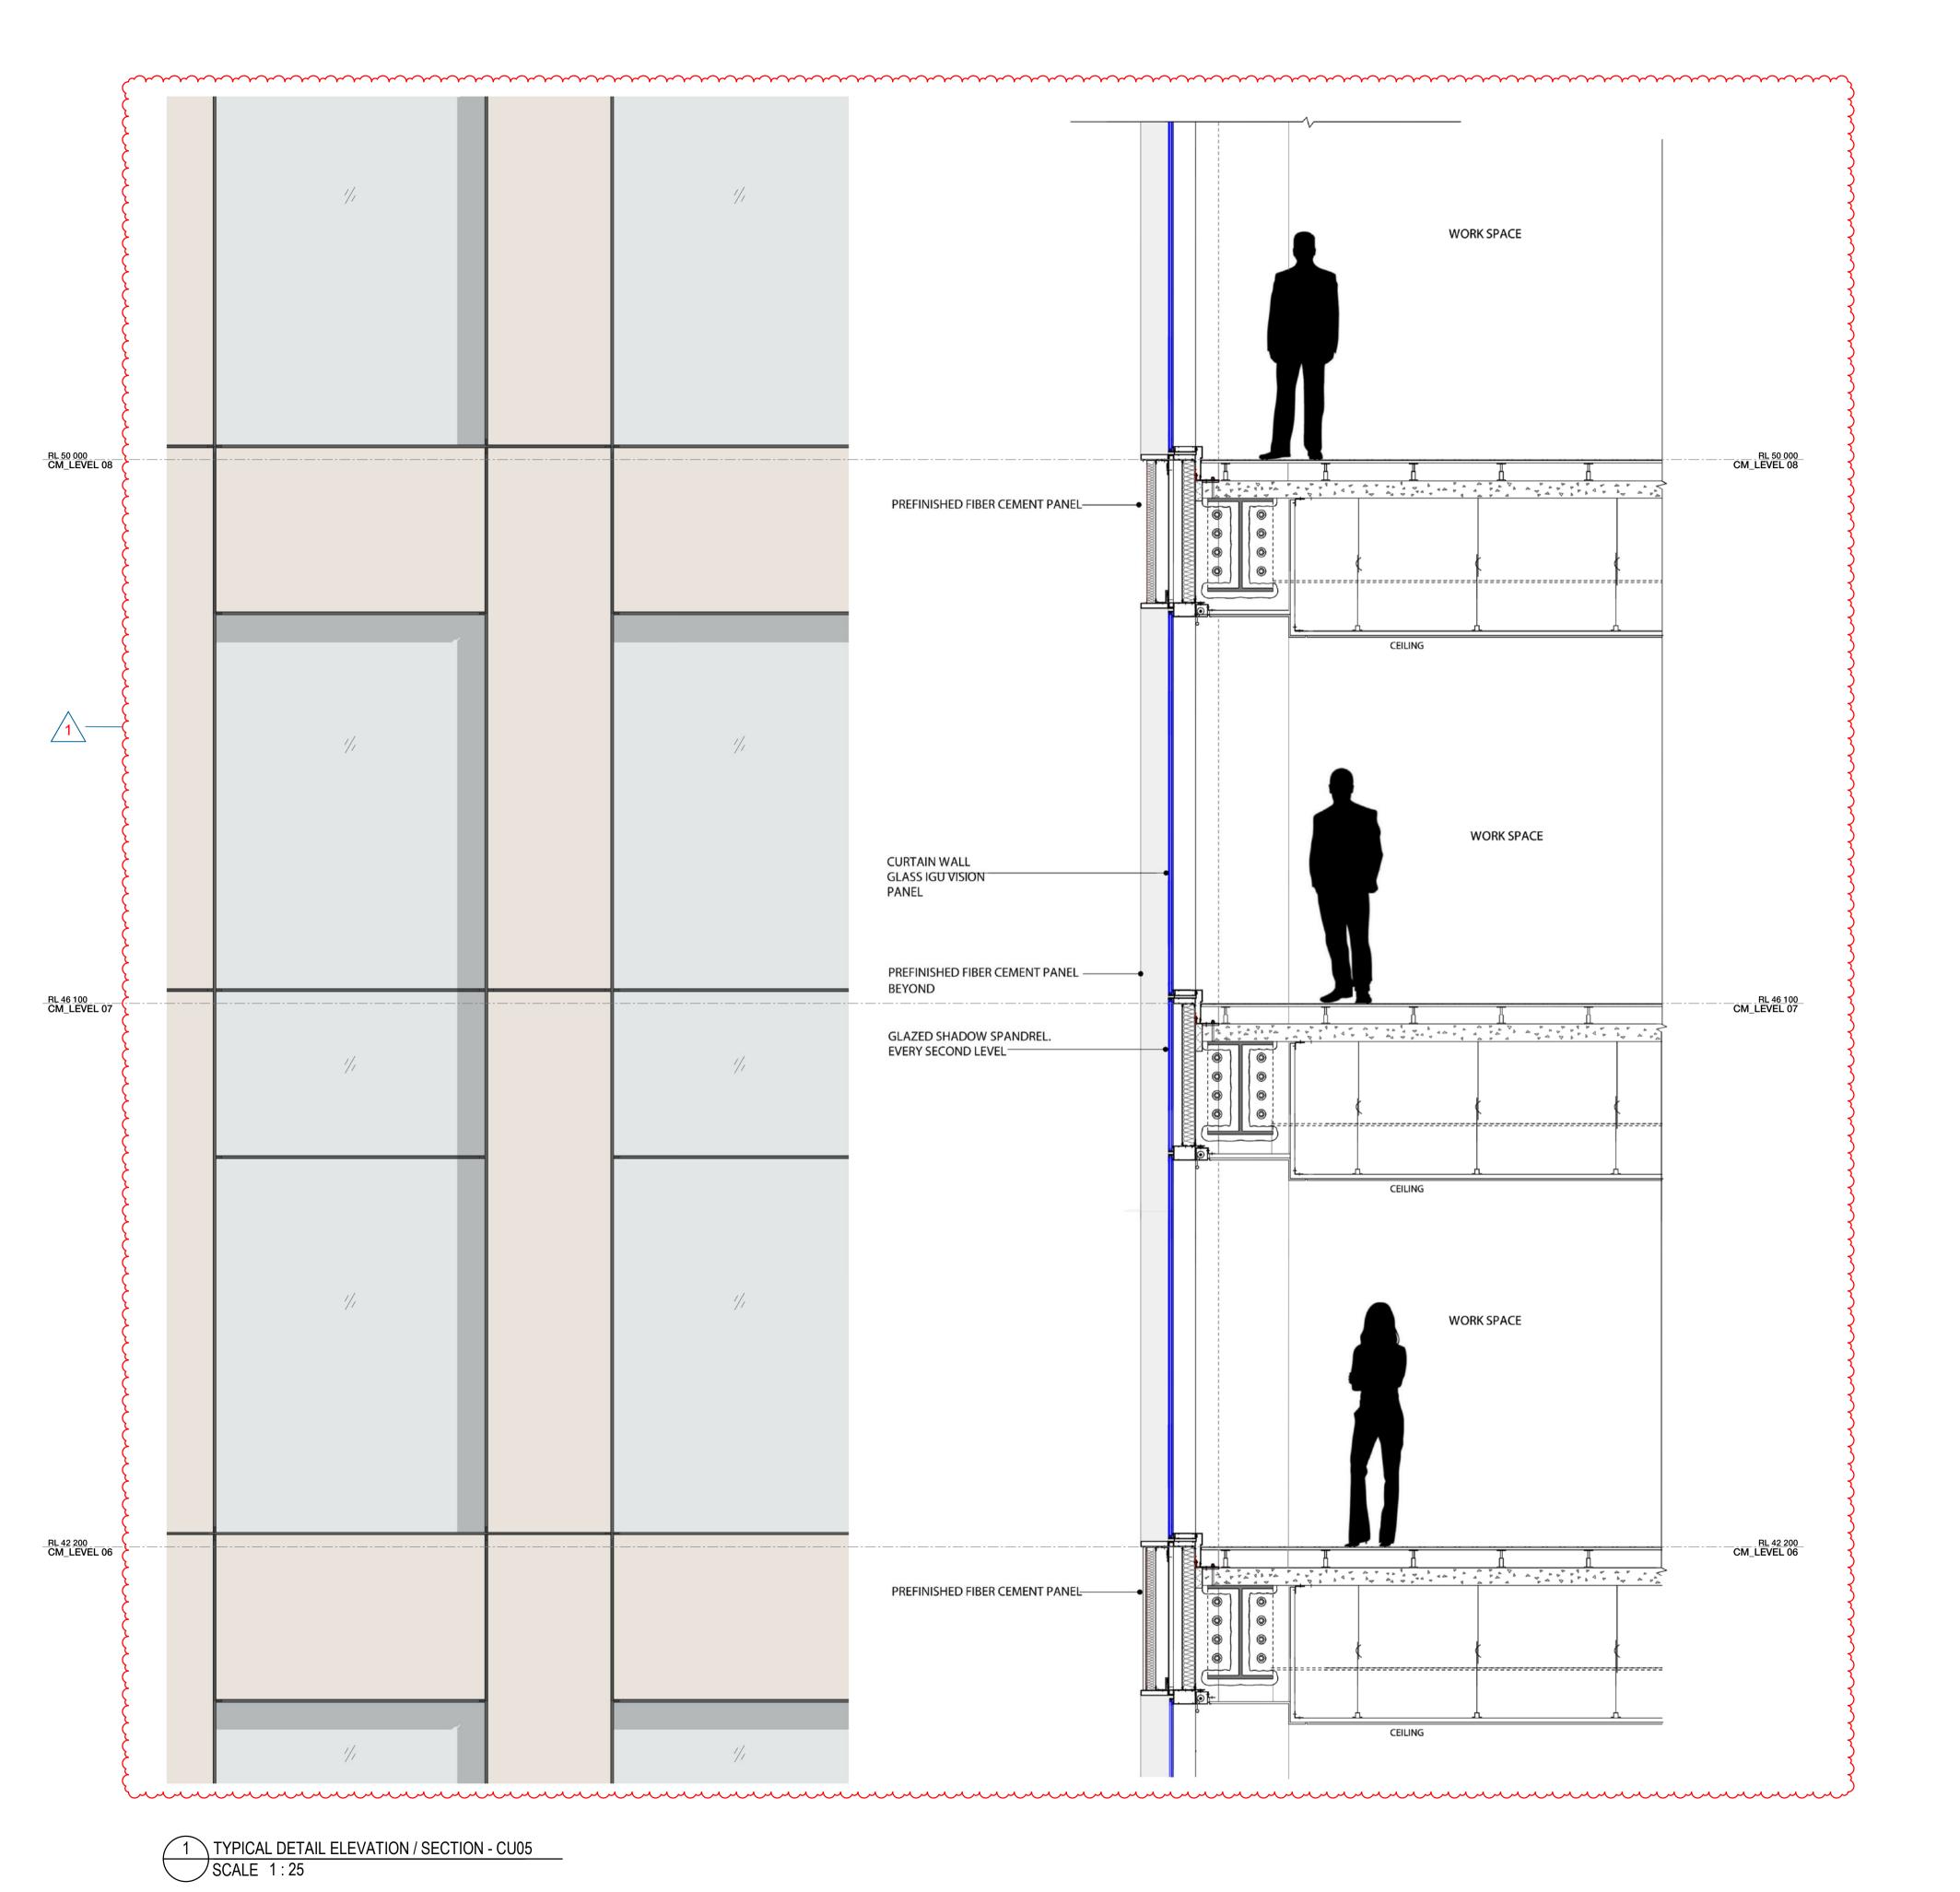

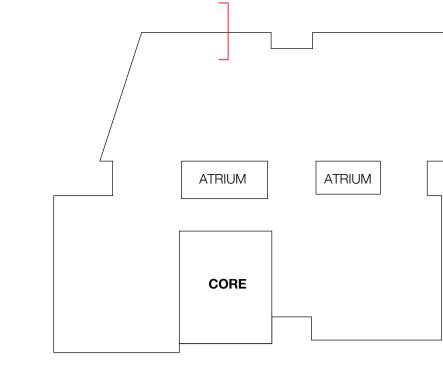

KEY PLAN

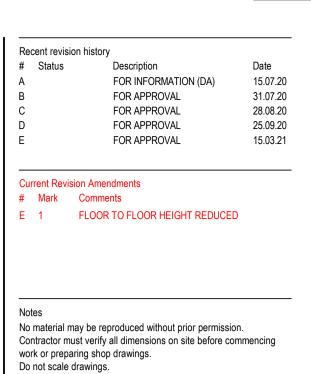

CU:01 CURTAIN WALL WITH EXPRESSED VERTICAL & HORIZONTAL FINS WITH GLASS SPANDREL

CU:02 CURTAIN WALL WITH EXPRESSED VERTICAL & HORIZONTAL FINS WITH METAL SPANDREL

CU:04 CURTAIN WALL WITH EXPRESSED VERTICAL & HORIZONTAL FINS WITH GLASS & METAL SPANDREL

CU:06 CURTAIN WALL WITH EXPRESSED VERTICAL & HORIZONTAL FINS WITH GLASS & METAL SPANDREL

CD:01 CERAMIC CLADDING - INTERNAL WALL:
BLOCKWALL GRD LVL & METAL FRAME L1 & ABOVE

(WD:03) PODIUM LANEWAY OPERABLE SHOPFRONT GLAZING

WD:01 SHOPFRONT WINDOW WITH METAL REVEAL
WD:02 REVOLVING DOOR WITH LIGHT FRAME

(WD:20) STRUCTURAL GLAZED FRAMED WINDOWS

WD:10 SHOP FRONT GLAZING WITH EXPRESSED POWDERCOATED STEEL FRAMED

WD:11 OPERABLE SHOP FRONT GLAZING WITH

CD:20 COMPRESSED FIBRE CEMENT PANEL
CU:08 CURTAIN WALL WINDOW WITH GLASS

CD:03 SOLID FOLDED METAL PANEL

WHERE SHOWN

WD:22 PRE-FINISHED FIBRE CEMENT PANELS LINING THE SHAFTS

CD:02 FACE BRICK - INTERNAL WALL: BLOCKWALL GRD LVL & METAL FRAME L1 & ABOVE

EXPRESSED POWDERCOATED STEEL FRAMED

SPANDREL AND SMOKE RELIEF LOUVRES

CU:07 CURTAIN WALL WITH ARCHITECTURAL LOUVRE AND PROFILED METAL

(WD:20) STRUCTURAL GLAZED FRAMED WINDOWS

WD:21 ATRIUM SKYLIGHT WITH PERFORMANCE SHADING GLAZED

FACADE - PODIUM NORTH

FACADE - PODIUM SOUTH

CU:03 CURTAIN WALL WITH FOLDED ALUMINIUM CLADDING

CU:05 PREFINISHED FIBRE CEMENT PANEL

**FACADE - TOWER** 

WD:30 CORE SLOT WINDOW

AWNINGS & CANOPIES

AW:01 NORTH RETAIL AWNING

AW:02 NORTH FOYER ENTRY CANOPY

AW:03 SOUTH RETAIL AWNING

CP:01 ROOF TERRACE GLAZED CANOPY WITH PAINTED STEEL FRAME

EXTERNAL SOFFIT

CL:01 LANEWAY CEILING

METALWORK

MW:01 FABRICATED ALUMINIUM PLANTER POWDERCOAT FINISH

Key Plan

NP

North Point

Client

Waterloo Integrated Station Development

A Joint Venture Project

JOHN
HOLLAND

MITVAC

WATERLOO METRO QUARTER DEVELOPMENT

**WOODS BAGOT** 

Project number Size check

121234


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YT PM A1 As indicated

Sheet title
SSD10440
BUILDING 1 - CU05 TOWER FACADE
DETAILS

Status FOR APPROVAL

WMQ-BLD1-WBG-AR-DRG-DA145 E

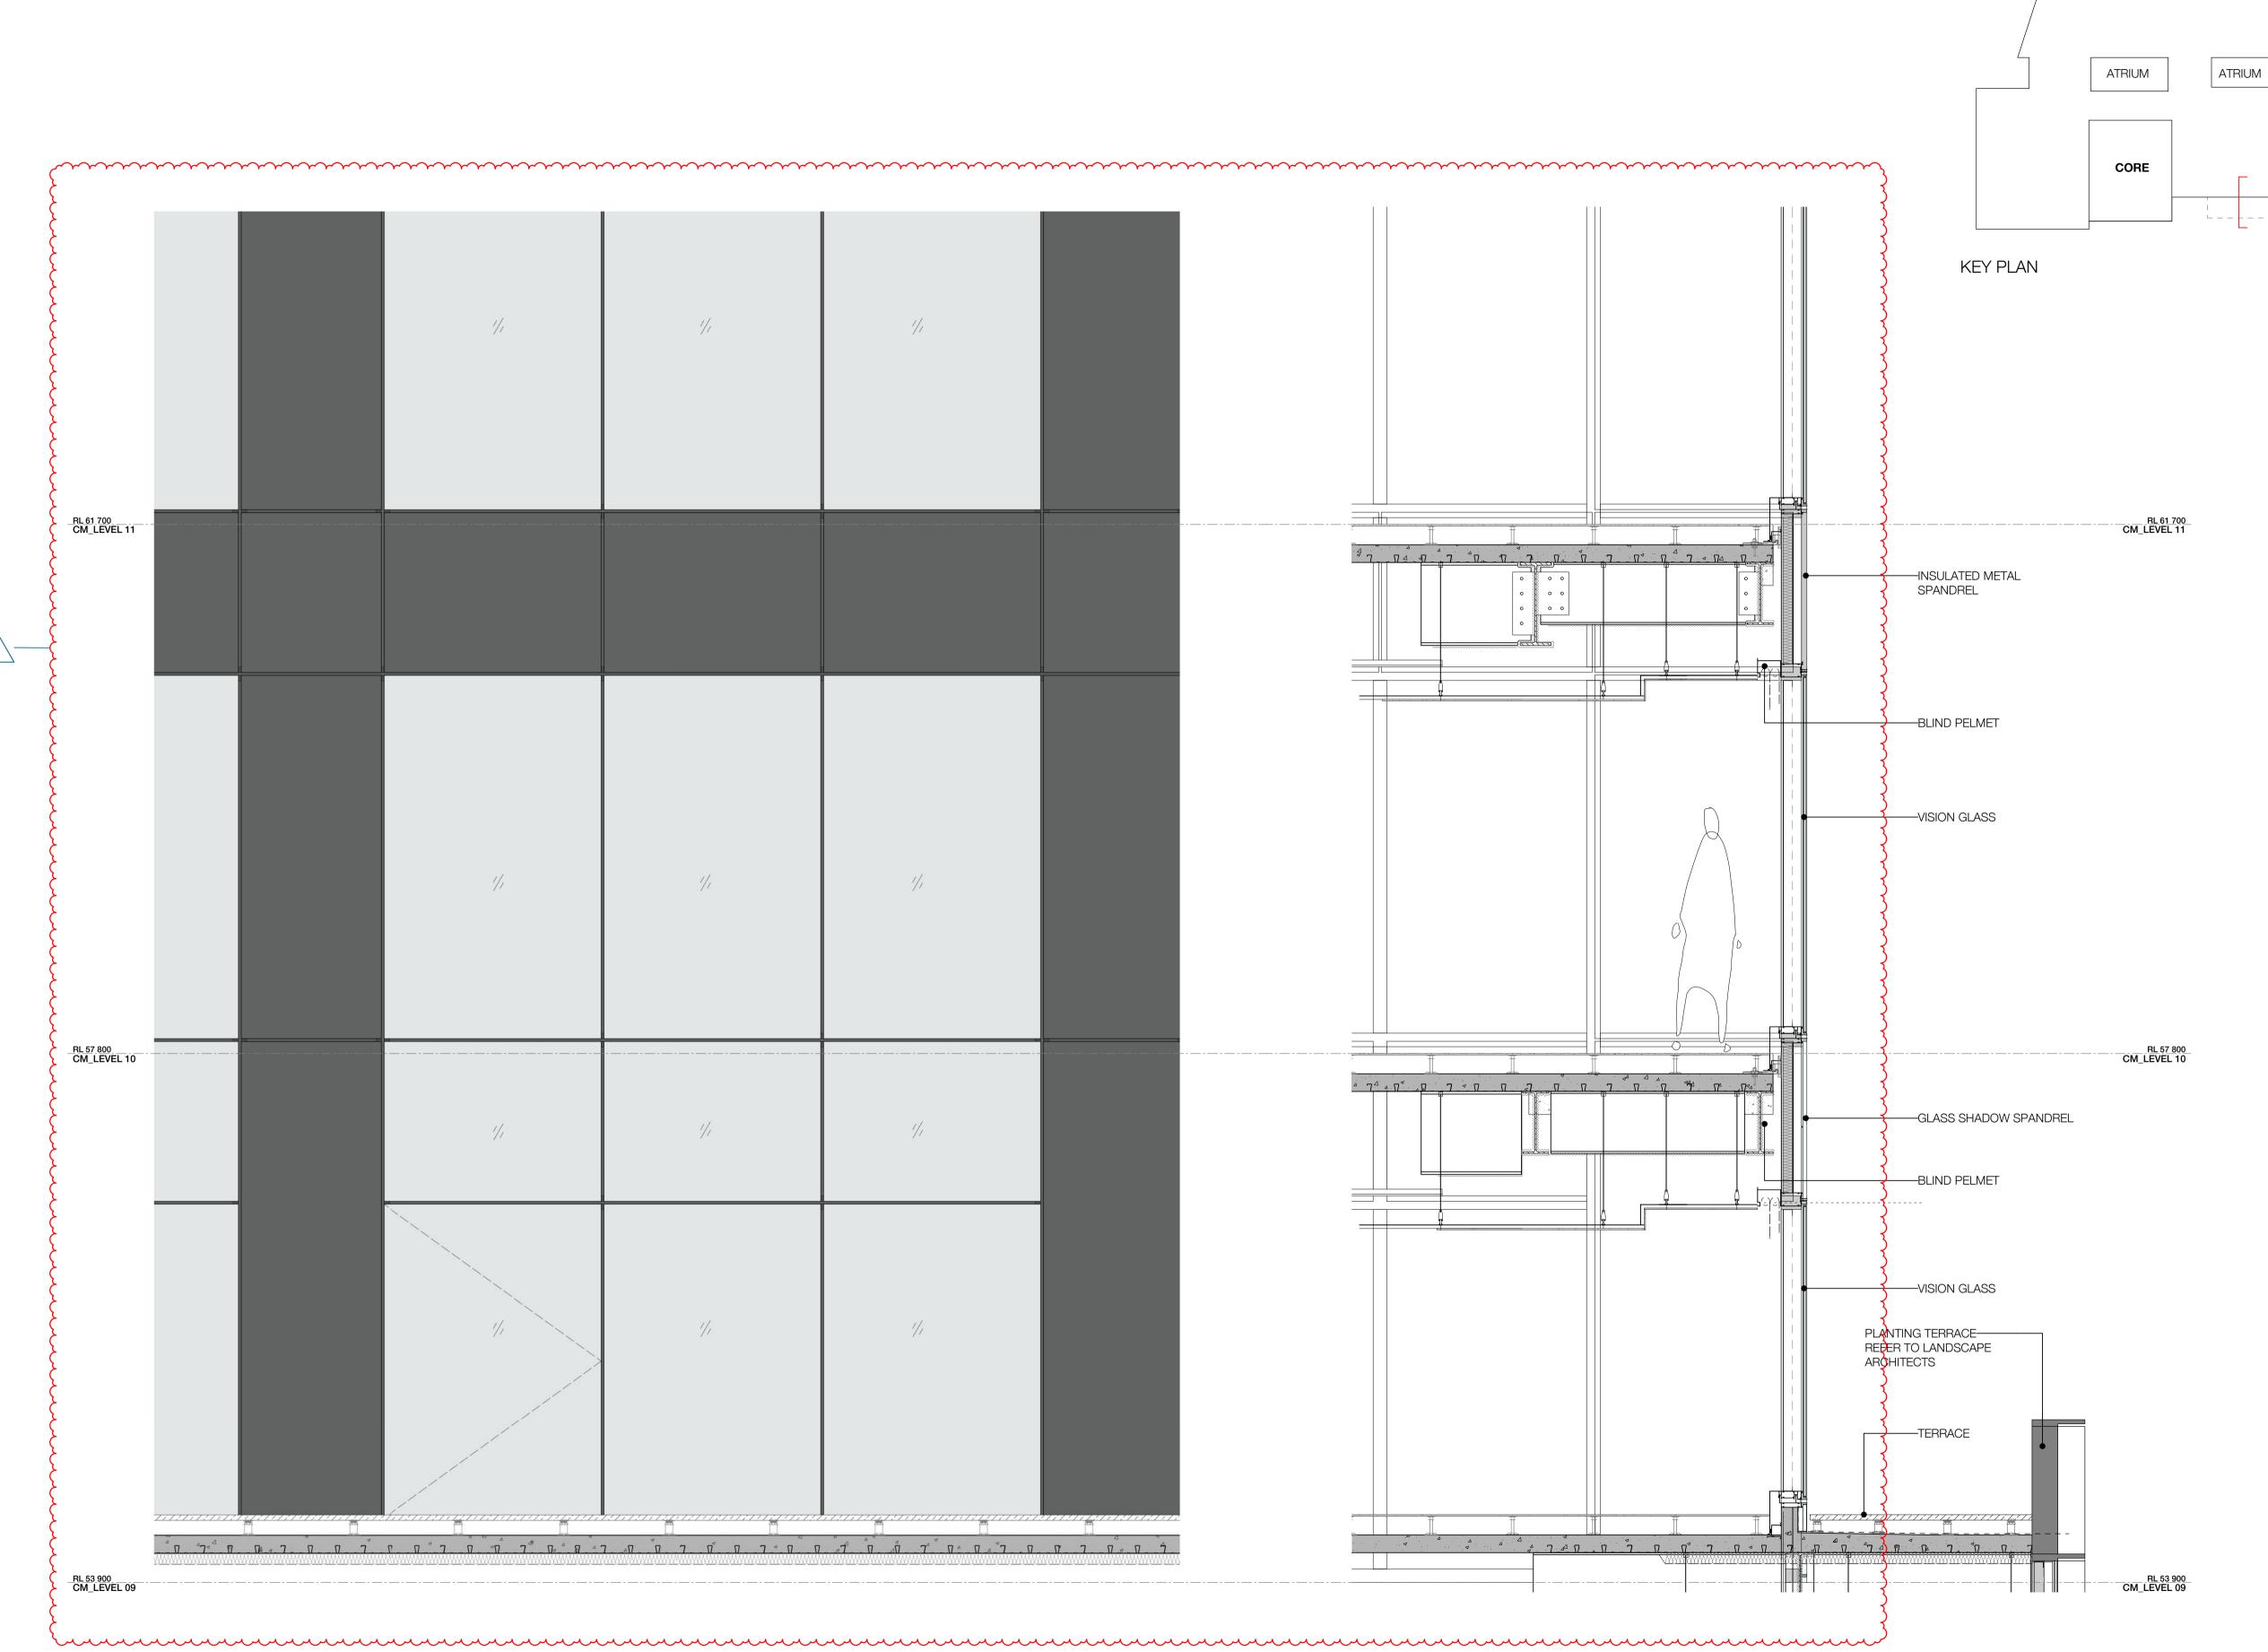

Recent revision history # Status FOR INFORMATION (DA) 15.07.20 FOR APPROVAL 31.07.20 FOR APPROVAL 28.08.20 FOR APPROVAL 25.09.20 FOR APPROVAL 15.03.21

Current Revision Amendments

# Mark Comments E 1 FLOOR TO FLOOR HEIGHT REDUCED

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**FACADE - TOWER** CU:01 CURTAIN WALL WITH EXPRESSED VERTICAL & HORIZONTAL FINS WITH GLASS SPANDREL

CU:02 CURTAIN WALL WITH EXPRESSED VERTICAL & HORIZONTAL FINS WITH METAL SPANDREL

CU:03 CURTAIN WALL WITH FOLDED ALUMINIUM CLADDING

CU:04 CURTAIN WALL WITH EXPRESSED VERTICAL & HORIZONTAL FINS WITH GLASS & METAL SPANDREL

CU:05 PREFINISHED FIBRE CEMENT PANEL

CU:06 CURTAIN WALL WITH EXPRESSED VERTICAL & HORIZONTAL FINS WITH GLASS & METAL SPANDREL

CU:07 CURTAIN WALL WITH ARCHITECTURAL LOUVRE AND PROFILED METAL

(WD:20) STRUCTURAL GLAZED FRAMED WINDOWS

WD:21 ATRIUM SKYLIGHT WITH PERFORMANCE SHADING GLAZED

FACADE - PODIUM NORTH CD:01 CERAMIC CLADDING - INTERNAL WALL:
BLOCKWALL GRD LVL & METAL FRAME L1 & ABOVE

WD:01) SHOPFRONT WINDOW WITH METAL REVEAL

(WD:02) REVOLVING DOOR WITH LIGHT FRAME

(WD:03) PODIUM LANEWAY OPERABLE SHOPFRONT GLAZING (WD:20) STRUCTURAL GLAZED FRAMED WINDOWS

WD:22 PRE-FINISHED FIBRE CEMENT PANELS LINING THE SHAFTS

FACADE - PODIUM SOUTH

CD:02 FACE BRICK - INTERNAL WALL: BLOCKWALL GRD LVL & METAL FRAME L1 & ABOVE

WD:10 SHOP FRONT GLAZING WITH EXPRESSED POWDERCOATED STEEL FRAMED

WD:11 OPERABLE SHOP FRONT GLAZING WITH EXPRESSED POWDERCOATED STEEL FRAMED

**CORE** 

CD:03 SOLID FOLDED METAL PANEL CD:20 COMPRESSED FIBRE CEMENT PANEL

CU:08 CURTAIN WALL WINDOW WITH GLASS SPANDREL AND SMOKE RELIEF LOUVRES WHERE SHOWN

(WD:30) CORE SLOT WINDOW

**AWNINGS & CANOPIES** (AW:01) NORTH RETAIL AWNING

(AW:02) NORTH FOYER ENTRY CANOPY

(AW:03) SOUTH RETAIL AWNING


CP:01 ROOF TERRACE GLAZED CANOPY WITH PAINTED STEEL FRAME

**EXTERNAL SOFFIT** 

(CL:01) LANEWAY CEILING

**METALWORK** 

MW:01 FABRICATED ALUMINIUM PLANTER POWDERCOAT FINISH

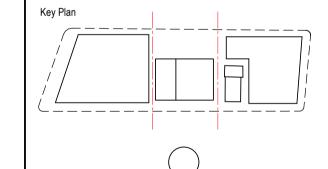









WATERLOO METRO QUARTER DEVELOPMENT


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As indicated


SSD10440 BUILDING 1 - CU06 TOWER FACADE **DETAILS** 

FOR APPROVAL

WMQ-BLD1-WBG-AR-DRG-DA146 E



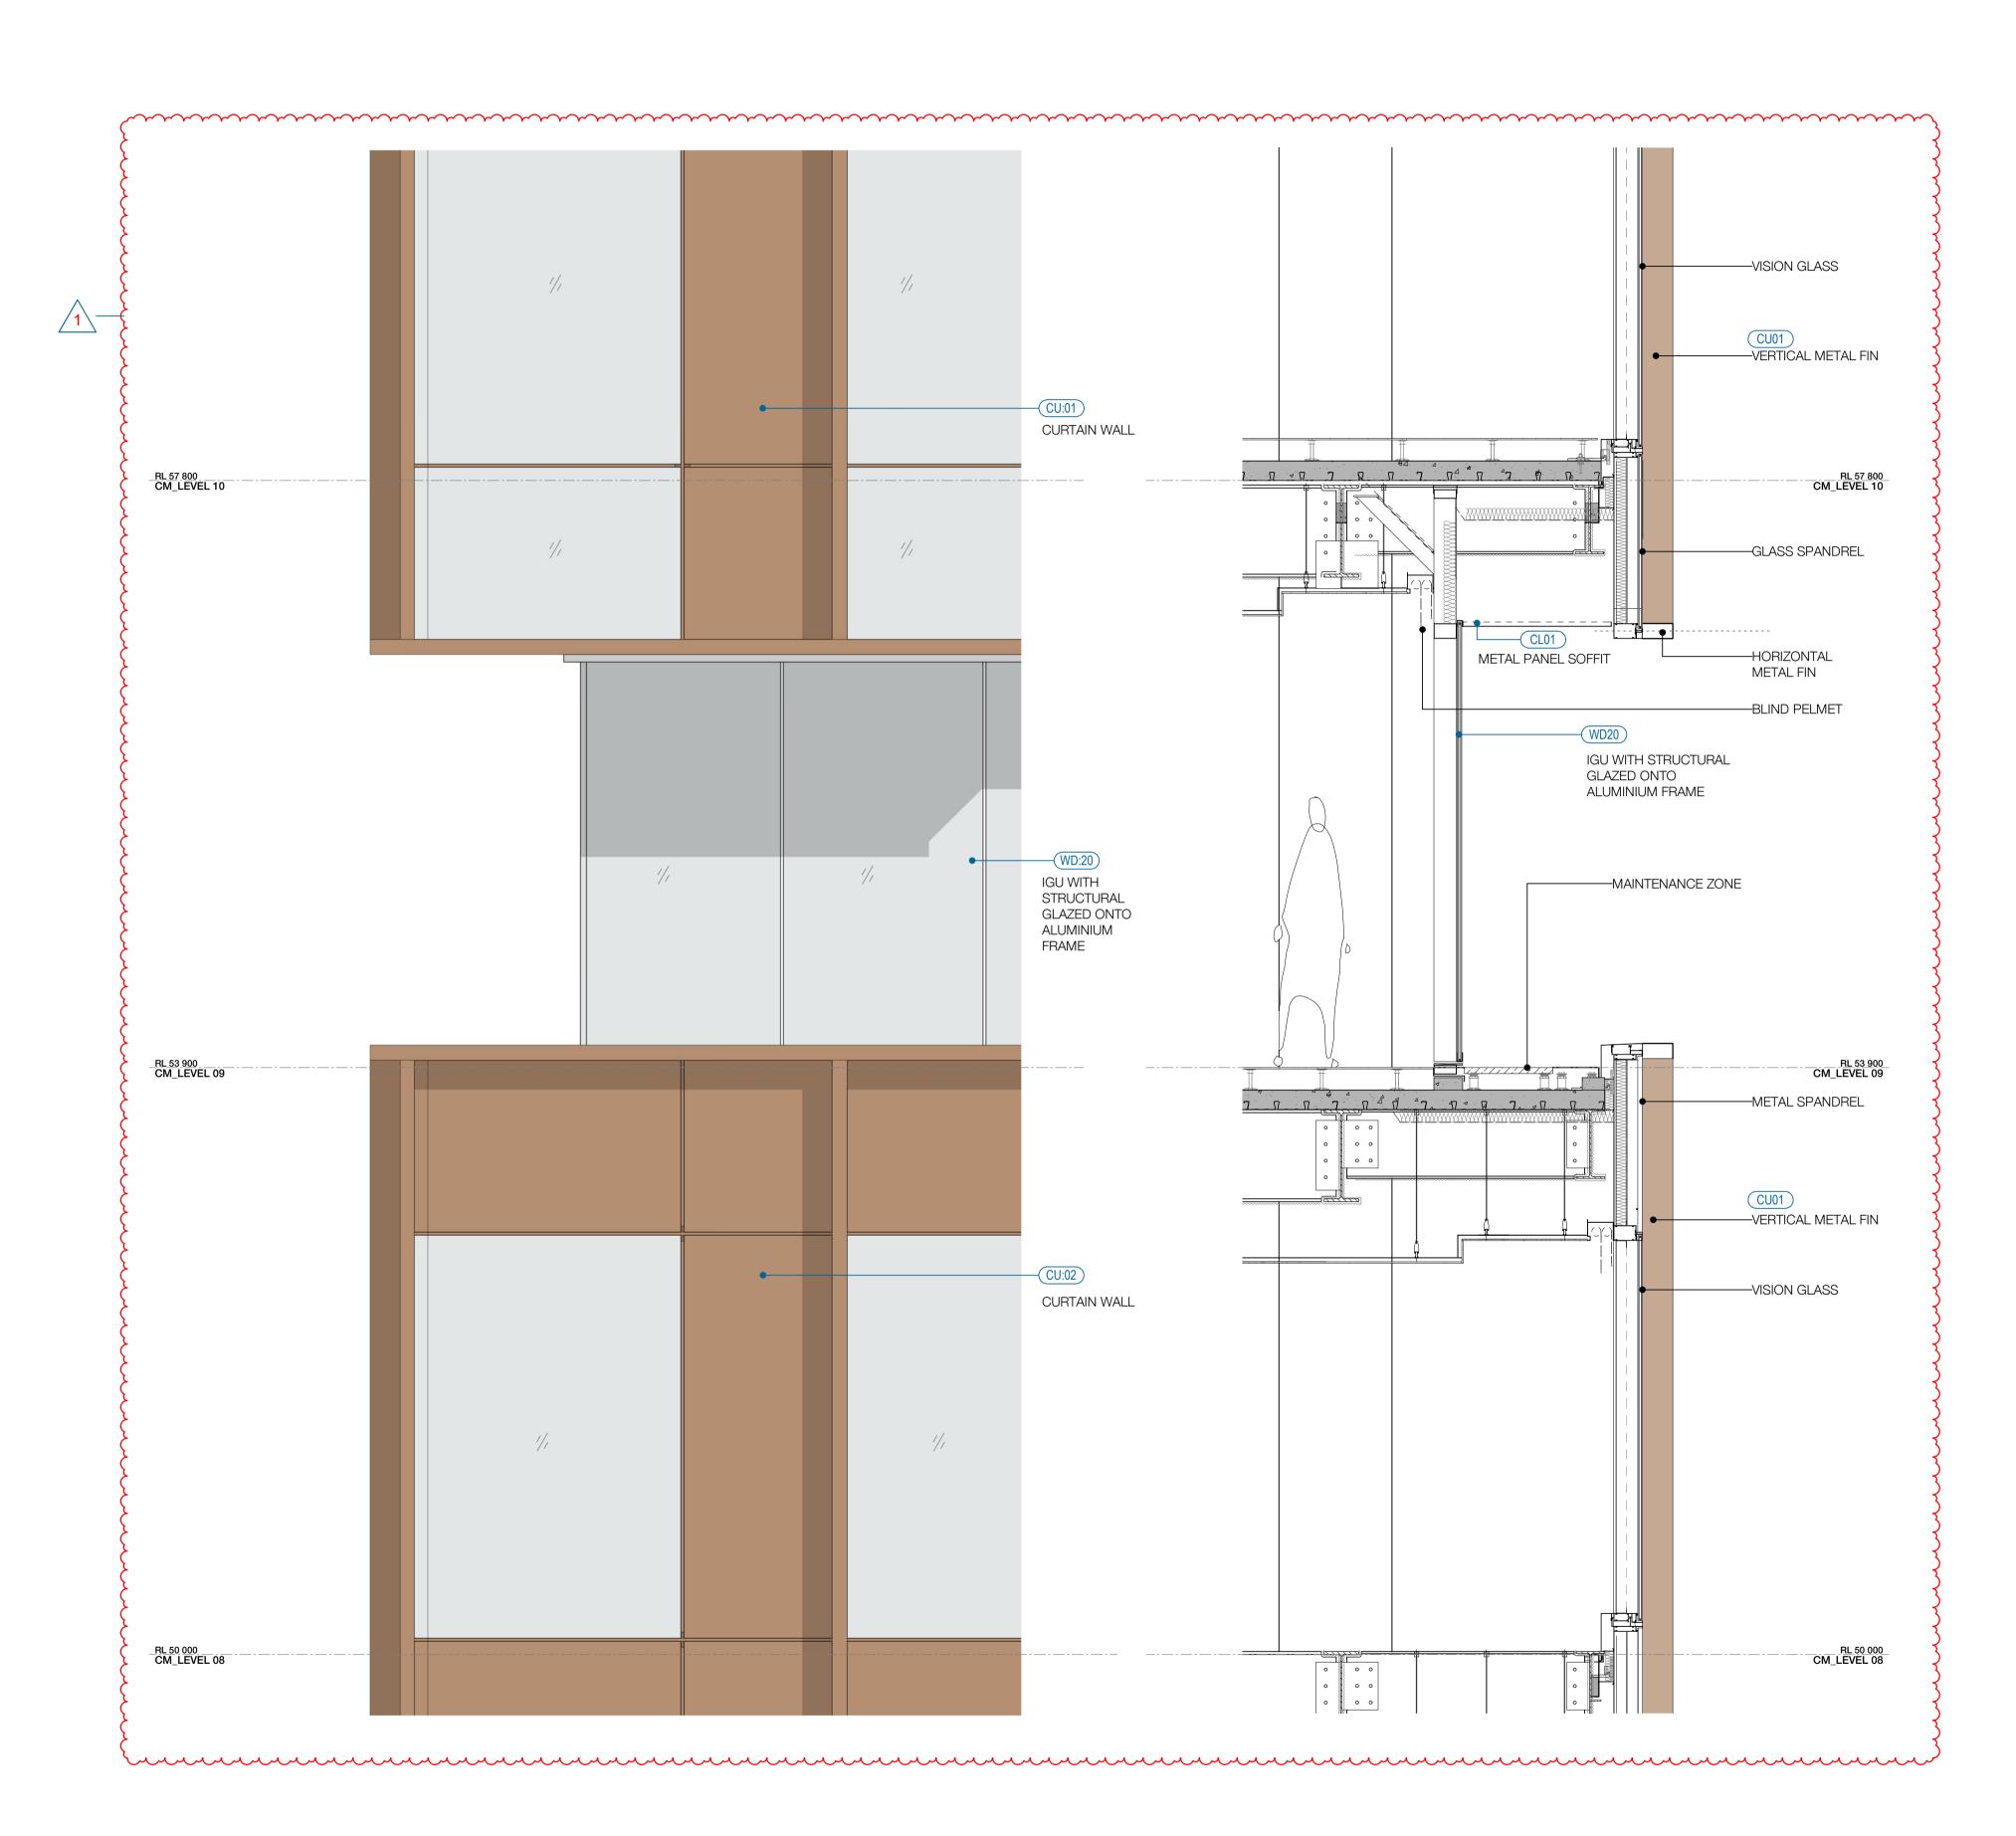

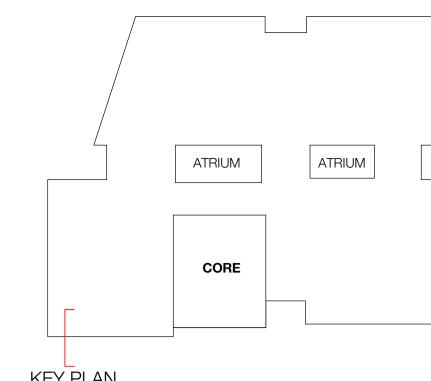

KEY PLAN

Recent revision history # Status FOR INFORMATION (DA) 15.07.20 FOR APPROVAL 31.07.20 FOR APPROVAL 28.08.20 FOR APPROVAL 25.09.20 FOR APPROVAL 15.03.21

> Current Revision Amendments # Mark Comments

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**FACADE - TOWER** 

CU:01 CURTAIN WALL WITH EXPRESSED VERTICAL & HORIZONTAL FINS WITH GLASS SPANDREL CU:02 CURTAIN WALL WITH EXPRESSED VERTICAL & HORIZONTAL FINS WITH METAL SPANDREL

CU:03 CURTAIN WALL WITH FOLDED ALUMINIUM CLADDING

CU:04 CURTAIN WALL WITH EXPRESSED VERTICAL & HORIZONTAL FINS WITH GLASS & METAL SPANDREL

CU:05 PREFINISHED FIBRE CEMENT PANEL

CU:06 CURTAIN WALL WITH EXPRESSED VERTICAL & HORIZONTAL FINS WITH GLASS & METAL SPANDREL

CU:07 CURTAIN WALL WITH ARCHITECTURAL LOUVRE AND PROFILED METAL

(WD:20) STRUCTURAL GLAZED FRAMED WINDOWS

WD:21 ATRIUM SKYLIGHT WITH PERFORMANCE SHADING GLAZED

FACADE - PODIUM NORTH

CD:01 CERAMIC CLADDING - INTERNAL WALL:
BLOCKWALL GRD LVL & METAL FRAME L1 & ABOVE

WD:01 SHOPFRONT WINDOW WITH METAL REVEAL

WD:02 REVOLVING DOOR WITH LIGHT FRAME (WD:03) PODIUM LANEWAY OPERABLE SHOPFRONT GLAZING

(WD:20) STRUCTURAL GLAZED FRAMED WINDOWS

WD:22 PRE-FINISHED FIBRE CEMENT PANELS LINING THE SHAFTS

FACADE - PODIUM SOUTH

CD:02 FACE BRICK - INTERNAL WALL: BLOCKWALL GRD LVL & METAL FRAME L1 & ABOVE

WD:10 SHOP FRONT GLAZING WITH EXPRESSED POWDERCOATED STEEL FRAMED

WD:11 OPERABLE SHOP FRONT GLAZING WITH EXPRESSED POWDERCOATED STEEL FRAMED

CD:03 SOLID FOLDED METAL PANEL

CD:20 COMPRESSED FIBRE CEMENT PANEL

CU:08 CURTAIN WALL WINDOW WITH GLASS SPANDREL AND SMOKE RELIEF LOUVRES

WHERE SHOWN (WD:30) CORE SLOT WINDOW

**AWNINGS & CANOPIES** 

(AW:01) NORTH RETAIL AWNING

(AW:02) NORTH FOYER ENTRY CANOPY


(AW:03) SOUTH RETAIL AWNING

CP:01 ROOF TERRACE GLAZED CANOPY WITH PAINTED STEEL FRAME

**EXTERNAL SOFFIT** 

(CL:01) LANEWAY CEILING **METALWORK** 

MW:01 FABRICATED ALUMINIUM PLANTER POWDERCOAT FINISH

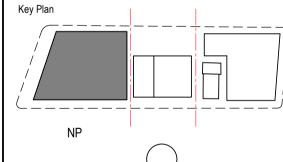

North Point









WATERLOO METRO QUARTER DEVELOPMENT


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SSD10440

BUILDING 1 - WD20 TOWER FACADE

FOR APPROVAL

WMQ-BLD1-WBG-AR-DRG-DA147 E

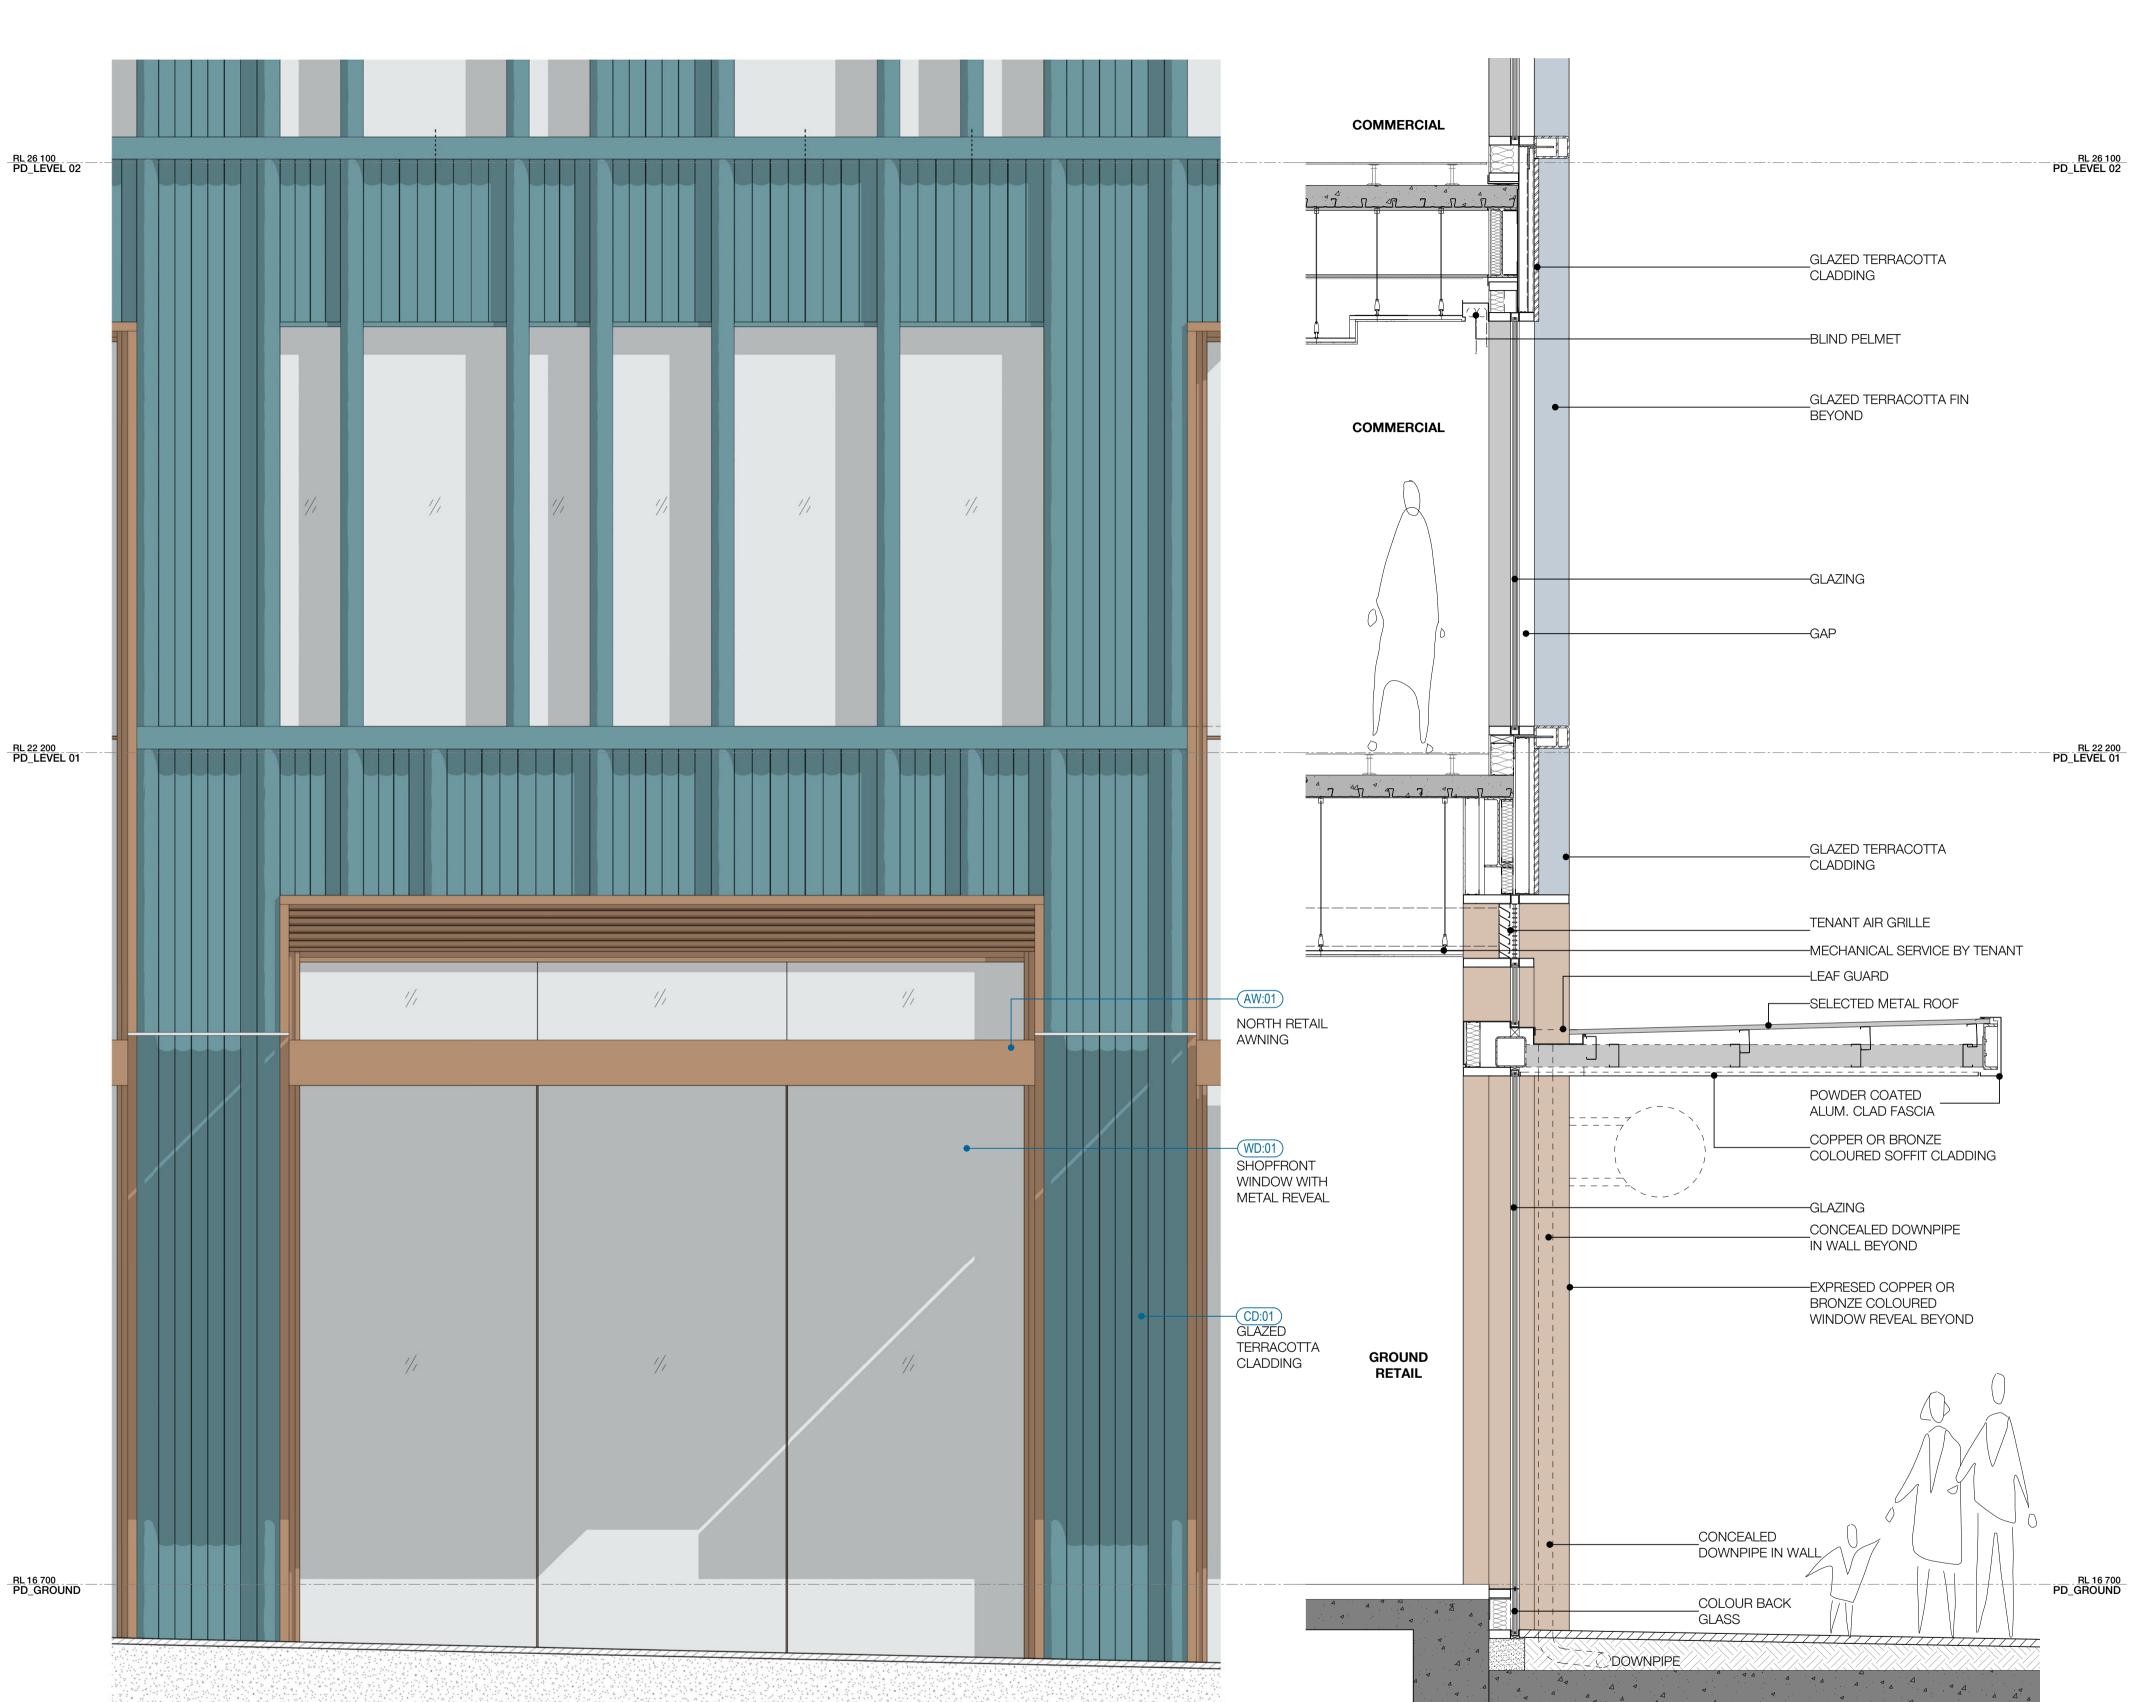

Recent revision history # Status FOR INFORMATION (DA) 15.07.20 FOR APPROVAL 31.07.20 FOR APPROVAL 28.08.20 FOR APPROVAL 25.09.20

**Current Revision Amendments** # Mark Comments

**METRO** 

CORE

KEY PLAN

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# Do not scale drawings.

**FACADE - TOWER** 

CU:01 CURTAIN WALL WITH EXPRESSED VERTICAL & HORIZONTAL FINS WITH GLASS SPANDREL CU:02 CURTAIN WALL WITH EXPRESSED VERTICAL & HORIZONTAL FINS WITH METAL SPANDREL

CU:03 CURTAIN WALL WITH FOLDED ALUMINIUM CLADDING

CU:04 CURTAIN WALL WITH EXPRESSED VERTICAL & HORIZONTAL FINS WITH GLASS & METAL SPANDREL

CU:05 PREFINISHED FIBRE CEMENT PANEL

CU:06 CURTAIN WALL WITH EXPRESSED VERTICAL & HORIZONTAL FINS WITH GLASS & METAL SPANDREL

CU:07 CURTAIN WALL WITH ARCHITECTURAL LOUVRE AND PROFILED METAL WD:20 STRUCTURAL GLAZED FRAMED WINDOWS

WD:21 ATRIUM SKYLIGHT WITH PERFORMANCE SHADING GLAZED

### FACADE - PODIUM NORTH

CD:01 CERAMIC CLADDING - INTERNAL WALL:
BLOCKWALL GRD LVL & METAL FRAME L1 & ABOVE WD:01) SHOPFRONT WINDOW WITH METAL REVEAL

WD:02 REVOLVING DOOR WITH LIGHT FRAME

(WD:03) PODIUM LANEWAY OPERABLE SHOPFRONT GLAZING

(WD:20) STRUCTURAL GLAZED FRAMED WINDOWS

WD:22 PRE-FINISHED FIBRE CEMENT PANELS LINING THE SHAFTS

# **FACADE - PODIUM SOUTH**

CD:02 FACE BRICK - INTERNAL WALL: BLOCKWALL GRD LVL & METAL FRAME L1 & ABOVE

WD:10 SHOP FRONT GLAZING WITH EXPRESSED POWDERCOATED STEEL FRAMED

WD:11 OPERABLE SHOP FRONT GLAZING WITH EXPRESSED POWDERCOATED STEEL FRAMED

**CORE** CD:03 SOLID FOLDED METAL PANEL

CD:20 COMPRESSED FIBRE CEMENT PANEL

CU:08 CURTAIN WALL WINDOW WITH GLASS SPANDREL AND SMOKE RELIEF LOUVRES WHERE SHOWN

(WD:30) CORE SLOT WINDOW

**AWNINGS & CANOPIES** (AW:01) NORTH RETAIL AWNING

(AW:02) NORTH FOYER ENTRY CANOPY


(AW:03) SOUTH RETAIL AWNING

CP:01 ROOF TERRACE GLAZED CANOPY WITH PAINTED STEEL FRAME

**EXTERNAL SOFFIT** 

(CL:01) LANEWAY CEILING METALWORK

MW:01 FABRICATED ALUMINIUM PLANTER POWDERCOAT FINISH

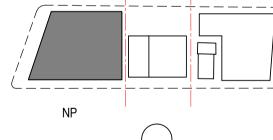










WATERLOO METRO QUARTER DEVELOPMENT

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Checked YT	Approved PM	Sheet size A1	Scale As indicat

SSD10440 BUILDING 1 - CD01 PODIUM FACADE **DETAILS** 

FOR APPROVAL

Sheet number WMQ-BLD1-WBG-AR-DRG-DA148 D

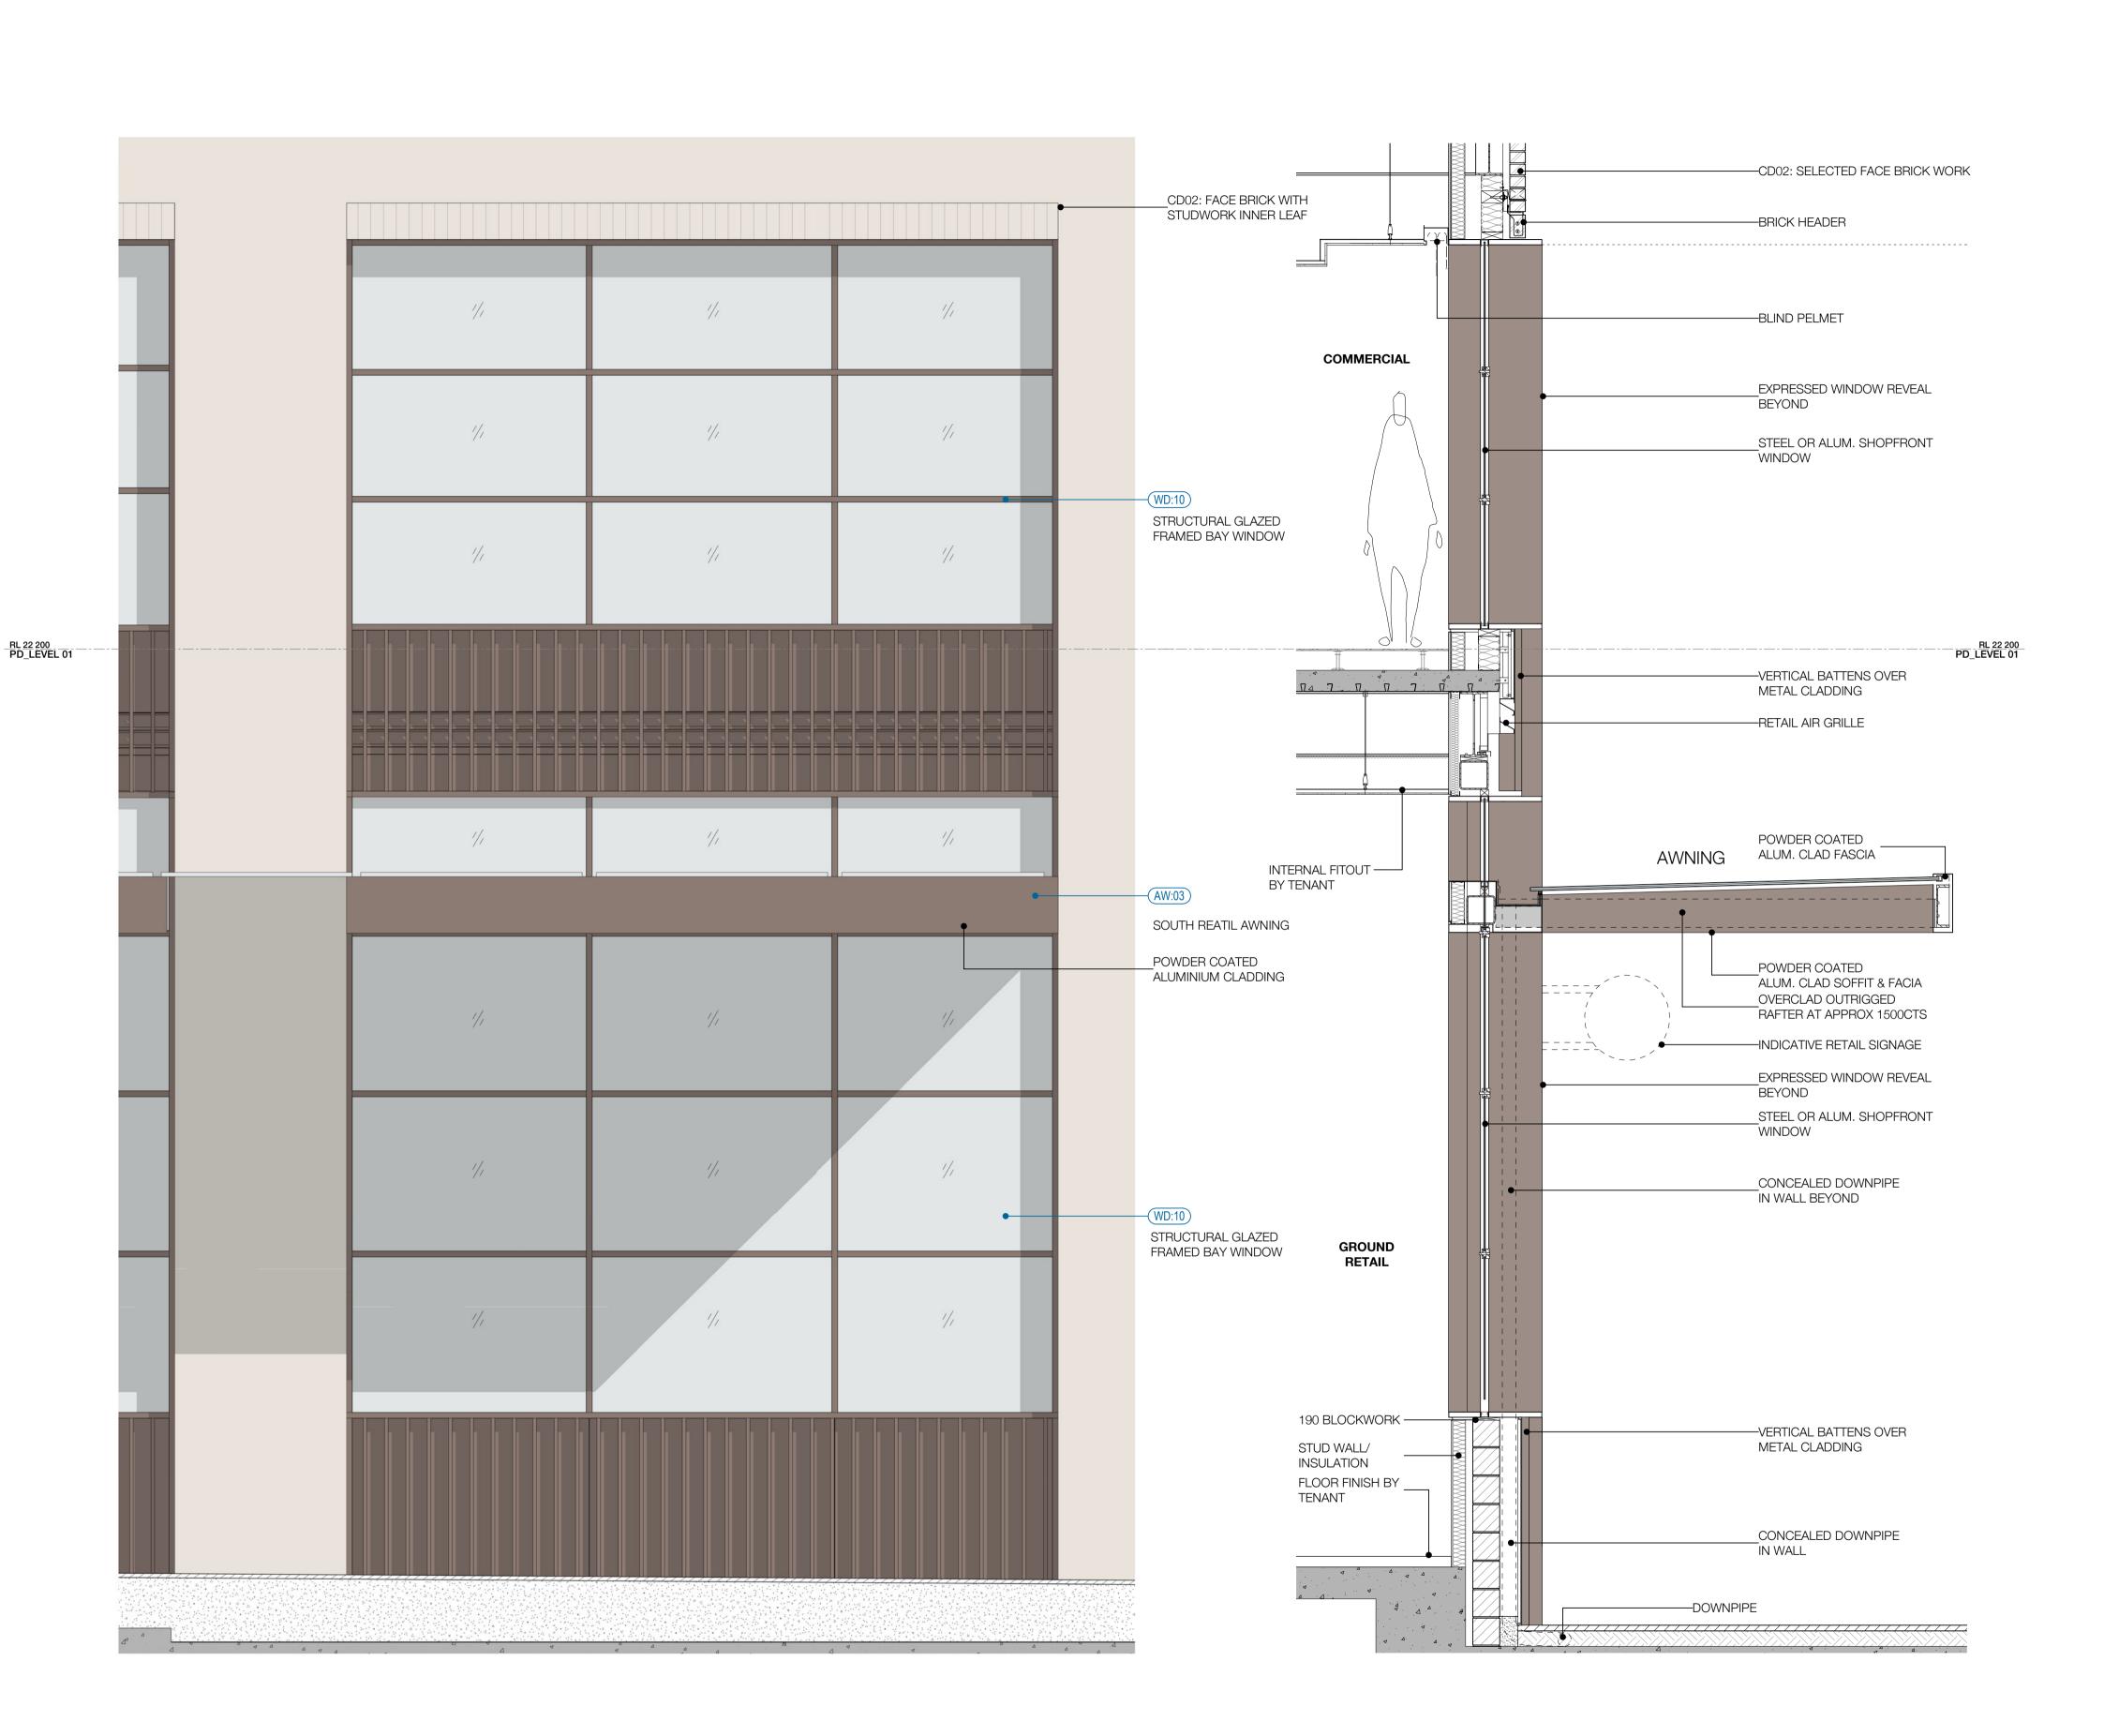

1 TYPICAL DETAIL ELEVATION / SECTION - CD02 SCALE 1:25

**METRO** CORE KEY PLAN

Recent revision history # Status FOR INFORMATION (DA) FOR APPROVAL FOR APPROVAL FOR APPROVAL **Current Revision Amendments** # Mark Comments No material may be reproduced without prior permission. Contractor must verify all dimensions on site before commencing work or preparing shop drawings. Do not scale drawings. **FACADE - TOWER** CU:01 CURTAIN WALL WITH EXPRESSED VERTICAL & HORIZONTAL FINS WITH GLASS SPANDREL CU:02 CURTAIN WALL WITH EXPRESSED VERTICAL & HORIZONTAL FINS WITH METAL SPANDREL CU:03 CURTAIN WALL WITH FOLDED ALUMINIUM CLADDING CU:04 CURTAIN WALL WITH EXPRESSED VERTICAL & HORIZONTAL FINS WITH GLASS & METAL SPANDREL CU:05 PREFINISHED FIBRE CEMENT PANEL CU:06 CURTAIN WALL WITH EXPRESSED VERTICAL & HORIZONTAL FINS WITH GLASS & METAL SPANDREL CU:07 CURTAIN WALL WITH ARCHITECTURAL LOUVRE AND PROFILED METAL (WD:20) STRUCTURAL GLAZED FRAMED WINDOWS WD:21 ATRIUM SKYLIGHT WITH PERFORMANCE SHADING GLAZED CD:01 CERAMIC CLADDING - INTERNAL WALL:
BLOCKWALL GRD LVL & METAL FRAME L1 & ABOVE

FACADE - PODIUM NORTH

WD:01 SHOPFRONT WINDOW WITH METAL REVEAL WD:02 REVOLVING DOOR WITH LIGHT FRAME

15.07.20

31.07.20

28.08.20

25.09.20

(WD:03) PODIUM LANEWAY OPERABLE SHOPFRONT GLAZING (WD:20) STRUCTURAL GLAZED FRAMED WINDOWS

WD:22 PRE-FINISHED FIBRE CEMENT PANELS LINING THE SHAFTS

**FACADE - PODIUM SOUTH** 

CD:02 FACE BRICK - INTERNAL WALL: BLOCKWALL GRD LVL & METAL FRAME L1 & ABOVE

WD:10 SHOP FRONT GLAZING WITH EXPRESSED POWDERCOATED STEEL FRAMED WD:11 OPERABLE SHOP FRONT GLAZING WITH

EXPRESSED POWDERCOATED STEEL FRAMED

CD:03 SOLID FOLDED METAL PANEL CD:20 COMPRESSED FIBRE CEMENT PANEL CU:08 CURTAIN WALL WINDOW WITH GLASS

SPANDREL AND SMOKE RELIEF LOUVRES WHERE SHOWN (WD:30) CORE SLOT WINDOW **AWNINGS & CANOPIES** 

(AW:01) NORTH RETAIL AWNING (AW:02) NORTH FOYER ENTRY CANOPY


(AW:03) SOUTH RETAIL AWNING

CP:01 ROOF TERRACE GLAZED CANOPY WITH PAINTED STEEL FRAME

**EXTERNAL SOFFIT** (CL:01) LANEWAY CEILING

**METALWORK** 

MW:01 FABRICATED ALUMINIUM PLANTER **POWDERCOAT FINISH** 

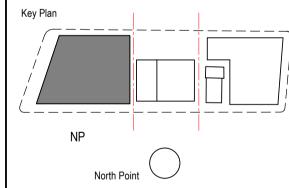





WATERLOO METRO QUARTER DEVELOPMENT

Project number Checked Approved Sheet size Scale PM A1 As indicated

> SSD10440 BUILDING 1 - CD02 PODIUM FACADE **DETAILS**

FOR APPROVAL

Sheet number WMQ-BLD1-WBG-AR-DRG-DA149 D






Light Beige Brick Appearance CD:02



Glazed Ceramic CD:01



PVDF OR Metalic Powdercoat -Green Copper CU:03

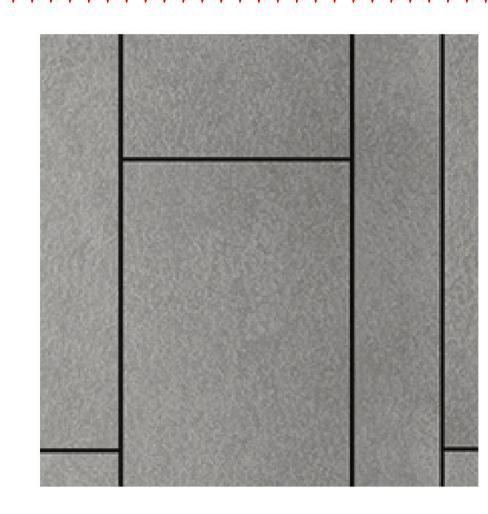


**Equitone OR Similar Product CD:20** 




**Equitone OR Similar Product CU:05** 



Triple Low E Coated Vision Glass (VLT 50% / Reflectivity < 20%)

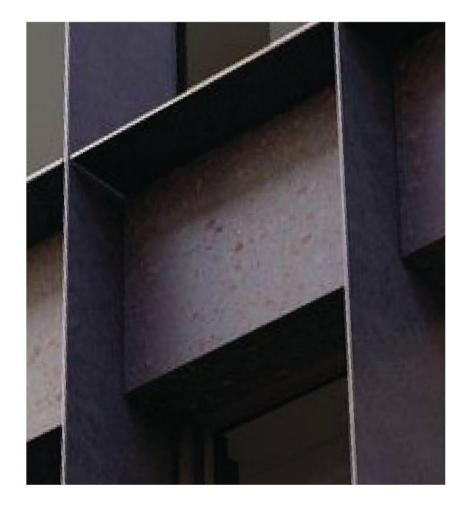

Powdercoat Aluminium - Black CU:04

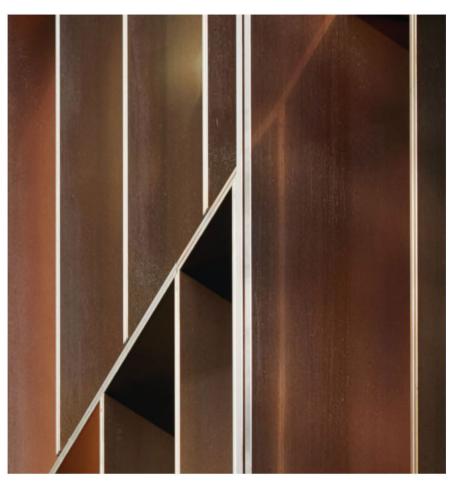

PVDF OR Metalic Powdercoat -Natual Copper CU:01/CU:02/CU:04/CD:01/ AW:01



Powdercoat Aluminium - Dark Bronze CD:02/AW:02



SSD10440

COLOUR PALETTE

Status FOR APPROVAL

BUILDING 1 - FACADE MATERIAL

WMQ-BLD1-WBG-AR-DRG-DA150 E

Recent revision history

Current Revision Amendments
# Mark Comments

work or preparing shop drawings.

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E 1 MATERIALS UPDATED

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FOR APPROVAL

FOR APPROVAL

28.08.20

25.09.20 15.03.21



Current Revision Amendments
# Mark Comments

E 1 TABLE UPDATED
E 2 LAYOUT UPDATED

Notes

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THE DEFINITION FOR GROSS FLOOR AREA IS SET OUT IN SYDNEY LEP 2012 AS:


GROSS FLOOR AREA MEANS THE SUM OF THE FLOOR AREA OF EACH FLOOR OF A
BUILDING MEASURED FROM THE INTERNAL FACE OF EXTERNAL WALLS, OR FROM
THE INTERNAL FACE OF WALLS SEPARATING THE BUILDING FROM ANY OTHER
BUILDING, MEASURED AT A HEIGHT OF 1.4 METRES ABOVE THE FLOOR, AND
INCLUDES:

a) THE AREA OF A MEZZANINE, AND
b) HABITABLE ROOMS IN A BASEMENT OR AN ATTIC, AND
c) ANY SHOP, AUDITORIUM, CINEMA, AND THE LIKE, IN A BASEMENT OR AN ATTIC,

BUT EXCLUDES:

d) ANY AREA OF COMMON VERTICAL CIRCUALTION, SUCH AS LIFTS AND STAIRS, AND
e) ANY BASEMENT:
i) STORAGE, AND

e) ANY BASEMENT:
i) STORAGE, AND
ii) VEHICULAR ACCESS, LOADING AREAS, GARBAGE AND SERVICES, AND
ii) VEHICULAR ACCESS, LOADING AREAS, GARBAGE AND SERVICES, AND
f) PLANT ROOMS, LIFT TOWERS AND OTHER AREAS USED EXCLUSIVELY FOR
MECHANICAL SERVICES OR DUCTING, AND
g) CAR PARKING TO MEET ANY REQUIREMENTS OF THE CONSENT AUTHORITY
(INCLUDING ACCESS TO THE CAR PARK), AND
h) ANY SPACED USED FOR THE LOADING OR UNLOADING OF GOODS (INCLUDING
ACCESS TO IT), AND
i) TERRACES AND BALCONIES WITH OUTER WALLS LESS THAN 1.4 METRES HIGH,
AND
j) VOIDS ABOVE A FLOOR AT THE LEVEL OF A STOREY OR STOREY ABOVE

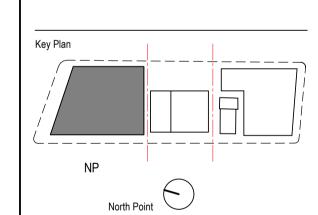







Project
WATERLOO METRO QUARTER DEVELOPMENT


Project number	Size check
121234	25mm


Sheet title PM

SSD10440 BUILDING 1 - AREA PLAN 01 - GFA

Status FOR APPROVAL

Sheet number Revision
WMQ-BLD1-WBG-AR-DRG-DA190 E

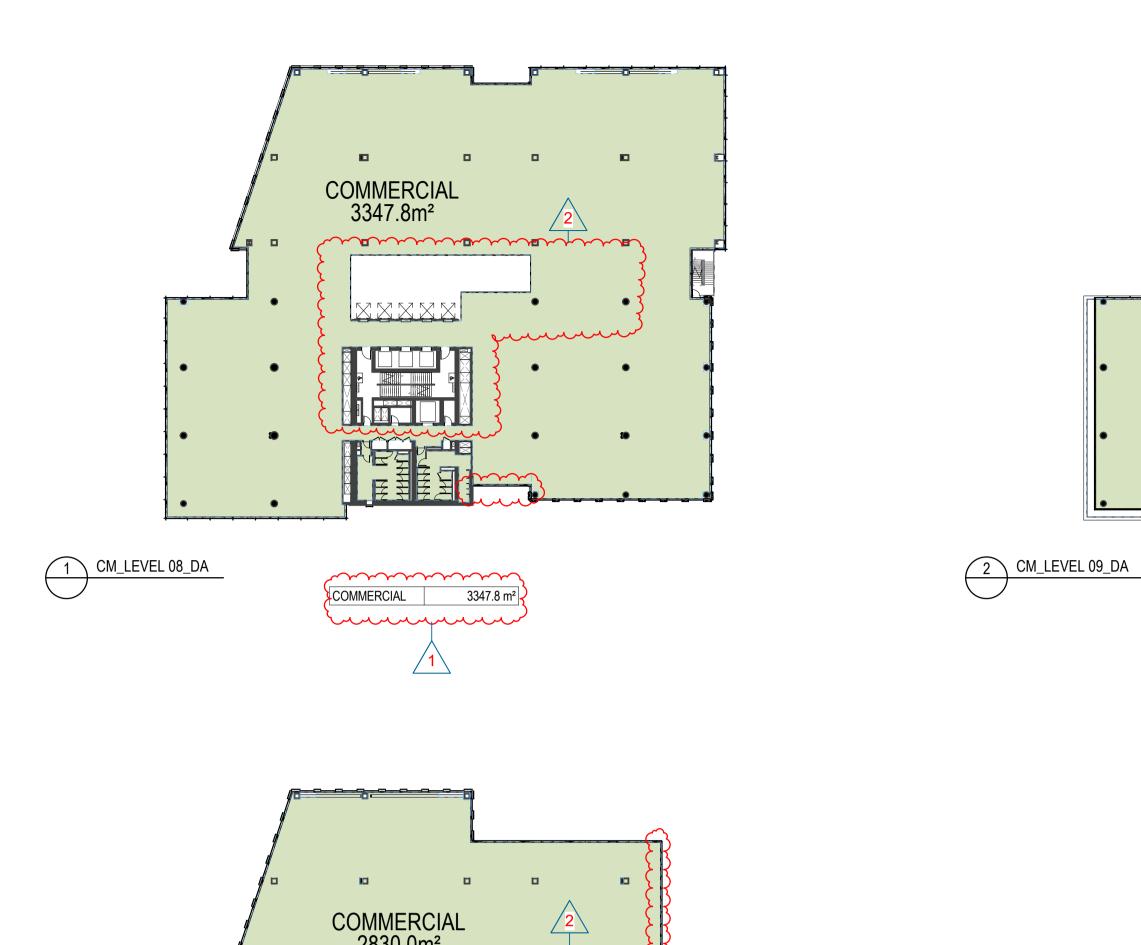

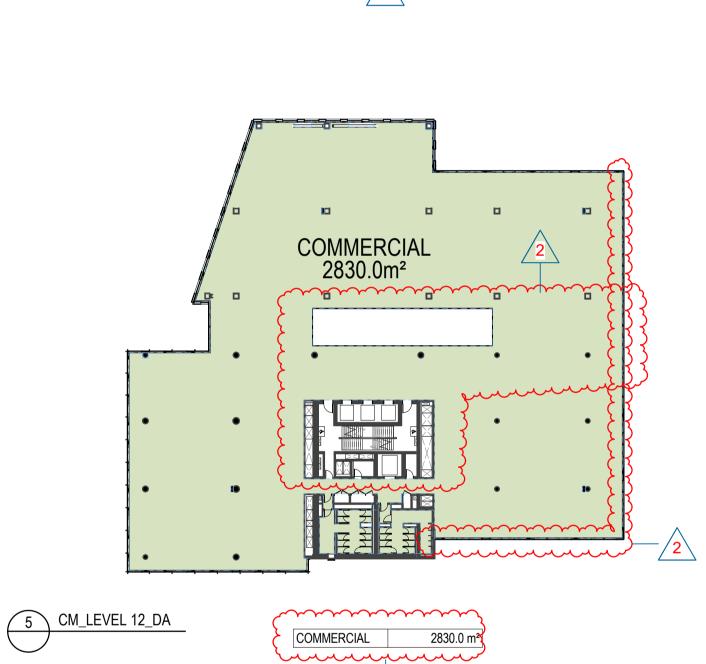

COMMERCIAL


2716.5m<sup>2</sup>


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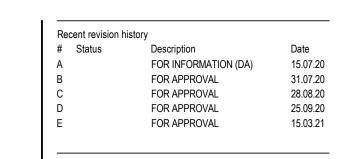
2716.5 m<sup>2</sup>

COMMERCIAL

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Current Revision Amendments # Mark Comments

E 1 TABLE UPDATED E 2 LAYOUT UPDATED

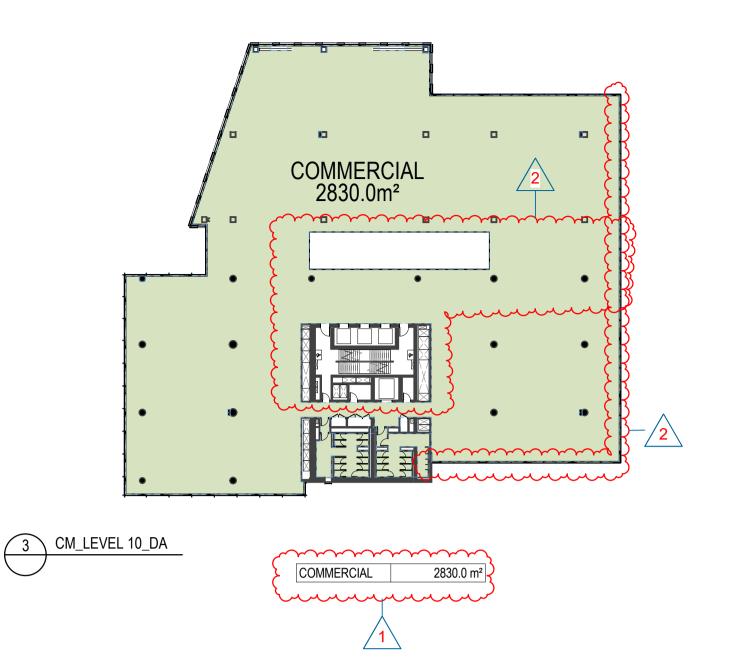
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j) VOIDS ABOVE A FLOOR AT THE LEVEL OF A STOREY OR STOREY ABOVE
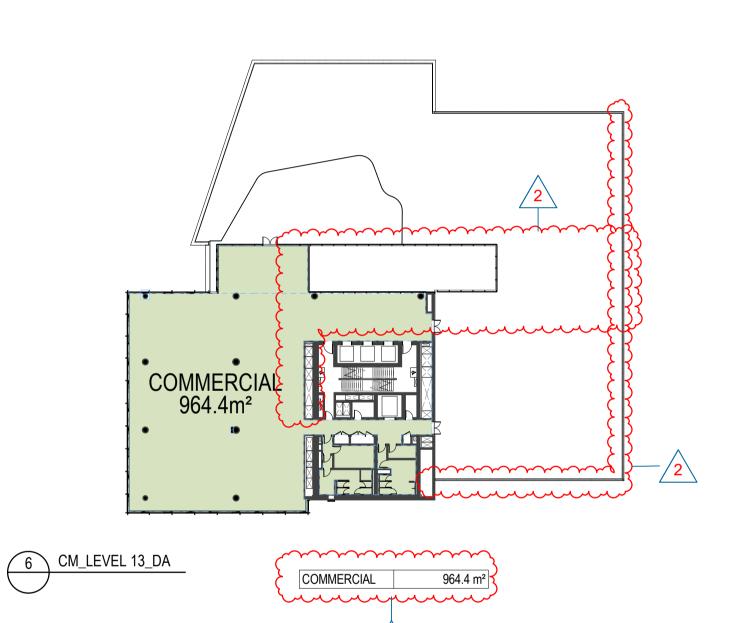
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AND





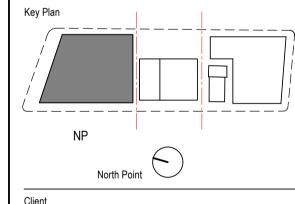

WATERLOO METRO QUARTER DEVELOPMENT

Project number		Size check	
121234		25mm	
Checked	Approved	Sheet size	Scale
SJ	PM	A1	1:500

4 CM\_LEVEL 11\_DA

COMMERCIAL

2830.0 m<sup>2</sup>