Drawing List SSDA

Drawing List SSDA

Sheet		Sheet		Sheet	
Number	Sheet Name	Number	Sheet Name	Number	Sheet Name
DA001	COVERSHEET	DA022	VIEW ANALYSIS - BROADHEAD ROAD	DA115	BLOCK D - SECTION DETAILS
DA002	CONTEXT PLANS	DA023	VIEW ANALYSIS - BROADHEAD ROAD	DA116	BLOCK E - GROUP FLOOR PLANS
DA003	SITE CONTEXT PHOTOS	DA024	VIEW ANALYSIS - BRUCE ROAD	DA117	BLOCK E - GROUP ELEVATIONS
DA004	SURVEY PLAN	DA101	BLOCK A - PLANS	DA118	BLOCK E - GROUP SECTIONS
DA005	SITE ANALYSIS PLAN	DA102	BLOCK A - ELEVATIONS	DA119	BLOCK E - BUILDING 1 FLOOR PLANS
DA006	SITE MASSING PLAN	DA103	BLOCK A - SECTIONS	DA120	BLOCK E - BUILDING 1 - ELEVATIONS
DA007	SITE STRATEGY PLAN	DA104	BLOCK A - SECTION DETAILS	DA121	BLOCK E - BUILDING 1 - SECTIONS
DA008	SITE PLAN	DA105	BLOCK B - FLOOR PLAN, ELEVATIONS & SECTIONS	DA122	BLOCK E - BUILDING 2 - FLOOR PLANS
DA009	PART SITE PLAN	DA106	BLOCK B - SECTIONS	DA123	BLOCK E - BUILDING 2 - ELEVATIONS
DA010	ROOF PLAN	DA108	BLOCK C - GROUND FLOOR PLAN	DA124	BLOCK E - BUILDING 2 - SECTIONS
DA011	STREET ELEVATIONS	DA109	BLOCK C - ELEVATIONS	DA125	BLOCK E - BUILDING 3 - FLOOR PLANS
DA012	STREET ELEVATIONS AND SITE SECTIONS	DA110	BLOCK C - ELEVATIONS AND SECTIONS	DA126	BLOCK E - BUILDING 3 - ELEVATIONS
DA013	AERIAL IMAGES	DA111	BLOCK C - SECTION DETAILS	DA127	BLOCK E - BUILDING 3 - SECTIONS
DA014	SHADOW DIAGRAMS - Part Site Plan	DA112	BLOCK D - GROUND FLOOR PLAN		
DA015	SIGNAGE DIAGRAM	DA113	BLOCK D - ELEVATIONS		
DA021	MATERIAL SCHEDULE	DA114	BLOCK D - SECTIONS		

ST MATTHEWS CATHOLIC SCHOOL, MUDGEE - SECONDARY CAMPUS STATE SIGNIFICANT DEVELOPMENT



Stage 1 Area Totals				
Department	Area			
Administration	747 m²			
Building Services	101 m²			
Car Park	2936 m ²			
Chapel	182 m²			
Enclosed Circulation	819 m ²			
GLA-Secondary	1864 m ²			
Multi-Purpose Hall	683 m ²			
Performing Arts	230 m ²			
Pupil Facilites	105 m ²			
Resource Centre	279 m ²			
TAS	522 m ²			
TAS Science	373 m ²			
TAS-Food Technology	223 m ²			
Unenclosed Circulation	61 m ²			
Unenclosed covered circulation	832 m ²			
Visual Arts	450 m ²			
Grand total	10409 m ²			

Drawing List SSDA

CBGA Schedule				
Department	Area			
Administration	747 m ²			
Building Services	101 m ²			
Car Park	2936 m ²			
Chapel	182 m ²			
GLA-Secondary	1864 m ²			
Multi-Purpose Hall	683 m ²			
Performing Arts	230 m ²			
Pupil Facilites	105 m ²			
Resource Centre	279 m ²			
TAS	522 m ²			
TAS Science	373 m ²			
TAS-Food Technology	223 m ²			
Unenclosed Circulation	61 m ²			
Unenclosed covered circulation	832 m ²			
Visual Arts	450 m ²			
Grand total	9590 m ²			

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SSDA- Project name adjusted	BLC	28.04.20	9
SSDA Issue, levels adjusted, dims added	BLC	01.04.20	8
GA NSW Issue	BLC	20.03.20	7
Preliminary SSDA Review	BLC	28.02.20	6
SSDA Documentation 90% Completion	DO	03.06.19	5
Carpark, paths, Block B Adjusted	BLC	22.05.19	4
Client Workshop Presentation	BLC	14.05.19	3
GANSW Review	BLC	20.03.19	2
For Review	BLC	06.03.19	1
purpose of issue	by	date	issue no.

NOMINATED ARCHITECT : CHARLES GLANVILLE NSW REGISTRATION No. 3130



architect


ST MATTHEW'S CATHOLIC SCHOOL - Secondary Campus


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Corner of BROADHEAD and BRUCE RD. MUDGEE Lot 40 of DP 756894

STATE SIGNIFICANT DEVELOPMENT APPLICATION

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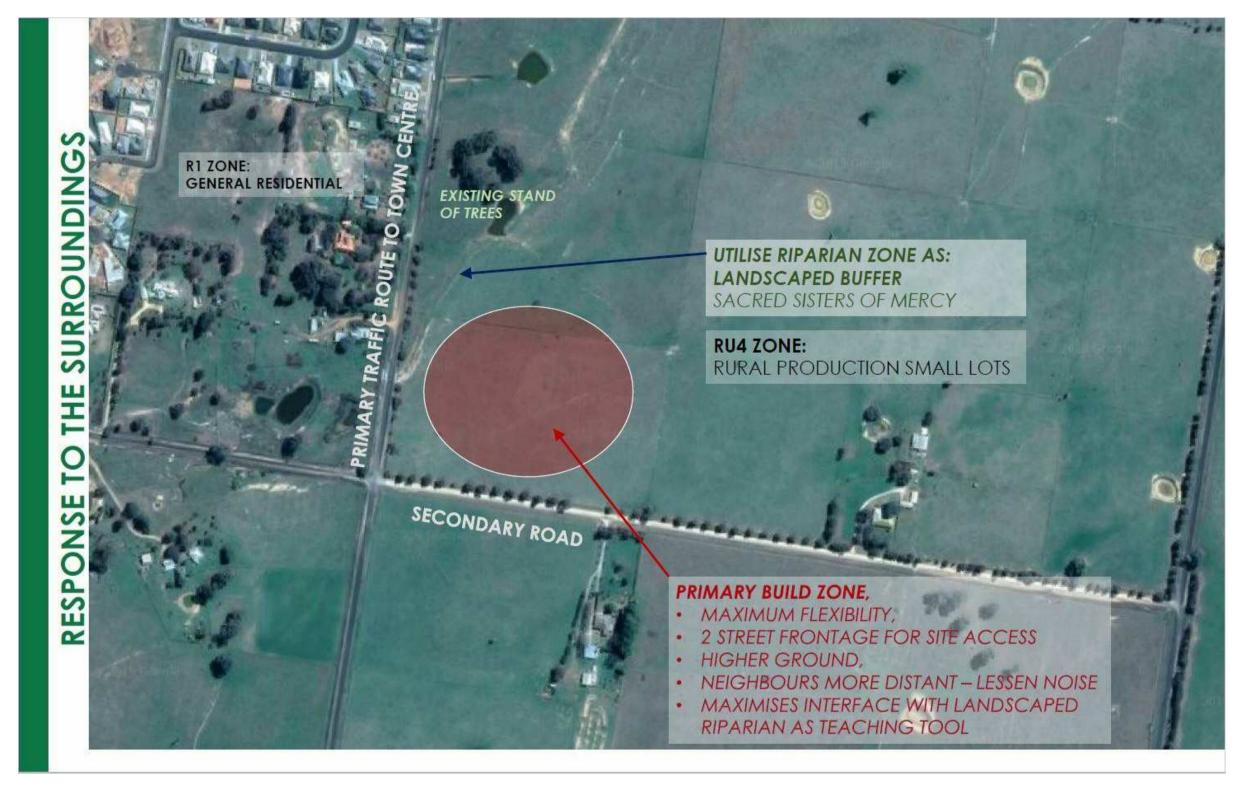




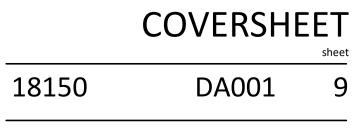
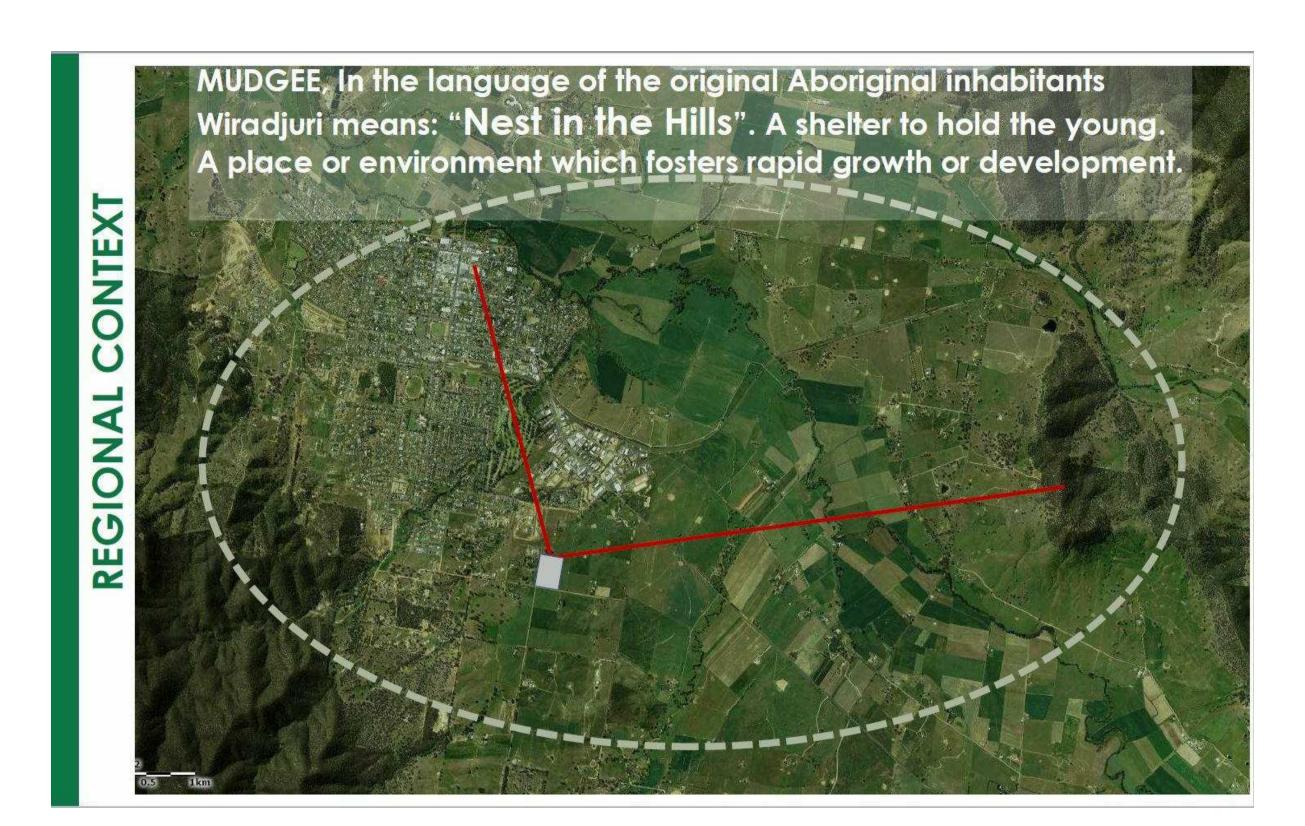
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SSDA- Project name adjusted	BLC	28.04.20	8
SSDA Issue, levels adjusted, dims added	BLC	01.04.20	7
GA NSW Issue	BLC	20.03.20	6
Preliminary SSDA Review	BLC	28.02.20	5
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Client Workshop Presentation	BLC	14.05.19	3
GANSW Review	BLC	20.03.19	2
For Review	BLC	06.03.19	1
purpose of issue	by	date	issue no.

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project

ST MATTHEW'S CATHOLIC SCHOOL - Secondary Campus

address

Corner of BROADHEAD and BRUCE RD. MUDGEE Lot 40 of DP 756894

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CONTEXT PLANS


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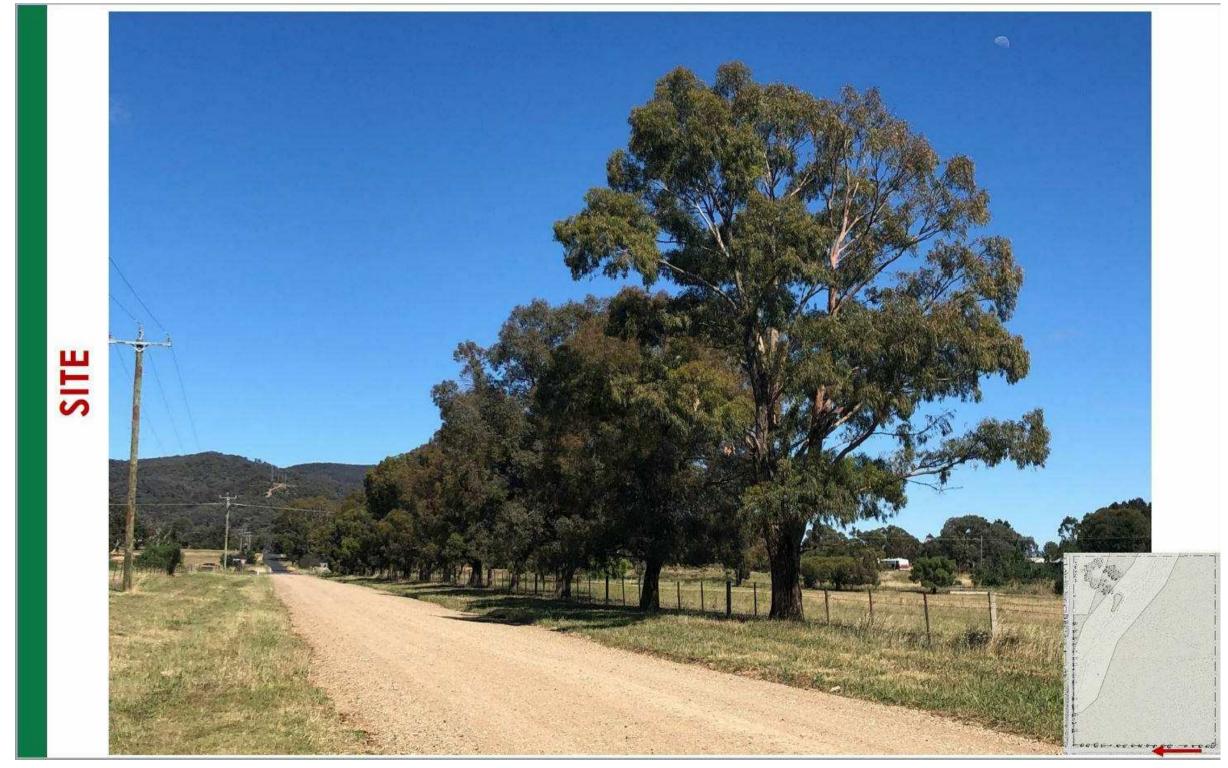
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SSDA- Project name adjusted	BLC 28.	.04.20	7
SSDA Issue, levels adjusted, dims added	BLC 01.	.04.20	6
GA NSW Issue	BLC 20.	.03.20	5
SSDA Documentation 90% Completion	DO 03.	.06.19	4
Client Workshop Presentation	BLC 14.	.05.19	3
DRAW NUMBERS ADJUSTED, Buildings moved, Elevations adjusted	BLC 08.	.05.19	2
GANSW Review	BLC 20.	.03.19	1
For Review	BLC 20.	.02.19	
purpose of issue	by d	date	issue no.

NOMINATED ARCHITECT : CHARLES GLANVILLE NSW REGISTRATION No. 3130



project

architect

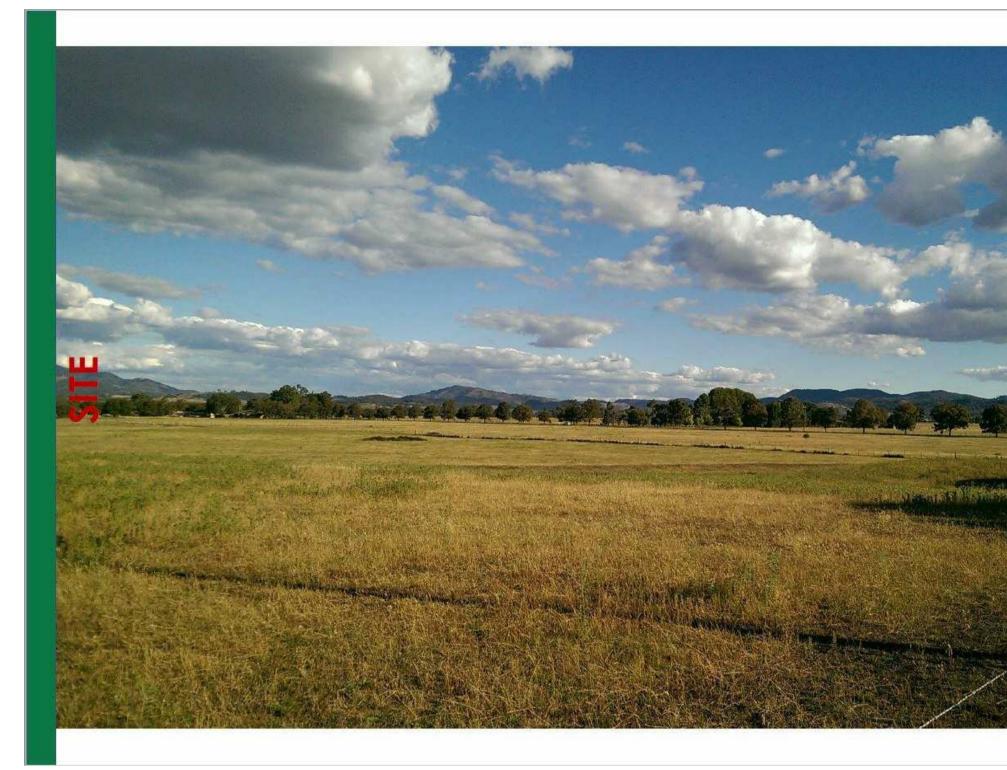ST MATTHEW'S CATHOLIC SCHOOL - Secondary Campus

address


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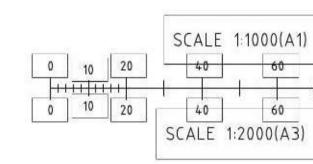
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SITE CONTEXT PHOTOS

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(S) EASEMENT TO DRAIN SEWAGE 3 WIDE (VIDE DP 1211844)

	EXISTING SUBJECT CADASTRAL BOUNDARIES BY T
	EXISTING BOTTOM OF BANK
	EXISTING TOP OF BANK
	EXISTING FENCE LINE
	CENTRELINE OF EXISTING ROAD
_ s	EXISTING UNDERGEROUND SEWER MAIN
- w	EXISTING UNDERGROUND RETICULATED WATER
— OE ——	EXISTING OVERHEAD ELECTRICITY CABLES
- E	EXISTING UNDERGROUND ELECTRICITY CABLES
	EXTEND OF EXISTING BITUMEN SEALED ROAD
	EXTENT OF EXISTING GRAVEL ROAD / DRIVEWAY



NOTES:

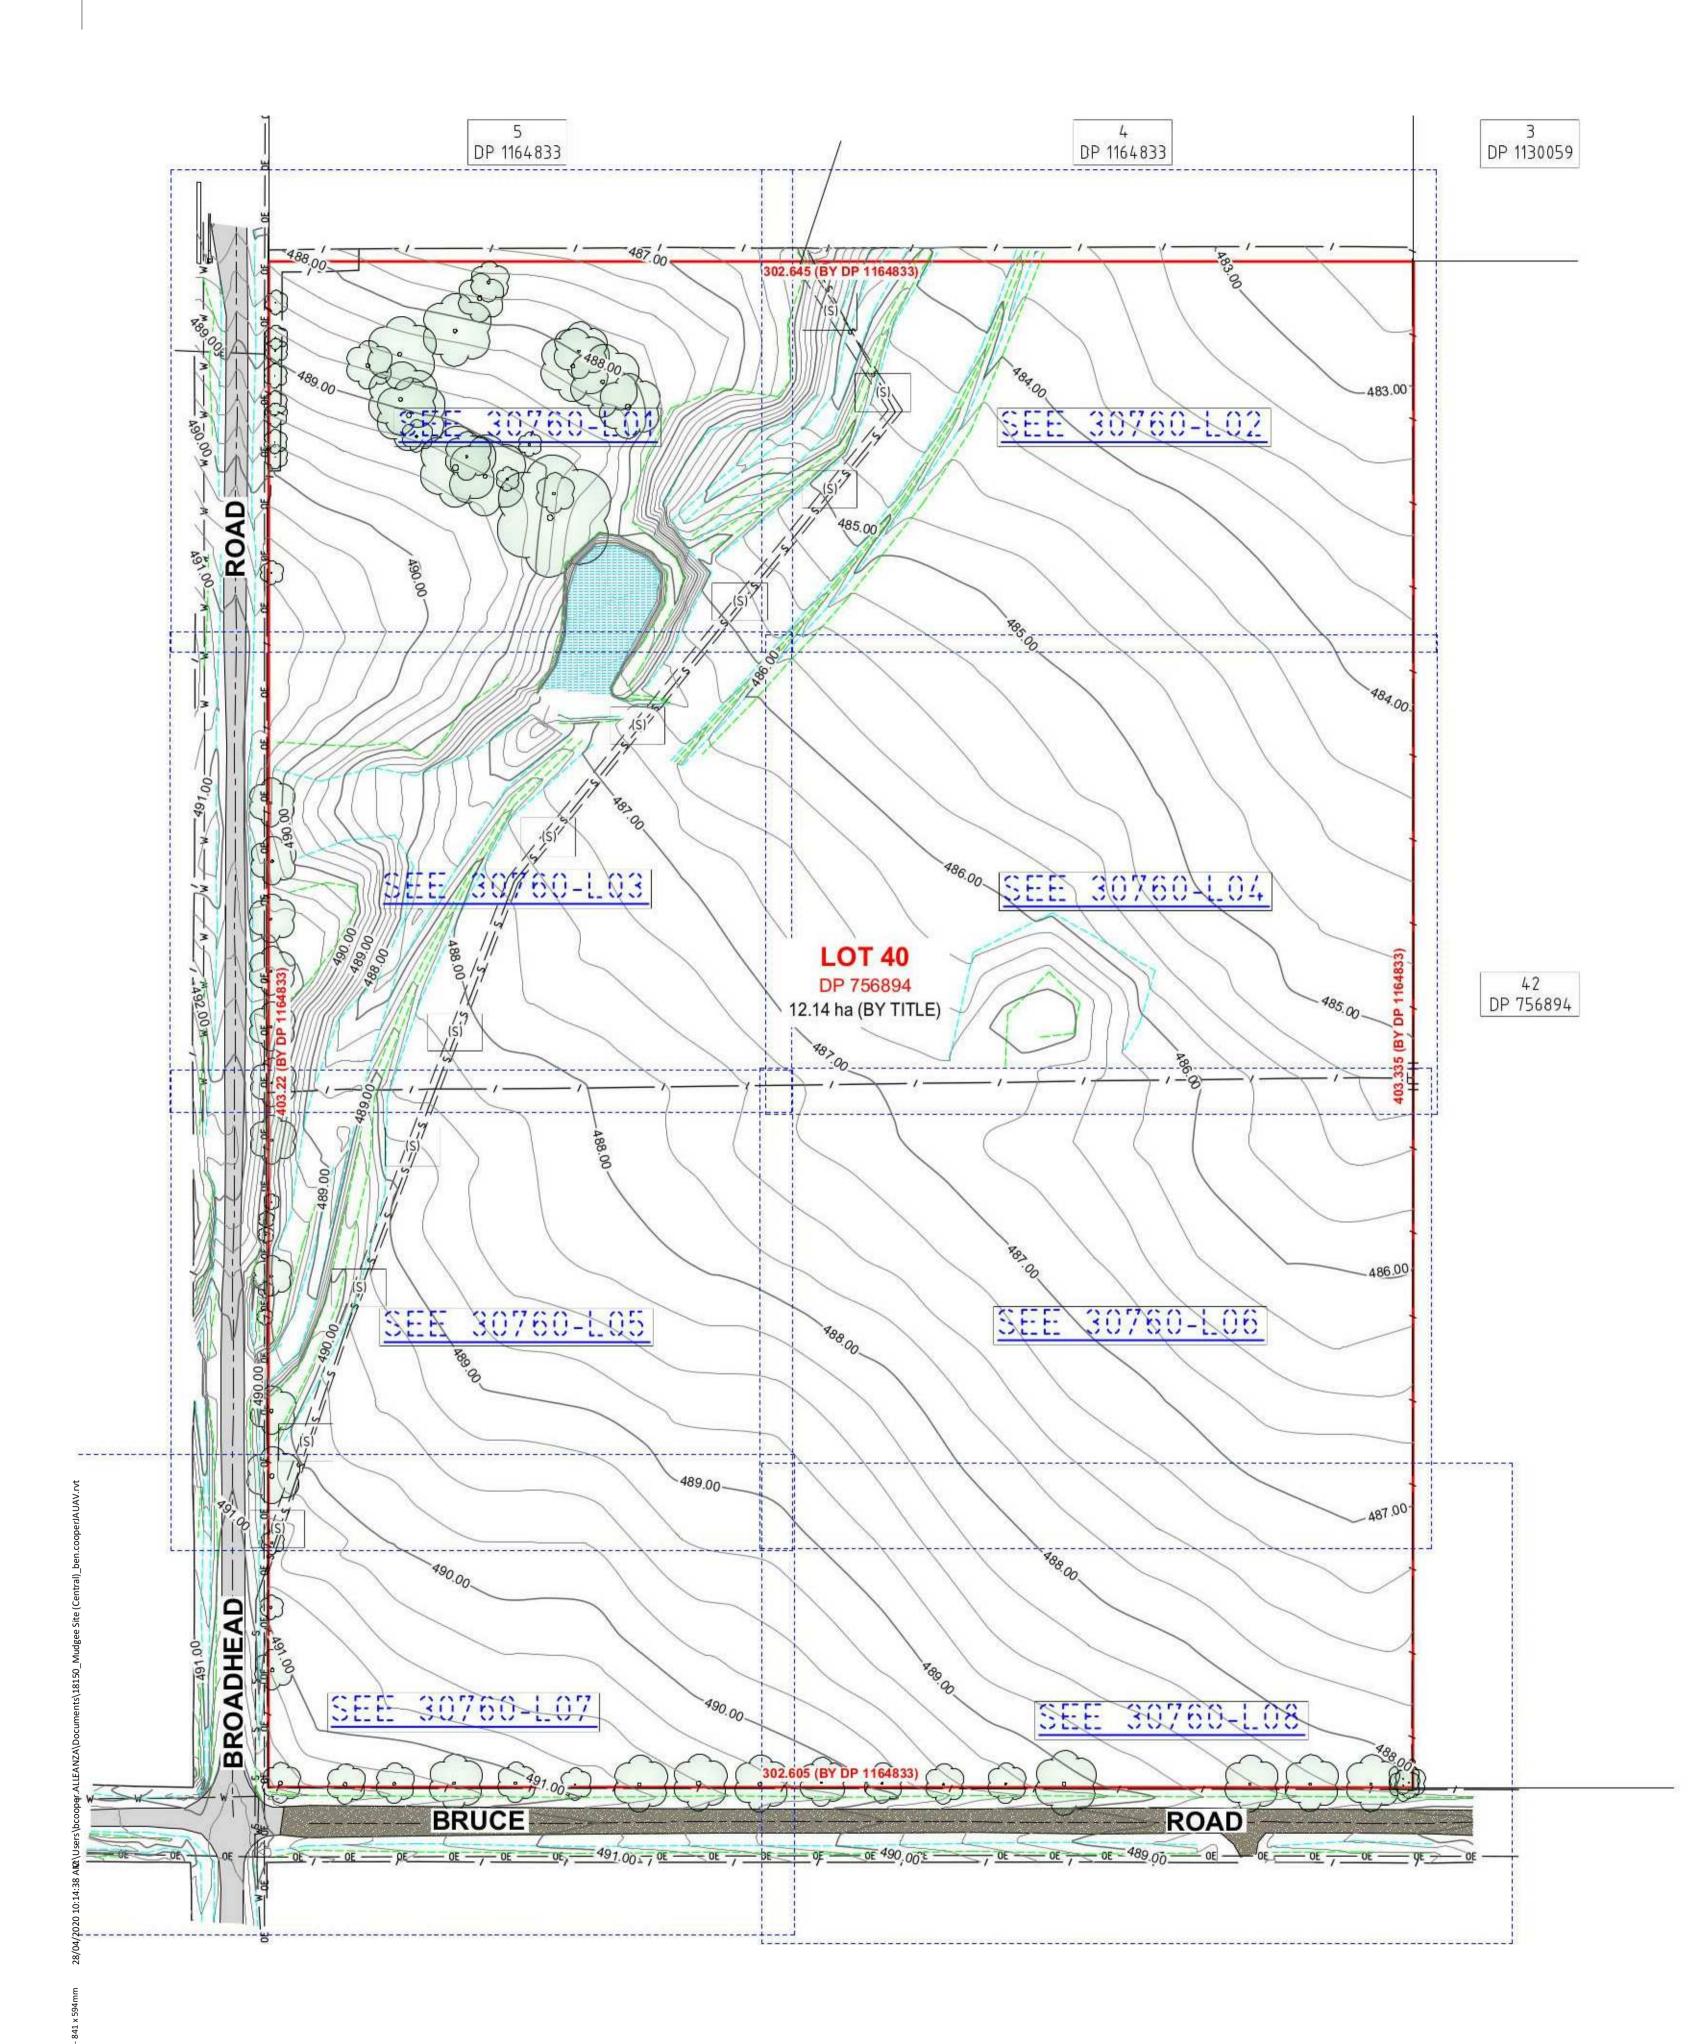- THE CADASTRAL BOUNDARIES, INCLUDING DIMENSIONS AND AREAS OF LOT 40 IN I
- TITLE BOUNDARIES WERE NOT MARKED AS PART OF THIS SURVEY. CONTOURS SHOWN ARE INTERPOLATED AND ARE INDICATIVE OF THE GROUND SU
- HEIGHTS SHOWN SHOULD BE USED IN PREFERENCE TO CONTOURS. SERVICE LOCATIONS SHOWN HEREON ARE BY FIELD INSPECTION DURING THE SURY
- DIG SEARCH. THE LOCATION OF AND DEPTHS OF ALL SERVICES SHOULD BE OBTAIL VERIFIED ON SITE PRIOR TO ANY DEMOLITION, EXCAVATION OR CONSTRUCTION. UNDERGROUND SERVICES MAY EXIST WHICH HAVE NOT BEEN SHOWN ON THIS PLA

		BRUCE RD. MU Lot 40 of DP 7	
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000251 (S.C.I.M.S.) N DP 756894 ARE SUBJECT TO FINAL SURVEY. SURFACE HEIGHT AT ANY POINT ONLY. SPOT RVEY AND DIGITISING FROM DIAL BEFORE YOU AINED FROM SERVICE PROVIDERS, LOCATED AND LAN.	north graphic scale	drawn: checked: verified: sheet size: scale:	BLC BLC CG A1 1 : 1000 6
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JM : AUSTRALIAN HEIC	SHT DATUM (A.H.D.)
M 150901 RL 487.270m	(S.C.I.M.S.)
R INTERVAL :	1 METRE

DATE OF SURVEY : 29th JAN -

IZE INDICATES APPROXIMATE

100

100

80

80





ST MATTHEW'S CATHOLIC

SCHOOL - Secondary Campus

Corner of BROADHEAD and

NOMINATED ARCHITECT : CHARLES GLANVILLE NSW REGISTRATION No. 3130











BLC 28.04.20

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SSDA- Project name adjusted

Client Workshop Presentation

moved, Elevations adjusted

GA NSW Issue

Consultant Issue

Consultant Review

purpose of issue

SSDA Issue, levels adjusted, dims added

SSDA Documentation 90% Completion


DRAW NUMBERS ADJUSTED, Buildings

Block B rotated, Consult Model Issue



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Take a look at our website widgets Available free! Find Out More > Average Low 2010–Present 8.7 °C Average 2010-Present 15.7 °C Average High 2010–Present 23.3 °C <u>اله</u> (Wind Rose Annual (5 Year Average) 🛩 6.82% N 11.25%

Average Minimum = 8.7° July Lowest Minimum = -7.4° Average Maximum = 23.3° January Highest Maximum = 40.5°

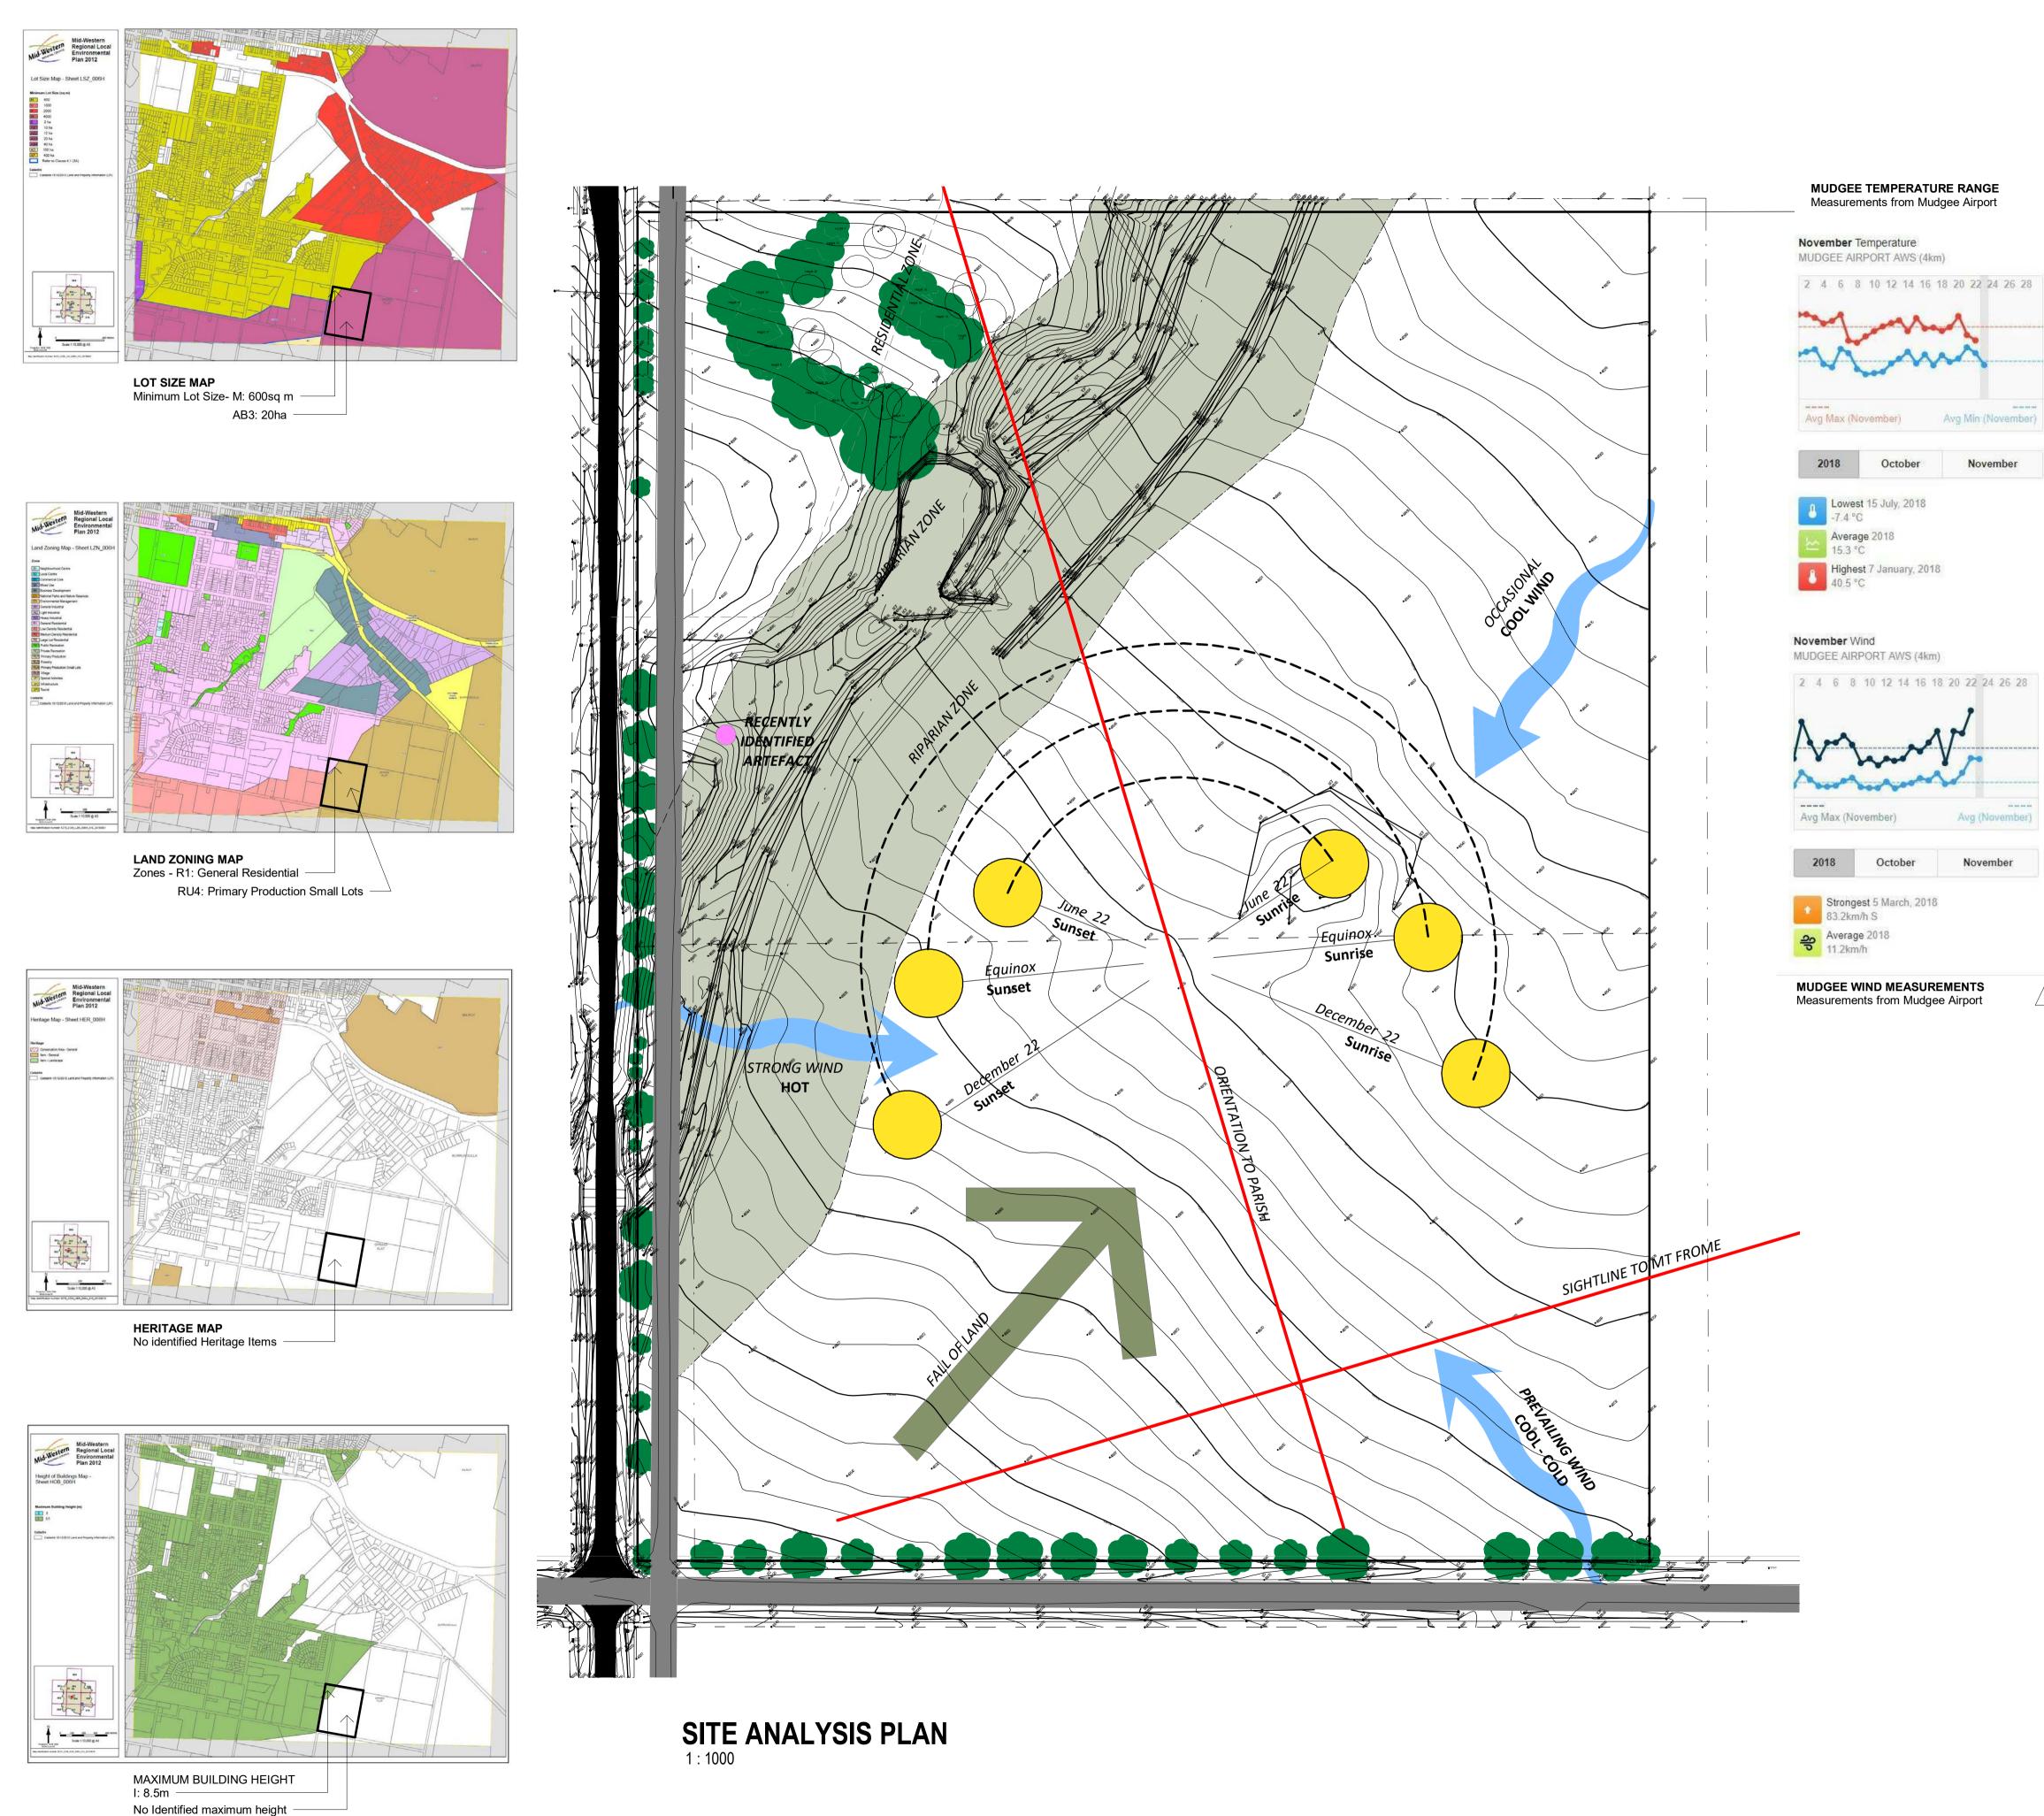Climate (2010-Present)

MUDGEE AIRPORT AWS (4km)

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SSDA- Project name adjusted	BLC	28.04.20	15
SSDA Issue, levels adjusted, dims added	BLC	01.04.20	14
GA NSW Issue	BLC	20.03.20	13
SSDA Documentation 90% Completion	DO	03.06.19	12
Client Workshop Presentation	BLC	14.05.19	11
DRAW NUMBERS ADJUSTED, Buildings moved, Elevations adjusted	BLC	08.05.19	10
ESD Consult Issue	BLC	02.05.19	9
Block B rotated, Consult Model Issue	BLC	30.04.19	8
Consultant Issue	BLC	12.04.19	7
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Consultant Issue	BLC	12.04.19	7
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IOMINATED ARCHITECT : CHARLES GLANVILLE NSW REGISTRATION No. 3130

Dominant Wind Direction: SE Strongest Wind: Westerly Maximum record=83km/h

> ST MATTHEW'S CATHOLIC SCHOOL - Secondary Campus

Corner of BROADHEAD and BRUCE RD. MUDGEE Lot 40 of DP 756894

STATE SIGNIFICANT DEVELOPMENT APPLICATION

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graphic scale		6

SITE ANALYSIS PLAN

18150

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Alternative massing forms relating to the school functioning and site conditions investigations below.

MASTERPLAN 1

Research / Technical / Creative Hub

Community / Performance / Food Hub

Knowledge / Spiritual Hub




Professional Hub



- Pro's - Strong Symbolism
- Discrete car parking
- Good "Front Door"
- Single storey layout provides Staging flexibility

Con's

- GLA's distant to Specialist facilities
- Community after-hours access challenges
- Bus Drop-off on Bruce Rd creates access issues
- Community Hub isolates Secondary Primary

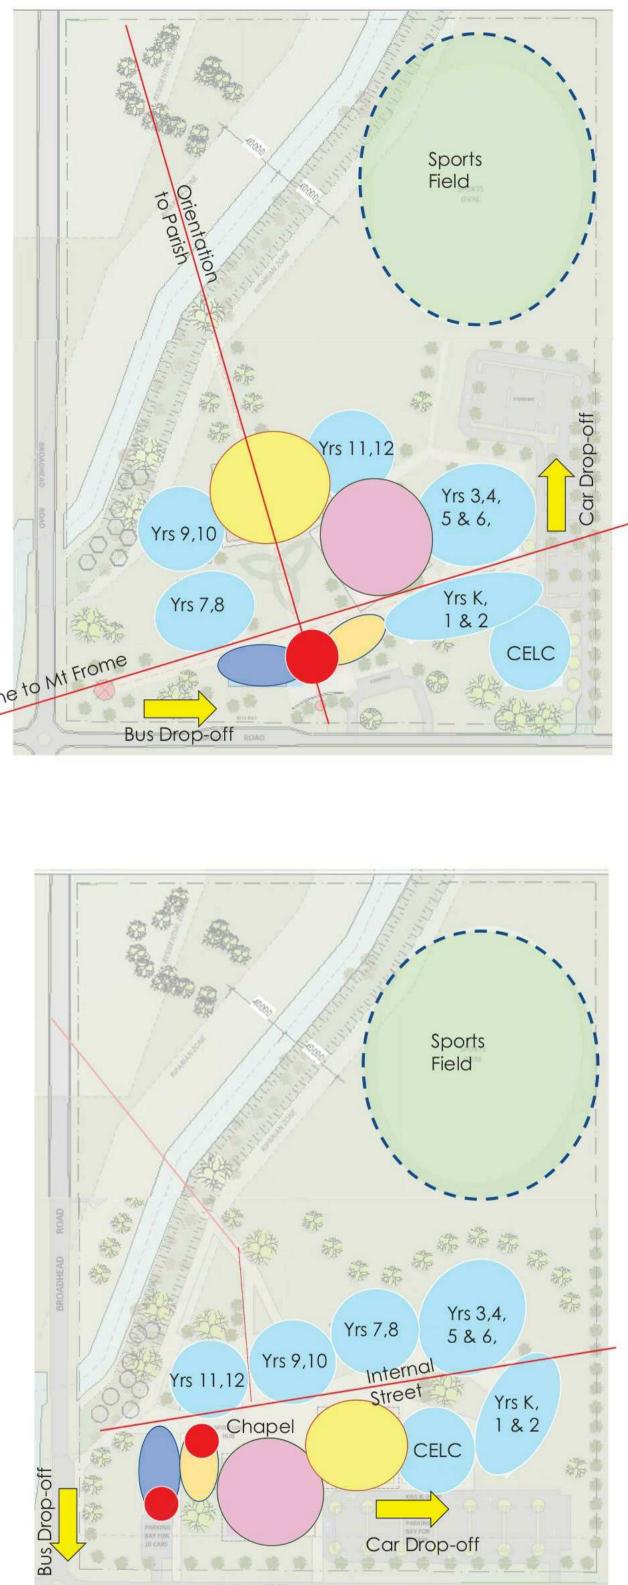

MASTERPLAN 3

Research / Technical / Creative Hub





Knowledge / Spiritual Hub




Professional Hub

Pro's

- Frontage to Broadhead Rd
- Connection to neighbourhood
- Bruce Rd traffic minimised
- Internal Street condenses pedestrian flow
- Close connection between Second Primary
- Good after-hours community access
- Single storey layout provides Staging flexibility

Con's

- Connection to "Nest in the Hills" not strong
- Access to Sports Field distant (perhaps)

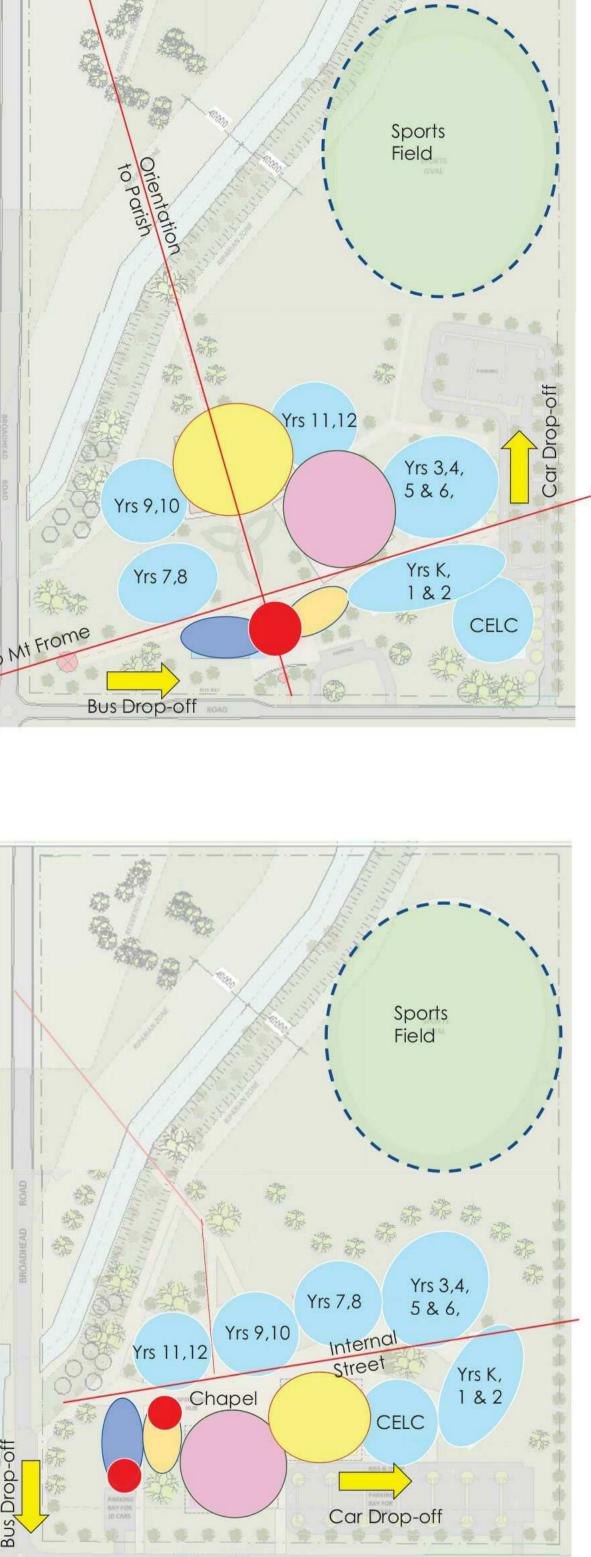

Masterplan 4 developed into the proposed scheme Condensed footprint minimises travel distances between facilities. Mt Frome sightline incorporated from Masterplan 1.







Community / Performance / Food Hub

Knowledge / Spiritual Hub



Professional Hub

Pro's

- Frontage to Broadhead Rd
- Good connection to neighbourhood & Hills
- Bruce Road traffic minimised
- Internal Street condenses pedestrian flow
- Close connection between Second Primary
- Good after-hours community access Single storey layout provides Staging flexibility

Con's

- "Front Door" distant from Visitor parking
- Front Door not immediately at street frontage
- Access to Sports Field distant (perhaps)





Community / Performance / Food Hub

Knowledge / Spiritual Hub




Pro's

- Frontage to Broadhead Rd
- Bruce Rd traffic minimised
- Internal Street condenses pedestrian flow
- 2-Storey layout results in "compact" footprint
- Good after-hours community access

Con's


- 2 storey layout limits Staging flexibility
- Access to Sports Field distant (perhaps)
- 2 storey layout obstructs connection to Hills

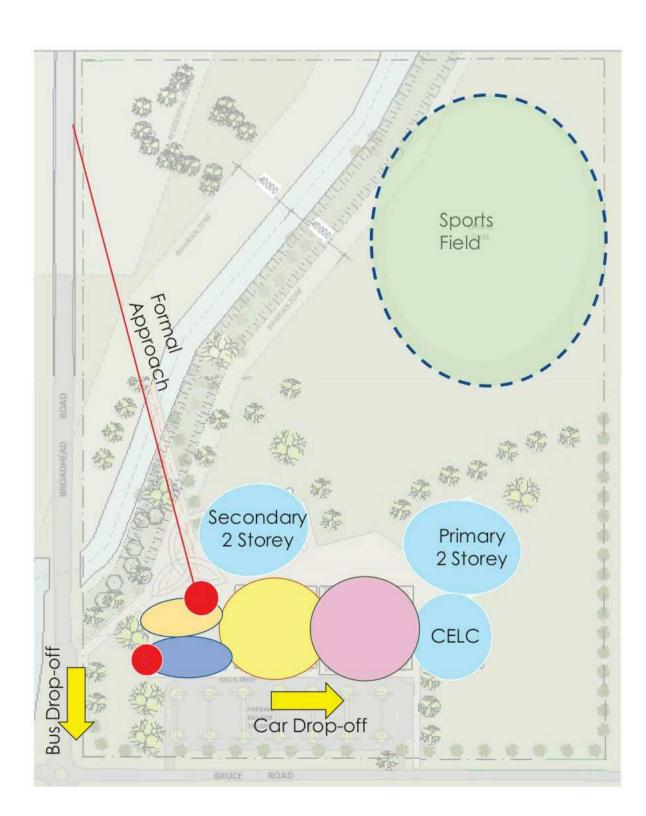

Car Drop-off

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SSDA- Project name adjusted	BLC	28.04.20	11
SSDA Issue, levels adjusted, dims added	BLC	01.04.20	10
GA NSW Issue	BLC	20.03.20	9
Preliminary SSDA Review	BLC	28.02.20	8
SSDA Documentation 90% Completion	DO	03.06.19	7
Client Workshop Presentation	BLC	14.05.19	6
DRAW NUMBERS ADJUSTED, Buildings moved, Elevations adjusted	BLC	08.05.19	5
ESD Consult Issue	BLC	02.05.19	4
Consultant Issue	BLC	12.04.19	3
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OMINATED ARCHIT	ECT : CHARLES G	LANVILLE NS	W REGISTRAT	TON No. 3
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ST MATTHEW'S CATHOLIC SCHOOL - Secondary Campus

Corner of BROADHEAD and BRUCE RD. MUDGEE Lot 40 of DP 756894

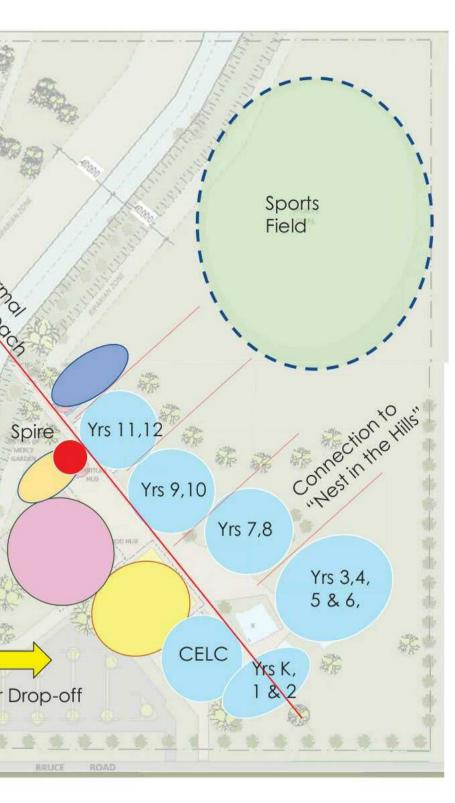STATE SIGNIFICANT DEVELOPMENT **APPLICATION**

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WORKS

EXTENT OF WORKS

Works are not proposed to the full site, but limited to the area shown white. This area shall be fenced. The large site area allows for ease of works with plenty of space for site containment, equipment and building supplies and works sheds with minimal disturbance to neighbours.

SERVICES & INFRASTRUCTURE

The site is serviced by water, sewer, electricity, data and road network. Some of these services shall need to be upgraded. A new substation and road works are proposed - refer to Engineers drawings for details.

FUTURE WORKS

Allowance is made for future works and associated construction zones, whilst maintaining uninterrupted operation of the school.

SITE USE It is considered that the un-utilised site area shall be maintained in its existing state. The school may periodically access this area for sporting or teaching purposes.

CRIME PREVENTION THROUGH DESIGN

a. Territorial re-enforcement

The Site is fenced with gates locked after hours (white area contained by perimeter fence) b. Surveillance:

Clustering designed with consideration to passive surveillance and supervision of students. c. Access Control:

Continous perimeter fencing provides secure enclosure with the Professional Hub fronting the primary access points and with sightlines over the entry points. The Community Hub can be accessed after hours directly from the car park. Waste collection is adjacent to the bus bay area via a separate gate, allowing after hour

access.

d. Space / Activity Management

Staff supervise students during school hours. Localised CCTV patrol key site access points after hours. Facilities likely to be used after hours (Community Hub, Professional Hub) are close to the car park and have clear line of sight to the access points for patrolling.

TRANSPORT

CAR ACCESS & PARKING:

Car access is provided from Bruce Road, with parking for visitors and staff. Drop-off zone is provide with extensive queuing provided to minimise peak hour congestion. Waste management services and servicing vehicles can access the site off Bruce Rd adjacent to the Bus Bay. Emergency vehicles can access the Blocks C & D from the service road, and all other

areas from traversing across the turf around Block D (Research Hub).

BICYLE & PEDESTRIAN ACCESS:

The primary pedestrian & bicycle path access is from Broadhead Rd, with vehicle access from Bruce Rd. Both throughfares flow into the heart of the school. Bike parking is adjacent to this throughfare, near the Chapel (Block B).

TRAVEL BY BUS:

The bus drop-off zones and turning bays have been designed in coordination with the local Bus operators, and allow for minimal operation disruption. The bus bays are proposed to the Bruce Rd verge for 3x standard buses with an on-site turning bay. Sweep paths are indicated on the plan, and sightline studies have been made to cater for trees and car movements.

ENVIRONMENTAL FACTORS

SUN CONTROL & DAYLIGHTING:

Typically in school facilities wall space is in high demand (TV's whiteboards) so glazed areas fit within the teaching demands. Glazed areas are generally maximised and shaded by large eaves reducing heat gain in summer months and glare. Window furnishings are provided for black-out provision to teaching spaces.

10

VENTILATION AND TEMPERATURE CONTROL:

Operable windows with flyscreens are provided generally with operable windows at high levels to help flush heat out. To teaching spaces large glazed areas allow the merging of separate spaces. Air conditioning is provided throughout habitable spaces. Large eaves sheild windows and walls of the strong summer sun and allow weak winter sun.

NOISE CONTROL:

Within the teaching spaces there is extensive use of acoustic pinboard wall linings and acoustic ceilings with minimal hard flooring finishes. Externally the large site means there is minimal disturbance to neighbouring properties, with the nearest dwelling a significant distance away.

OVERSHADOWING:

The buildings are clustered into hubs. The buildings generally have large eaves and there is a central Cola (Covered outdoor learning area) and covered ways which provide wet weather access. The buildings are located such that there are pockets of shade and pockets of sun, so there is opportunity for either according to the weather. The landscaping incorporates feature trees and open spaces so users can select sun or shade.

There is no overshading of neighbouring properties.

LANDSCAPING:

Refer to the Landscape plans for detail. The site landscaping attempts to marry indigenous and exotic plants into a unified scheme representing cultural heritage. The landscaping selection is sensitive to the water, soil and climatic requirements of the site and uses both soft and hard landscaping solutions. Rainwater harvesting provides irrigation to plants where required. The landscaping also incorporates Catholic symbols including a statue of St Matthew. These are central to the school identity and its role in the community.

WATER AND ENERGY USE:

Large roofs collect the water into localised rainwater tanks which serve the toilets and irrigation. An additional large underground tank catches overflow and tops the tanks up when depleted.

Investigations have been carried out on the viability of geothermal air conditioning on appropriate biuldings and photovoltaic systems. Air conditioning systems and lighting controls utilise movement sensors to help control

operations and shut off systems where appropriate. Lighting is typically LED with high LUX levels required to teaching areas.


The electrical systems are generally centrally controlled with separate system to allow for potential of after hours use to the Community Hub and Professional Hub.

Outdoor and security lighting is provided to the car park, entry avenue, entry points and Cola. The elevated lights are shielded to prevent light spill. There is not expected to be any significant light pollution to the neighbouring properties or street.

DURABILITY:

Materials are generally selected to be factory finished so as to be more robust, maintenance free and durable, which helps minimise waste. ADAPTIBILITY & FLEXIBILITY:

The buildings are of lightweight construction with concrete floors and steel roof framing. Walls are steel framed with brickwork base (to deal with wear and tear) and painted fibre cement or steel cladding over. The stucture is independent of the walls providing opportunity for later removal/movement. Large glazed areas are provided generally providing good connection between and through spaces.

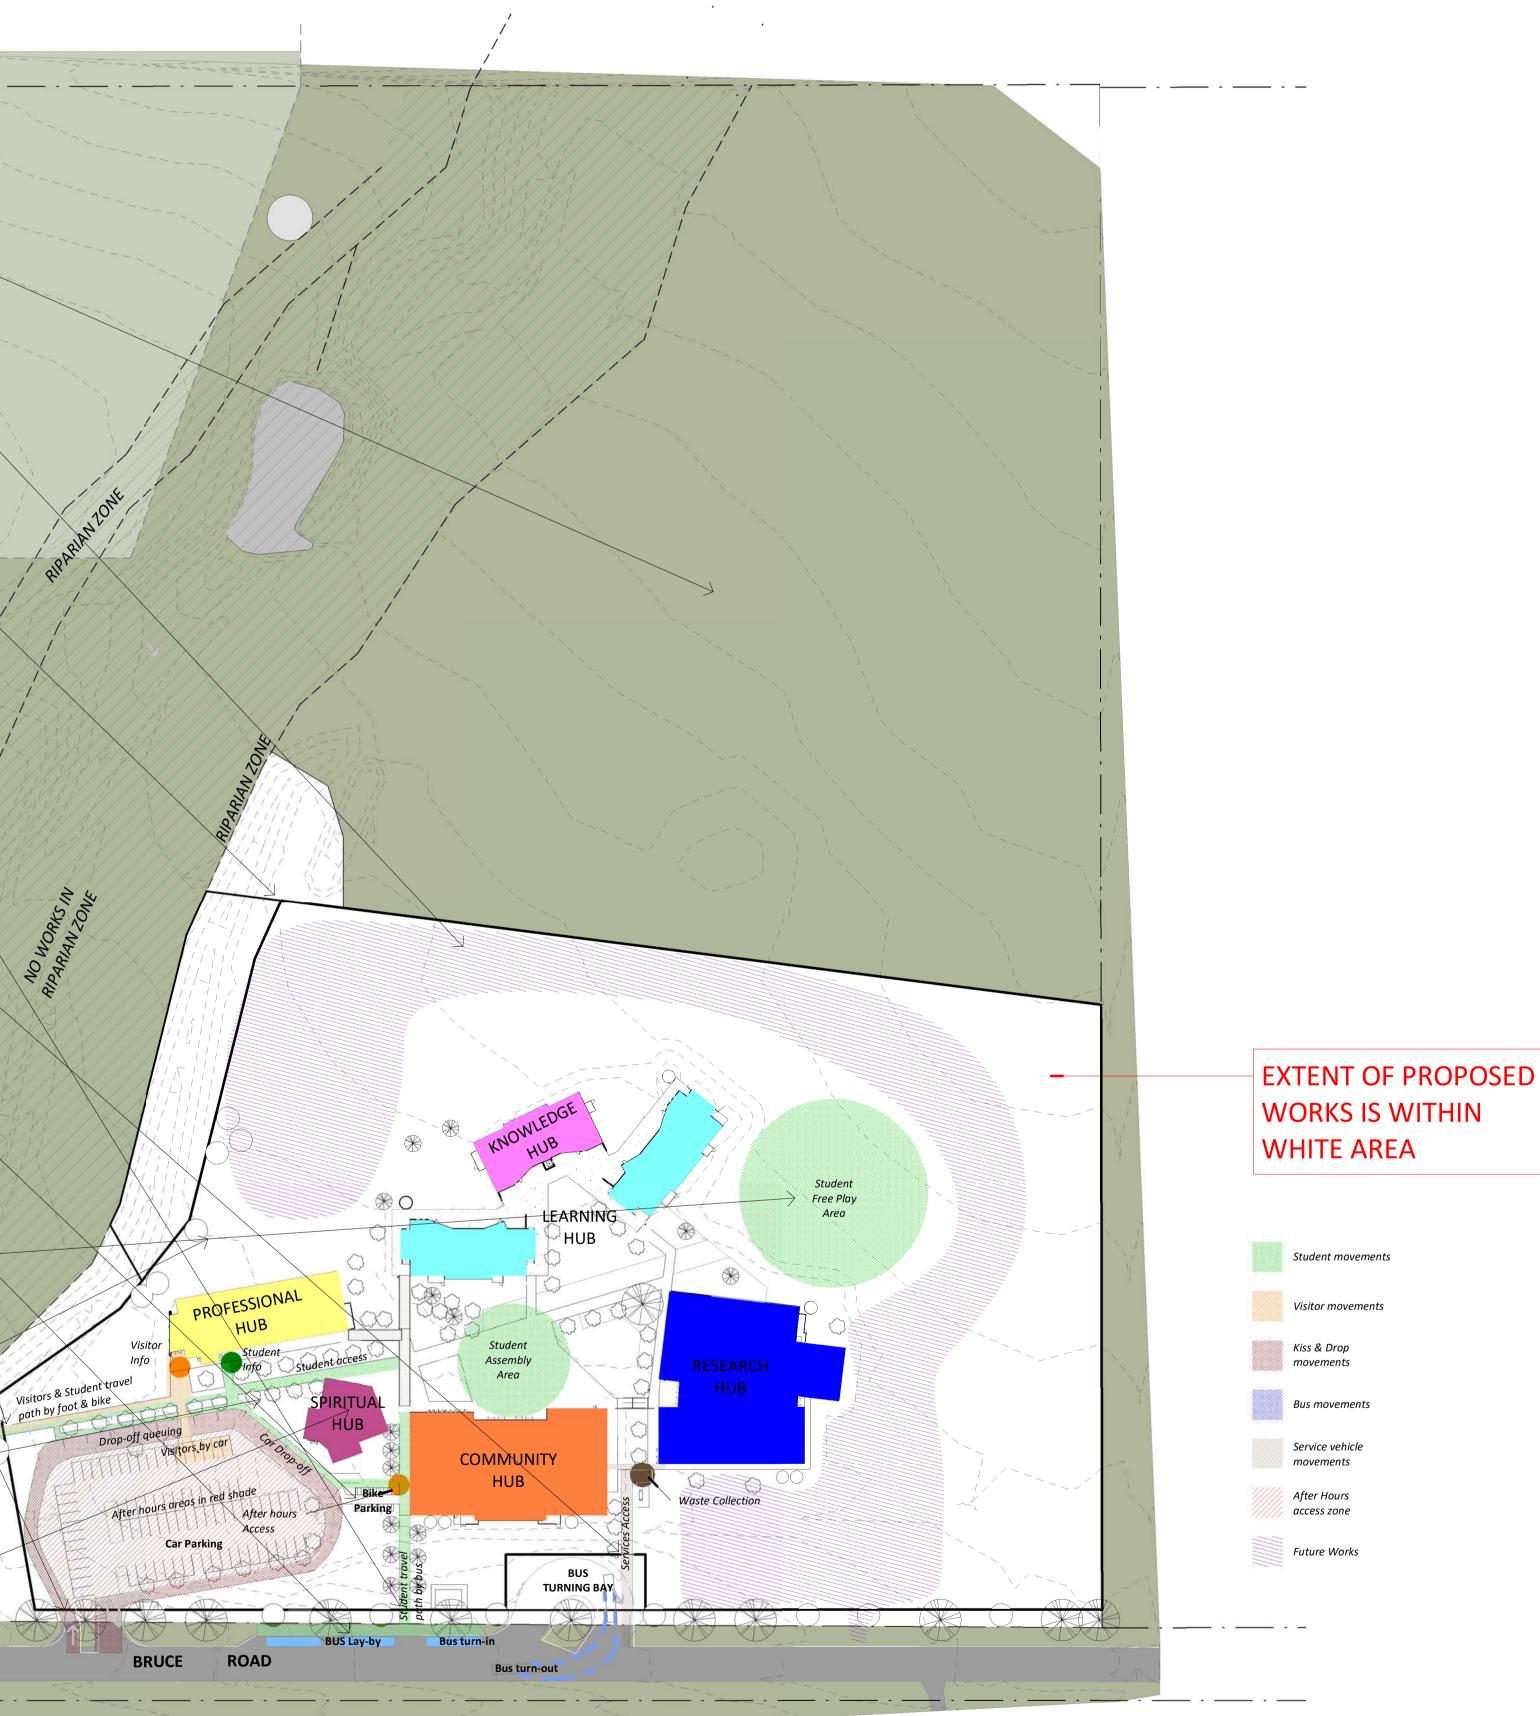

SITE STRATEGY PLAN 18150

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SSDA- Project name adjusted

Preliminary SSDA Review

Site Plan, Block B & F adjusted

Carpark, paths, Block B Adjusted

Client Workshop Presentation

moved, Elevations adjusted

purpose of issue

GA NSW Issue

SSDA Issue, levels adjusted, dims added

SSDA Documentation 90% Completion

DRAW NUMBERS ADJUSTED, Buildings

CATHOLIC =

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NOMINATED ARCHITECT : CHARLES GLANVILLE NSW REGISTRATION No. 3130

ST MATTHEW'S CATHOLIC

SCHOOL - Secondary Campus

Corner of BROADHEAD and

STATE SIGNIFICANT

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project no.

BRUCE RD. MUDGEE

Lot 40 of DP 756894

DEVELOPMENT

APPLICATION

ARCHITECTUR

BLC 28.04.20

BLC 20.03.20

BLC 28.02.20

BLC 19.09.19

DO 03.06.19

BLC 22.05.19

BLC 14.05.19

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by date issue no.

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Visitor movements

movements

movements

After Hours access zone

Future Works

Service vehicle

Student movements

Kiss & Drop

Bus movements



keyplan

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SSDA- Project name adjusted BLC 28.04.20 16 SSDA Issue, levels adjusted, dims added BLC 01.04.20 15 GA NSW Issue BLC 20.03.20 14 Trees adjusted to Arborist Reports BLC 05.03.20 13 Preliminary SSDA Review BLC 28.02.20 Site Plan, Block B & F adjusted BLC 19.09.19 11 Block B & F adjusted BLC 30.08.19 10 Access adjust, dis car added BLC 31.07.19 SSDA Documentation 90% Completion DO 03.06.19 Block Labels Added, Artefact Removed DO 27.5.19 purpose of issue by date issue no.

architect





project

ST MATTHEW'S CATHOLIC SCHOOL - Secondary Campus

address

Corner of BROADHEAD and BRUCE RD. MUDGEE Lot 40 of DP 756894

STATE SIGNIFICANT DEVELOPMENT APPLICATION

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EXTENT OF WORKS



PART SITE PLAN 1:500

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PART SITE PLAN

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ROOF NOTES

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1 Photovoltaic panel layout indicative only

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NOMINATED ARCHITECT : CHARLES GLANVILLE NSW REGISTRATION No. 3130

ST MATTHEW'S CATHOLIC

SCHOOL - Secondary Campus

Corner of BROADHEAD and

STATE SIGNIFICANT

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scale:

BRUCE RD. MUDGEE

Lot 40 of DP 756894

DEVELOPMENT

APPLICATION

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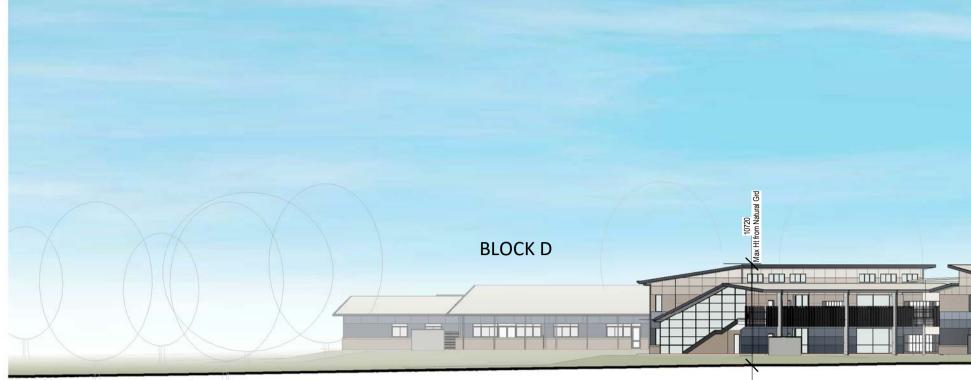
TSA

SDA- Project name adjusted	BLC 28.04.20	
SDA Issue, levels adjusted, dims added	BLC 01.04.20	
A NSW Issue	BLC 20.03.20	
ite Plan, Block B & F adjusted	BLC 19.09.19	
SDA Documentation 90% Completion	DO 03.06.19	
arpark, paths, Block B Adjusted	BLC 22.05.19	
lient Workshop Presentation	BLC 14.05.19	
RAW NUMBERS ADJUSTED, Buildings	BLC 08.05.19	
noved Elevations adjusted		

ROOF PLA	١N
	sheet
DA010	9

18150

graphic scale



NORTH ELEVATION




WEST ELEVATION






BLOCK E	BLOCK B	BLOCK A	11 from Nat Gd

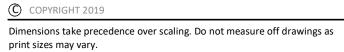

keyplan

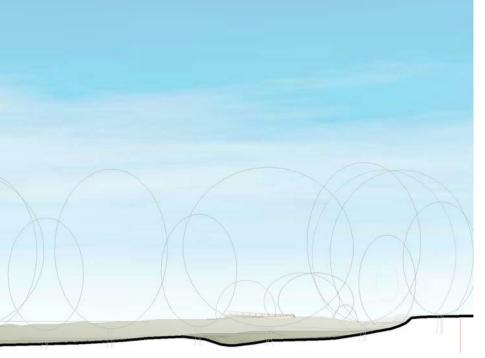

purpose of issue	by	date	issue no.
GANSW Review	BLC	20.03.19	1
moved, Elevations adjusted			
DRAW NUMBERS ADJUSTED, Buildings	BLC	08.05.19	2
Client Workshop Presentation	BLC	14.05.19	3
Carpark, paths, Block B Adjusted	BLC	22.05.19	4
SSDA Documentation 90% Completion	DO	03.06.19	5
Site Plan, Block B & F adjusted	BLC	19.09.19	6
GA NSW Issue	BLC	20.03.20	7
SSDA Issue, levels adjusted, dims added	BLC	01.04.20	8
SSDA- Project name adjusted	BLC	28.04.20	9







project

ST MATTHEW'S CATHOLIC SCHOOL - Secondary Campus

address

Corner of BROADHEAD and BRUCE RD. MUDGEE Lot 40 of DP 756894

STATE SIGNIFICANT DEVELOPMENT APPLICATION


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	verified:	CG
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north	scale:	1 : 400
graphic scale		6

STREET ELEVATIONS sheet


DA011 9




NORTH SOUTH SECTION 1:400

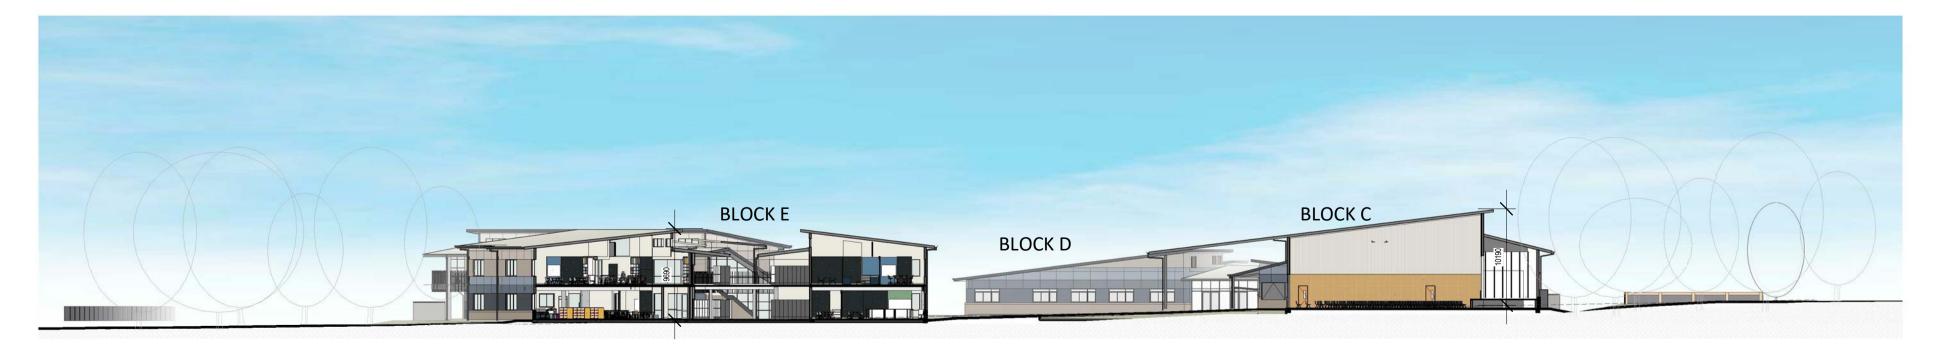


WEST EAST SECTION 1 : 400

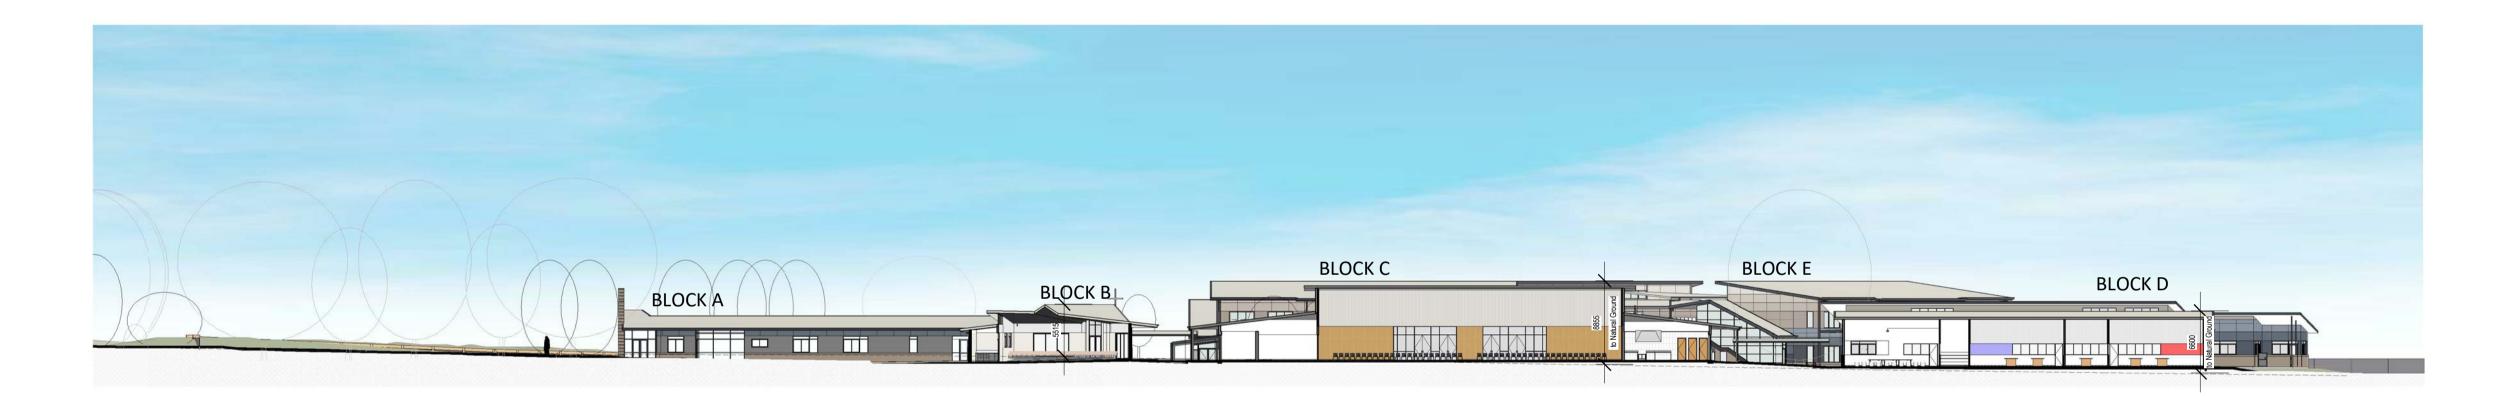

EAST ELEVATION 1:400

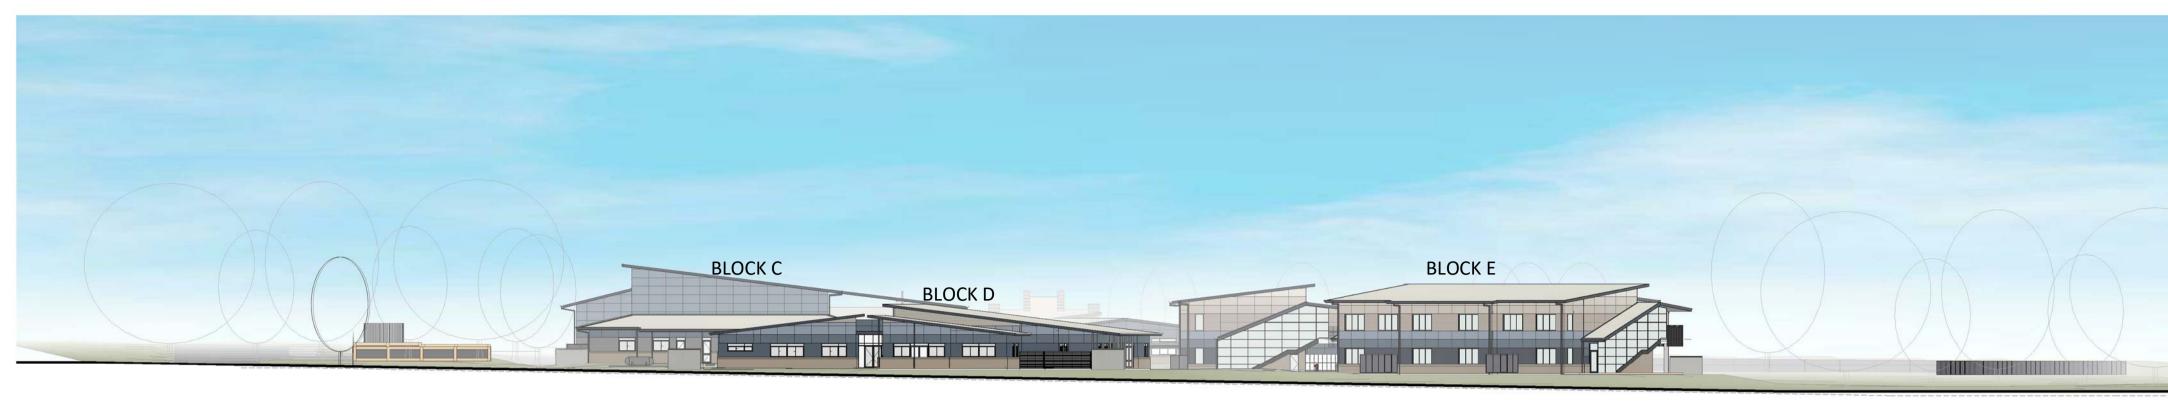


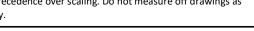

keyplan

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NOMINATED ARCHITECT : CHARLES GLANVILLE NSW REGISTRATION No. 3130

CATHOLIC EDUCATION DIOCESE OF BATHURST

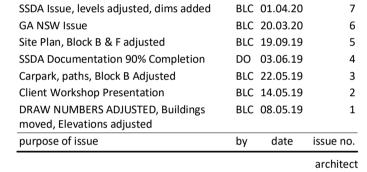BLC 28.04.20

TSA

project

SSDA- Project name adjusted

address Corner of BROADHEAD and BRUCE RD. MUDGEE Lot 40 of DP 756894

ST MATTHEW'S CATHOLIC

SCHOOL - Secondary Campus

STATE SIGNIFICANT DEVELOPMENT APPLICATION


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graphic scale		6

STREET ELEVATIONS AND SITE SECTIONS


18150

DA012

8

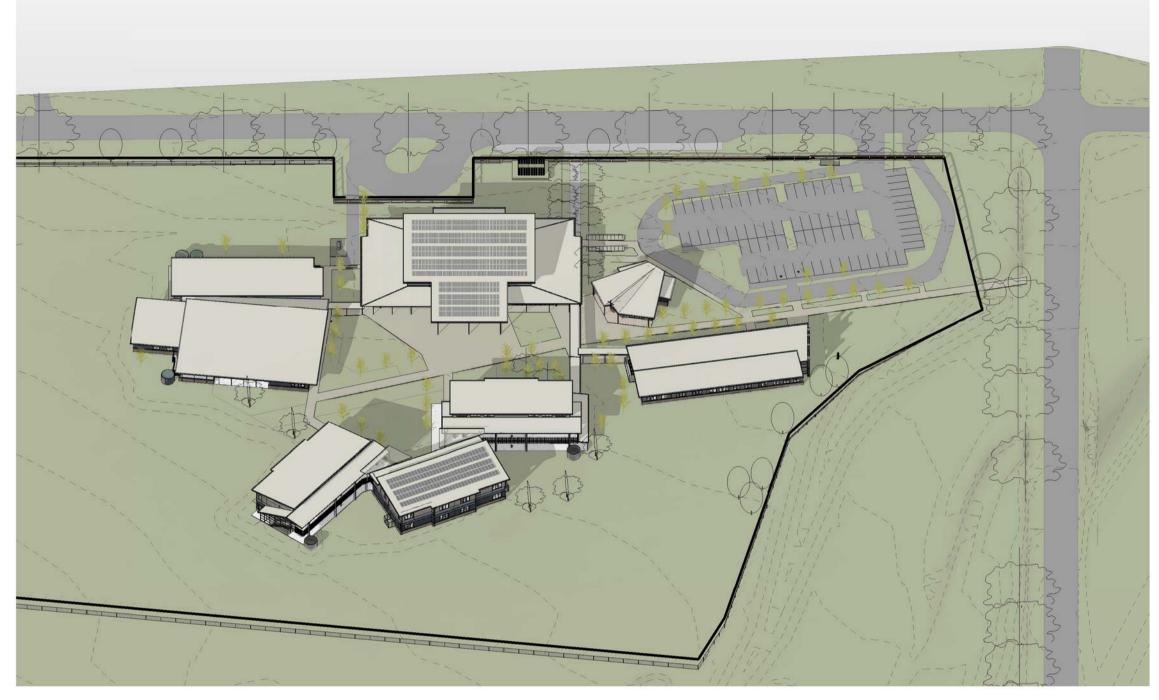

AXONOMETRIC - FROM NORTH

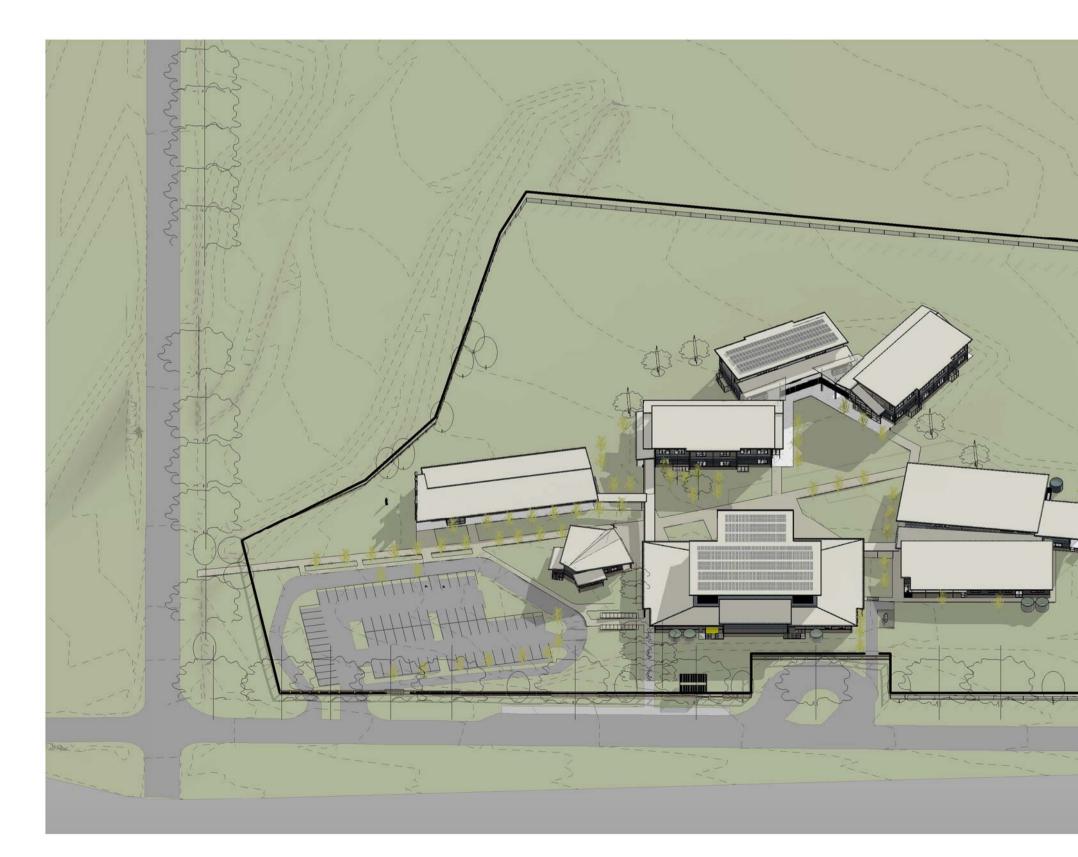


AXONOMETRIC FROM SOUTH



AXONOMETRIC VIEW from SE




AXONOMETRIC VIEW from West

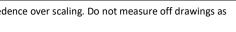

keyplar

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SSDA- Project name adjusted

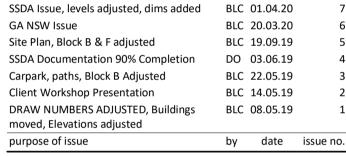

BLC 28.04.20

	СНТ	T E C		E
1INATED ARC	HITECT : CHARLE	S GLANVILLE N	SW REGISTRAT	ION No. 3130



project

ST MATTHEW'S CATHOLIC SCHOOL - Secondary Campus

address

Corner of BROADHEAD and BRUCE RD. MUDGEE Lot 40 of DP 756894

STATE SIGNIFICANT DEVELOPMENT APPLICATION

	drawn:	BLC
	checked:	BLC
	verified:	CG
	sheet size:	A1
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graphic scale		6








SOLAR STUDY - 22 JUNE 9AM SCALE 1:1000



SCALE 1:1000

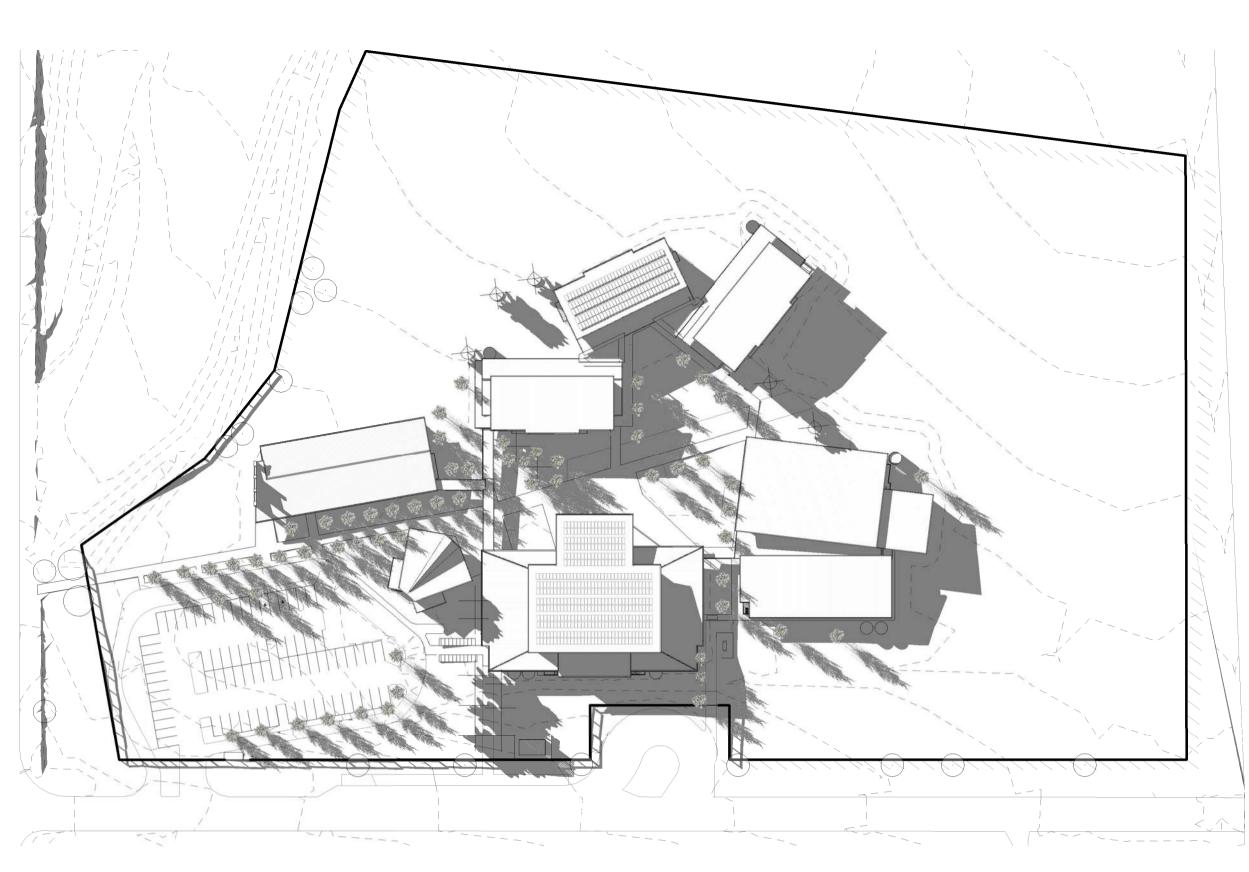

SOLAR STUDY - 22 JUNE 3PM SCALE 1:1000 C COPYRIGHT 2019

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keyplan

purpose of issue	by	date	issue no.
moved, Elevations adjusted			
DRAW NUMBERS ADJUSTED, Buildings	BLC	08.05.19	1
Client Workshop Presentation	BLC	14.05.19	2
Carpark, paths, Block B Adjusted	BLC	22.05.19	3
SSDA Documentation 90% Completion	DO	03.06.19	4
Site Plan, Block B & F adjusted	BLC	19.09.19	5
GA NSW Issue	BLC	20.03.20	6
SSDA Issue, levels adjusted, dims added	BLC	01.04.20	7
SSDA- Project name adjusted	BLC	28.04.20	8

architect





project

ST MATTHEW'S CATHOLIC SCHOOL - Secondary Campus

address

Corner of BROADHEAD and BRUCE RD. MUDGEE Lot 40 of DP 756894

STATE SIGNIFICANT DEVELOPMENT APPLICATION

	drawn:	EJ
	checked:	BLC
	verified:	CG
	sheet size:	A1
north	scale:	
graphic scale		6

SHADOW DIAGRAMS -Part Site Plan

18150	DA014	8
project no.	sheet no.	issue



SCHOOL IDENTITY:

The school Administration building shall have a stainless steel "cross" mounted on the brick facade which addresses Broadhead Rd entry.

A statue of St Matthews shall be --placed central to the brick facade wall, reinforcing the school identity

SIGNAGE NOTES:

2x proprietary digital LED signboards proposed, both to the same specification. Both signboards to incorporate a digital board with fixed school signage and perimeter powdercoated steel frame & supporting posts.

One signboard fronting Broadhead Rd, angled to approaching southbound traffic. Another signboard perpendicular to Bruce Rd carpark entry.

The digital displays shall be static daily displays, not animated displays. The digital displays shall be used for school community notices such as: "Welcome back", "Congratulations Year 12", "Term 2 starts"



INDICATIVE DIGITAL SIGNBOARD DIAGRAM

PART SITE PLAN - SIGNAGE

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SSDA- Project name adjusted BLC 28.04.20 BLC 16.04.20 Signage Review purpose of issue by date issue no architect





ST MATTHEW'S CATHOLIC SCHOOL - Secondary Campus

Corner of BROADHEAD and BRUCE RD. MUDGEE Lot 40 of DP 756894


STATE SIGNIFICANT DEVELOPMENT APPLICATION

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	verified:	CG
	sheet size:	A1
north	scale:	1 : 500
graphic scale		6

SIGNAGE DIAGRAM

18150

DA015

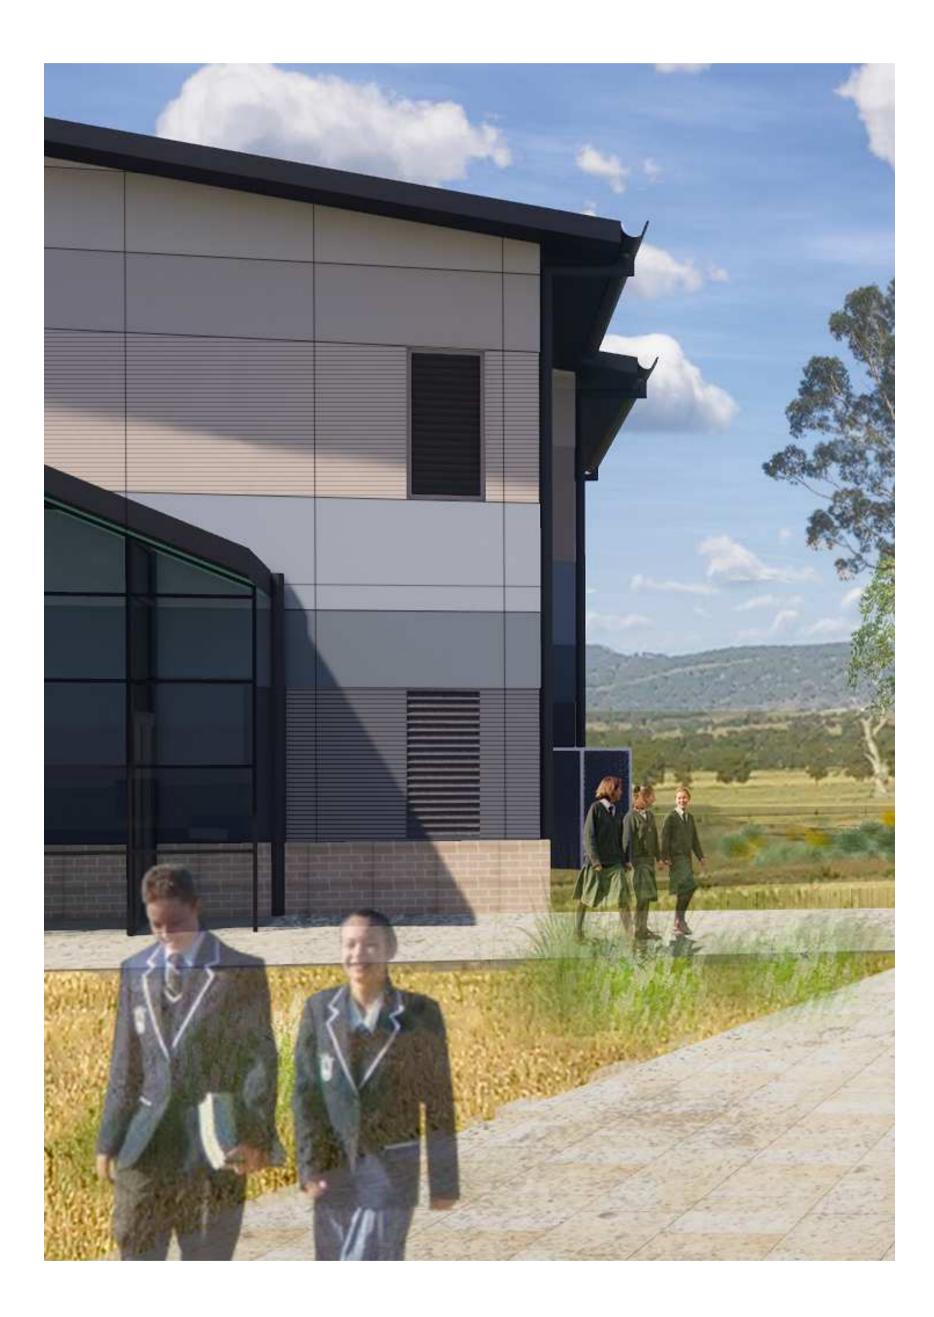

		ROOF AND FASCIA COLORBOND
		FIBRE CEMENT PANELS 900MM
		FIBRE CEMENT PANELS 900MM
		FIBRE CEMENT PANELS 900MM
1		COLORBOND PANELS 1800MM
ł		
		— FIBRE CEMENT PANELS 900MM
		— FIBRE CEMENT PANELS 400MM
		FIBRE CEMENT PANELS 900MM
		COLORBOND PANELS 1800MM
		FACE BRICK 900MM

Dimensions take precedence over scaling. Do not measure off drawings as print sizes may vary.

keyplan



DULUX TO MATCH COLORBOND IRONSTONE

DULUX PHANTOM WHITE (SN3E1)

DULUX BEIGE ANTIQUITY (SN3F2)

DULUX BEIGE INTENT (SN3E4)

DULUX TO MATCH COLORBOND DUNE

DULUX OZONE

DULUX OZONE

DULUX MIRAGE

(S38A3)

(S38A3)

(S38A5)

SSDA- Project name adjusted	BLC 28.04.20 7
SSDA Issue, levels adjusted, dims added	BLC 01.04.20 6
GA NSW Issue	BLC 20.03.20 5
SSDA Documentation 90% Completion	DO 03.06.19 4
Chapel Options Re Issue	BLC 23.05.19 3
Client Workshop Presentation	BLC 14.05.19 2
DRAW NUMBERS ADJUSTED, Buildings moved, Elevations adjusted	BLC 08.05.19 1
purpose of issue	by date issue no.

architect



NOMINATED ARCHITECT : CHARLES GLANVILLE NSW REGISTRATION No. 3130



project

ST MATTHEW'S CATHOLIC SCHOOL - Secondary Campus

address

Corner of BROADHEAD and BRUCE RD. MUDGEE Lot 40 of DP 756894

STATE SIGNIFICANT DEVELOPMENT APPLICATION

	drawn:	DO
	checked:	BLC
	verified:	CG
	sheet size:	A1
north	scale:	1 : 2000
graphic scale		6

DULUX TO MATCH COLORBOND IRONSTONE

FACE BRICK, REFER TO FINISHES SCHEDULE

MATERIAL SCHEDULE

18150

DA021

project no.

sheet no.


issue



ginal Sheet Size A1 - 841 x 594mm 28/04/2020 10:20:34 Al@\Users\bcooper.ALLEANZA\Documents\18150_Mudgee Site (Central)_ben.cooperJAUAV.rvt

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SSDA- Project name adjustedBLC28.04.20SSDA Issue, levels adjusted, dims addedBLC01.04.20GA NSW IssueBLC20.03.20SSDA Documentation 90% CompletionDO03.06.19Client Workshop PresentationBLC14.05.19DRAW NUMBERS ADJUSTED, BuildingsBLC08.05.19moved, Elevations adjustedbydateissue not

by date issue no. architect

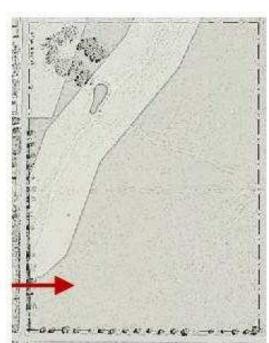



project

ST MATTHEW'S CATHOLIC SCHOOL - Secondary Campus

address

Corner of BROADHEAD and BRUCE RD. MUDGEE Lot 40 of DP 756894

STATE SIGNIFICANT DEVELOPMENT APPLICATION

	drawn:	BLC
	checked:	BLC
	verified:	CG
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north	scale:	1 : 500
graphic scale		6

VIEW ANALYSIS -BROADHEAD ROAD

18150

DA022

6




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keyplan



SSDA- Project name adjusted	BLC	28.04.20	6
SSDA Issue, levels adjusted, dims added	BLC	01.04.20	5
GA NSW Issue	BLC	20.03.20	4
SSDA Documentation 90% Completion	DO	03.06.19	3
Client Workshop Presentation	BLC	14.05.19	2
DRAW NUMBERS ADJUSTED, Buildings	BLC	08.05.19	1
moved, Elevations adjusted			
purpose of issue	by	date	issue no.

architect

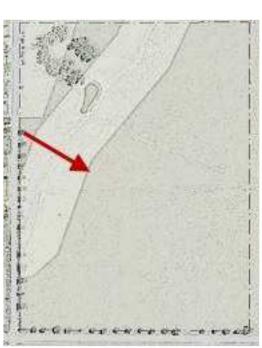



project

ST MATTHEW'S CATHOLIC SCHOOL - Secondary Campus

address

Corner of BROADHEAD and BRUCE RD. MUDGEE Lot 40 of DP 756894

STATE SIGNIFICANT DEVELOPMENT APPLICATION

	drawn:	DO
	checked:	BLC
	verified:	CG
	sheet size:	A1
north	scale:	1 : 500
graphic scale		6

VIEW ANALYSIS -BROADHEAD ROAD

18150


DA023



inal Sheet Size A1 - 841 x 594mm 28/04/2020 10:20:39 Att Visers \bcooper. ALLEANZA\Documents \18150_Mudgee Site (Central)_ben.cooper/AUAV.rvf

COPYRIGHT 2019 Dimensions take precedence over scaling. Do not measure off drawings as print sizes may vary.

kevplan

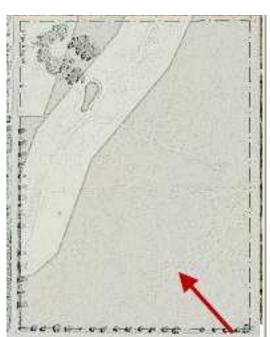



purpose of issue	by	date	issue no.
moved, Elevations adjusted			
DRAW NUMBERS ADJUSTED, Buildings	BLC	08.05.19	1
Client Workshop Presentation	BLC	14.05.19	2
Carpark, paths, Block B Adjusted	BLC	22.05.19	3
SSDA Documentation 90% Completion	DO	03.06.19	4
GA NSW Issue	BLC	20.03.20	5
SSDA Issue, levels adjusted, dims added	BLC	01.04.20	6
SSDA- Project name adjusted	BLC	28.04.20	7

architect





project

ST MATTHEW'S CATHOLIC SCHOOL - Secondary Campus

address

Corner of BROADHEAD and BRUCE RD. MUDGEE Lot 40 of DP 756894

STATE SIGNIFICANT DEVELOPMENT APPLICATION

	drawn:	BLC
	checked:	BLC
	verified:	CG
	sheet size:	A1
north	scale:	1 : 500
graphic scale		6

VIEW ANALYSIS -BRUCE ROAD

18150

DA024





Dimensions take precedence over scaling. Do not measure off drawings as print sizes may vary.

keyplan

Administration Building Services

- Enclosed Circulation GLA-Secondary
- Multi-Purpose Hall
- Performing Arts Pupil Facilites
- Resource Centre
- TAS Science
- TAS-Food Technology
- Visual Arts

A DA103

Administration		
Name	Area	
	E m ²	
ACC. WC ACC. WC/Shr	5 m ²	
	3 m ²	
AMB. WC AMB. WC	3 m ²	
BOOTH	Not Placed	
	5 m ²	
BOOTH	•	
COMMS	10 m ²	
COMPACTUS	12 m ²	
CORRIDOR	44 m ²	
EDB	2 m ²	
FOYER	29 m ²	
H.O.C.	10 m ²	
INTERVIEW 1	9 m²	
INTERVIEW 2	10 m ²	
KITCHEN	22 m ²	
LEADERSHIP	16 m ²	
MEETING 1	24 m²	
MEETING 2	15 m²	
MISSION	10 m ²	
P.A.	10 m ²	
PRINCIPAL	16 m ²	
PRINT.	21 m ²	
RECEPTION	49 m ²	
SICK BAY	11 m ²	
STAFF ROOM	83 m ²	
STAFF STUDY	192 m ²	
STUDENT FOYER	24 m ²	
WC	2 m ²	
WC	2 m ²	
WC	2 m ²	
WC	2 m ²	
WC / SHOWER	4 m ²	
Grand total area	654 m²	

SSDA- Project name adjusted	BLC 28.04.20	18
SSDA- BCA & Access Update	BLC 21.04.20	17
SSDA Issue, Legend Updated	BLC 03.04.20	16
SSDA Issue, levels adjusted, dims added	BLC 01.04.20	15
GA NSW Issue	BLC 20.03.20	14
Preliminary SSDA Review	BLC 28.02.20	13
Block A Draft Single Storey	BLC 21.01.20	12
Design Development Sign off	CG 21.10.19	11
Access adjust, dis car added	BLC 31.07.19	10
SSDA Documentation 90% Completion	DO 03.06.19	9
purpose of issue	by date	issue no.

architect







project

ST MATTHEW'S CATHOLIC SCHOOL - Secondary Campus

address

Corner of BROADHEAD and BRUCE RD. MUDGEE Lot 40 of DP 756894


STATE SIGNIFICANT DEVELOPMENT APPLICATION

	drawn:	BLC
(Λ)	checked:	CG
	verified:	CG
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north	scale:	1 : 100
graphic scale		6



issue



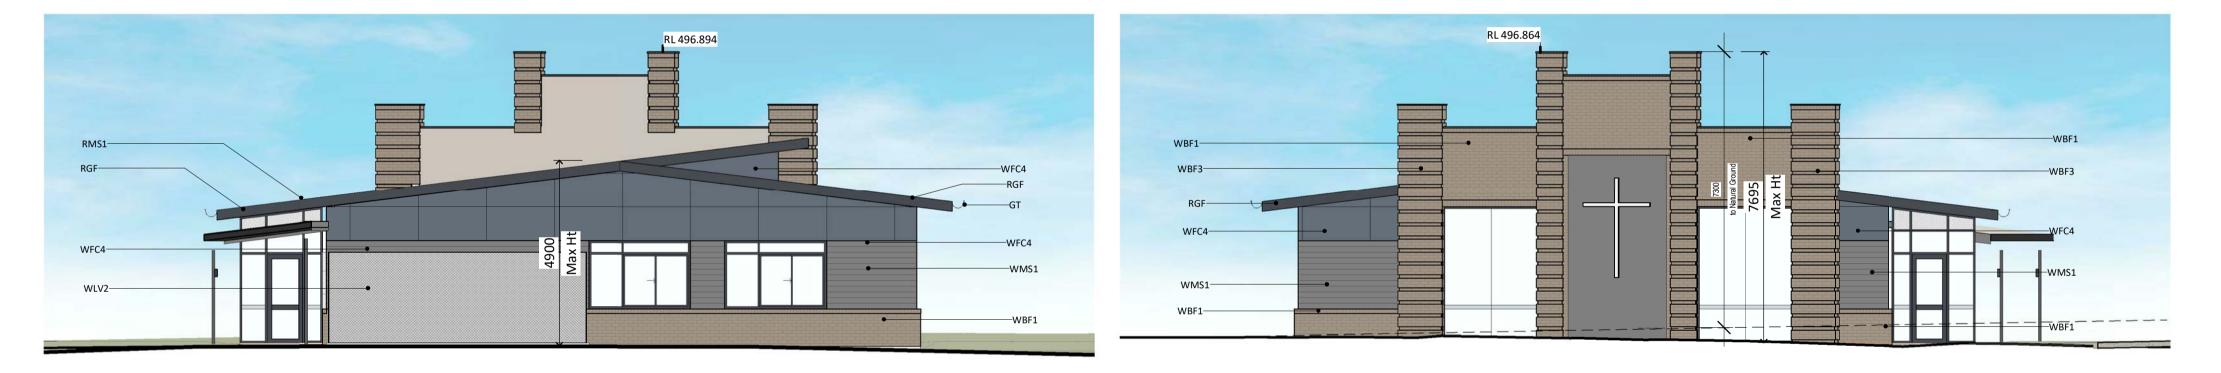

BLOCK A - EAST ELEVATION




BLOCK A - SOUTH ELEVATION 1 : 100

BLOCK A - WEST ELEVATION

C COPYRIGHT 2019

Dimensions take precedence over scaling. Do not measure off drawings as print sizes may vary.

	keyplan				
	LEGEND				
CODE	DESCRIPTION				
BAL-1	Balustrade & handrail - type 1 to details				
DP	Downpipe				
GT	Gutter refer to hydraulic engineer				
LOC1	Lockers - Student				
РСР	Painted concrete column				
PSC	Painted steel column				
RBC	Colorbond metal Barge capping				
RGF	Colorbond metal gutter & fascia				
RMS1	Colorbond profiled metal roof sheet - type 1				
RMS2	Colorbond profiled metal roof sheet - type 2				
RPS	Polycarbonate roof sheet				
RWT	Rain water tank				
SL	Metal profiled Soffit Lining				
WBF	Face brickwork				
WBF1	Face brickwork - type 1				
WBF3	Face brickwork - type 3				
WFC1	Painted fibre cement cladding type 1				
WFC2	Painted fibre cement cladding type 2				
WFC3	Painted fibre cement cladding type 3				
WFC4	Painted fibre cement cladding type 4				
WFC5	Painted fibre cement cladding type 5				
WFC6	Painted fibre cement cladding type 6				
WFC7	Painted fibre cement cladding type 7				
WFC8	Painted fibre cement cladding type 8				
WFC9	Painted fibre cement cladding type 9				
WFC.1					
WLV1	Louvre screen - type 1				
WLV2	Louvre screen - type 2				
WMS1	Profiled metal sheet cladding - type 1				
WMS2	Profiled metal sheet cladding - type 2				
WPL4	Pinboard lining - type 4				

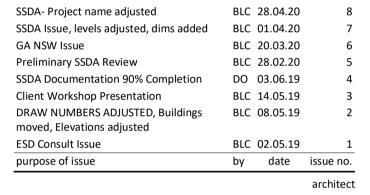



NOMINATED ARCHITECT : CHARLES GLANVILLE NSW REGISTRATION No. 3130



project

ST MATTHEW'S CATHOLIC SCHOOL - Secondary Campus

address

Corner of BROADHEAD and BRUCE RD. MUDGEE Lot 40 of DP 756894

STATE SIGNIFICANT DEVELOPMENT APPLICATION

	drawn:	DO
	checked:	BLC
	verified:	CG
	sheet size:	A1
north	scale:	1 : 100
graphic scale		6




18150 DA102


sheet n

issue


8

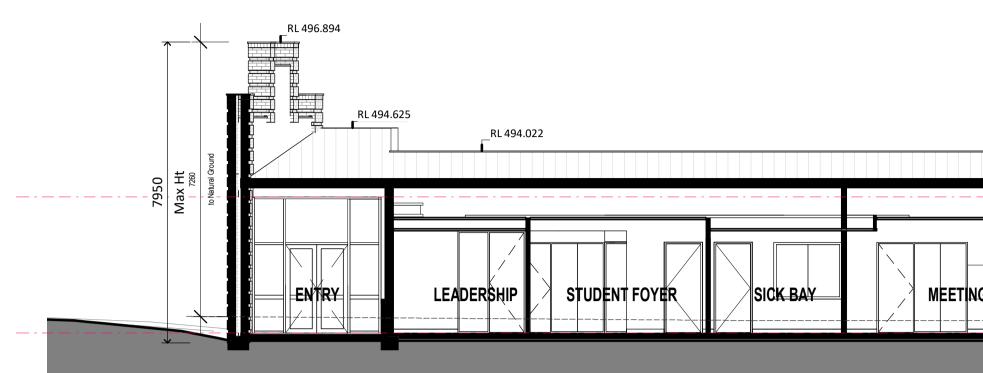



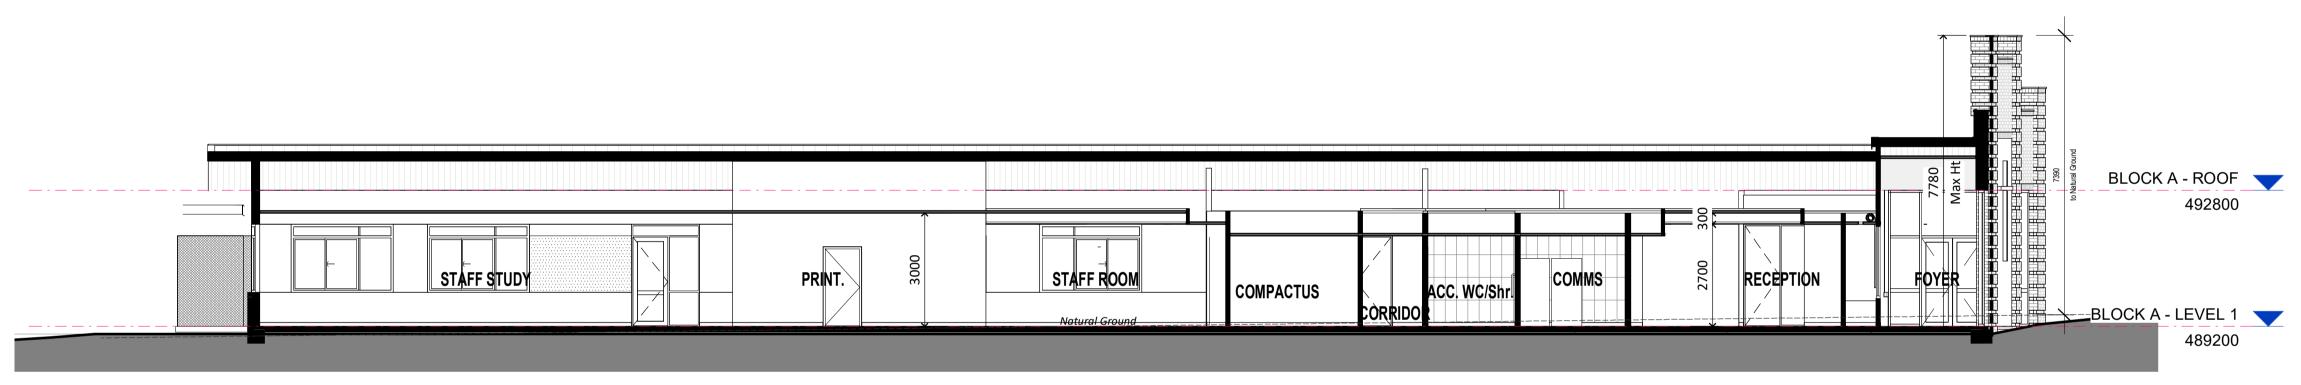



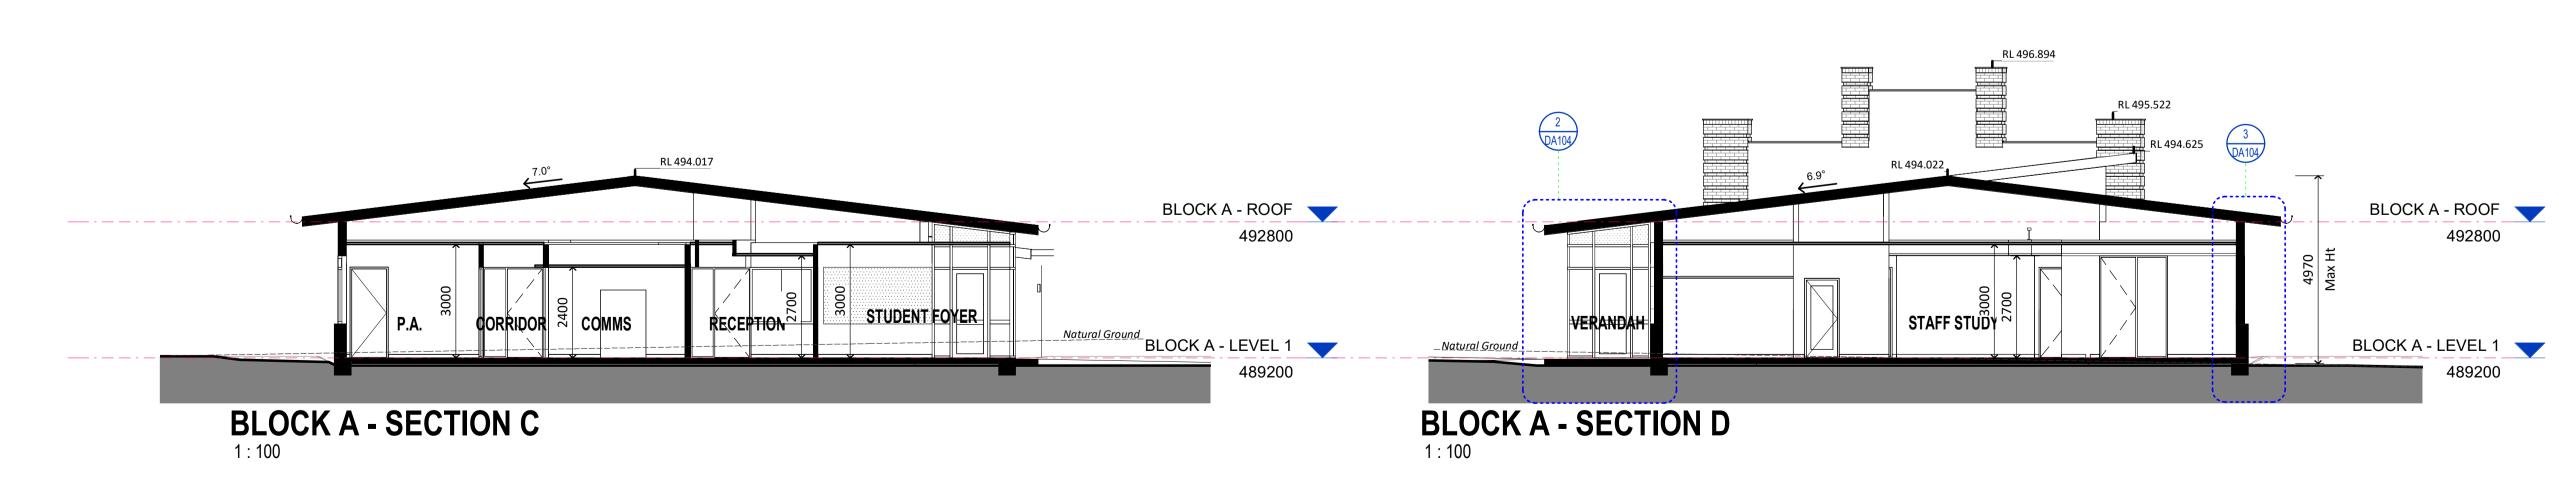

				1 DA104
				BLOCK A - R 492
NG 1	KITCHEN	AMB. WC CORR. WC	STAFF STUDY	PLANT BLOCK A - LEV
				48

Dimensions take precedence over scaling. Do not measure off drawings as print sizes may vary.

		keyplan		
LEGEND				
CODE	DESCRIPTION			
BAL-1	Balustrade & handrail - type 1 to details			
DP	Downpipe			
GT	Gutter refer to hydraulic engineer			
LOC1	Lockers - Student			
РСР	Painted concrete column			
PSC	Painted steel column			
RBC	Colorbond metal Barge capping			
RGF	Colorbond metal gutter & fascia			
RMS1	Colorbond profiled metal roof sheet - type 1			
RMS2	Colorbond profiled metal roof sheet - type 2			
RPS	Polycarbonate roof sheet			
RWT	Rain water tank			
SL	Metal profiled Soffit Lining			
WBF	Face brickwork			
WBF1	Face brickwork - type 1			
WBF3	Face brickwork - type 3			
WFC1	Painted fibre cement cladding type 1			
WFC2	Painted fibre cement cladding type 2			
WFC3	Painted fibre cement cladding type 3			
WFC4	Painted fibre cement cladding type 4			
WFC5	Painted fibre cement cladding type 5			
WFC6	Painted fibre cement cladding type 6			
WFC7	Painted fibre cement cladding type 7			
WFC8	Painted fibre cement cladding type 8			
WFC9	Painted fibre cement cladding type 9			
WFC.1				
WLV1	Louvre screen - type 1			
WLV2	Louvre screen - type 2			
WMS1	Profiled metal sheet cladding - type 1			
WMS2	Profiled metal sheet cladding - type 2			
WPL4	Pinboard lining - type 4			





			architect
purpose of issue	by	date	issue no.
ESD Consult Issue	BLC	02.05.19	1
moved, Elevations adjusted			
DRAW NUMBERS ADJUSTED, Buildings	BLC	08.05.19	2
Client Workshop Presentation	BLC	14.05.19	3
Carpark, paths, Block B Adjusted	BLC	22.05.19	4
SSDA Documentation 90% Completion	DO	03.06.19	5
Preliminary SSDA Review	BLC	28.02.20	6
GA NSW Issue	BLC	20.03.20	7
SSDA Issue, levels adjusted, dims added	BLC	01.04.20	8
SSDA- Project name adjusted	BLC	28.04.20	9





project

ST MATTHEW'S CATHOLIC SCHOOL - Secondary Campus

address

Corner of BROADHEAD and BRUCE RD. MUDGEE Lot 40 of DP 756894

STATE SIGNIFICANT DEVELOPMENT APPLICATION


	drawn:	DO
	checked:	BLC
	verified:	CG
	sheet size:	A1
north	scale:	1 : 100
graphic scale		6

BLOCK A - SECTIONS

		sheet
8150	DA103	9

sheet no

issue

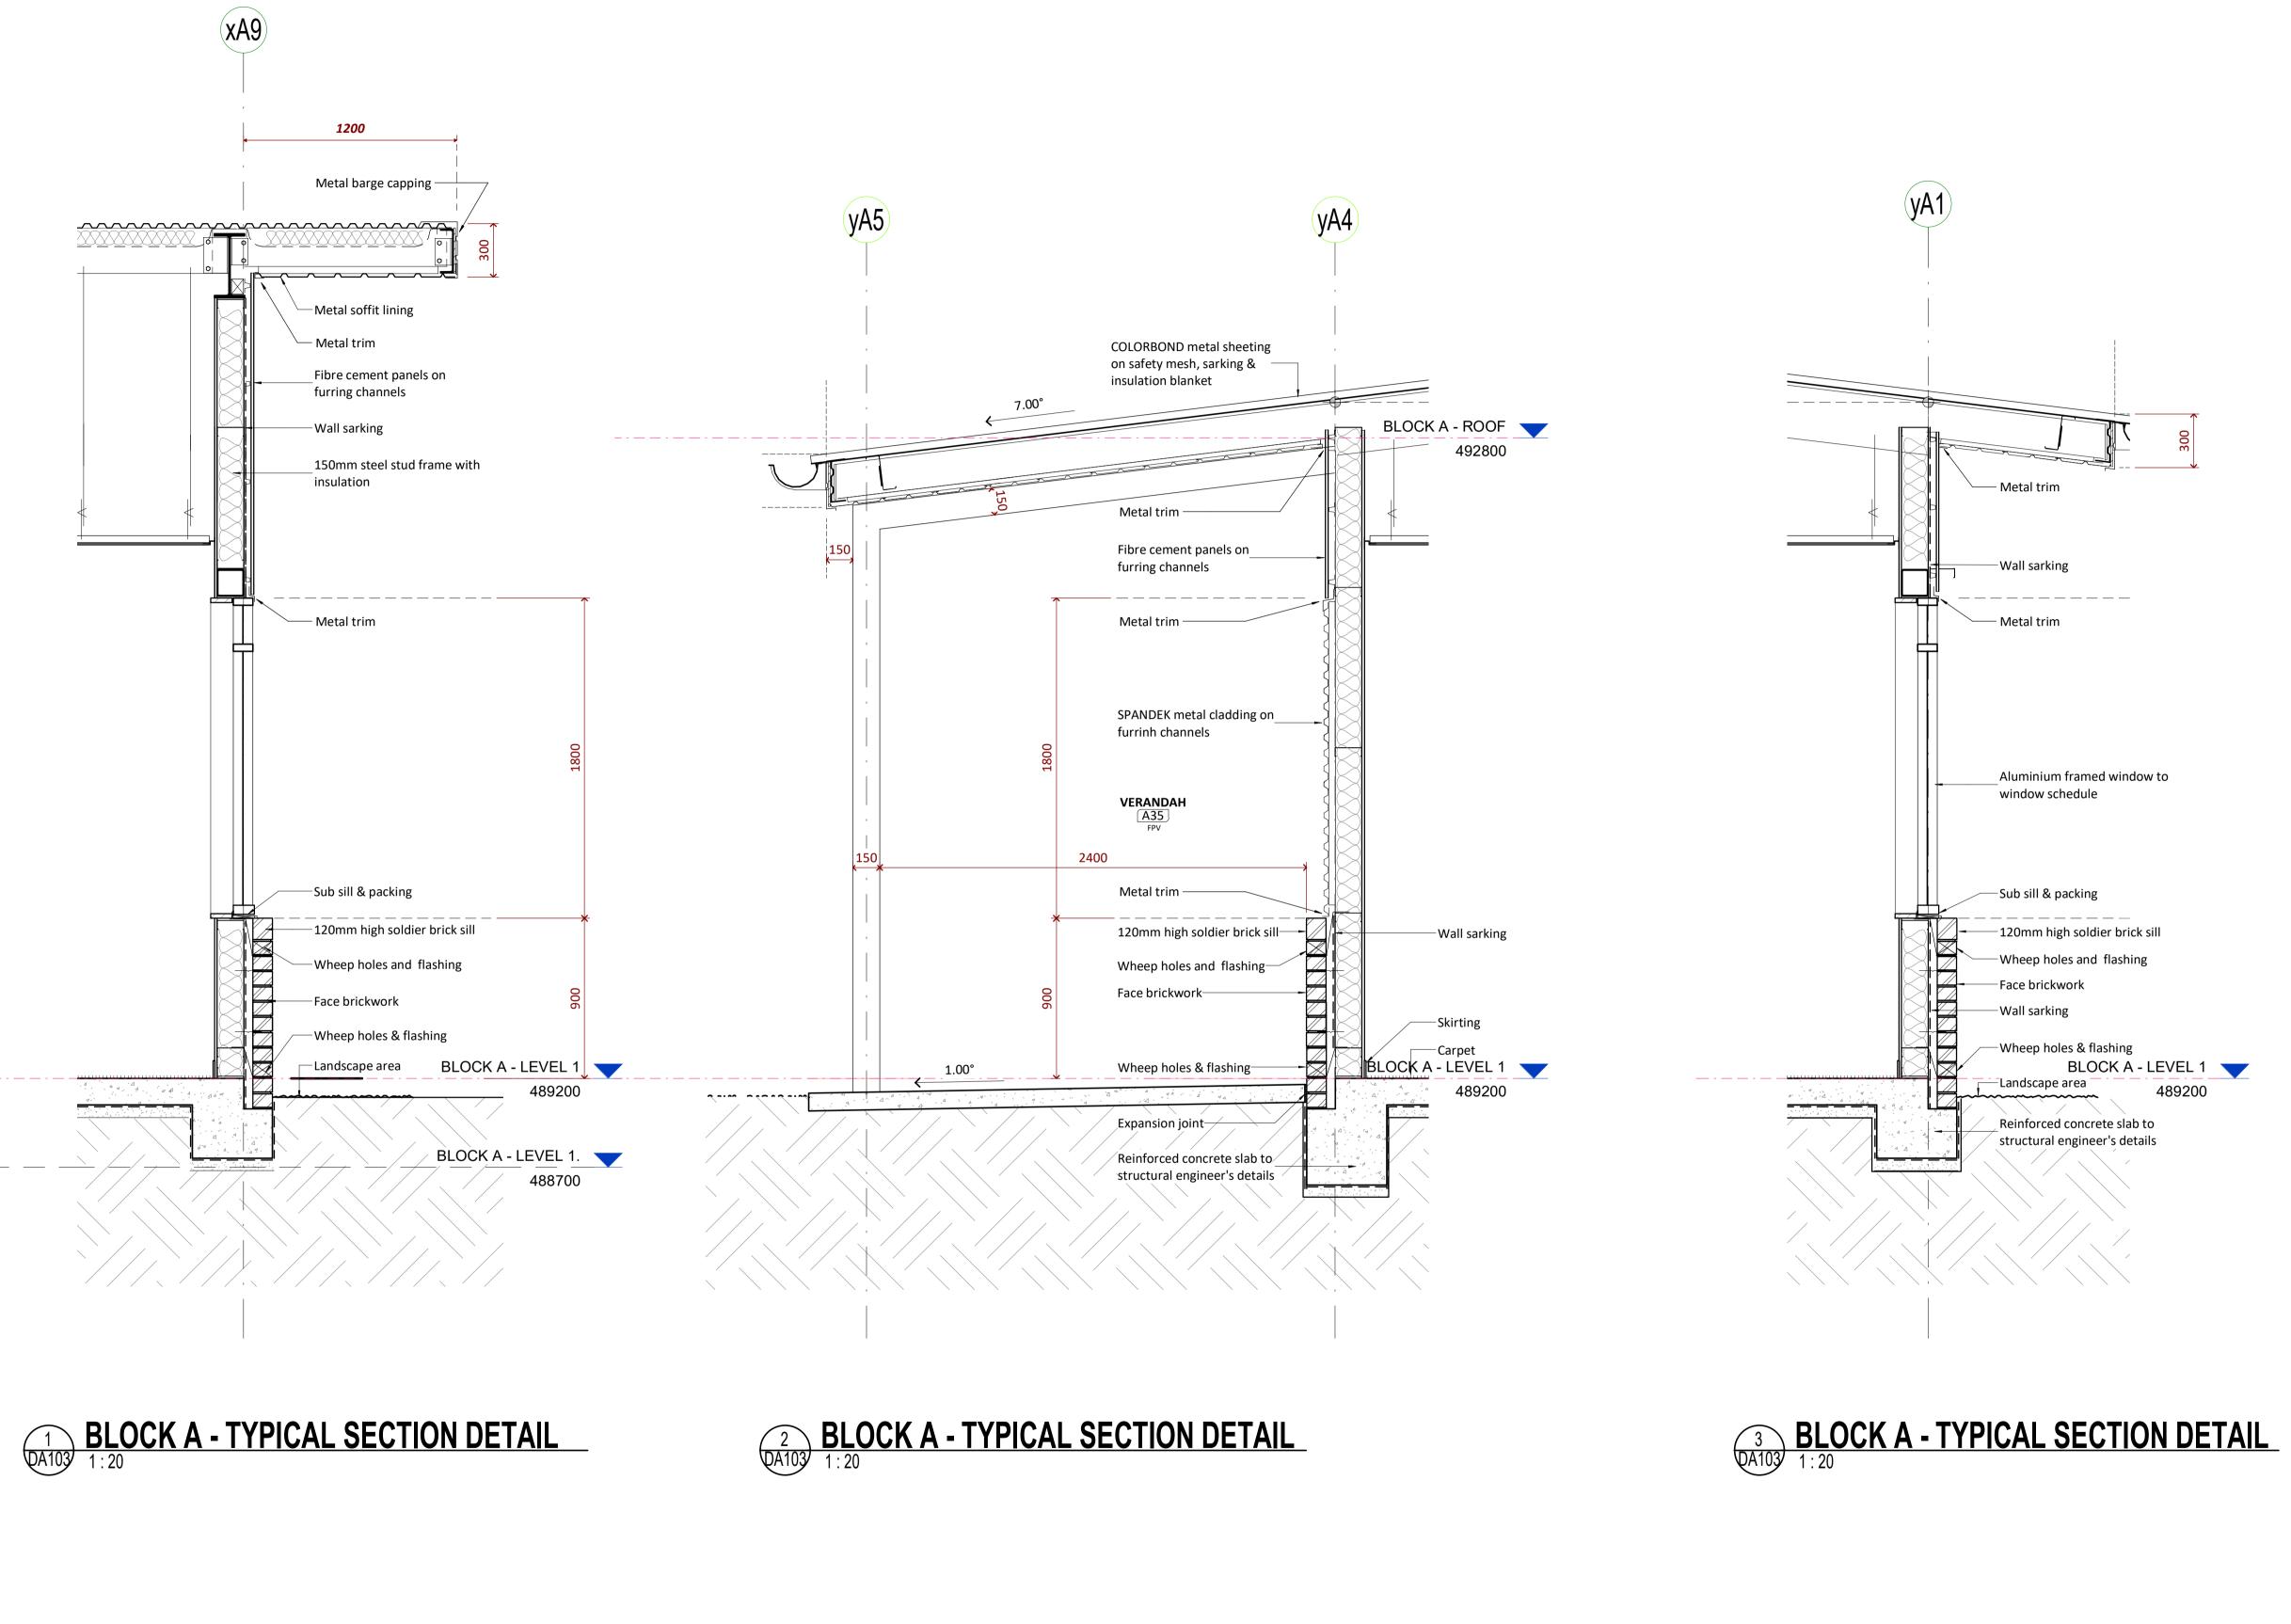

ST MATTHEW'S CATHOLIC SCHOOL - Secondary Campus

address Corner of BROADHEAD and

BRUCE RD. MUDGEE Lot 40 of DP 756894

CONSTRU	JCTION
DOCUMENT	ATION
drawn:	Author
	Chockor

	drawr	1:	Author
	check	ed:	Checker
	verifi	ed:	Approver
	sheet	size:	A1
north	scale:		1 : 20
			6

graphic scale

project no.

SITE

builder


project

BLOCK A - SECTION DETAILS sheet

18150 DA104 17

sheet no.

issue

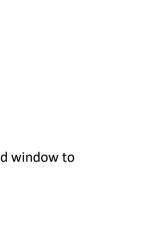

purpose of issue by date issue no. architect

north

BUILDING WITH TRUST®

NORTH CONSTRUCTIONS & BUILDINGS


TSA


NOMINATED ARCHITECT : CHARLES GLANVILLE NSW REG

CATHOLIC EDUCATION DIOCESE OF BATHURST

SSDA- Project name adjusted	BLC 28.04.20	17
SSDA Issue, levels adjusted, dims added	BLC 01.04.20	16
GA NSW Issue	BLC 20.03.20	15
Preliminary SSDA Review	BLC 28.02.20	14
Design Development Sign off	CG 21.10.19	13
Site Plan, Block B & F adjusted	BLC 19.09.19	12
Block B & F adjusted	BLC 30.08.19	11
Access adjust, dis car added	BLC 31.07.19	10
SSDA Documentation 90% Completion	DO 03.06.19	9
Carpark, paths, Block B Adjusted	BLC 22.05.19	8

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BLOCK B - NORTH-WEST ELEVATION

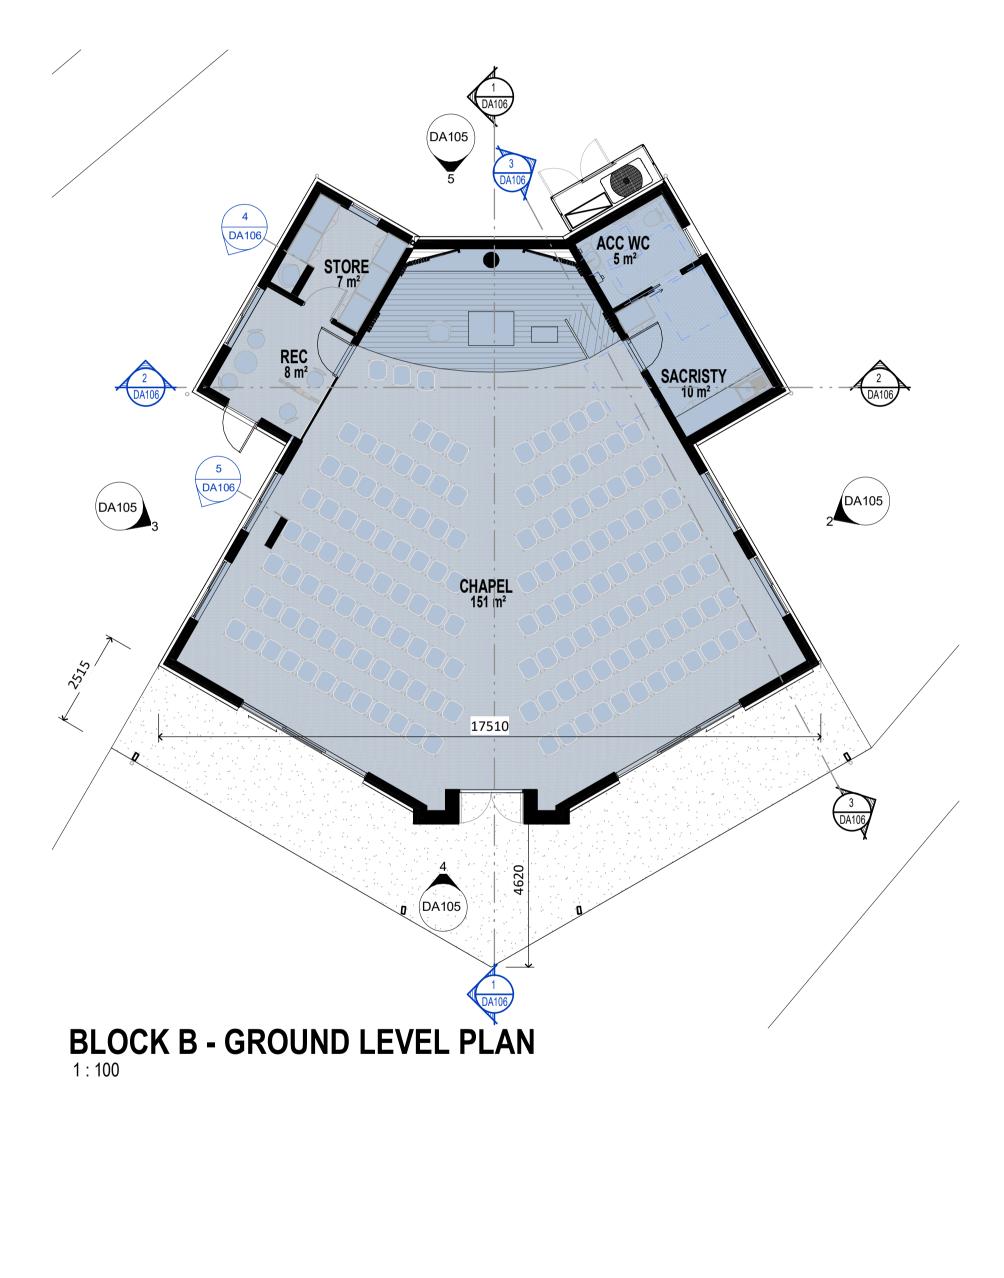1 : 100

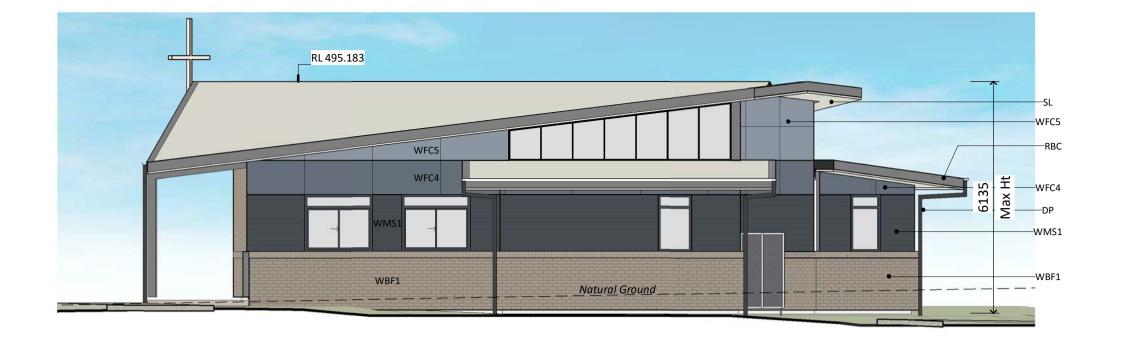


BLOCK B - SOUTH-EAST ELEVATION

1 : 100



BLOCK B - NORTH-EAST ELEVATION

1:100

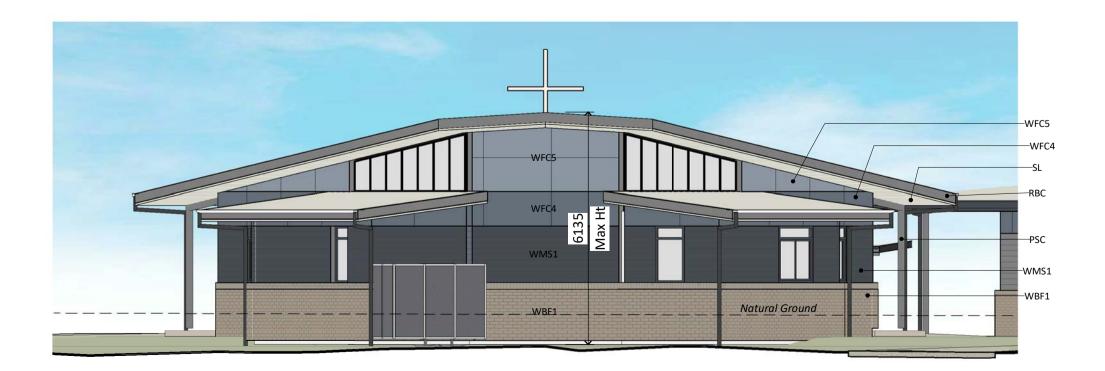

C COPYRIGHT 2019

Dimensions take precedence over scaling. Do not measure off drawings as print sizes may vary.

Chapel			
Name	Area		
HAPEL	151 m²		
ACRISTY	10 m ²		
STORE	7 m ²		
REC	8 m²		
VCC WC	5 m ²		
Grand total	182 m²		

Administration Building Services

Enclosed Circulation

GLA-Secondary Multi-Purpose Hall Performing Arts

Pupil Facilites

TAS Science

Visual Arts

Resource Centre

TAS-Food Technology

Chapel

TAS

		keyplan
	LEGEND	
CODE	DESCRIPTION	
BAL-1	Balustrade & handrail - type 1 to details	
DP	Downpipe	
GT	Gutter refer to hydraulic engineer	
LOC1	Lockers - Student	
РСР	Painted concrete column	
PSC	Painted steel column	
RBC	Colorbond metal Barge capping	
RGF	Colorbond metal gutter & fascia	
RMS1	Colorbond profiled metal roof sheet - type 1	
RMS2	Colorbond profiled metal roof sheet - type 2	
RPS	Polycarbonate roof sheet	
RWT	Rain water tank	
SL	Metal profiled Soffit Lining	
WBF	Face brickwork	
WBF1	Face brickwork - type 1	
WBF3	Face brickwork - type 3	
WFC1	Painted fibre cement cladding type 1	
WFC2	Painted fibre cement cladding type 2	
WFC3	Painted fibre cement cladding type 3	
WFC4	Painted fibre cement cladding type 4	
WFC5	Painted fibre cement cladding type 5	
WFC6	Painted fibre cement cladding type 6	
WFC7	Painted fibre cement cladding type 7	
WFC8	Painted fibre cement cladding type 8	
WFC9	Painted fibre cement cladding type 9	
WFC.1		
WLV1	Louvre screen - type 1	
WLV2	Louvre screen - type 2	
WMS1	Profiled metal sheet cladding - type 1	
WMS2	Profiled metal sheet cladding - type 2	
WPL4	Pinboard lining - type 4	

SSDA- Project name adjusted	BLC	28.04.20	13
SSDA- BCA & Access Update	BLC	21.04.20	12
SSDA Issue, Legend Updated	BLC	03.04.20	11
SSDA Issue, levels adjusted, dims added	BLC	01.04.20	10
GA NSW Issue	BLC	20.03.20	9
Site Plan, Block B & F adjusted	BLC	19.09.19	8
Block B & F adjusted	BLC	30.08.19	7
SSDA Documentation 90% Completion	DO	03.06.19	6
Carpark, paths, Block B Adjusted	BLC	22.05.19	5
Client Workshop Presentation	BLC	14.05.19	4
purpose of issue	by	date	issue no.

architect





project

ST MATTHEW'S CATHOLIC SCHOOL - Secondary Campus

address


Corner of BROADHEAD and BRUCE RD. MUDGEE Lot 40 of DP 756894

STATE SIGNIFICANT DEVELOPMENT APPLICATION


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	checked:	CG
	verified:	CG
	sheet size:	A1
north	scale:	1 : 100
graphic scale		6


BLOCK B - FLOOR PLAN, ELEVATIONS & SECTIONS

18150	DA105	13

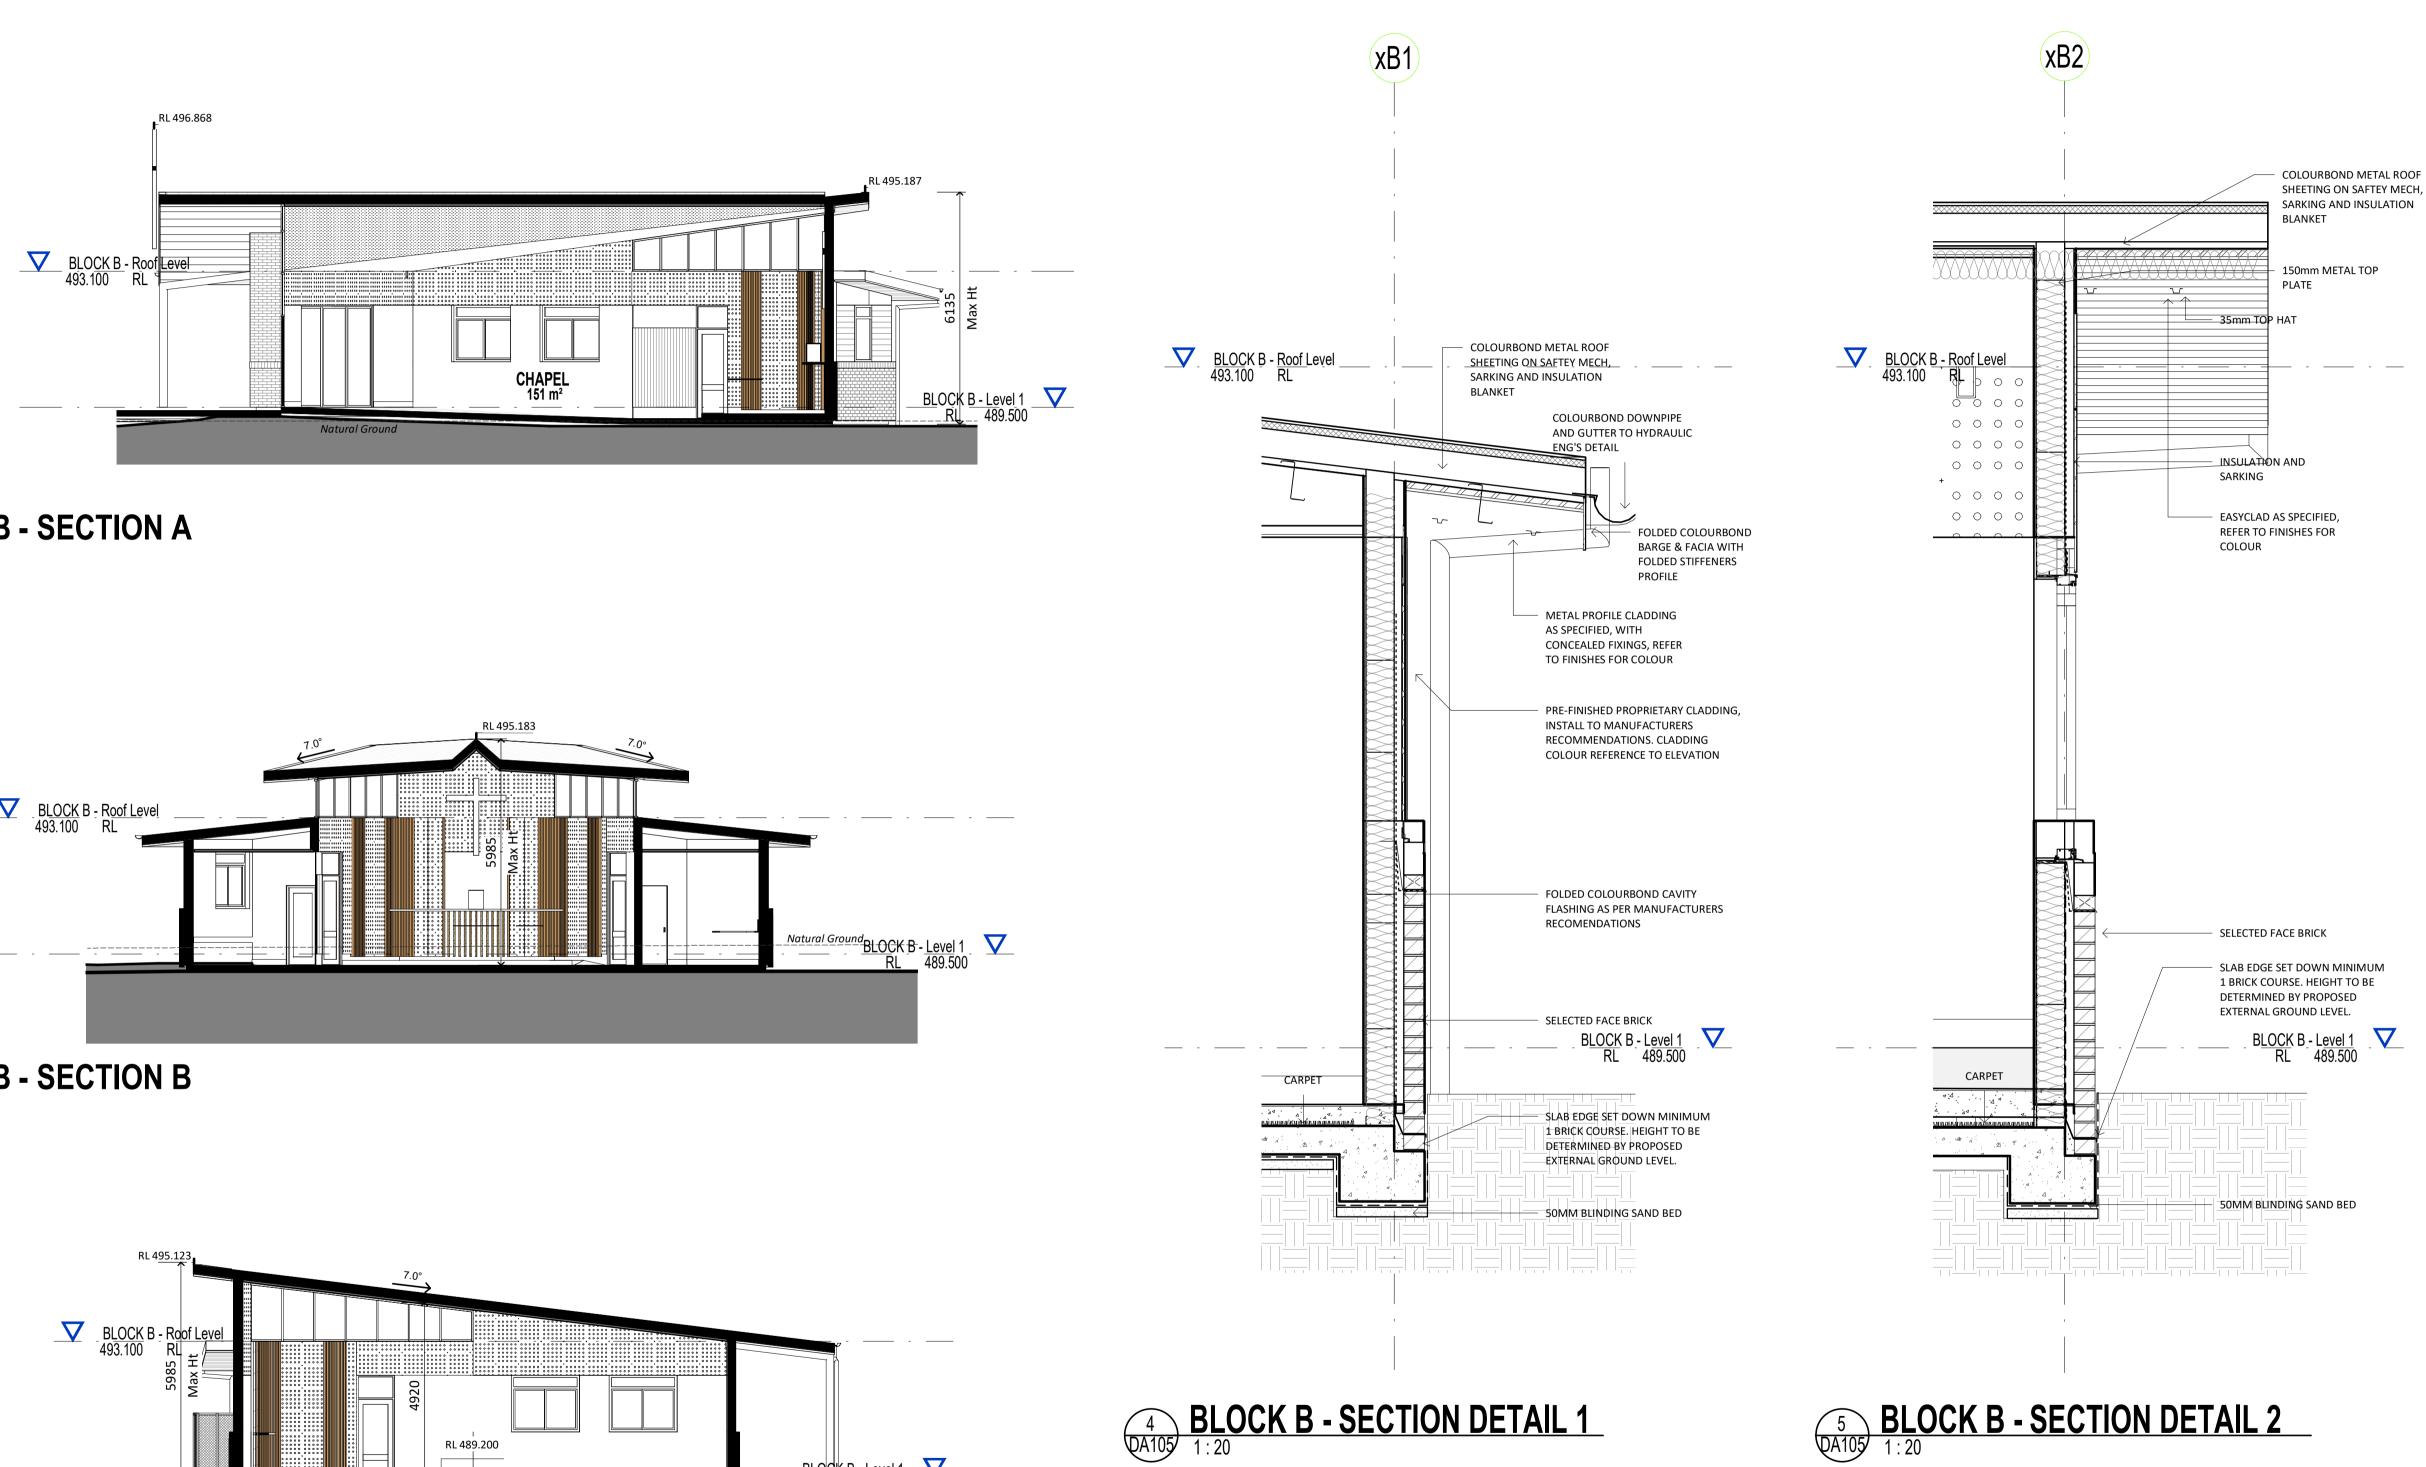


BLOCK B - SECTION A 1:100

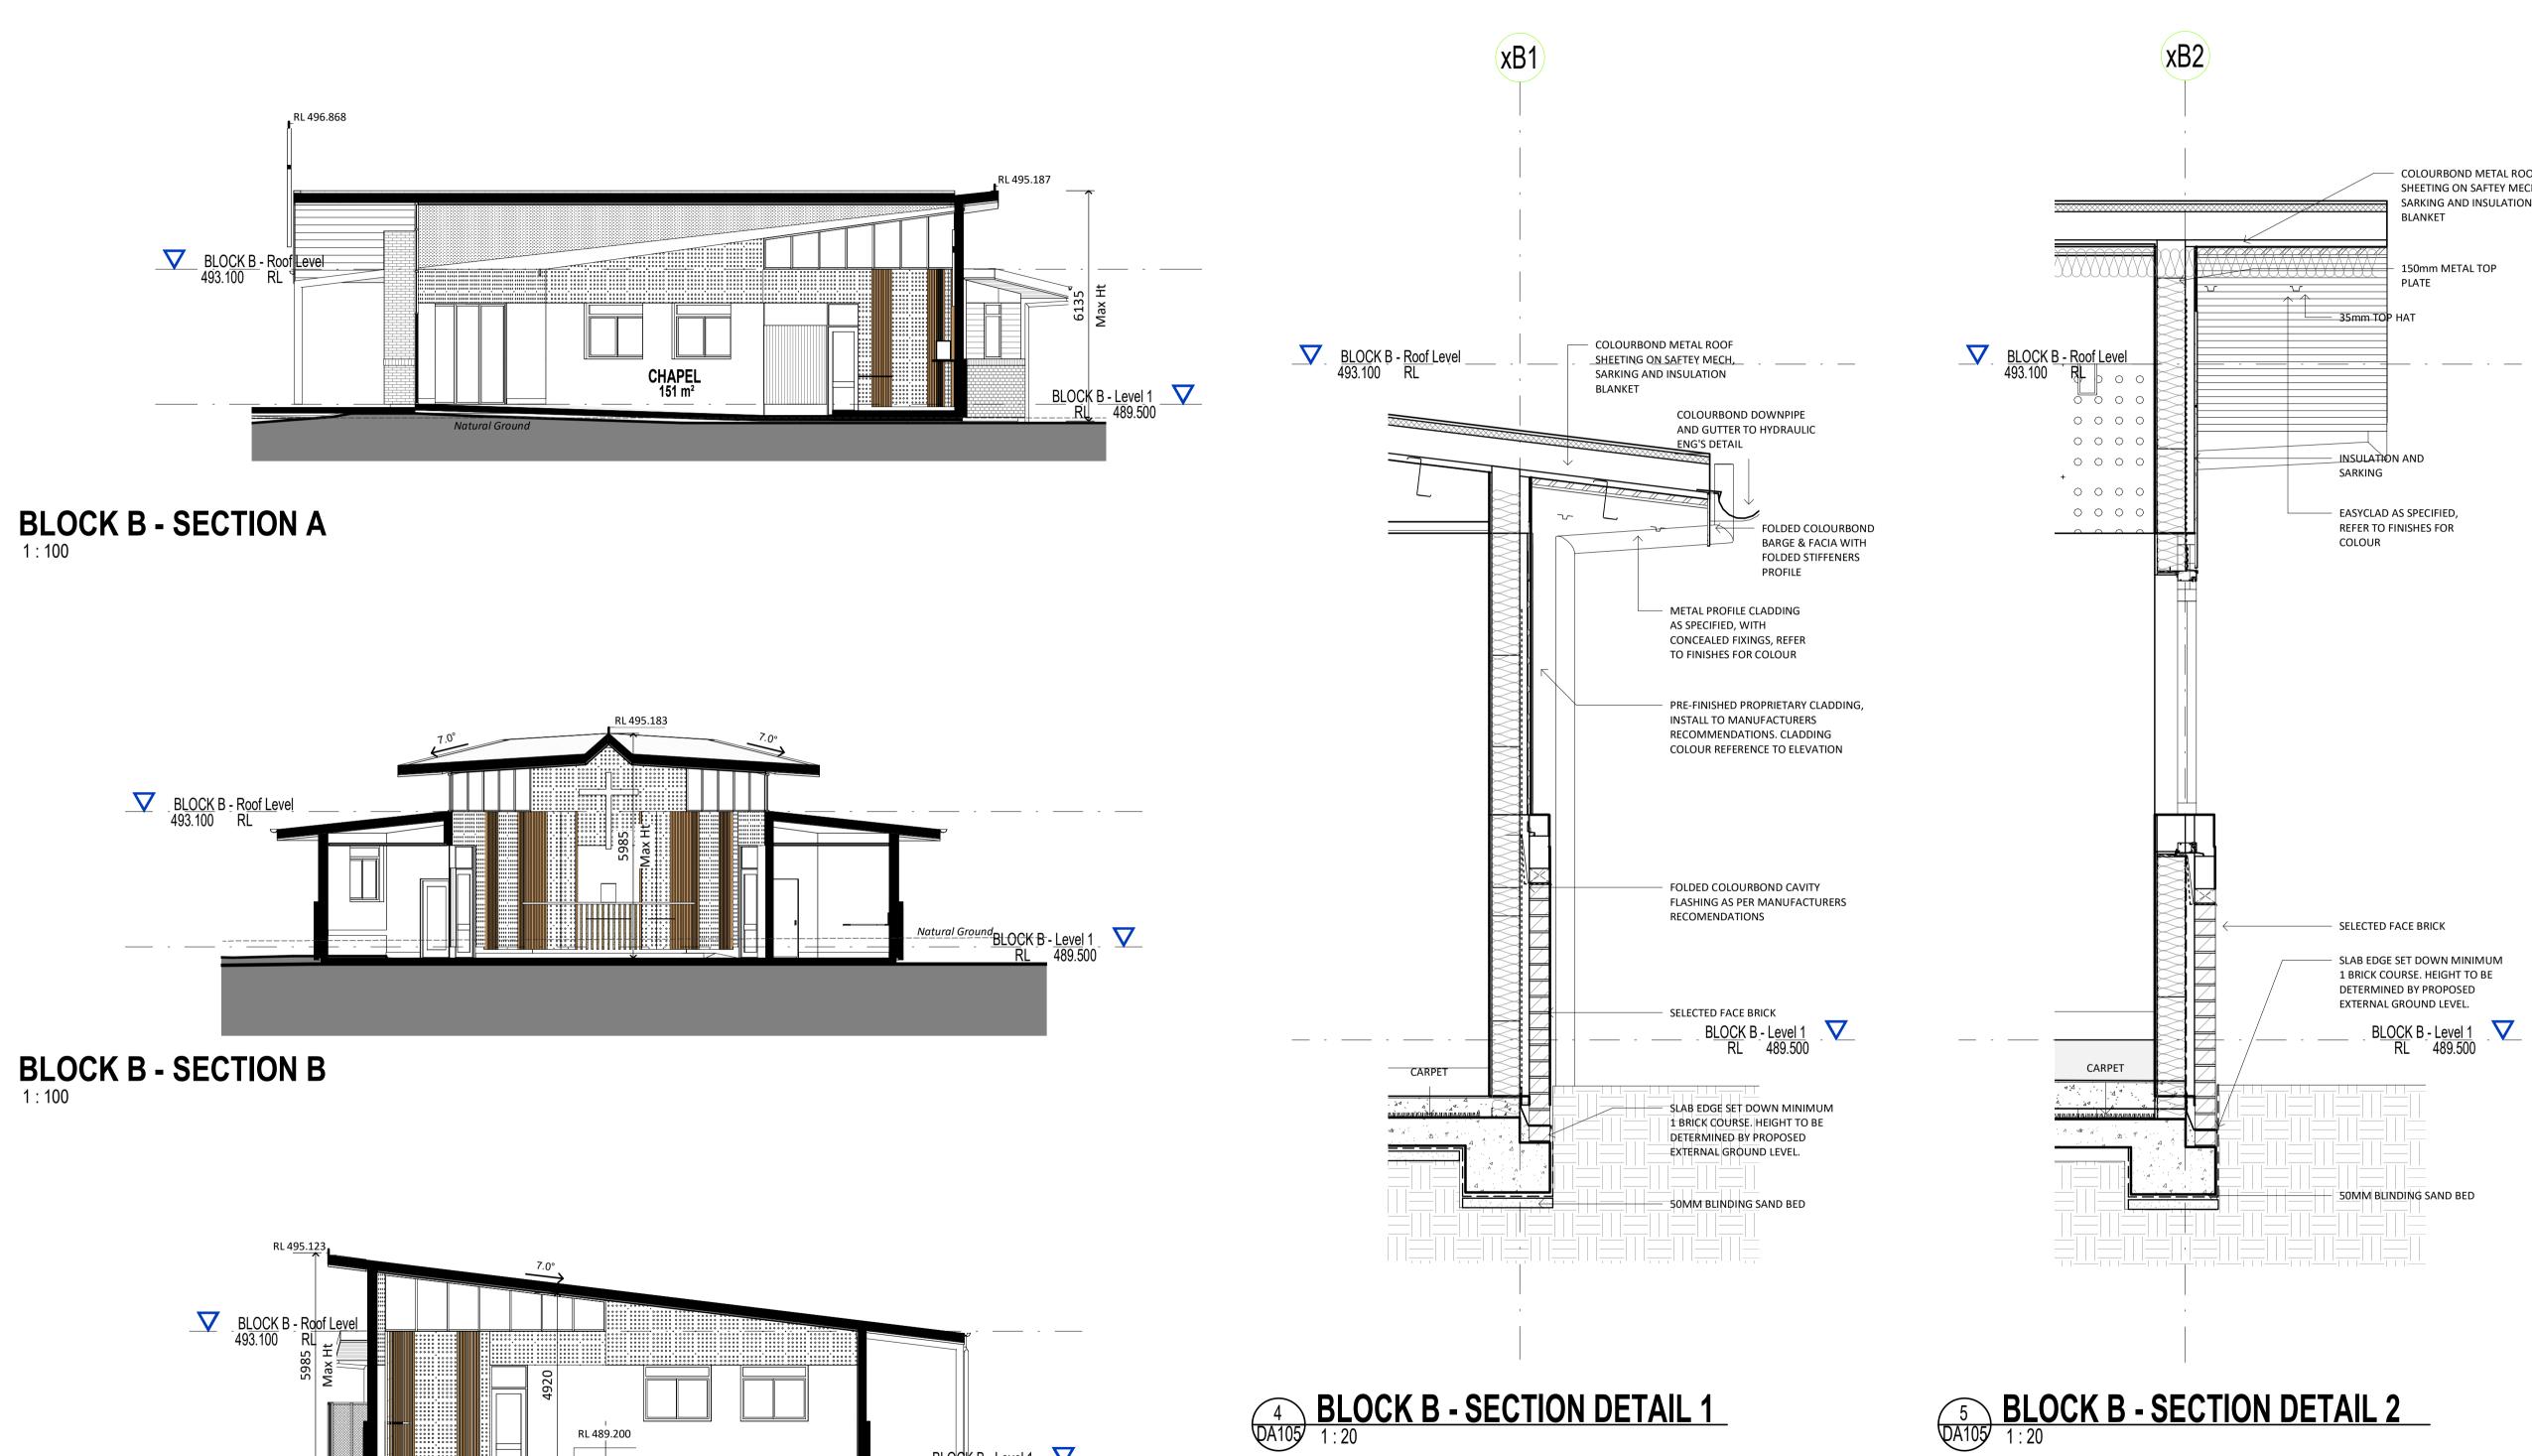

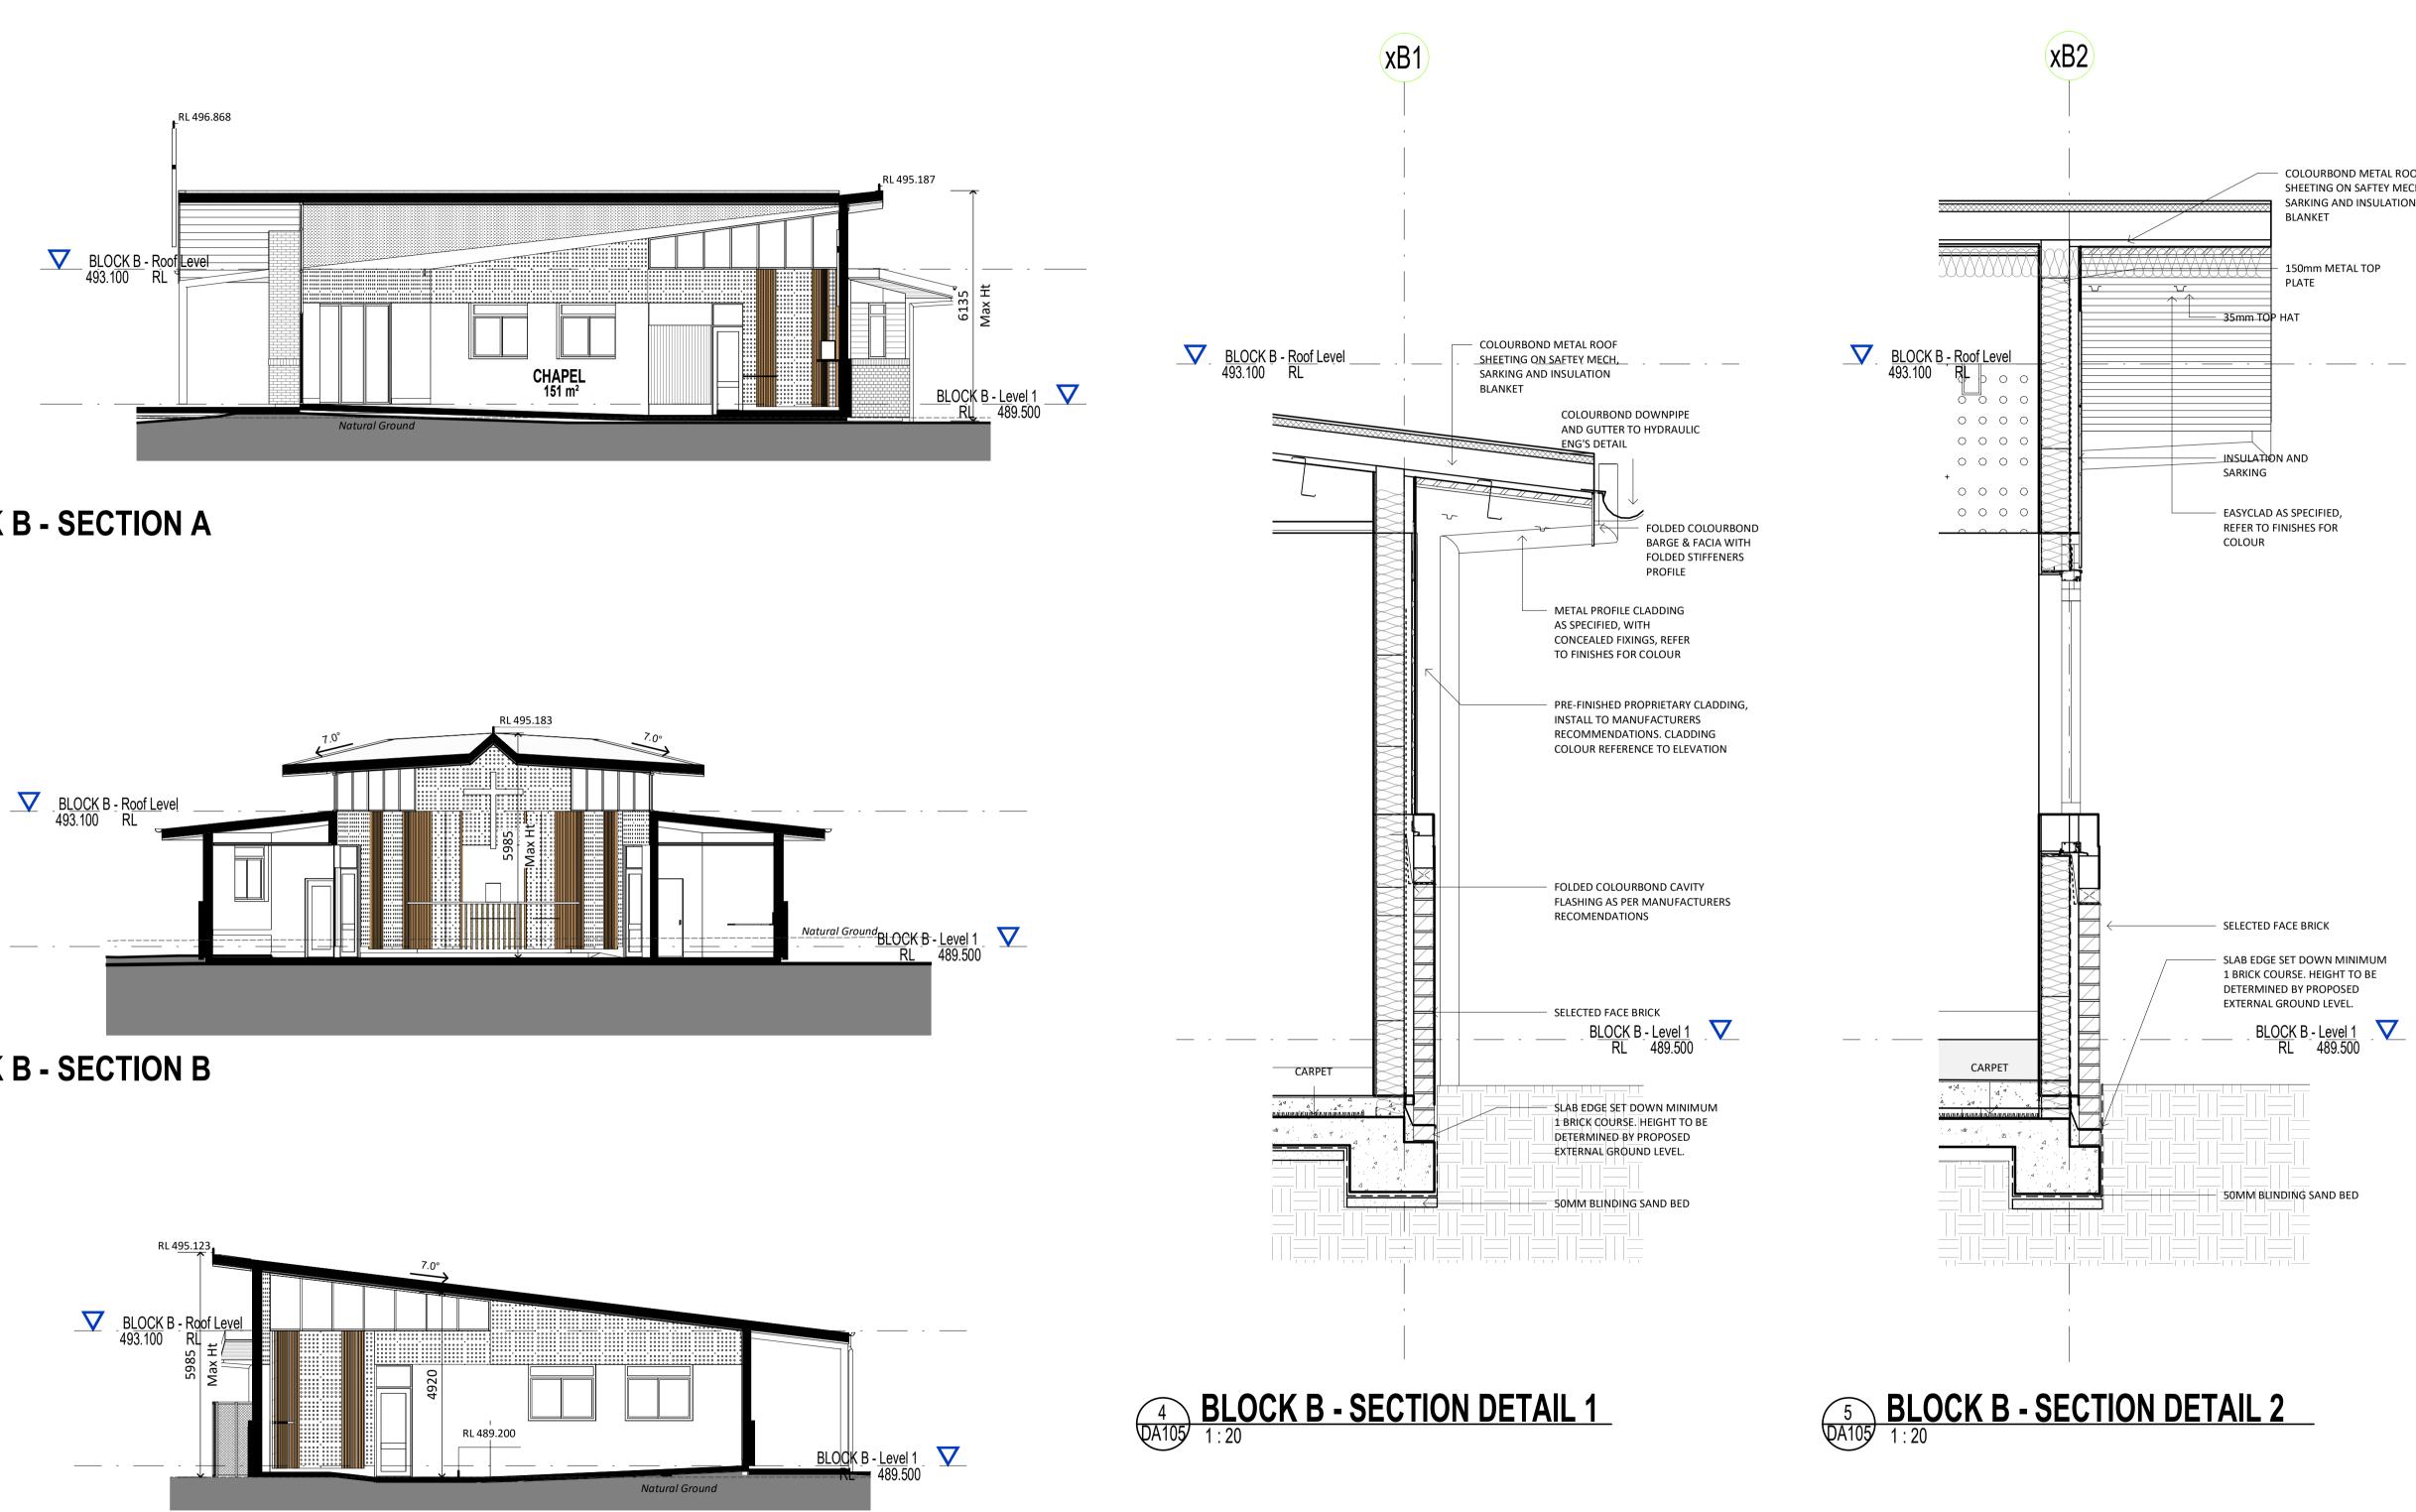


BLOCK B - SECTION C 1 : 100

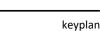

C COPYRIGHT 2019 Dimensions take precedence over scaling. Do not measure off drawings as print sizes may vary.

	 COLOURBOND META SHEETING ON SAFTEY SARKING AND INSULA BLANKET
	 150mm METAL TOP PLATE
35mm TO	Р НАТ

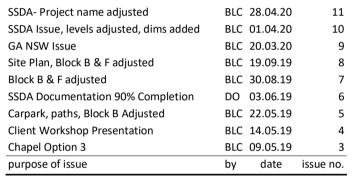

architect





project

ST MATTHEW'S CATHOLIC SCHOOL - Secondary Campus

address

issue

Corner of BROADHEAD and BRUCE RD. MUDGEE Lot 40 of DP 756894


STATE SIGNIFICANT DEVELOPMENT APPLICATION

	drawn:	Author
	checked:	Checker
	verified:	Approver
	sheet size:	A1
north	scale:	As indicated
graphic scale		6

BLOCK B - SECTIONS

		31100
18150	DA106	11



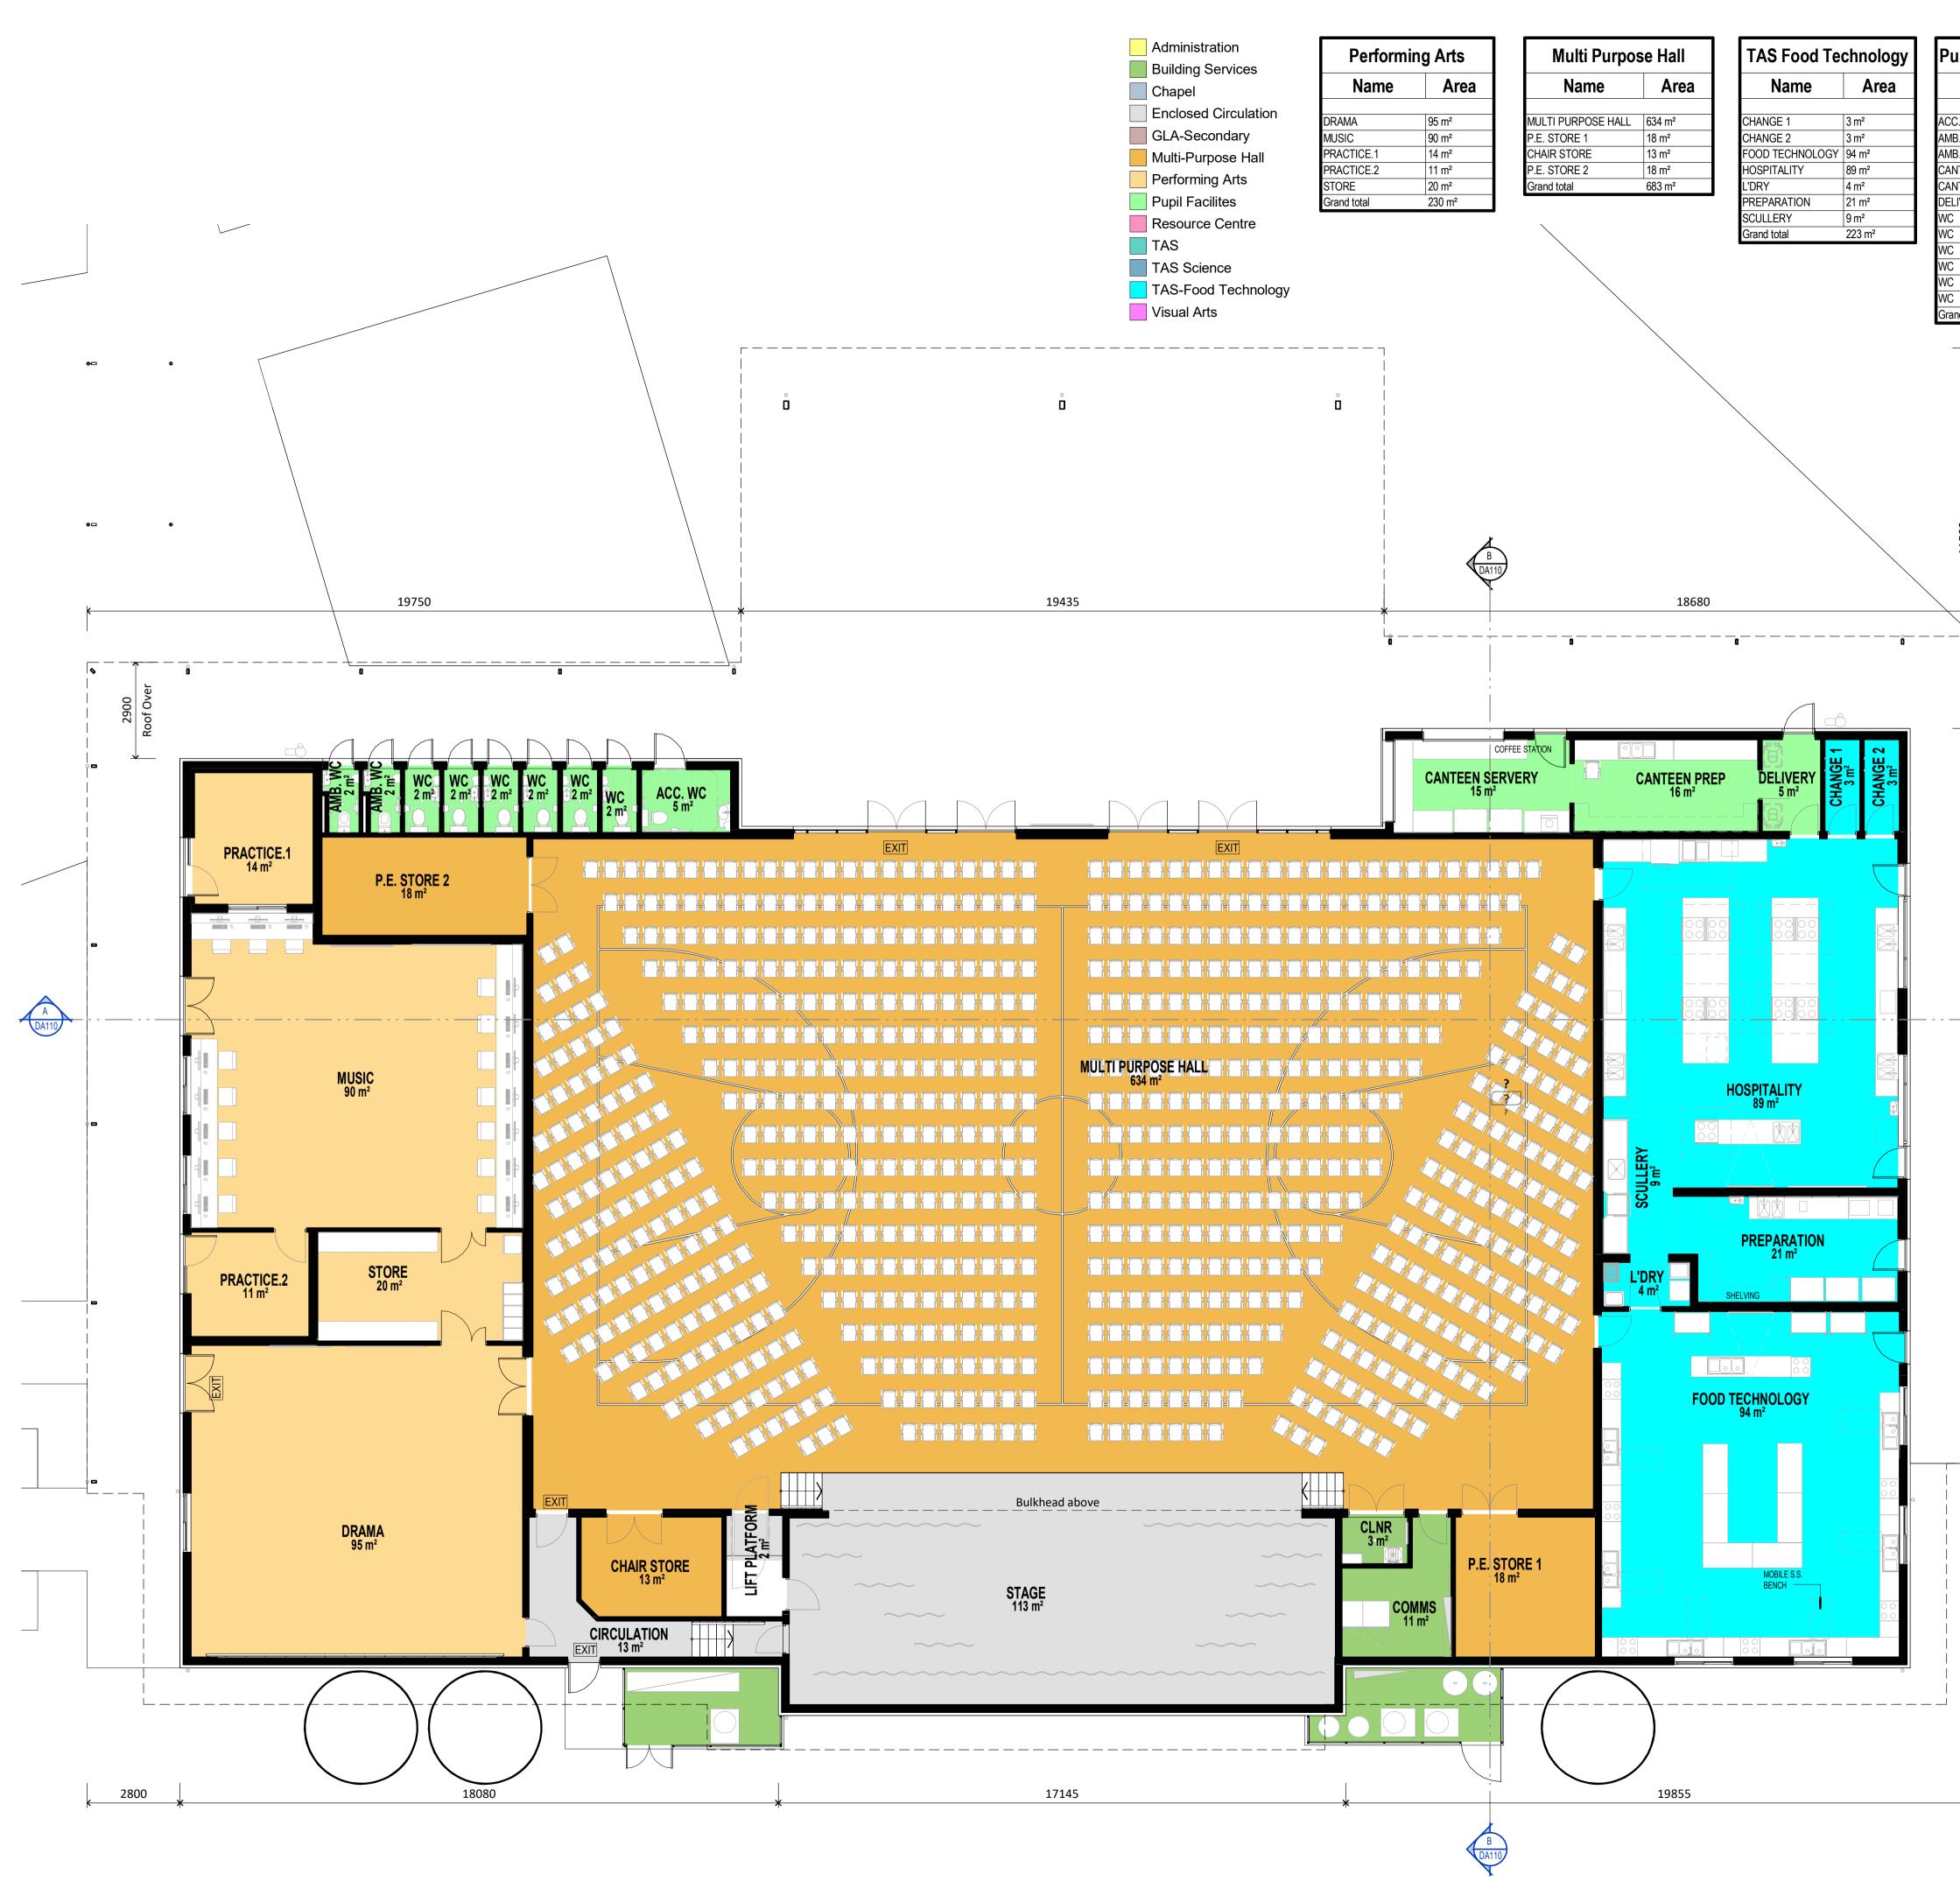

echnology			
	Area		
	3 m²		
	3 m²		
GΥ	94 m²		
	89 m²		
	4 m ²		
	21 m ²		
	9 m²		
	223 m ²		

Pupil Facilities Block C	
Name	Area
ACC. WC	5 m ²
AMB. WC	2 m ²
AMB. WC	2 m ²
CANTEEN PREP	16 m ²
CANTEEN SERVERY	15 m ²
DELIVERY	5 m ²
WC	2 m ²
WC	2 m ²

Grand total

11500 COLA

2 m²

2 m² 2 m²

2 m²

57 m²

DA110

C COPYRIGHT 2019

Dimensions take precedence over scaling. Do not measure off drawings as print sizes may vary.

keyplan			
LEGEND			
CODE	DESCRIPTION		
BAL-1	Balustrade & handrail - type 1 to details		
DP	Downpipe		
GT	Gutter refer to hydraulic engineer		
LOC1	Lockers - Student		
РСР	Painted concrete column		
PSC	Painted steel column		
RBC	Colorbond metal Barge capping		
RGF	Colorbond metal gutter & fascia		
RMS1	Colorbond profiled metal roof sheet - type 1		
RMS2	Colorbond profiled metal roof sheet - type 2		
RPS	Polycarbonate roof sheet		
RWT	Rain water tank		
SL	Metal profiled Soffit Lining		
WBF	Face brickwork		
WBF1	Face brickwork - type 1		
WBF3	Face brickwork - type 3		
WFC1	Painted fibre cement cladding type 1		
WFC2	Painted fibre cement cladding type 2		
WFC3	Painted fibre cement cladding type 3		
WFC4	Painted fibre cement cladding type 4		
WFC5	Painted fibre cement cladding type 5		
WFC6	Painted fibre cement cladding type 6		
WFC7	Painted fibre cement cladding type 7		
WFC8	Painted fibre cement cladding type 8		
WFC9	Painted fibre cement cladding type 9		
WFC.1			
WLV1	Louvre screen - type 1		
WLV2	Louvre screen - type 2		
WMS1	Profiled metal sheet cladding - type 1		
WMS2	Profiled metal sheet cladding - type 2		
WPL4	Pinboard lining - type 4		

purpose of issue	by	date	issue no.
SSDA Documentation 90% Completion	DO	03.06.19	5
Access adjust, dis car added	BLC	31.07.19	6
Design Development Sign off	CG	21.10.19	7
Preliminary Cost Plan 2A Amendments	BLC	06.02.20	8
Block C Comms & Store Revised	BLC	07.02.20	9
GA NSW Issue	BLC	20.03.20	10
SSDA Issue, levels adjusted, dims added	BLC	01.04.20	11
SSDA Issue, Legend Updated	BLC	03.04.20	12
SSDA- BCA & Access Update	BLC	21.04.20	13
SSDA- Project name adjusted	BLC	28.04.20	14

architect





ST MATTHEW'S CATHOLIC SCHOOL - Secondary Campus

Corner of BROADHEAD and BRUCE RD. MUDGEE Lot 40 of DP 756894

STATE SIGNIFICANT DEVELOPMENT **APPLICATION**

	drawn:	BLC
	checked:	CG
	verified:	CG
	sheet size:	A1
north	scale:	1 : 100
graphic scale		6

BLOCK C - GROUND FLOOR PLAN

DA108	14



BLOCK C - WEST ELEVATION





BLOCK C - EAST ELEVATION



BLOCK C - NORTH ELEVATION

C COPYRIGHT 2019

Dimensions take precedence over scaling. Do not measure off drawings as print sizes may vary.

		keyplan
LEGEND		
CODE	DESCRIPTION	
BAL-1	Balustrade & handrail - type 1 to details	
DP	Downpipe	
GT	Gutter refer to hydraulic engineer	
LOC1	Lockers - Student	
РСР	Painted concrete column	
PSC	Painted steel column	
RBC	Colorbond metal Barge capping	
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RMS1	Colorbond profiled metal roof sheet - type 1	
RMS2	Colorbond profiled metal roof sheet - type 2	
RPS	Polycarbonate roof sheet	
RWT	Rain water tank	
SL	Metal profiled Soffit Lining	
WBF	Face brickwork	
WBF1	Face brickwork - type 1	
WBF3	Face brickwork - type 3	
WFC1	Painted fibre cement cladding type 1	
WFC2	Painted fibre cement cladding type 2	
WFC3	Painted fibre cement cladding type 3	
WFC4	Painted fibre cement cladding type 4	
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WFC7	Painted fibre cement cladding type 7	
WFC8	Painted fibre cement cladding type 8	
WFC9	Painted fibre cement cladding type 9	
WFC.1		
WLV1	Louvre screen - type 1	
WLV2	Louvre screen - type 2	
WMS1	Profiled metal sheet cladding - type 1	
WMS2	Profiled metal sheet cladding - type 2	
WPL4	Pinboard lining - type 4	

			architect
purpose of issue	by	date	issue no.
ESD Consult Issue	BLC	02.05.19	1
DRAW NUMBERS ADJUSTED, Buildings moved, Elevations adjusted	BLC	08.05.19	2
Client Workshop Presentation	BLC	14.05.19	3
Carpark, paths, Block B Adjusted	BLC	22.05.19	4
SSDA Documentation 90% Completion	DO	03.06.19	5
GA NSW Issue	BLC	20.03.20	6
SSDA Issue, levels adjusted, dims added	BLC	01.04.20	7
SSDA- Project name adjusted	BLC	28.04.20	8





project

ST MATTHEW'S CATHOLIC SCHOOL - Secondary Campus

address


Corner of BROADHEAD and BRUCE RD. MUDGEE Lot 40 of DP 756894

STATE SIGNIFICANT DEVELOPMENT APPLICATION


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	checked:	BLC
	verified:	CG
	sheet size:	A1
north	scale:	1 : 100
graphic scale		6

BLOCK C - ELEVATIONS


		Sileei
18150	DA109	8

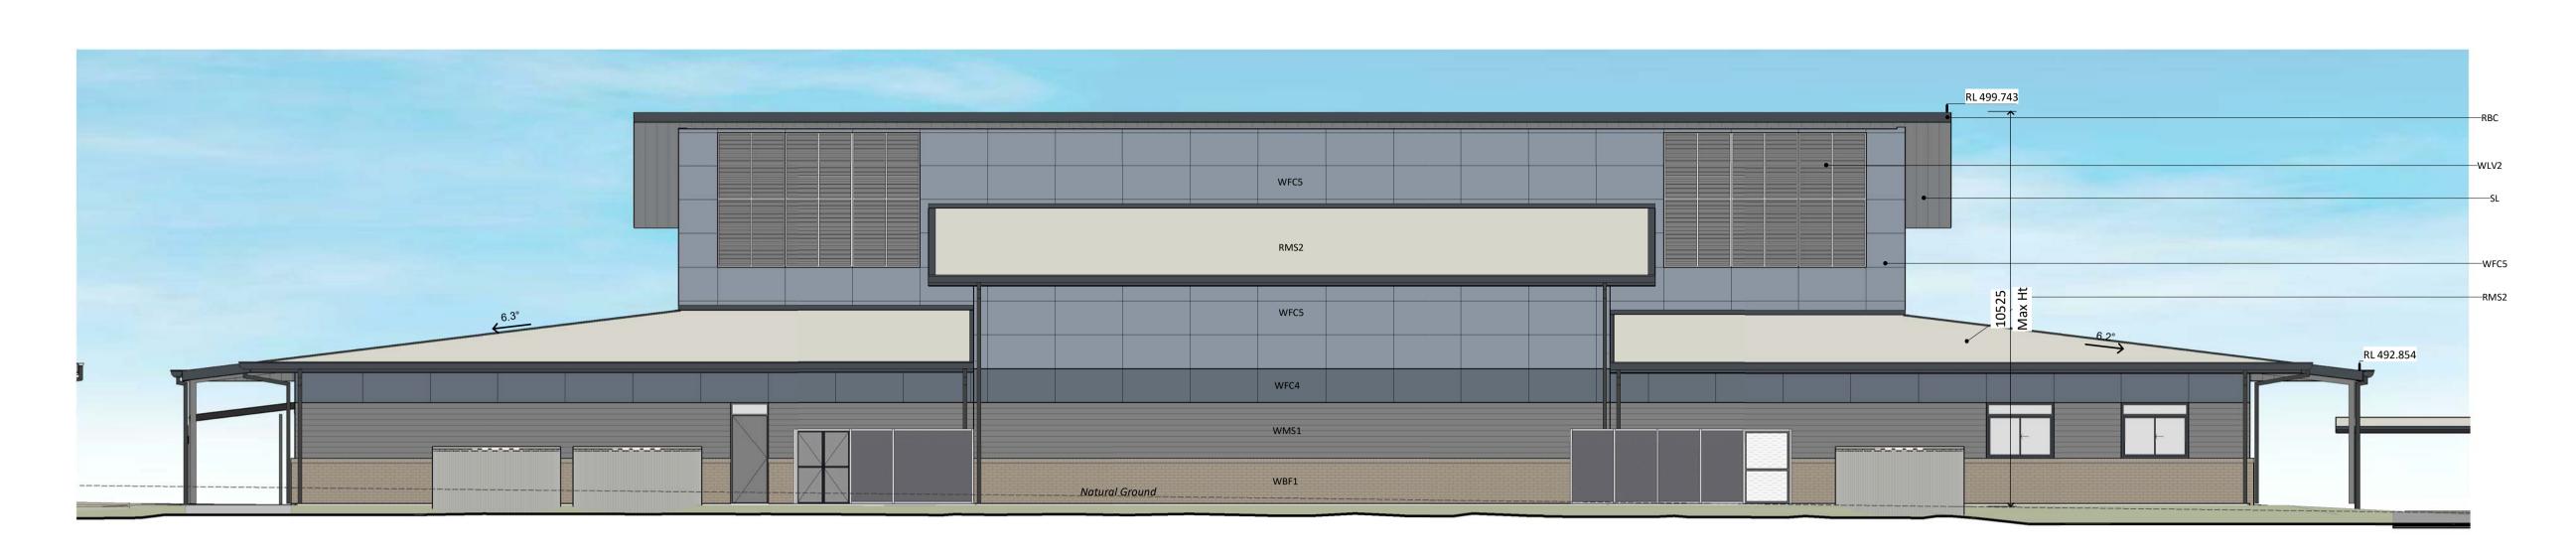

BLOCK C - SOUTH ELEVATION

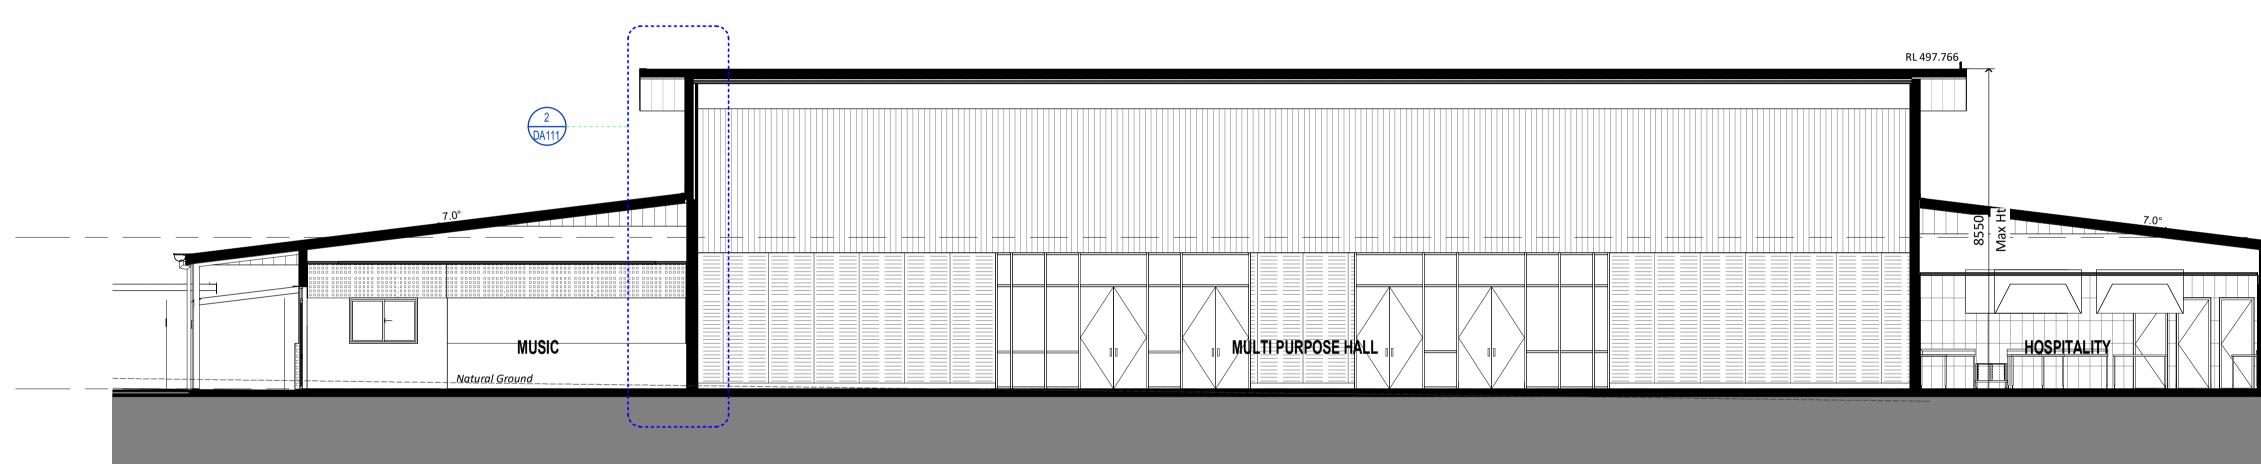

BLOCK C - SECTION A

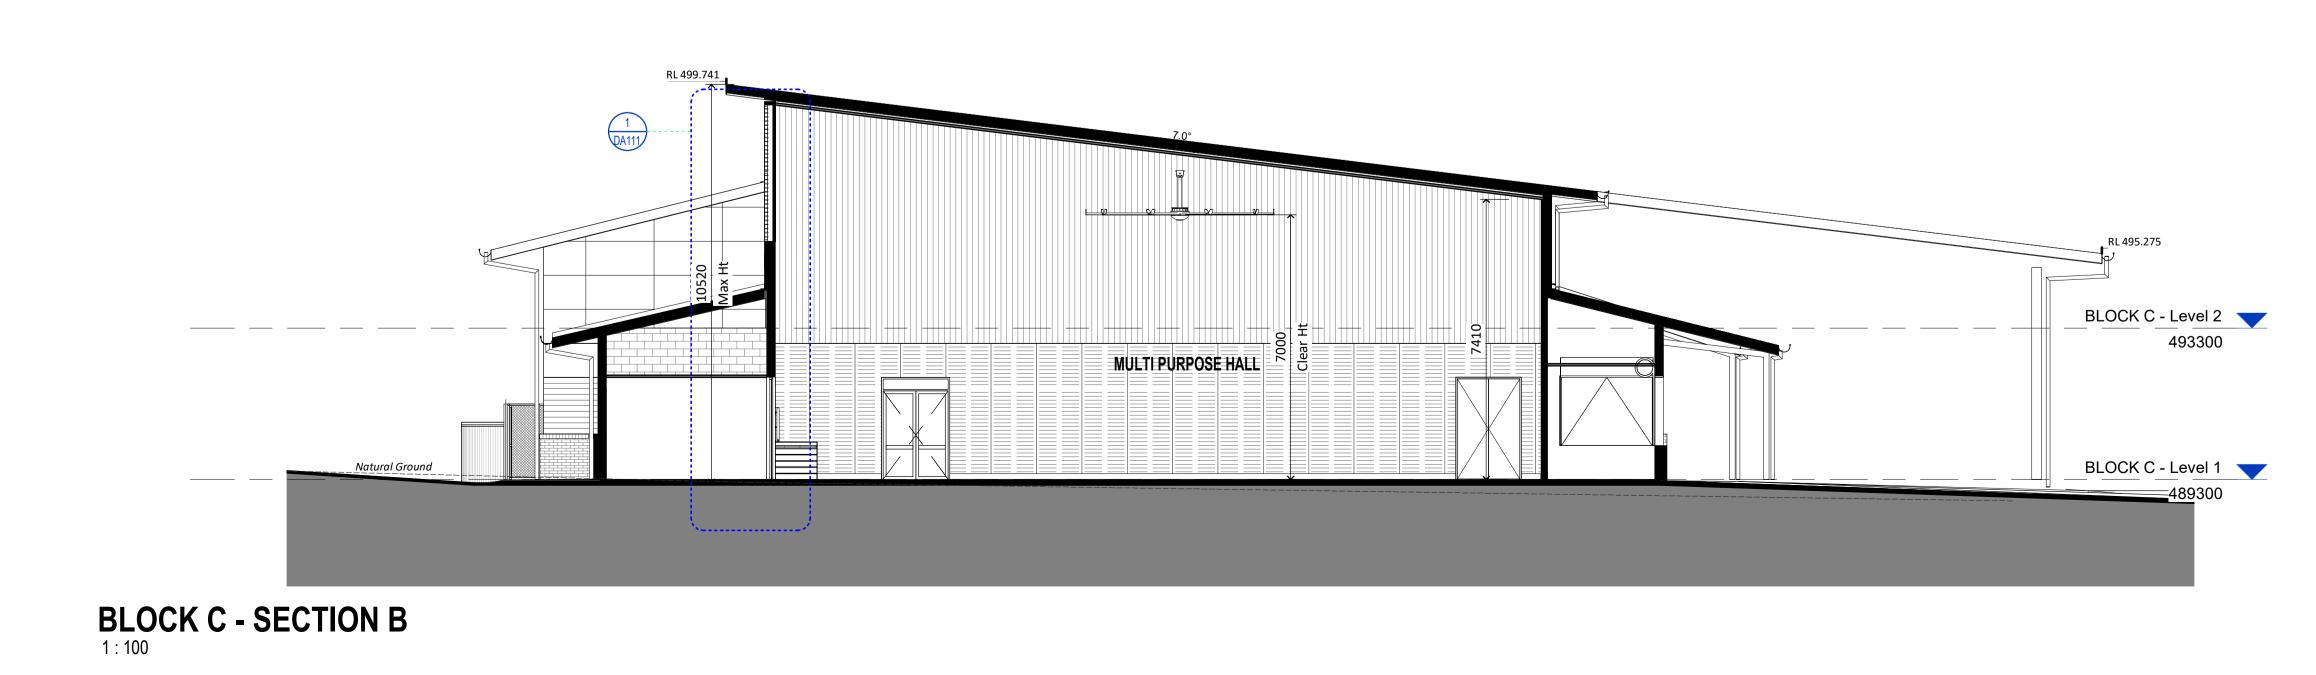

C COPYRIGHT 2019

Dimensions take precedence over scaling. Do not measure off drawings as print sizes may vary.

		keyplan	
	LEGEND		
CODE	DESCRIPTION		
BAL-1	Balustrade & handrail - type 1 to details		
DP	Downpipe		
GT	Gutter refer to hydraulic engineer		
LOC1	Lockers - Student		
РСР	Painted concrete column		
PSC	Painted steel column		
RBC	Colorbond metal Barge capping		
RGF	Colorbond metal gutter & fascia		
RMS1	Colorbond profiled metal roof sheet - type 1		
RMS2	Colorbond profiled metal roof sheet - type 2		
RPS	Polycarbonate roof sheet		
RWT	Rain water tank		
SL	Metal profiled Soffit Lining		
WBF	Face brickwork		
WBF1	Face brickwork - type 1		
WBF3	Face brickwork - type 3		
WFC1	Painted fibre cement cladding type 1		
WFC2	Painted fibre cement cladding type 2		
WFC3	Painted fibre cement cladding type 3		
WFC4	Painted fibre cement cladding type 4		
WFC5	Painted fibre cement cladding type 5		
WFC6	Painted fibre cement cladding type 6		
WFC7	Painted fibre cement cladding type 7		
WFC8	Painted fibre cement cladding type 8		
WFC9	Painted fibre cement cladding type 9		
WFC.1			
WLV1	Louvre screen - type 1		
WLV2	Louvre screen - type 2		
WMS1	Profiled metal sheet cladding - type 1		
WMS2	Profiled metal sheet cladding - type 2		
WPL4	Pinboard lining - type 4		

SSDA- Project name adjusted	BLC	28.04.20	11
SSDA Issue, levels adjusted, dims added	BLC	01.04.20	10
GA NSW Issue	BLC	20.03.20	9
SSDA Documentation 90% Completion	DO	03.06.19	8
Carpark, paths, Block B Adjusted	BLC	22.05.19	7
Client Workshop Presentation	BLC	14.05.19	6
DRAW NUMBERS ADJUSTED, Buildings moved, Elevations adjusted	BLC	08.05.19	5
ESD Consult Issue	BLC	02.05.19	4
Consultant Issue	BLC	12.04.19	3
purpose of issue	by	date	issue no.

architect





project

ST MATTHEW'S CATHOLIC SCHOOL - Secondary Campus

address

Corner of BROADHEAD and BRUCE RD. MUDGEE Lot 40 of DP 756894

STATE SIGNIFICANT DEVELOPMENT APPLICATION

	drawn:	RF
	checked:	BLC
	verified:	CG
	sheet size:	A1
north	scale:	1 : 100
graphic scale		6


BLOCK C - ELEVATIONS AND SECTIONS sheet


DA110	11
DAIIO	ᆂᆂ

BLOCK C - Level 2 493300 BLOCK C - Level 1 🗡 489300

18150

issue

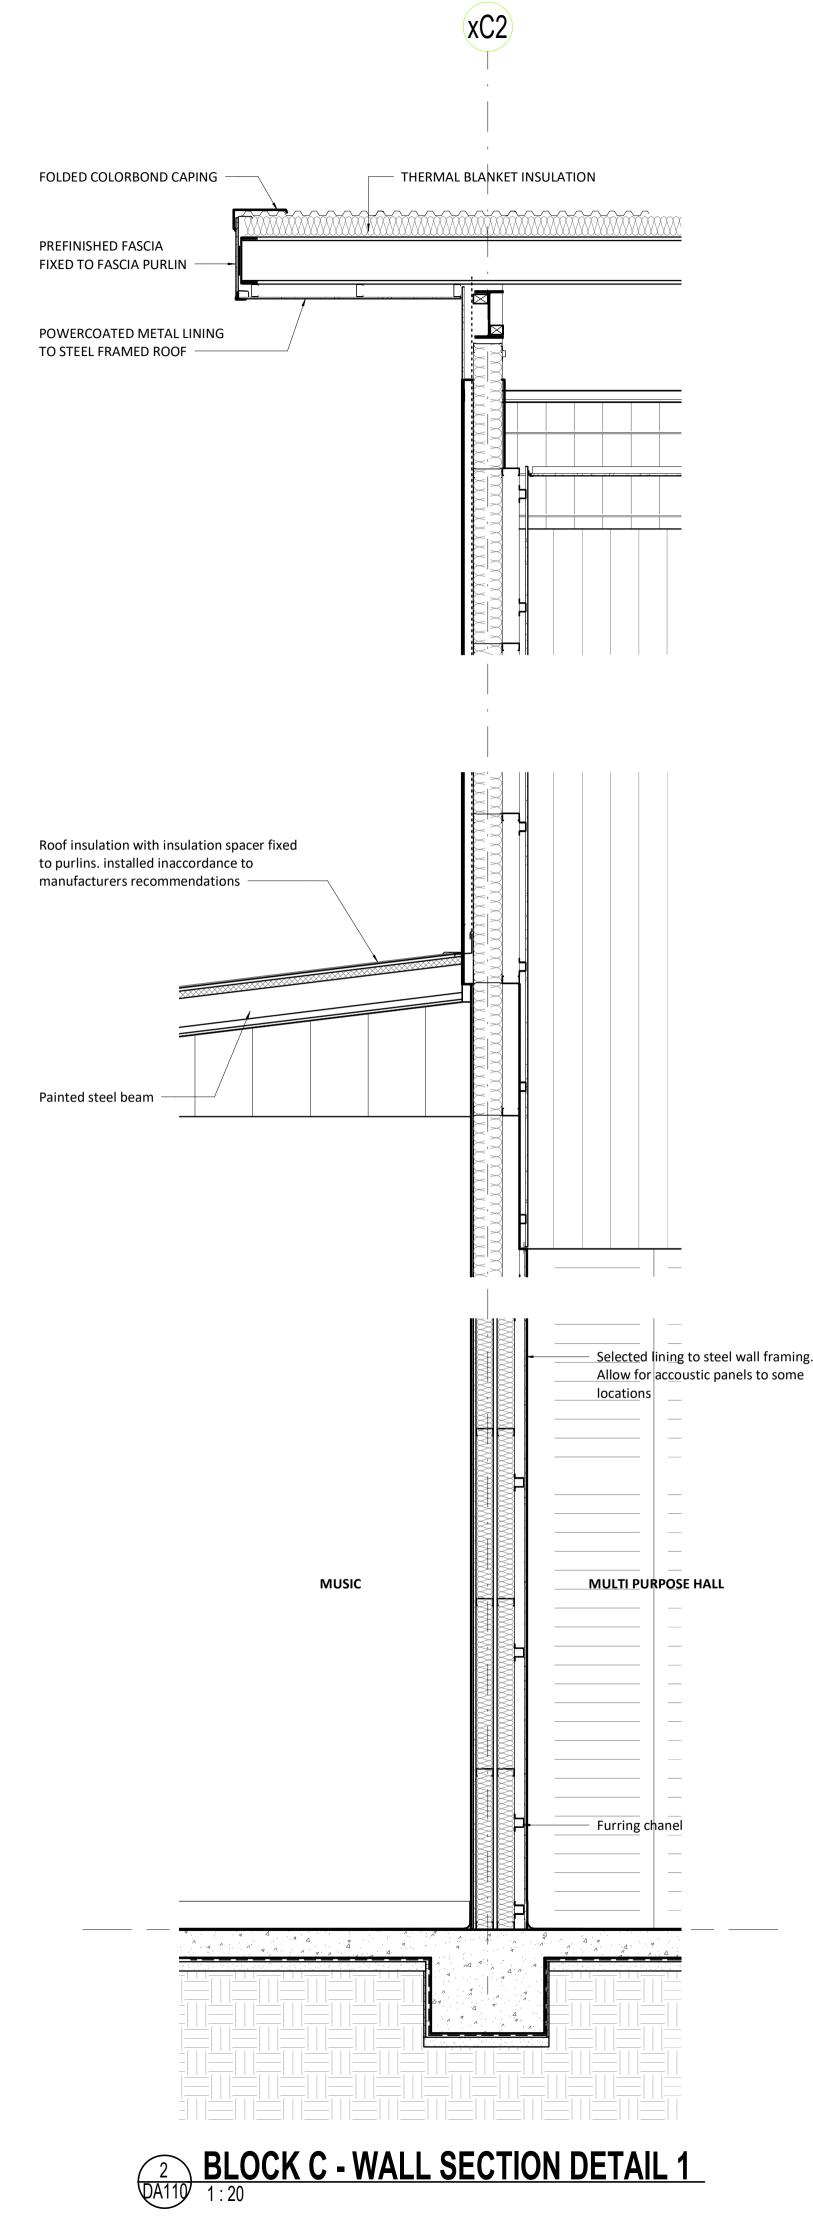

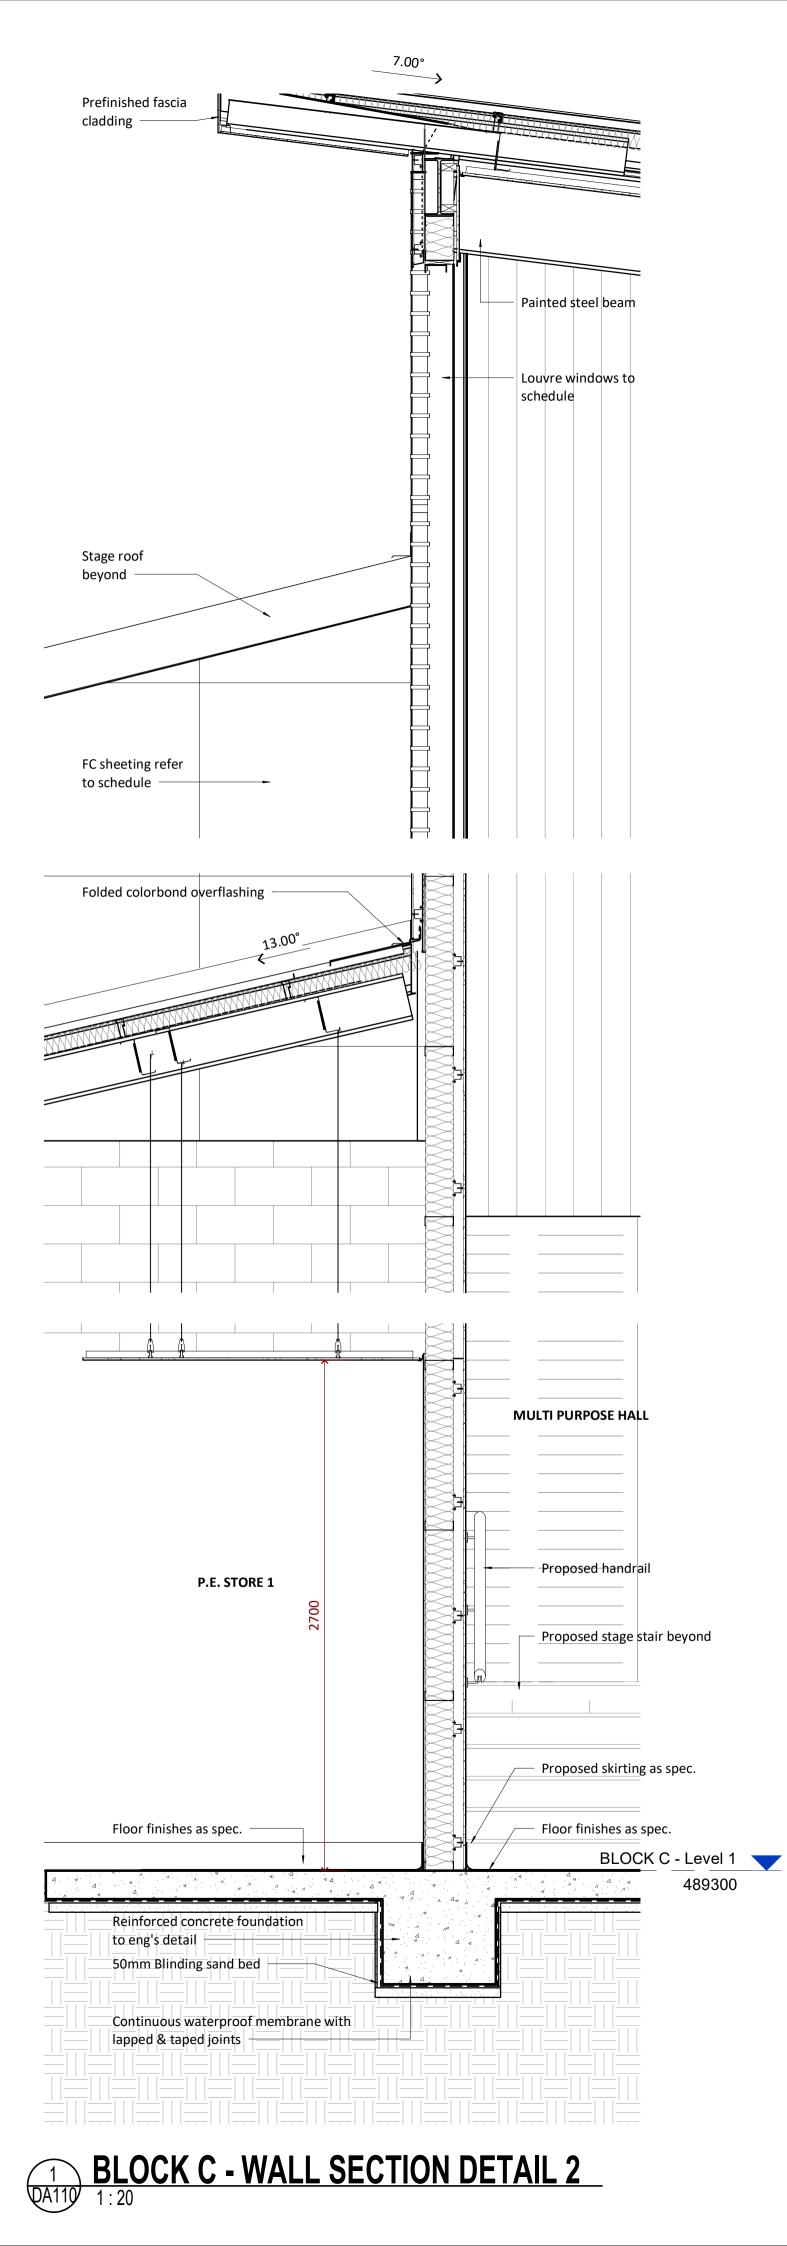

Dimensions take precedence over scaling. Do not measure off drawings as print sizes may vary.

		keyplan	
	LEGEND		
CODE	DESCRIPTION		
BAL-1	Balustrade & handrail - type 1 to details		
DP	Downpipe		
GT	Gutter refer to hydraulic engineer		
LOC1	Lockers - Student		
РСР	Painted concrete column		
PSC	Painted steel column		
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RGF	Colorbond metal gutter & fascia		
RMS1	Colorbond profiled metal roof sheet - type 1		
RMS2	Colorbond profiled metal roof sheet - type 2		
RPS	Polycarbonate roof sheet		
RWT	Rain water tank		
SL	Metal profiled Soffit Lining		
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WBF3	Face brickwork - type 3		
WFC1	Painted fibre cement cladding type 1		
WFC2	Painted fibre cement cladding type 2		
WFC3	Painted fibre cement cladding type 3		
WFC4	Painted fibre cement cladding type 4		
WFC5	Painted fibre cement cladding type 5		
WFC6	Painted fibre cement cladding type 6		
WFC7	Painted fibre cement cladding type 7		
WFC8	Painted fibre cement cladding type 8		
WFC9	Painted fibre cement cladding type 9		
WFC.1			
WLV1	Louvre screen - type 1		
WLV2	Louvre screen - type 2		
WMS1	Profiled metal sheet cladding - type 1		
WMS2	Profiled metal sheet cladding - type 2		
WPL4	Pinboard lining - type 4		

SSDA- Project name adjusted	BLC	28.04.20	8
SSDA Issue, levels adjusted, dims added	BLC	01.04.20	7
GA NSW Issue	BLC	20.03.20	6
SSDA Documentation 90% Completion	DO	03.06.19	5
Carpark, paths, Block B Adjusted	BLC	22.05.19	4
Client Workshop Presentation	BLC	14.05.19	3
DRAW NUMBERS ADJUSTED, Buildings moved, Elevations adjusted	BLC	08.05.19	2
ESD Consult Issue	BLC	02.05.19	1
purpose of issue	by	date	issue no.
			architect



NOMINATED ARCHITECT : CHARLES GLANVILLE NSW REGISTRATION No. 3130



project

ST MATTHEW'S CATHOLIC SCHOOL - Secondary Campus

address

Corner of BROADHEAD and BRUCE RD. MUDGEE Lot 40 of DP 756894

STATE SIGNIFICANT DEVELOPMENT APPLICATION

	drawn:	RF
	checked:	BLC
	verified:	CG
	sheet size:	A1
north	scale:	1 : 20
graphic scale		6

489300

BLOCK C - SECTION DETAILS

18150	DA111	8

project no.

sheet no.

issue





Dimensions take precedence over scaling. Do not measure off drawings as print sizes may vary.

TAS Science		
Name	Area	
COLLABORATIVE LEARNING	103 m ²	
MINI LAB.	37 m ²	
PREP ROOM	34 m ²	
SCIENCE 1	100 m ²	
SCIENCE 2	100 m ²	
Grand total	373 m ²	

TAS BI	ock D
--------	-------

Name	Area	
3D PRINT	7 m ²	
CNC	7 m ²	
COURTYARD	56 m ²	
LASER CUT	7 m ²	
MACHINES	45 m ²	
MAJOR WORKS 3	24 m ²	
METAL	100 m ²	
PLANT	8 m ²	
STEM	100 m ²	
STORE	43 m ²	
WIP STORE 3	16 m ²	
WIP STORE 4	7 m ²	
WOOD	100 m ²	
Grand total	522 m ²	

Visual Arts					
Name Area					
ART 1	91 m²				
ART 2	92 m²				
ART SUPPLIES	13 m²				
COURTYARD	29 m²				
COURTYARD	47 m²				
DESIGN	45 m²				
MAJOR WORKS 1	63 m²				
POTTERY	22 m²				
WIP STORE 1	21 m²				
WIP STORE 2	27 m²				
Grand total	450 m ²				

Pupil Facilities Block D				
Name	Area			
ACC. WC Grand total	6 m² 6 m²			
Administratio				
Building Ser	vices			

Chapel

Enclosed Circulation

GLA-Secondary

Multi-Purpose Hall

Performing Arts

Pupil Facilites
Resource Centre

TAS

TAS Science

TAS-Food Technology

	keyplan
LEGEND	
DESCRIPTION	
Balustrade & handrail - type 1 to details	
Downpipe	
Gutter refer to hydraulic engineer	
Lockers - Student	
Painted concrete column	
Painted steel column	
Colorbond metal Barge capping	
Colorbond metal gutter & fascia	
Colorbond profiled metal roof sheet - type 1	
Colorbond profiled metal roof sheet - type 2	
Polycarbonate roof sheet	
Rain water tank	
Metal profiled Soffit Lining	
Face brickwork	
Face brickwork - type 1	
Face brickwork - type 3	
Painted fibre cement cladding type 1	
Painted fibre cement cladding type 2	
Painted fibre cement cladding type 3	
Painted fibre cement cladding type 4	
Painted fibre cement cladding type 5	
Painted fibre cement cladding type 6	
Painted fibre cement cladding type 7	
Painted fibre cement cladding type 8	
Painted fibre cement cladding type 9	
Louvre screen - type 1	
Louvre screen - type 2	
Profiled metal sheet cladding - type 1	
Profiled metal sheet cladding - type 2	
Pinboard lining - type 4	
	DESCRIPTIONBalustrade & handrail - type 1 to detailsDownpipeGutter refer to hydraulic engineerLockers - StudentPainted concrete columnPainted steel columnColorbond metal Barge cappingColorbond metal gutter & fasciaColorbond profiled metal roof sheet - type 1Colorbond profiled metal roof sheet - type 2Polycarbonate roof sheetRain water tankMetal profiled Soffit LiningFace brickworkFace brickwork - type 1Face brickwork - type 3Painted fibre cement cladding type 1Painted fibre cement cladding type 3Painted fibre cement cladding type 4Painted fibre cement cladding type 5Painted fibre cement cladding type 6Painted fibre cement cladding type 7Painted fibre cement cladding type 8Painted fibre cement cladding type 9Louvre screen - type 1Louvre screen - type 2Profiled metal sheet cladding - type 1Profiled metal sheet cladding - type 2

SSDA- Project name adjusted	BLC	28.04.20	11
SSDA Issue, Legend Updated	BLC	03.04.20	10
SSDA Issue, levels adjusted, dims added	BLC	01.04.20	9
GA NSW Issue	BLC	20.03.20	8
Design Development Sign off	CG	21.10.19	7
Access adjust, dis car added	BLC	31.07.19	6
SSDA Documentation 90% Completion	DO	03.06.19	5
Carpark, paths, Block B Adjusted	BLC	22.05.19	4
Client Workshop Presentation	BLC	14.05.19	3
purpose of issue	by	date	issue no.

architect





project

ST MATTHEW'S CATHOLIC SCHOOL - Secondary Campus

address

Corner of BROADHEAD and BRUCE RD. MUDGEE Lot 40 of DP 756894

STATE SIGNIFICANT DEVELOPMENT APPLICATION

north	drawn:	BLC
	checked:	CG
	verified:	CG
	sheet size:	A1
	scale:	1 : 100
graphic scale		6

BLOCK D - GROUND FLOOR PLAN

DA112 11

project no.

18150

sheet no.



BLOCK D - NORTH ELEVATION



BLOCK D - EAST ELEVATION



BLOCK D - SOUTH ELEVATION 1 : 100



BLOCK D - WEST ELEVATION 1 : 100

		5
		6965

C COPYRIGHT 2019

Dimensions take precedence over scaling. Do not measure off drawings as print sizes may vary.

		keyplan
	LEGEND	
CODE	DESCRIPTION	
BAL-1	Balustrade & handrail - type 1 to details	
DP	Downpipe	
GT	Gutter refer to hydraulic engineer	
LOC1	Lockers - Student	
РСР	Painted concrete column	
PSC	Painted steel column	
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WLV1	Louvre screen - type 1	
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WMS1	Profiled metal sheet cladding - type 1	
WMS2	Profiled metal sheet cladding - type 2	
WPL4	Pinboard lining - type 4	

SSDA- Project name adjusted	BLC	28.04.20	12
SSDA Issue, levels adjusted, dims added	BLC	01.04.20	11
GA NSW Issue	BLC	20.03.20	10
SSDA Documentation 90% Completion	DO	03.06.19	9
Client Workshop Presentation	BLC	14.05.19	8
DRAW NUMBERS ADJUSTED, Buildings moved, Elevations adjusted	BLC	08.05.19	7
ESD Consult Issue	BLC	02.05.19	6
Lift Supplier Issue	BLC	30.04.19	5
Consultant Issue	BLC	12.04.19	4
purpose of issue	by	date	issue no.

architect





project

ST MATTHEW'S CATHOLIC SCHOOL - Secondary Campus

address


Corner of BROADHEAD and BRUCE RD. MUDGEE Lot 40 of DP 756894

STATE SIGNIFICANT DEVELOPMENT APPLICATION

	drawn:	RF
	checked:	BLC
	verified:	CG
	sheet size:	A1
north	scale:	1 : 100
graphic scale		6


BLOCK D - ELEVATIONS sheet

DA113 12 18150

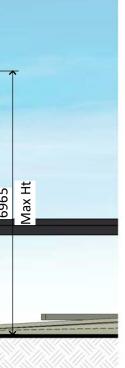


project no.

sheet n

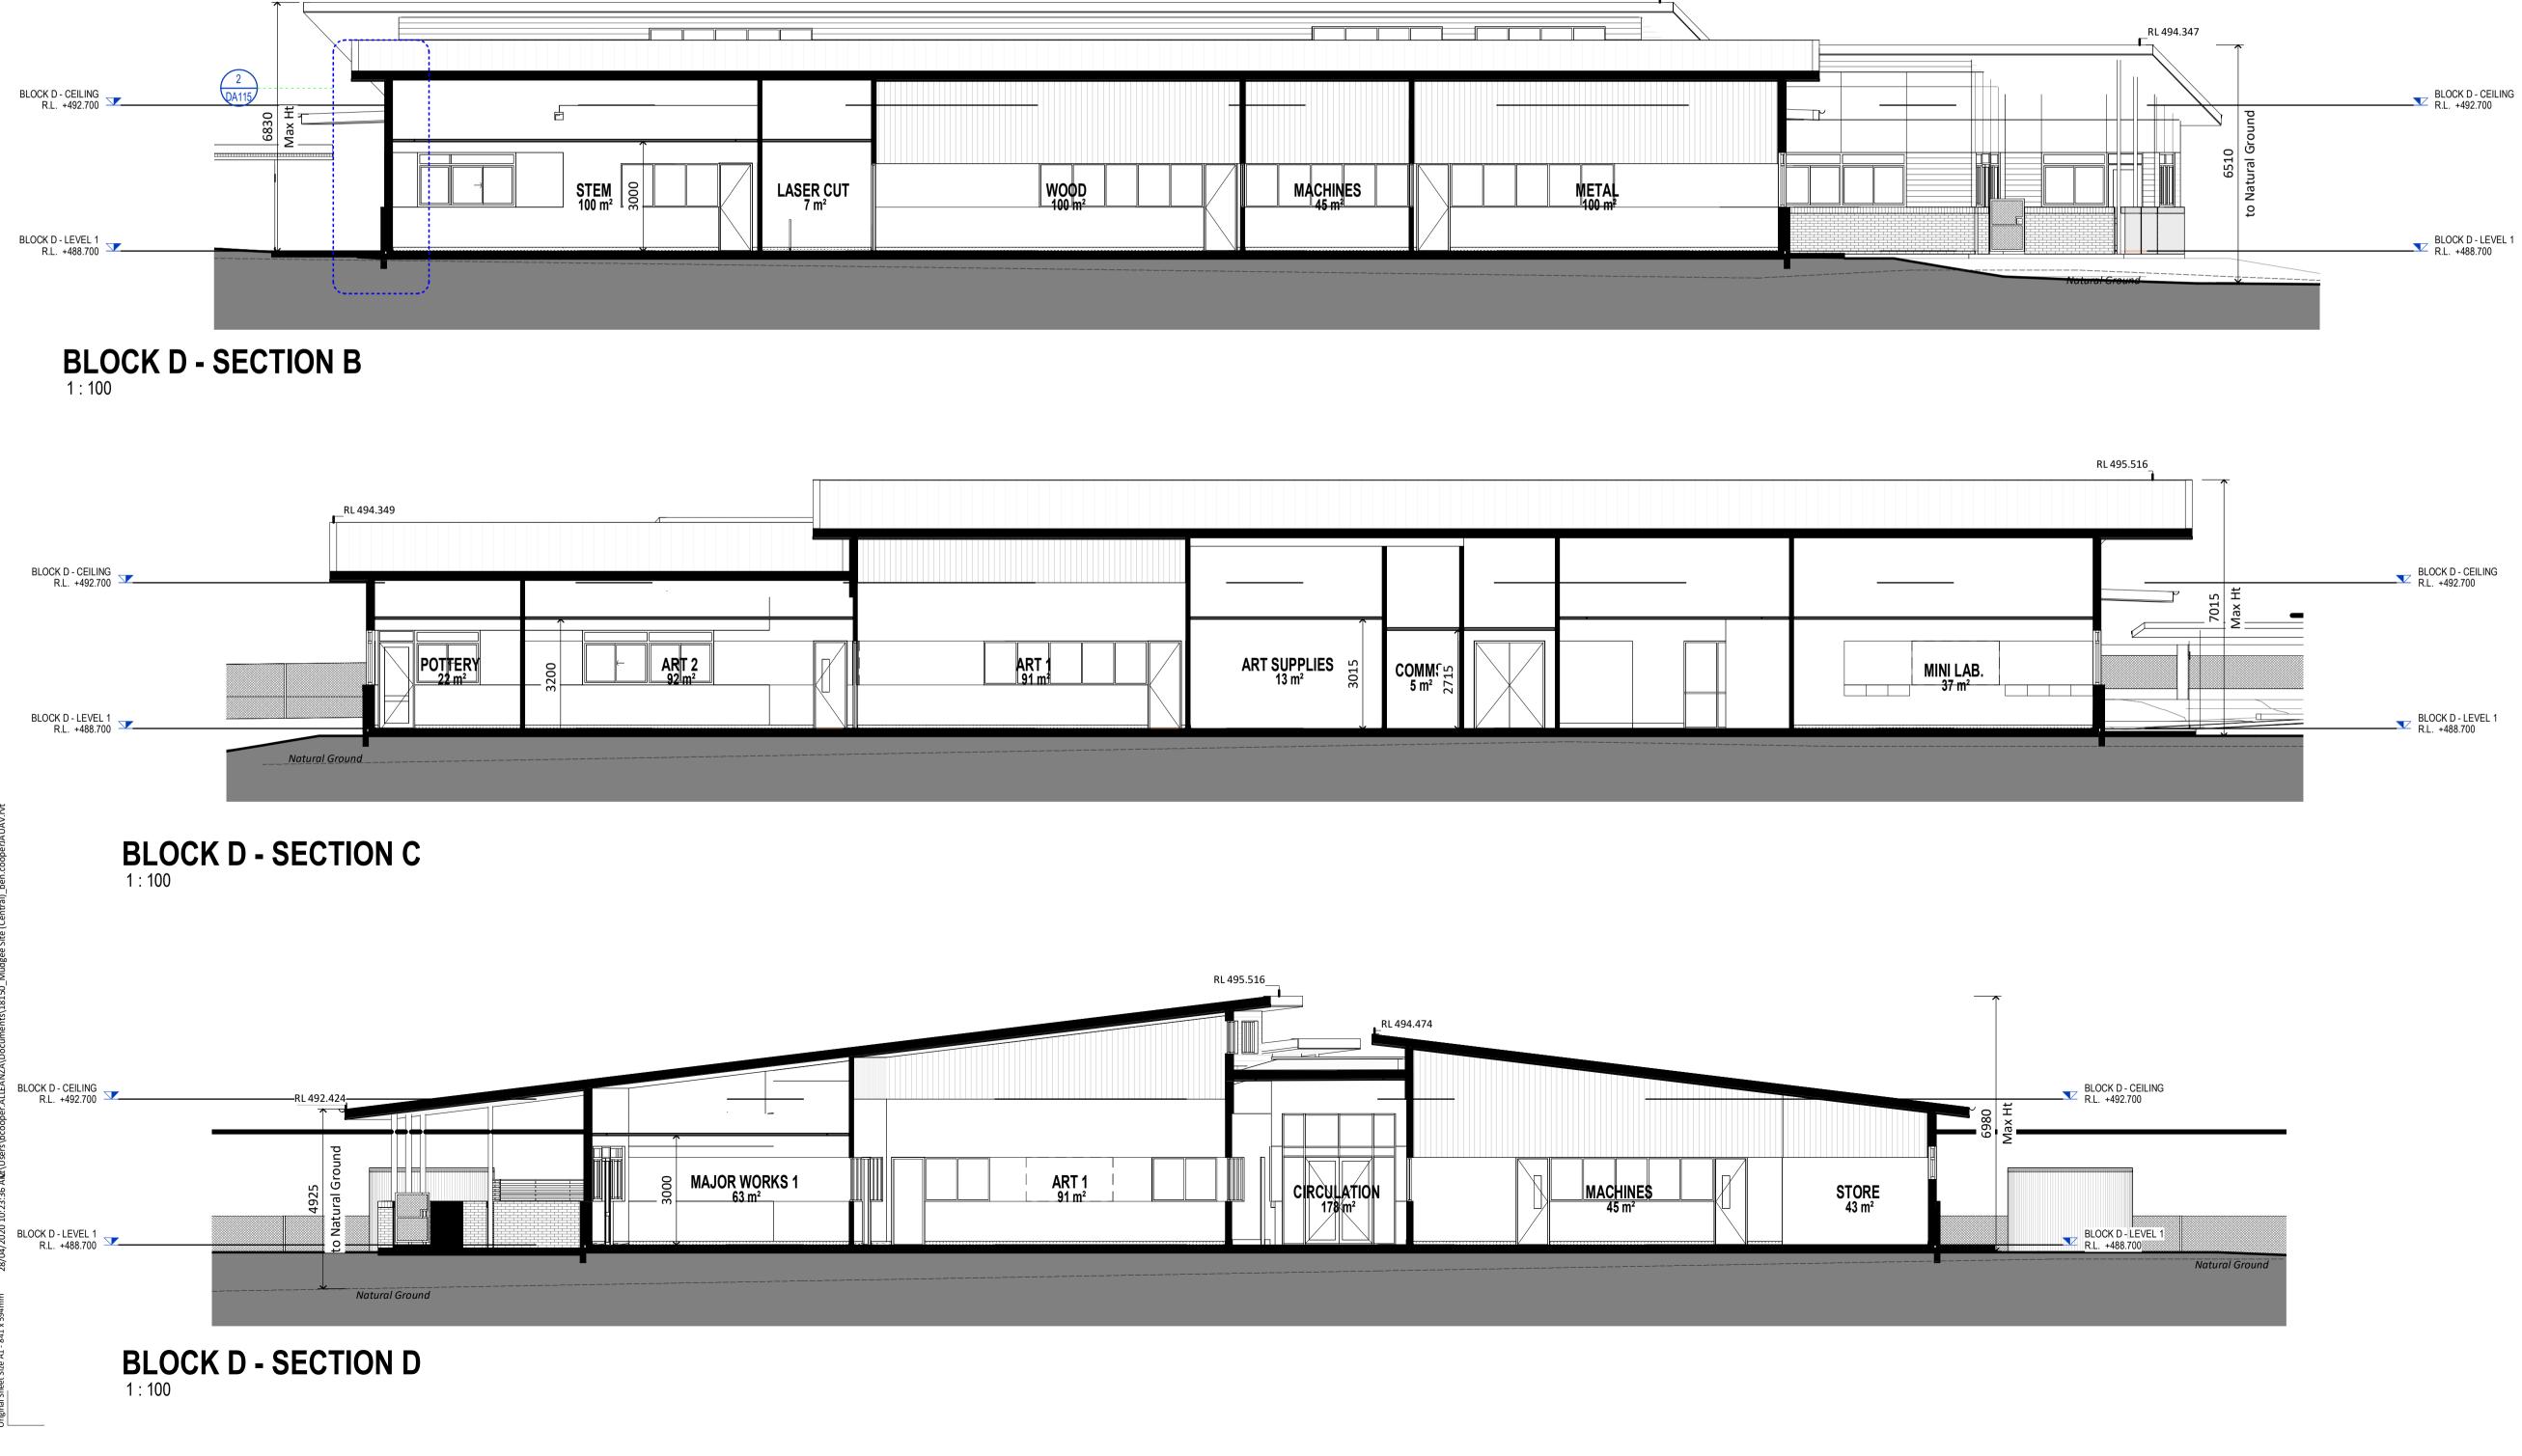

BLOCK D - SECTION A

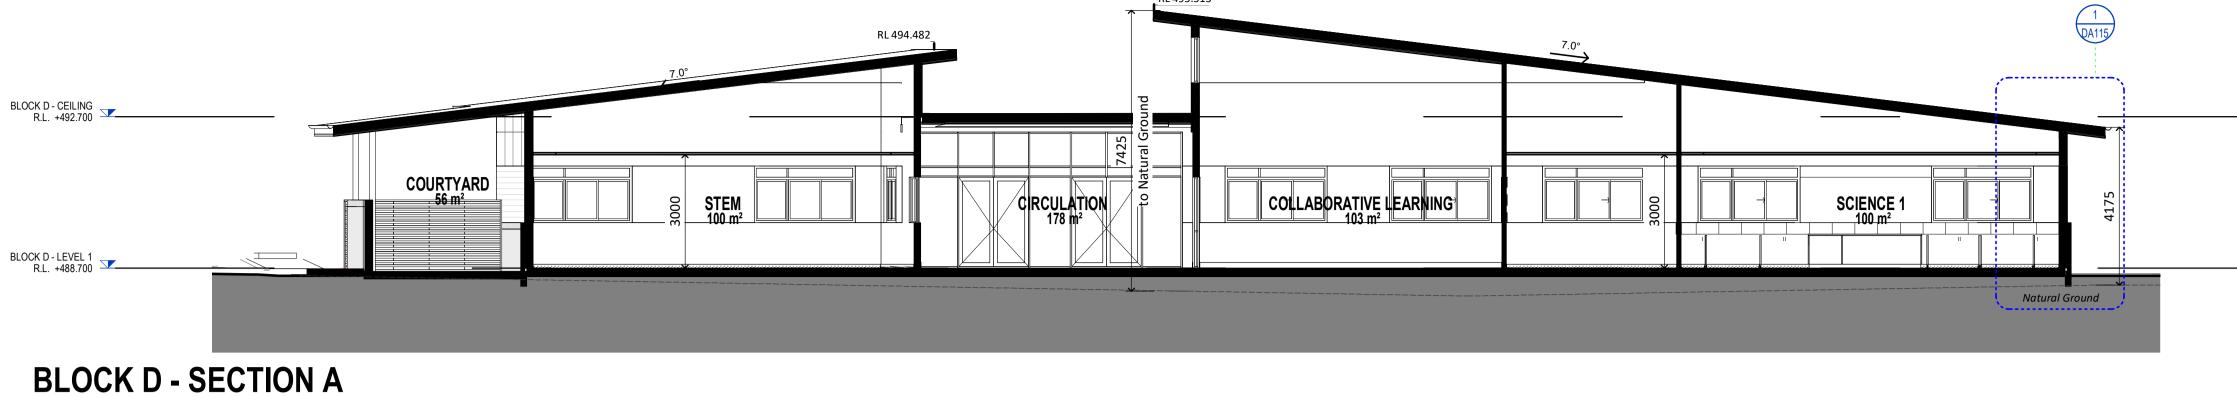

RL 495.513

		 		7015
ART SUPPLIES STOR	COMM ر 5 m² در 5 m²		MINI LAB.	

WOOD 100 m ²	MACHINES 45 m ²	METAL 100 m ²		
				Natural Ground

RL 495.514

C COPYRIGHT 2019

Dimensions take precedence over scaling. Do not measure off drawings as print sizes may vary.

 BLOCK D - CEILING R.L. +492.700
R.L. +492.700

BLOCK D - LEVEL 1 R.L. +488.700

		keyplan
	LEGEND	
CODE	DESCRIPTION	
BAL-1	Balustrade & handrail - type 1 to details	
DP	Downpipe	
GT	Gutter refer to hydraulic engineer	
LOC1	Lockers - Student	
РСР	Painted concrete column	
PSC	Painted steel column	
RBC	Colorbond metal Barge capping	
RGF	Colorbond metal gutter & fascia	
RMS1	Colorbond profiled metal roof sheet - type 1	
RMS2	Colorbond profiled metal roof sheet - type 2	
RPS	Polycarbonate roof sheet	
RWT	Rain water tank	
SL	Metal profiled Soffit Lining	
WBF	Face brickwork	
WBF1	Face brickwork - type 1	
WBF3	Face brickwork - type 3	
WFC1	Painted fibre cement cladding type 1	
WFC2	Painted fibre cement cladding type 2	
WFC3	Painted fibre cement cladding type 3	
WFC4	Painted fibre cement cladding type 4	
WFC5	Painted fibre cement cladding type 5	
WFC6	Painted fibre cement cladding type 6	
WFC7	Painted fibre cement cladding type 7	
WFC8	Painted fibre cement cladding type 8	
WFC9	Painted fibre cement cladding type 9	
WFC.1		
WLV1	Louvre screen - type 1	
WLV2	Louvre screen - type 2	
WMS1	Profiled metal sheet cladding - type 1	
WMS2	Profiled metal sheet cladding - type 2	
WPL4	Pinboard lining - type 4	

SSDA- Project name adjusted	BLC 28.04.20	9
SSDA Issue, levels adjusted, dims added	BLC 01.04.20	8
GA NSW Issue	BLC 20.03.20	7
Design Development Sign off	CG 21.10.19	6
SSDA Documentation 90% Completion	DO 03.06.19	5
Carpark, paths, Block B Adjusted	BLC 22.05.19	4
Client Workshop Presentation	BLC 14.05.19	3
DRAW NUMBERS ADJUSTED, Buildings moved, Elevations adjusted	BLC 08.05.19	2
Block E Lift moved	BLC 03.05.19	1
purpose of issue	by date issue	no.
	archit	ect



NOMINATED ARCHITECT : CHARLES GLANVILLE NSW REGISTRATION No. 3130



project

ST MATTHEW'S CATHOLIC SCHOOL - Secondary Campus

address

Corner of BROADHEAD and BRUCE RD. MUDGEE Lot 40 of DP 756894

STATE SIGNIFICANT DEVELOPMENT APPLICATION


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BLOCK D - SECTIONS


		sheet
.8150	DA114	9

project no.

issue



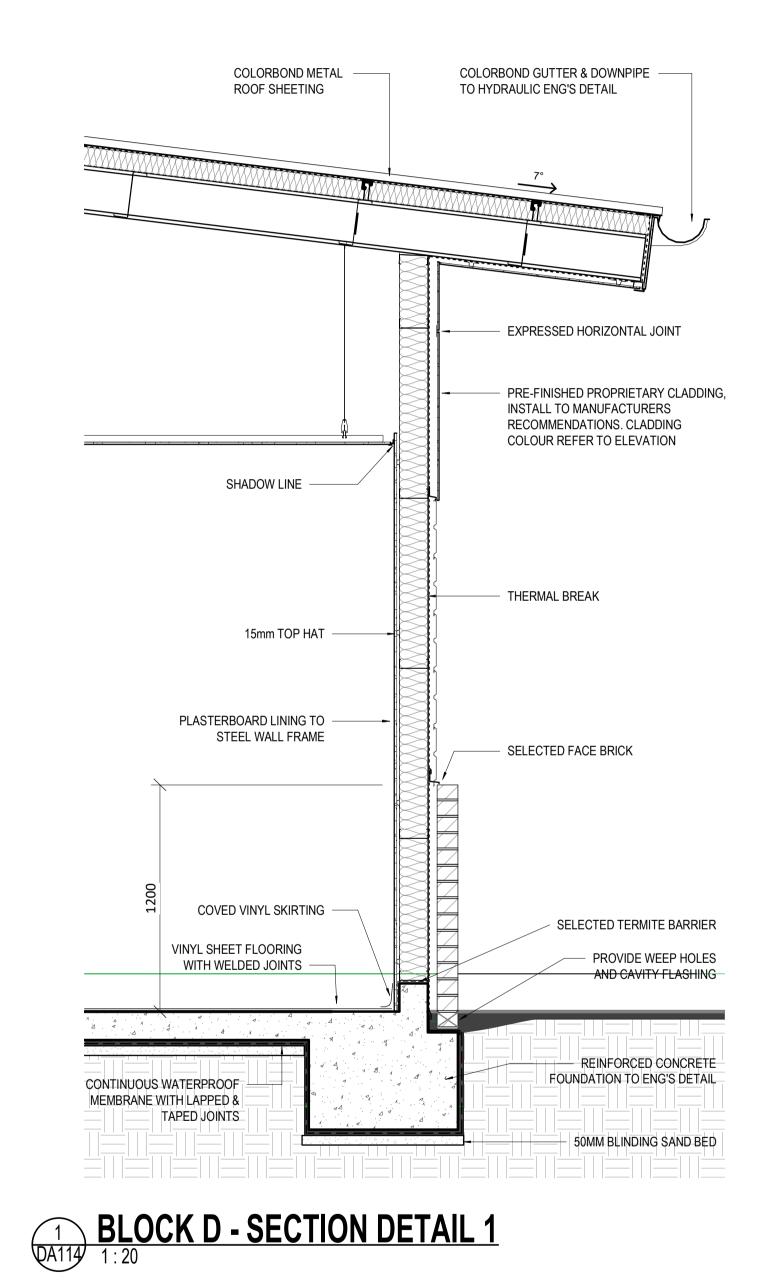

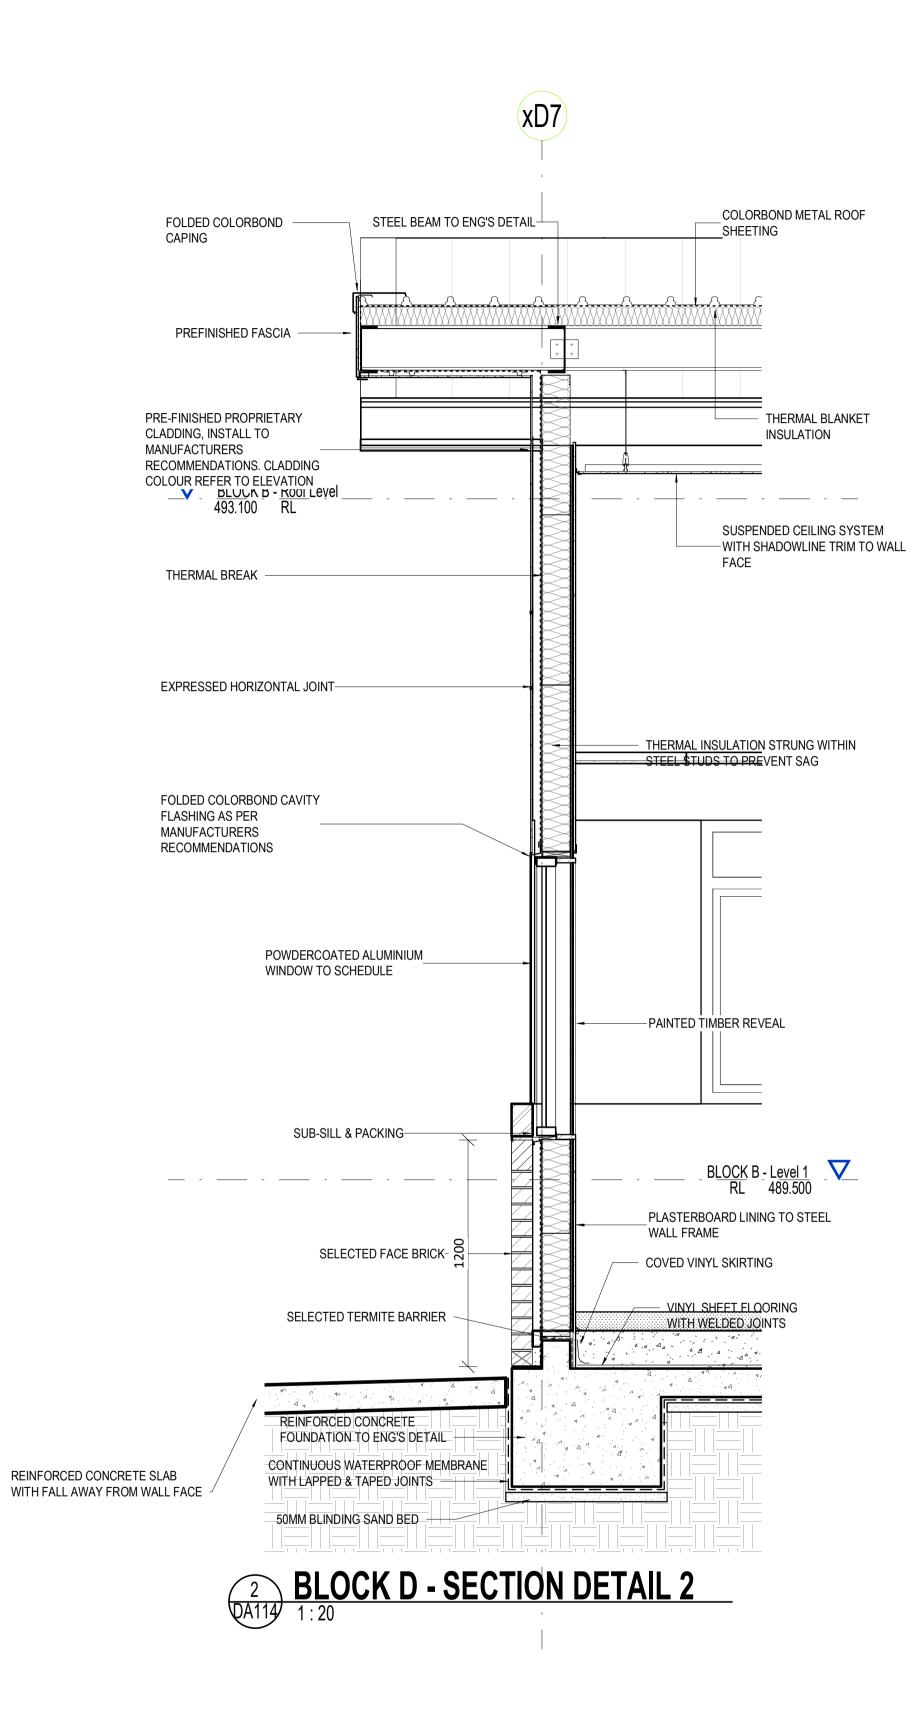

Dimensions take precedence over scaling. Do not measure off drawings as print sizes may vary.

		keyplan
	LEGEND	
CODE	DESCRIPTION	
BAL-1	Balustrade & handrail - type 1 to details	
DP	Downpipe	
GT	Gutter refer to hydraulic engineer	
LOC1	Lockers - Student	
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WFC4	Painted fibre cement cladding type 4	
WFC5	Painted fibre cement cladding type 5	
WFC6	Painted fibre cement cladding type 6	
WFC7	Painted fibre cement cladding type 7	
WFC8	Painted fibre cement cladding type 8	
WFC9	Painted fibre cement cladding type 9	
WFC.1		
WLV1	Louvre screen - type 1	
WLV2	Louvre screen - type 2	
WMS1	Profiled metal sheet cladding - type 1	
WMS2	Profiled metal sheet cladding - type 2	
WPL4	Pinboard lining - type 4	

SSDA- Project name adjusted	BLC	28.04.20	7
SSDA Issue, levels adjusted, dims added	BLC	01.04.20	6
GA NSW Issue	BLC	20.03.20	5
SSDA Documentation 90% Completion	DO	03.06.19	4
Carpark, paths, Block B Adjusted	BLC	22.05.19	3
Client Workshop Presentation	BLC	14.05.19	2
DRAW NUMBERS ADJUSTED, Buildings	BLC	08.05.19	1
moved, Elevations adjusted			
purpose of issue	by	date	issue no.

architect





project

ST MATTHEW'S CATHOLIC SCHOOL - Secondary Campus

address

Corner of BROADHEAD and BRUCE RD. MUDGEE Lot 40 of DP 756894

STATE SIGNIFICANT DEVELOPMENT APPLICATION


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graphic scale		6


BLOCK D - SECTION DETAILS

18150	DA115	7

sheet no.

issue

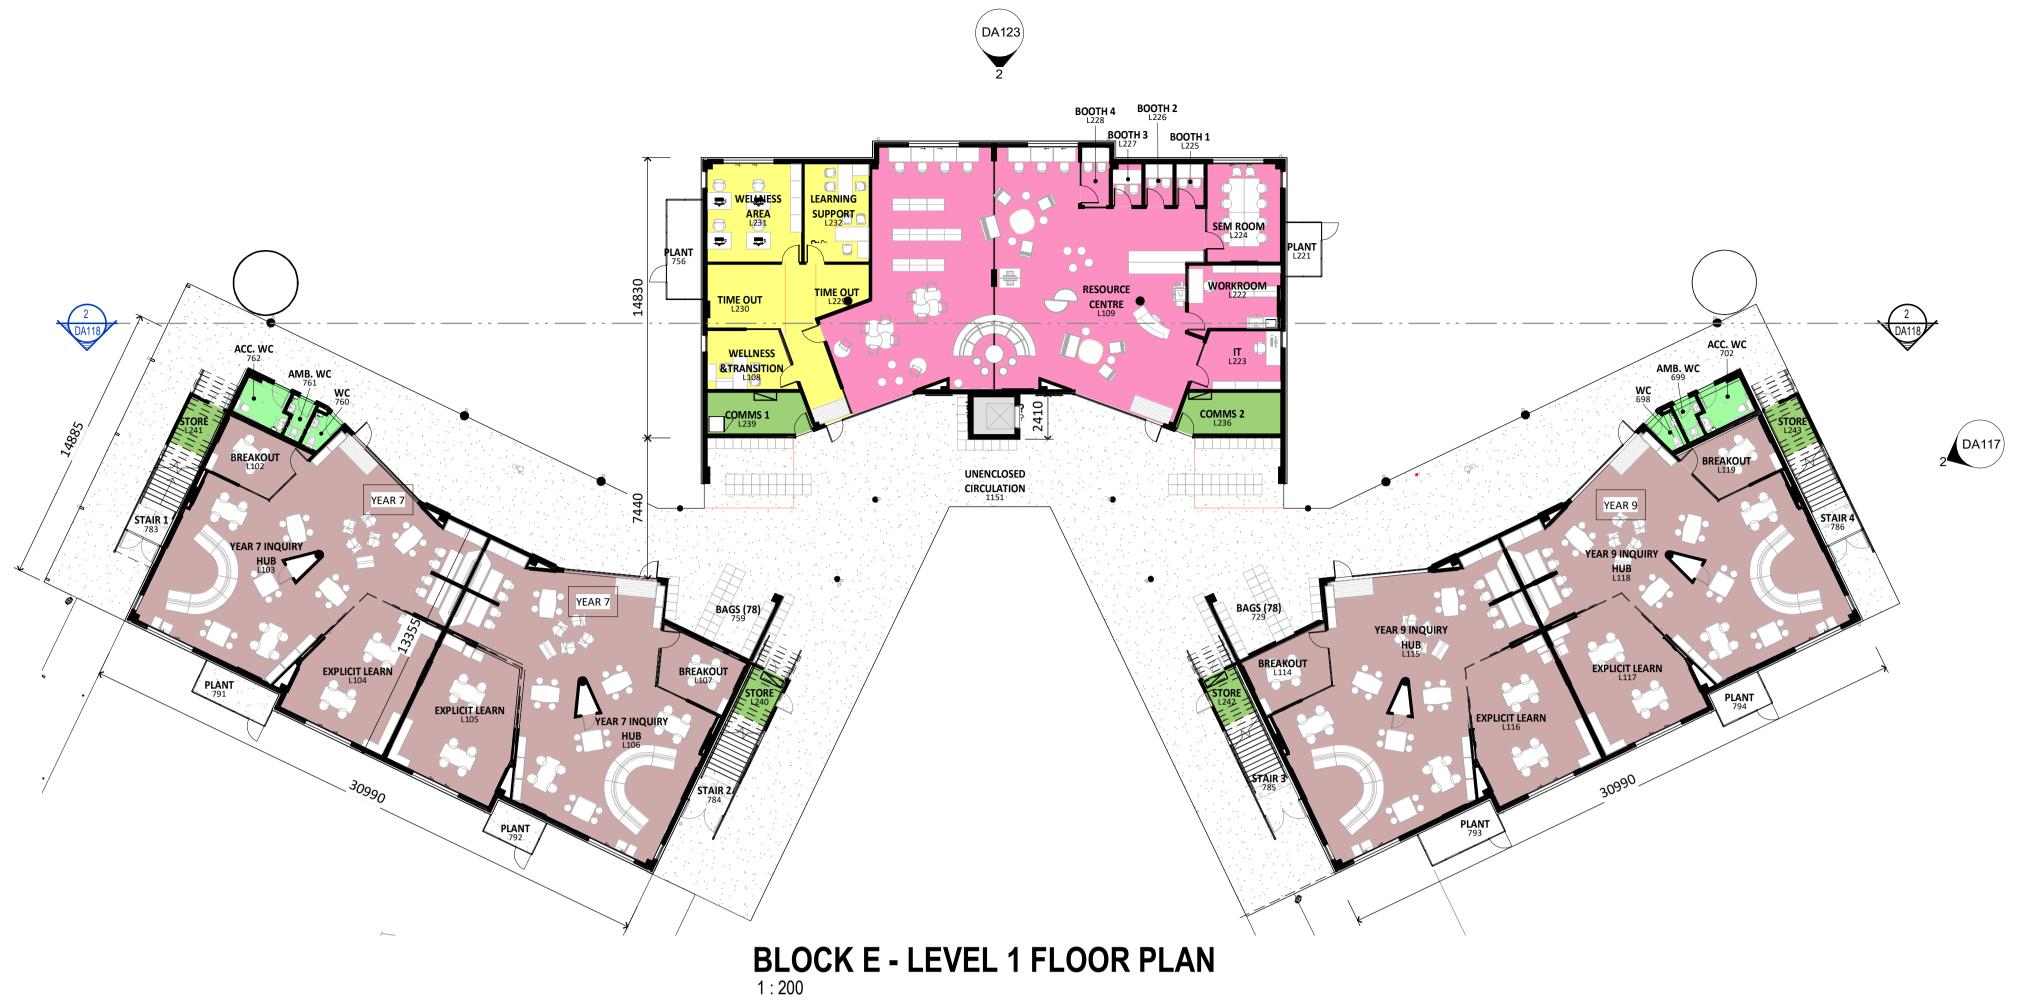

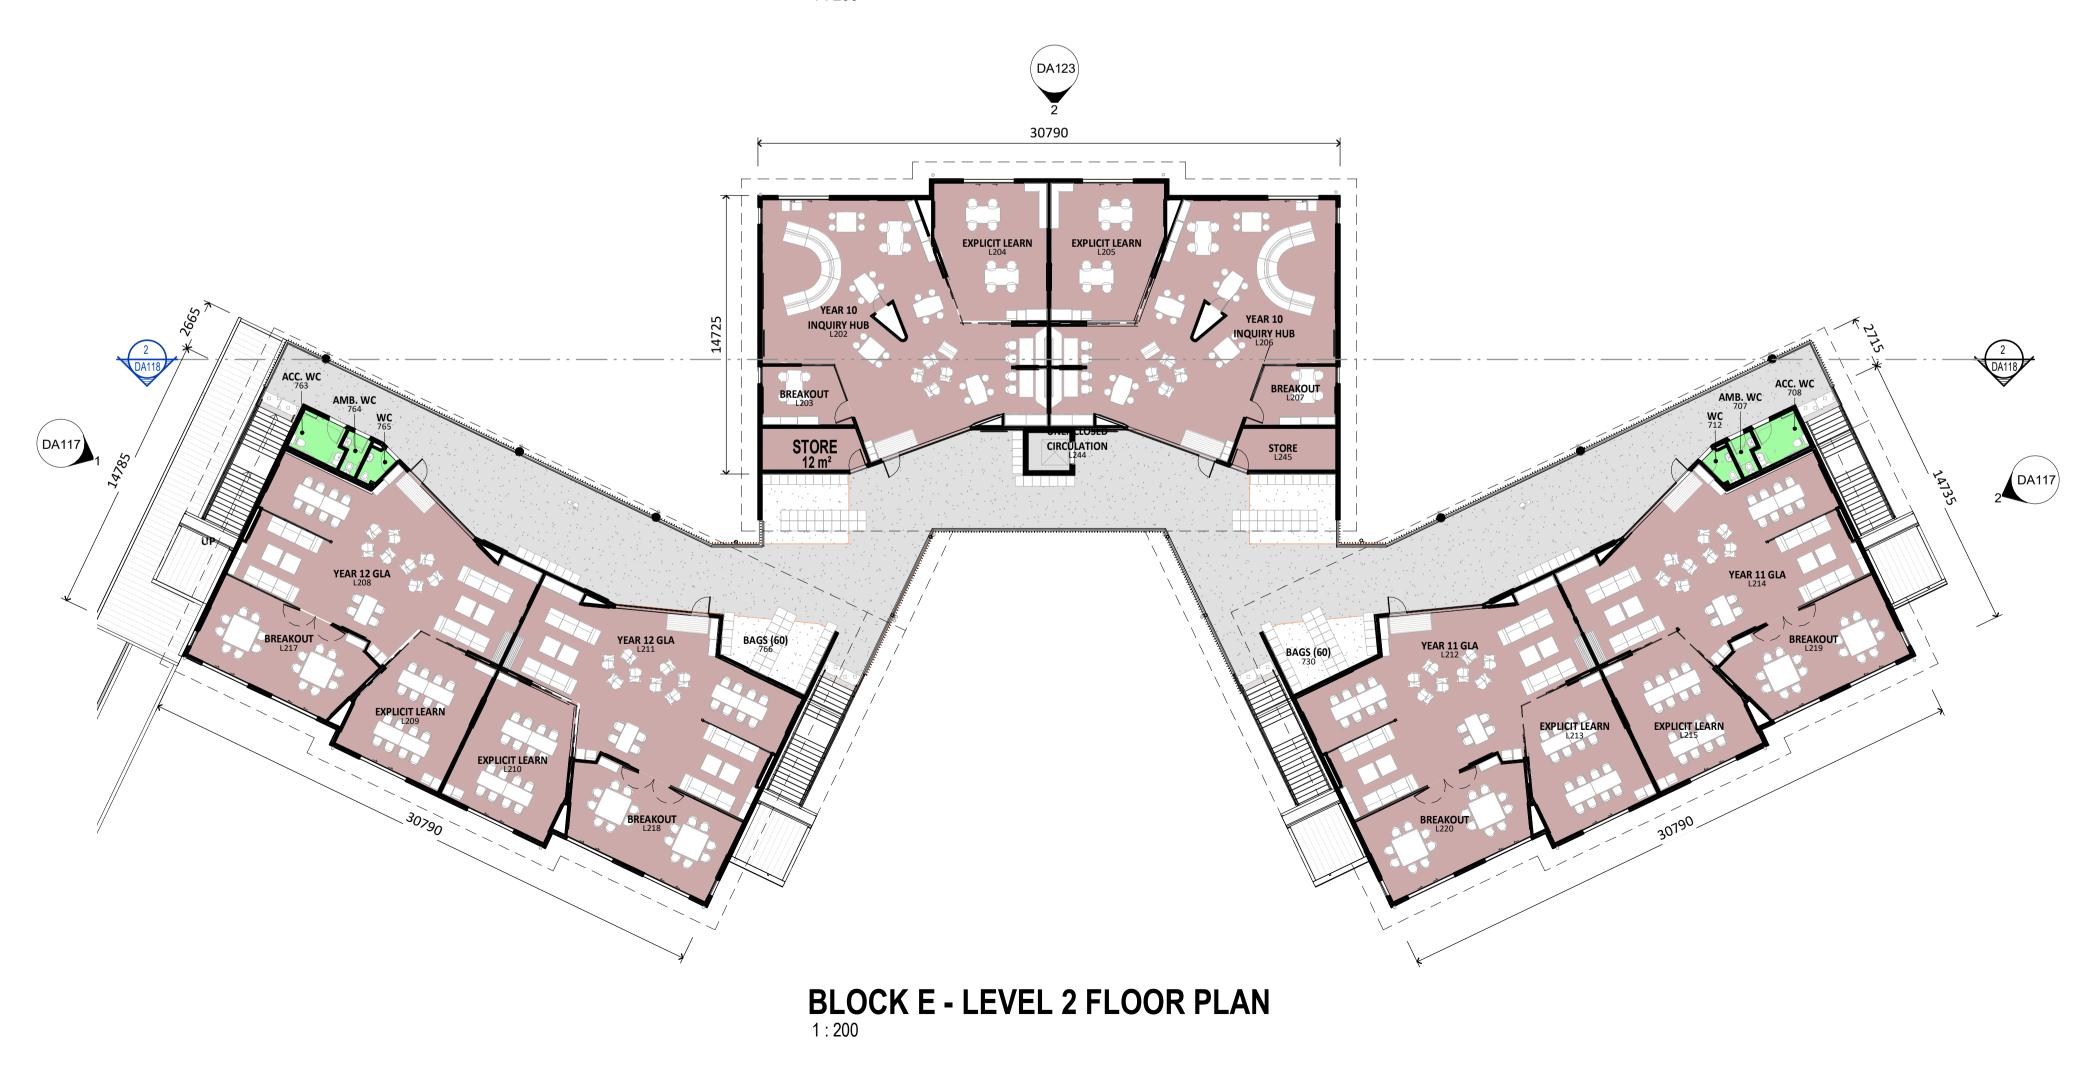

GLA - Sec	ondary
vv	Area
	-
YEAR 7 INQUIRY HUB	130 m²
YEAR 9 INQUIRY HUB	129 m²
YEAR 9 INQUIRY HUB	130 m²
BREAKOUT	13 m²
BREAKOUT	13 m²
BREAKOUT	14 m²
BREAKOUT	13 m²
EXPLICIT LEARN	40 m ²
EXPLICIT LEARN	40 m²
EXPLICIT LEARN	40 m ²
EXPLICIT LEARN	40 m ²
YEAR 10 INQUIRY HUB	131 m²
YEAR 10 INQUIRY HUB	130 m²
EXPLICIT LEARN	40 m ²
EXPLICIT LEARN	40 m ²
BREAKOUT	14 m²
BREAKOUT	13 m²
EXPLICIT LEARN	40 m²
YEAR 12 GLA	105 m ²
YEAR 12 GLA	105 m ²
YEAR 11 GLA	105 m ²
YEAR 11 GLA	105 m ²
YEAR 7 INQUIRY HUB	130 m²
BREAKOUT	41 m²
BREAKOUT	41 m²
BREAKOUT	41 m²
BREAKOUT	41 m²
STORE	12 m ²
STORE	12 m ²
Grand total	1864 m²

Dimensions take precedence over scaling. Do not measure off drawings as print sizes may vary.

		keyplan
	LEGEND	
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WMS1	Profiled metal sheet cladding - type 1	
WMS2	Profiled metal sheet cladding - type 2	
WPL4	Pinboard lining - type 4	

Pupil Facilities Block E	
Name	Area
ACC. WC	6 m²
AMB. WC	2 m ²
WC	2 m ²
WC	2 m ²
WC	2 m ²
WC	2 m ²
Grand total	42 m ²

Gr	rand total 42 m ²
	Administration
	Building Services
	Chapel
	Enclosed Circulation
	GLA-Secondary
	Multi-Purpose Hall
	Performing Arts
	Pupil Facilites
	Resource Centre
	TAS

TAS Science

Visual Arts

TAS-Food Technology

purpose of issue	by	date	issue no
Client Workshop Presentation	BLC	14.05.19	5
Carpark, paths, Block B Adjusted	BLC	22.05.19	e
SSDA Documentation 90% Completion	DO	03.06.19	7
Access adjust, dis car added	BLC	31.07.19	8
GA NSW Issue	BLC	20.03.20	ç
SSDA Issue, levels adjusted, dims added	BLC	01.04.20	10
SSDA Issue, Legend Updated	BLC	03.04.20	11
SSDA- BCA & Access Update	BLC	21.04.20	12
SSDA- Project name adjusted	BLC	28.04.20	13

architect





project

ST MATTHEW'S CATHOLIC SCHOOL - Secondary Campus

address

Corner of BROADHEAD and BRUCE RD. MUDGEE Lot 40 of DP 756894

STATE SIGNIFICANT DEVELOPMENT APPLICATION

	drawn:	BLC
	checked:	BLC
	verified:	CG
	sheet size:	A1
north	scale:	1 : 200
graphic scale		6

BLOCK E - GROUP FLOOR PLANS sheet

18150

DA116 13









BLOCK E - GA SOUTH ELEVATION



Dimensions take precedence over scaling. Do not measure off drawings as print sizes may vary.

		keyplan		
LEGEND				
CODE	DESCRIPTION			
BAL-1	Balustrade & handrail - type 1 to details			
DP	Downpipe			
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WMS1	Profiled metal sheet cladding - type 1			
WMS2	Profiled metal sheet cladding - type 2			
WPL4	Pinboard lining - type 4			

			architect
purpose of issue	by	date	issue no.
ESD Consult Issue	BLC	02.05.19	1
DRAW NUMBERS ADJUSTED, Buildings moved, Elevations adjusted	BLC	08.05.19	2
Client Workshop Presentation	BLC	14.05.19	3
SSDA Documentation 90% Completion	DO	03.06.19	4
GA NSW Issue	BLC	20.03.20	5
SSDA Issue, levels adjusted, dims added	BLC	01.04.20	6
SSDA- Project name adjusted	BLC	28.04.20	7



NOMINATED ARCHITECT : CHARLES GLANVILLE NSW REGISTRATION No. 3130



project

ST MATTHEW'S CATHOLIC SCHOOL - Secondary Campus

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Corner of BROADHEAD and BRUCE RD. MUDGEE Lot 40 of DP 756894

STATE SIGNIFICANT DEVELOPMENT APPLICATION

	drawn:	BLC
	checked:	BLC
	verified:	CG
	sheet size:	A1
north	scale:	1 : 200
graphic scale		6

BLOCK E - GROUP ELEVATIONS


18150

project no.

DA117

9655 Max Ht

issue

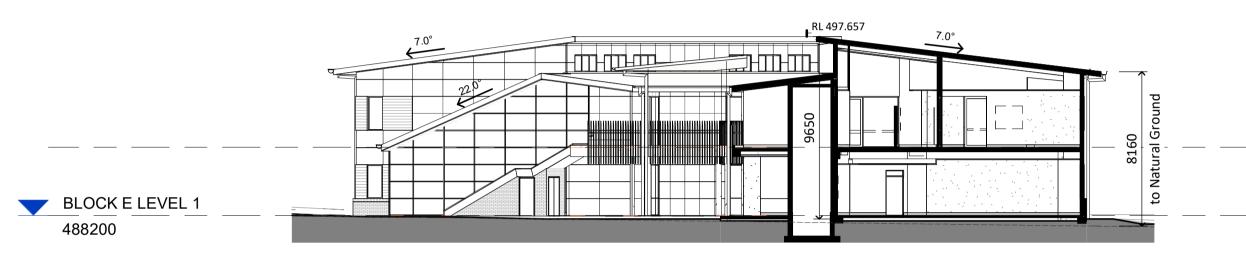

BLOCK E - GA CROSS SECTION



BLOCK E - GA LONG SECTION

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Dimensions take precedence over scaling. Do not measure off drawings as print sizes may vary.

		keyplan		
LEGEND				
CODE	DESCRIPTION			
BAL-1	Balustrade & handrail - type 1 to details			
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WFC9	Painted fibre cement cladding type 9			
WFC.1				
WLV1	Louvre screen - type 1			
WLV2	Louvre screen - type 2			
WMS1	Profiled metal sheet cladding - type 1			
WMS2	Profiled metal sheet cladding - type 2			
WPL4	Pinboard lining - type 4			

			architect
purpose of issue	by	date	issue no.
ESD Consult Issue	BLC	02.05.19	1
DRAW NUMBERS ADJUSTED, Buildings moved, Elevations adjusted	BLC	08.05.19	2
Client Workshop Presentation	BLC	14.05.19	3
Carpark, paths, Block B Adjusted	BLC	22.05.19	4
SSDA Documentation 90% Completion	DO	03.06.19	5
GA NSW Issue	BLC	20.03.20	6
SSDA Issue, levels adjusted, dims added	BLC	01.04.20	7
SSDA- Project name adjusted	BLC	28.04.20	8



NOMINATED ARCHITECT : CHARLES GLANVILLE NSW REGISTRATION No. 3130



project

ST MATTHEW'S CATHOLIC SCHOOL - Secondary Campus

address

Corner of BROADHEAD and BRUCE RD. MUDGEE Lot 40 of DP 756894


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graphic scale		6


BLOCK E - GROUP SECTIONS

		sneet
18150	DA118	8





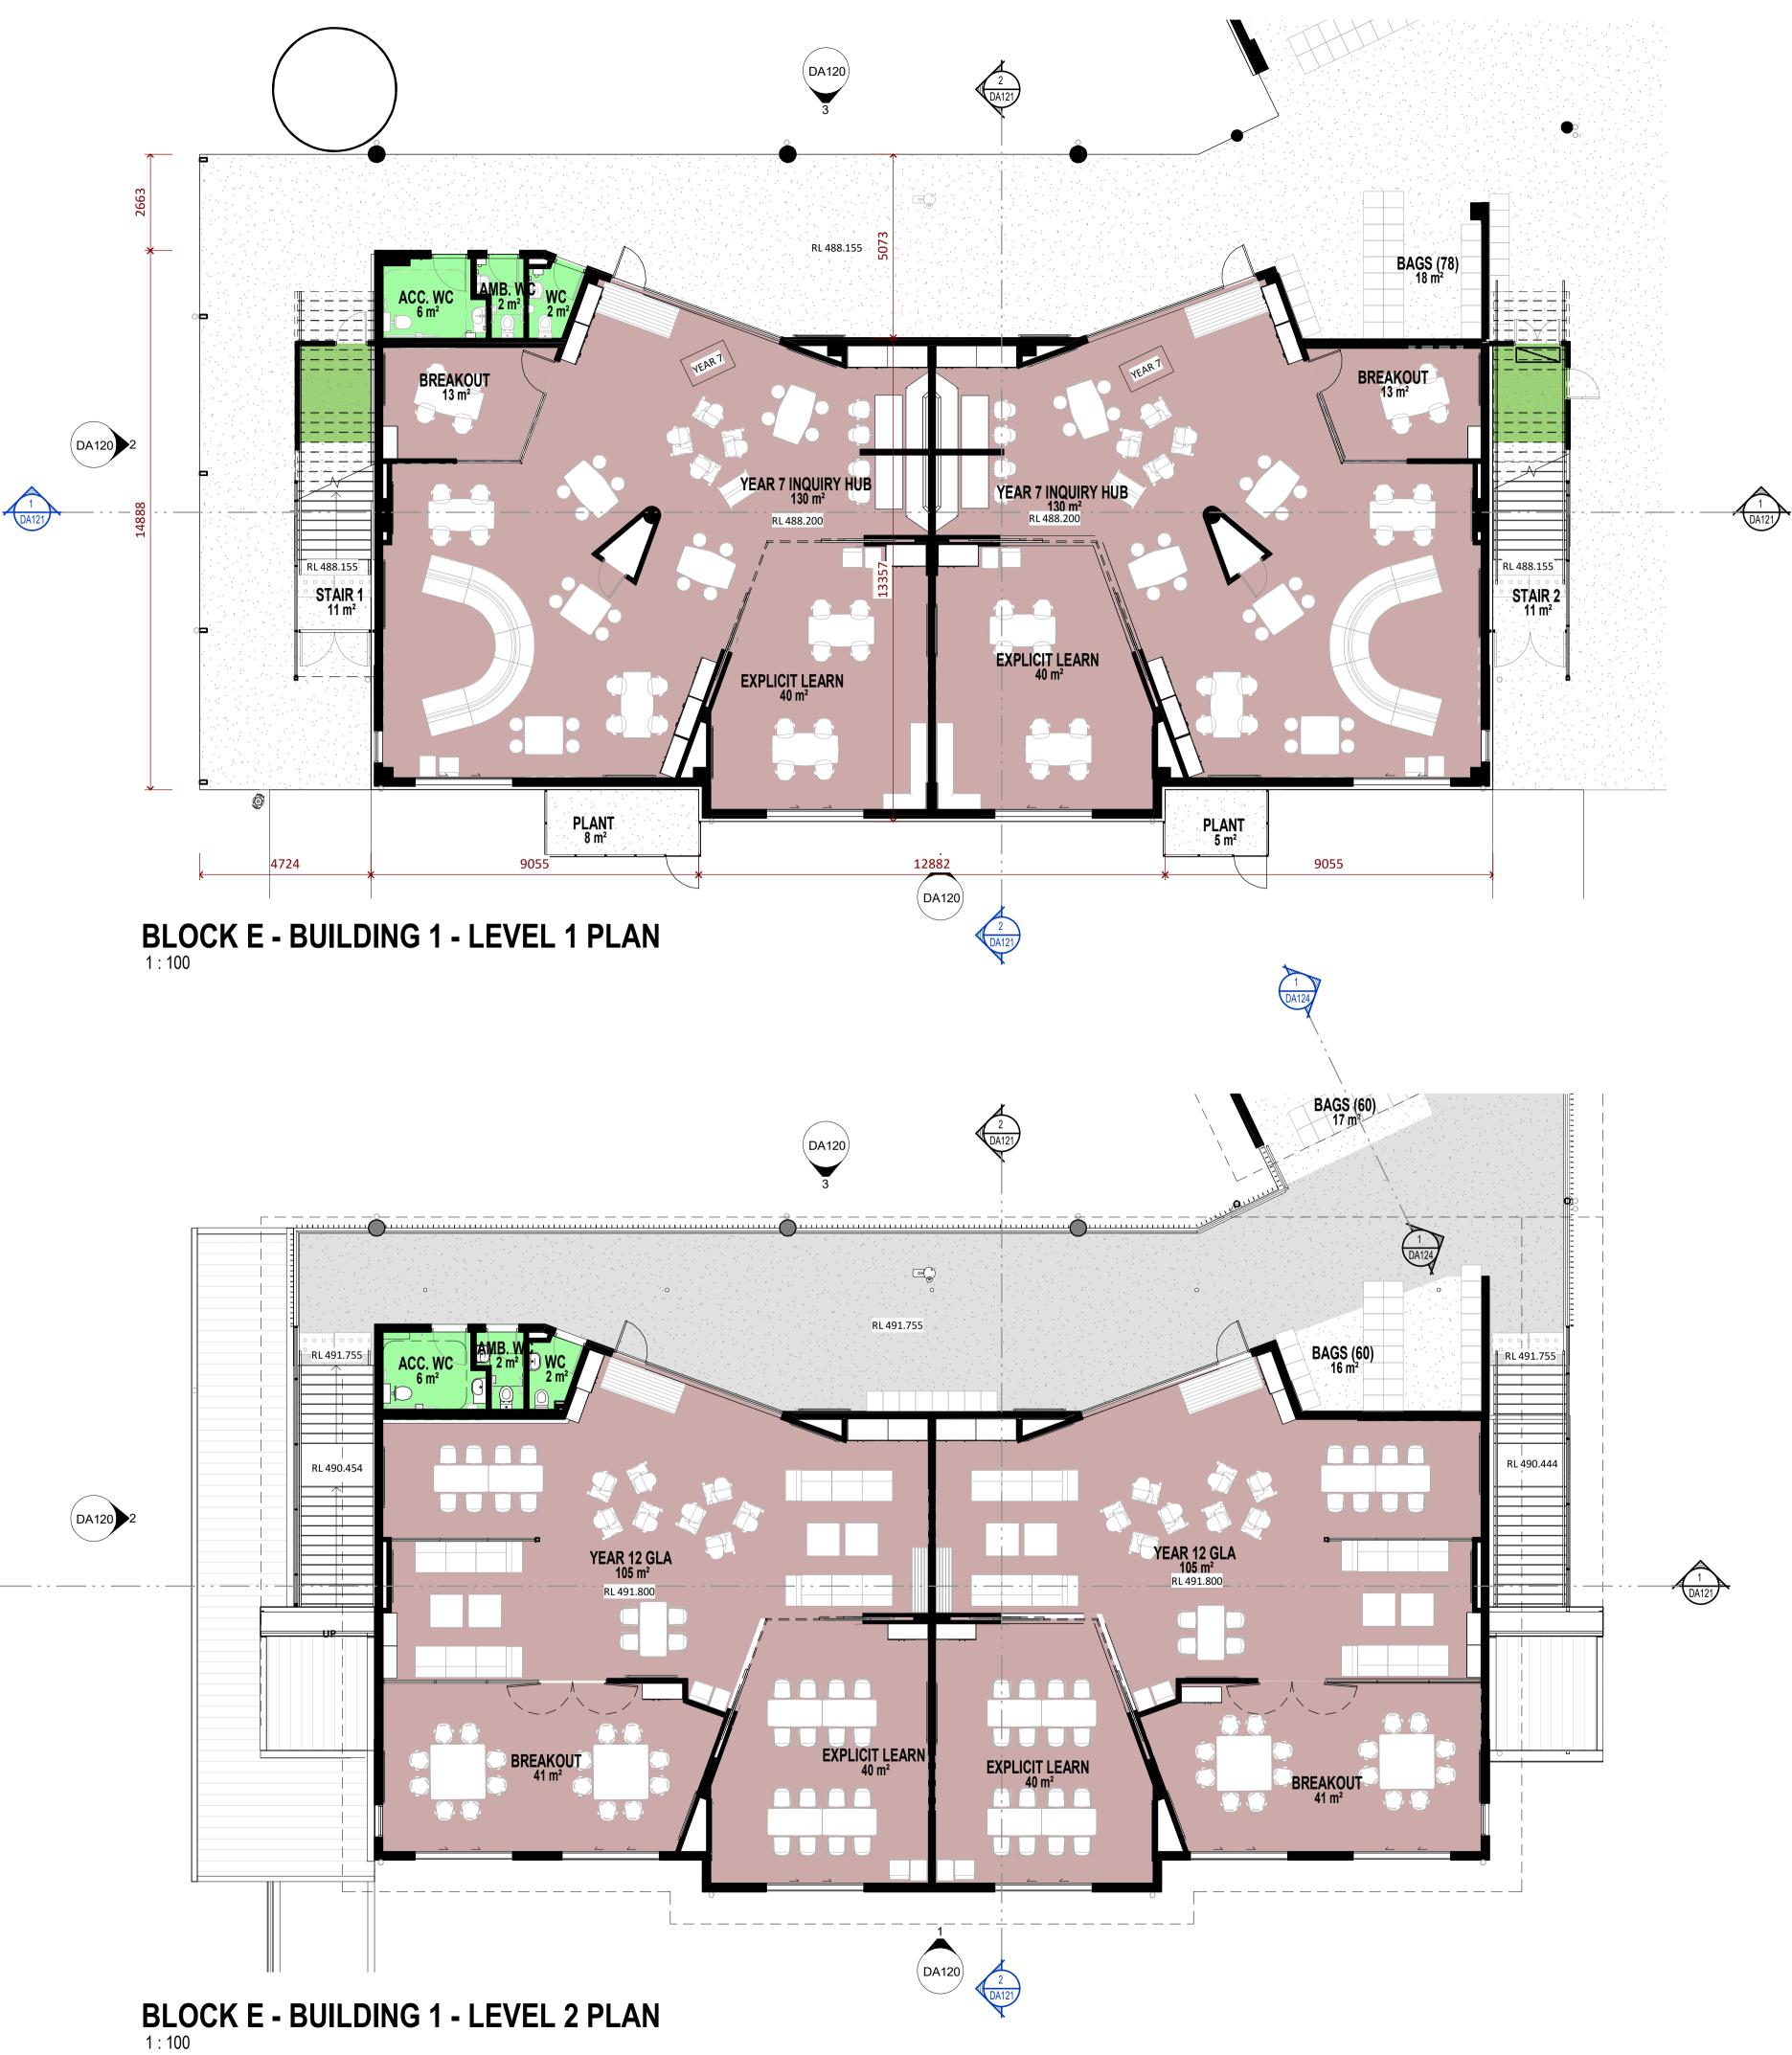

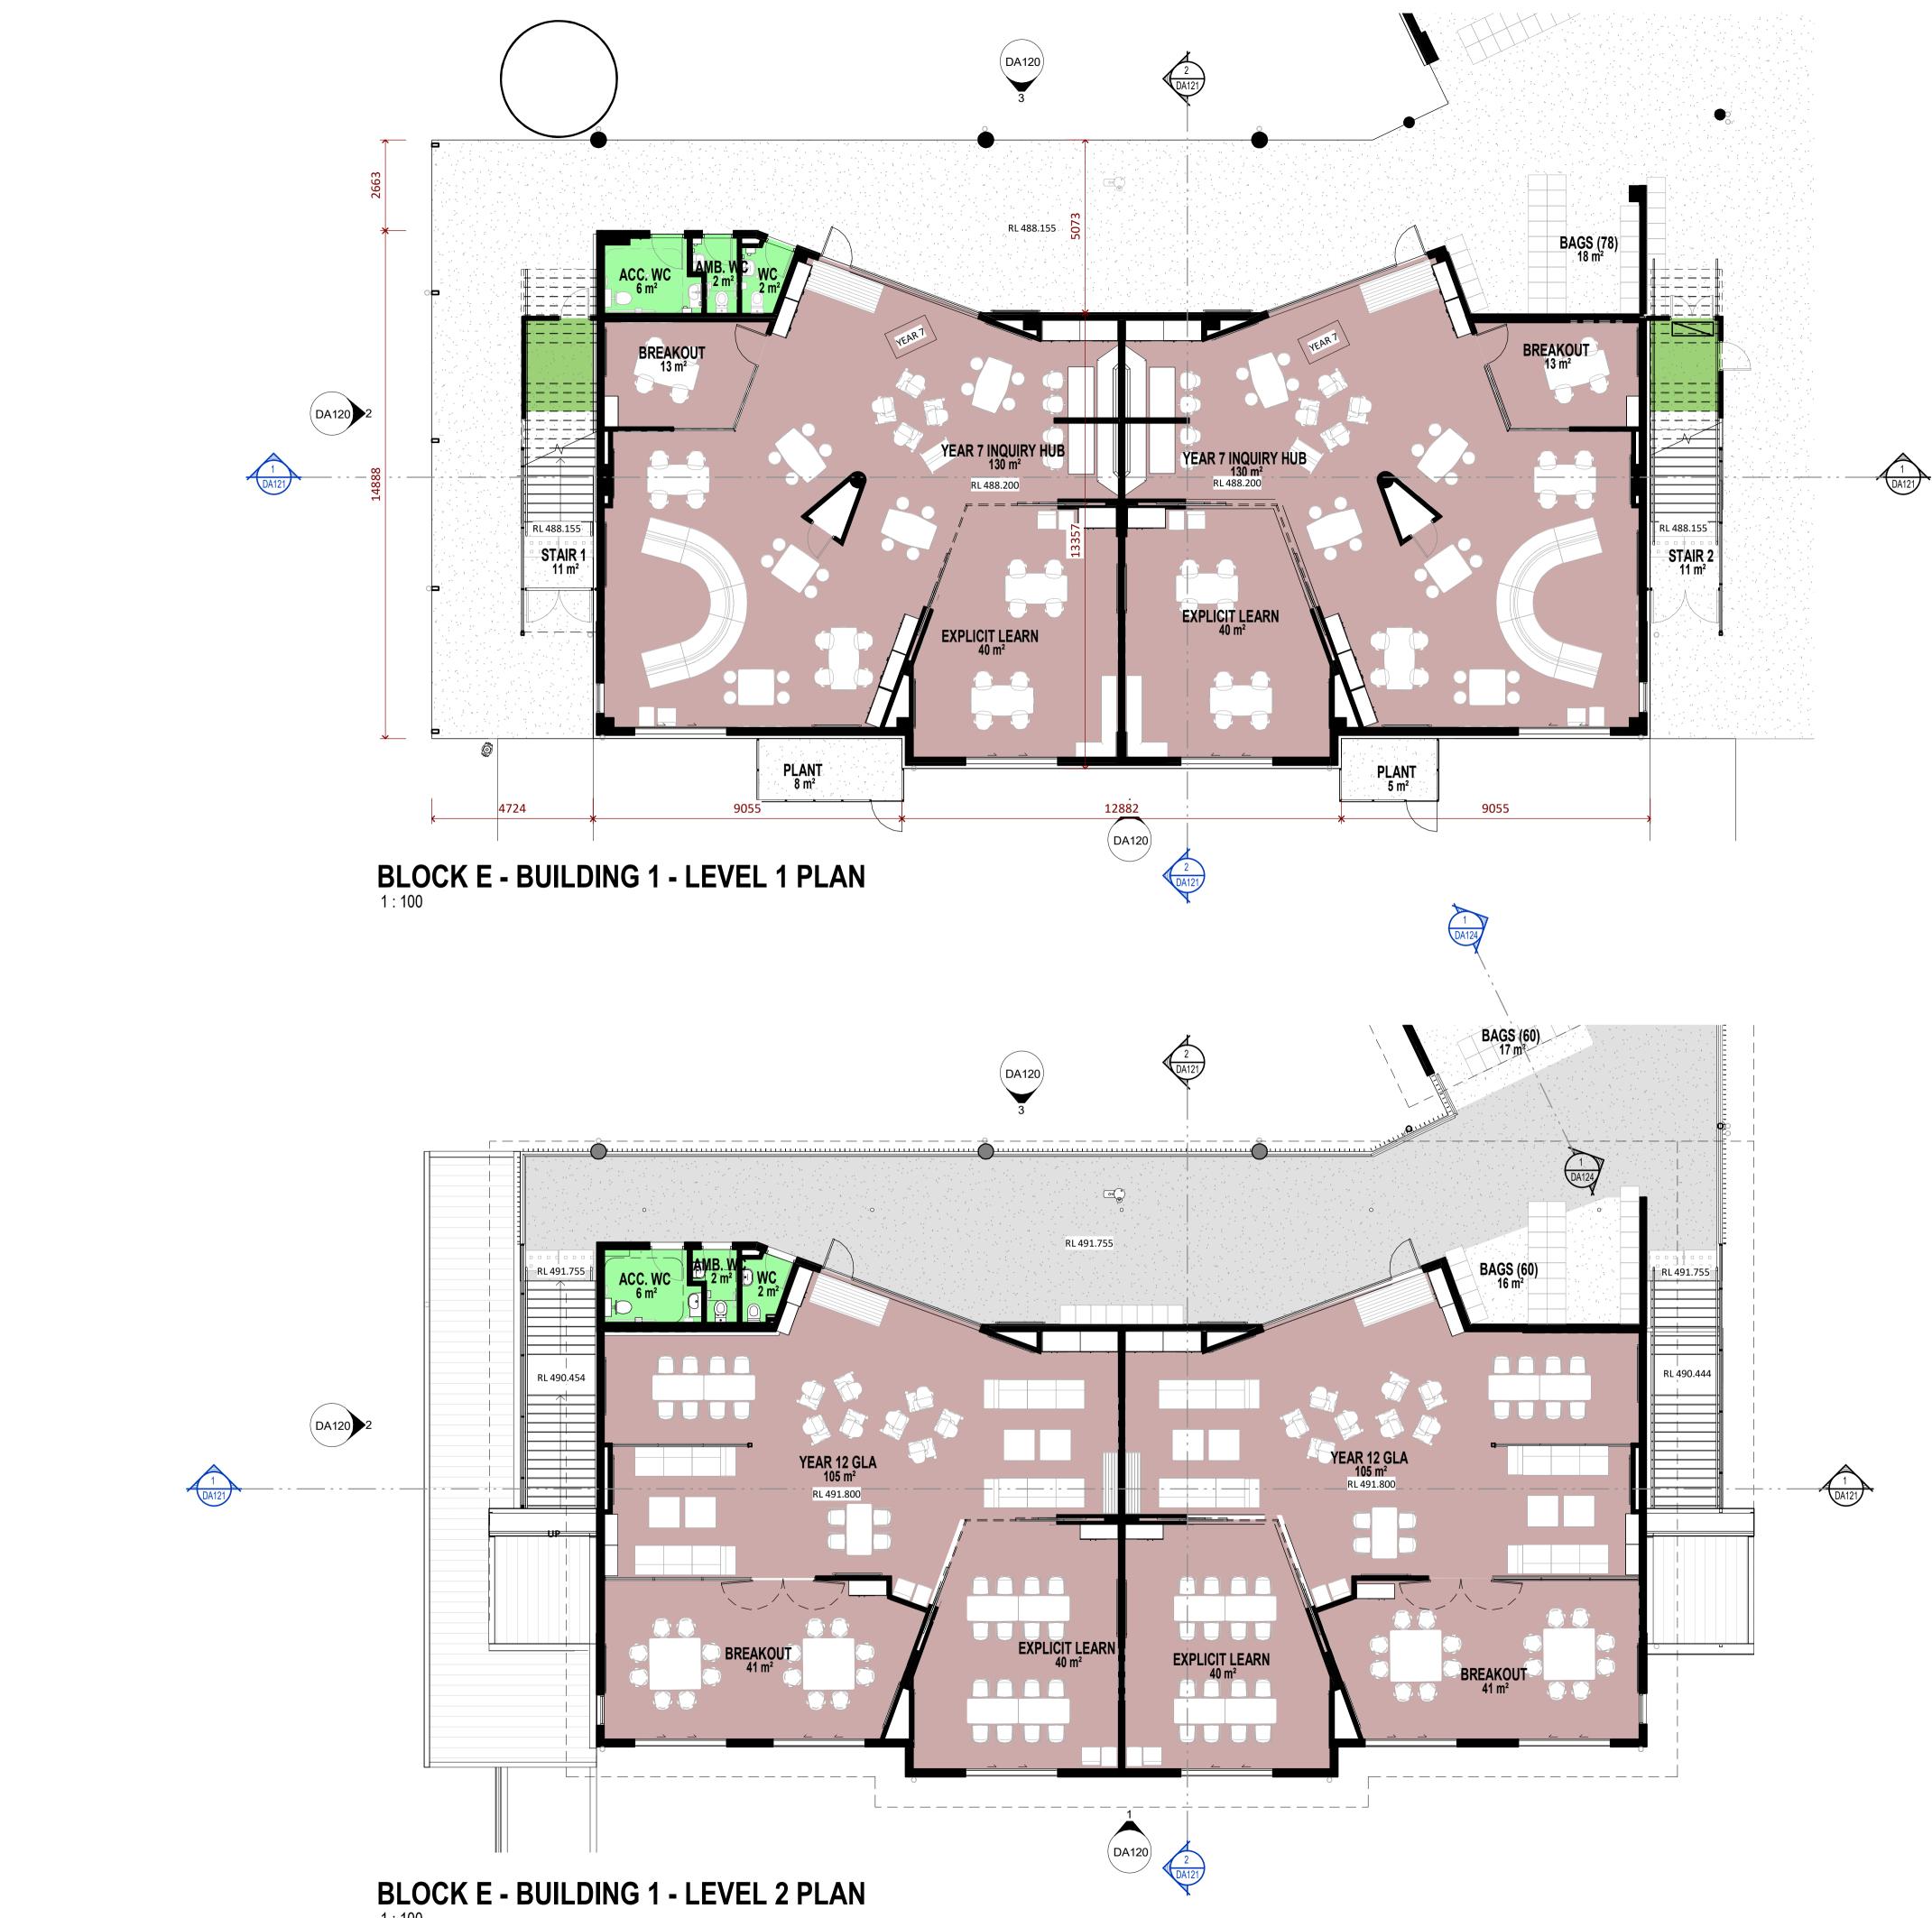

Dimensions take precedence over scaling. Do not measure off drawings as print sizes may vary.

		keyplan		
LEGEND				
CODE	DESCRIPTION			
BAL-1	Balustrade & handrail - type 1 to details			
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WFC6	Painted fibre cement cladding type 6			
WFC7	Painted fibre cement cladding type 7			
WFC8	Painted fibre cement cladding type 8			
WFC9	Painted fibre cement cladding type 9			
WFC.1				
WLV1	Louvre screen - type 1			
WLV2	Louvre screen - type 2			
WMS1	Profiled metal sheet cladding - type 1			
WMS2	Profiled metal sheet cladding - type 2			
WPL4	Pinboard lining - type 4			

SSDA- Project name adjusted	BLC	28.04.20	10
SSDA- BCA & Access Update	BLC	21.04.20	9
SSDA Issue, levels adjusted, dims added	BLC	01.04.20	8
GA NSW Issue	BLC	20.03.20	7
Design Development Sign off	CG	21.10.19	6
Access adjust, dis car added	BLC	31.07.19	5
SSDA Documentation 90% Completion	DO	03.06.19	4
Client Workshop Presentation	BLC	14.05.19	3
DRAW NUMBERS ADJUSTED, Buildings	BLC	08.05.19	2
moved, Elevations adjusted			
purpose of issue	by	date	issue no.

architect





project

ST MATTHEW'S CATHOLIC SCHOOL - Secondary Campus

address

Corner of BROADHEAD and BRUCE RD. MUDGEE Lot 40 of DP 756894

STATE SIGNIFICANT DEVELOPMENT APPLICATION

	drawn:	BLC
	checked:	BLC
	verified:	CG
	sheet size:	A1
north	scale:	1 : 100
graphic scale		6

BLOCK E - BUILDING 1 FLOOR PLANS sheet

DA119 10



BLOCK E - BUILDING 1 - SOUTH ELEVATION







BLOCK E - BUILDING 1 - NORTH ELEVATION

BLOCK E - BUILDING 1 - EAST ELEVATION

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Dimensions take precedence over scaling. Do not measure off drawings as print sizes may vary.

		keyplan		
	LEGEND			
CODE	DESCRIPTION			
BAL-1	Balustrade & handrail - type 1 to details			
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WPL4	Pinboard lining - type 4			



project

ST MATTHEW'S CATHOLIC SCHOOL - Secondary Campus

address

Corner of BROADHEAD and BRUCE RD. MUDGEE Lot 40 of DP 756894

STATE SIGNIFICANT DEVELOPMENT APPLICATION

	drawn:	BLC
	checked:	CG
	verified:	CG
	sheet size:	A1
north	scale:	1 : 100
graphic scale		6

BLOCK E - BUILDING 1 - ELEVATIONS


18150

DA120


sheet no

project no.

issue

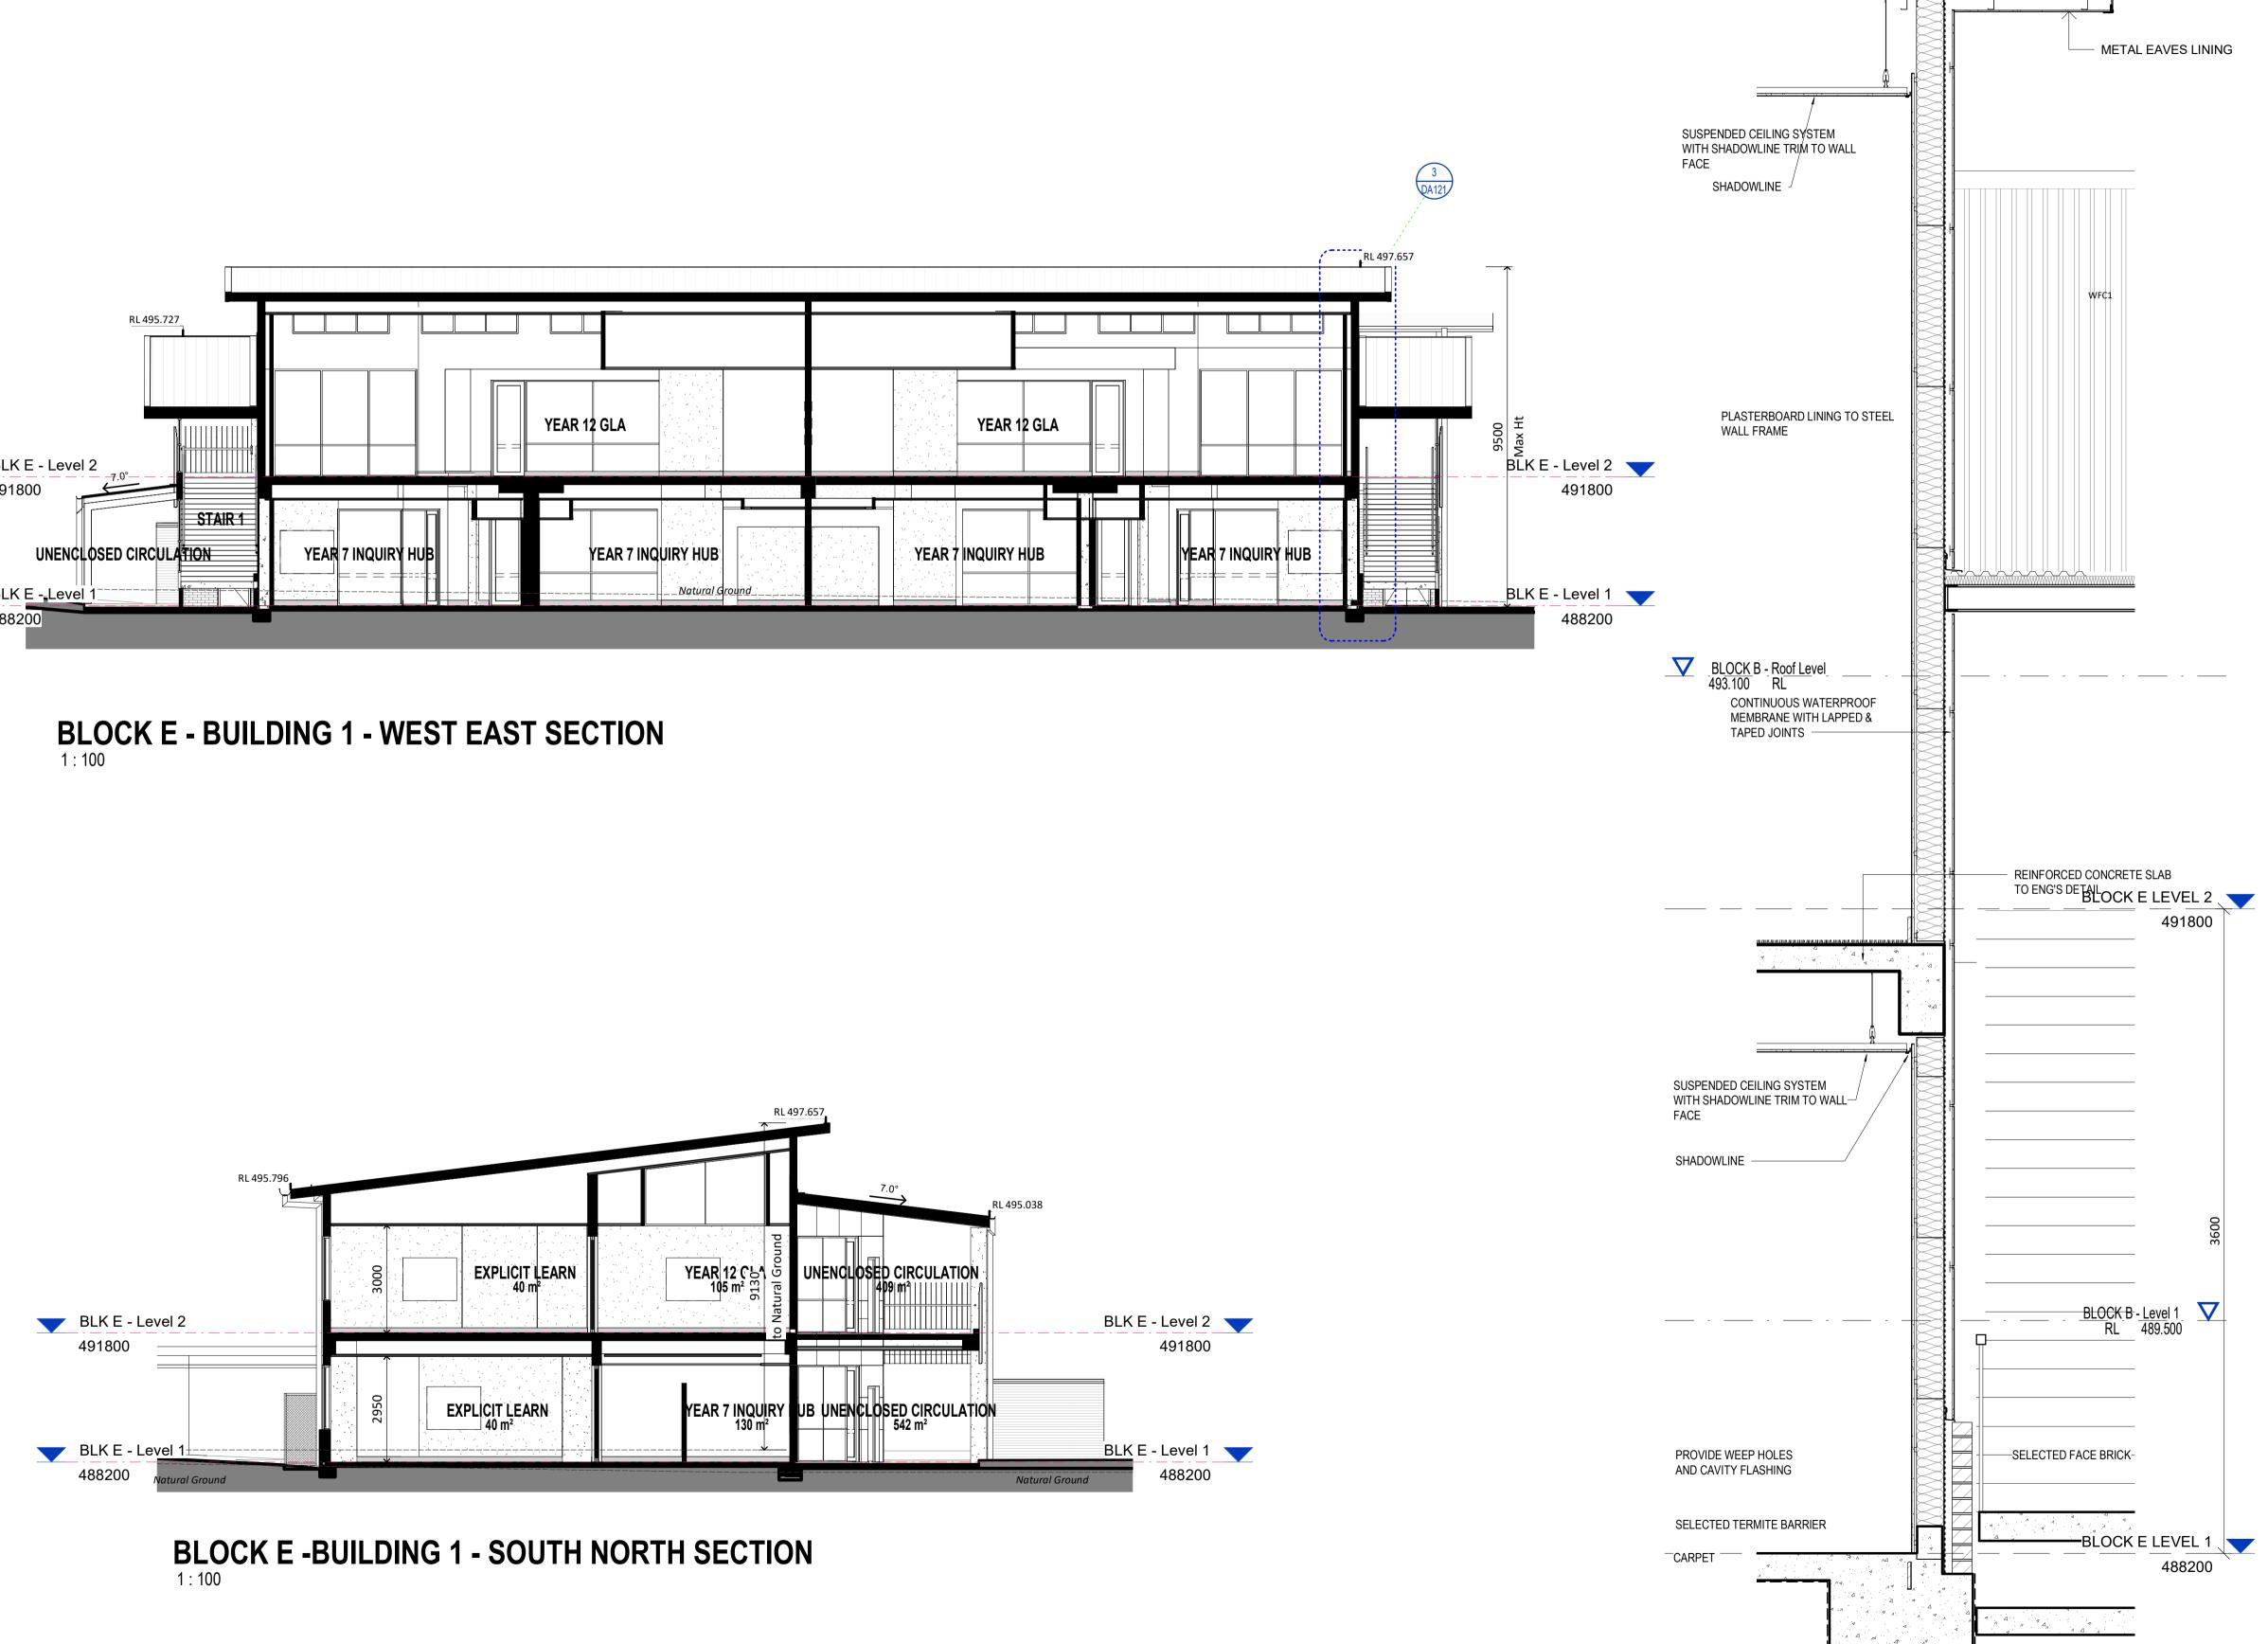




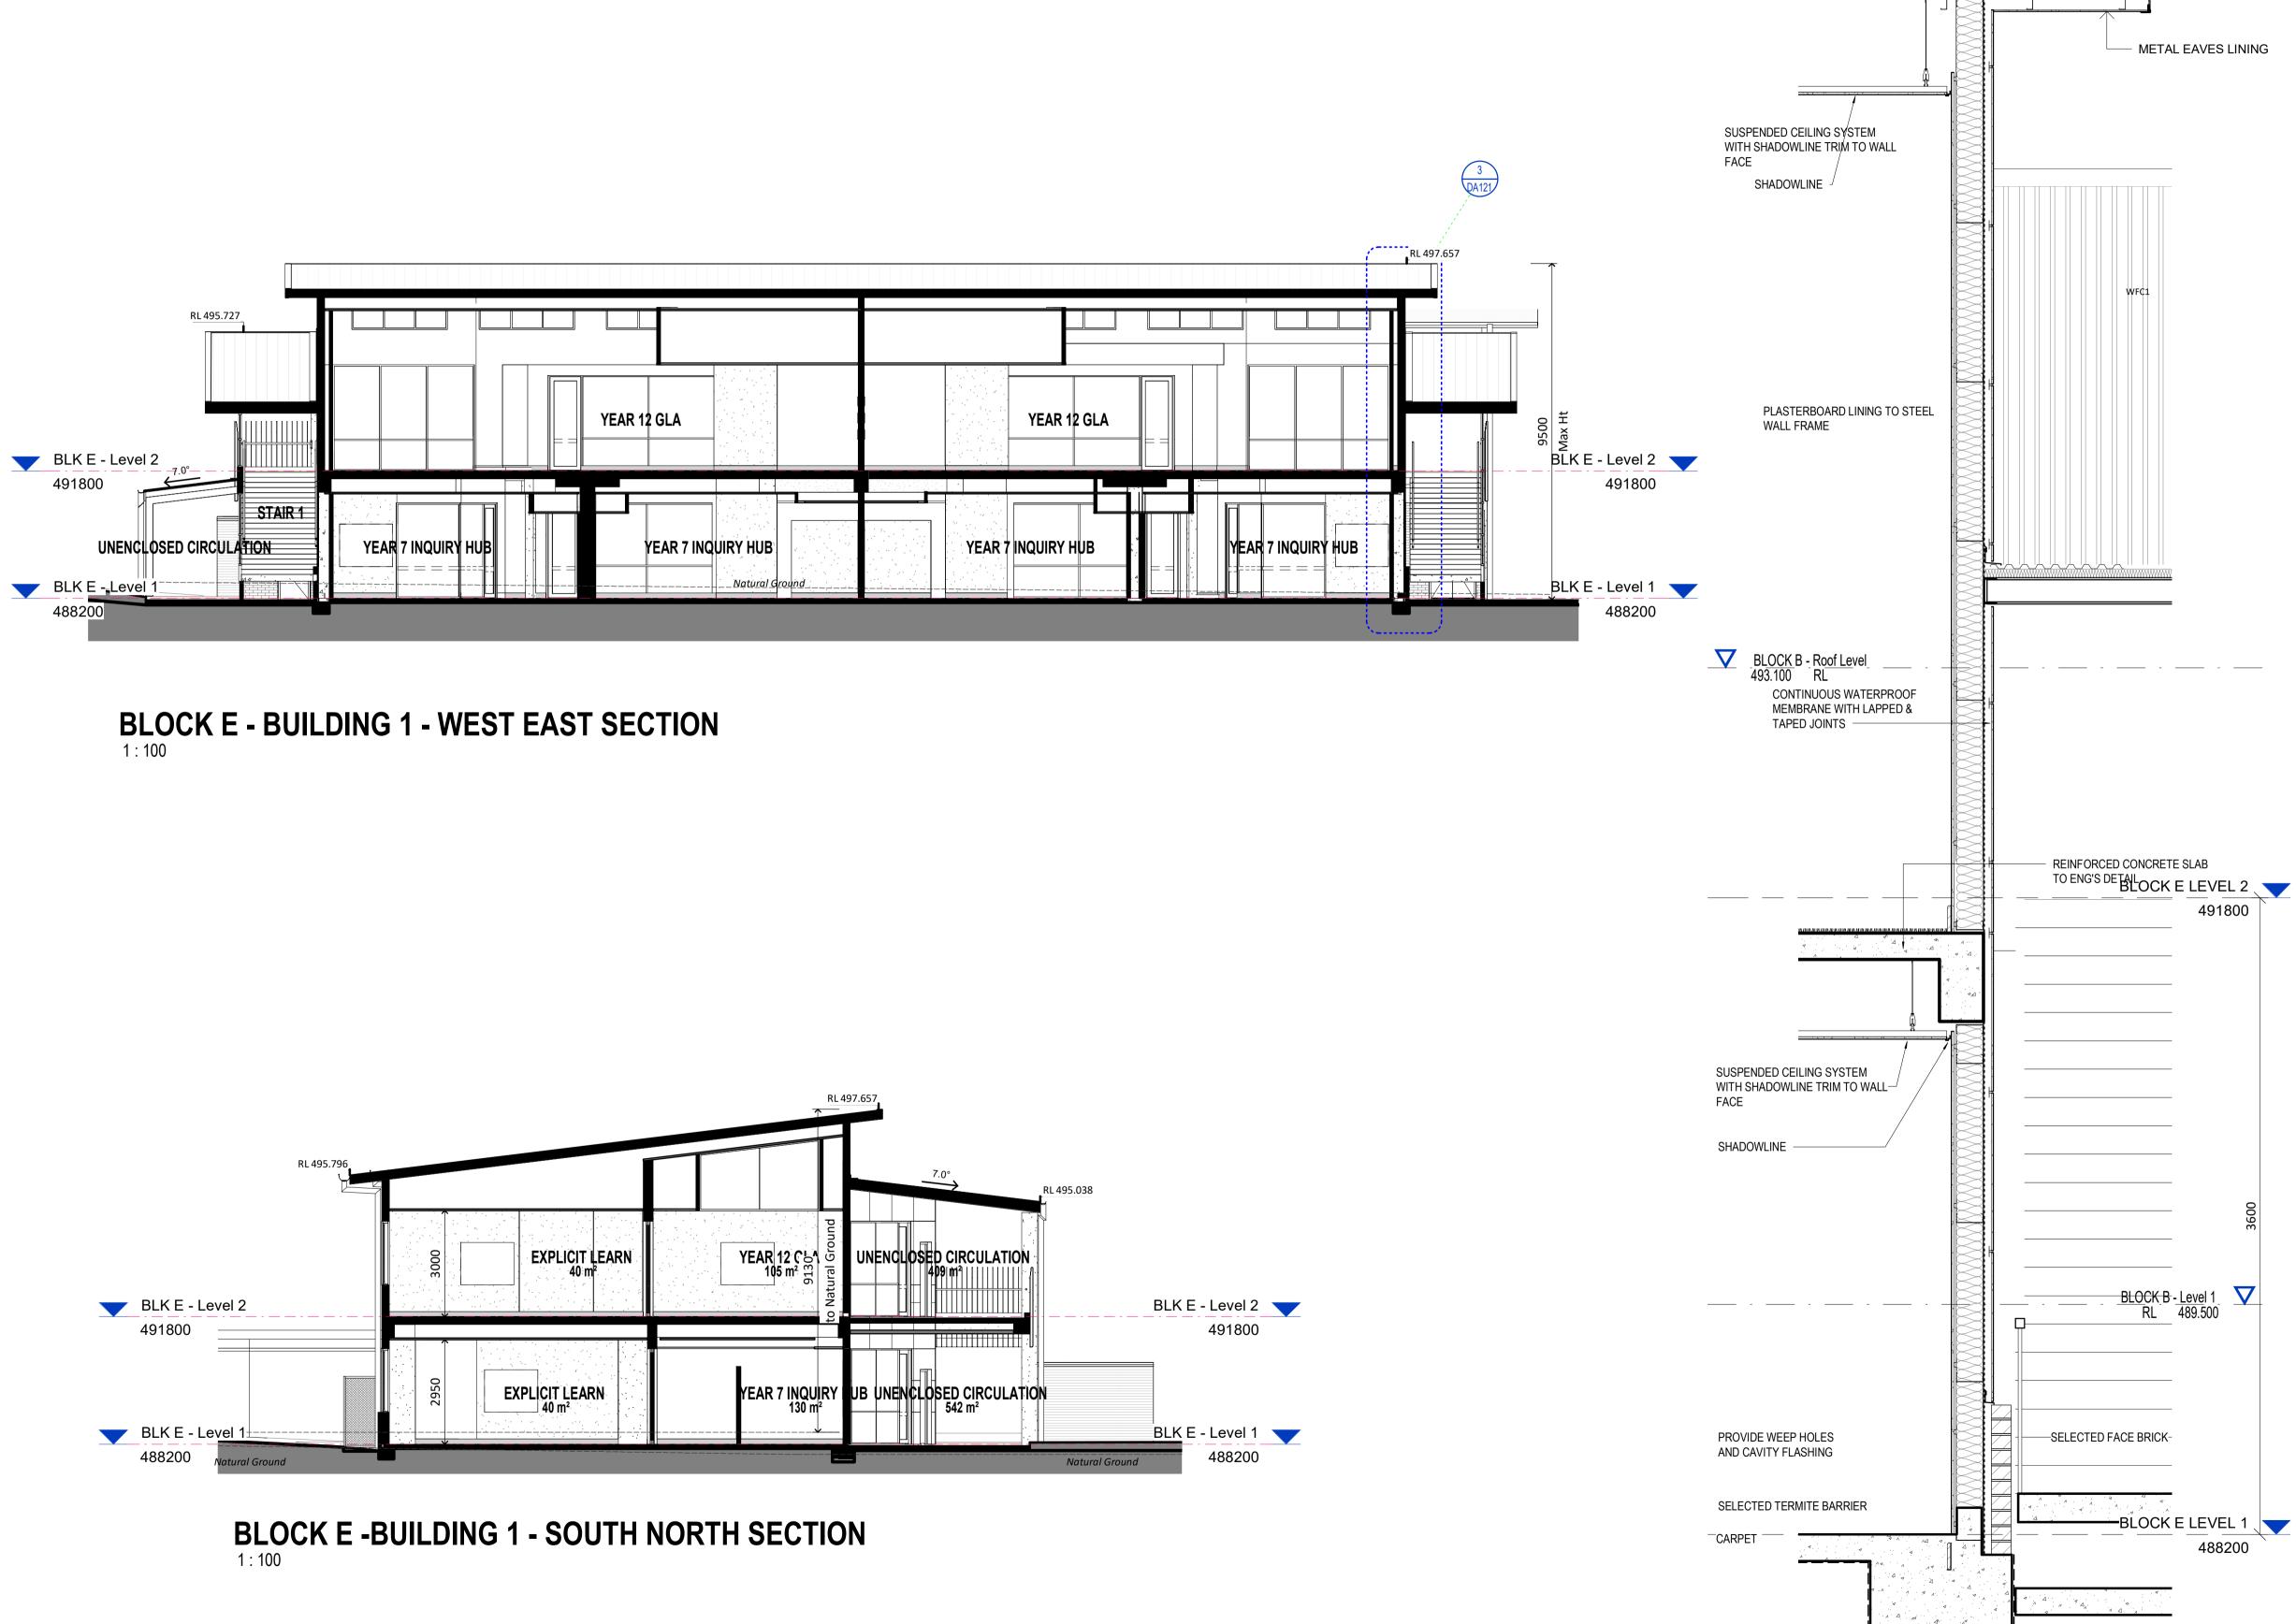

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Dimensions take precedence over scaling. Do not measure off drawings as print sizes may vary.

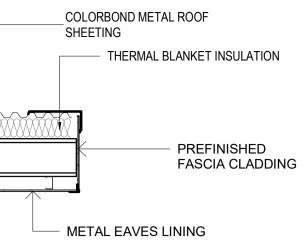

- REINFORCED CONCRETE FOUNDATION TO ENG'S DETAIL



		keyplan
	LEGEND	
CODE	DESCRIPTION	
BAL-1	Balustrade & handrail - type 1 to details	
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WPL4	Pinboard lining - type 4	

purpose of issue	by	date	issue no.
Block E Lift moved	BLC	03.05.19	1
moved, Elevations adjusted			
DRAW NUMBERS ADJUSTED, Buildings	BLC	08.05.19	2
Client Workshop Presentation	BLC	14.05.19	3
Carpark, paths, Block B Adjusted	BLC	22.05.19	4
SSDA Documentation 90% Completion	DO	03.06.19	5
GA NSW Issue	BLC	20.03.20	6
SSDA Issue, levels adjusted, dims added	BLC	01.04.20	7
SSDA- Project name adjusted	BLC	28.04.20	8

architect



NOMINATED ARCHITECT : CHARLES GLANVILLE NSW REGISTRATION No. 3130



project

ST MATTHEW'S CATHOLIC SCHOOL - Secondary Campus

address

Corner of BROADHEAD and BRUCE RD. MUDGEE Lot 40 of DP 756894

STATE SIGNIFICANT DEVELOPMENT APPLICATION


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	verified:	CG
	sheet size:	A1
north	scale:	As indicated
graphic scale		6

BLOCK E - BUILDING 1 - SECTIONS

		511000
18150	DA121	8

sheet n



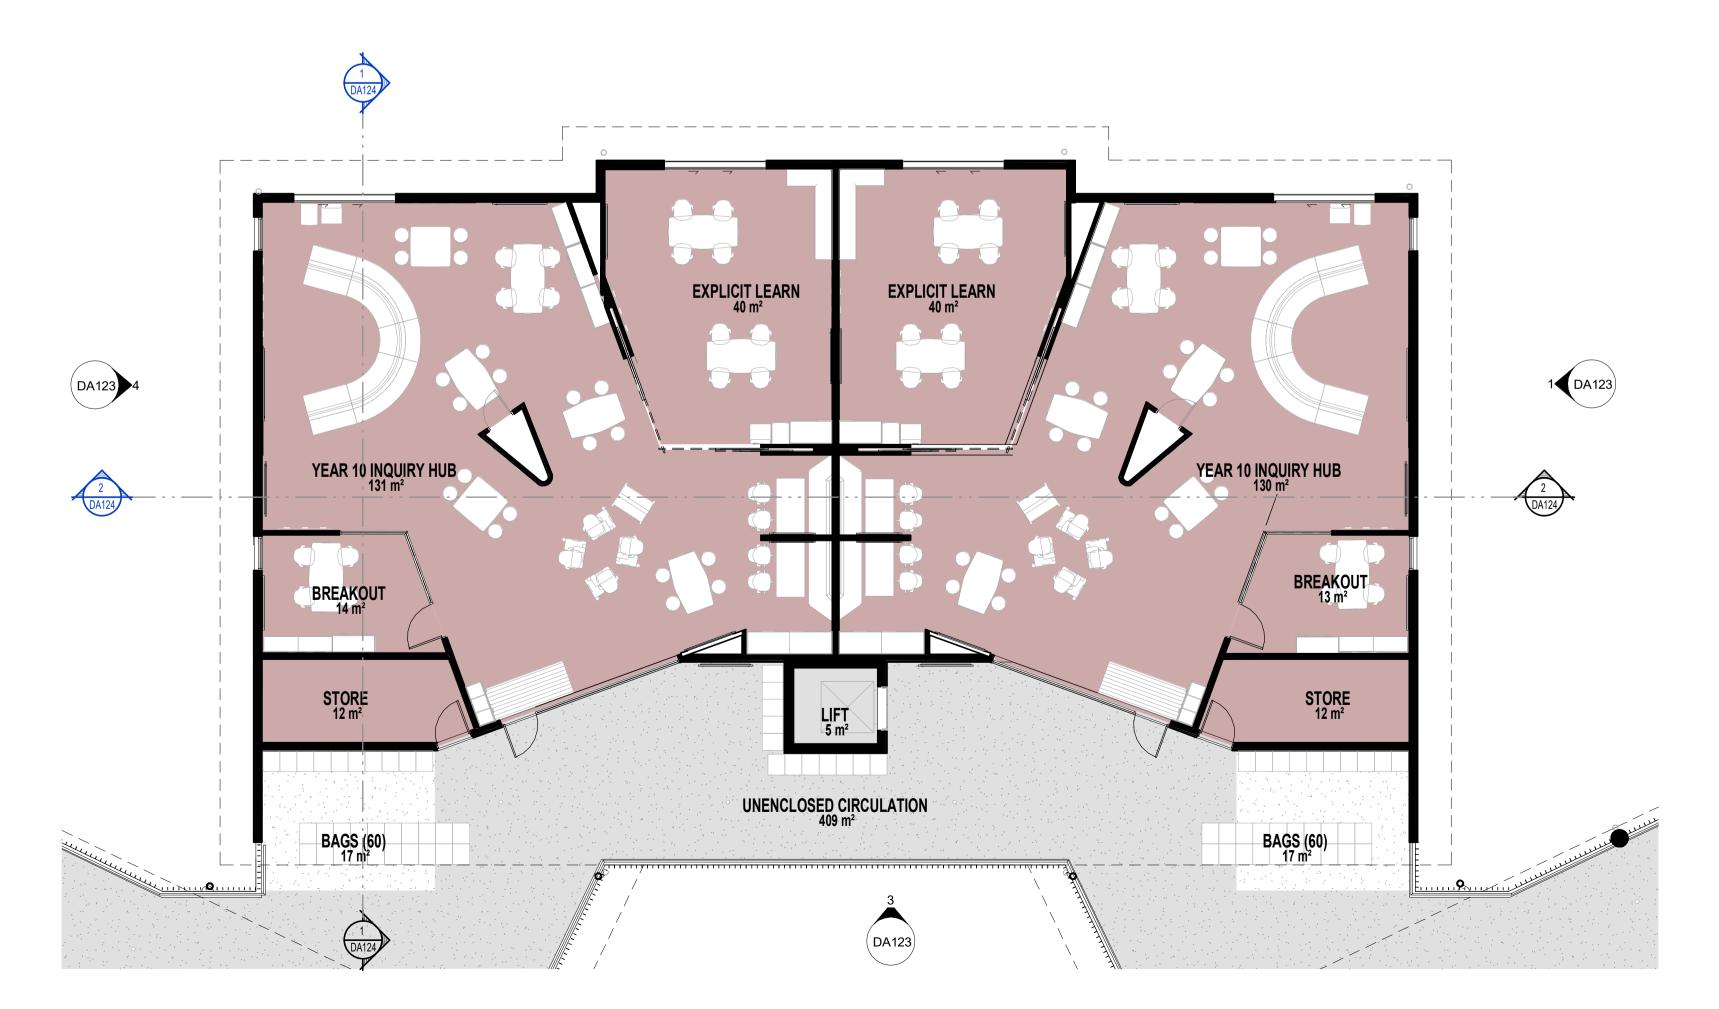



BLOCK E - LEVEL 1 - BUILDING 2

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Dimensions take precedence over scaling. Do not measure off drawings as print sizes may vary.

		keyplan		
	LEGEND			
CODE	DESCRIPTION			
BAL-1	Balustrade & handrail - type 1 to details			
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WPL4	Pinboard lining - type 4			

purpose of issue	by	date	issue no.
Client Workshop Presentation	BLC	14.05.19	3
Carpark, paths, Block B Adjusted	BLC	22.05.19	4
SSDA Documentation 90% Completion	DO	03.06.19	5
Access adjust, dis car added	BLC	31.07.19	6
Block E, Resource Centre substitute	BLC	21.01.20	7
GA NSW Issue	BLC	20.03.20	8
SSDA Issue, levels adjusted, dims added	BLC	01.04.20	9
SSDA- BCA & Access Update	BLC	21.04.20	10
SSDA- Project name adjusted	BLC	28.04.20	11

architect





project

ST MATTHEW'S CATHOLIC SCHOOL - Secondary Campus

address

Corner of BROADHEAD and BRUCE RD. MUDGEE Lot 40 of DP 756894

STATE SIGNIFICANT DEVELOPMENT APPLICATION

	drawn:	BLC
	checked:	BLC
	verified:	CG
	sheet size:	A1
north	scale:	1 : 100
graphic scale		6

BLOCK E - BUILDING 2 - FLOOR PLANS sheet

DA122 11

18150

project no.

sheet n



BLOCK E - BUILDING 2 - NORTH ELEVATION 1 : 100



BLOCK E - BUILDING 2 - EAST ELEVATION



BLOCK E - BUILDING 2 - SOUTH ELEVATION 1 : 100

BLOCK E - BUILDING 2 - WEST ELEVATION 1:100

C COPYRIGHT 2019

Dimensions take precedence over scaling. Do not measure off drawings as print sizes may vary.

		keyplan		
	LEGEND			
CODE	DESCRIPTION			
BAL-1	Balustrade & handrail - type 1 to details			
DP	Downpipe			
GT	Gutter refer to hydraulic engineer			
LOC1	Lockers - Student			
РСР	Painted concrete column			
PSC	Painted steel column			
RBC	Colorbond metal Barge capping			
RGF	Colorbond metal gutter & fascia			
RMS1	Colorbond profiled metal roof sheet - type 1			
RMS2	Colorbond profiled metal roof sheet - type 2			
RPS	Polycarbonate roof sheet			
RWT	Rain water tank			
SL	Metal profiled Soffit Lining			
WBF	Face brickwork			
WBF1	Face brickwork - type 1			
WBF3	Face brickwork - type 3			
WFC1	Painted fibre cement cladding type 1			
WFC2	Painted fibre cement cladding type 2			
WFC3	Painted fibre cement cladding type 3			
WFC4	Painted fibre cement cladding type 4			
WFC5	Painted fibre cement cladding type 5			
WFC6	Painted fibre cement cladding type 6			
WFC7	Painted fibre cement cladding type 7			
WFC8	Painted fibre cement cladding type 8			
WFC9	Painted fibre cement cladding type 9			
WFC.1				
WLV1	Louvre screen - type 1			
WLV2	Louvre screen - type 2			
WMS1	Profiled metal sheet cladding - type 1			
WMS2	Profiled metal sheet cladding - type 2			
WPL4	Pinboard lining - type 4			

project

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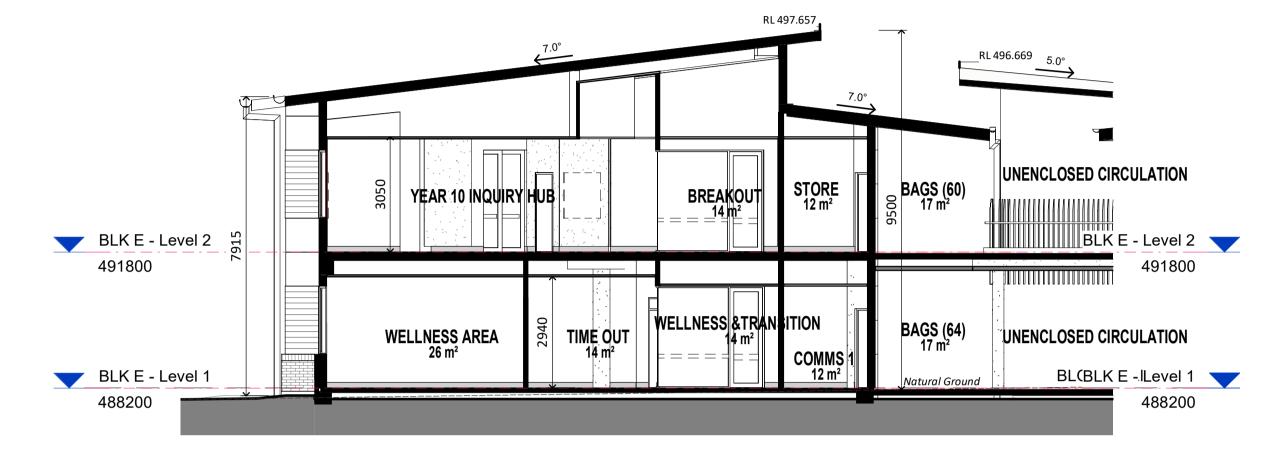
STATE SIGNIFICANT DEVELOPMENT APPLICATION

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verified:	CG
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	6
	checked: verified: sheet size:


BLOCK E - BUILDING 2 - ELEVATIONS shee

18150

heet r



BLOCK E - BUILDING 2 - WEST EAST SECTION1

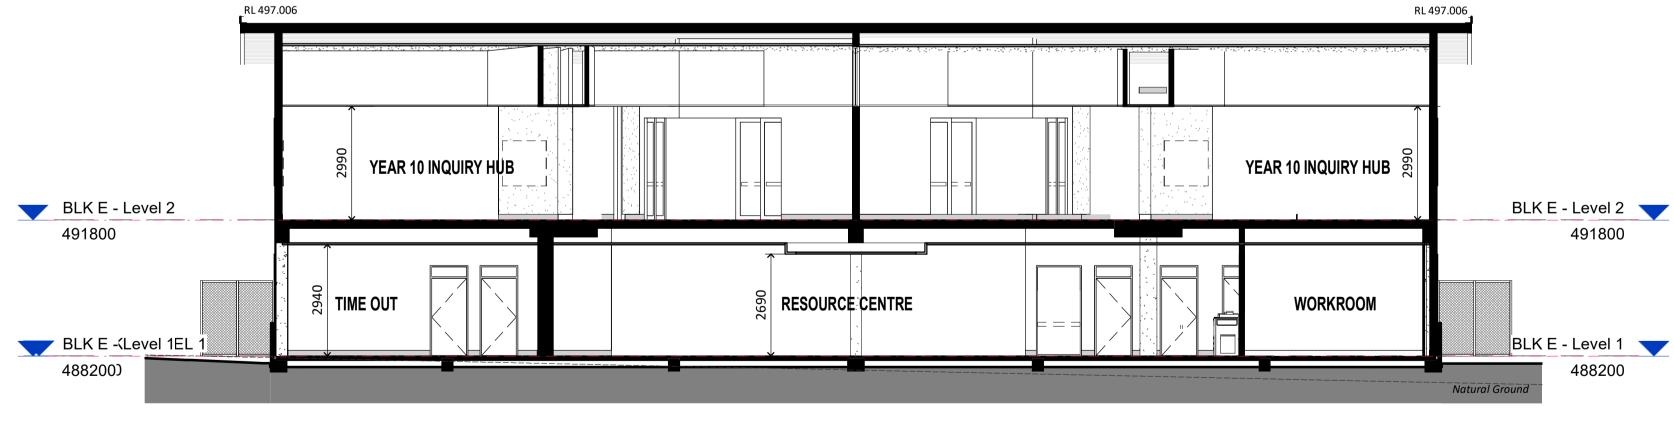

BLOCK E - BUILDING 2 - WEST EAST SECTION 1:100

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Dimensions take precedence over scaling. Do not measure off drawings as print sizes may vary.

		keyplan		
LEGEND				
CODE	DESCRIPTION			
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WFC3	Painted fibre cement cladding type 3			
WFC4	Painted fibre cement cladding type 4			
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WFC6	Painted fibre cement cladding type 6			
WFC7	Painted fibre cement cladding type 7			
WFC8	Painted fibre cement cladding type 8			
WFC9	Painted fibre cement cladding type 9			
WFC.1				
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WMS1	Profiled metal sheet cladding - type 1			
WMS2	Profiled metal sheet cladding - type 2			
WPL4	Pinboard lining - type 4			

03.05.19 date	1 issue no.
03.05.19	1
08.05.19	2
14.05.19	3
22.05.19	4
03.06.19	5
20.03.20	6
01.04.20	7
28.04.20	8
	28.04.20 01.04.20 20.03.20 03.06.19 22.05.19 14.05.19 08.05.19







project

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STATE SIGNIFICANT DEVELOPMENT APPLICATION


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	verified:	CG
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north	scale:	1 : 100
graphic scale		6

BLOCK E - BUILDING 2 - SECTIONS sheet

18150	DA124	8

sheet no



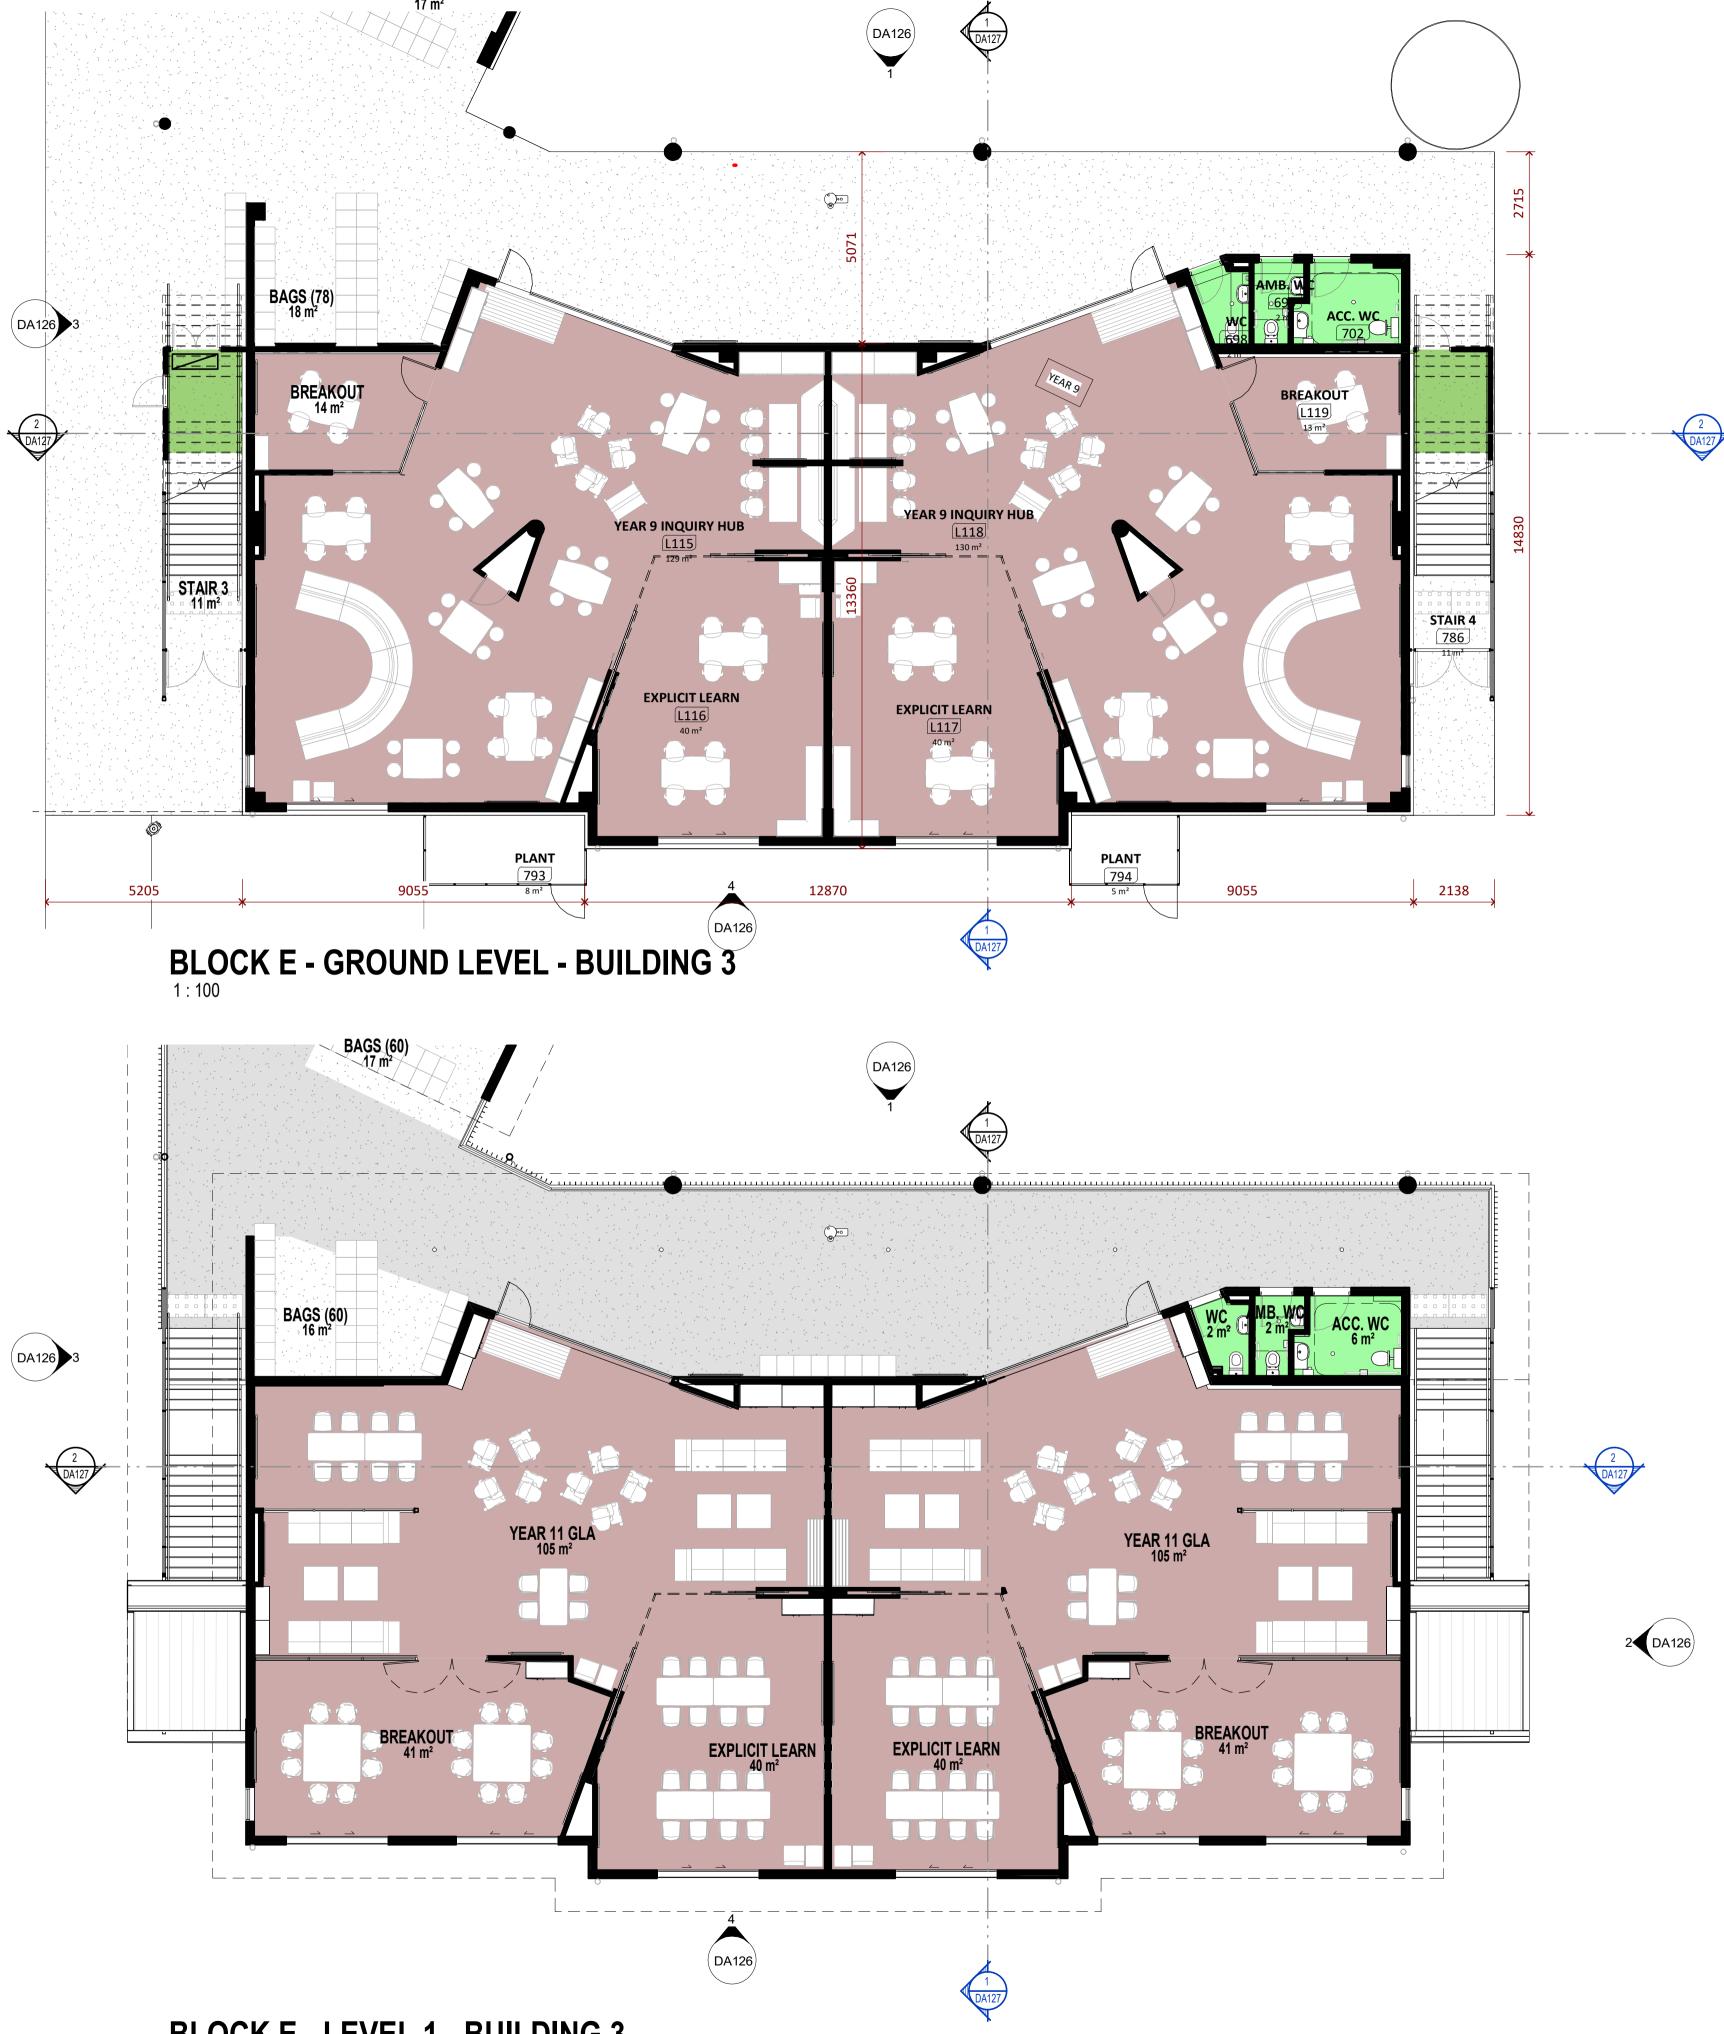

BLOCK E - LEVEL 1 - BUILDING 3 1 : 100

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Dimensions take precedence over scaling. Do not measure off drawings as print sizes may vary.

		keyplan		
LEGEND				
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WMS1	Profiled metal sheet cladding - type 1			
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SSDA- Project name adjusted	BLC	28.04.20	10
SSDA- BCA & Access Update	BLC	21.04.20	9
SSDA Issue, levels adjusted, dims added	BLC	01.04.20	8
GA NSW Issue	BLC	20.03.20	7
Access adjust, dis car added	BLC	31.07.19	6
SSDA Documentation 90% Completion	DO	03.06.19	5
Carpark, paths, Block B Adjusted	BLC	22.05.19	4
Client Workshop Presentation	BLC	14.05.19	3
DRAW NUMBERS ADJUSTED, Buildings	BLC	08.05.19	2
moved, Elevations adjusted			
purpose of issue	by	date	issue no.

architect





project

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	verified:	CG
	sheet size:	A1
north	scale:	1 : 100
graphic scale		6

BLOCK E - BUILDING 3 - FLOOR PLANS sheet

DA125 10



BLOCK E - BUILDING 3 - NORTH ELEVATION



BLOCK E - BUILDING 3 - EAST ELEVATION 1 : 100



BLOCK E - BUILDING 3 - SOUTH ELEVATION 1:100



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LEGEND				
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SSDA- Project name adjusted SSDA Issue, levels adjusted, dims added		28.04.20 01.04.20	7
GA NSW Issue		20.03.20	5
SSDA Documentation 90% Completion		03.06.19	4
Carpark, paths, Block B Adjusted		22.05.19	3
Client Workshop Presentation	BLC	14.05.19	2
DRAW NUMBERS ADJUSTED, Buildings	BLC	08.05.19	1
moved, Elevations adjusted			
purpose of issue	by	date	issue no.

architect





project

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graphic scale		6

BLOCK E - BUILDING 3 - ELEVATIONS sheet


18150

project no.

DA126



1 : 100

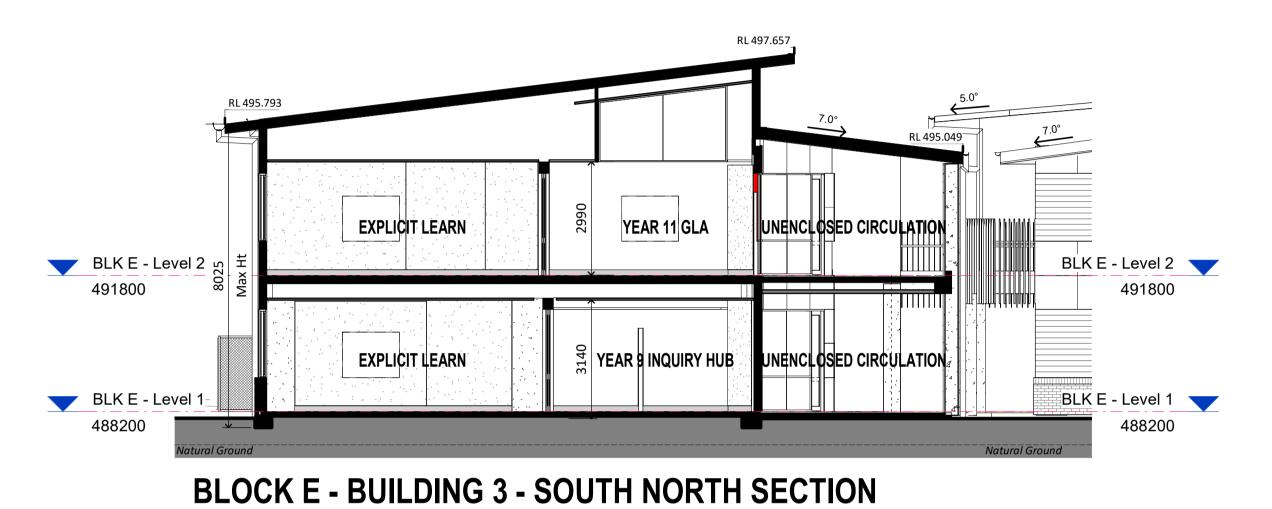

Dimensions take precedence over scaling. Do not measure off drawings as print sizes may vary.

		keyplan
	LEGEND	
CODE	DESCRIPTION	
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SSDA- Project name adjusted	BLC	28.04.20	7
SSDA Issue, levels adjusted, dims added	BLC	01.04.20	6
GA NSW Issue	BLC	20.03.20	5
SSDA Documentation 90% Completion	DO	03.06.19	4
Carpark, paths, Block B Adjusted	BLC	22.05.19	3
Client Workshop Presentation	BLC	14.05.19	2
DRAW NUMBERS ADJUSTED, Buildings	BLC	08.05.19	1
moved, Elevations adjusted			
purpose of issue	by	date	issue no.

architect





project

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	sheet size:	A1
north	scale:	1 : 100
graphic scale		6

BLOCK E - BUILDING 3 - SECTIONS

18150	DA127	7

issue