



Overland Flow Assessment & Stormwater Management Report **2B-6 Hassall Street Parramatta**

Issue: A- Development Application

3rd April 2019

Prepared For: CHARTER HALL LIMITED

Project No.: 18570C



Document No.: 18570-CH RPT-SWMP-190403

Report Amendment Register

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Signing for and on behalf of
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1.0 Introduction

1.1 Executive Summary

This report has been prepared by Robert Bird Group (RBG) and is submitted to the City of Parramatta Council. This report is to accompany a Development Application (DA) for a mixed-use tertiary educational and commercial development at 2B-6 Hassall Street, Parramatta.

This stormwater management report summarises the stormwater drainage design for the proposed development site and its connections to existing networks for point of discharge. Stormwater Quality management and Stormwater Management Strategy has also been incorporated within this report. All design of stormwater infrastructure including detention tanks and treatment devices has been carried out by Floth Pty.Ltd.

Other associated reference information, standards and inputs, a description of the existing site and the proposed works, discussion on the pre- and post- development catchment analysis has also been discussed within this report.

1.2 Site Description

The site is located at 2B-6 Hassall Street, in the City of Parramatta locality. The proposed development area is currently occupied by three allotments of land that comprises of a two-storey structure, a three-storey low residential apartment and a vacant lot in between the two lots to provide a partition. The site is approximately 62m long and 48m wide, is located between Hassall Street to the south and Station Street to the west. The project area is on a flat topography at the crest of Hassall Street.



Figure 1-1: Project Extents

1.3 Standards and Design reference information

The project team has consulted with City of Parramatta Council during Pre-DA stage. City of Parramatta Council require that the stormwater design is carried out in accordance with the City of Parramatta Development Control Plan (DCP) 2011, Interim Floodplain Management Plan and Stormwater Drainage Guideline.

Other reports from City of Parramatta which have been reviewed in the preparation of this report are:

- Stormwater and OSD documentation DA checklist
- Development Engineering Design Guidelines 2018
- Upper Parramatta River Catchment Trust (UPRCT) On Site Detention Handbook 2005
- Upper Parramatta River Catchment Trust (UPRCT) Calculation Sheet V9
- Stormwater Disposal Policy
- AS 3500 National Plumbing Code Part 3 – Stormwater Drainage
- Australian Rainfall and Runoff 2016
- Blue Book (Landcom 2004)

2.0 Flooding and Freeboard levels

Based on City of Parramatta flood maps, (Refer to Appendix D), the subject site is not located within any of the Low, Medium and High flood zones.

Consultation with council's Senior Development Engineer (Andrew Rofail) has occurred and we have been advised that freeboard is not required as the development is outside of the floodplain. This advice also appears consistent with neighbouring properties such as 10 Hassall street.

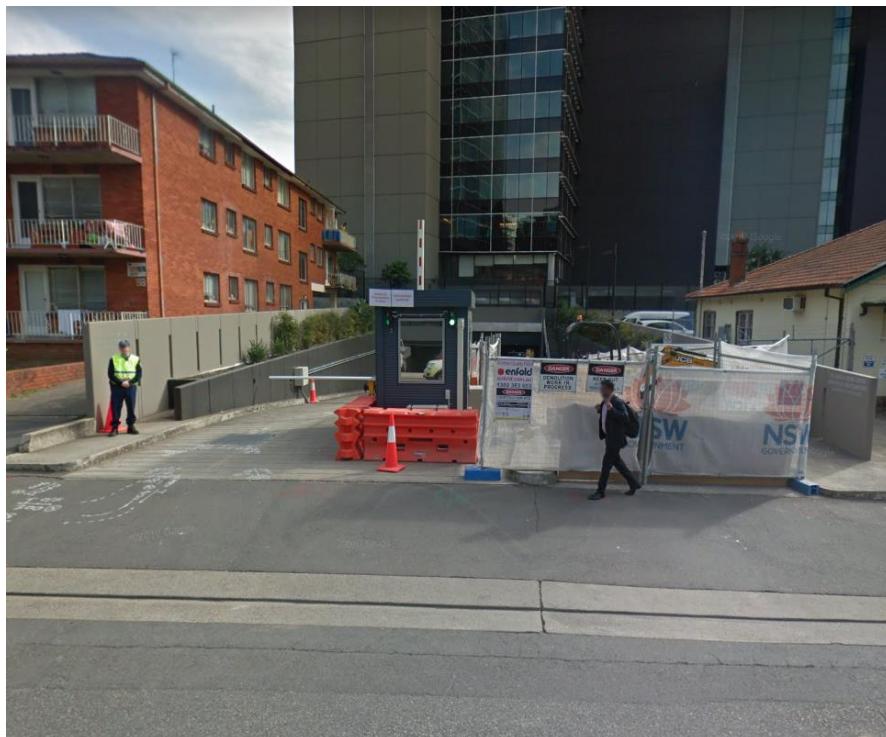


Figure 2-1 10 Hassall Street Basement entrance, with no freeboard

RBG have completed an upstream and local catchment review along Hassall street to assess whether any external overland flow paths may impact the development. It was found that the proposed development is located at the crest of Hassall Street and that the adjoining roads (Station Street and Charles Street) fall away from the development. Hence the project is not impacted by any significant external overland flow paths.

Based on the above RBG the design provides a minimum vehicle clearance of 225mm between kerb invert and property line. This effective freeboard consists of a 150mm kerb and a 2.5% cross fall along the pedestrian footpath.

3.0 Proposed Stormwater Quantity Strategy

3.1 Existing Catchment Analysis

Based on the survey it is evident that the existing structures within the site are currently discharging into the kerb inlets on Hassall Street. No stormwater pits have been detected on site from the survey information provided.

3.2 Proposed Stormwater Catchment Analysis

The majority of the runoff from the development is to be captured and detained by an on-site detention (OSD) system using gravity flow. This system is comprised of rainwater gutters, inlets, pipes and pits.

In accordance with Council standards, Floth has designed the OSD system to cater for all storm durations up to and including the 1% Annual Exceedance Probability (AEP).

This section aims to summarise the approach implemented within the project.

Total Catchment area	2647m ²
Area of Site Draining to OSD	2456m ²
Residual Site Area (lot Area – Roof Area)	880m ²
Area Bypassing Storage	191m ²
Area Bypassing / Residual Site Area %	21.7%

3.3 Proposed On-site Detention

The proposed OSD design follows the City of Parramatta guidelines. The OSD sizing has been calculated using the “On-Site Detention Calculation Sheet for Upper Parramatta River Catchment HED Secondary Outlet” Spreadsheet, provided by the City of Parramatta.

A key set up to this design has been implementing the City of Parramatta’s recent approach to combined OSD’s and WSUD devices. That is by designing a separate chamber for the WSUD device, capable of treating and holding the flow from a 3-month storm. Refer to Appendix C for drawings by Floth.

A summary of the design is shown below.

WSUD chamber volume	9.58m ³
OSD Total Volume	120m ³
Site Discharge	28.21L/s



4.0 Stormwater Quality Management

A proprietary water quality treatment system has been utilised to ensure that the development improves the quality of stormwater leaving the site the project. Floth has modelled the proposed treatment Train performance using the computer software "MUSIC". Refer to Appendix C for MUSIC model provided by Floth.

The projects approach to water quality urban design has been summarised below.

4.1 Water Quality Train Performance

The Stormwater 360 StormFilter Cartridges system has been proposed and can be installed in the detention tank. The system is effective at removing total suspended solids, total phosphorus, and total nitrogen to reach the reduction targets.

As per Council's recent approach the StormFilter Cartridges have been installed into a separate chamber within the OSD capable of treating a 3-month flow.

A summary of the performance is shown below.

Pollutant	Objective Target	Design Reduction
Gross Pollutant (GP)	90%	95%
Total Suspended Solids (TSS)	85%	85%
Total Phosphorus (TP)	60%	86.9%
Total Nitrogen (TN)	45%	80%

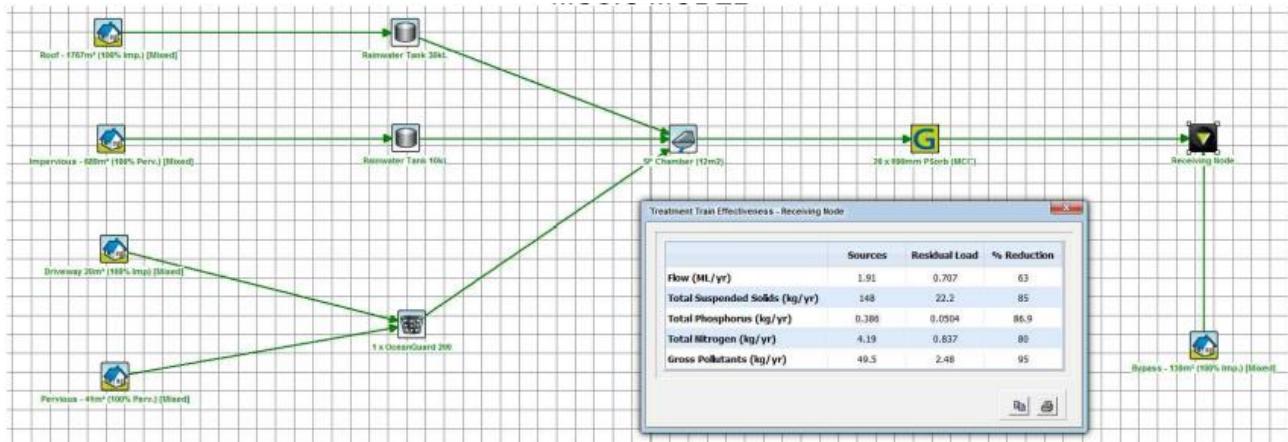


Figure 4-1 MUSIC Modelling Performance



5.0 Erosion and Sediment Control

To maintain the water quality during the construction stage, erosion and sediment control measures will be installed. Soil management measures shall follow the Landcom guidelines Managing Urban Stormwater Runoff: Soils and Construction ("Blue Book"), City of Parramatta DCP and Drainage Standards.

The footprint of the basement and above ground structure is such that disturbed soil will only be exposed during excavation of the basement. As such the majority of RBG's erosion and sediment control strategy takes places during the early works and preparation of the site.

RBG's proposed basement drainage strategy during construction consists of the following:

1. The basement rain and groundwater is to be stored and inspected prior to being pumped off site. This is to verify that the water is free of contamination, so its disposal should not contribute to water pollution.
2. To remove water from the work area, the pump intake should be kept as close to the surface of the pool as possible. Floating intakes should be used when the depth of water is sufficient. Care will be taken to avoid pumping from the bottom of ponds, and constant supervision is required during pumping operations to ensure this does not happen.

The following additional erosion and sediment control measure for the development are also required throughout the duration of the project to protect downstream infrastructure.

- Sediment fences around stockpiles and construction zones where soils are exposed;
- Sediment basin with sediment storage volume;
- Sediment protection devices on existing and proposed inlet pits i.e. filter socks; and
- Truck Wash/Shaker Grid at all site access/egress points.

Refer to drawing C-1-00 in Appendix B for further information.





Appendix A

City of Parramatta Council

Stormwater and OSD

documentation DA checklist.



Disclaimer: The information provided by you on this form will be used by Parramatta City Council or its agents to process this application. Once collected by Council, the information can be accessed by you in accordance with Council's Access to Information Policy and Privacy Management Plan or in special circumstances, where Commonwealth legislation requires or where you give permission for third party access.

- The purpose of this form is to confirm that your stormwater design and OSD drawings (where necessary) have been prepared in line with Council requirements.
- It will ensure that quality submissions are lodged with necessary and correct information to prevent delay of the assessment of the development application
- A correctly completed form is required to enable lodgement of your DA/s96.
- It is essential that the Design Engineer carefully reads this checklist as any inaccurate or incomplete checklists will prevent the lodgement of your application.
- N/A shall be indicated adjacent to any details or information that are not relevant.

PROPERTY DETAILS

1. Property Details	Unit No: <u>2, 4, 6</u>	House No: <u>26 - 6</u>
Address	Street: <u>HASSAW STREET</u>	
	Suburb: <u>PARRAMATTA</u>	Postcode: <u>2150</u>
Lot/DP/SP etc	Lot: <u>22, 62, 7</u>	DP/SP etc: <u>DP608861, DP100 6215</u> <u>DP 128820</u>
DA Number: (office use only)		

TYPE OF DEVELOPMENT

MINOR DEVELOPMENTS NO OSD

May include single and secondary dwellings, alterations and additions with No OSD.



PAGE 2

MAJOR DEVELOPMENTS with OSD

May include duplexes, townhouses, residential flat buildings, commercial premises, major developments.



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STORMWATER & OSD DOCUMENTATION DA CHECKLIST

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Minor Developments - No OSD

Stormwater Drainer/ Plumber (or Engineer's) Details & Declaration

This form is to be completed by a Licensed Drainer/Plumber (or a Registered Stormwater Engineer).

Company Details

Company & ABN:

Engineering Details:

Registered Engineer Reference (NPER) if held:

Licence no & ABN:

Family Name:

Full Given Name(s):

Postal Address

Suburb:

Postcode:

Contact Details

Office phone:

Mobile:

Fax:

Email:

I confirm that:

- A true diagram or drawing of the stormwater system is attached.
- I am the Licensed Stormwater Drainer /Plumber (or Engineer) responsible for designing the stormwater system associated with this development proposal AND
- I certify that this proposal will meet accepted standards of good stormwater practice, Council and Australian Standards and will not cause nuisance or adversely affect this or other properties, AND
- There is no Council drainage line within or adjacent to this property, AND
- in my opinion, the existing stormwater drainage system is adequate to receive the stormwater from this new development OR I have proposed a new stormwater drainage system which will be adequate for the total site drainage needs from the existing and new development.

Stormwater Drainer / Plumber or Engineer's Signature:

date:

STORMWATER & OSD DOCUMENTATION DA CHECKLIST

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Major Developments - OSD required

This portion of the form is to be completed by a registered and practising stormwater engineer.

Registered Stormwater Design Engineer's Details

Company & ABN: 67 010 580 248

Registered Stormwater Design Engineer Reference (NPER): 4155 632

Is the Engineer accredited to carry out Design of Stormwater & OSD Systems: Y N

Full Given Name(s): COLIN DAVID ROPE

Suburb: BELROSE Postcode: NSW

Office phone: +61 (0)2 8246 3200 Mobile: 0437 008 375

Registered Stormwater Design Engineer's Checklist

	ITEMS	Yes (✓)	No N/A (✗)
1.	<p>Registered Stormwater Design Engineer</p> <p>Name, Signature, and Registration of the Stormwater Design Engineer are clearly indicated on the submitted design documentation.</p>	✓	
2.	<p>Flood Prone Land</p> <p>The site is (wholly or partly) affected by flood as indicated on a current s149 planning certificate AND:</p> <p>Flood Level information has been obtained from Council by completing a Flood Enquiry Application form. This is attached.</p> <p>20 year and 100 year ARI flood inundation extent line and levels (to m AHD) are clearly indicated on submitted Plan No.</p> <p>AND/OR:</p> <p>There is a Council stormwater pipe, channel or watercourse traversing the site or within close proximity to the site AND an upstream catchment Overland Flow Assessment Report is attached for a 1 in 20 and 1 in 100 year ARI storm event flow running through site (including hydrological and hydraulic calculations).</p> <p>This information is attached as Attachment - B</p> <p>Overland flow paths within the site are identified on Plan No.</p>	✓	✓

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3.	<p>Private Easements</p> <p>Existing easement - drainage is proposed through adjoining private properties.</p> <p>The site already benefits from an existing drainage easement AND an up to date Certificate of Title has been provided to confirm this benefit. AND an engineer or licensed plumber has certified that the proposed system (including connection to Council's stormwater system) is adequate and operational. Written confirmation of this is attached.</p> <hr/> <p>OR, New easement - drainage proposed through adjoining private properties.</p> <p>A new easement(s) over downstream property/ies is required to enable the site and/or the OSD system to be drained by gravity AND this is indicated on submitted Plan No.</p> <p>The permission of all affected downstream property owners has been obtained for such easement(s) AND written approval of this is attached.</p> <p>An engineer (or licensed plumber) has certified that the proposed system (including connection to Council's stormwater system) is adequate and operational. Written confirmation of this is attached.</p>		
4.	<p>Stormwater Design Preparation and Documents:</p> <p>A site inspection was undertaken in preparation of the stormwater system design.</p> <p>A survey by a Registered Surveyor has been prepared to AHD and is attached.</p> <ul style="list-style-type: none"> • The stormwater system and OSD system are designed in accordance with: <ul style="list-style-type: none"> • Councils Stormwater Disposal Policy (2015) and other relevant Policies • Council's Development Design Guidelines (2015), Policies and Engineering Specifications and DCP 2011. • Upper Parramatta River Catchment Trust On Site Detention Handbook (Ed 3 or 4) (unless overridden by Council's Policies) • Australian Standards and National Construction Codes (2015). • Stormwater designs are consistent with architectural and landscape designs for the development and correspond with levels, building locations, requirements of any Flood/Overland Flow Assessment, trees to be retained or planted, utilities, services and easements. • Stormwater designs adequately incorporate Water Sensitive Urban Design Principles and are generally in accordance with Council's DCP 2011, Development Design Guidelines (2015) and WSUD Technical Guidelines for Western Sydney (2004), and/or other approved reference. • The submitted stormwater plans: <ul style="list-style-type: none"> • are based on a Survey Plan prepared by a registered surveyor • provide spot levels to mAHD and contours (with extensions into adjoining properties) • provide location of any existing easements • provide locations of existing trees and structures • are to a 1:100 scale @ (INTERNAL) 1:200 (WHOLE SITE) 		
5.	<p>On Site Retention (OSR) and Water Sensitive Urban Design (WSUD):</p> <p>The site is greater than 2000m² and WSUD/OSR requirements of Council's DCP 2011 have been addressed.</p> <p>Full details of the OSR/WSUD system are attached.</p>		

STORMWATER & OSD DOCUMENTATION DA CHECKLIST

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6.	<p>The site immediately drains to a Council Reserve or other Council land and Council does not accept a piped drainage line across this land. As a result OSD is not proposed and an OSR/WSUD system is proposed instead.</p> <p>Full details of the OSR/WSUD system are attached.</p>		✓
7.	<p>The site immediately drains to a floodway and OSD here is predicted to adversely affect mainstream flooding. A demonstration of this is attached. As a result OSD is not proposed and an OSR/WSUD system is proposed instead.</p> <p>Full details of the OSR/WSUD system are attached.</p>		✓
8.	<p>For Development Requiring OSD</p> <p>Residential Development (Duplexes) The OSD system comprises below ground tanks as required for residential development.</p> <p>Non residential development only: The depth of above-ground detention basins does not exceed 300mm in landscaped areas and 150mm over impervious surfaces. TANK PROPOSED ABOVE GROUND AND WITHIN BUILDING STRUCTURE</p>		✗ ✓
9.	<p>OSD Design</p> <p><i>& DA - H06</i></p> <p>The OSD design (DWG Nos DA-H04.....) is generally consistent with the requirements of the Upper Parramatta River Catchment Trust On Site Detention Handbook (Ed 3 or 4). and showing the following details:</p> <ul style="list-style-type: none"> Site layout showing all buildings, pathways, roadways and landscaped areas; Areas to be drained to OSD Location, levels and extent of all detention tanks, pits and pipes Location and levels of all collecting stormwater system including downpipes, surface collection pits, grated drains and Water Sensitive Urban Design (WSUD) and OSR features Areas of the site that by-pass detention system/s Location of any other constraints, e.g. easements, Sydney Water Assets (water/sewer pipes) & Electricity Overhead Cables; <p>OSD storage tank detail designs (or OSD storage basins for non-residential development) and surface collection pits include:</p> <ul style="list-style-type: none"> All design dimensions including levels and inverts to AHD and OSD volumes Cross-Sectional details Discharge Control Pit/s Safe and practical maintenance access <p>The above details are shown on A1 or A3 size plans with a scale of 1:100 and/or 1:50</p> <p>The OSD storage volume has been calculated using the Upper Parramatta River Catchment Trust On Site Detention Handbook (3rd or 4th edition) calculation sheet.</p> <p>The completed Design Summary Calculation Sheet has been signed by the Stormwater Design Engineer and attached as <u>Attachment - C.</u></p> <p>The areas of the site (including roofs) to be drained to any rainwater collection system and to the OSD system have been determined and are clearly indicated on Plan No. <i>DA-H06</i>.</p>		✓ ✓ ✓ ✓ ✓ ✓ ✓ ✓ ✓ ✓ ✓ ✓ ✓ ✓ ✓

STORMWATER & OSD DOCUMENTATION DA CHECKLIST

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9.	<p>OSD Design (continued)</p> <p>The remaining percentage of the total site area not drained to the roofwater and OSD systems is <u>7.2%</u> (to be not more than 15%).</p> <p>This is <u>not</u> a 'drowned outlet'.</p> <p>Because the designed discharge flow rate is greater than 30l/s, a connection to the nearest Council stormwater pit has been shown with associated levels.</p> <p>Overland flow from adjacent properties has been intercepted and disposed separately without discharging into any proposed OSD system.</p>	<input checked="" type="checkbox"/>	<input checked="" type="checkbox"/>
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Registered Stormwater Design Engineer's Declaration

I confirm that, as the Registered Stormwater Design Engineer responsible for designing the stormwater system associated with this development proposal, that I have done so with a full understanding of the relevant Council requirements and have read, understood and completed this checklist accurately.

Registered Stormwater Design Engineer's Signature:

date:

03/04/2019

Council Development Engineer's Notes

Development Engineer Name:

Signature:

date:

STORMWATER & OSD DOCUMENTATION DA CHECKLIST

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PART 4 - Applicant Declaration

6. Declaration

I confirm that as the design engineer/project designer responsible for designing the stormwater system associated with this development proposal that I have done so with a full understanding of the relevant Council requirements and have read, understood and completed this checklist accurately.

Engineer's signature



date: 03/04/2019

Engineer's name

PART 5 - Council's Officers Sign-off

7. Declaration

Council Officers signature

date:

Council Officers name



You can log onto www.parracity.nsw.gov.au/development to track the progress of any application lodged after 30 June 2005. The information you supply on this form and any related documentation will be publicly available on this Council website.

Parramatta City Council
30 Darcy Street, Parramatta 2150
PO Box 32, Parramatta 2124

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fax: 9806 5917


Appendix B

Civil Engineering Drawings



**2B-6 HASSAL ST MAIN WORKS
PARRAMATTA, NSW 2150
CIVIL ENGINEERING DRAWINGS
ISSUED FOR DEVELOPMENT APPLICATION**

Sheet List Table	
Sheet Number	Sheet Title
C-0-00	COVER SHEET, LOCATION MAP AND SHEET INDEX
C-0-01	GENERAL NOTES
C-1-00	EROSION AND SEDIMENT CONTROL
C-1-10	EROSION AND SEDIMENT CONTROL DETAILS
C-2-01	BULK EARTHWORKS PLAN
C-2-10	BULK EARTHWORKS SECTIONS
C-3-00	GENERAL ARRANGEMENT PLAN
C-3-10	CIVIL DETAILS
C-4-10	PAVEMENT DETAILS
C-6-50	STORMWATER PRE CATCHMENT ANALYSIS
C-6-51	STORMWATER POST CATCHMENT ANALYSIS

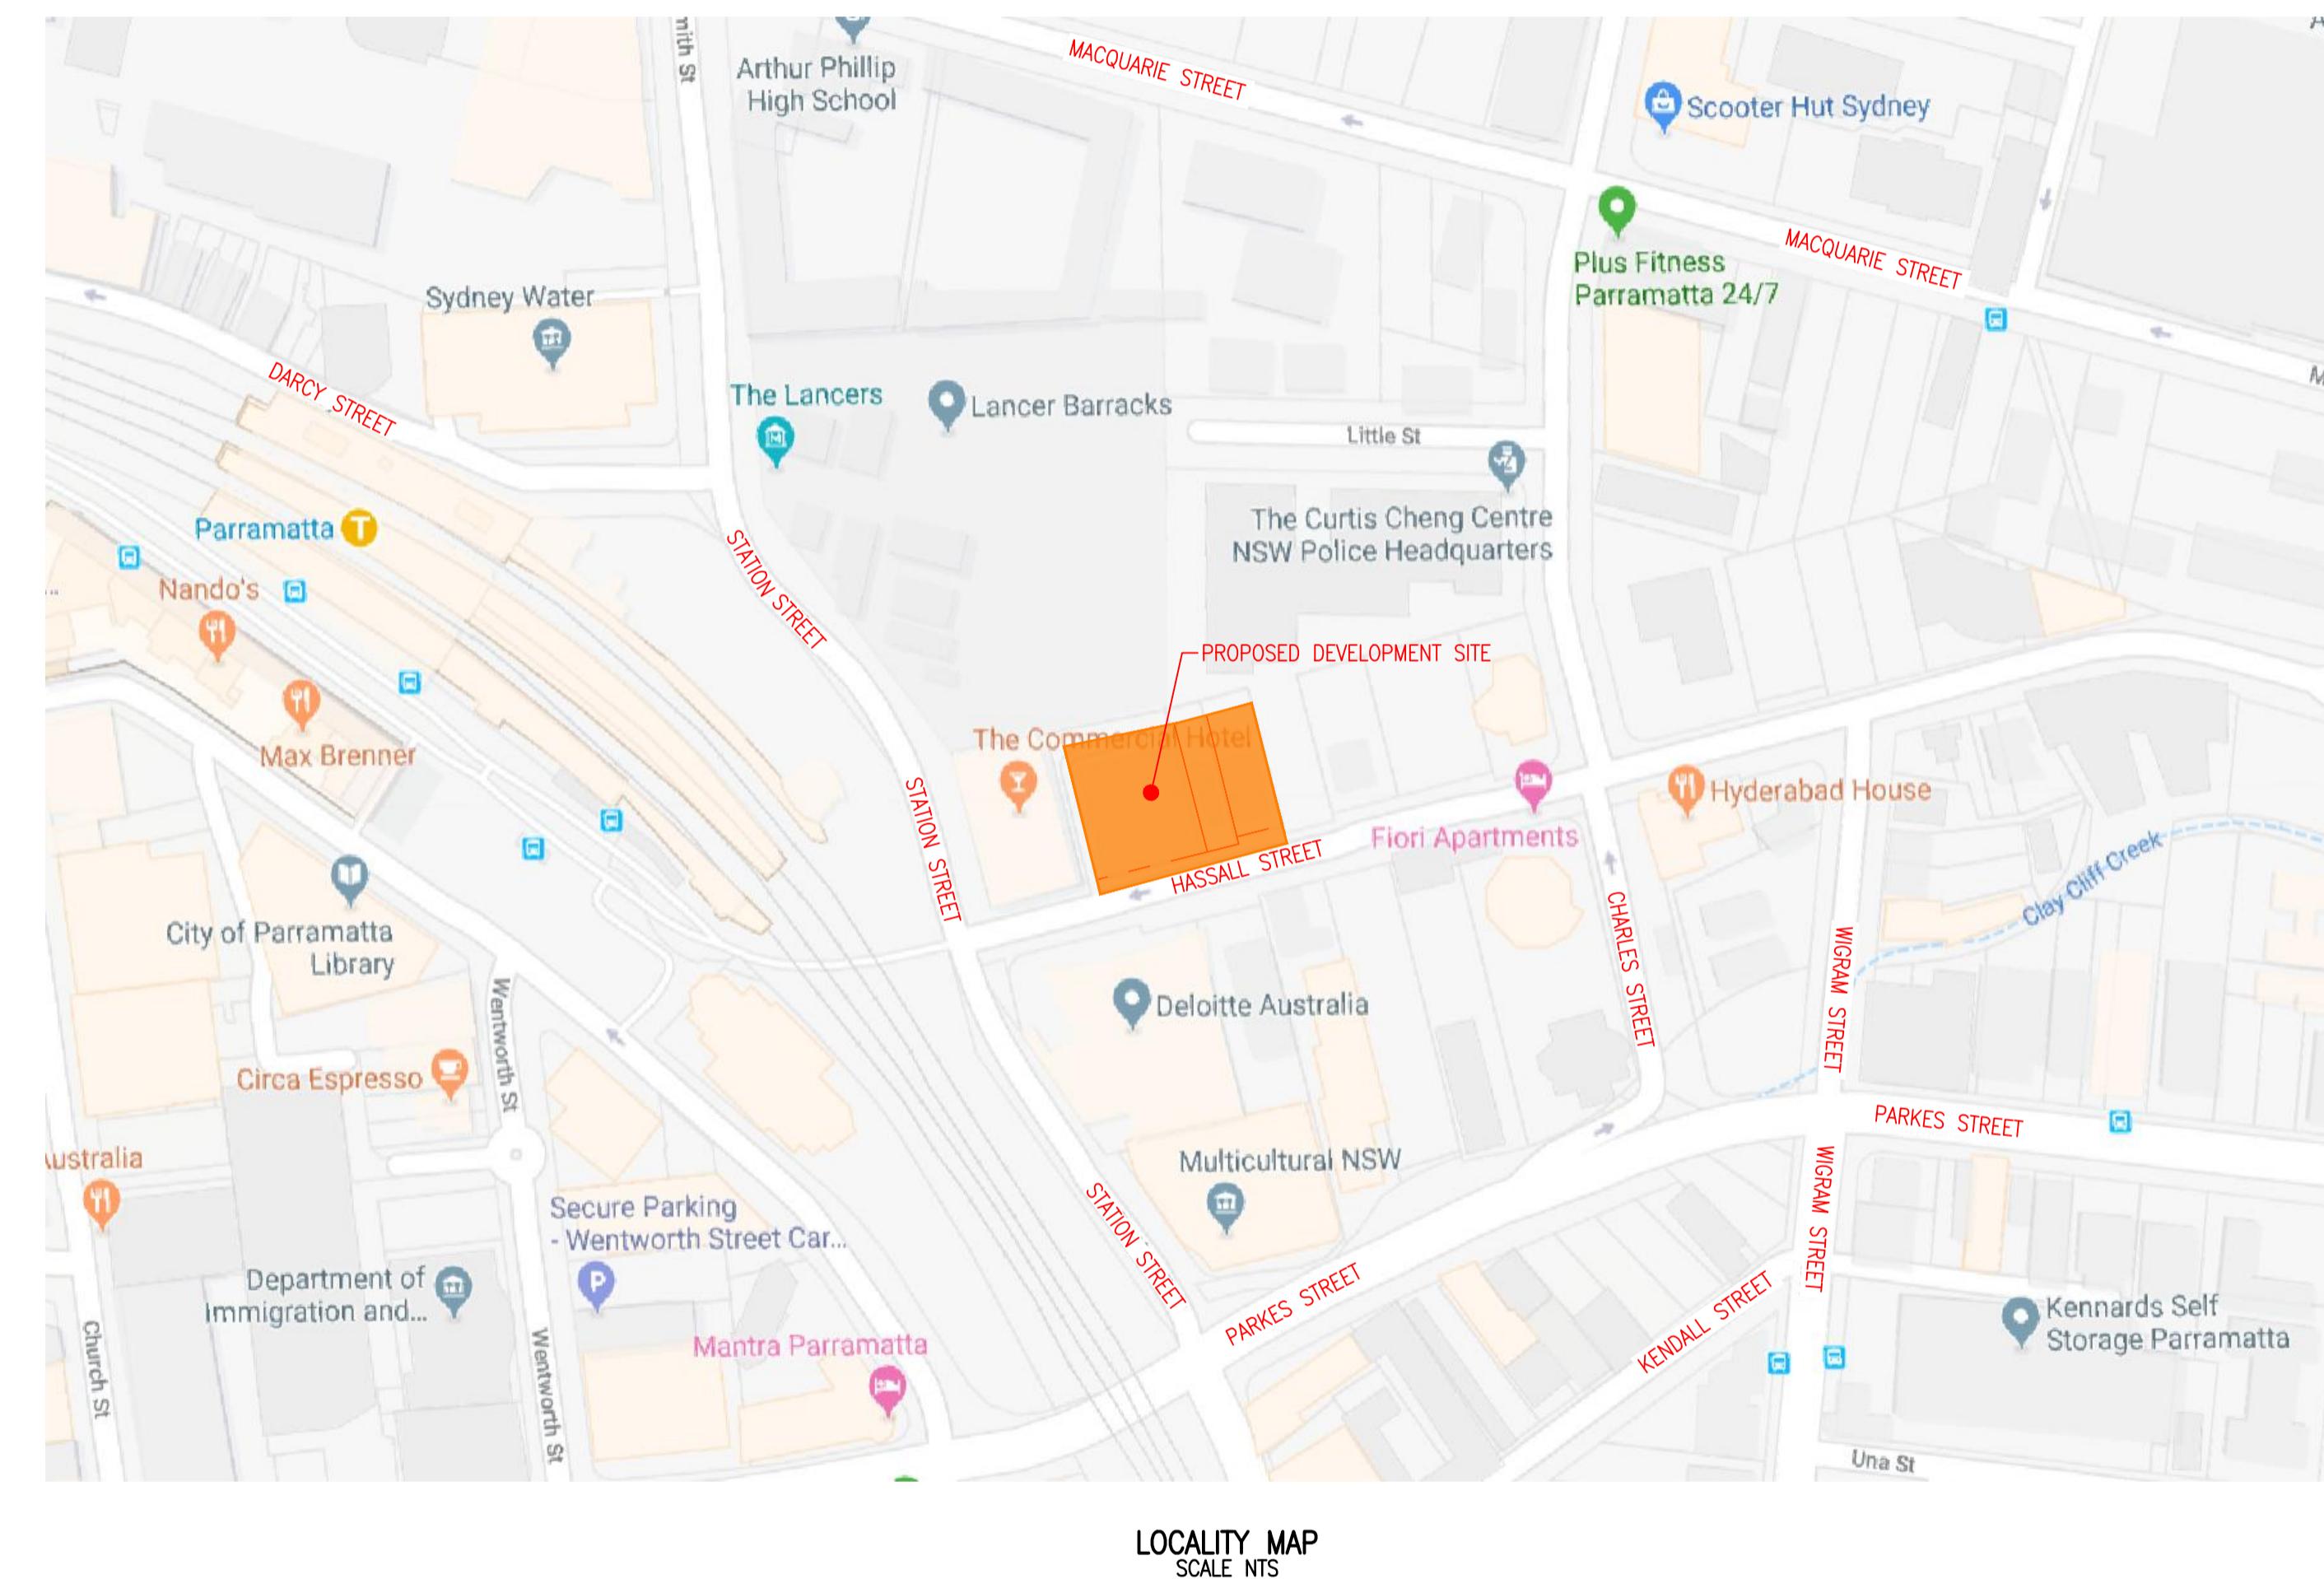

Rev	Revision	Description	By	App	Date	Rev	Revision	Description	By	App	Date
1		ISSUED FOR DEVELOPMENT APPLICATION	ZJ	CR	04.03.19						
<p>Disclaimer: Robert Bird Group Pty Ltd ACN 010 580 248 and its related entities (RBG) do not warrant the accuracy, currency or completeness of any information or data they supply or transfer by electronic means. You are responsible for verifying that any information or data supplied or transferred by electronic means matches the information or data on the corresponding PDF or DWG version issued by RBG. RBG will not be liable for any loss or damage you or any other party incurs as a result of acting in reliance on any information or data supplied or transferred by electronic means and you release RBG from any liability for any loss or damage however caused which you or any other party may directly or indirectly suffer in connection with your access to or use of that information or data.</p> <p>RBG provides this information for the express purpose contemplated by the underlying terms of engagement for the project which must not be used for any other purpose. The information is not a contractual document. Unless otherwise agreed in writing by RBG, all intellectual property rights in any information supplied by RBG are owned by, or licensed to, RBG. RBG only provides you with a non-transferable, fully revocable licence to use the intellectual property rights for the express purpose.</p> <p>DO NOT SCALE DRAWINGS, USE FIGURED DIMENSIONS REFER TO GENERAL NOTES UNLESS NOTED OTHERWISE</p>											

GENERAL NOTES

- THESE DRAWINGS SHALL BE READ IN CONJUNCTION WITH ALL OTHER ENGINEERING DRAWINGS AND CITY OF PARRAMATTA COUNCIL AND WITH SUCH OTHER WRITTEN INSTRUCTIONS AS MAY BE ISSUED DURING THE COURSE OF THE CONTRACT.
- THESE ENGINEERING PLANS ARE TO BE READ IN CONJUNCTION WITH PROJECT SPECIFICATIONS AND OTHER CONSULTANTS DOCUMENTATION ON THE PROJECT.
- THESE ENGINEERING PLANS HAVE BEEN PREPARED FROM INFORMATION AVAILABLE AT THE TIME OF ISSUE AS THIS INFORMATION MAY BE THE SUBJECT OF CHANGE PRIOR TO OR DURING CONSTRUCTION THE CONTRACTOR IS TO ADVISE THE ENGINEER WHERE DISCREPANCIES OCCUR.
- THESE DRAWINGS SHALL NOT BE USED FOR FINAL SETOUT OF THE PROJECT UNLESS SPECIFICALLY STATED.
- ALL WORK TO BE CARRIED OUT IN ACCORDANCE WITH PARRAMATTA CITY COUNCIL STANDARDS, GUIDELINES AND TECHNICAL MANUALS.
- ALL WORKS SHALL HAVE SMOOTH JUNCTIONS WITH EXISTING.
- ALL SURFACES SHALL BE EVEN GRADED AT MINIMUM 1% TO PREVENT SURFACE WATER PONDING.
- WHERE CERTIFICATION IS REQUIRED, INSPECTIONS ARE TO BE PERFORMED BY A DULY APPOINTED INSPECTOR FROM 'ROBERT BIRD GROUP'. THESE INSPECTIONS ARE TO BE PROVIDED IN ACCORDANCE WITH THE INSPECTION & TEST PLANS PREPARED BY 'ROBERT BIRD GROUP'. THE INSPECTOR IS TO BE GIVEN A MINIMUM NOTICE AS DETAILED IN THE SPECIFICATIONS.
- ALL MATERIALS SHALL COMPLY WITH WHAT IS SHOWN ON THE PROJECT DRAWINGS AND IN THE PROJECT SPECIFICATIONS.
- THE CONTRACTOR SHALL VERIFY THE LOCATIONS OF ALL EXISTING SERVICES WITH ALL RELEVANT SERVICE AUTHORITIES PRIOR TO THE COMMENCEMENT OF CONSTRUCTION. A COPY OF THE LOCATIONS OF THE EXISTING SERVICES IS TO BE PROVIDED TO THE MANAGING CONTRACTOR BY THE SERVICES ENGINEER. CONTRACTOR TO NOTIFY MANAGING CONTRACTOR OF ANY POTENTIAL CLASHES.
- THE CONTRACTOR SHALL VERIFY OFFSET PEGS AND BENCHMARK LEVELS, AND ADVISE THE MANAGING CONTRACTOR OF ANY DISCREPANCY PRIOR TO COMMENCING CONSTRUCTION.
- THE CONTRACTOR SHALL VERIFY THE EXISTING LEVELS WHERE NEW WORKS ARE TO JOIN TO EXISTING WORKS, AND ADVISE THE MANAGING CONTRACTOR OF ANY DISCREPANCY PRIOR TO COMMENCING CONSTRUCTION.
- THE CONTRACTOR SHALL CHECK OR OBTAIN ALL DIMENSIONS RELEVANT TO SETTING OUT OF SITE WORKS.
- DURING CONSTRUCTION THE CONTRACTOR SHALL BE RESPONSIBLE FOR MAINTAINING THE STABILITY OF THE WORKS AND ENSURE NO PART IS OVERSTRESSED. THE DESIGN AND CERTIFICATION OF ALL FORMWORK AND BACKPROPPING IS TO BE THE RESPONSIBILITY OF THE CONTRACTOR.
- THE CONTRACTOR IS TO OBTAIN DESIGN ADVICE FROM A SUITABLY QUALIFIED ENGINEER REGARDING DEMOLITION, RETROFITTING, TEMPORARY WORKS, HEALTH & SAFETY AND NUISANCE. THIS HAS BEEN REFERRED TO AS THE "CONTRACTORS ENGINEER" THROUGHOUT THE REMAINING NOTES.
- FORMWORK STRIPPING: UNLESS SPECIFIED OTHERWISE IN THE PROJECT DOCUMENTATION, MINIMUM STRIPPING TIMES FOR IN-SITU CONCRETE FORMWORK SHALL COMPLY WITH SECTION 5.4.3 (TABLE 5.4.1) OF AS3610-'FORMWORK FOR CONCRETE'.
- WORKMANSHIP AND MATERIALS SHALL BE IN ACCORDANCE WITH THE CURRENT AUSTRALIAN STANDARDS AND BCA STATUTORY REQUIREMENTS, EXCEPT WHERE VARIED BY THE CONTRACT DOCUMENTS.
- THE CONTRACTOR SHALL BE RESPONSIBLE FOR ENSURING THAT SUFFICIENT TOLERANCES ARE PROVIDED AND INTEGRATED THROUGHOUT ALL ELEMENTS OF THE WORKS.
- ALL DIMENSIONS ARE IN METRES UNLESS STATED OTHERWISE.
- ALL LEVELS ARE TO AUSTRALIAN HEIGHT DATUM (A.H.D.).
- DESIGN LEVELS AND SETOUT DETAILED HEREIN ARE DERIVED SURVEY, LANDSCAPE AND ARCHITECTURAL PLANS. CONTRACTOR SHALL CONFIRM LEVELS ARE COORDINATED PRIOR TO COMMENCING WORKS. EXISTING LEVELS ARE DERIVED FROM SURVEY DATA. CONTRACTOR TO CONFIRM ALL ON SITE PRIOR TO COMMENCING WORKS.

HEALTH & SAFETY

- THE CONTRACTOR SHALL DEVELOP, IMPLEMENT AND ADMINISTER A WORKPLACE HEALTH AND SAFETY PROGRAM THAT WILL ENSURE THAT ALL CONSTRUCTION ACTIVITIES ARE PERFORMED TO THE RELEVANT WORKPLACE HEALTH AND SAFETY REQUIREMENTS AND ANY OTHER RELEVANT STATUTORY REQUIREMENTS.
- THE WORKPLACE HEALTH AND SAFETY PROGRAM MUST BE CO-ORDINATED WITH ADJOINING PROPERTY OWNERS AND ALL RELEVANT PARTIES AS NECESSARY TO ENSURE A SAFE BUILDING ENVIRONMENT AT ALL TIMES.
- THE CONTRACTOR SHALL DEVELOP, IMPLEMENT, AND ADMINISTER A PLAN THAT WILL ENSURE THE MANAGEMENT OF NOISE AND VIBRATION RESULTING FROM CONSTRUCTION WORKS. REFER TO SPECIFICATIONS FOR REQUIRED LIMITS, OTHERWISE, CONTACT ENGINEER FOR GUIDANCE.
- THE CONTRACTOR WILL NEED TO ENSURE ALL ADJOINING PROPERTY REQUIREMENTS RELATING TO NOISE AND VIBRATION ARE MET.
- IF IT IS ESTABLISHED THAT THERE ARE NO SITE SPECIFIC REQUIREMENTS, THEN THE CONTRACTOR SHALL REFER TO MINIMUM REQUIREMENTS FOR ABATEMENT OF NOISE AND VIBRATION NOMINATED BY RELEVANT STATUTORY REQUIREMENTS
- THE CONTRACTOR WILL NEED TO PREPARE AND ADVISE ON MONITORING AND MANAGEMENT OF NOISE AND VIBRATION BASED ON PROFESSIONAL ADVICE FROM SUITABLY QUALIFIED PERSON OR PERSONS.

SURVEY NOTES

- THE SURVEY INFORMATION SHOWN ON ROBERT BIRD GROUP DRAWINGS HAS BEEN OVERLaid FROM INFORMATION PROVIDED IN THE DETAILED SURVEY BY USHER & COMPANY, SURVEYING AND LAND DEVELOPMENT CONSULTANTS FILE REF: 6083-DET ISSUE 3, DATED 25.09.2018. ROBERT BIRD GROUP DOES NOT GUARANTEE THAT THE SURVEY INFORMATION IS ACCURATE, AND ACCEPTS NO LIABILITY FOR INACCURACIES.

SEDIMENT AND EROSION CONTROL NOTES

- EROSION AND SEDIMENT CONTROL MEASURES ARE TO BE PROVIDED IN ACCORDANCE WITH SPECIFICATION AND EPA "MANAGING URBAN STORMWATER CONSTRUCTION ACTIVITIES" 1998. ALL WORKS SHALL BE COMPLETED PRIOR TO CONSTRUCTION COMMENCING.
- REFER TO ROBERT BIRD GROUP'S DRAWING SHEETS C-1-00 AND C-1-10 FOR EROSION AND SEDIMENT CONTROL NOTES AND DETAILS.

EARTHWORKS NOTES

- REFER TO THE GEOTECHNICAL ENGINEERING REPORT.
- THE CONTRACTOR IS RESPONSIBLE FOR THE REMOVAL, COMPACTION AND DISPOSAL OF ALL EXCAVATED MATERIAL.

TEMPORARY WORKS

- ALL EARTHWORKS AREAS ARE TO BE LEFT IN A FREE DRAINING STATE.
- PROOF ROLL SUBGRADE TO REVEAL SOFT SPOTS. SOFT SPOTS TO BE REMOVED AND BACKFILLED. ALL NATURAL SUBGRADE IS TO BE COMPACTION TO IN ACCORDANCE WITH AS1289 PRIOR TO PLACEMENT OF FILL MATERIAL.
- MATERIAL WON FROM THE SITE TO BE INSPECTED BY THE GEOTECHNICAL ENGINEER FOR APPROVAL PRIOR TO USE AS FILL. ALL FILL TO BE COMPACTION TO MIN. 98% STANDARD COMPACTION IN 200mm MAXIMUM THICK LAYERS IN ACCORDANCE WITH AS1289.
- TEST CERTIFICATES ON THE FILL MATERIAL SHALL BE SUPPLIED TO THE SUPERINTENDENT FOR APPROVAL PRIOR TO THE USE OF THE FILL MATERIAL.

CONCRETE NOTES

GENERAL

- CONCRETE WORK SHALL BE IN ACCORDANCE WITH AS3600 AND WITH THE PROJECT SPECIFICATIONS.
- CONSTRUCTION JOINTS SHALL BE PROPERLY FORMED AND USED ONLY WHERE SHOWN ON SUPERINTENDENT DRAWINGS OR SPECIFICALLY APPROVED BY SUPERINTENDENT.
- ALL THICKNESSES SHOWN ARE MINIMUM STRUCTURAL REQUIREMENTS, NO REDUCTION IN THICKNESS DUE TO FALLS OR TOPPING IS PERMITTED.
- UNLESS A GROOVE LINE ALLOWANCE HAS BEEN NOTED ON THE DRAWINGS, NO GROOVE LINES ARE PERMITTED, EXCEPT AT SLAB LINES. ALL GROOVE LINES ARE TO BE SUBMITTED TO 'ROBERT BIRD GROUP' FOR APPROVAL.
- THE FACE OF ALL CONCRETE AGAINST WHICH NEW CONCRETE IS TO BE CAST IS TO BE THOROUGHLY MECHANICALLY SCABBLED, FULLY EXPOSING THE AGGREGATE MATRIX.

CONCRETE

- THE CHARACTERISTIC COMPRESSIVE STRENGTH (f_c) AT 28 DAYS OF IN PLACE CONCRETE SHALL BE AS NOTED IN THE SPECIFICATION OR OTHERWISE NOTED ON THE DRAWINGS
- MAXIMUM AGGREGATE SIZE....20mm
- SLUMP.....80mm
- ALL CONCRETE SHALL BE VIBRATED.
- ALL CONCRETE SHALL BE CURED IN ACCORDANCE WITH THE SPECIFICATION
- ALL CONCRETE SHALL BE SAMPLED AND TESTED IN ACCORDANCE WITH AS1012 AND THE PROJECT SPECIFICATION.
- ALL FORM WORK SHALL COMPLY WITH AS3610
- REFER STRUCTURAL ENGINEER'S SPECIFICATIONS FOR CONCRETE REQUIREMENTS.
- REINFORCEMENT**
- REINFORCEMENT IS TO BE MANUFACTURED IN ACCORDANCE WITH AS4671 AND SHALL BE FIXED AS SHOWN ON DRAWINGS.
- MATERIAL IS INDICATED BY THE FOLLOWING SYMBOLS:-

 - Y DEFORMED BAR GRADE 400
 - N DEFORMED BAR GRADE 500 (NORMAL DUCTILITY)
 - R PLAIN ROUND BAR GRADE 250
 - W PLAIN WIRE GRADE 450
 - SL SQUARE FABRIC GRADE 500
 - RL RECTANGULAR FABRIC GRADE 500


- THE BAR SIZE IS INDICATED BY A NUMBER AFTER THE SYMBOL, WHICH INDICATES THE BAR DIAMETER IN MILLIMETRES.
- REINFORCEMENT SPACING NOMINATED ON DRAWINGS IS TO ASSIST SCHEDULER AND STEEL FIXER TO ASSESS TOTAL NUMBER OF BARS REQUIRED. WHERE BARS PLACED IN ACCORDANCE WITH SPACING NOMINATED FOUL WITH OTHER STRUCTURAL REQUIREMENTS, PREFERENCE IS TO BE GIVEN TO RELOCATING BARS BY LOCALLY ADJUSTING SPACING TO ENABLE ASSEMBLY OF REINFORCEMENT TO BE COMPLETED. ENGINEER IS TO BE CONTACTED IN THE EVENT THAT REINFORCEMENT IS NEEDED TO BE CUT ON SITE PRIOR TO CONTINUING.
- LAP LENGTHS TO REINFORCEMENT BARS TO BE AS NOTED ON THE RELEVANT DRAWINGS.
- WELDING OF REINFORCEMENT BARS IS NOT PERMITTED UNLESS APPROVED.

CONCRETE NOTES CONTINUED

REINFORCEMENT CONTINUED

- COVER SHALL BE AS NOTED ON THE RELEVANT DRAWINGS.
- CONCRETE COVERS NOTED ARE MEASURED FROM THE FORM WORK OR GROUND FACE TO THE OUTERMOST REINFORCEMENT COMPONENT, i.e.. IN COLUMNS AND BEAMS TO THE OUTSIDE OF TIES OR LIGATURES.
- COVER TO BE MAINTAINED DURING POURING BY THE USE OF PLASTIC CHAIRS OR PLASTIC TIPPED METAL CHAIRS.
- WHERE NO REINFORCEMENT IS SHOWN ON THE DRAWING AT RIGHT ANGLES TO THE MAIN REINFORCEMENT DISTRIBUTION REINFORCEMENT IS TO BE PROVIDED.
- BENDING & STRAIGHTENING
- COLD BENDING: BARS CANNOT BE COLD BENT WITHOUT PRIOR APPROVAL FROM THE PROJECT STRUCTURAL ENGINEER. CORRECT MINIMUM DIAMETER FORMERS ARE TO BE USED IN ACCORDANCE WITH AS3600.
- HOT BENDING: HOT BENDING MAY ONLY BE CONDUCTED WITH THE APPROVAL OF THE PROJECT STRUCTURAL ENGINEER. HOT BENDING CAN ONLY BE PERFORMED BY A CERTIFIED WELDER. TEST CERTIFICATE OF AFFECTED AREA TO BE OBTAINED.
- STRAIGHTENING: WHEN RE-STRAIGHTENING PARTIALLY EMBEDDED BARS, DO NOT BEND OVER FORMERS OF SMALLER DIAMETER THAN PERMITTED IN AS 3600. DO NOT SUBJECT REINFORCEMENT BARS TO IMPACT IN ORDER TO STRAIGHTEN.

SLAB ON GROUND NOTES

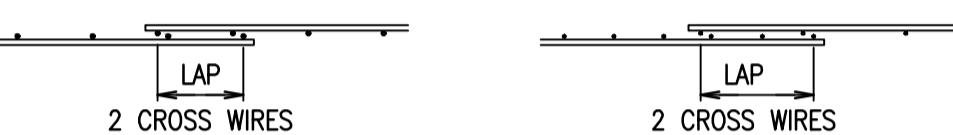- SLAB ON GROUND TO BE POURED ON A LAYER OF POLYETHYLENE SHEETING 200μm THICK ON TOP of 50mm of BEDDING SAND. JOINTS TO BE TAPEd
 - FABRIC TO BE PLACED ON CHAIRS AT 800 x 800 CENTRES AND CHAIRS TO BE PLACED ON STEEL PANS.
 - LAP FABRIC REINFORCEMENT THUS:
- 
- 2 CROSS WIRES LAP 2 CROSS WIRES LAP
- WHERE BEDDING SAND IS REQUIRED UNDER SLAB, THIS SHALL BE COMPACTION SUFFICIENTLY TO SUPPORT REINFORCEMENT PLUS 100kg/CHAIR WITHOUT VERTICAL DISPLACEMENT EXCEEDING 5mm.

ROADS AND PAVEMENT NOTES

GENERAL

- PAVEMENT SHALL BE BOXED OUT TO THE DEPTHS AS SHOWN ON THE PAVEMENT DRAWINGS, AND SUBGRADE TESTING IS TO BE UNDERTAKEN. SUBGRADE TESTING RESULTS ARE TO BE FORWARDED TO THE ENGINEER (ROBERT BIRD GROUP) FOR DETERMINATION OF FINAL PAVEMENT DEPTH. PAVEMENT CONSTRUCTION IS TO HOLD UNTIL FINAL PAVEMENT DEPTH HAS BEEN DETERMINED BY THE ENGINEER, AND APPROVED BY THE RELEVANT AUTHORITY.
- PREPARATION OF SELECT SUBGRADE LAYERED**
- THE SELECT SUBGRADE LAYER IS DEFINED AS THE UPPER 300MM OF THE FORMATION UPON WHICH THE ROAD PAVEMENT IS TO BE CONSTRUCTED. THE UPPER SURFACE OF THE SUBGRADE LAYER IS DEFINED AS THE DESIGN SUBGRADE LEVEL.
- THE SELECT SUBGRADE LAYER SHALL BE FREE FROM ALL POCKETS OF SOFT COMPRESSIBLE MATERIAL, FREE FROM STONE WITH A MAXIMUM DIMENSION LARGER THAN 50MM, AND HAVE A MINIMUM SOAKED CBR AS SPECIFIED ON DRAWINGS.
- ANY UNSUITABLE LAYER SHALL BE COMPACTION TO A FIELD DRY DENSITY OF NOT LESS THAN 100% AS DETERMINED IN ACCORDANCE WITH RTA TEST METHOD T111 - STANDARD COMPACTION (FOR A COHESIVE SOIL) OR A MINIMUM DENSITY INDEX OF 80% WHEN TESTED IN ACCORDANCE WITH AS:1289.5.6.1 (FOR A COHESIVE LESS SOIL)
- TESTS FOR COMPACTION OF SELECTED SUBGRADE LAYER SHALL BE CARRIED OUT BY THE CONTRACTOR AT LOCATION APPROVED BY THE SUPERINTENDENT AT A RATE AS SPECIFIED.

PLACEMENT OF PAVEMENT MATERIALS

- THE PAVEMENT SHALL BE CONSTRUCTED TO THE THICKNESS AS SHOWN ON THE DRAWINGS. PAVEMENT COURSES LESS THAN 150mm IN COMPACTED THICKNESS SHALL BE SPREAD AND COMPACTION IN TWO OR MORE LAYERS OF NOT LESS THAN 75MM OR MORE THAN 150MM IN COMPACTED THICKNESS.
- SPREADING SHALL BE UNDERTAKEN BY A METHOD THAT WILL ENSURE THAT SEGREGATION DOES NOT OCCUR.
- MIXING OR BLENDING OF PAVEMENT MATERIALS WILL NOT BE ALLOWED ON THE ROAD FORMATION. PAVEMENT MATERIAL SHALL NOT BE SPREAD ON A WATERLOGGED SUBGRADE NOR BROKEN ON THE SUBGRADE. WHEN SPREADING AND/OR MIXING PAVEMENT MATERIAL, CARE SHALL BE TAKEN TO ENSURE THAT THE SUBGRADE SHALL NOT BE DISTURBED, BECOME RUTTED OR MIXED WITH THE PAVEMENT MATERIALS.
- IF, AT ANY TIME, ANY PART OF SUBGRADE AND PAVEMENT MATERIALS BECOME MIXED, THE CONTRACTOR SHALL, AT ITS COST, REMOVE THE MIXTURE AND RESHAPE THE SUBGRADE WITH APPROVED MATERIAL COMPACTED UNIFORMLY WITH THE SURROUNDING SURFACE.
- WHEN EACH LAYER OF PAVEMENT MATERIAL HAS BEEN SPREAD, WATERING SHALL BE CARRIED OUT AS NECESSARY TO MAINTAIN THE MATERIAL AT A MOISTURE CONTENT DURING ROLLING AS CLOSE TO BUT NOT EXCEEDING ITS OPTIMUM MOISTURE CONTENT.
- WHERE THE MOISTURE CONTENT OF PAVEMENT MATERIAL IS INSUFFICIENT, WATER SHALL BE ADDED BY APPROVED WATERING EQUIPMENT AND SHALL BE MIXED UNIFORMLY WITH THE MATERIAL BY AN APPROVED MECHANICAL DEVICE.
- WHERE THERE IS EXCESS MOISTURE IN THE PAVEMENT MATERIAL, IT SHALL BE DRIED TO THE REQUIRED MOISTURE CONTENT BY LOOSENING AND AERATING.

COMPACTION OF PAVEMENT MATERIALS

- AS EACH LAYER IS BROUGHT TO IT OPTIMUM MOISTURE CONTENT, IT SHALL BE IMMEDIATELY COMPACTION BY ROLLING.
- COMPACTION SHALL BE CARRIED OUT USING APPROVED EQUIPMENT OF ADEQUATE CAPACITY TO ACHIEVE THE DEGREE OF COMPACTION SPECIFIED.
- ANY DEFICIENCIES MADE BY THE SINKING OF THE COMPACTOR WHEN COMPACTION MATERIAL SHALL AT ONCE BE MADE GOOD BY SCARIFYING THE SURFACE AND ADDING ADDITIONAL MATERIAL AT THE CONTRACTOR'S EXPENSE.
- ON THE SECTION OF PAVEMENT HAVING A ONE-WAY CROSS FALL, COMPACTION SHALL COMMENCE AT THE LOWER EDGE OF THE BASE AND PROGRESS UPWARDS TO THE HIGHER EDGE.
- ON CROWNED SECTION OF PAVEMENT, COMPACTION SHALL COMMENCE AT THE OUTER EDGES OF THE BASE AND PROGRESS INWARDS TOWARDS THE CROWN.
- Each PASS OF THE COMPACTION PLANT SHALL BE PARALLEL TO THE CENTRE LINE OF THE PAVEMENT. THE METHOD OF COMPACTION SHALL ALLOW FOR PROGRESSIVE AND UNIFORM OVERLAP BETWEEN PASSES.
- IF NON-VIBRATING SMOOTH-WHEELED ROLLERS ARE USED AS COMPACTION PLANT, THEY SHALL BE OPERATED WITH THE DRIVING ROLLERS FACING THE UNCOMPACTED MATERIAL DURING THE INITIAL PASS.
- IF VIBRATING ROLLERS ARE USED AS COMPACTION PLANT, THE VIBRATOR SHALL NOT BE ACTIVATED UNTIL A MINIMUM OF TWO "STATIC" PASSES HAVE BEEN MADE. IN ADDITION, THE VIBRATORS SHALL NOT BE ACTIVATED DURING ANY CHANGE IN DIRECTION OF THE ROLLER.
- COMPACTION PLANT AND OTHER AUXILIARY PLANT SHALL NOT BE ALLOWED TO REMAIN STANDING ON THE COMPACTED PAVEMENT WITHOUT THE APPROVAL OF THE SUPERINTENDENT.
- TRAFFIC SHALL NOT BE ALLOWED ON ANY COMPACTED LAYER WITHOUT APPROVAL OF THE SUPERINTENDENT. EACH LAYER IN A MULTI-LAYERED COURSE SHALL BE FULLY COMPACTION IN SEQUENCE. THE SURFACE OF THE COMPACTED LAYER SHALL BE KEPT SUFFICIENTLY MOIST TO MAINTAIN THE REQUIRED FIELD MOISTURE CONTENT THROUGHOUT THE FULL DEPTH OF THE LAYER PRIOR TO PLACEMENT OF SUBSEQUENT LAYERS OR TO THE APPLICATION OF THE SURFACE PRIMER, AS APPROPRIATE.
- COMPACTION SHALL CONTINUE UNTIL THE MATERIAL DOES NOT CREEP OR WAVE AHEAD OF THE ROLLER, UNTIL THE SURFACE PRESENTS A SMOOTH UNIFORM APPEARANCE AND UNTIL THE MATERIAL HAS BEEN LEVELED AND COMPACTED TO THE REQUIREMENTS AND TOLERANCES SPECIFIED ELSEWHERE HEREIN.
- TESTS FOR COMPACTION OF ROAD PAVEMENT MATERIALS SHALL BE CARRIED OUT BY THE CONTRACTOR AT LOCATIONS APPROVED BY THE SUPERINTENDENT AT A RATE AS SPECIFIED.

STORMWATER DRAINAGE NOTES

- THESE NOTES SHALL BE READ IN CONJUNCTION WITH:
 - GENERAL NOTES AND DISCLAIMERS FOR THE PROJECT
 - ROADWORKS NOTES FOR THE PROJECT
 - SPECIFICATIONS FOR THE PROJECT
- STORMWATER PIPES 375NB AND GREATER SHALL BE RCP RRJ, U.N.O. CLASSES AS NOTED ON THE DRAWINGS. FRC PERMITTED.
- STORMWATER DRAINAGE PIPES LESS THAN OR EQUAL TO 900mm DIAMETER SHALL BE SPIGOT AND SOCKET AND RUBBER RING JOINED.
- OUTLET LOCATIONS ARE TO BE CONFIRMED ON SITE BY THE MANAGING CONTRACTOR PRIOR TO THE COMMENCEMENT OF STORMWATER DRAINAGE CONSTRUCTION.
- ALL PROPOSED STORMWATER WORKS DESIGNED IN ACCORDANCE WITH:
 - AUSTRALIAN RAINFALL AND RUNOFF (1987 EDITION) VOLUMES 1 AND 2.
 - AS 3500 NATIONAL PLUMBING CODE PART 3 - STORMWATER DRAINAGE.
 - PARRAMATTA CITY COUNCIL'S PUBLIC DOMAIN GUIDELINES.

SERVICE NOTES

- ALL EXISTING SERVICES LIDS THAT ARE TO REMAIN ARE TO BE RECONSTRUCTED TO MATCH PROPOSED LEVELS AND ALIGNED TO PARRAMATTA CITY COUNCIL STANDARDS.

LANDSCAPING NOTES


- REFER TO ASPECT LANDSCAPE ARCHITECTS DRAWINGS FOR LANDSCAPING DETAILS.

HYDRAULICS NOTES

- REFER TO HYDRAULIC ENGINEERS DRAWINGS FOR SEWER, WATER AND INTERNAL SITE STORMWATER DRAINAGE WORKS

Rev	Revision	Description	By	App	Date	Rev	Revision	Description	By	App	Date
1	ISSUED FOR DEVELOPMENT APPLICATION	ZJ CR	04.03.19								

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Structural, Civil & Construction
Engineering Consultant
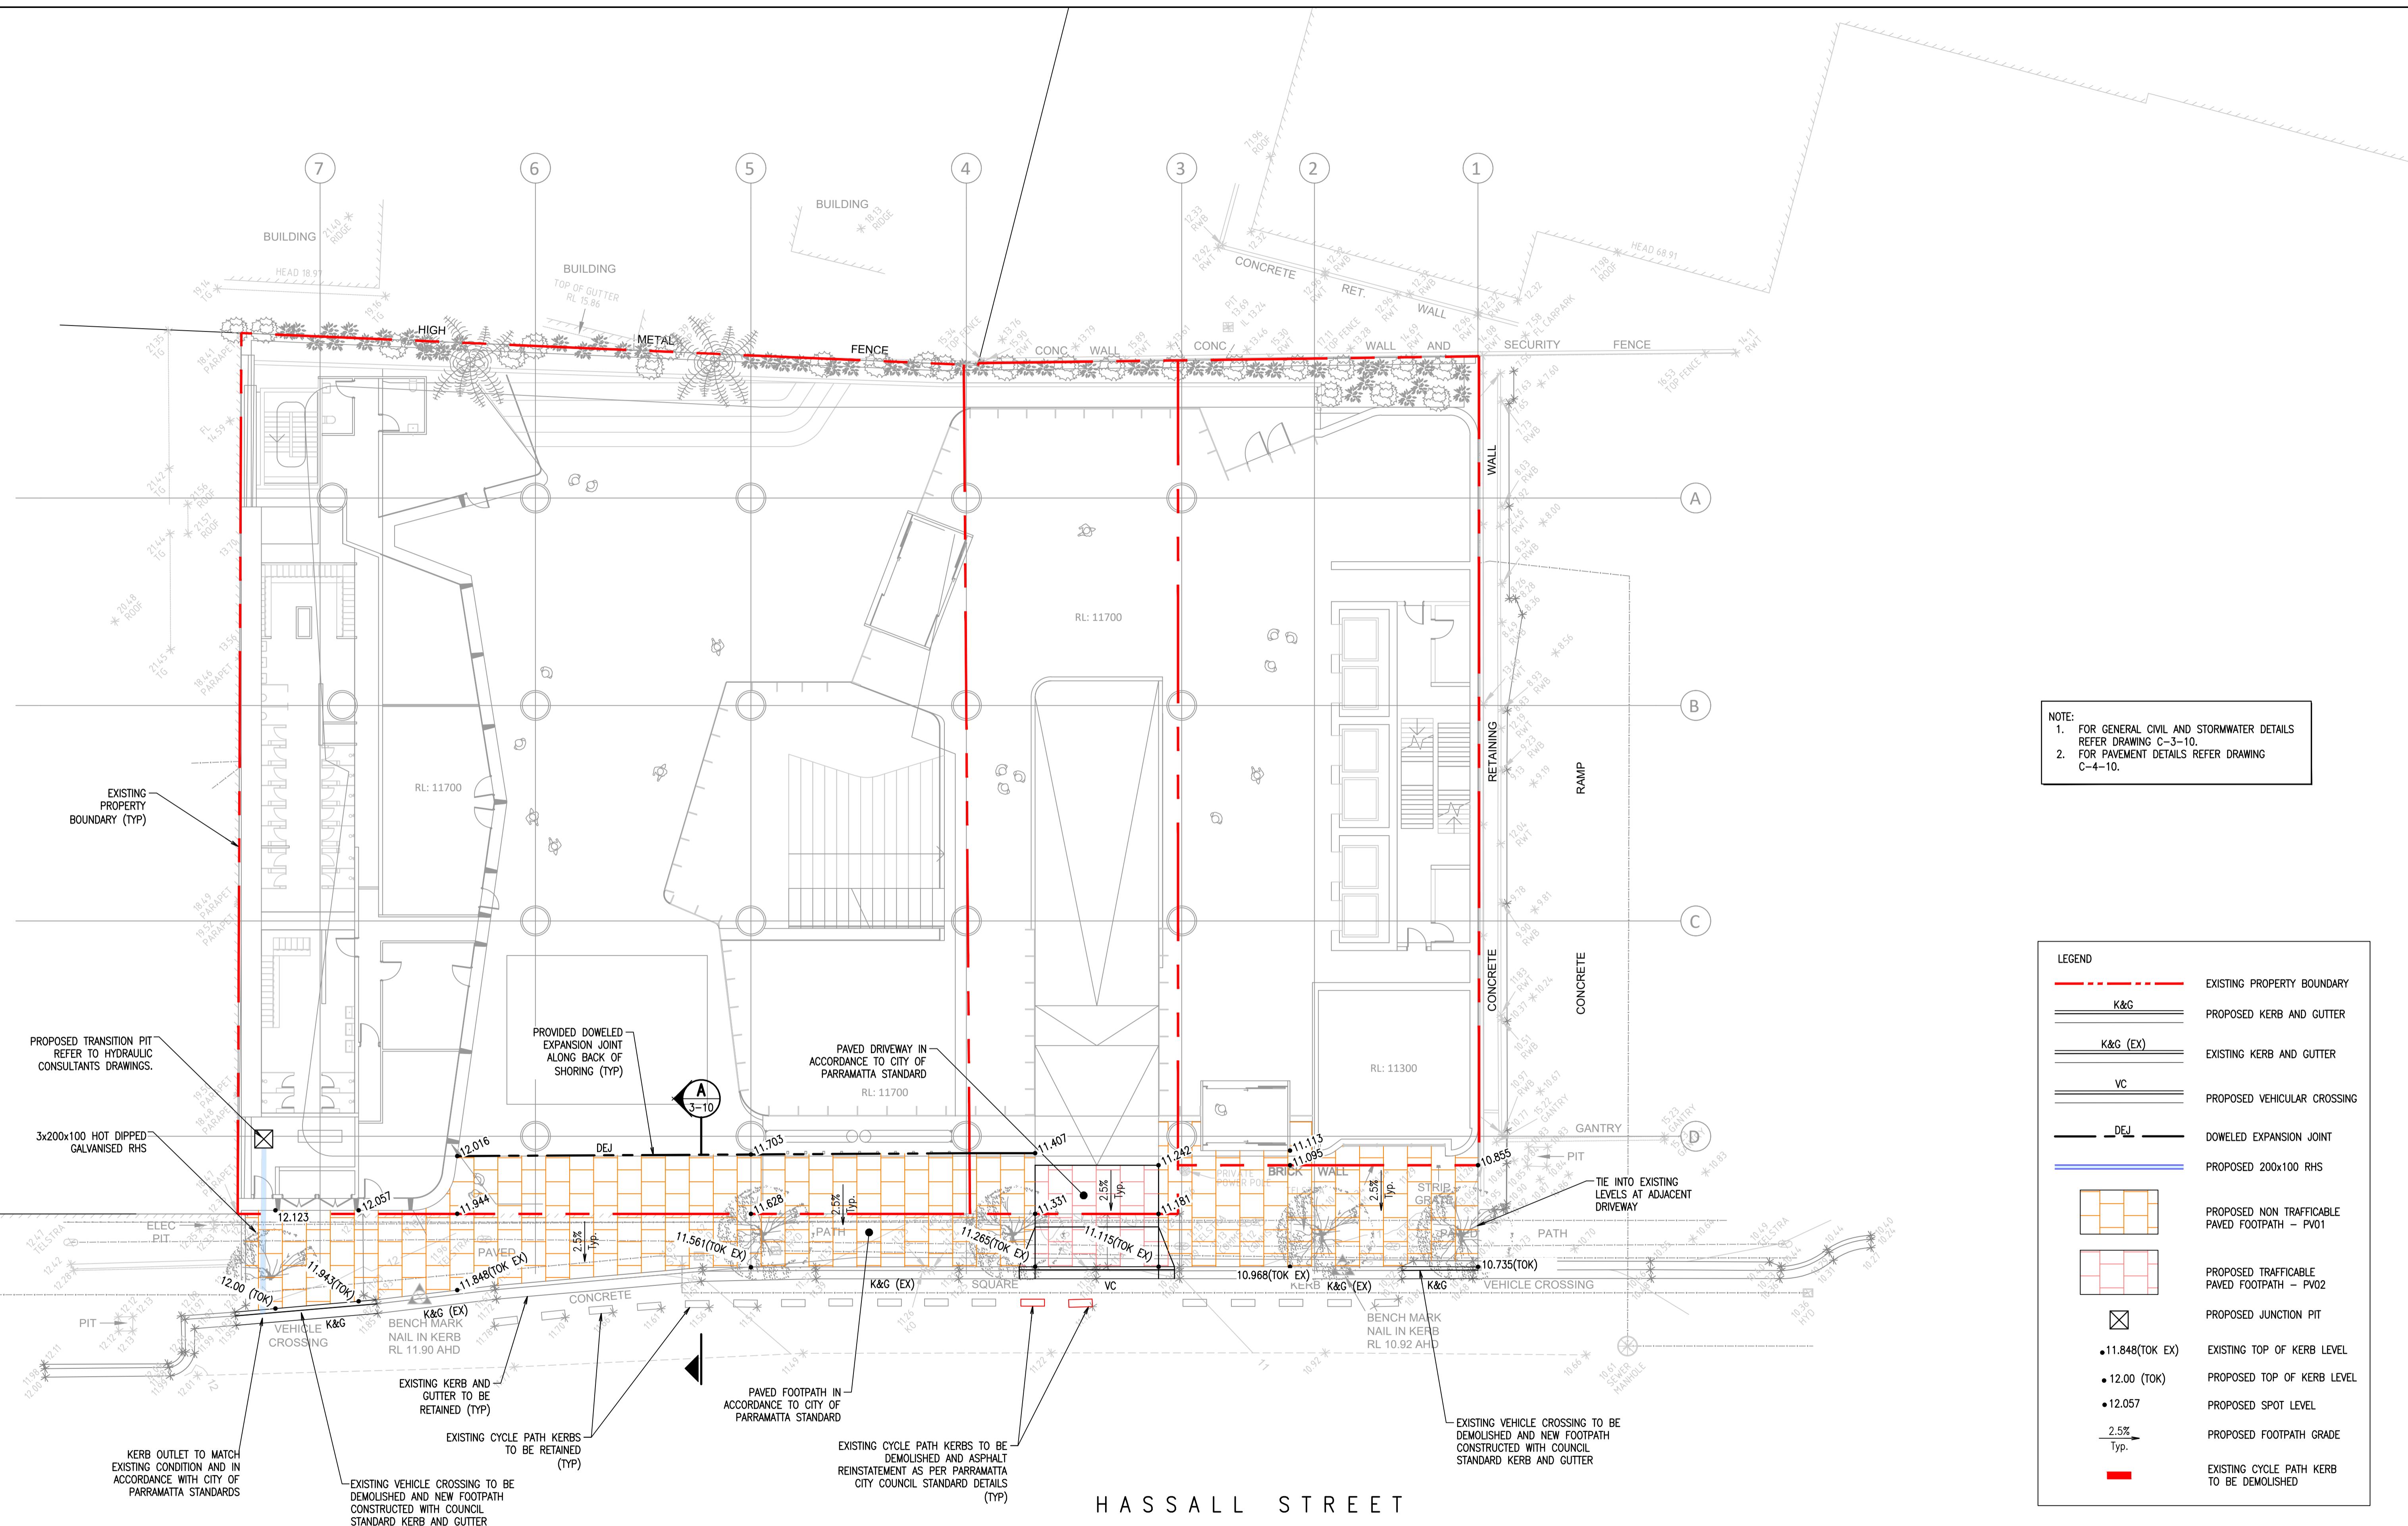
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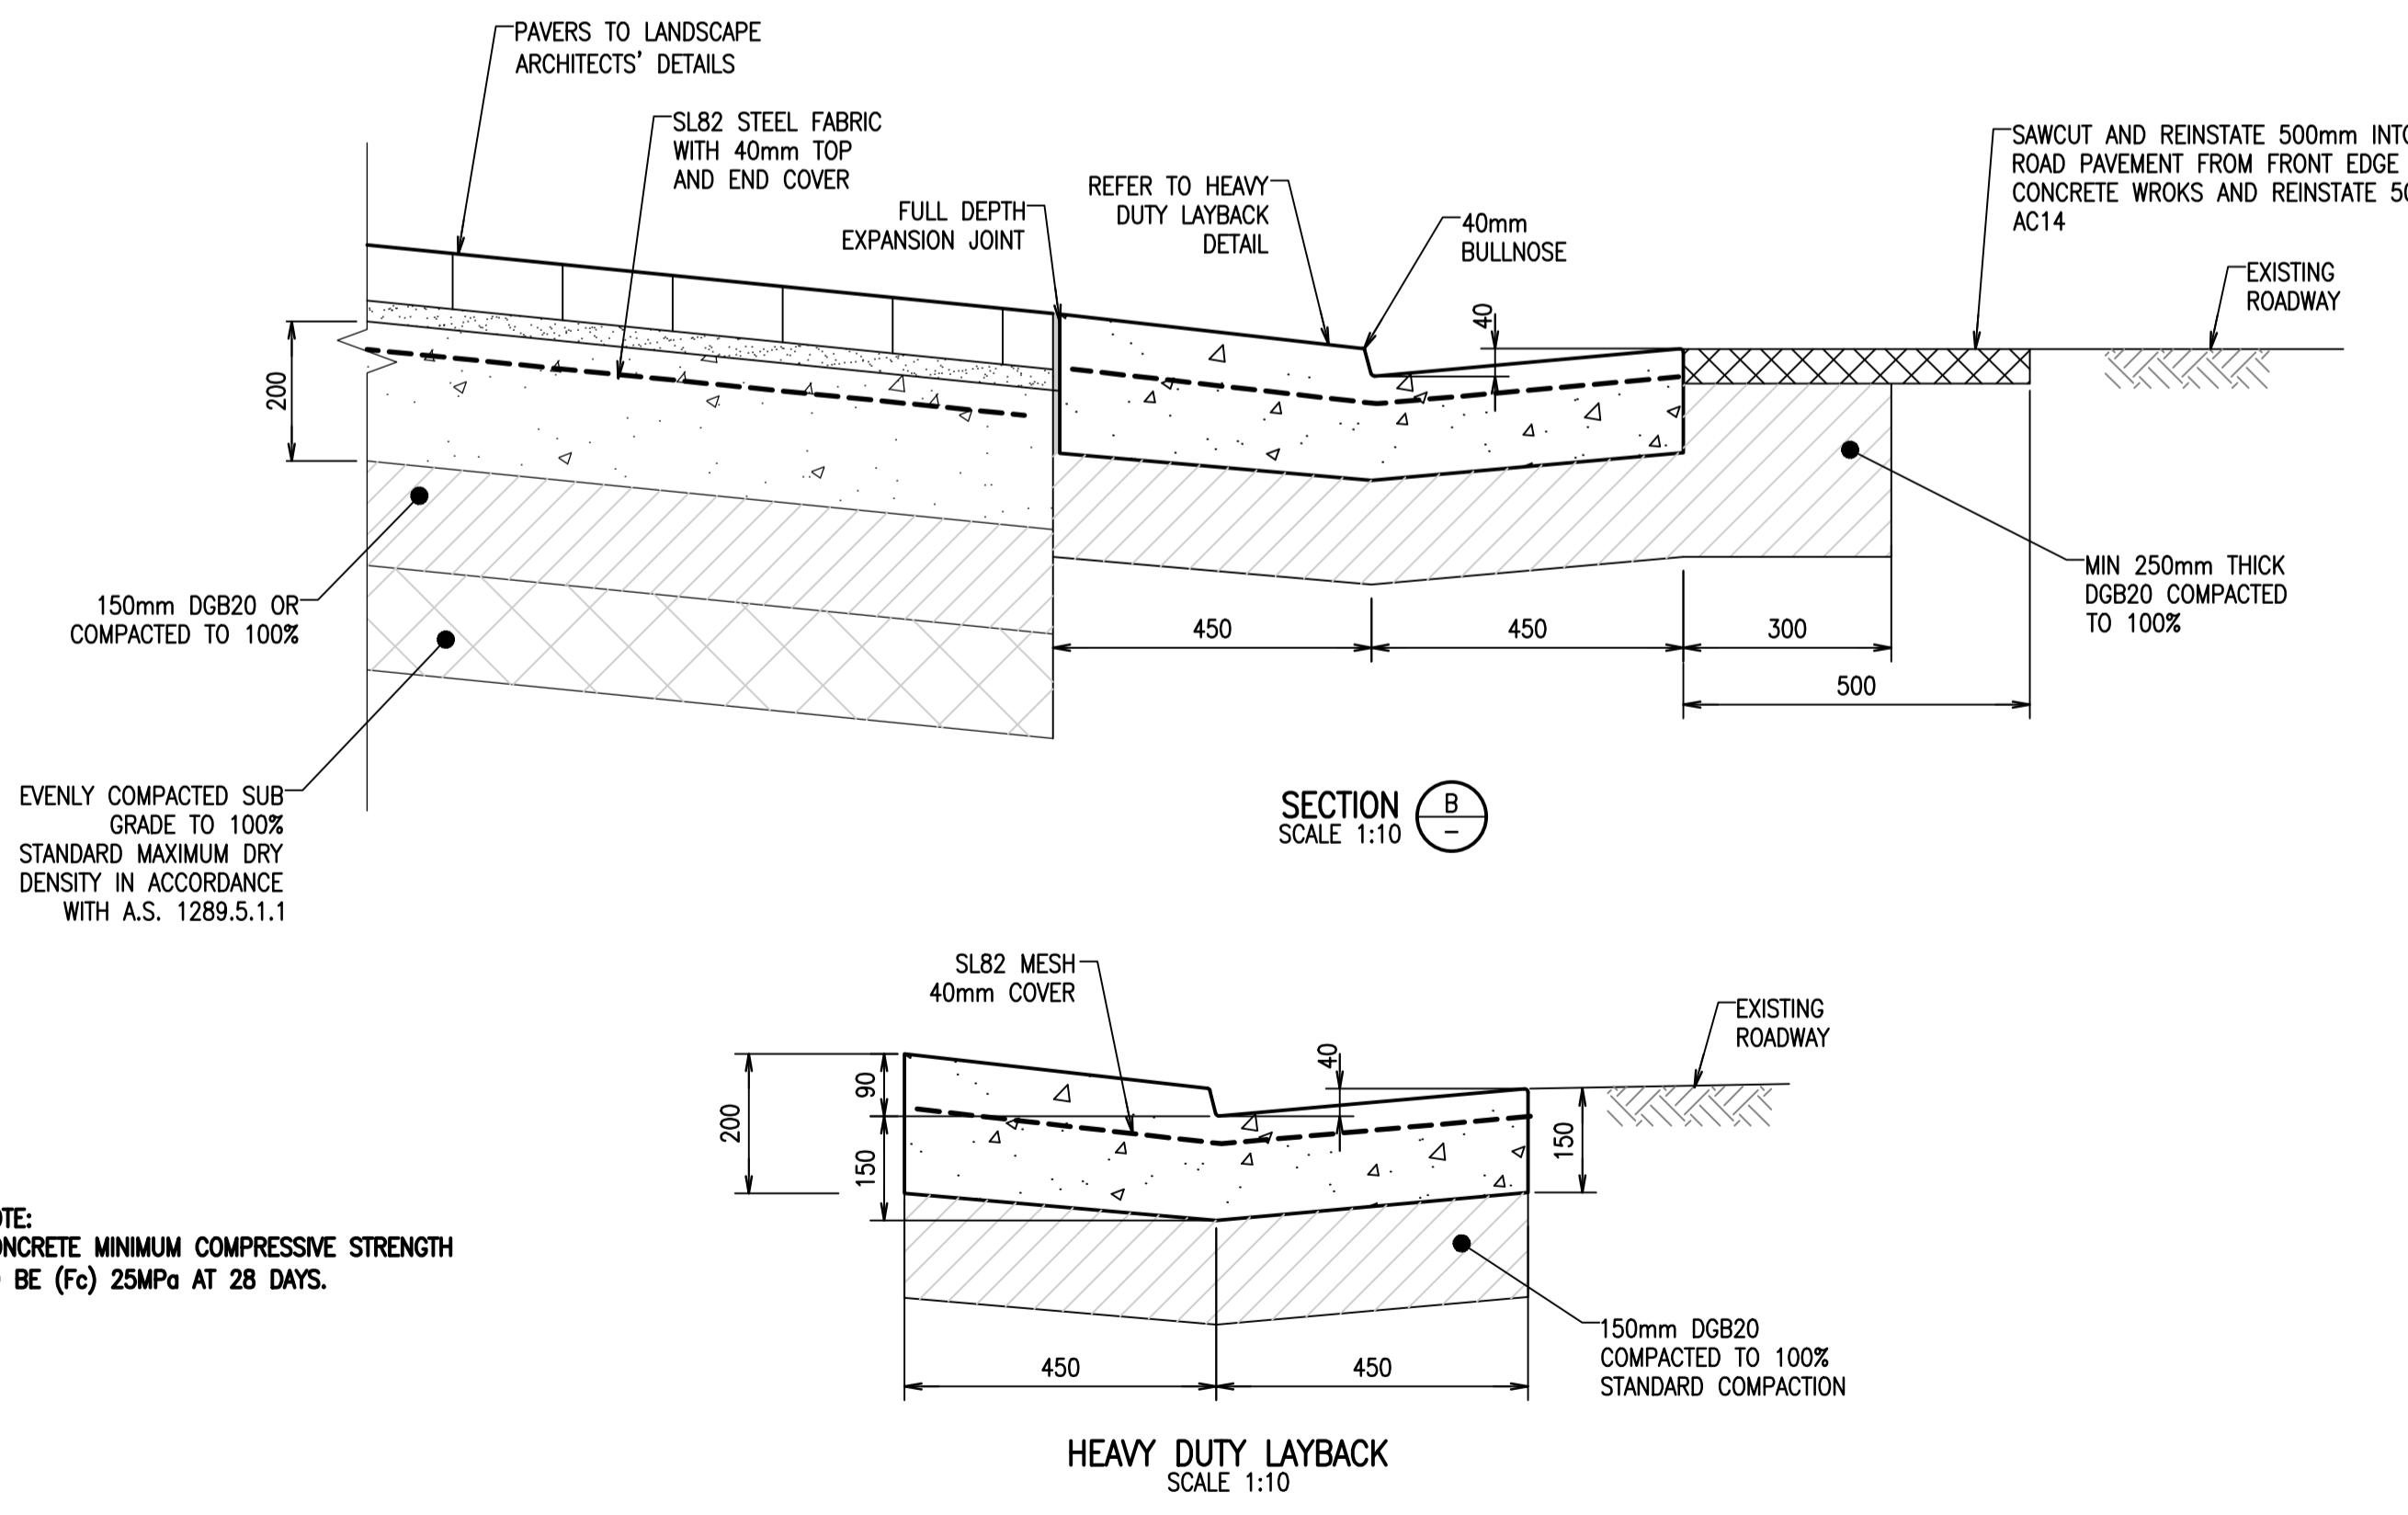
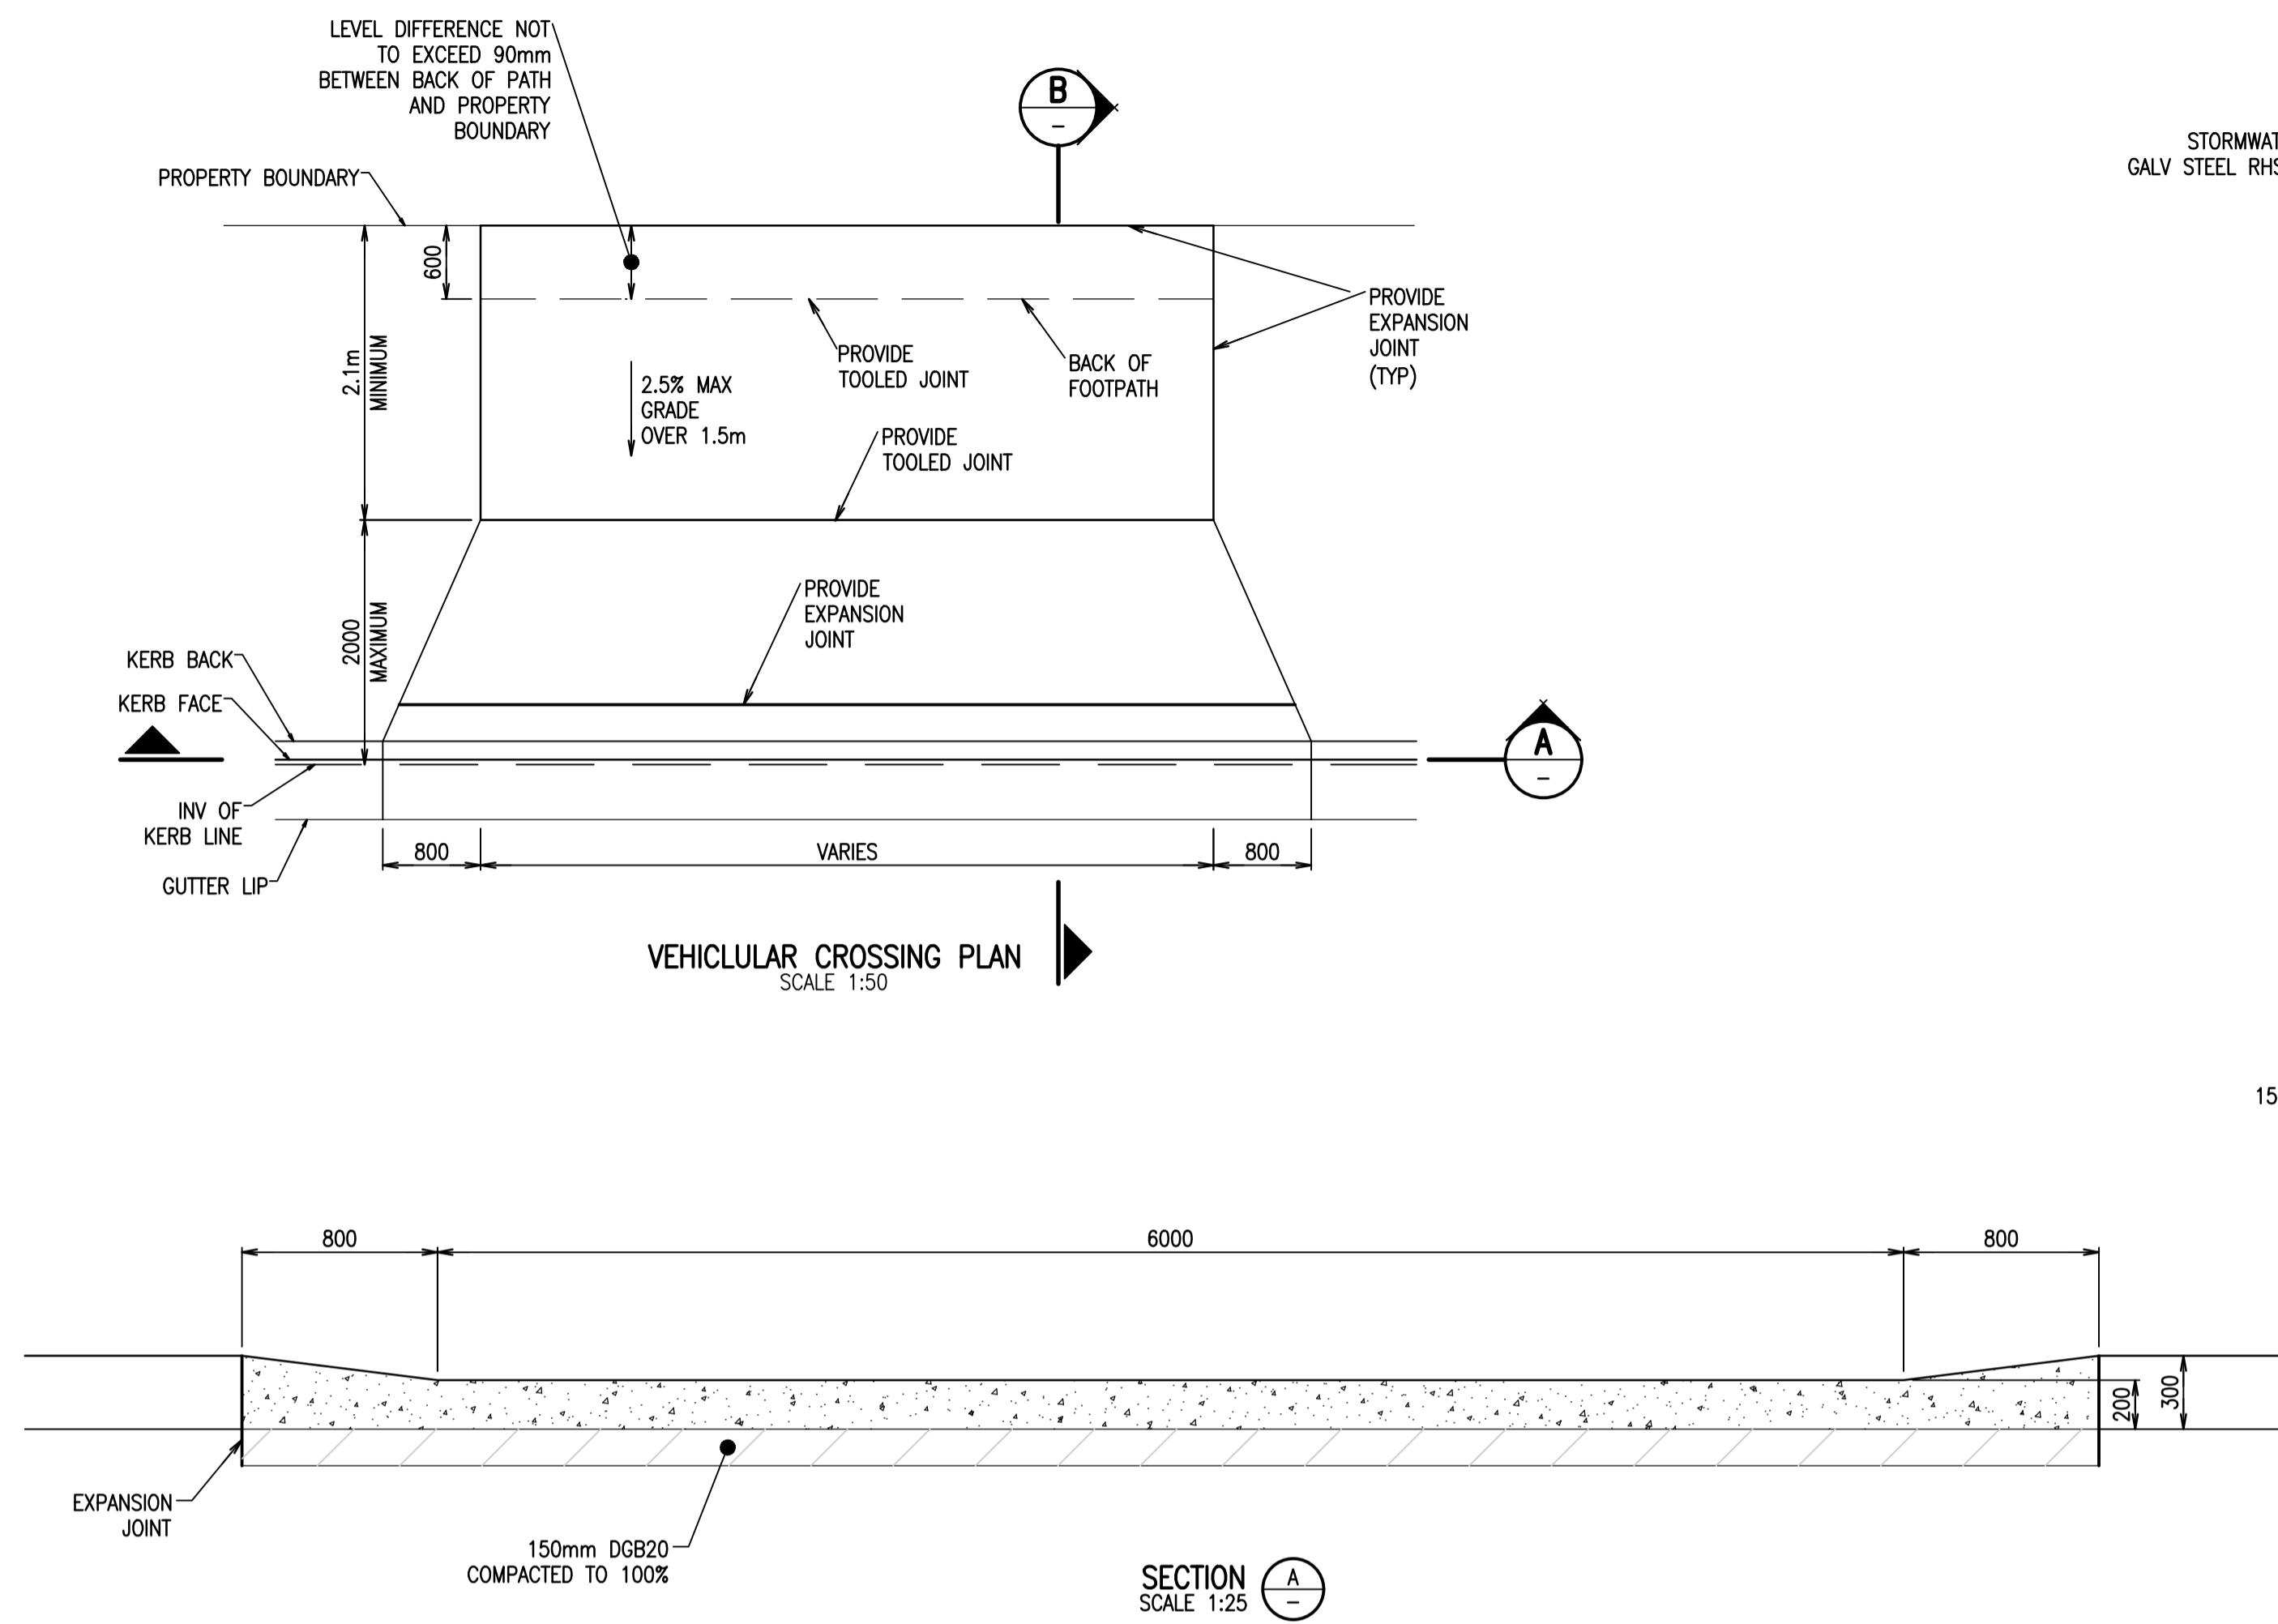
Client

Charter Hall

Title
GENERAL ARRANGEMENT PLAN
Project
2B-6 HASSALL STREET
PARRAMATTA

Scale at A1
AS SHOWN
Drawn
S.MANANDHAR
Date
03.04.19
Designer
C.ROPE
Approved
Z.JONES
Job Number
18570C

NOT FOR CONSTRUCTION
Drawing Number
C-3-00
Revision
2



Rev	Revision	Description
1	ISSUED FOR DEVELOPMENT	APPLICATION
2	ISSUED FOR DEVELOPMENT	APPLICATION

	By	App	Date	Rev	Revision	Description
N	ZJ	CR	04.03.19			
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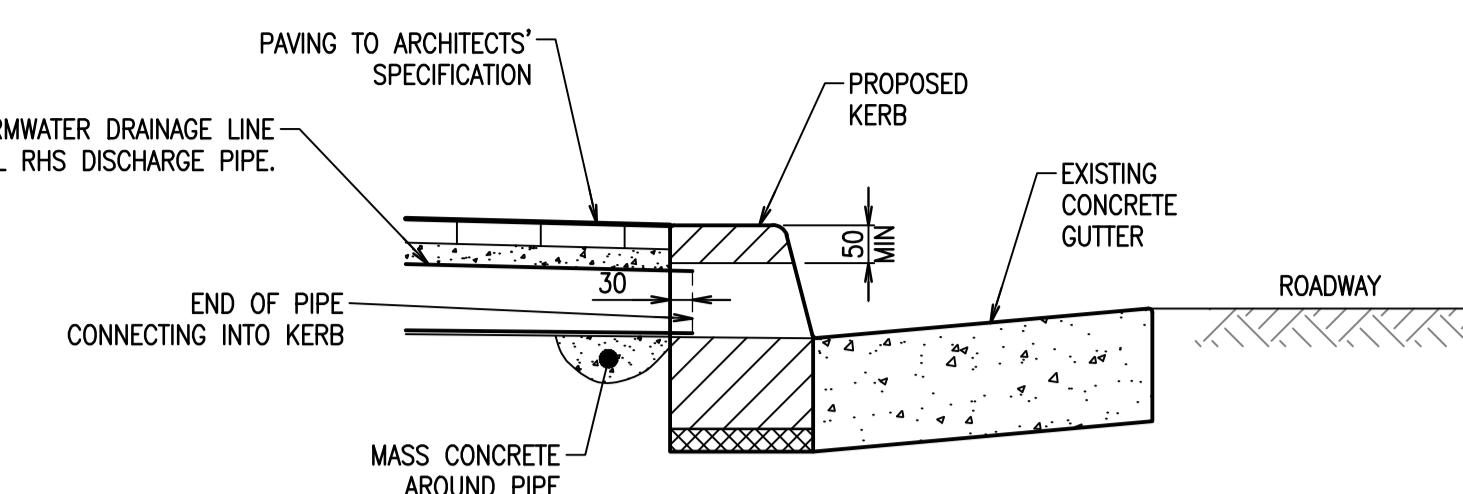
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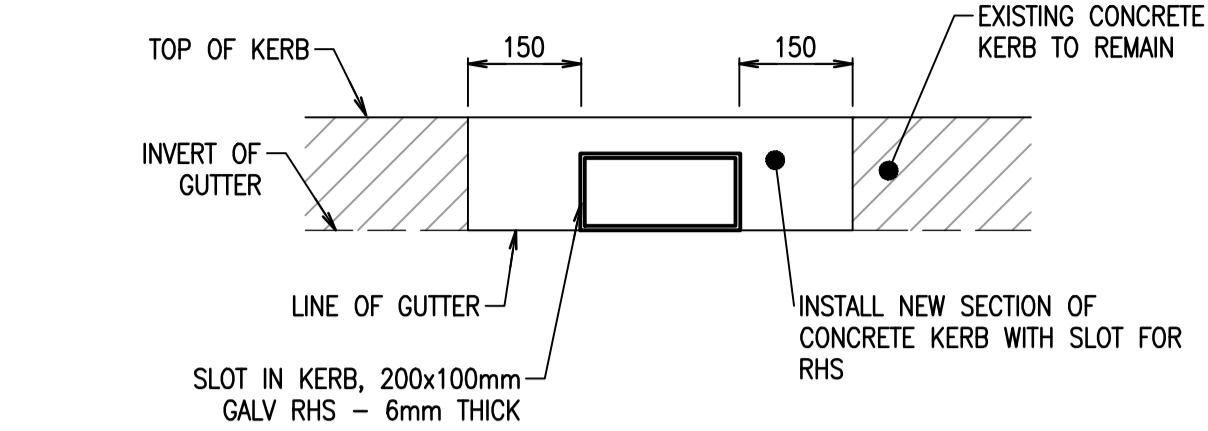


Project
2B-6 HASSALL STREET
PARRAMATTA


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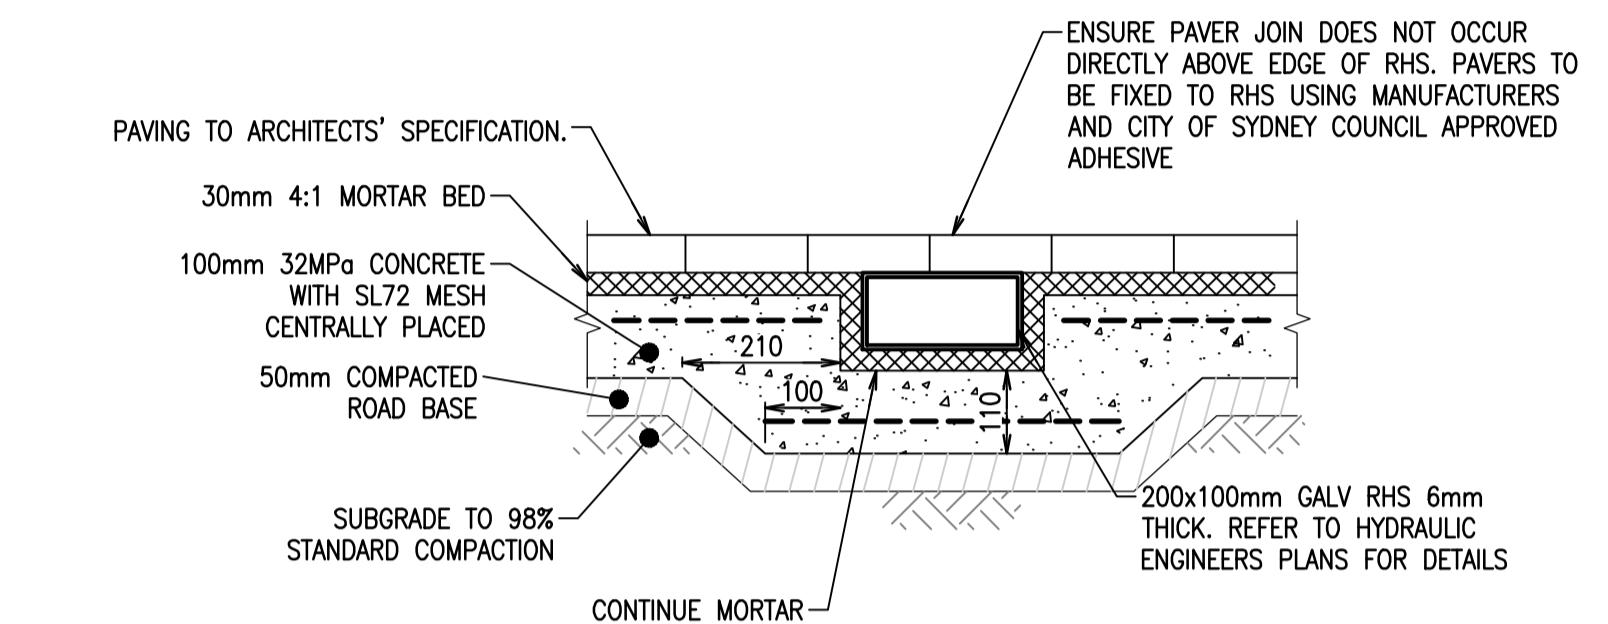
CONCRETE KERB STORMWATER OUTLET – SECTION
SCALE 1:10




CONCRETE KERB STORMWATER OUTLET – ELEVATION
SCALE 1:10









KERB AND GUTTER (K)

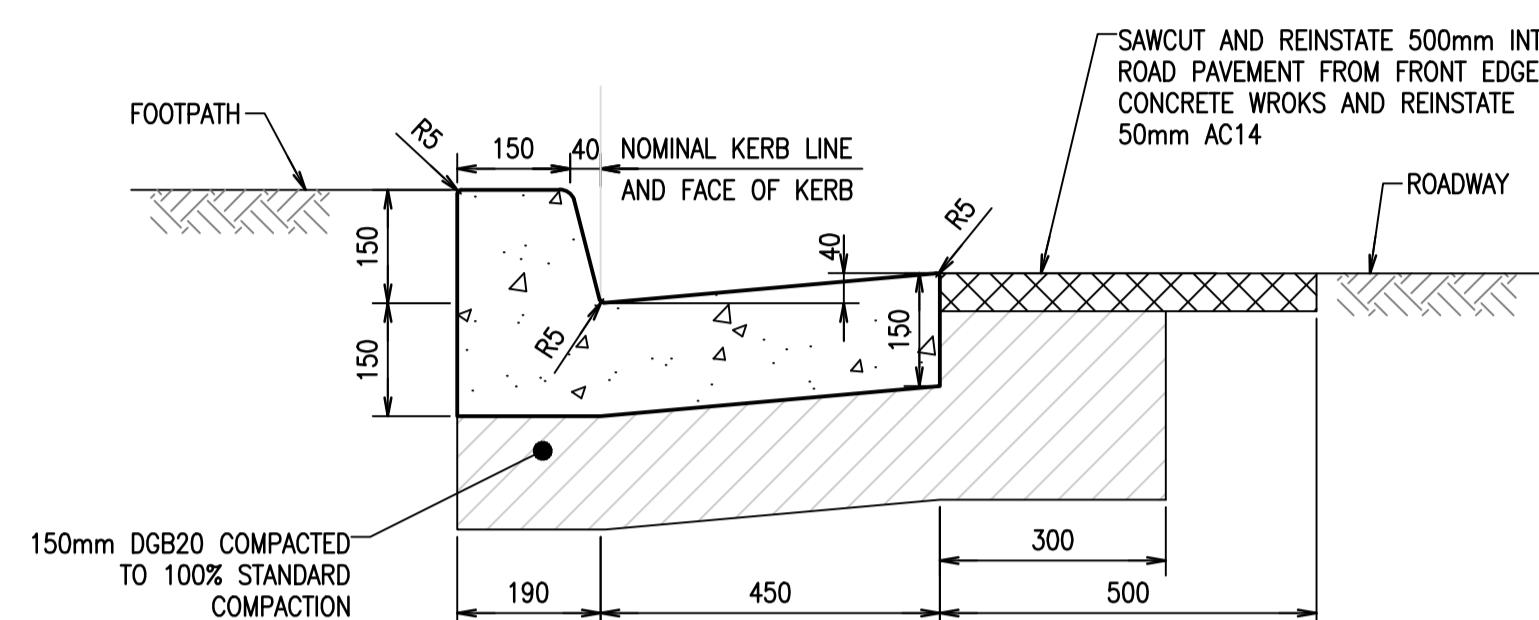

STORMWATER RHS WITHIN PAVEMENT DETAIL
SCALE 1:10

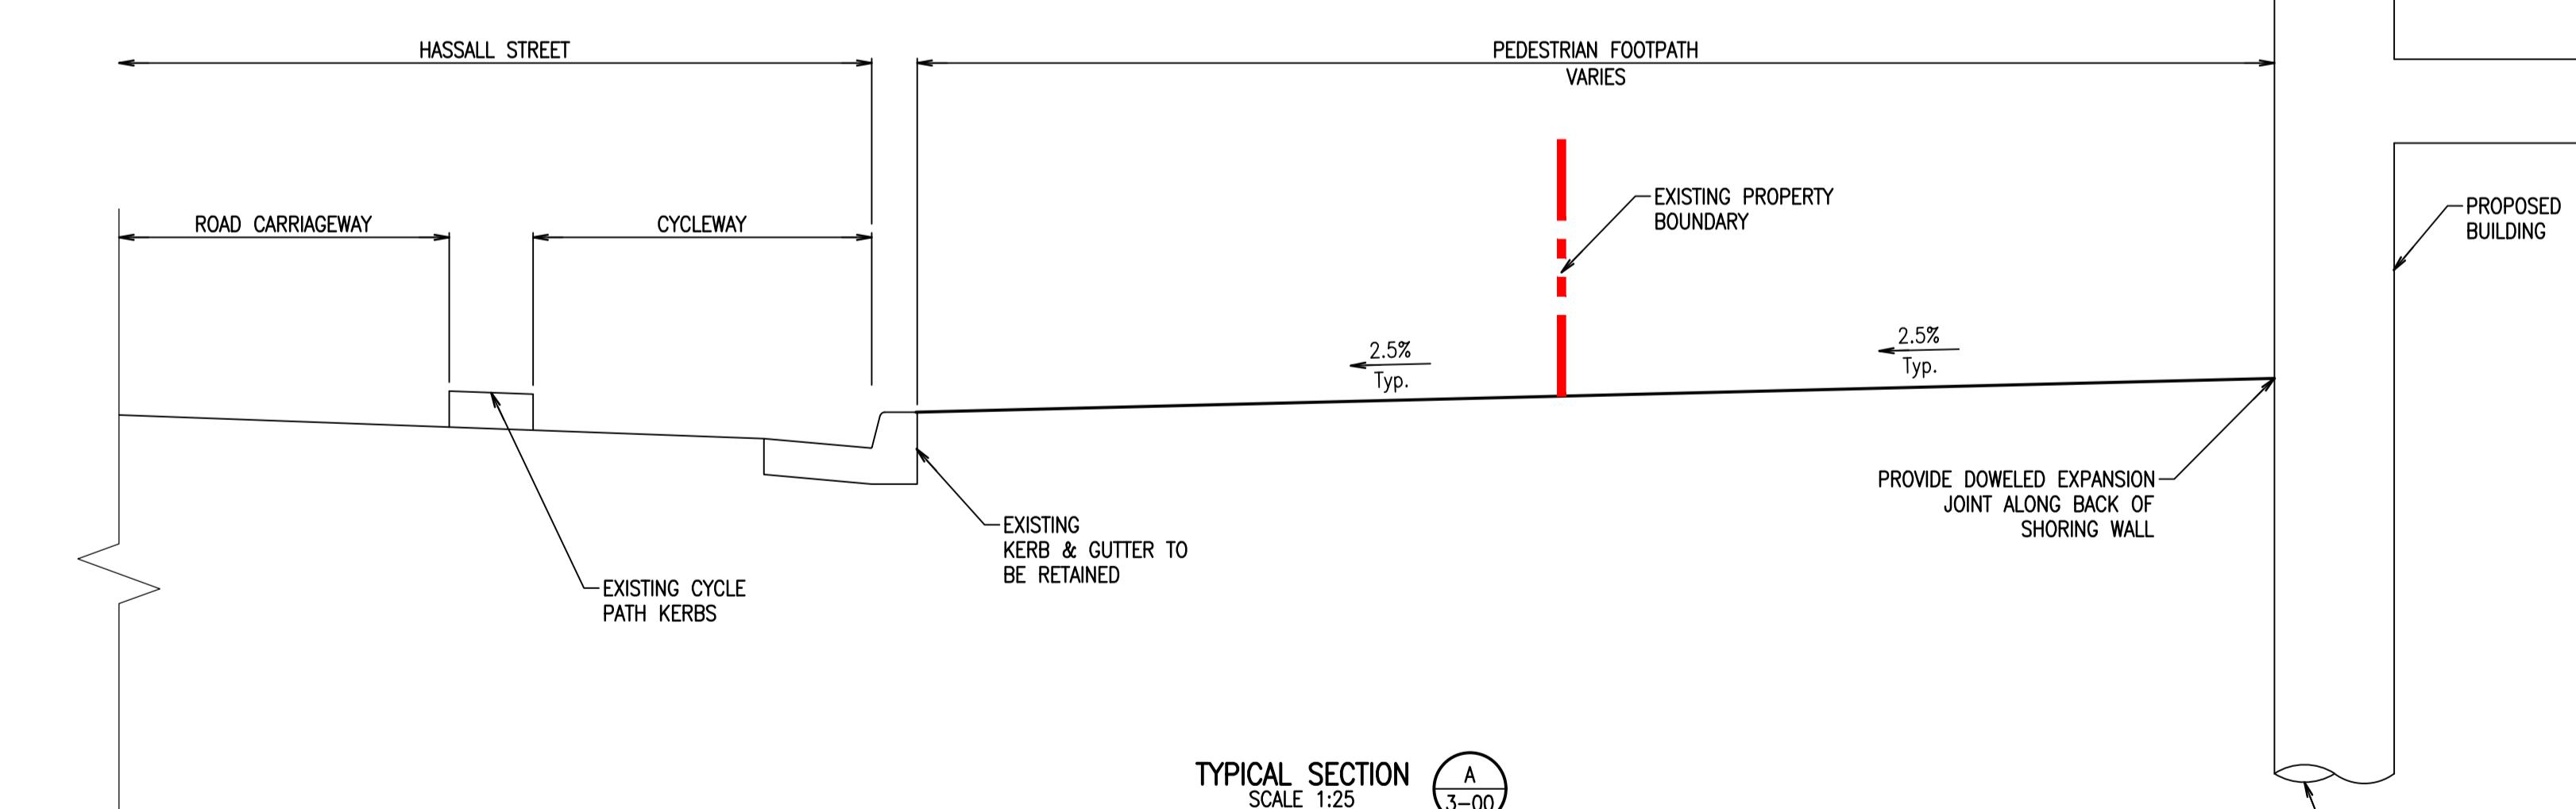

TYPICAL SECTION
SCALE 1:25

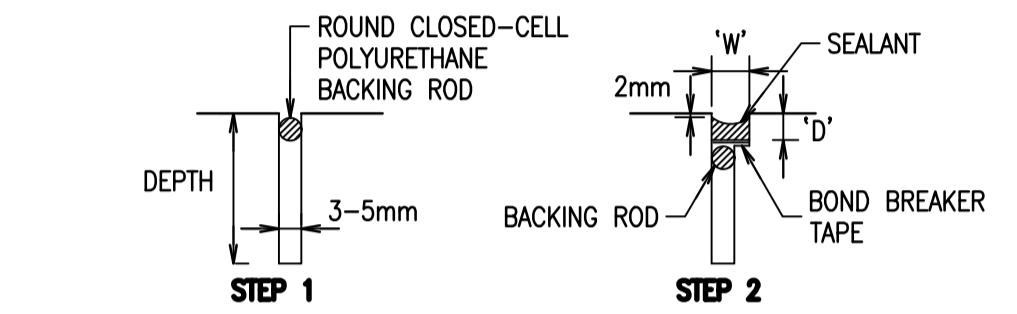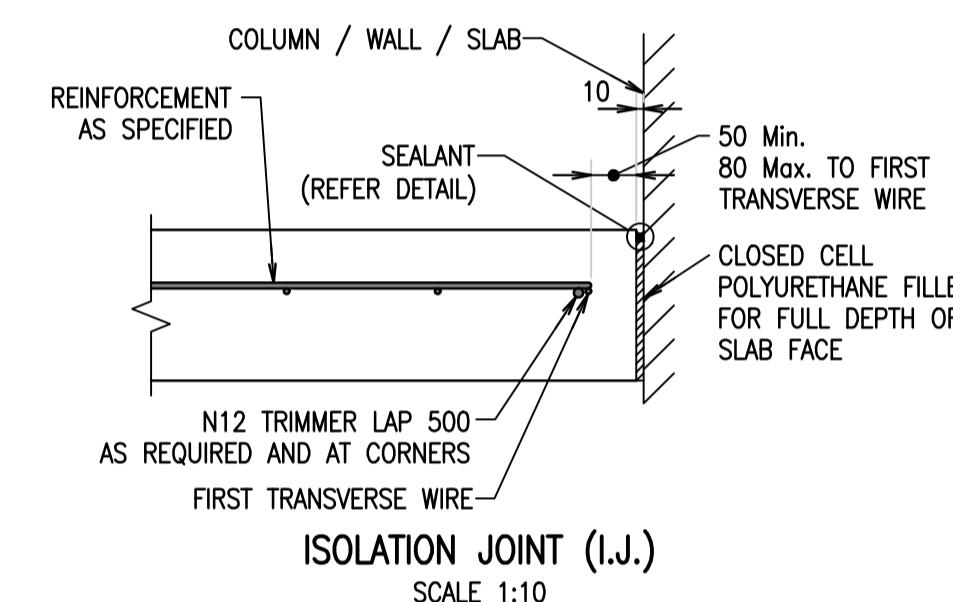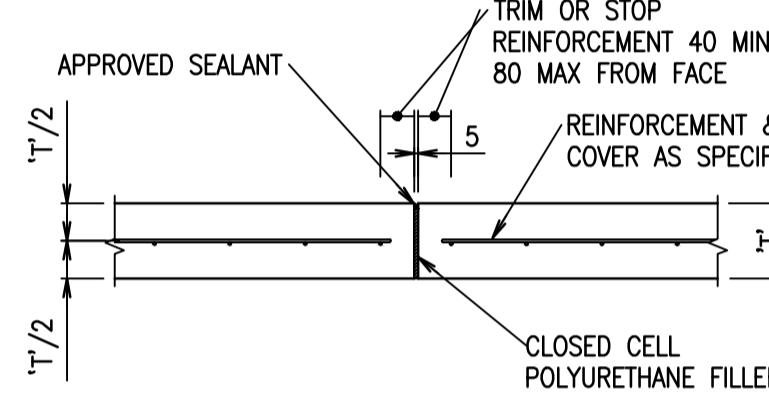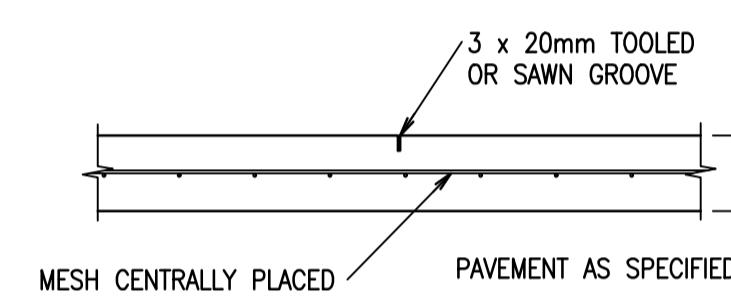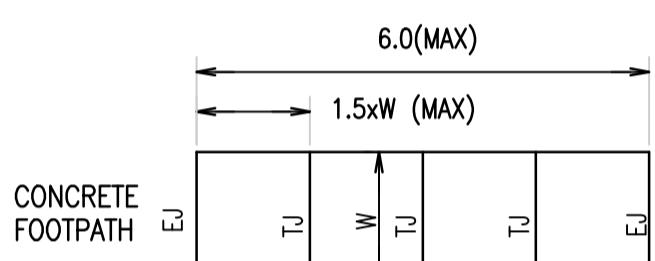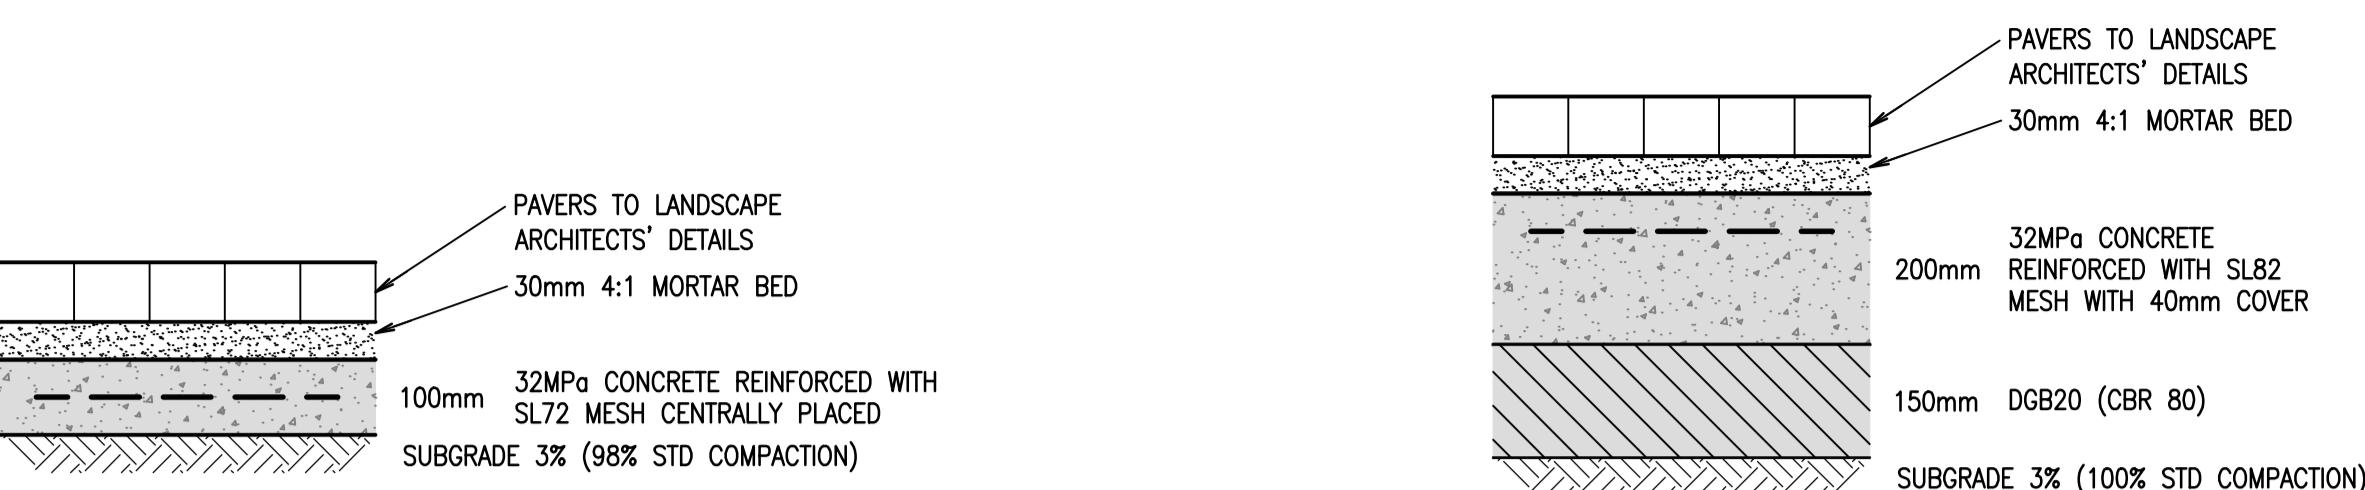



SEALANT DIMENSIONS		
MEAN SLAB LENGTH (m)	SEALANT WIDTH 'W' (mm)	SEALANT DEPTH 'D' (mm)
≤4	7 ± 1	7 ± 1
5	9 ± 2	7 ± 1
6	9 ± 2	7 ± 1
7	10 ± 2	8 ± 1
8	11 ± 2	9 ± 2
9	12 ± 2	10 ± 2
10	13 ± 2	10 ± 2
11	14 ± 2	11 ± 2
12	15 ± 2	12 ± 2
ALL (T.S.J.)	6	6
ALL (I.J. & E.J.)	10	8

NOTES:

1. FOR T.S.J. ONLY, CLEAN, PRIME AND SEAL INITIAL SAW CUT ONLY.

NOTES:


1. E.J.'S TO ALIGN WITH ADJOINING BAYS
2. JOINT SPACING AROUND CURVES IS TO BE TAKEN TO THE OUTSIDE LENGTH

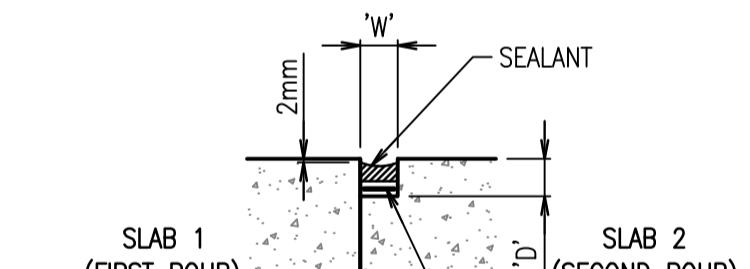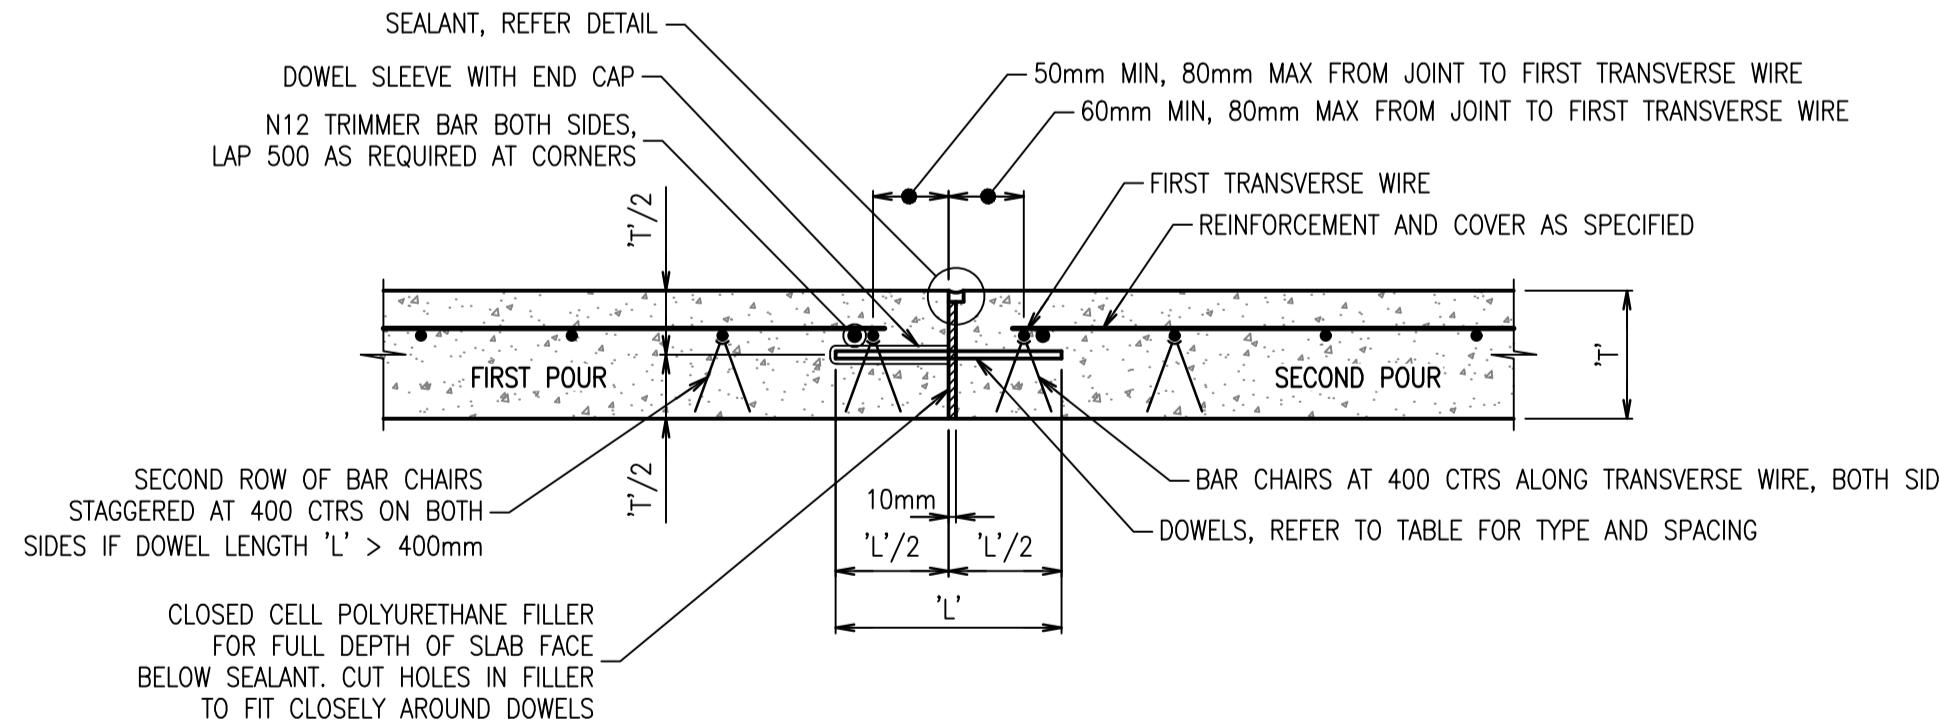

- ALTERNATIVE SEALANTS MUST HAVE**
- MOVEMENT ACCOMMODATION FACTOR +/- 50%
 - PRIMER TO MANUFACTURER'S SPECIFICATION
 - INSTALLATION TO MANUFACTURER'S RECOMMENDATIONS
 - PRIOR APPROVAL BY SUPERINTENDENT.

- STEPS:**
1. FORM REBATE IN SLAB 2 AGAINST FACE OF SLAB 1.
 2. AFTER SLAB CURING PERIOD (MIN. 28 DAYS) WASH OUT REBATE USING HIGH PRESSURE WATER. DRY USING HIGH PRESSURE COMPRESSED AIR AND ALLOW ADDITIONAL 16HRS TO DRY THOROUGHLY.
 3. INSTALL POLYETHYLENE BOND BREAKER TAPE FOR FULL WIDTH 'W'. FOR I.J. EJ AND DEJ JOINTS OMIT BOND BREAKER TAPE.
 4. PRIME FACES OF SIDES OF REBATE (REFER SEALANT TABLE)
 5. INSTALL SEALANT AS SPECIFIED (REFER SEALANT TABLE) IN ACCORDANCE WITH MANUFACTURER'S RECOMMENDATIONS.

DOWEL / TIE BAR TABLE			
JOINT DESIGNATION	DOWEL / TIE	SPACING CTR-CTR	LENGTH 'L'
DEJ	10x110 DANLEY DIAMOND	450	155

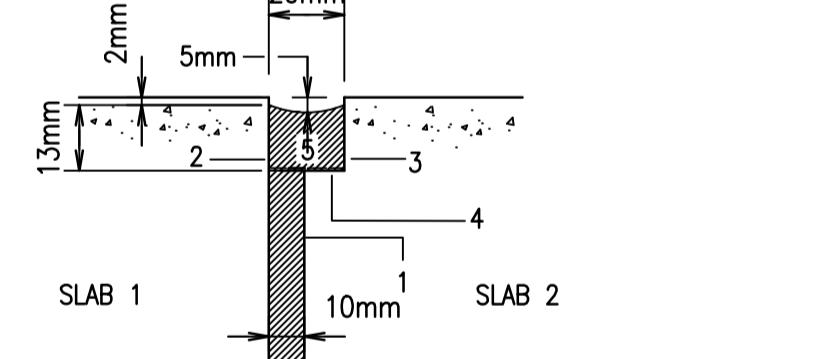

Rev Revision Description By App Date

1 ISSUED FOR DEVELOPMENT APPLICATION ZJ CR 04.03.19

2 ISSUED FOR DEVELOPMENT APPLICATION ZJ CR 03.04.19

Rev Revision Description By App Date

ZJ CR 03.04.19

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Client




Title
PAVEMENT DETAILS

Project
**2B-6 HASSALL STREET
PARRAMATTA**

Scale at A1
AS SHOWN
Drawn
S.MANANDHAR
Date
03.04.19
Designer
Z.JONES
Approved
C.ROPE
Job Number
18570C

Revision
2
Drawing Number
C-4-10
NOT FOR CONSTRUCTION

DO NOT SCALE DRAWINGS, USE FIGURED DIMENSIONS
REFER TO GENERAL NOTES UNLESS NOTED OTHERWISE

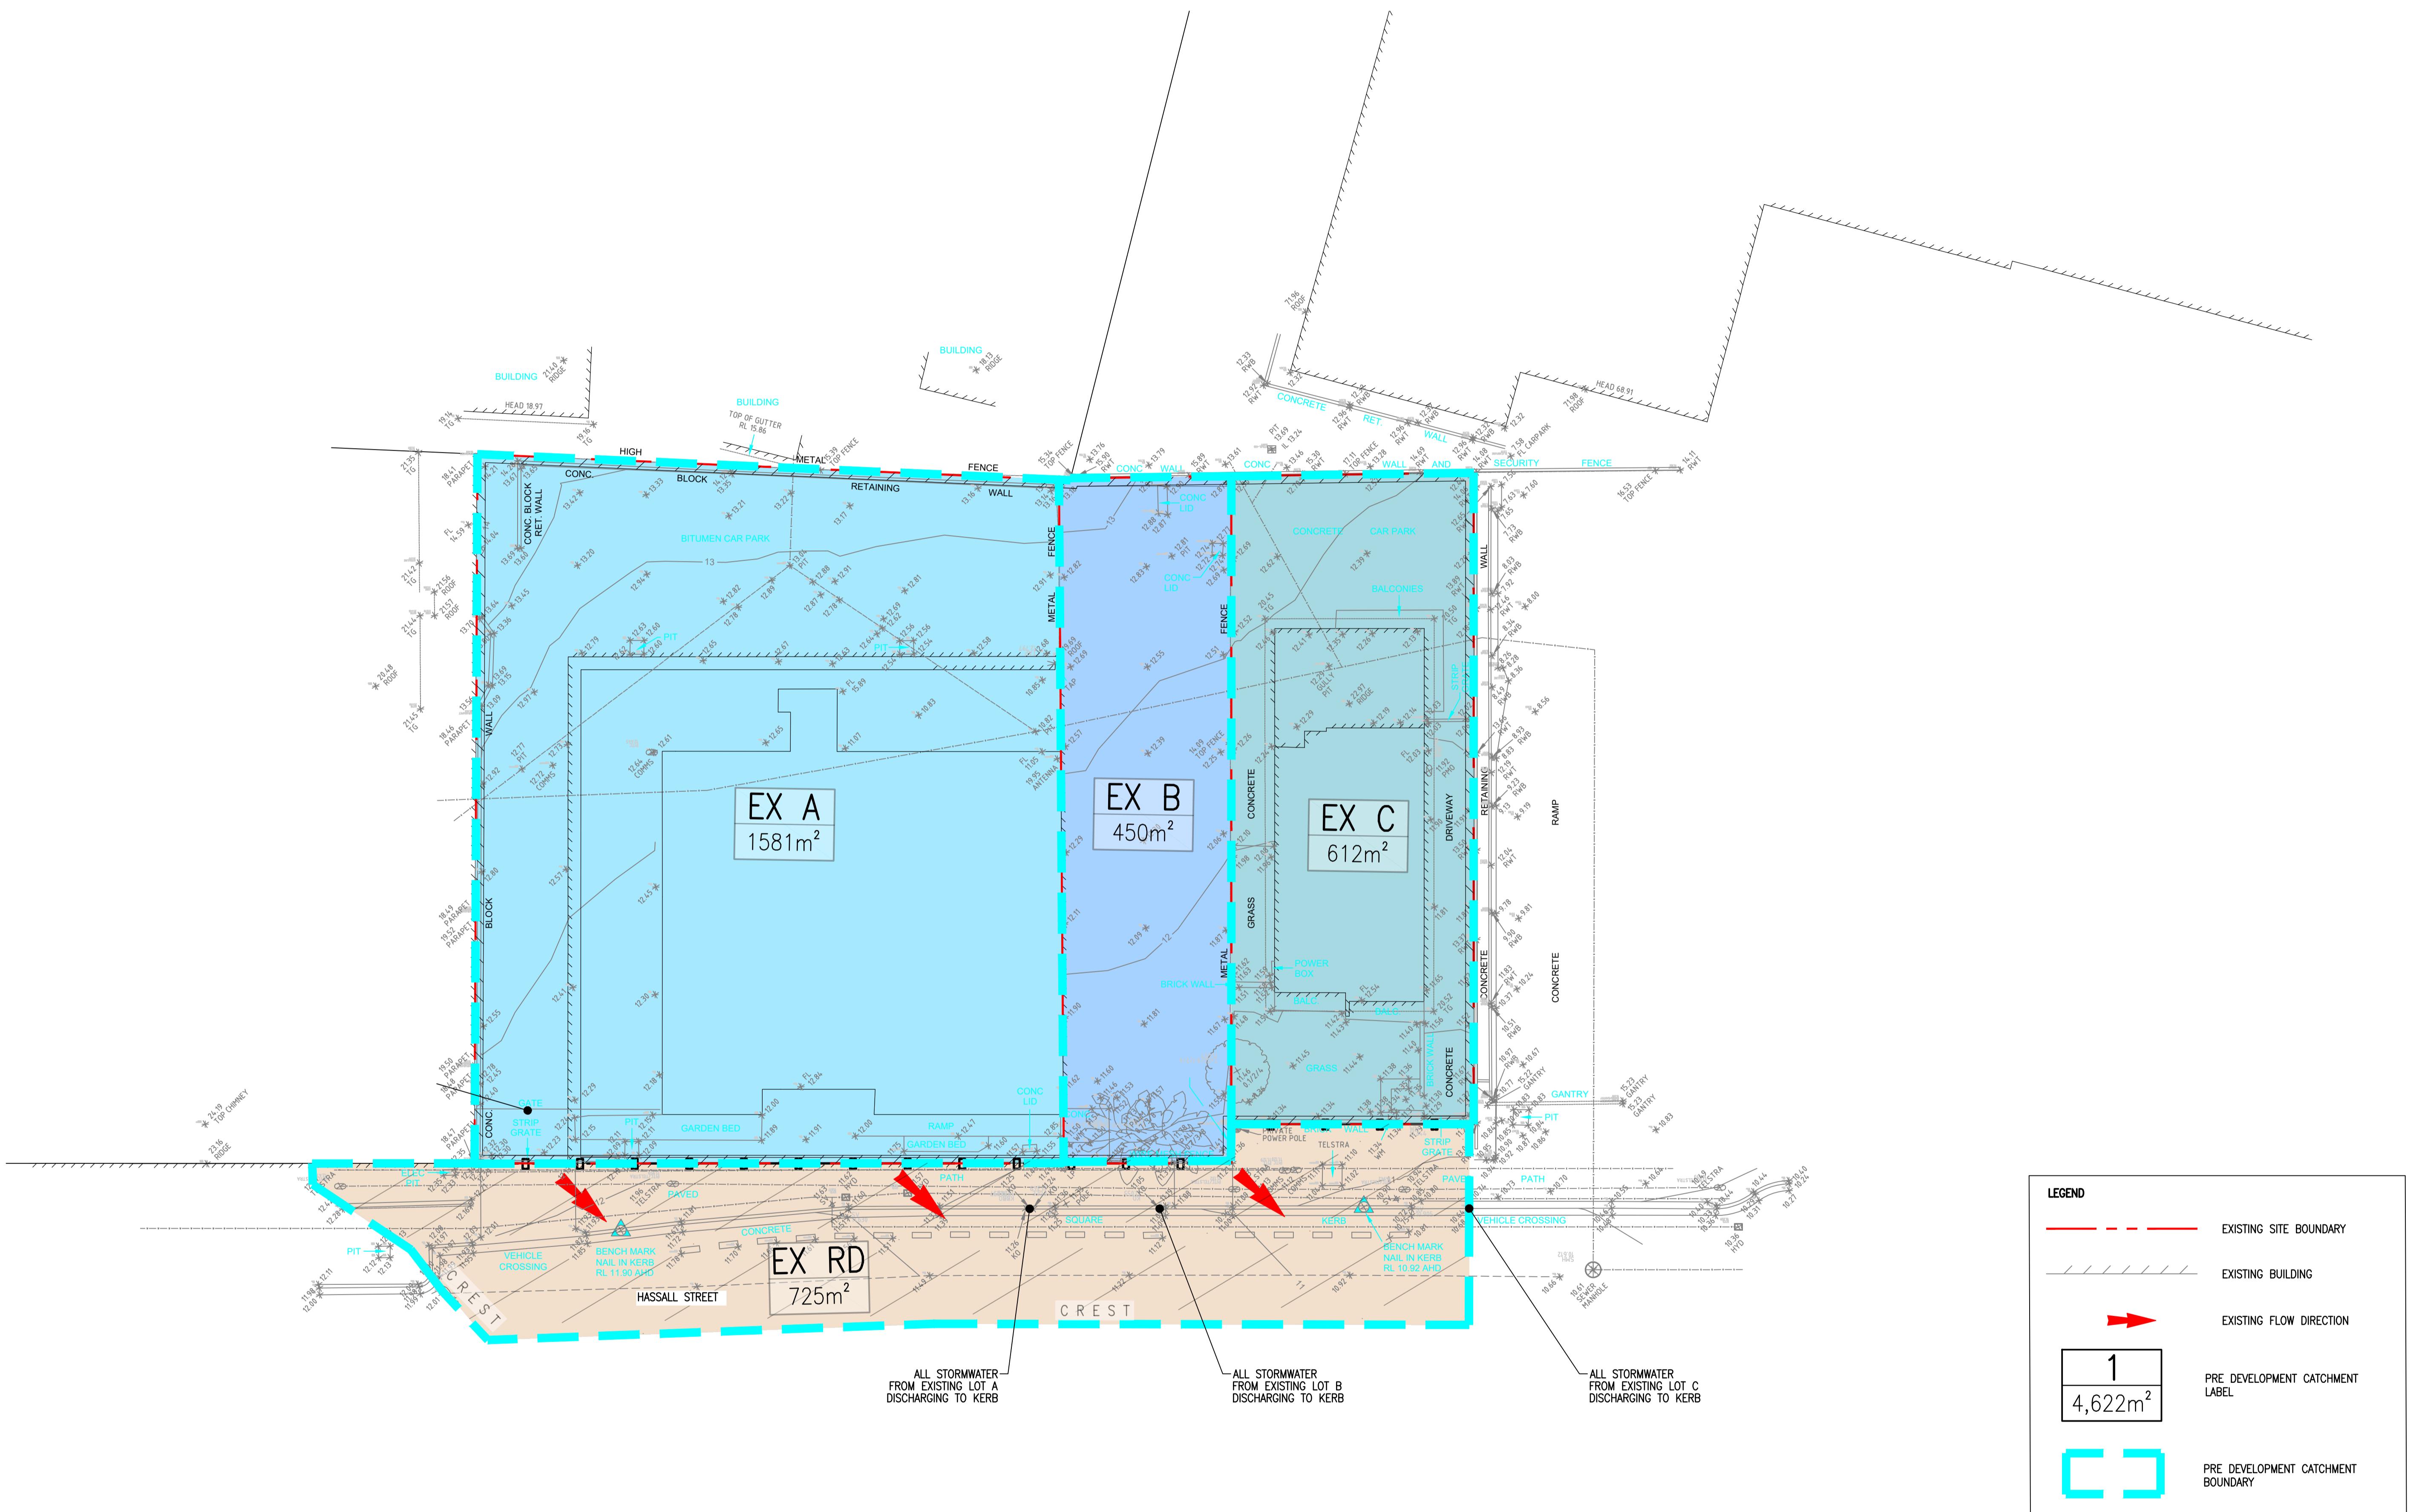

Rev Revision Description By App Date

1 ISSUED FOR DEVELOPMENT APPLICATION ZJ CR 04.03.19

Rev Revision Description By App Date

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ACN 010 500 246



Title
**STORMWATER PRE CATCHMENT
ANALYSIS**

Project
**2B-6 HASSALL STREET
PARRAMATTA**

Scale at A1
AS SHOWN
Date
04.03.19

Drawn
Z.JONES
Designer
C.Rope



Approved
Z.JONES
Job Number
18570C

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Drawing Number
C-6-50

Revision
1

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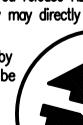


HASSALL STREET

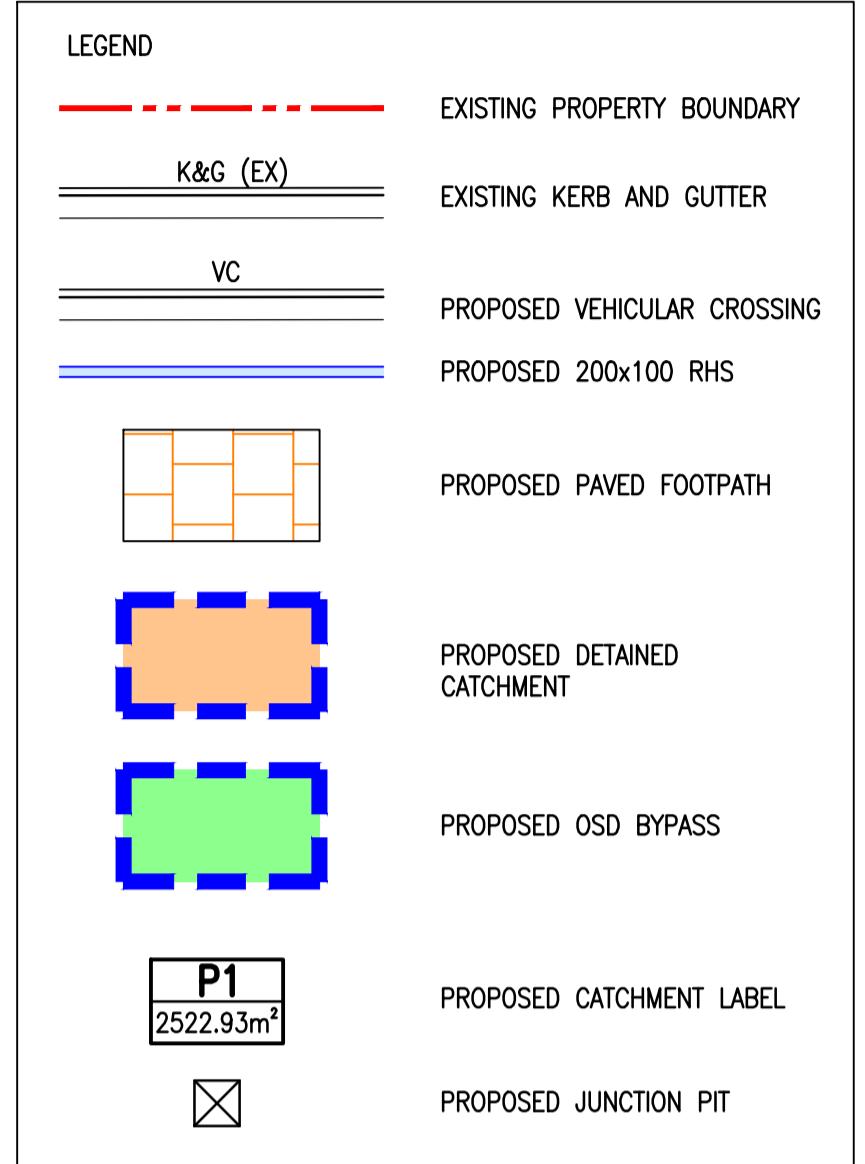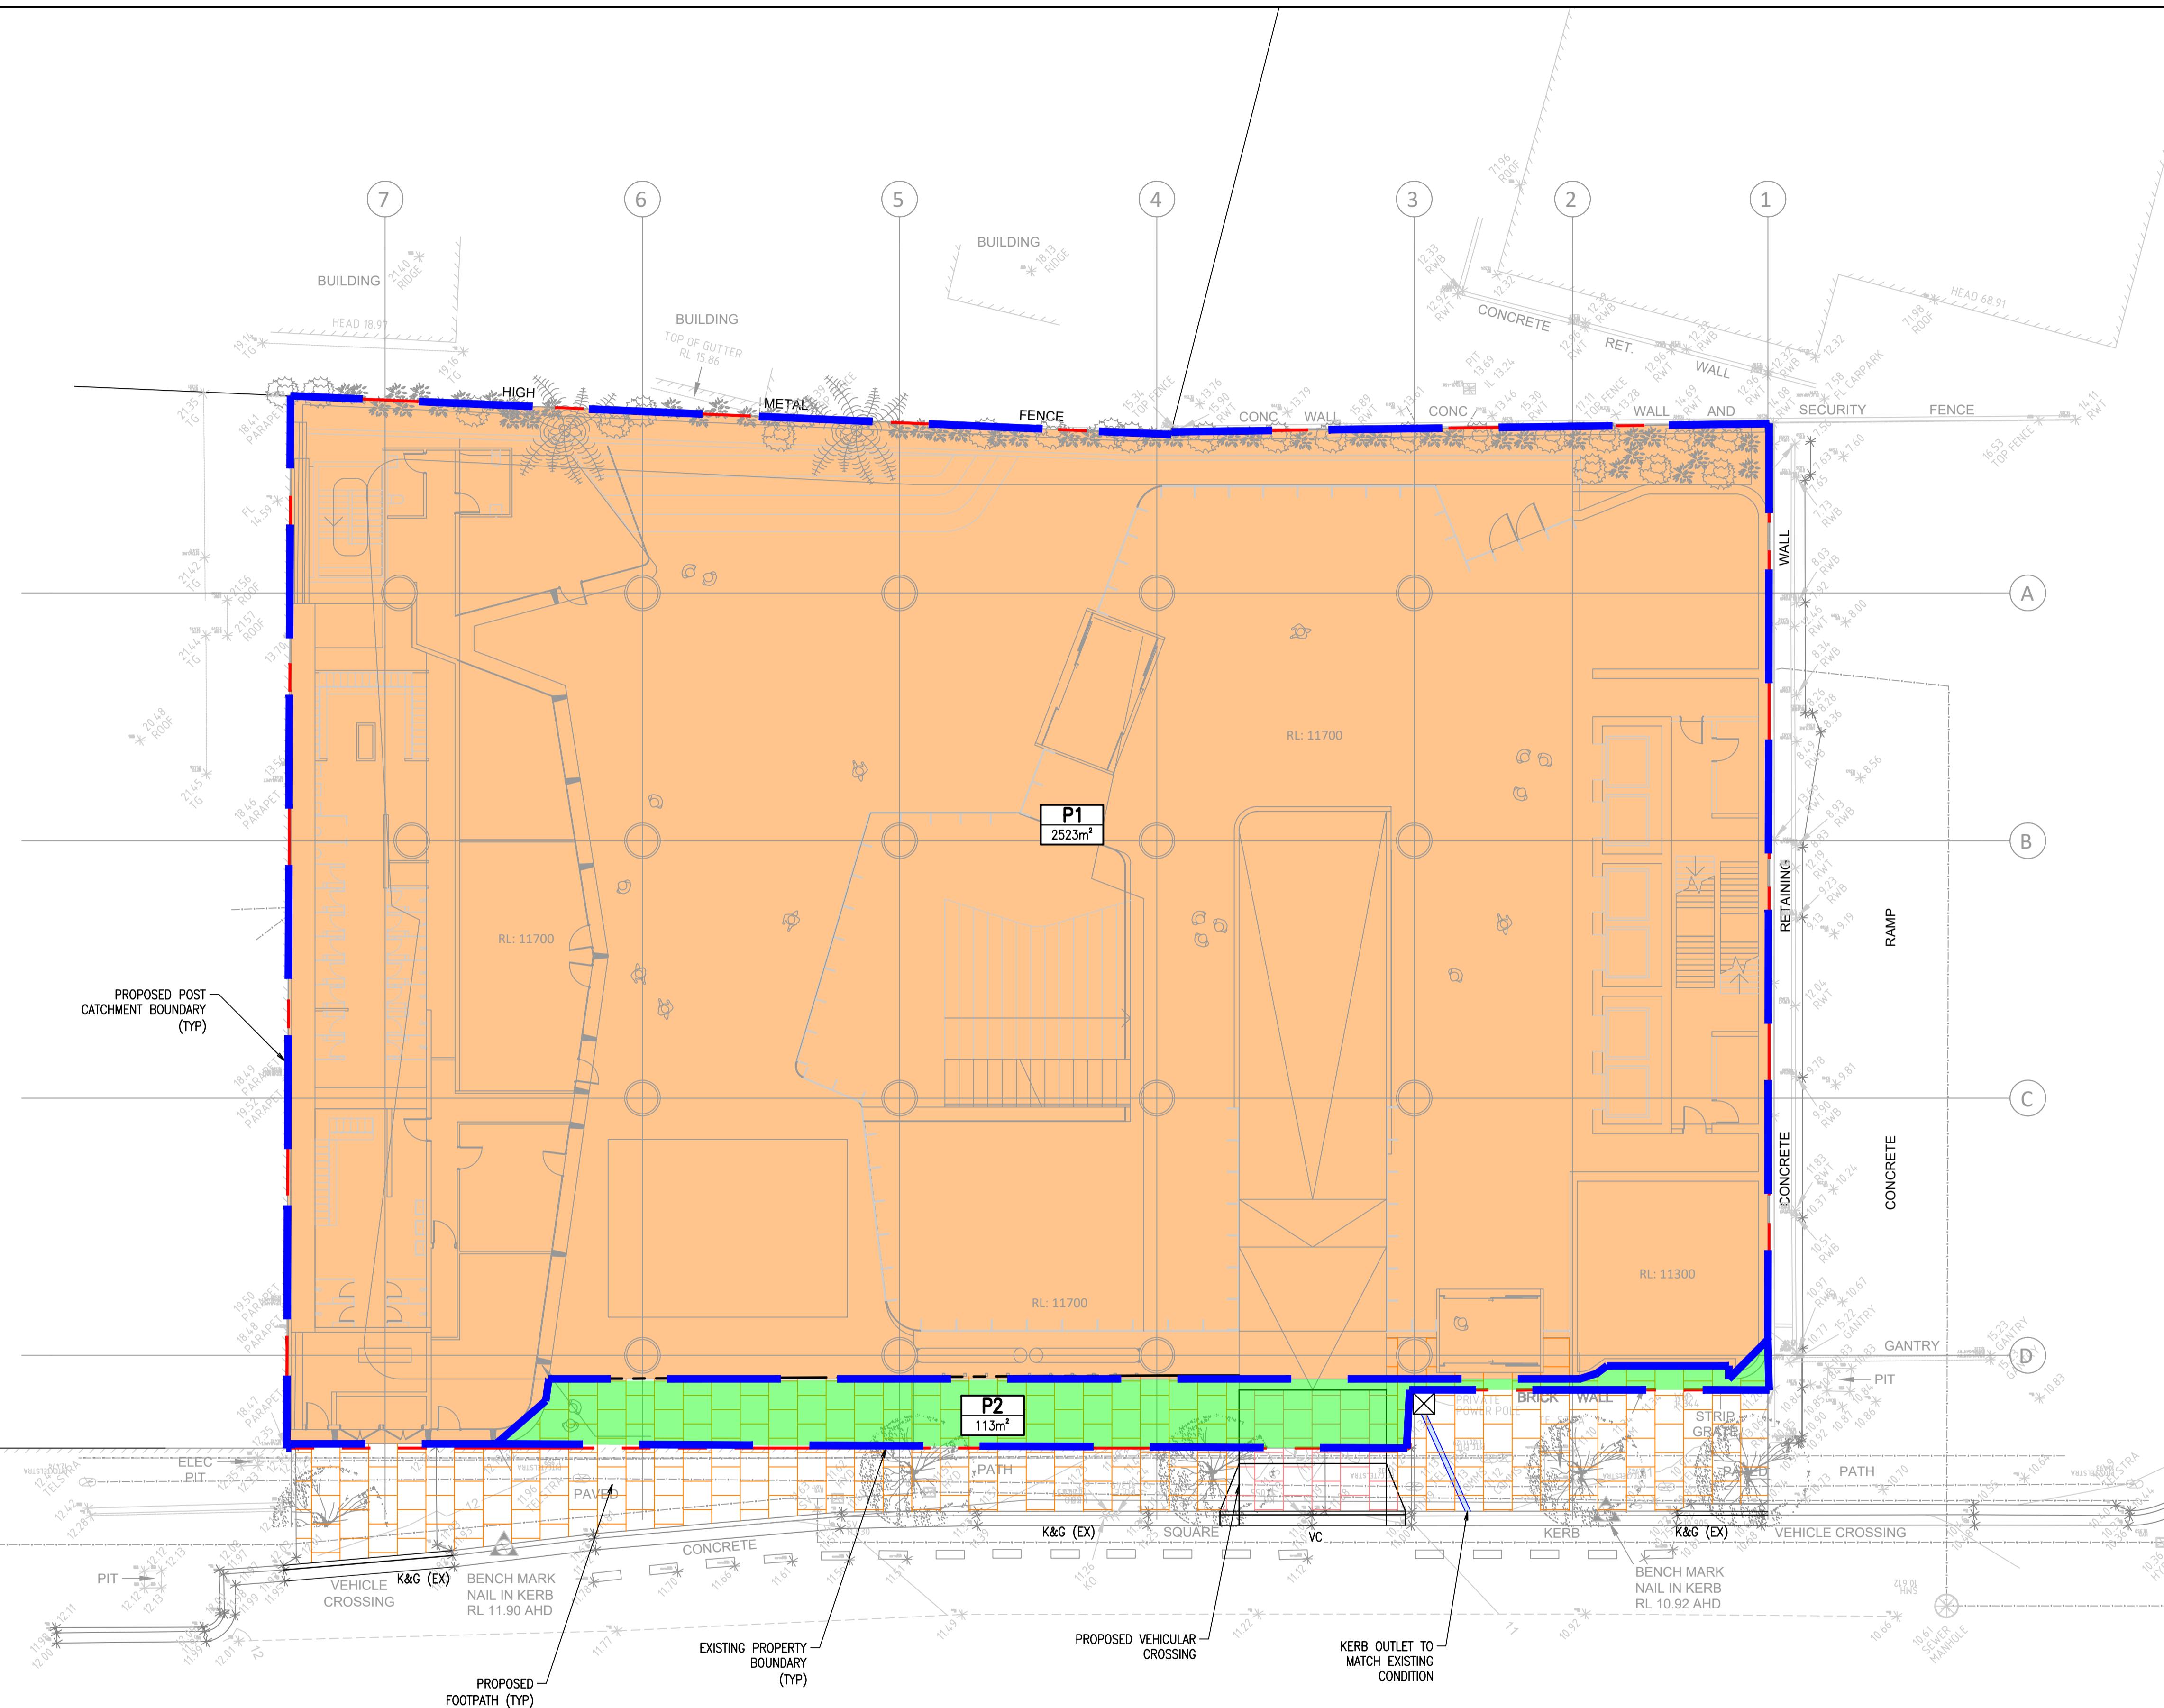A scale bar diagram for a 1:150 scale drawing. The top part shows a horizontal line divided into 15 equal segments, labeled "SCALE 1:150". Below this, a longer horizontal line is divided into four segments by tick marks. The first segment is shaded grey and contains the number "0". The second segment is also shaded grey and contains the number "2". The third segment is white and contains the number "4". The fourth segment is shaded grey and contains the number "6". To the right of the fourth segment, the label "8m" is written, indicating the total length represented by the scale bar.

Rev	Revision Description
1	ISSUED FOR DEVELOPMENT APPLICATION

By	App	Date	Rev	Revision	Description
ZJ	CR	04.03.19			

By	App	Date
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Title

STORMWATER POST CATCHMENT ANALYSIS

Project

NOT FOR CONSTRUCTION

Appendix C

Floth OSD and WSUD Drawings



2-6 HASSALL STREET, PARRAMATTA



LOCATION PLAN

HYDRAULIC LEGEND:

STORMWATER

STORMWATER DRAINAGE		SW
OVERFLOW		OF
SUB SOIL DRAINAGE		

PUMPED SERVICES

PUMP DISCHARGE		PD
----------------	--	----

MISCELLANEOUS

ELECTRICAL		E
------------	--	---

SYMBOLS

	PIPE RISER
	PIPE DROPPER
	HEEL GUARD GRATED ACCESS COVER & FRAME
	GRATED ACCESS COVER & FRAME
	AIRTIGHT ACCESS COVER & FRAME
	GRATED DRAIN
	CONTROL PANEL

REFER TO DRAWING DA## CONTINUED ON DRAWING No.

	CONTINUED ON DRAWING No.
	RAINWATER OUTLET
	PLANTER DRAIN
	CLEAROUT
	INSPECTION OPENING
	OVERFLOW
	NON-RETURN VALVE
	SUMP DRAIN
	SERVICE PIPE SIZE

ABBREVIATIONS


AHD	AUSTRALIAN HEIGHT DATUM
EX	EXISTING
CP	CONTROL PANEL
CI	CAST IRON
CO	CLEAROUT
DN	DIMENSION NOMINAL
DP	DOWN PIPE
FFL	FINISHED FLOOR LEVEL
H/L	HIGH LEVEL
IL	INVERT LEVEL
KIP	KERB INLET PIT
L/L	LOW LEVEL
OF	OVERFLOW
OFG	OVERFLOW GULLY
PD	PLANTER DRAIN
RL	REDUCED LEVEL
RWO	RAINWATER OUTLET
SYP	SYPHONIC DRAINAGE
U/S	UNDERSIDE

DRAWING SCHEDULE

DRAWING NO.	DRAWING TITLE
DA-H01	LEGEND & DRAWING SCHEDULE
DA-H02	SITE PLAN
DA-H03	BASEMENT LEVEL STORMWATER SERVICES
DA-H04	GROUND LEVEL STORMWATER SERVICES
DA-H05	LEVEL 1 STORMWATER SERVICES
DA-H06	DETAILSHEET 1
DA-H07	DETAILSHEET 2



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E: tzannes@tzannes.com.au

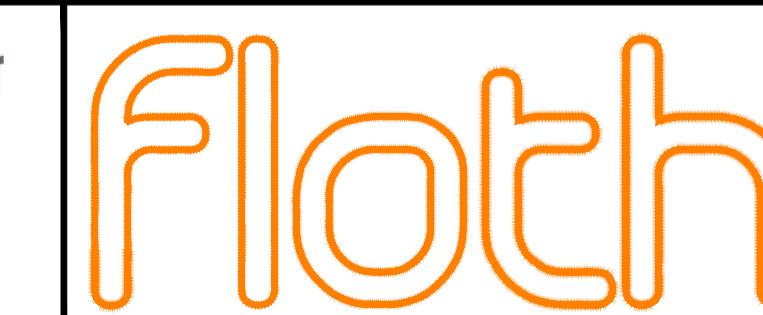


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PROJECT
HASSALL STREET, PARRAMATTA
2-6 HASSALL STREET,
PARRAMATTA NSW 2150

SERVICE
STORMWATER CONCEPT PLAN
DRAWING TITLE
LEGEND AND DRAWING SCHEDULE

DR JB
CHECKED DATE STARTED
SO MARCH 2019
DRAWING SCALE
NTS @ A1
PROJECT NO. DRAWING NO.
S18255 DA-H01 P1
REVISION

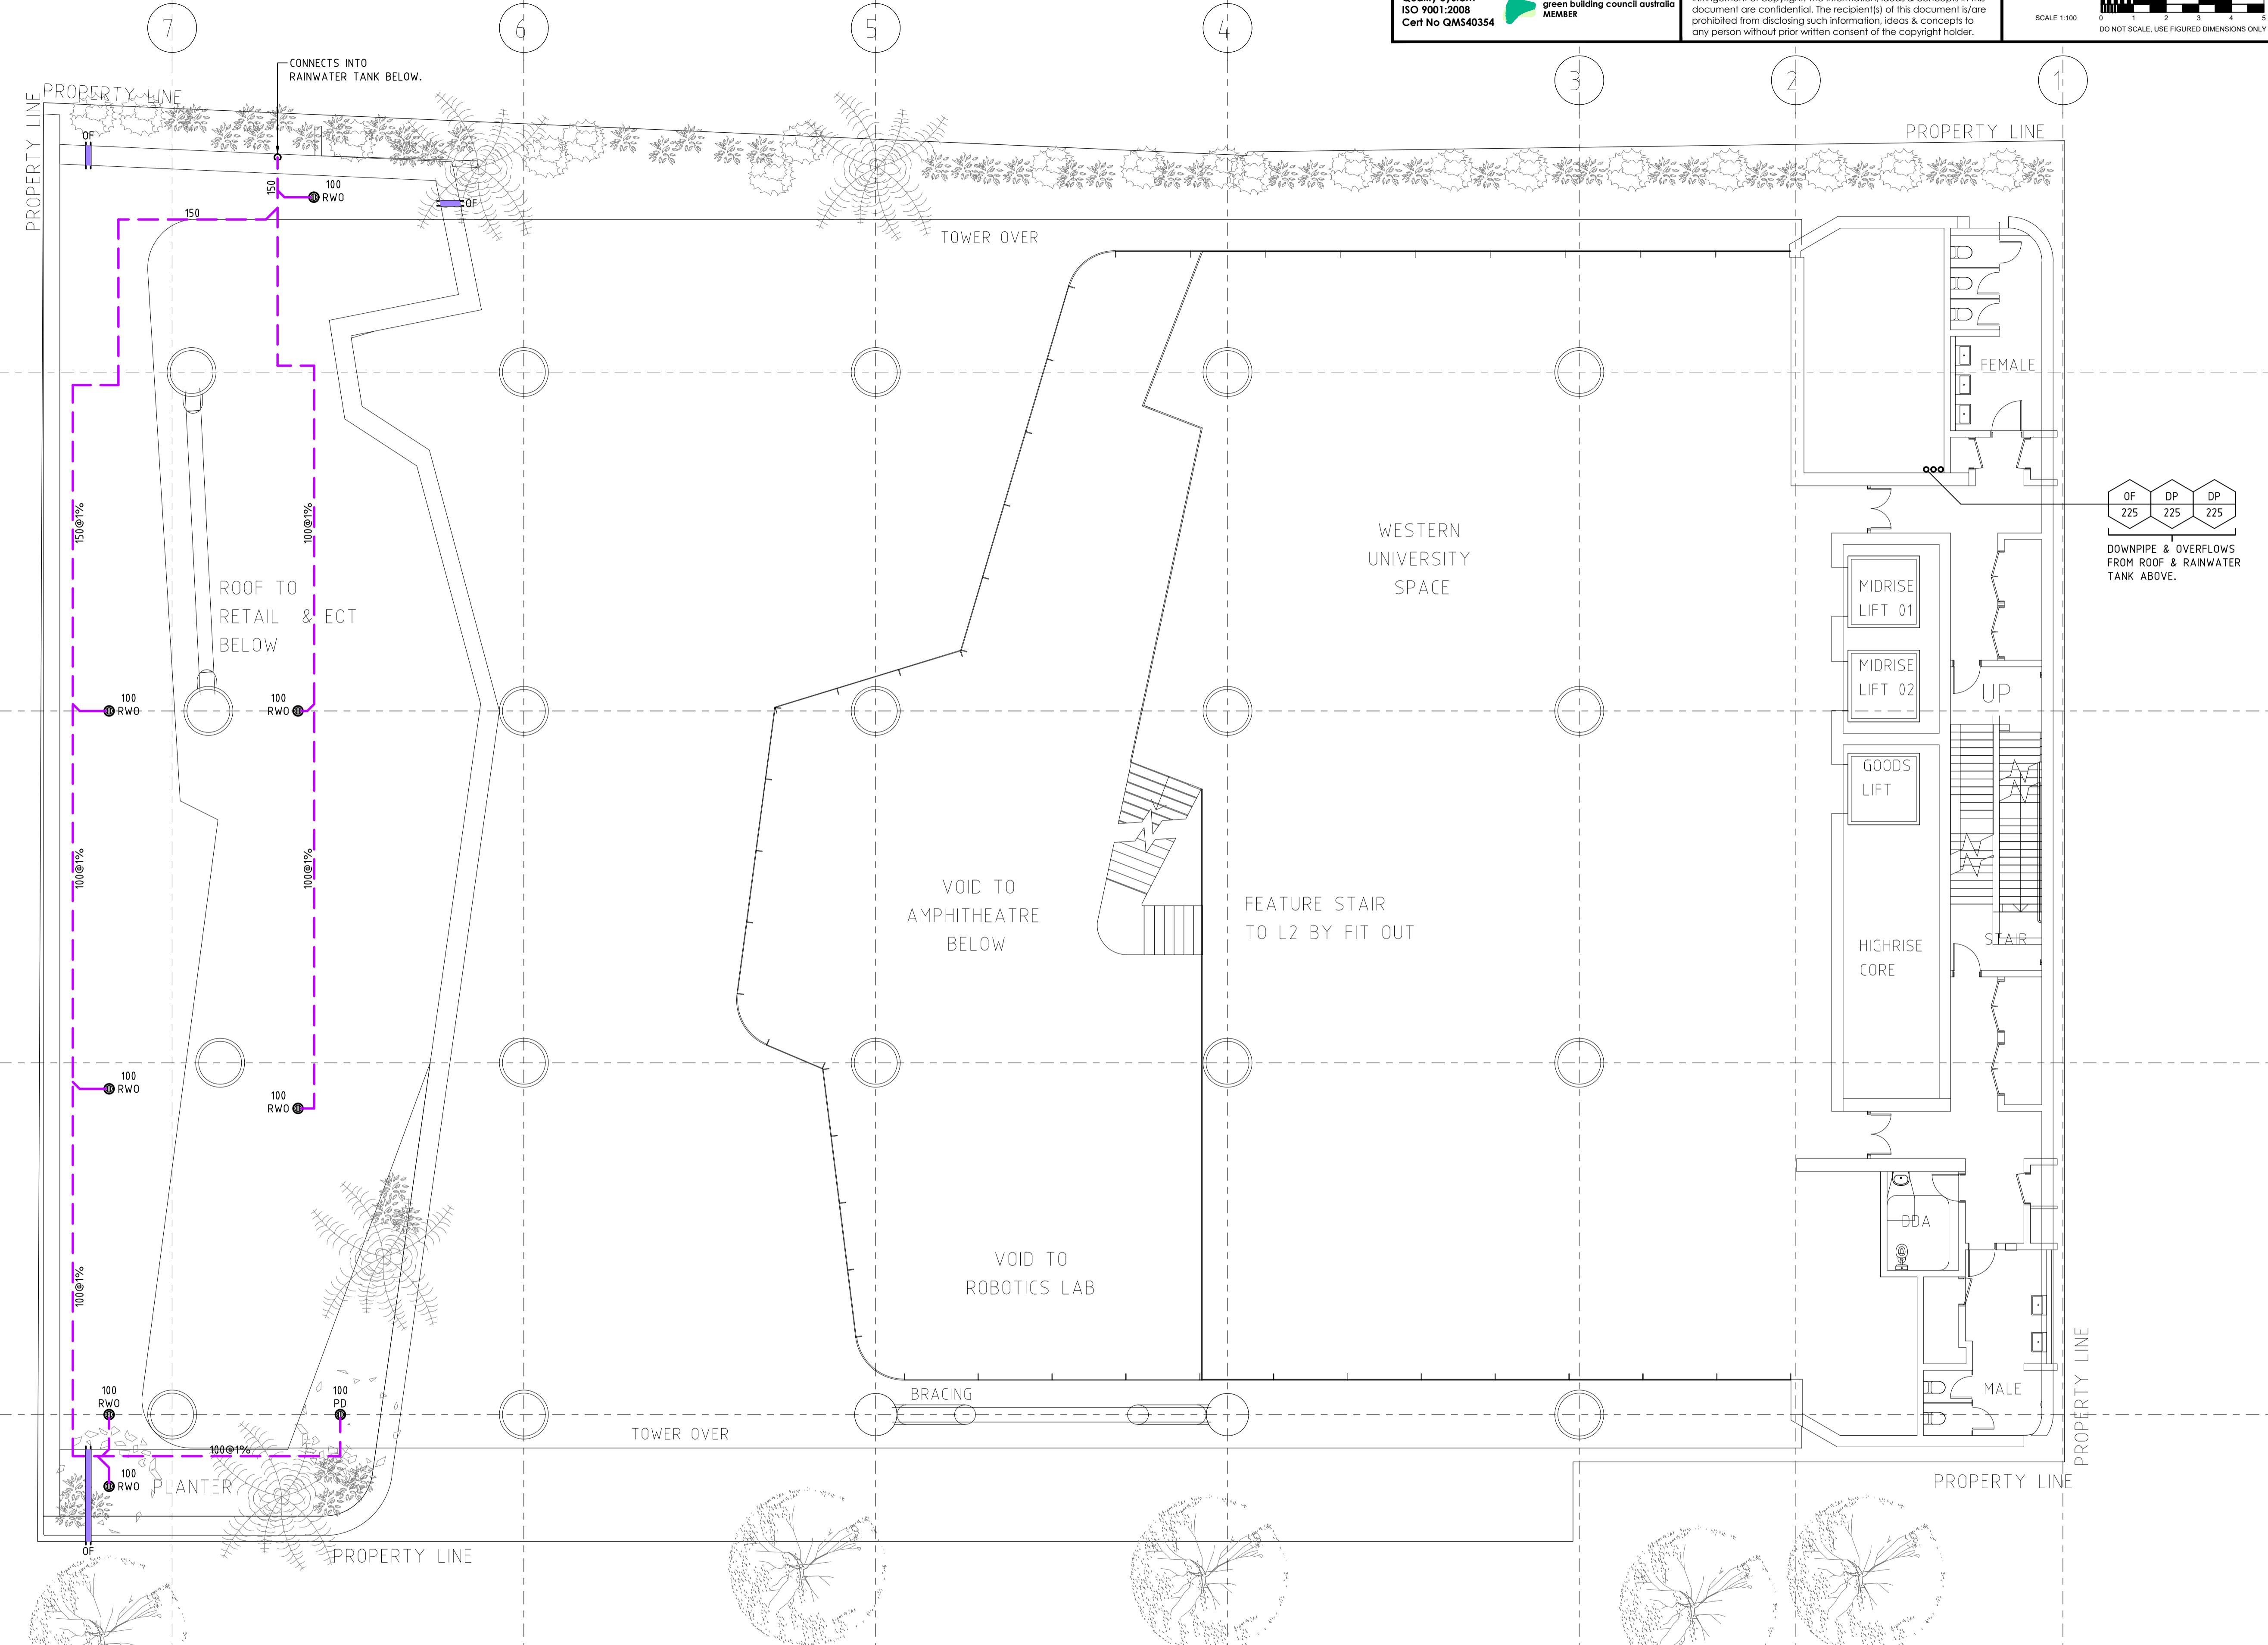

REVISION					
P1	27.03.2019	DR	JB	DA	ISSUE
REV	DATE	DRN	CHD	DESCRIPTION	

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**HASSALL STREET, PARRAMATTA
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PARRAMATTA NSW 2150**


STORMWATER CONCEPT PLAN

DRAWING TITLE ━━━━━━


LEVEL 1

STORMWATER SERVICES

DR JB
CHECKED ————— DATE STARTED —————
SO MARCH 2019
DRAWING SCALE —————
1:100 @ A1
PROJECT No ————— DRAWING No ————— REVISION
S18255 DA-H05 P1

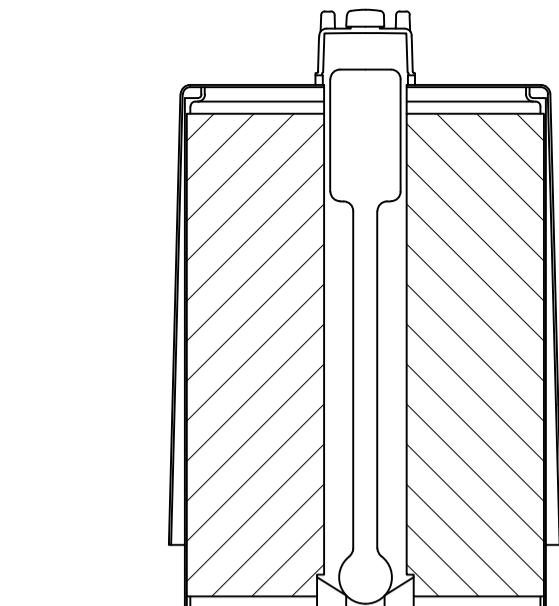


STORMFILTER CARTRIDGE FILTRATION UNIT. FRONT ELEVATION SIDE ELEVATION

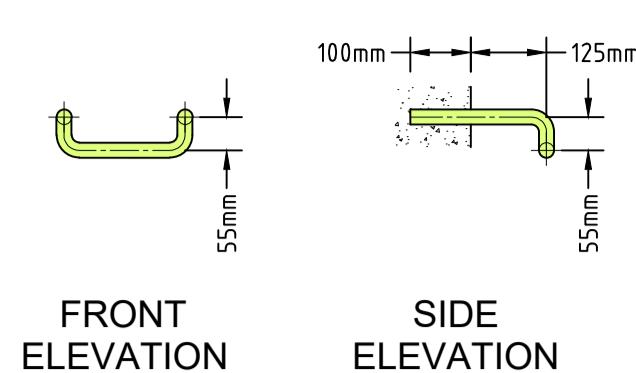


STORMFILTER CARTRIDGE DETAIL

TYPICAL STEEL IRONS DETAIL

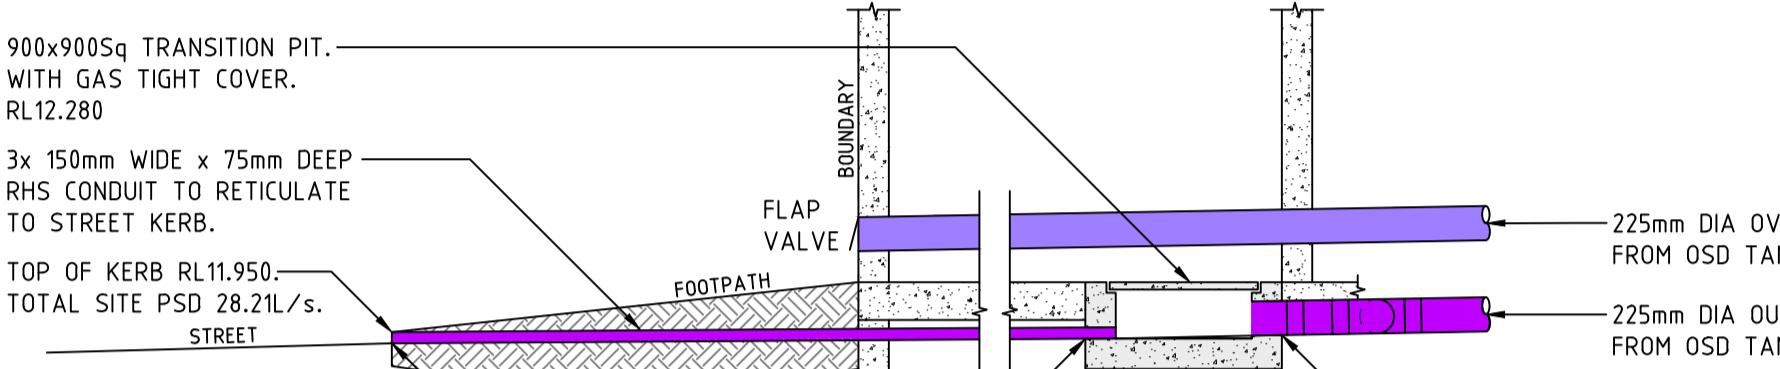

KERB & TRANSITION PIT SECTION

OSD TANK SECTION A-A

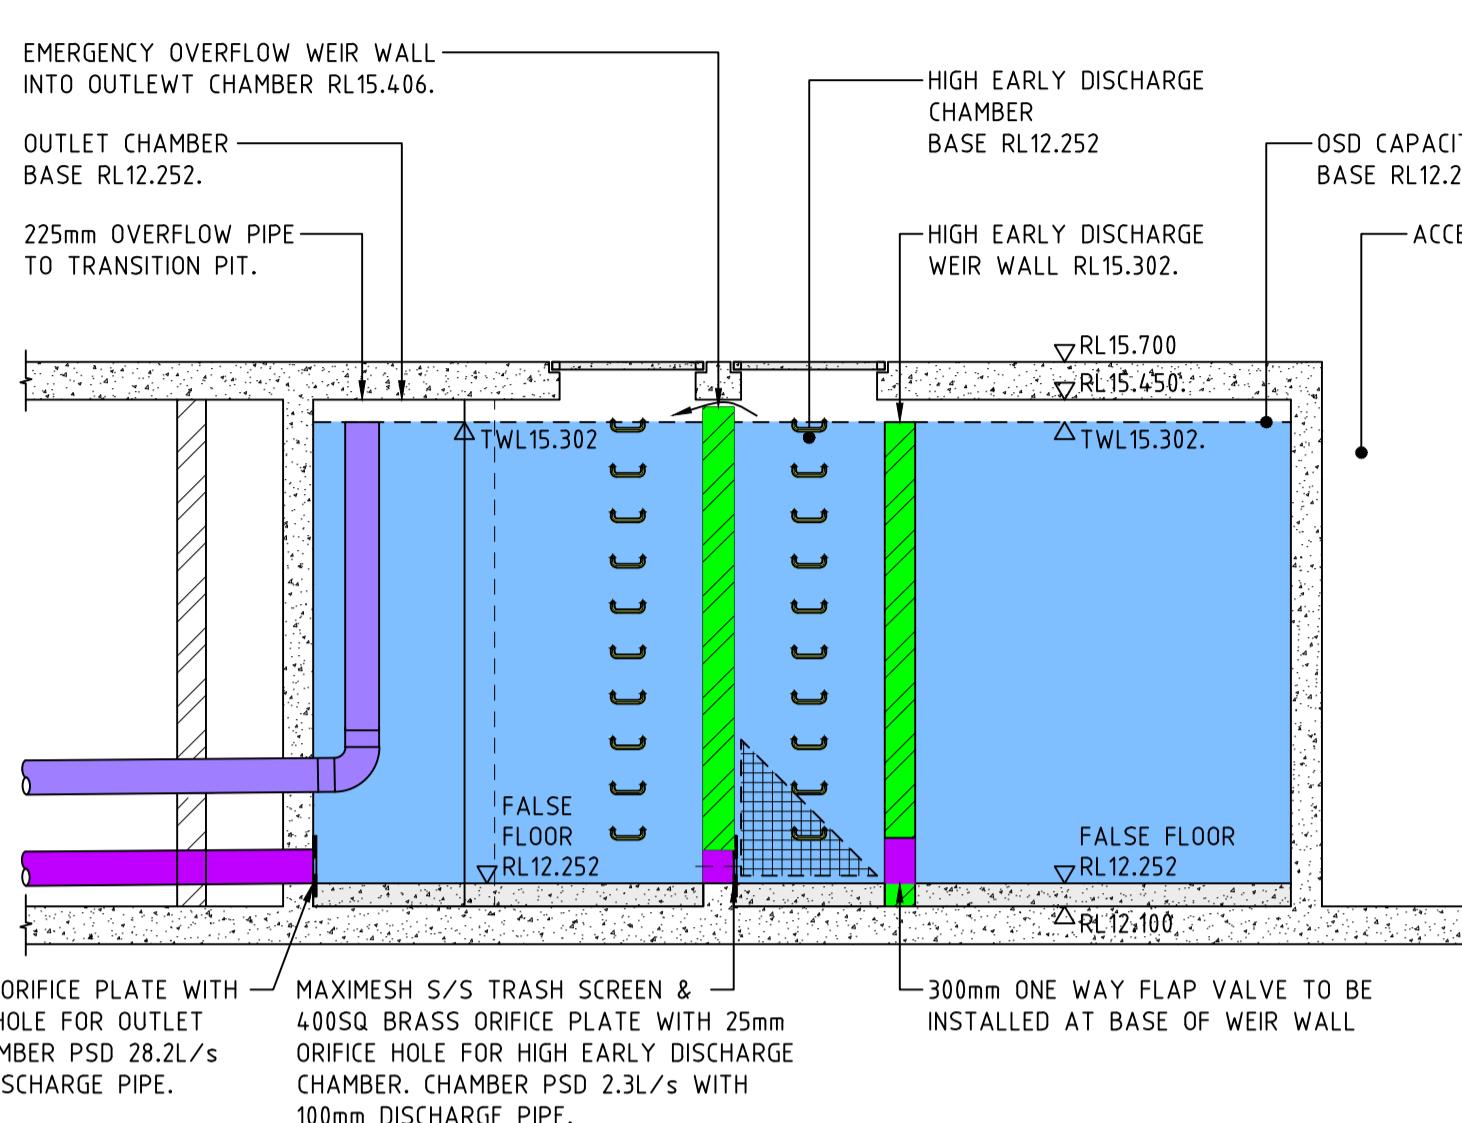

The diagram illustrates a cross-section of a stormwater treatment facility. On the left, a 'WATER QUALITY CONTROL CHAMBER' is shown with a 'FALSE FLOOR RL12.402'. Three grey rectangular components are positioned on this floor at elevation RL12.252. To the right, an 'OUTLET CHAMBER' is described as being 'BEHIND WATER CONTROL CHAMBER.' It features a 'MAXIMESH S/S TRASH SCREEN & 400SQ BRASS ORIFICE PLATE WITH 99mm ORIFICE HOLE FOR OUTLET CHAMBER. CHAMBER PSD 30.5L/s WITH 225mm DISCHARGE PIPE.' The outlet chamber has a 'FALSE FLOOR RL12.252' at elevation RL12.100. Above the outlet chamber is a 'HIGH FLOW BYPASS CHAMBER' with a 'FALSE FLOOR RL12.552' at elevation RL12.252. A 'WEIR WALL RL15.202' is located between the outlet chamber and the bypass chamber. The bypass chamber has a 'HIGH FLOW BYPASS WEIR WALL RL15.202.' The top of the bypass chamber is at elevation RL15.700. An 'OSD CAPACITY' is indicated on the far right. A vertical line labeled 'A' is also present.

WATER QUALITY CONTROL CHAMBER
BASE RL12.252
FALSE FLOOR RL12.402

OUTLET CHAMBER
BASE RL12.100
BEHIND WATER CONTROL CHAMBER.

FALSE FLOOR RL12.402
△ RL12.252

STORMFILTER CARTRIDGE
REFER TO DETAIL.

HIGH FLOW BYPASS CHAMBER
BASE RL12.252
FALSE FLOOR RL12.552

HIGH FLOW BYPASS WEIR WALL RL15.202.
△ RL15.700


△ TWL15.302

OSD

FALSE FLOOR RL12.252
△ RL12.100

MAXIMESH S/S TRASH SCREEN &
400SQ BRASS ORIFICE PLATE WITH
99mm ORIFICE HOLE FOR OUTLET
CHAMBER. CHAMBER PSD 30.5L/s
WITH 225mm DISCHARGE PIPE.


A

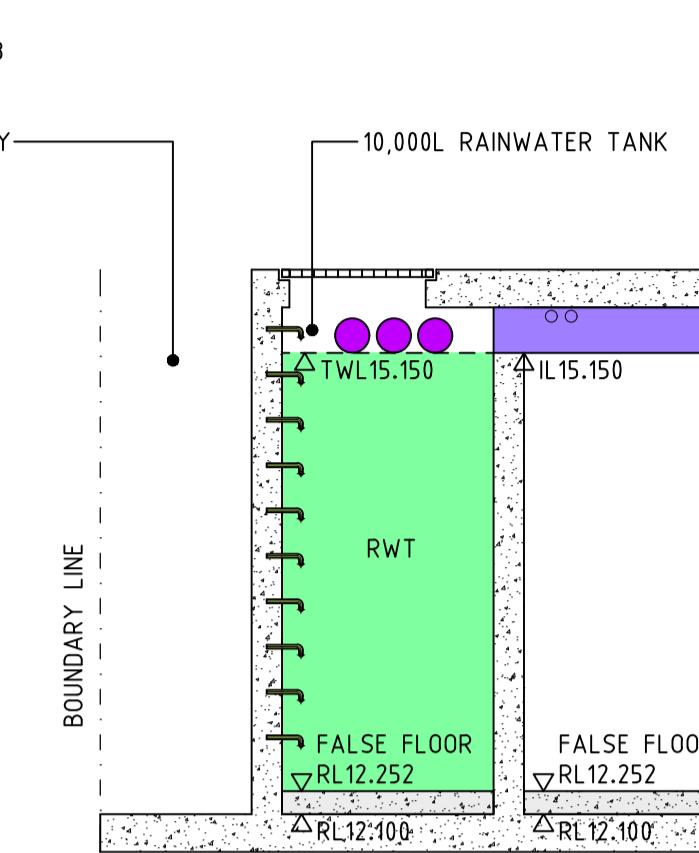


OSD TANK SECTION C-C

NOTE:

- RAINWATER TANK RE-USE IS TO BE PROVIDED FOR;
 - WC FLUSHING,
 - MECHANICAL COOLING TOWERS,
 - LANDSCAPE & IRRIGATION.

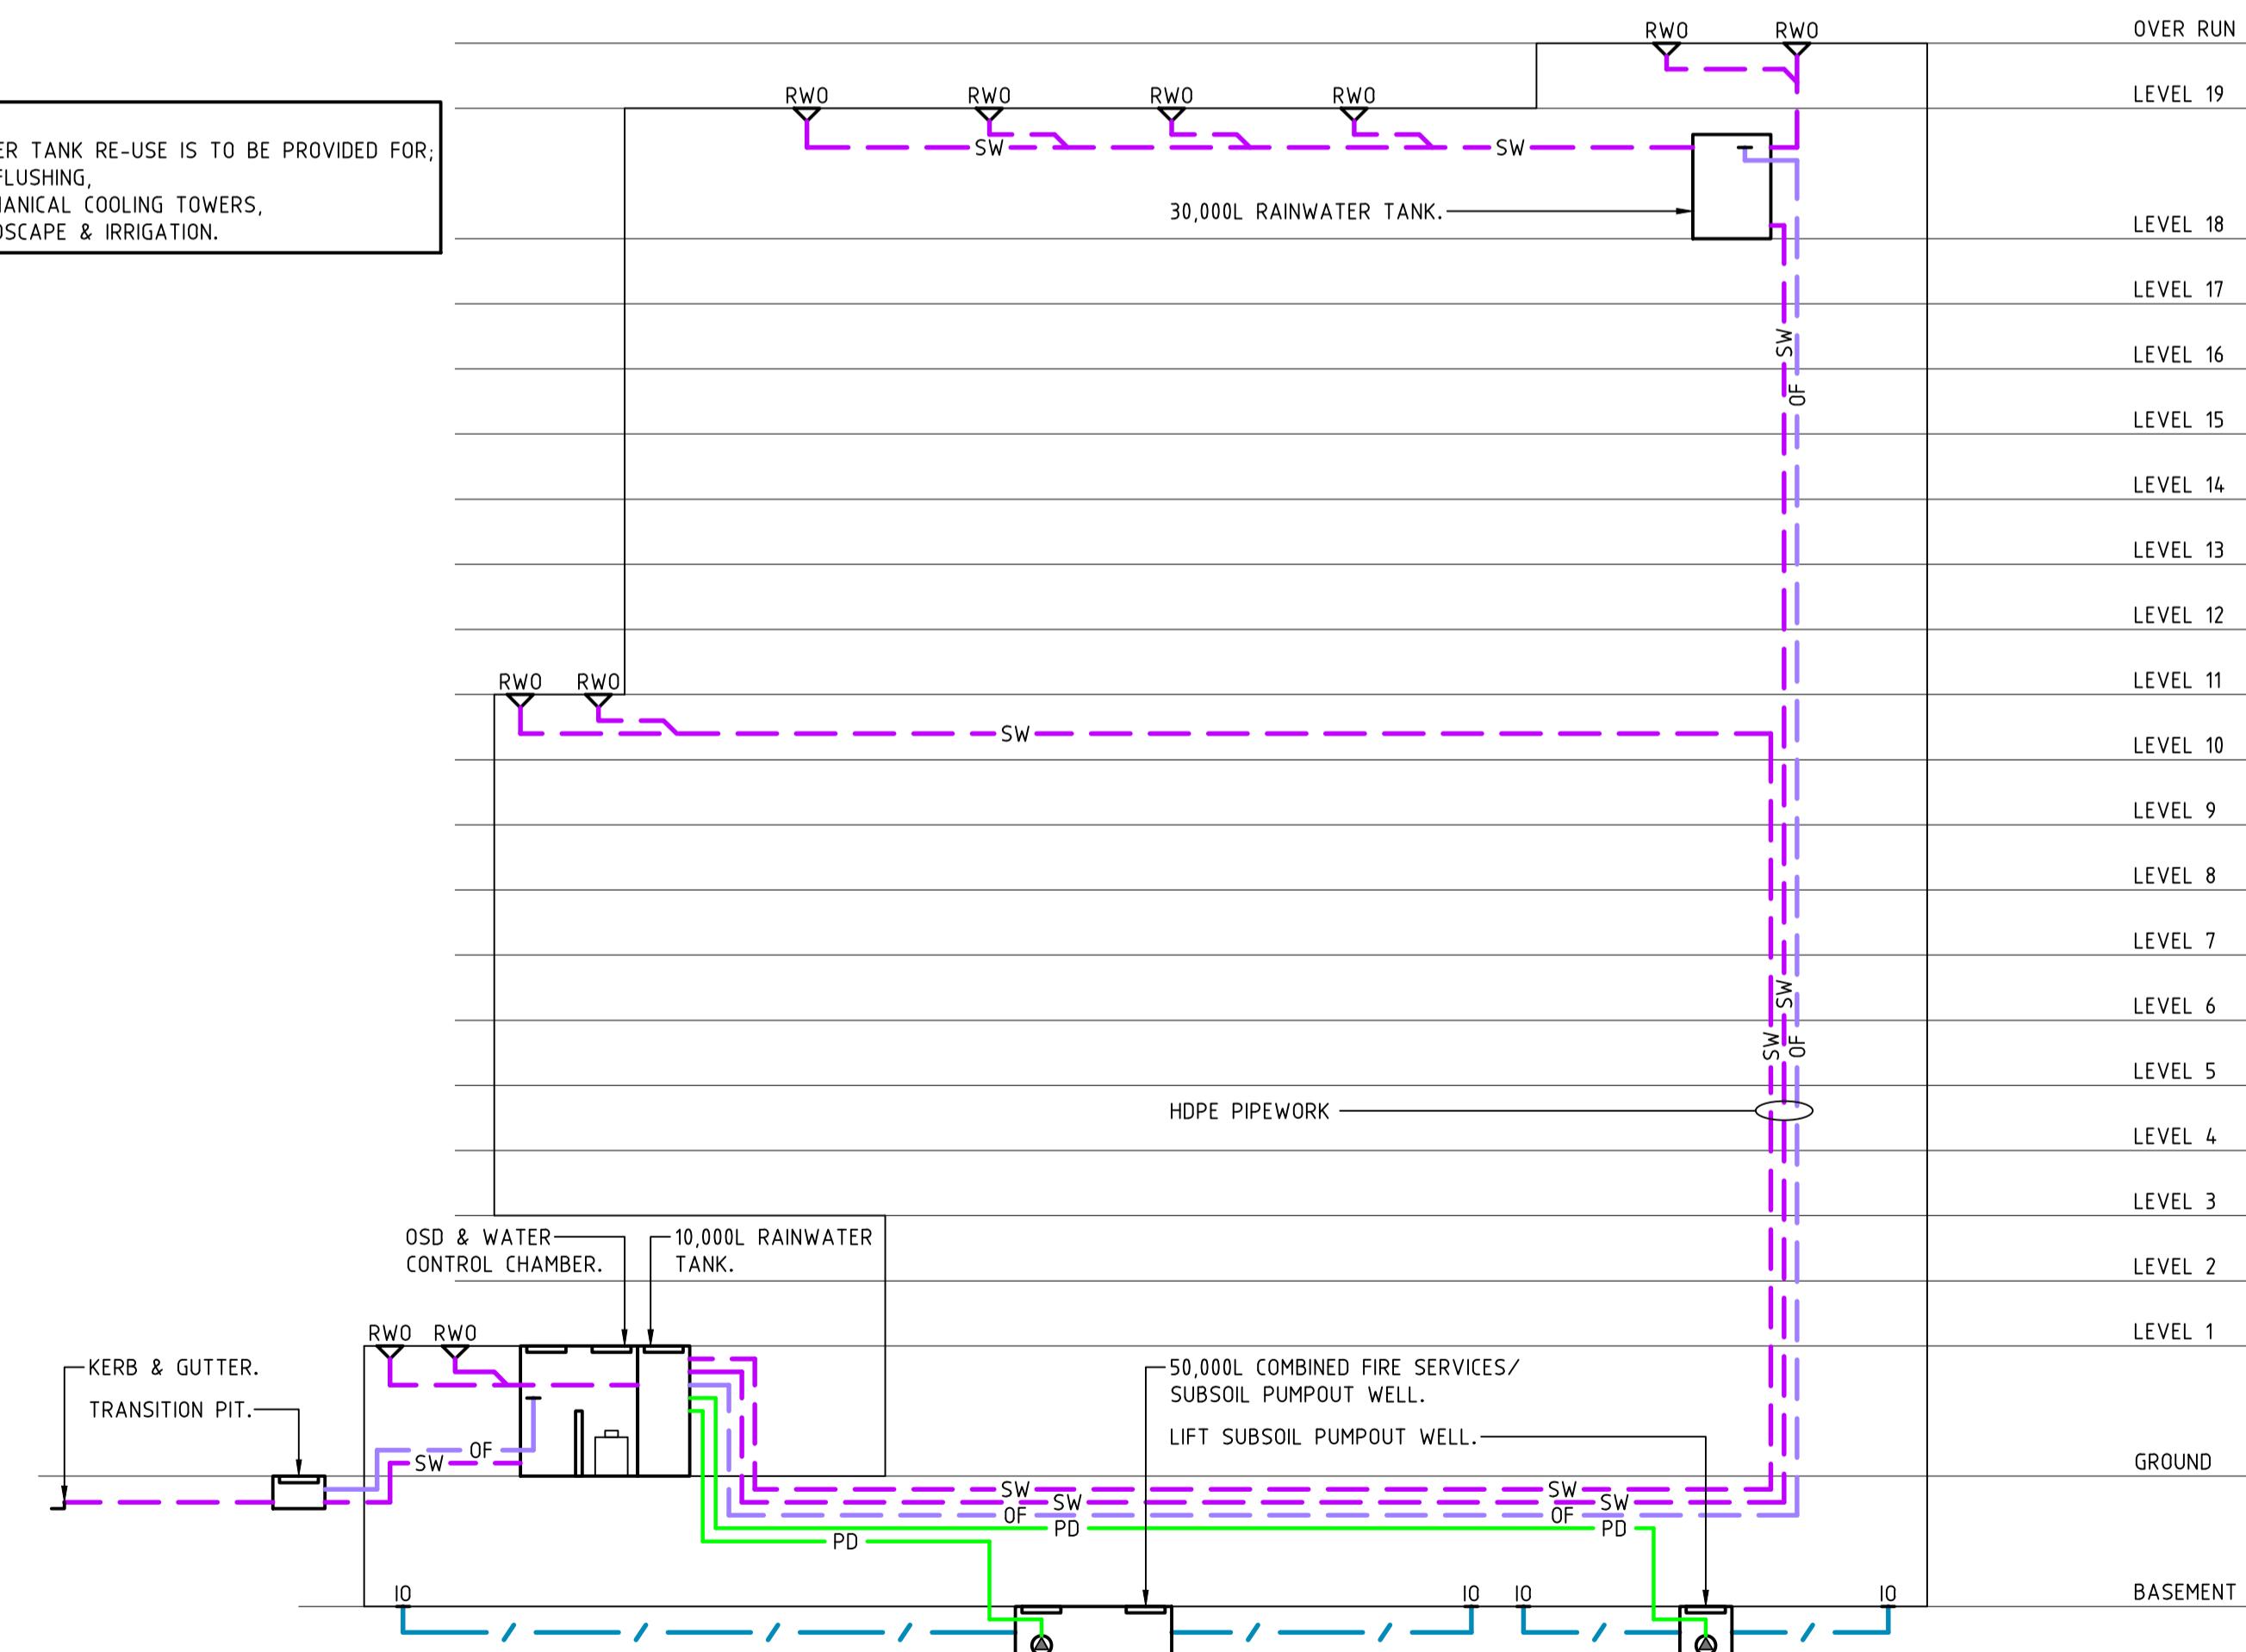

STORMWATER & RAINWATER DRAINAGE DIAGRAM INTENT

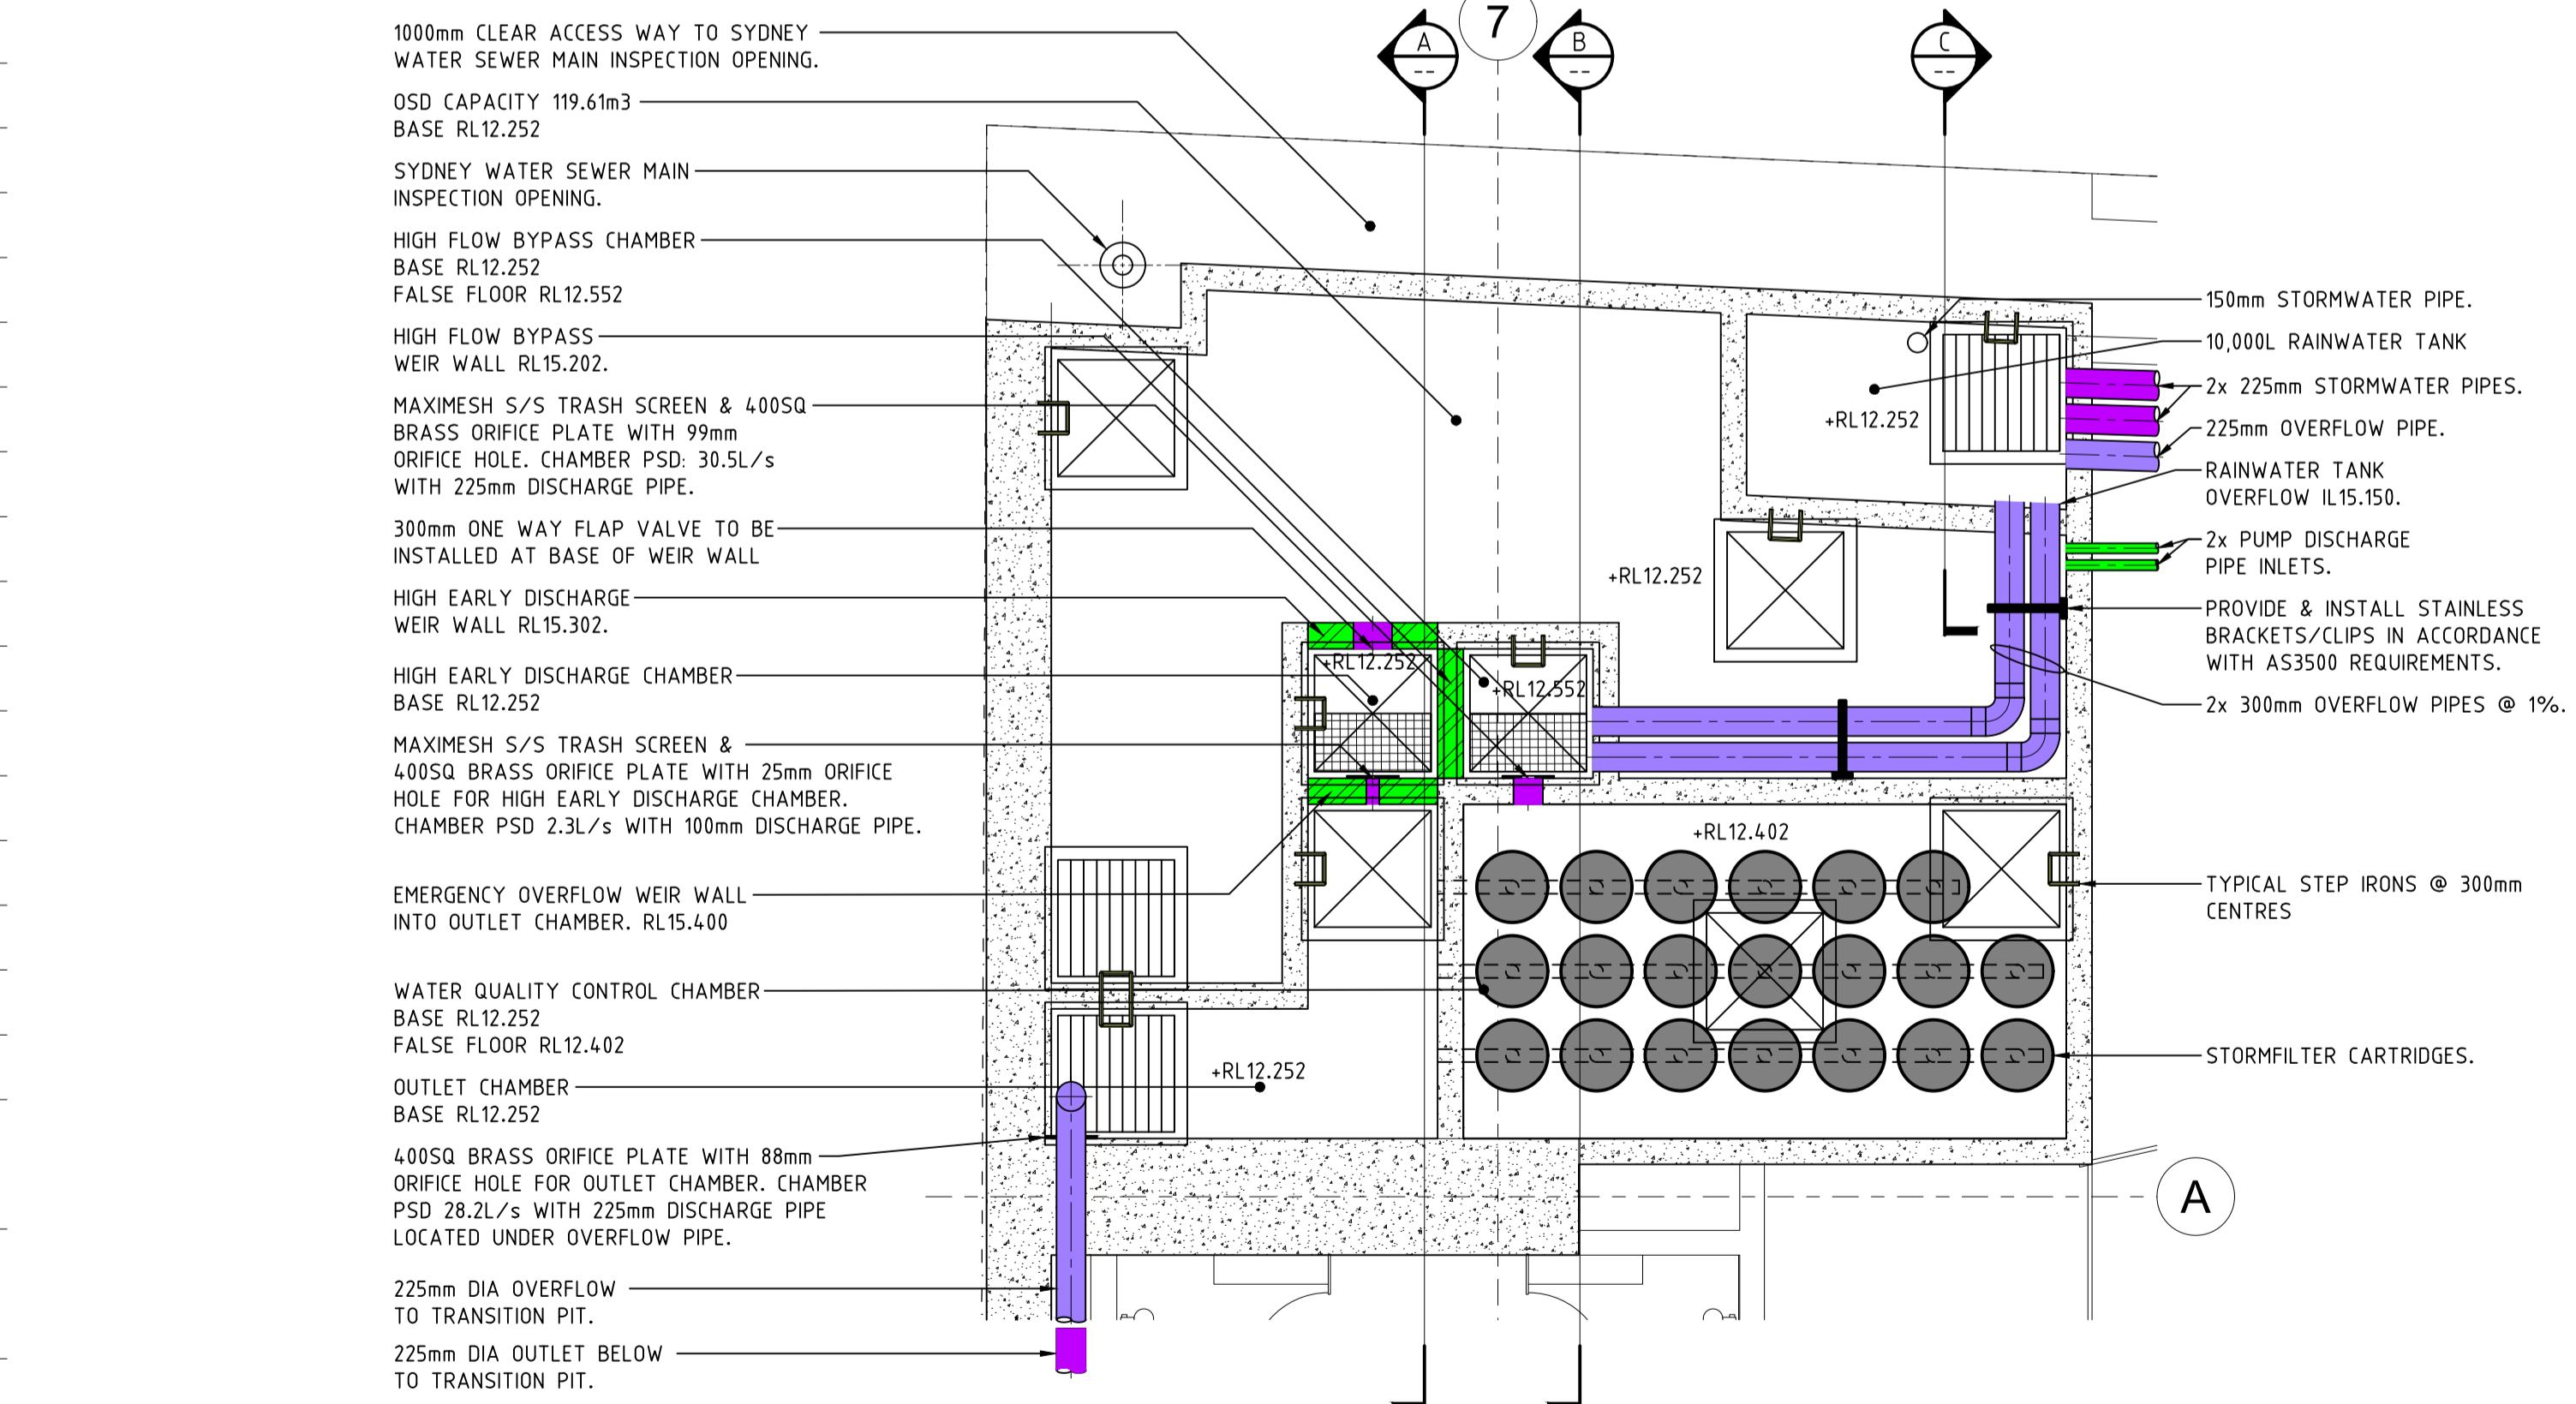

OSD TANK PLAN DETAIL

REVISION					
H					
P1	27.03.2019	DR	JB	DA	ISSUE
REV	DATE	DRN	CHD	DESCRIPTION	

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ARCHITECT

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**HASSALL STREET, PARRAMATTA
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PARRAMATTA NSW 2150**


SERVICE

STORMWATER CONCEPT PLAN

DRAWING TITLE

DETAIL SHEET 1

DRAWN **DR** ENGINEER **JB**
CHECKED **SO** DATE STARTED **MARCH 2019**
DRAWING SCALE
AS SHOWN @ A1
PROJECT No **S18255** DRAWING NO **DA-H06** REVISION **P1**

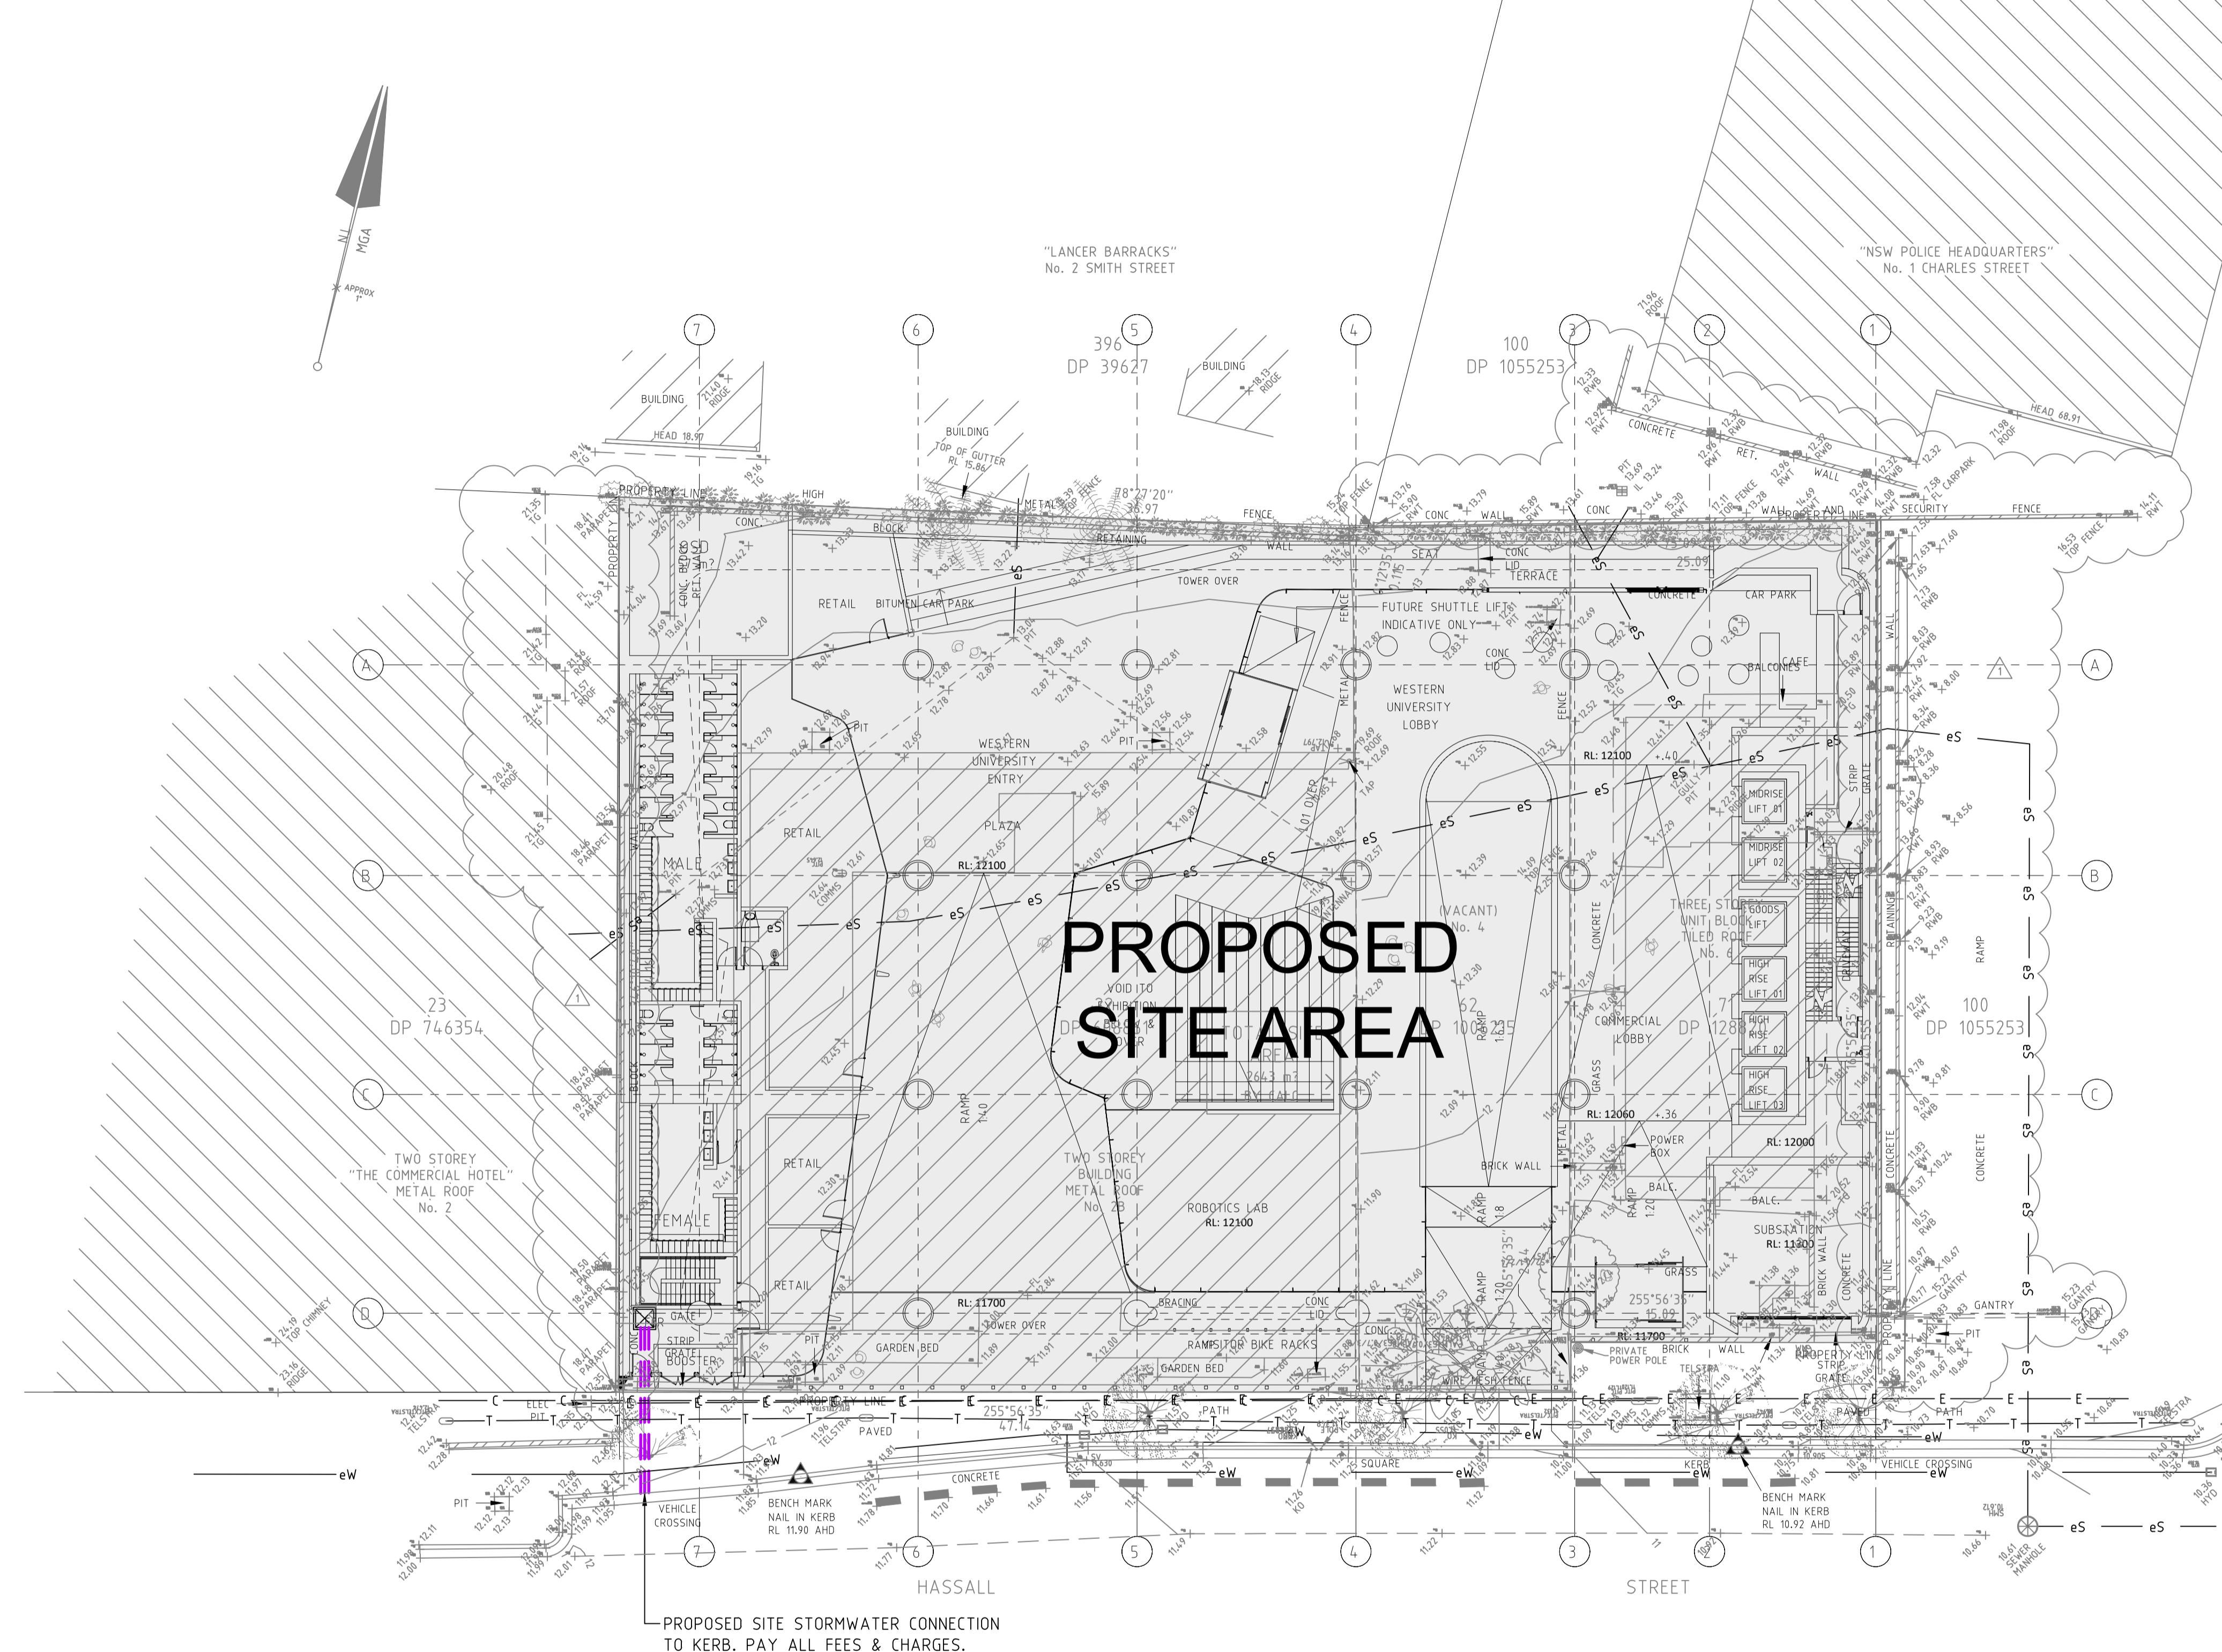

On-Site Detention Calculation Sheet for Upper Parramatta River Catchment

HED Secondary Outlet

Project:	2-6 Hassall St Parramatta					
Site Address	2-6 Hassall St Parramatta					
Job No:	18255					
Designer:	James Browne					
Telephone:	(02) 9406 4563					
Site Data						
OSD Area:	Upper Parramatta River Catchment					
L.G.A	Parramatta City Council					
Site Area	0.2647	ha	2,647	m ²		
Total Roof Area	0.1767	ha	1,767	m ²		
Area of Site draining to OSD Storage	0.2456	ha	2,456	m ²	Satisfactory	
Residual Site Area (Lot Area - Roof Area)	0.088	ha				
Area Bypassing Storage	0.0191	ha				
Area Bypassing / Residual Site Area	21.7%				Satisfactory	30% Max
No. of Dwellings on Site	1				Satisfactory	
Site Area per Dwelling	0.265	ha				
Roof Area per Dwelling	0.177	ha				
Basic OSD Parameters						
Extended Detention						
Basic SSR Vols	Ext Detention Storage	300	m ³ /ha		Total Storage	455 m ³ /ha
Basic SRDs	Primary Outlet	40	L/s/ha		Secondary Outlet	150 L/s/ha
OSD Tank Bypass						
Residual Lot Capture in OSD Tank	78%					
Adjusted SRDs	33	L/s/ha			107	L/s/ha
OSD Calculations						
Extended Detention						
Basic SSR Volume	Ext Detention Storage	79.41	m ³		Total Storage	120.44 m ³
Total Rainwater Tank Credits		0.64	m ³			0.83 m ³
Storage Volume					Total	119.61 m ³
Storage Volume	Ext Detention Storage	78.77	m ³		Flood Detention Storage	40.84 m ³
OSD Discharges	Primary Outlet	8.86	L/s		Secondary Outlet	28.21 L/s
RL of Top Water Level of Storage	0.000	m			15.323	m
RL of Orifice Centre-line	0.000	m			12.302	m
Number of Orifices	1				1	
Estimated Downstream Flood Level	9.00	1.5 yr ARI			9.00	100 yr ARI
Downstream FL - RL of Orifice Cente-line	9.00	Raise Orifice Level			-3.30	m
Design Head to Orifice Centre	0.000	m		TWL Ext Detn Storage - RL Orifice	-12.302	m
Calculated Orifice Diameter	#DIV/0!	mm	Satisfactory		#DIV/0!	#NUM! mm
Overflow Weir & Freeboard Calculation						
RL of Minimum Habitable Floor Level					12.100	m
RL of Minimum Garage Floor Level					12.100	m
Length of Overflow Weir					0.90	m
Site Runoff Coefficient				Parramatta City Council	0.75	
Storm Intensity (5 min 100 yr ARI)					206	mm/h
Peak Flow over Weir					105.4	L/s
Depth of Flow over Weir					172	mm
Freeboard to Habitable Floor			Unacceptable - Min Freeboard = 200 mm		-3395	mm
Freeboard to Garage Floor			Unacceptable - Min Freeboard = 100 mm		-3395	mm
Rainwater Tank Calculations (per Dwelling)						

Only Complete this Section if a Rainwater Tank Airspace Credit is Claimed

The calculations assume that the same size rainwater tank is installed on each dwelling

			Min	Max
% of Roof draining to Rainwater Tank	100.0%		Satisfactory	4.6% 100%
Total Rainwater Tank Volume	40.00	kL	Tank Volume OK	
Min Volume that triggers Top-up	0.00	kL	Note - Min Vol in Tank < 10% Total Tank Vol	
Total Tank Vol - Min Top-up Vol	40.00	kL		
Dedicated Airspace				
Dedicated Airspace	0.00	kL	Satisfactory	
Extended Detention				
Dedicated Airspace Credit	0.00	kL	0.00	kL
Maximum Tank PSD	40	L/s/ha		
Maximum Tank Discharge	0.0	L/s		
Maximum Head to Centre of Tank Orifice	0.000	m	No Dedicated Airspace	
Calculated Orifice Diameter	0	mm	No Dedicated Airspace	
Dynamic Airspace				
Maximum Dynamic Storage (Nett Vol)	40.00	kL	Controls minimum % Roof to Rainwater Tank	
Daily Demand on Rainwater Tank	0.657	kL/d	Satisfactory	
Dynamic Airspace at start of Storm	8.59	kL		
Extended Detention				
Dynamic Airspace Credit	0.64	kL	0.83	kL
Combined Rainwater Tank Credit	0.64	kL	0.83	kL
Maximum Rainwater Tank Credit	40.00	kL	40.00	kL
Rainwater Tank Credit per Dwelling	0.64	kL	0.83	kL
Rainwater Tank Credit for the Site	0.64	m ³	0.83	m ³

Signature: James Browne



Date: 27/03/2019

1

2

3

4

5

6

7

8

9

10

11

12

**On-Site Detention Calculation Sheet for Upper Parramatta River Catchment
HED Secondary Outlet**

MUSIC MODEL LINK
PARRAMATTA CITY COUNCIL



Quality System
ISO 9001:2008
Cert No QMS40354



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Project:	UPRCT Handbook Demonstration Example
Site Address:	2-6 Hassall St Parramatta
Job No:	18255
Designer:	LM
Telephone:	(02) 9406 4563

Site Data

OSD Area:	Upper Parramatta River Catchment
L.G.A	Parramatta City Council
Site Area	0.2647 ha 2,647 m ²
Total Roof Area	0.1767 ha 1,767 m ²
Area of Site draining to OSD Storage	0.2456 ha 2,456 m ² Satisfactory
Residual Site Area (Lot Area - Roof Area)	0.088 ha
Area Bypassing Storage	0.0191 ha
Area Bypassing / Residual Site Area	21.7% Satisfactory 30% Max
No. of Dwellings on Site	1 Satisfactory
Site Area per Dwelling	0.265 ha
Roof Area per Dwelling	0.177 ha

Basic OSD Parameters

Basic SSR Vols	Extended Detention		Detention	
	Ext Detention Storage	300 m ³ /ha	Total Storage	455 m ³ /ha
Basic SRDs	Primary Outlet	40 L/s/ha	Secondary Outlet	150 L/s/ha

OSD Tank Bypass

Residual Lot Capture in OSD Tank	78%
Adjusted SRDs	33 L/s/ha

OSD Calculations

Basic SSR Volume	Extended Detention		Detention	
	Ext Detention Storage	79.41 m ³	Total Storage	120.44 m ³
Total Rainwater Tank Credits	0.64 m ³		0.83 m ³	
Storage Volume	Ext Detention Storage	78.77 m ³	Total	119.61 m ³
OSD Discharges	Primary Outlet	8.86 L/s	Flood Detention Storage	40.84 m ³
			Secondary Outlet	28.21 L/s
RL of Top Water Level of Storage	0.000 m		15.323 m	
RL of Orifice Centre-line	0.000 m		12.302 m	
Number of Orifices	1		1	
Estimated Downstream Flood Level	9.00 m 1.5 yr ARI		9.00 m 100 yr ARI	
Downstream FL - RL of Orifice Centre-line	9.00 m Raise Orifice Level		Satisfactory	-3.30 m
Design Head to Orifice Centre	0.000 m		TW2 Ext Detn Storage - RL Orifice	-12.302 m
Calculated Orifice Diameter	#DIV/0! mm			#NUM! mm

REFER TO NOTE 1

REFER TO NOTE 2

Overflow Weir & Freeboard Calculation

RL of Minimum Habitable Floor Level	12.100 m
RL of Minimum Garage Floor Level	12.100 m
Length of Overflow Weir	0.90 m
Site Runoff Coefficient	Parramatta City Council
Storm Intensity (5 min 100 yr ARI)	0.75
Peak Flow over Weir	206 mm/h
Depth of Flow over Weir	105.4 L/s
Freeboard to Habitable Floor	Unacceptable - Min Freeboard = 200 mm
Freeboard to Garage Floor	Unacceptable - Min Freeboard = 100 mm

Rainwater Tank Calculations (per Dwelling)

Only Complete this Section if a Rainwater Tank Airspace Credit is Claimed

The calculations assume that the same size rainwater tank is installed on each dwelling

% of Roof draining to Rainwater Tank	Min	Max
Total Rainwater Tank Volume	40.00 kL	Satisfactory 4.6% 100%
Min Volume that triggers Top-up	0.00 kL	Tank Volume OK
Total Tank Vol - Min Top-up Vol	40.00 kL	Note - Min Vol in Tank < 10% Total Tank Vol
Dedicated Airspace	0.00 kL	

Extended Detention

Detention

Dedicated Airspace Credit	0.00 kL	Satisfactory
Maximum Tank PSD	40 L/s/ha	
Maximum Tank Discharge	0.0 L/s	
Maximum Head to Centre of Tank Orifice	0.000 m	No Dedicated Airspace
Calculated Orifice Diameter	0 mm	No Dedicated Airspace
Dynamic Airspace		
Maximum Dynamic Storage (Nett Vol)	40.00 kL	Controls minimum % Roof to Rainwater Tank
Daily Demand on Rainwater Tank	0.657 kL/d	Satisfactory
Dynamic Airspace at start of Storm	8.59 kL	
Dynamic Airspace Credit	0.64 kL	0.83 kL
Combined Rainwater Tank Credit	0.64 kL	0.83 kL
Maximum Rainwater Tank Credit	40.00 kL	40.00 kL
Rainwater Tank Credit per Dwelling	0.64 kL	0.83 kL
Rainwater Tank Credit for the Site	0.64 m ³	0.83 m ³

Signature: JAMES BROWNE

Date: 27/03/2019

REVISION

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Charter Hall WESTERN SYDNEY UNIVERSITY



W



Tzannes + BlightRayner

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Sydney, Australia W: blightrayner.com.au

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E: tzannes@tzannes.com.au

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Appendix D

Flood Enquiry Application





Our Reference: FL/136/2018
Contact: Peter Sirianni
Telephone: 02 9806 8250
Fax: 02 9806 5906

Gary Singh & Andrew Steventon
Level 14, 5 Martin Place
SYDNEY NSW 2000

24 October 2018

FLOOD ENQUIRY APPLICATION

Property Details

Address	2 Hassall Street, PARRAMATTA NSW 2150, 4 Hassall Street, PARRAMATTA NSW 2150, 6 Hassall Street, PARRAMATTA NSW 2150
<i>This form applies for up to three adjoining sites relating to the same development. A separate Flood Enquiry form and fee will be required for more than 3 or separate lots.</i>	

Delivery Preference

gary.singh@solutionsconsulting.com.au & andrew.steventon@solutionsconsulting.com.au

Reason for Enquiry

Proposed Re-development of Property

Property Type

**** GST not applicable from 1 July 2013****

Flooding Application - Commercial	\$496.45
-----------------------------------	----------

Disclaimer: Flood levels and flood extent lines are based on current information held by Council. Council does not accept responsibility for the accuracy of this information. Any pipe sizes and location of pits and pipe lines should be confirmed by site investigation.

The flood levels shown on the back of this form are only an approximate guide and have been derived using the current computer simulated model.

The information provided in this document is presented in good faith to assist the public in understanding Council's drainage requirements that apply within the Parramatta Local Government Area. It is the responsibility of each individual using this information to undertake their own checks and confirm this information prior to its use.

City of Parramatta Council, its agents and employees are not liable (whether by reason of negligence, lack of care or otherwise) to any person for any damage or loss whatsoever which has occurred or may occur in relation to that person taking or not taking (as the case may be) action in respect of any representation, statement, or advice referred to above.

Refer to back of this form for level information issued



Flood Enquiry Information Issued - 24 October 2018

Mainstream Flooding

Is this property affected by mainstream flooding? 2-6 Hassall Street, Parramatta		<input type="checkbox"/> Yes <input checked="" type="checkbox"/> No
Flood Levels	Closest Cross Sections: (Please refer to Flood Study):	
<input type="checkbox"/> 5% AEP	m AHD	Comments: See Note on Flood / Hazard Map
<input type="checkbox"/> 1% AEP	m AHD	
<input type="checkbox"/> PMF	m AHD	
<input checked="" type="checkbox"/> Refer to flood maps provided for detailed flood levels.		
Flood information is obtained from the following flood study report: 1. Lower Parramatta River Floodplain Risk Management Study – Flood Study Review, 2005 (SKM) 2. Parramatta Drainage, 1990 (Sinclair Knight & Partners)		

Note: Flood inundation can be verified by detail survey to AHD undertaken by a Registered Surveyor.

Local Flooding

Is the property located within a Hatched Grey Area? <i>Properties located within a Hatched Grey Area are subjected to flooding from the local catchment.</i>		<input type="checkbox"/> Yes <input checked="" type="checkbox"/> No
Is the property located within a Grey Area? <i>Properties located within a Grey Area are subjected to additional site drainage controls to manage flooding in the local catchment.</i>		<input type="checkbox"/> Yes <input checked="" type="checkbox"/> No
Is the property likely to be affected by overland stormwater run-off from the local catchment? Note: No site inspection conducted for this assessment. Based solely on the information supplied for this flood enquiry application.		<input type="checkbox"/> Yes <input checked="" type="checkbox"/> Subject to Detailed Investigation
Note: You are required to contact Council's Development Service Engineer for any details and requirements relating to development that is affected by local flooding.		


Additional Recommended Actions

<input checked="" type="checkbox"/>	The Applicant needs to discuss the proposal to re-develop this site with Council's Town Planner and Development Services Engineer.
<input type="checkbox"/>	The Applicant needs to contact Council's Town Planner and organise a pre-lodgement meeting to discuss any proposal to redevelop this property.
<input type="checkbox"/>	The Applicant needs to refer to Council's Local Floodplain Risk Management policy for details relating to developing a land affected by flooding.

Definitions: (As per NSW Floodplain Development Manual dated April 2005)

1. **AHD** – a common national surface level datum approximately corresponding to mean sea level.
2. **ARI** – the long term average number of years between the occurrences of a flood as big as or larger than, the selected event.
3. **PMF** – is the largest flood that could conceivably occur at a particular location, usually estimated from probable maximum precipitation.
4. **AEP** – Annual Exceedance Probability is the chance of a flood of a given or larger size occurring in any one year, usually expressed as a percentage.

NOTE: The Lower Parramatta River Floodplain Risk Management Study and Plan is currently being updated. Flood levels in this area may change.

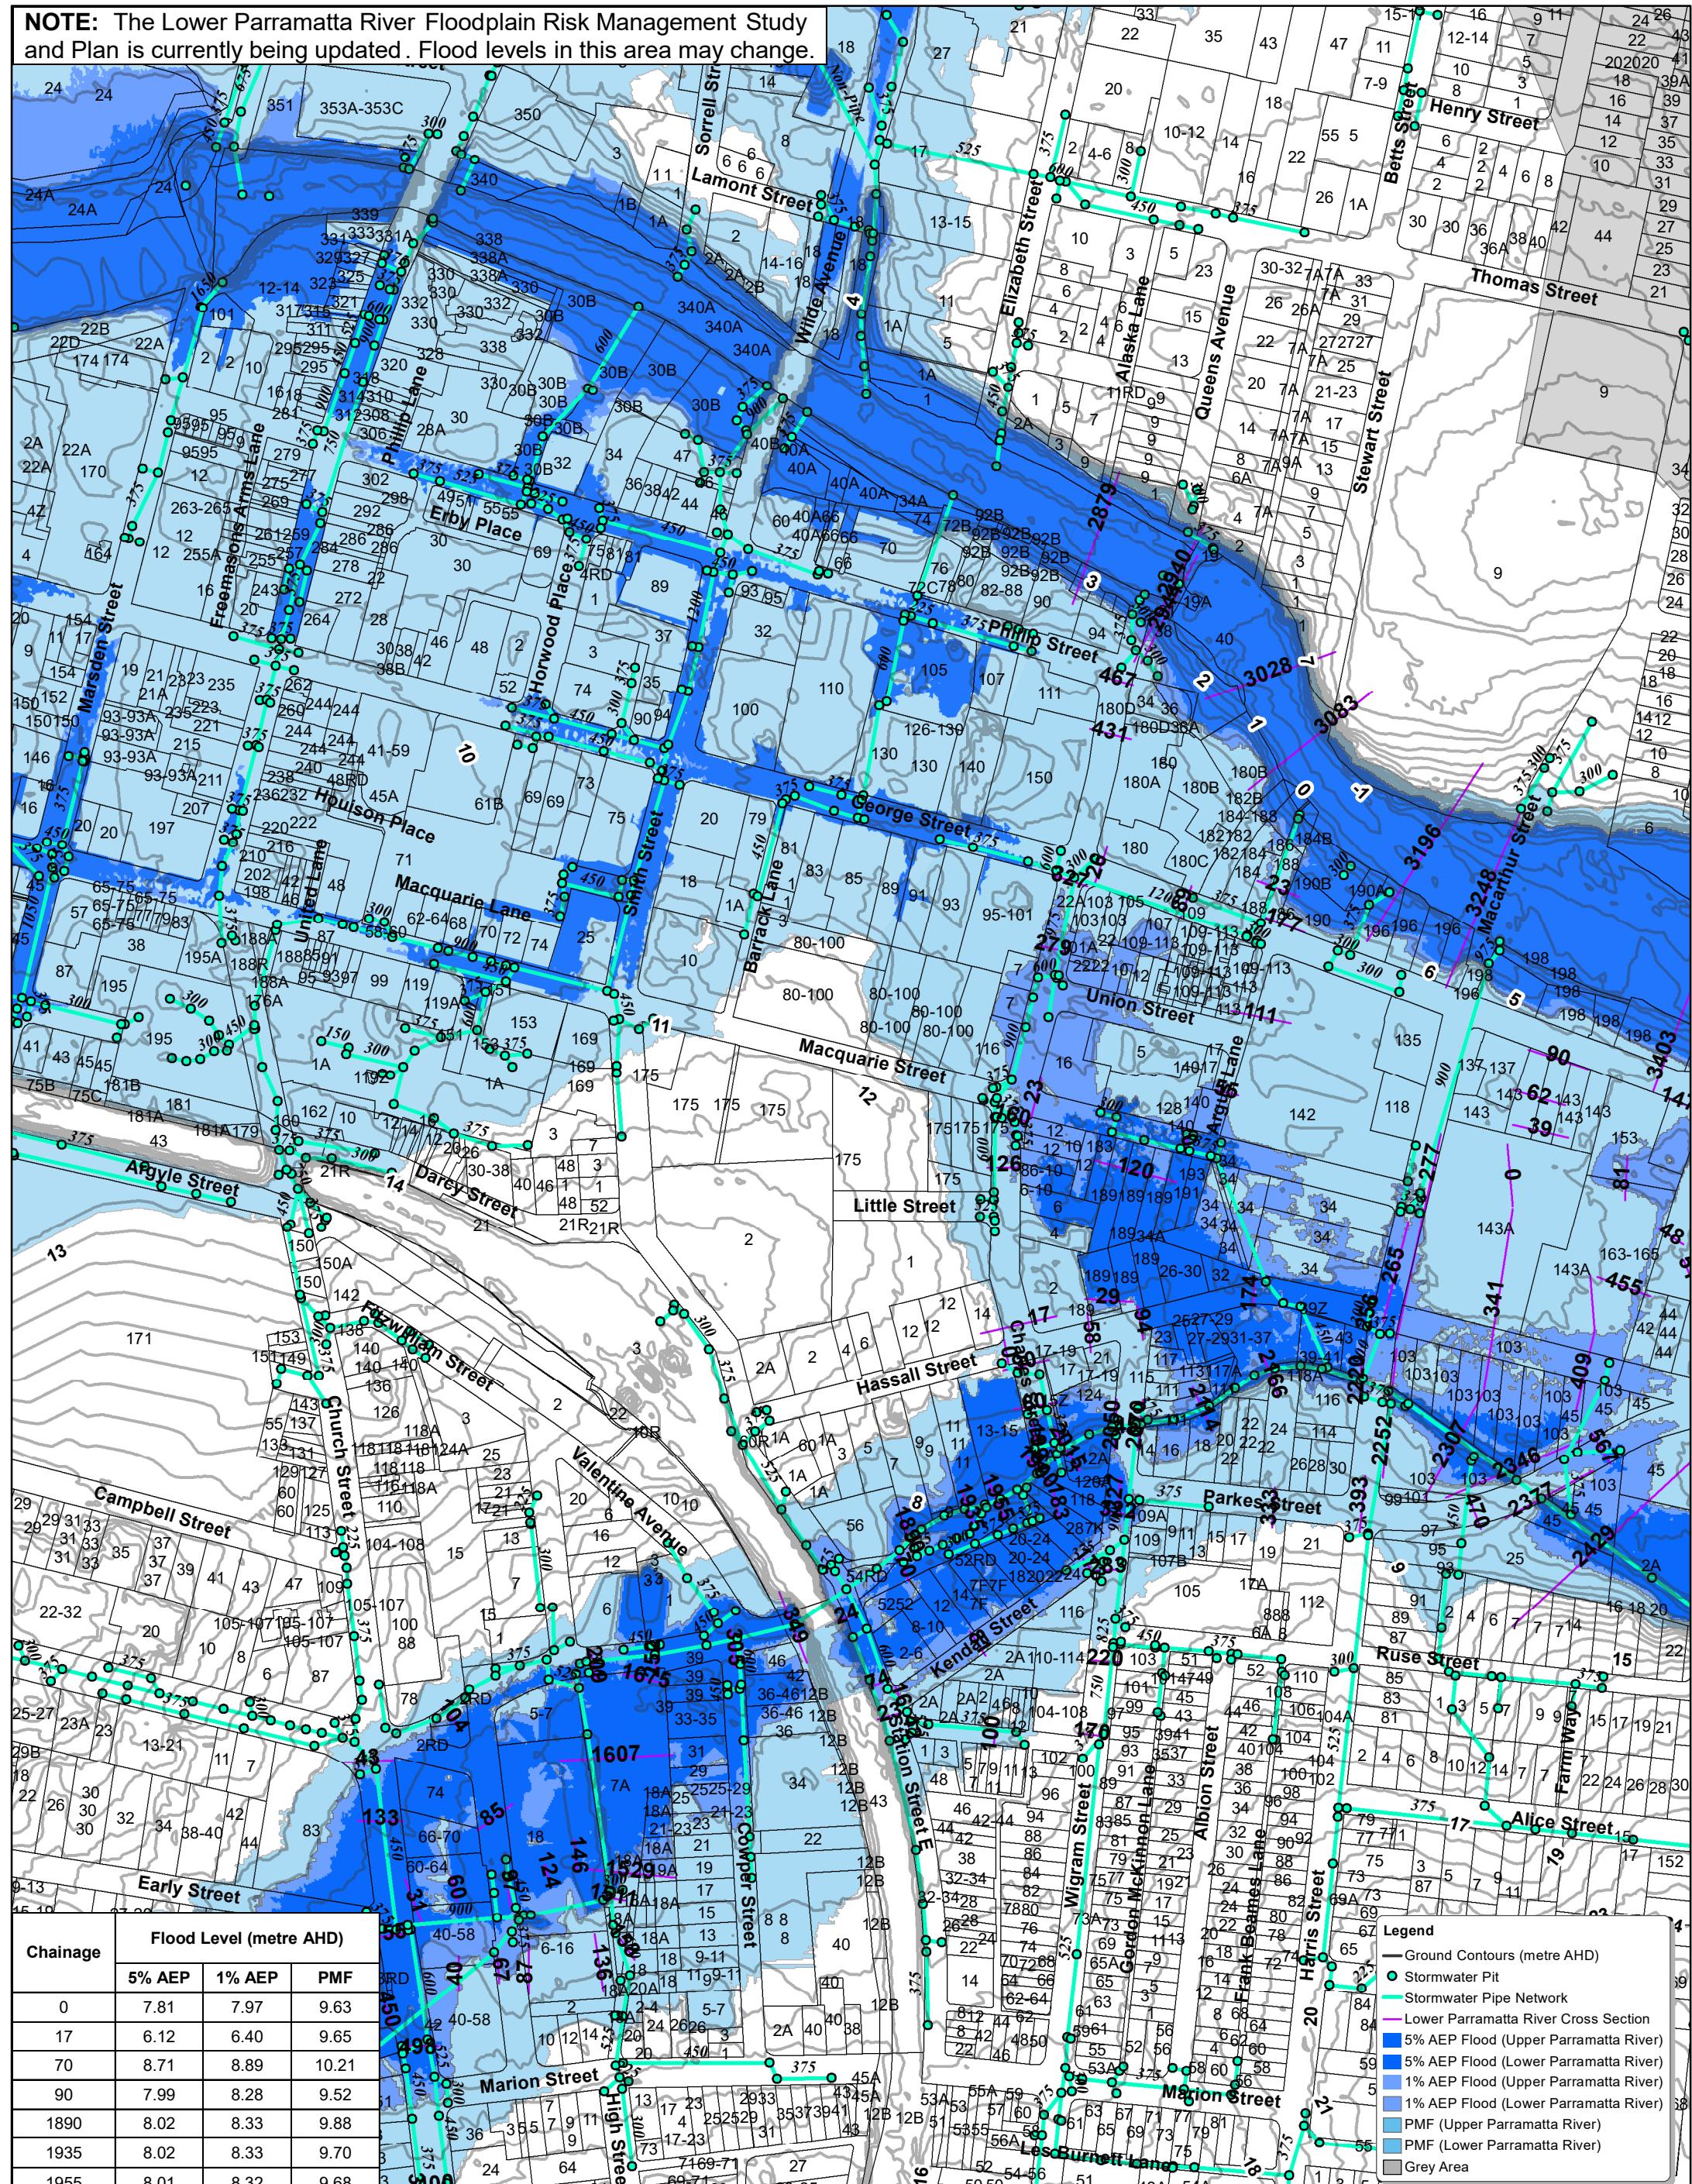

Printed
23/10/2018

City of Parramatta Council Flood Map

DISCLAIMER: Flood levels and flood extent lines are based on current information held by Council. Council does not accept responsibility for the accuracy of this Information. Any pipe sizes and location of pits and pipe lines should be confirmed by site investigation.

The flood levels provided are only an approximate guide and have been derived using the current computer simulated model.


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NOTE: The Lower Parramatta River Floodplain Risk Management Study and Plan is currently being updated. Hydraulic hazard extents in this area may change.





Robert
Bird
Group

Sydney Office

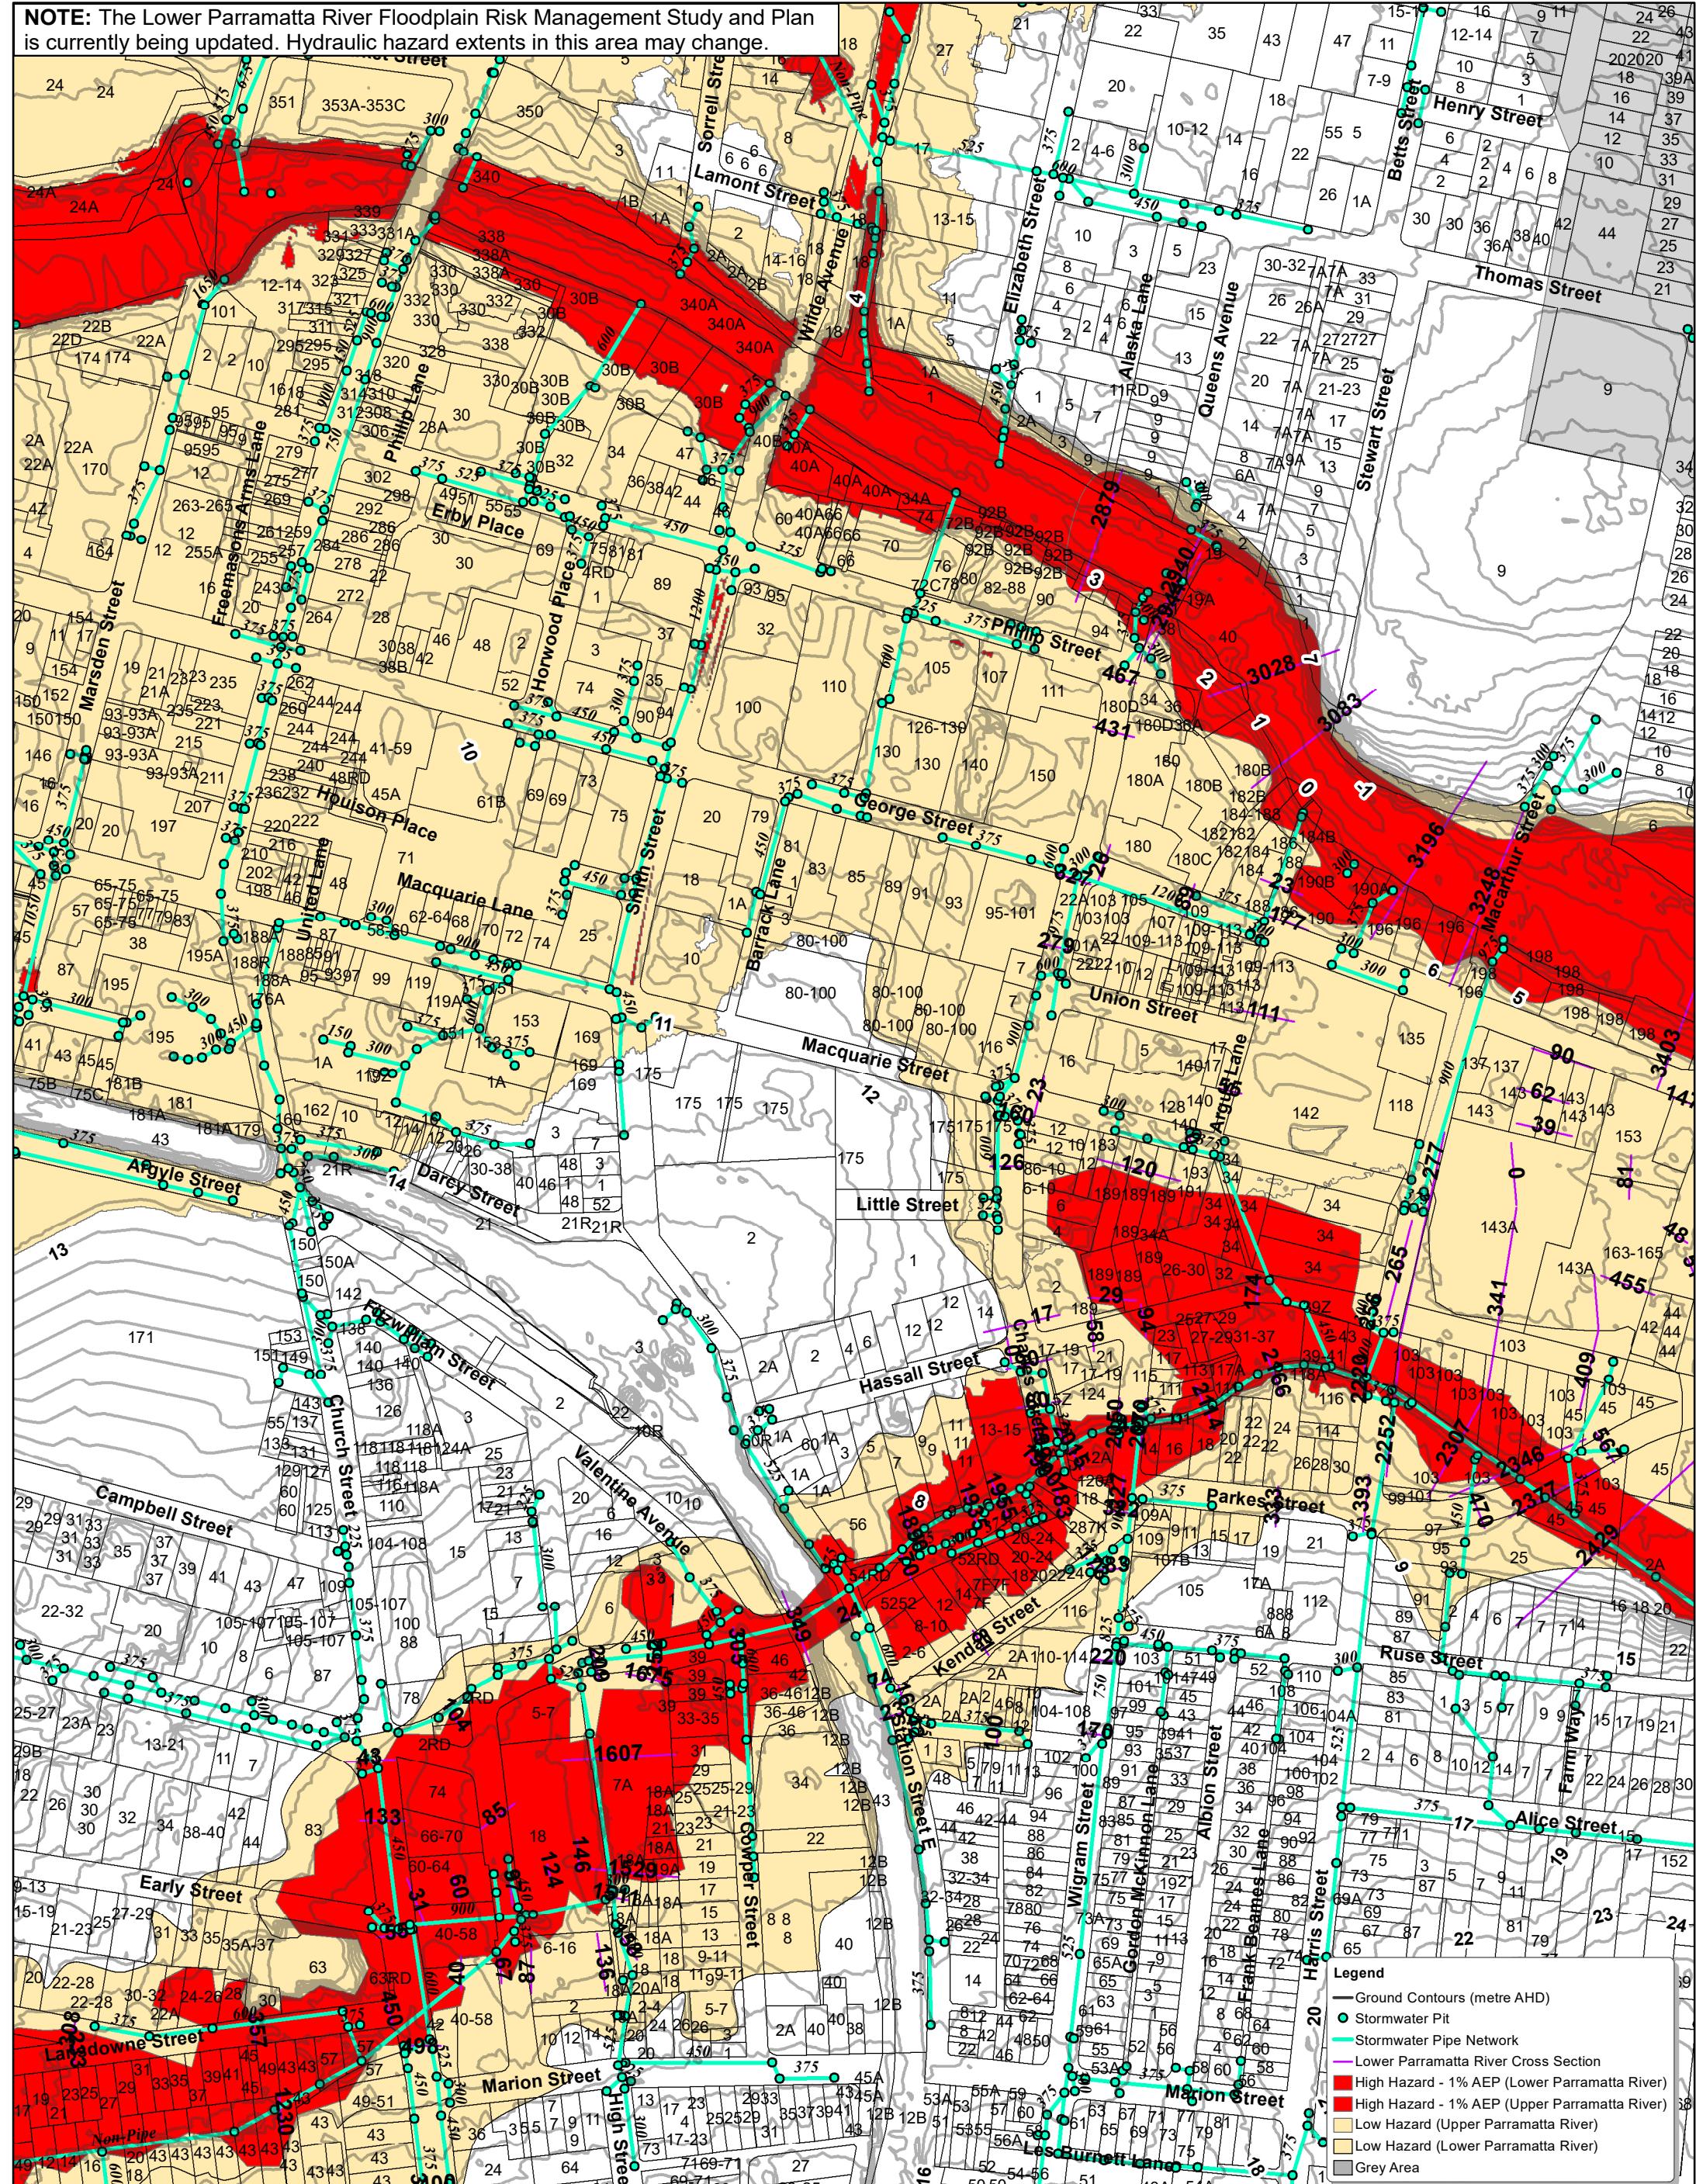
Robert Bird Group Pty Ltd
ABN 67 010 580 248 ACN 010 580 248


Level 11, 151 Castlereagh Street
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**2B-6 HASSAL ST MAIN WORKS
PARRAMATTA, NSW 2150
CIVIL ENGINEERING DRAWINGS
ISSUED FOR DEVELOPMENT APPLICATION**

Sheet List Table	
Sheet Number	Sheet Title
C-0-00	COVER SHEET, LOCATION MAP AND SHEET INDEX
C-0-01	GENERAL NOTES
C-1-00	EROSION AND SEDIMENT CONTROL
C-1-10	EROSION AND SEDIMENT CONTROL DETAILS
C-2-01	BULK EARTHWORKS PLAN
C-2-10	BULK EARTHWORKS SECTIONS
C-3-00	GENERAL ARRANGEMENT PLAN
C-3-10	CIVIL DETAILS
C-4-10	PAVEMENT DETAILS
C-6-50	STORMWATER PRE CATCHMENT ANALYSIS
C-6-51	STORMWATER POST CATCHMENT ANALYSIS



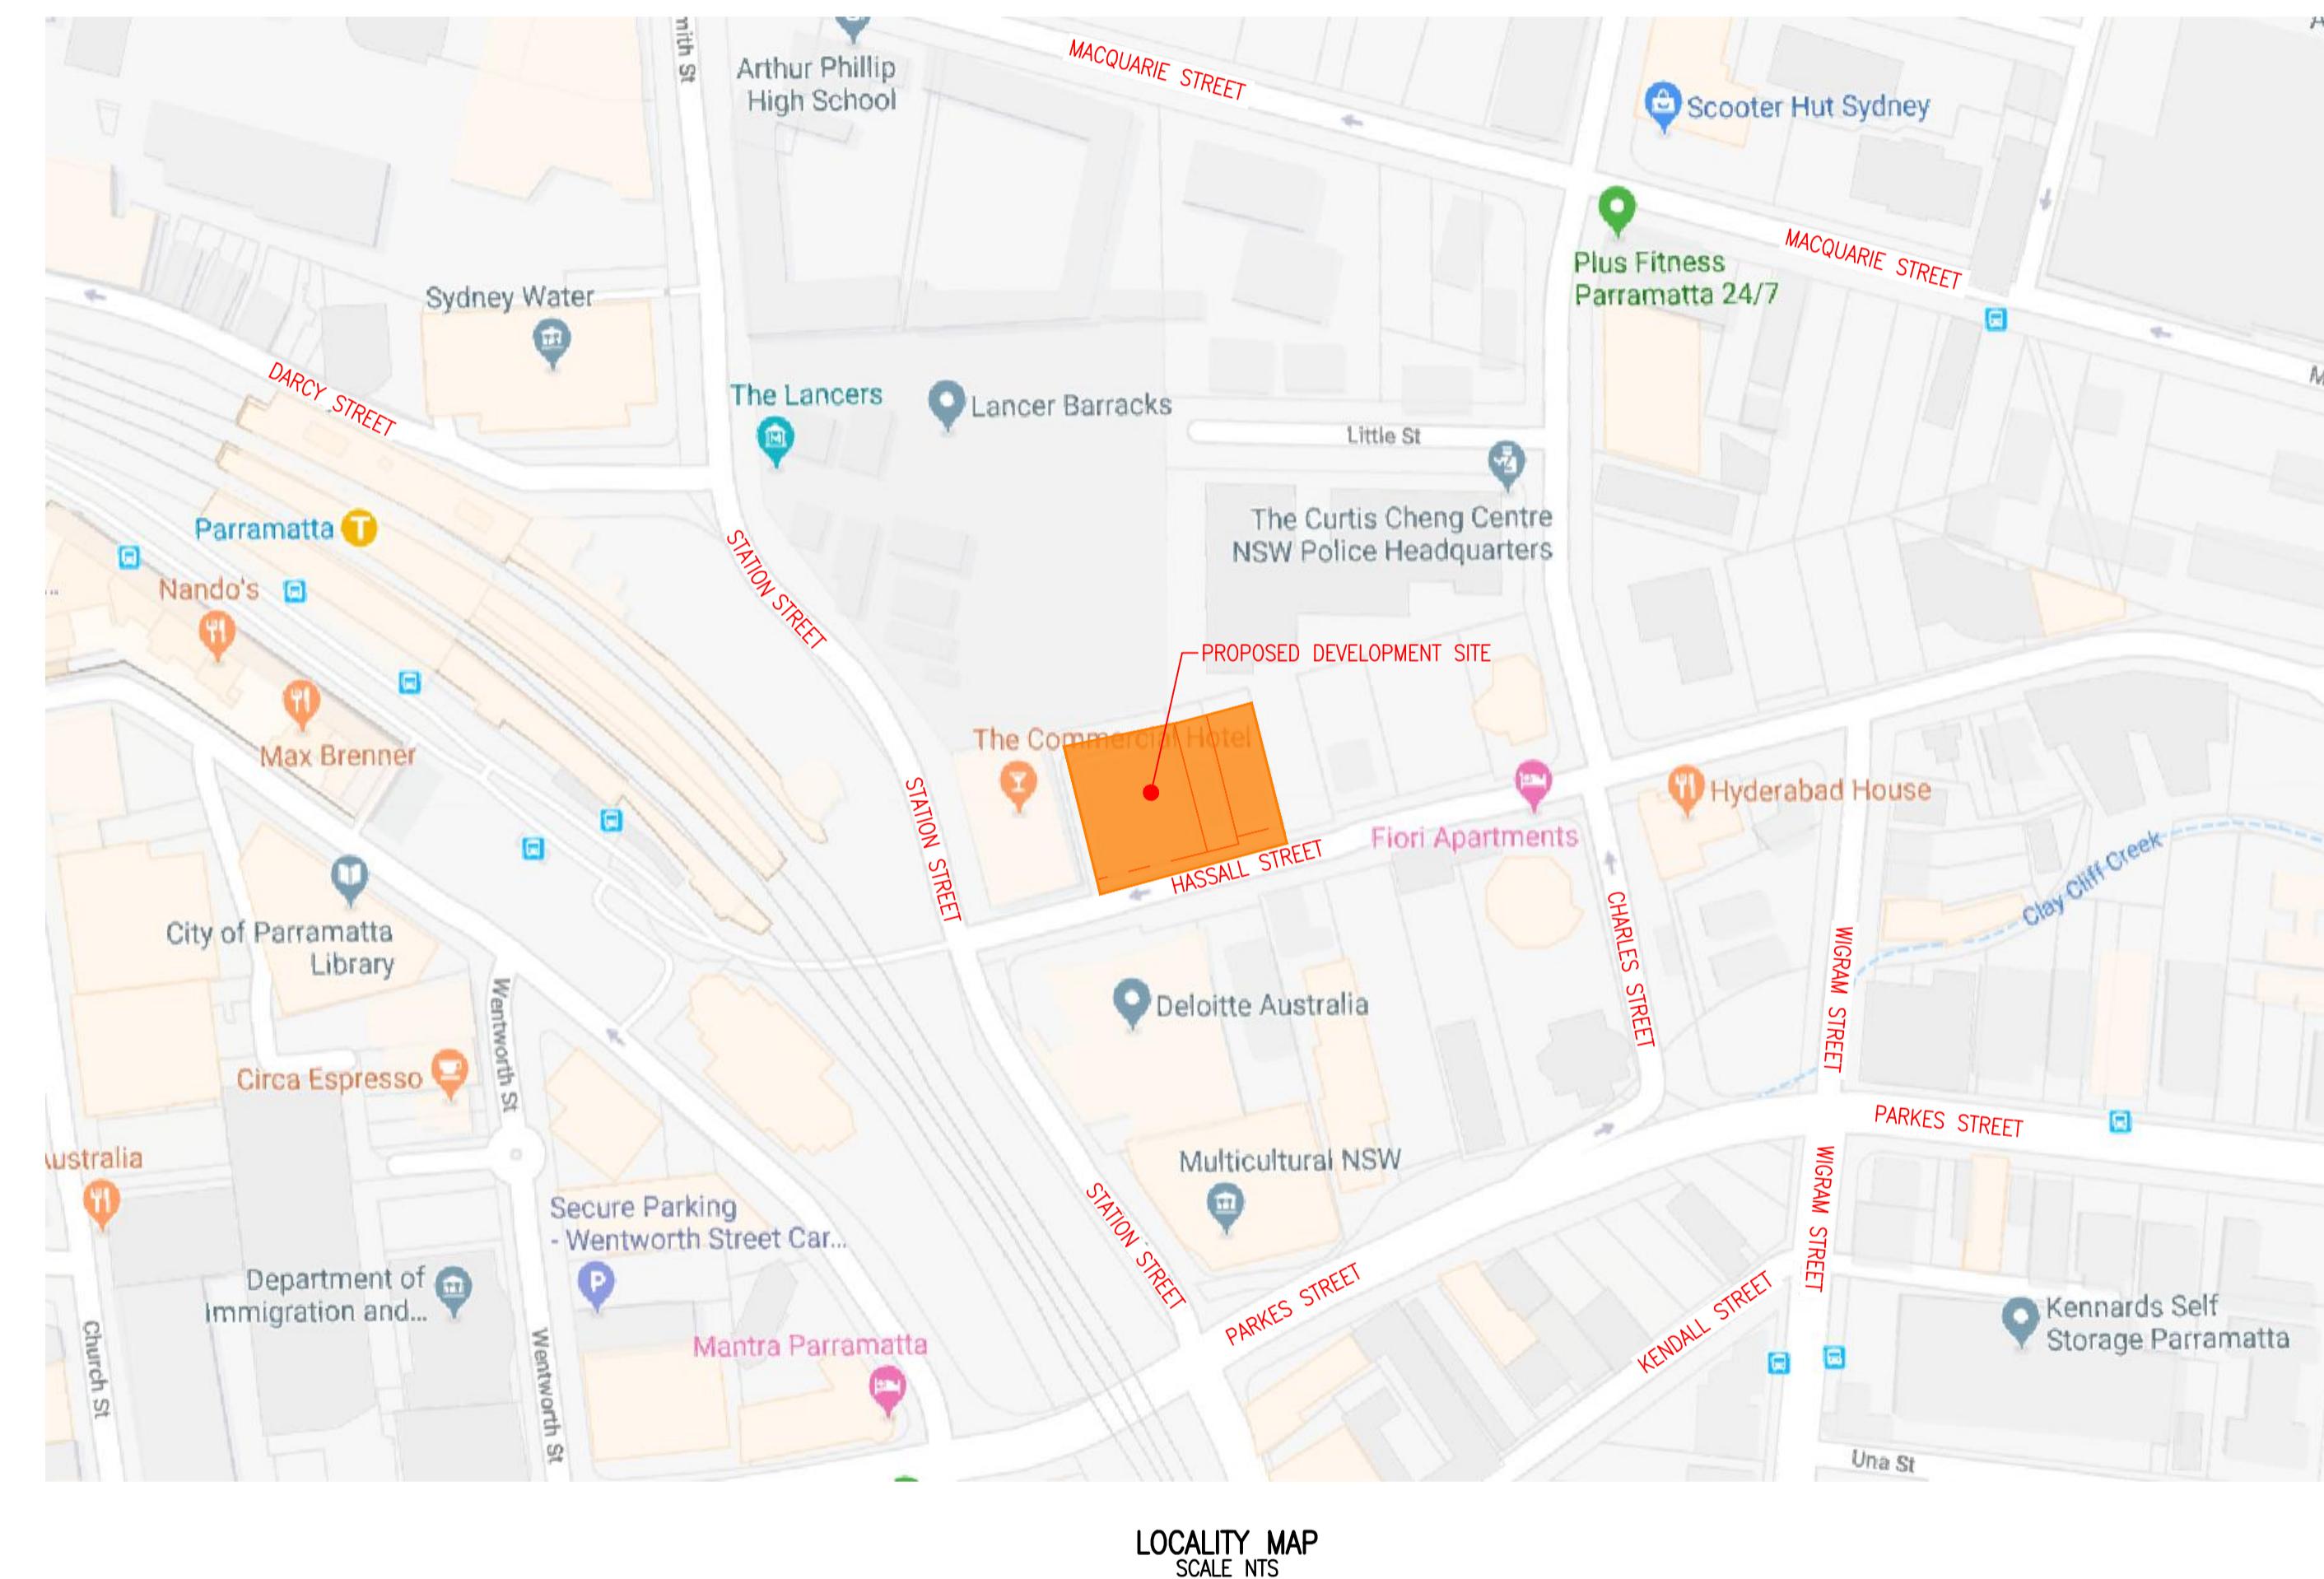

NOTES:
PRIOR TO ANY EARTHWORKS COMMENCING ON SITE, ALL EROSION AND SEDIMENT CONTROL MEASURES WOULD BE INSTALLED IN ACCORDANCE WITH THE APPROVED PLANS. THESE MEASURES WOULD INCLUDE SUPPLEMENTARY EROSION AND SEDIMENT CONTROLS IMPLEMENTED AS PART OF THE PROJECT, AS DEEMED NECESSARY:

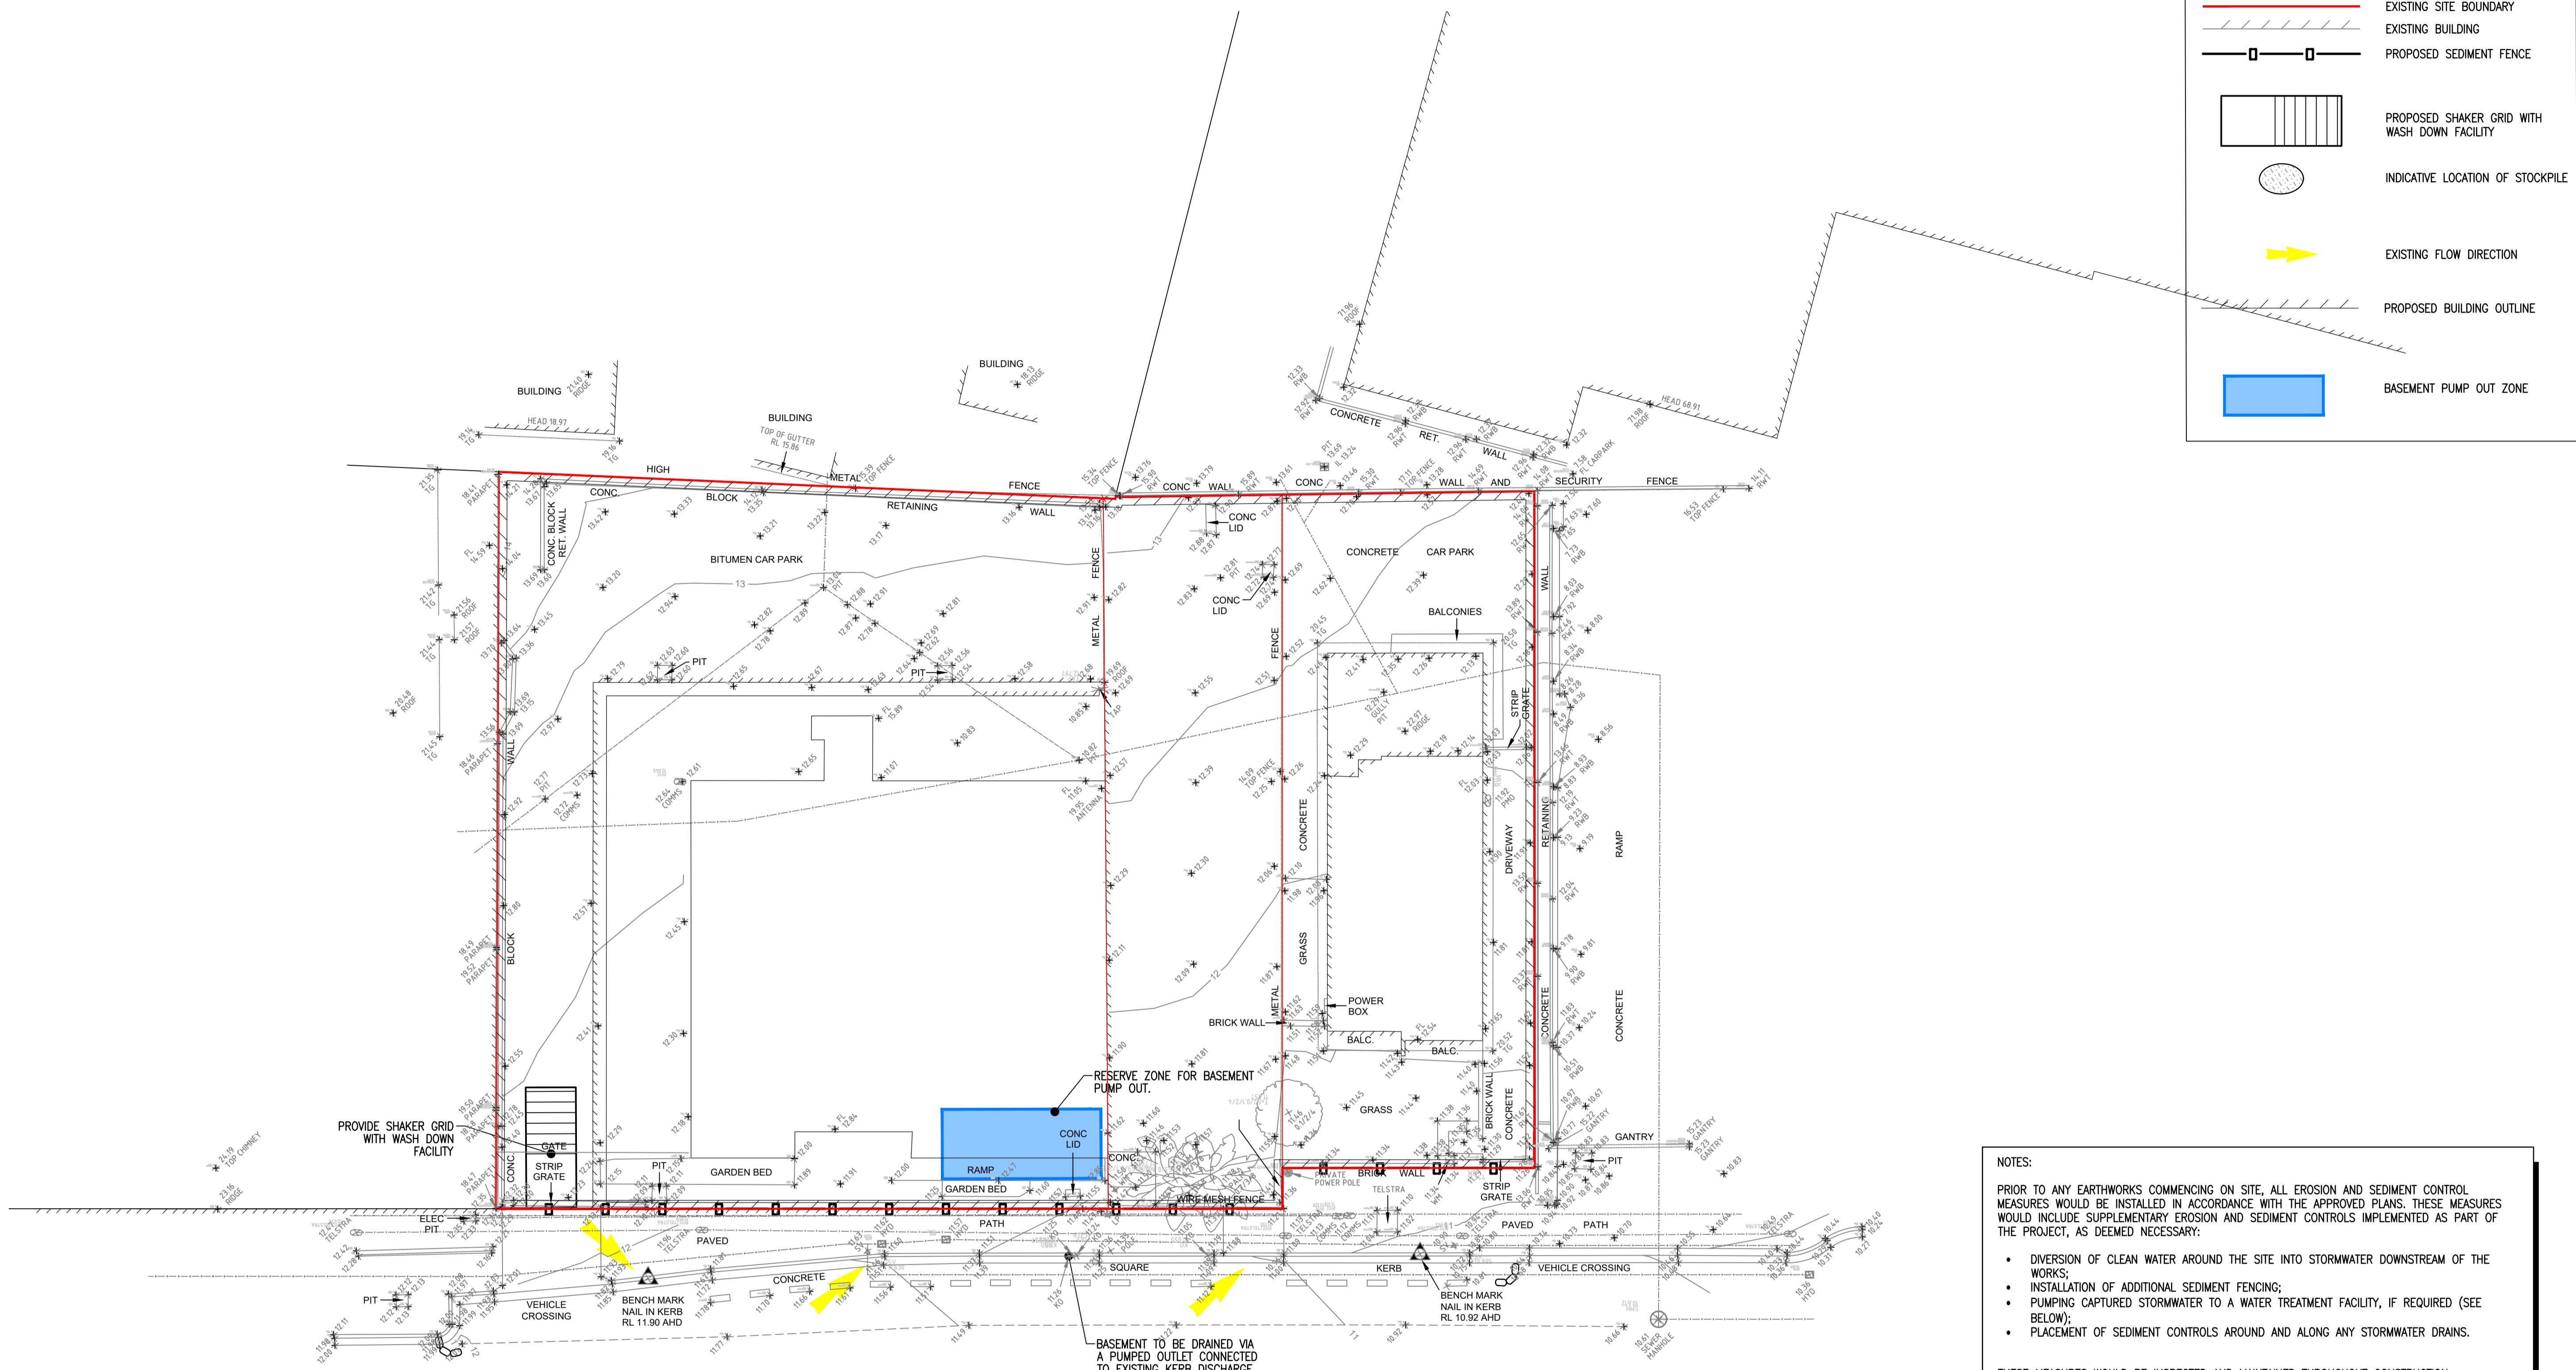- DIVERSION OF CLEAN WATER AROUND THE SITE INTO STORMWATER DOWNSTREAM OF THE WORKS;
- INSTALLATION OF ADDITIONAL SEDIMENT FENCING;
- PUMPING CAPTURED STORMWATER TO A WATER TREATMENT FACILITY, IF REQUIRED (SEE BELOW);
- PLACEMENT OF SEDIMENT CONTROLS AROUND AND ALONG ANY STORMWATER DRAINS.

THESE MEASURES WOULD BE INSPECTED AND MAINTAINED THROUGHOUT CONSTRUCTION.
RAIN AND GROUNDWATER WITHIN THE EXCAVATION IS TO BE PUMPED OFFSITE. ALL WATER IS TO BE
VERIFIED FREE OF CONTAMINATION WITH SUSPENDED SEDIMENT SO THAT ITS DISPOSAL SHOULD NOT
CONTRIBUTE TO WATER POLLUTION.

TO REMOVE WATER FROM THE WORK AREA, THE PUMP INTAKE SHOULD BE KEPT AS CLOSE TO THE SURFACE OF THE POOL AS POSSIBLE. FLOATING INTAKES SHOULD BE USED WHEN THE DEPTH OF WATER IS SUFFICIENT. CARE WILL BE TAKEN TO AVOID PUMPING FROM THE BOTTOM OF PONDS, AND CONSTANT SUPERVISION IS REQUIRED DURING PUMPING OPERATIONS TO ENSURE THIS DOES NOT HAPPEN.

TREATMENT IS REQUIRED BEFORE DISCHARGING RUNOFF TO A NATURAL WATERWAY OR STORMWATER SYSTEM, WHERE TURBIDITY EXCEEDS 30 NEPHELOMETRIC TURBIDITY UNITS (NTU) AND IS HIGHER THAN UPSTREAM MEASUREMENTS. HOURLY MEASUREMENTS OF DISCHARGE WATER QUALITY WILL BE TAKEN. CONTAMINATED WATER PUMPED OFF THE SITE WILL BE DIRECTED TO SEDIMENT CONTROL STRUCTURES (SETTLEMENT TANKS).

Rev Revision Description By App Date

1 ISSUED FOR DEVELOPMENT APPLICATION ZJ CR 30.11.18

Rev Revision Description By App Date

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Structural, Civil & Construction

Engineering Consultant

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Ph:

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Email:

sydney@robertbird.com.au

Web:

www.robertbird.com

Client

EROSION AND SEDIMENT CONTROL

Charter Hall

Project

2B-6 HASSALL STREET

PARRAMATTA

Scale at A1
AS SHOWN
Drawn
Z.JONES
Date
30.11.18
Designer
Z.JONES
Approved
C.ROPE
Job Number
18570C

Design Checker
C.ROPE

NOT FOR CONSTRUCTION

Drawing Number
C-1-00

Revision
1

DO NOT SCALE DRAWINGS, USE FIGURED DIMENSIONS
REFER TO GENERAL NOTES UNLESS NOTED OTHERWISE

GENERAL NOTES:

- A1. THIS SOIL AND WATER MANAGEMENT PLAN IS TO BE READ IN CONJUNCTION WITH OTHER ENGINEERING PLANS RELATING TO THIS DEVELOPMENT.
- A2. CONTRACTORS WILL ENSURE THAT ALL SOIL AND WATER MANAGEMENT WORKS ARE UNDERTAKEN AS INSTRUCTED IN THIS SPECIFICATION AND CONSTRUCTED FOLLOWING THE LANDCOM - MANAGING URBAN STORMWATER: SOIL AND CONSTRUCTION, 4TH EDITION, MAR 2004.
- A3. REFER VEGETATION MANAGEMENT PLAN BY ECOLOGICAL FOR VEGETATION CLEARANCE AND RIPARIAN ZONE MANAGEMENT.
- A4. REFER GEOTECHNICAL REPORT FOR EARTHWORKS AND PARAMETERS.
- A5. ALL SUBCONTRACTORS WILL BE INFORMED OF THEIR RESPONSIBILITIES IN REDUCING THE POTENTIAL FOR SOIL EROSION AND POLLUTION TO DOWNSLOPE AREAS.

SITE MAINTENANCE NOTES:

- SM1. THE CONTRACTOR SHALL INSPECT THE SITE AT LEAST WEEKLY AND AT THE CONCLUSION OF EVERY STORM EVENT TO:
 - A) ENSURE THAT DRAINS OPERATE PROPERLY AND TO EFFECT AND NECESSARY REPAIRS.
 - B) REMOVED SPILLED SAND OR OTHER MATERIALS FROM HAZARD AREAS, INCLUDING LANDS CLOSER THAN 5 METRES FROM AREAS OF LIKELY CONCENTRATED OR HIGH VELOCITY FLOWS, ESPECIALLY WATERWAYS AND PAVED AREAS.
 - C) REMOVED TRAPPED SEDIMENT WHENEVER THE DESIGN CAPACITY OF THAT STRUCTURES HAS BEEN EXCEEDED.
 - D) ENSURE REHABILITATION LANDS HAVE EFFECTIVELY REDUCED THE EROSION HAZARD TO INITIATE UPGRADING OR REPAIR AS NECESSARY.
 - E) CONSTRUCT ADDITIONAL EROSION AND/or SEDIMENT CONTROL WORKS THAT MIGHT BECOME NECESSARY TO ENSURE THE DESIRED PROTECTION IS GIVEN TO DOWNSLOPE LANDS AND WATERWAYS. MAKE ONGOING CHANGES TO THE PLAN WHERE IT PROVES INADEQUATE IN PRACTICE OR IS SUBJECT TO CHANGES IN CONDITIONS ON THE WORK-SITE OR ELSEWHERE IN THE CATCHMENT.
 - F) MAINTAIN EROSION AND SEDIMENT CONTROL STRUCTURES IN A FULLY FUNCTIONING CONDITION UNTIL ALL EARTHWORK ACTIVITIES ARE COMPLETED AND THE SITE IS REHABILITATED.
- SM2. THE SITE SUPERINTENDENT WILL KEEP A LOGBOOK MAKING ENTRIES AT LEAST WEEKLY, IMMEDIATELY BEFORE FORECAST RAIN AND AFTER RAINFALL. ENTRIES WILL INCLUDE:
 - A) THE VOLUME AND INTENSITY OF ANY RAINFALL EVENTS.
 - B) THE CONDITION OF ANY SOIL AND WATER MANAGEMENT WORKS.
 - C) THE CONDITION OF VEGETATION AND ANY NEED TO IRRIGATE.
 - D) THE NEED FOR DUST PREVENTION STRATEGIES


THE LOGBOOK WILL BE KEPT ON-SITE AND MADE AVAILABLE TO ANY AUTHORISED PERSON UPON REQUEST. IT WILL BE GIVEN TO THE SUPERINTENDENT AT THE CONCLUSION OF THE WORKS.

SEDIMENT CONTROL NOTES:

- SC1. SEDIMENT FENCES WILL BE INSTALLED AS SHOWN ON THE PLAN AND ELSEWHERE AT THE DISCRETION OF THE SITE SUPERINTENDENT TO CONTAIN SOIL AS NEAR AS POSSIBLE TO THEIR SOURCE.
- SC2. SEDIMENT FENCES WILL NOT HAVE CATCHMENT AREAS EXCEEDING 900 SQUARE METRES AND HAVE A STORAGE DEPTH OF AT LEAST 0.6 METRES.
- SC3. SEDIMENT REMOVED FROM ANY TRAPPING DEVICES WILL BE RELOCATED WHERE FURTHER POLLUTION TO DOWNSLOPE LANDS AND WATERWAYS CANNOT OCCUR.
- SC4. STOCKPILES ARE NOT TO BE LOCATED WITHIN 5 METERS OF HAZARD AREAS INCLUDING AREAS OF HIGH VELOCITY FLOWS SUCH AS WATERWAYS, PAVED AREAS AND DRIVEWAYS.
- SC5. WATER WILL BE PREVENTED FROM DIRECTLY ENTERING THE PERMANENT DRAINAGE SYSTEM UNLESS THE CATCHMENT AREA HAS BEEN PERMANENTLY LANDSCAPED AND/OR WATER HAS BEEN TREATED BY AN APPROVED DEVICE.
- SC6. TEMPORARY SEDIMENT TRAPS WILL REMAIN IN PLACE UNTIL AFTER THE LANDS THEY ARE PROTECTING ARE COMPLETELY REHABILITATED.
- SC7. ACCESS TO SITES SHOULD BE STABILIZED TO REDUCE THE LIKELIHOOD OF VEHICLES TRACKING SOIL MATERIALS ONTO PUBLIC ROADS AND ENSURE ALL-WEATHER ENTRY/EXIT.

LAND DISTURBANCE NOTES:


- LD1. ACCESS AREAS ARE TO BE LIMITED TO A MAXIMUM WIDTH OF 10 METERS. THE SITE MANAGER WILL DETERMINE AND MARK THE LOCATION OF THESE ZONES ON-SITE. ALL SITE WORKERS WILL CLEARLY RECOGNIZE THOSE BOUNDARIES THAT, WHERE APPROPRIATE, ARE IDENTIFIED WITH A BARRIER FENCING (UPSLOPE) AND SEDIMENT FENCING (DOWNSLOPE) OR SIMILAR MATERIALS.
- LD2. ENTRY TO LANDS NOT REQUIRED FOR CONSTRUCTION OR ACCESS IS PROHIBITED EXCEPT FOR ESSENTIAL THINNING OF PLANT GROWTH.
- LD3. WORKS ARE TO PROCEED IN THE FOLLOWING SEQUENCE:
 - A) INSTALL ALL BARRIER AND SEDIMENT FENCING WHERE SHOWN ON THE PLAN.
 - B) CONSTRUCT THE STABILISED SITE ACCESS.
 - C) CONSTRUCT DIVERSION DRAINS AS REQUIRED.
 - D) INSTALL MESH AND GRAVEL INLETS FOR ANY ADJACENT KERB INLETS.
 - E) INSTALL GEOTEXTILE INLET FILTERS AROUND ANY ON-SITE DROP INLET PITS.
 - F) CLEAR SITE AND STRIP AND STOCKPILE TOPSOIL IN LOCATIONS SHOWN ON THE PLAN.
 - G) UNDERTAKE ALL ESSENTIAL CONSTRUCTION WORKS ENSURING THAT ROOF AND/OR PAVED AREA STORMWATER SYSTEMS ARE CONNECTED TO PERMANENT DRAINAGE AS SOON AS PRACTICABLE.
 - H) GRADE LOT AREAS TO FINAL GRADES AND APPLY PERMANENT STABILISATION (LANDSCAPING) WITHIN 20 DAYS OF COMPLETION OF CONSTRUCTION WORKS.
 - I) REMOVE TEMPORARY EROSION CONTROL MEASURES AFTER THE PERMANENT LANDSCAPING HAS BEEN COMPLETED.
- LD4. ENSURE THAT SLOPE LENGTHS DO NOT EXCEED 80 METRES WHERE PRACTICABLE. SLOPE LENGTHS ARE DETERMINED BY SILTATION FENCING AND CATCH DRAIN SPACING.

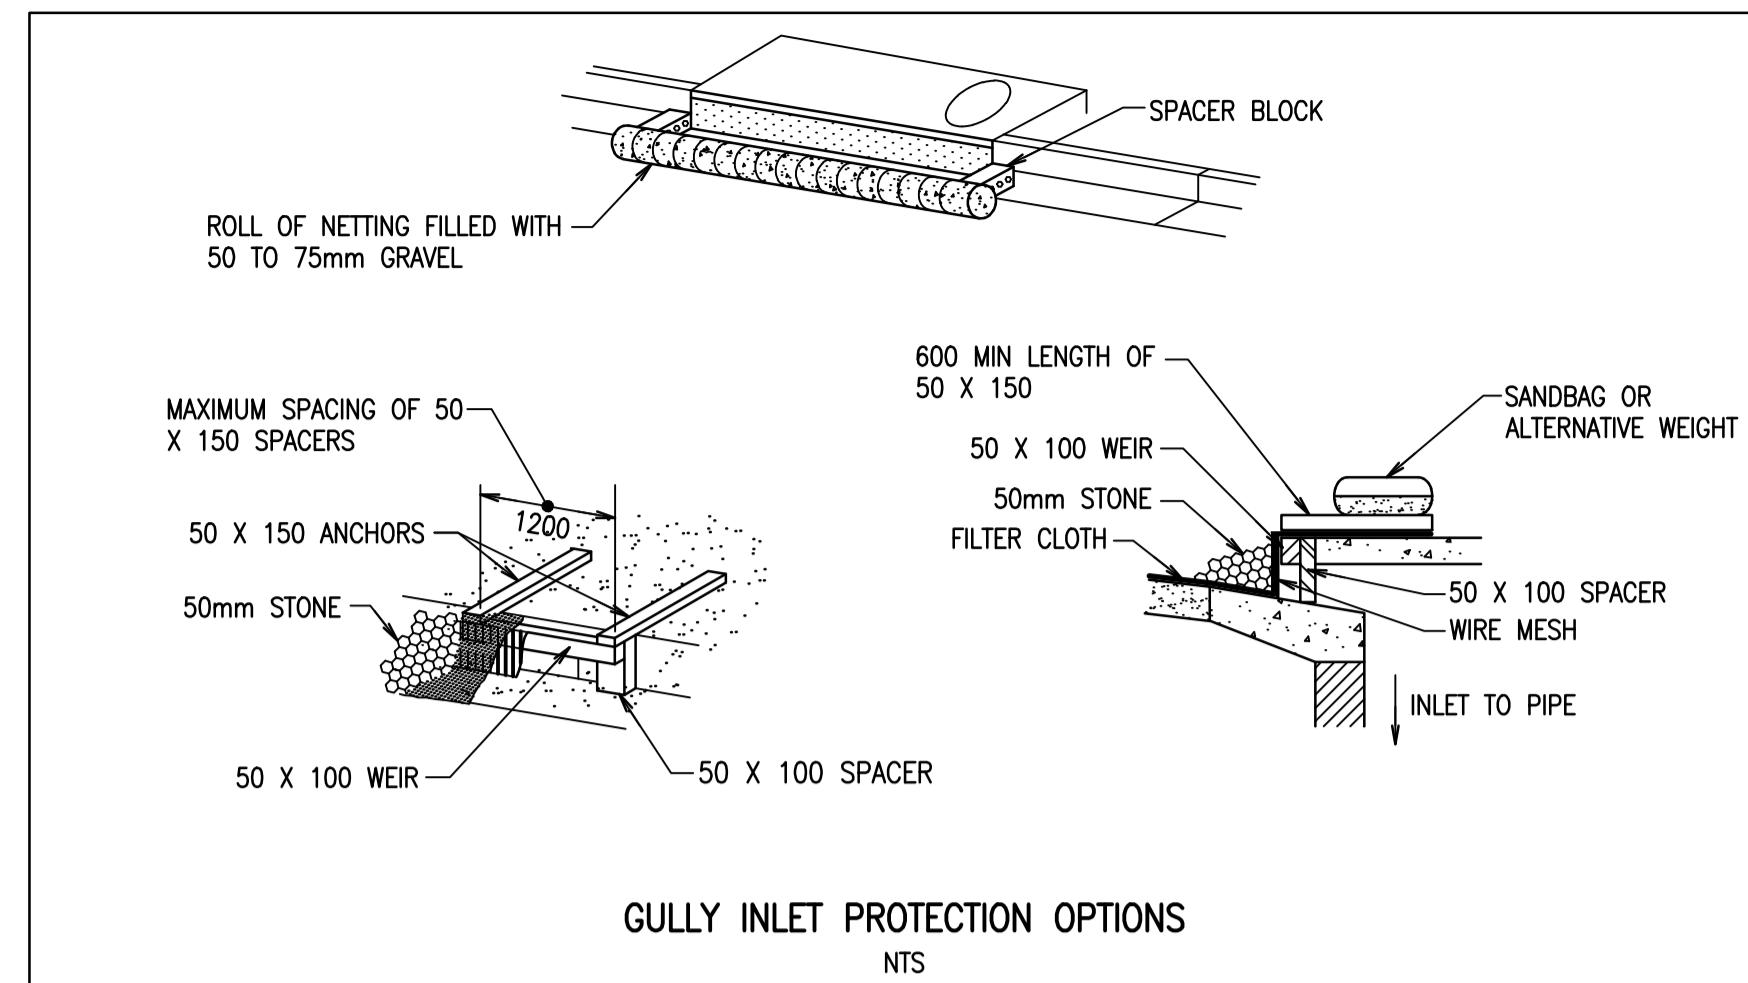

GULLY INLET PROTECTION OPTIONS
NTS

SOIL EROSION CONTROL NOTES:

- SE1. EARTH BATTERS WILL BE CONSTRUCTED WITH AS LOW A GRADIENT AS PRACTICABLE BUT NO STEEPER, UNLESS OTHERWISE NOTES, THAN THAT RECOMMENDED BY THE GEOTECHNICAL REPORT.
- SE2. ALL WATERWAYS, DRAINS, SPILLWAYS AND THEIR OUTLETS WILL BE CONSTRUCTED TO BE STABLE IN AT LEAST THE 1:20 YEAR ARI, TIME OF CONCENTRATION STORM EVENT.
- SE3. WATERWAYS AND OTHER AREAS SUBJECT TO CONCENTRATED FLOWS AFTER CONSTRUCTION ARE TO HAVE A MAXIMUM GROUNDCOVER C-FACTOR OF 0.05 (70% GROUNDCOVER) WITHIN 10 WORKING DAYS FROM COMPLETION OF FORMATION. FOOT AND VEHICULAR TRAFFIC WILL BE PROHIBITED IN THESE AREAS.
- SE4. STOCKPILES AFTER CONSTRUCTION ARE TO HAVE A MAXIMUM GROUNDCOVER C-FACTOR OF 0.1% (60% GROUNDCOVER) WITHIN 10 WORKING DAYS FROM COMPLETION OF FORMATION.
- SE5. ALL LANDS, INCLUDING WATERWAYS AND STOCKPILES DURING CONSTRUCTION ARE TO HAVE A MAXIMUM GROUNDCOVER C-FACTOR OF 0.15 (50% GROUNDCOVER) WITHIN 20 WORKING DAYS FROM INACTIVITY EVEN THOUGH WORKS MAY CONTINUE LATER.
- SE6. PERMANENT REHABILITATION OF LANDS AFTER CONSTRUCTION WILL ACHIEVE A GROUNDCOVER C-FACTOR OF LESS THAN 0.1 AND LESS THAN 0.05 WITHIN 60 DAYS. NEWLY PLANTED LANDS WILL BE WATERED REGULARLY UNTIL AN EFFECTIVE COVER IS ESTABLISHED AND PLANTS ARE GROWING VIGOROUSLY. FOLLOW-UP SEED AND FERTILISER WILL BE APPLIED AS NECESSARY.

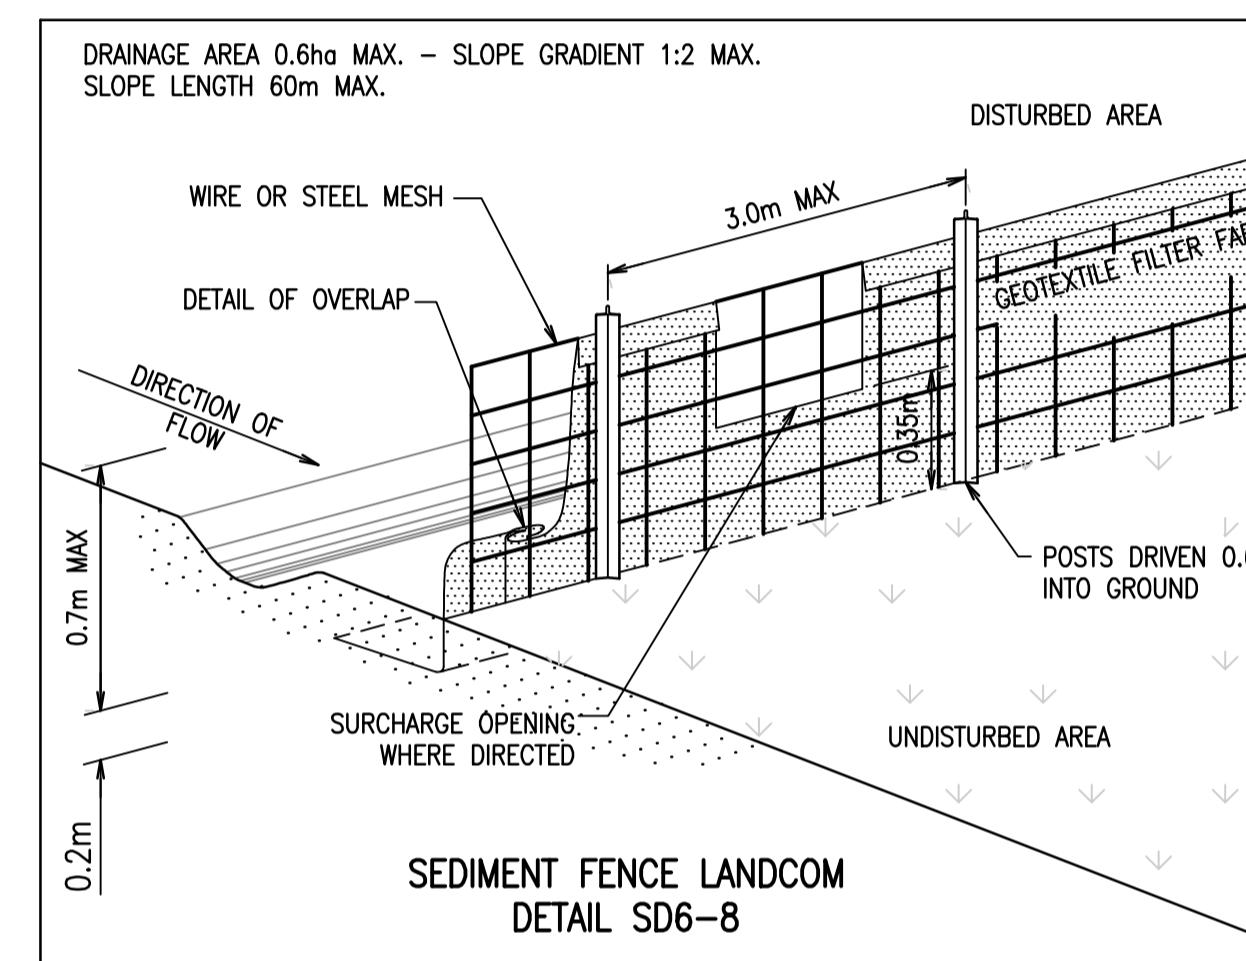




INSTALLATION

1. EXCAVATE A TRENCH 200mm DEEP.
2. DRIVE POSTS 500-700mm INTO GROUND AT A MAXIMUM SPACING OF 3.0m CENTRES.
3. PLACE AND FIX SUPPORT MESH (F52) TO POST.
4. LAY BIDIM GEOFABRIC (SF 2000) AGAINST THE SUPPORT MESH AND FIX BY TIE WIRE, STAPLES OR HOG RINGS.
5. PLACE BIDIM IN TRENCH AND BACKFILL WITH SOIL.

NOTE:
POSITION OF SEDIMENT FENCE AS DIRECTED BY SUPERINTENDENT. FENCE TO REMAIN IN PLACE UNTIL EXCAVATION IS BELOW FOOTPATH LEVEL.

WASTE CONTROL NOTES:

- WC1. ACCEPTABLE BINS WILL BE PROVIDED FOR ANY CONCRETE AND MORTAR SLURRIES, PAINTS, ACID WASHING, LIGHTWEIGHT WASTE MATERIALS AND LITTER. CLEARANCE SERVICES WILL BE PROVIDED AT LEAST WEEKLY. DISPOSAL OF WASTE WILL BE IN A MANNER APPROVED BY THE SITE SUPERINTENDENT.
- WC2. ALL POSSIBLE POLLUTANT MATERIALS ARE TO BE STORED WELL CLEAR OF ANY POORLY DRAINED AREAS, FLOW PRONE AREAS, STREAMBANKS, CHANNELS AND STORMWATER DRAINAGE AREAS. STORE SUCH MATERIALS IN A DESIGNATED AREA UNDER COVER WHERE POSSIBLE AND WITHIN CONTAINMENT BUNDS.
- WC3. ALL SITE STAFF AND SUBCONTRACTORS ARE TO BE INFORMED OF THEIR OBLIGATION TO USE WASTE CONTROL FACILITIES PROVIDED.
- WC4. ANY DE-WATERING ACTIVITIES ARE TO BE CLOSELY MONITORED TO ENSURE THAT WATER IS NOT POLLUTED BY SEDIMENT, TOXIC MATERIALS OR PETROLEUM PRODUCTS.
- WC5. PROVIDE DESIGNATED VEHICULAR WASHDOWN AND MAINTENANCE AREAS WHICH ARE TO HAVE CONTAINMENT BUNDS.

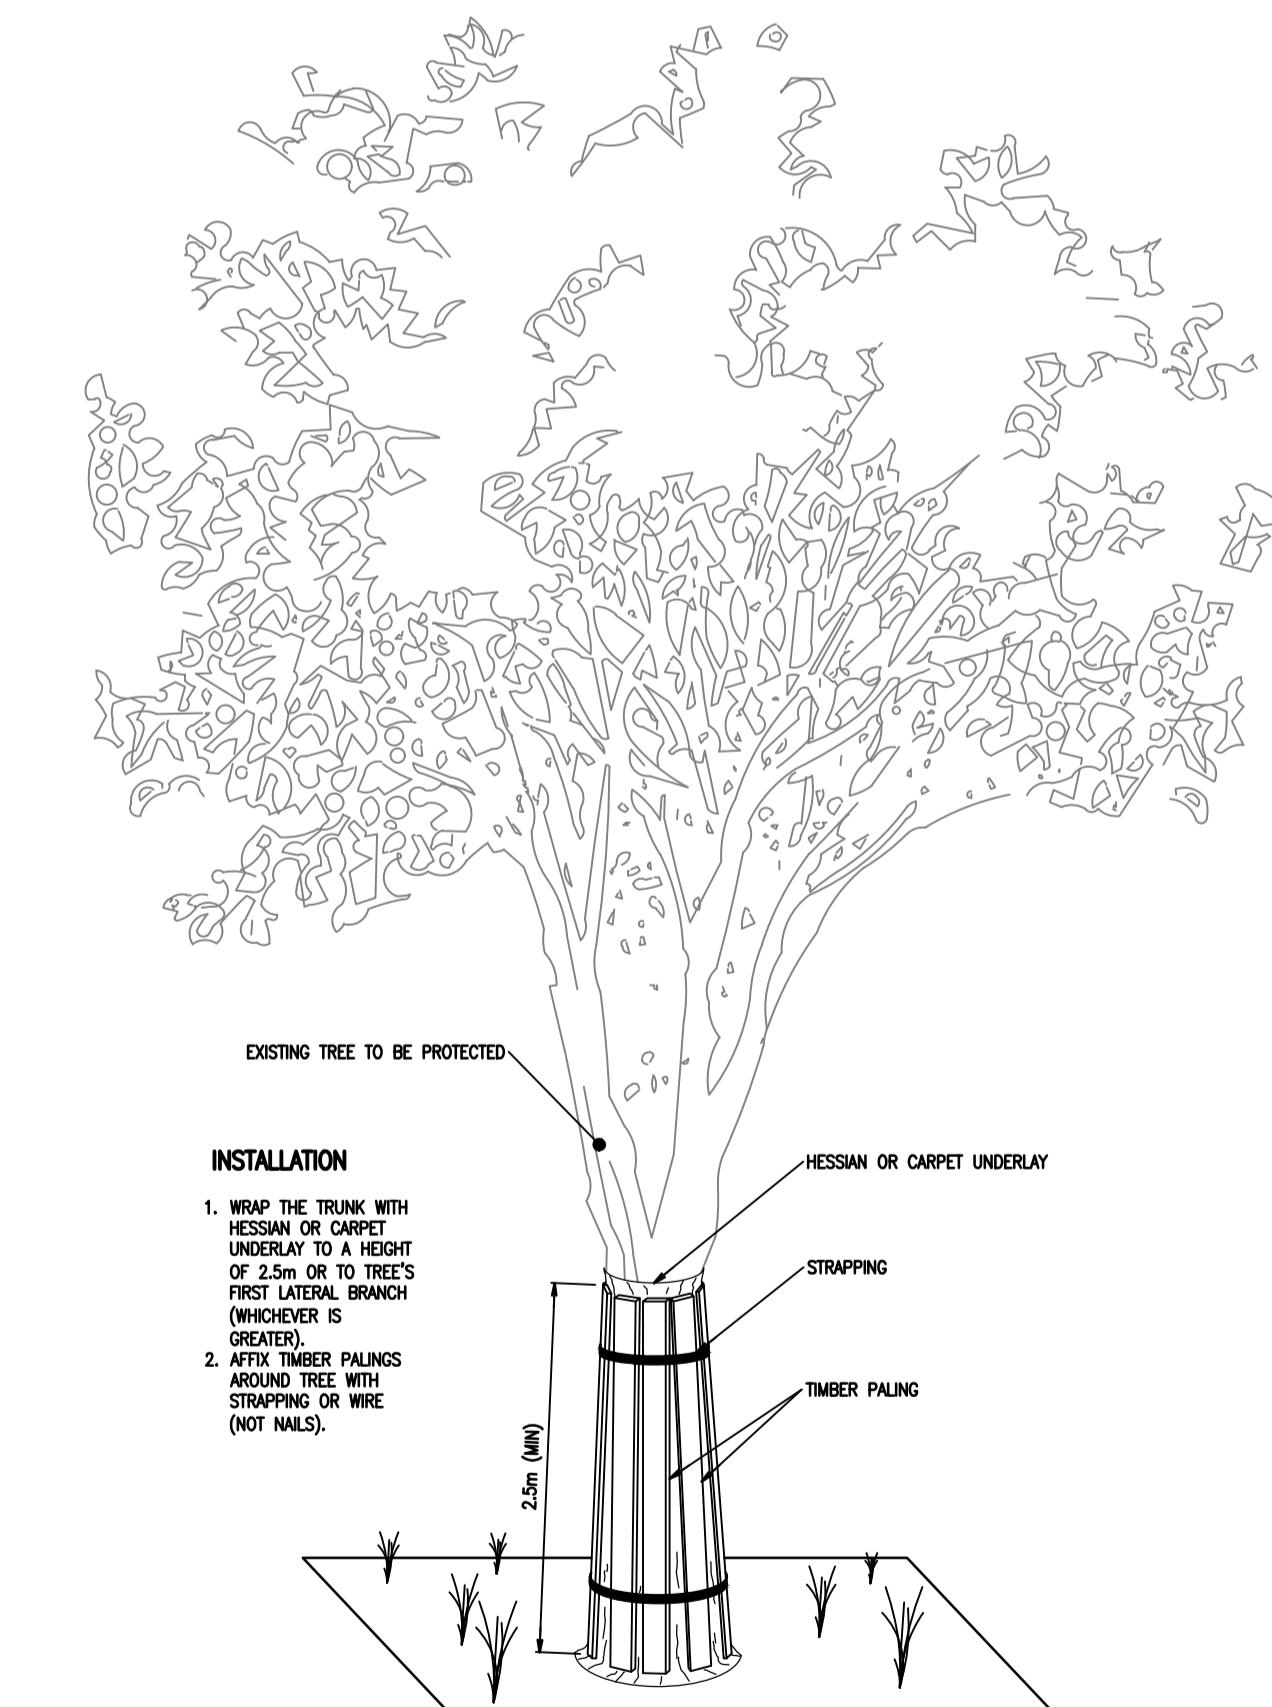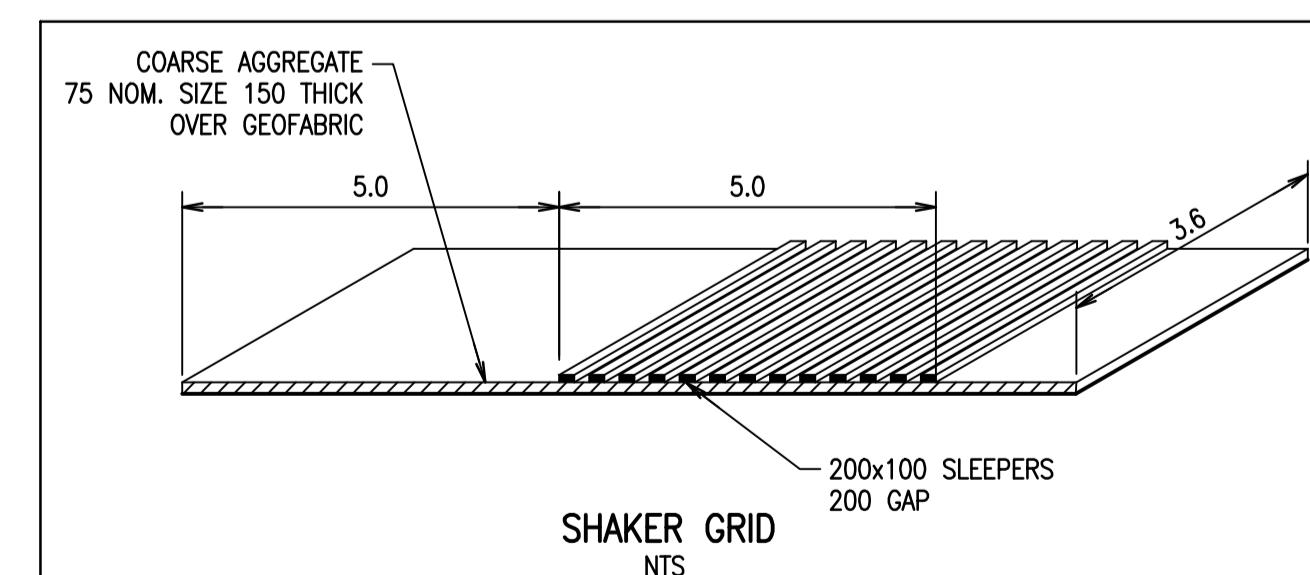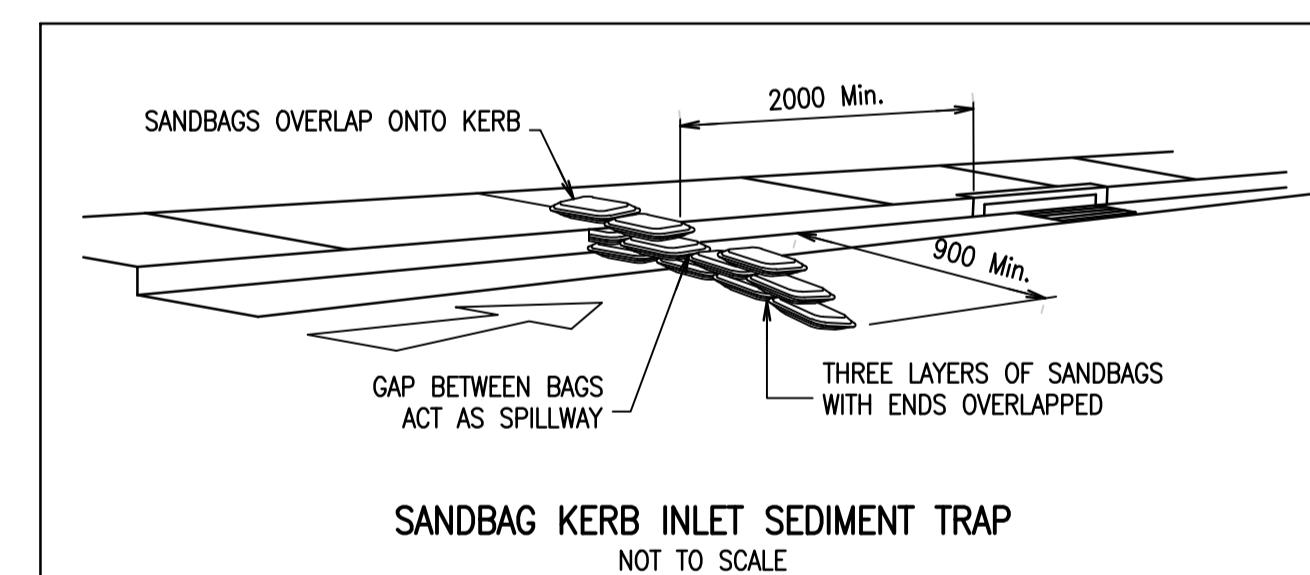

GENERAL NOTES:

- 1 ISSUED FOR DEVELOPMENT APPLICATION ZJ CR 30.11.18

GENERAL NOTES:

- Rev Revision Description By App Date

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- Rev Revision Description By App Date

GENERAL NOTES:

- 1 ISSUED FOR DEVELOPMENT APPLICATION ZJ CR 30.11.18

GENERAL NOTES:

- Rev Revision Description By App Date

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- 1 ISSUED FOR DEVELOPMENT APPLICATION ZJ CR 30.11.18

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GENERAL NOTES:

- Rev Revision Description By App Date

EARTHWORKS ANALYSIS

THIS PLAN DENOTES THE PROPOSED DEPTH OF BULK EARTHWORKS:

GROSS CUT VOLUME 15,750m³
GROSS FILL VOLUME 0m³
NET VOLUME 15,750m³ (CUT)

SOIL ESTIMATION;

GENERAL SOLID WASTE (GWS)
– 1100m³


EXCAVATED NATURAL MATERIAL
(ENM)/VIRGIN EXCAVATED NATURAL
MATERIAL
–14,650m³

CUT & FILL ANALYSIS ASSUMPTIONS:

- ANALYSIS HAS NOT INCORPORATED STRUCTURAL FOOTINGS, CONSTRUCTION ACCESS RAMPS, BASEMENT SERVICE TRENCHES OR TREES.
- 1:1 TEMPORARY BATTERS HAVE BEEN ALLOWED FOR SAFE WORKING BATTERS REFER TO GEOTECHNICAL REPORT 86415.03.R.001.Rev0.GEOTECH.
- SHORING ASSUMED TO BE VERTICAL.
- EXISTING LEVELS BASED ON SURVEY DATA "6083-DET-2", DATE OF SURVEY 10/01/2019.
- EARTHWORKS ANALYSIS DOES NOT INCLUDE MATERIAL BULKING VALUES THROUGH EXCAVATION.
- BULK EARTHWORKS CALCULATED TO THE UNDERSIDE OF THE RAFT SLAB . NO PAD FOOTINGS OR PILES HAVE BEEN ALLOWED.
- BUILDING LEVELS BASED ON SECTION DRAWING "2B-6 HASSALL STREET PARRAMATTA SCHEMATIC DESIGN DEC 2018, EAST-WEST SECTION.
- VOLUME OF SOIL MATERIAL IS AN ESTIMATION ONLY. THE CALCULATIONS ARE BASED ON THE GEOTECHNICAL REPORT, 86415.03.R.001.Rev0.GEOTECH

LEGEND		
BEL	BULK EARTHWORKS LEVEL	
—	PROPOSED BASEMENT OUTLINE	
—	BATTER	

Surface Analysis: Elevation Ranges			
Number	Color	Minimum Elevation (m)	Maximum Elevation (m)
1	■	-10.700	-10.000
2	■	-10.000	-9.500
3	■	-9.500	-9.000
4	■	-9.000	-8.500
5	■	-8.500	-8.000
6	■	-8.000	-7.500
7	■	-7.500	-7.000
8	■	-7.000	-6.500
9	■	-6.500	-6.200
10	■	-6.200	-5.900
11	■	-5.900	-5.600
12	■	-5.600	-5.300
13	■	-5.300	-5.000
14	■	-5.000	-4.700
15	■	-4.700	-4.400
16	■	-4.400	-4.100
17	■	-4.100	0.100

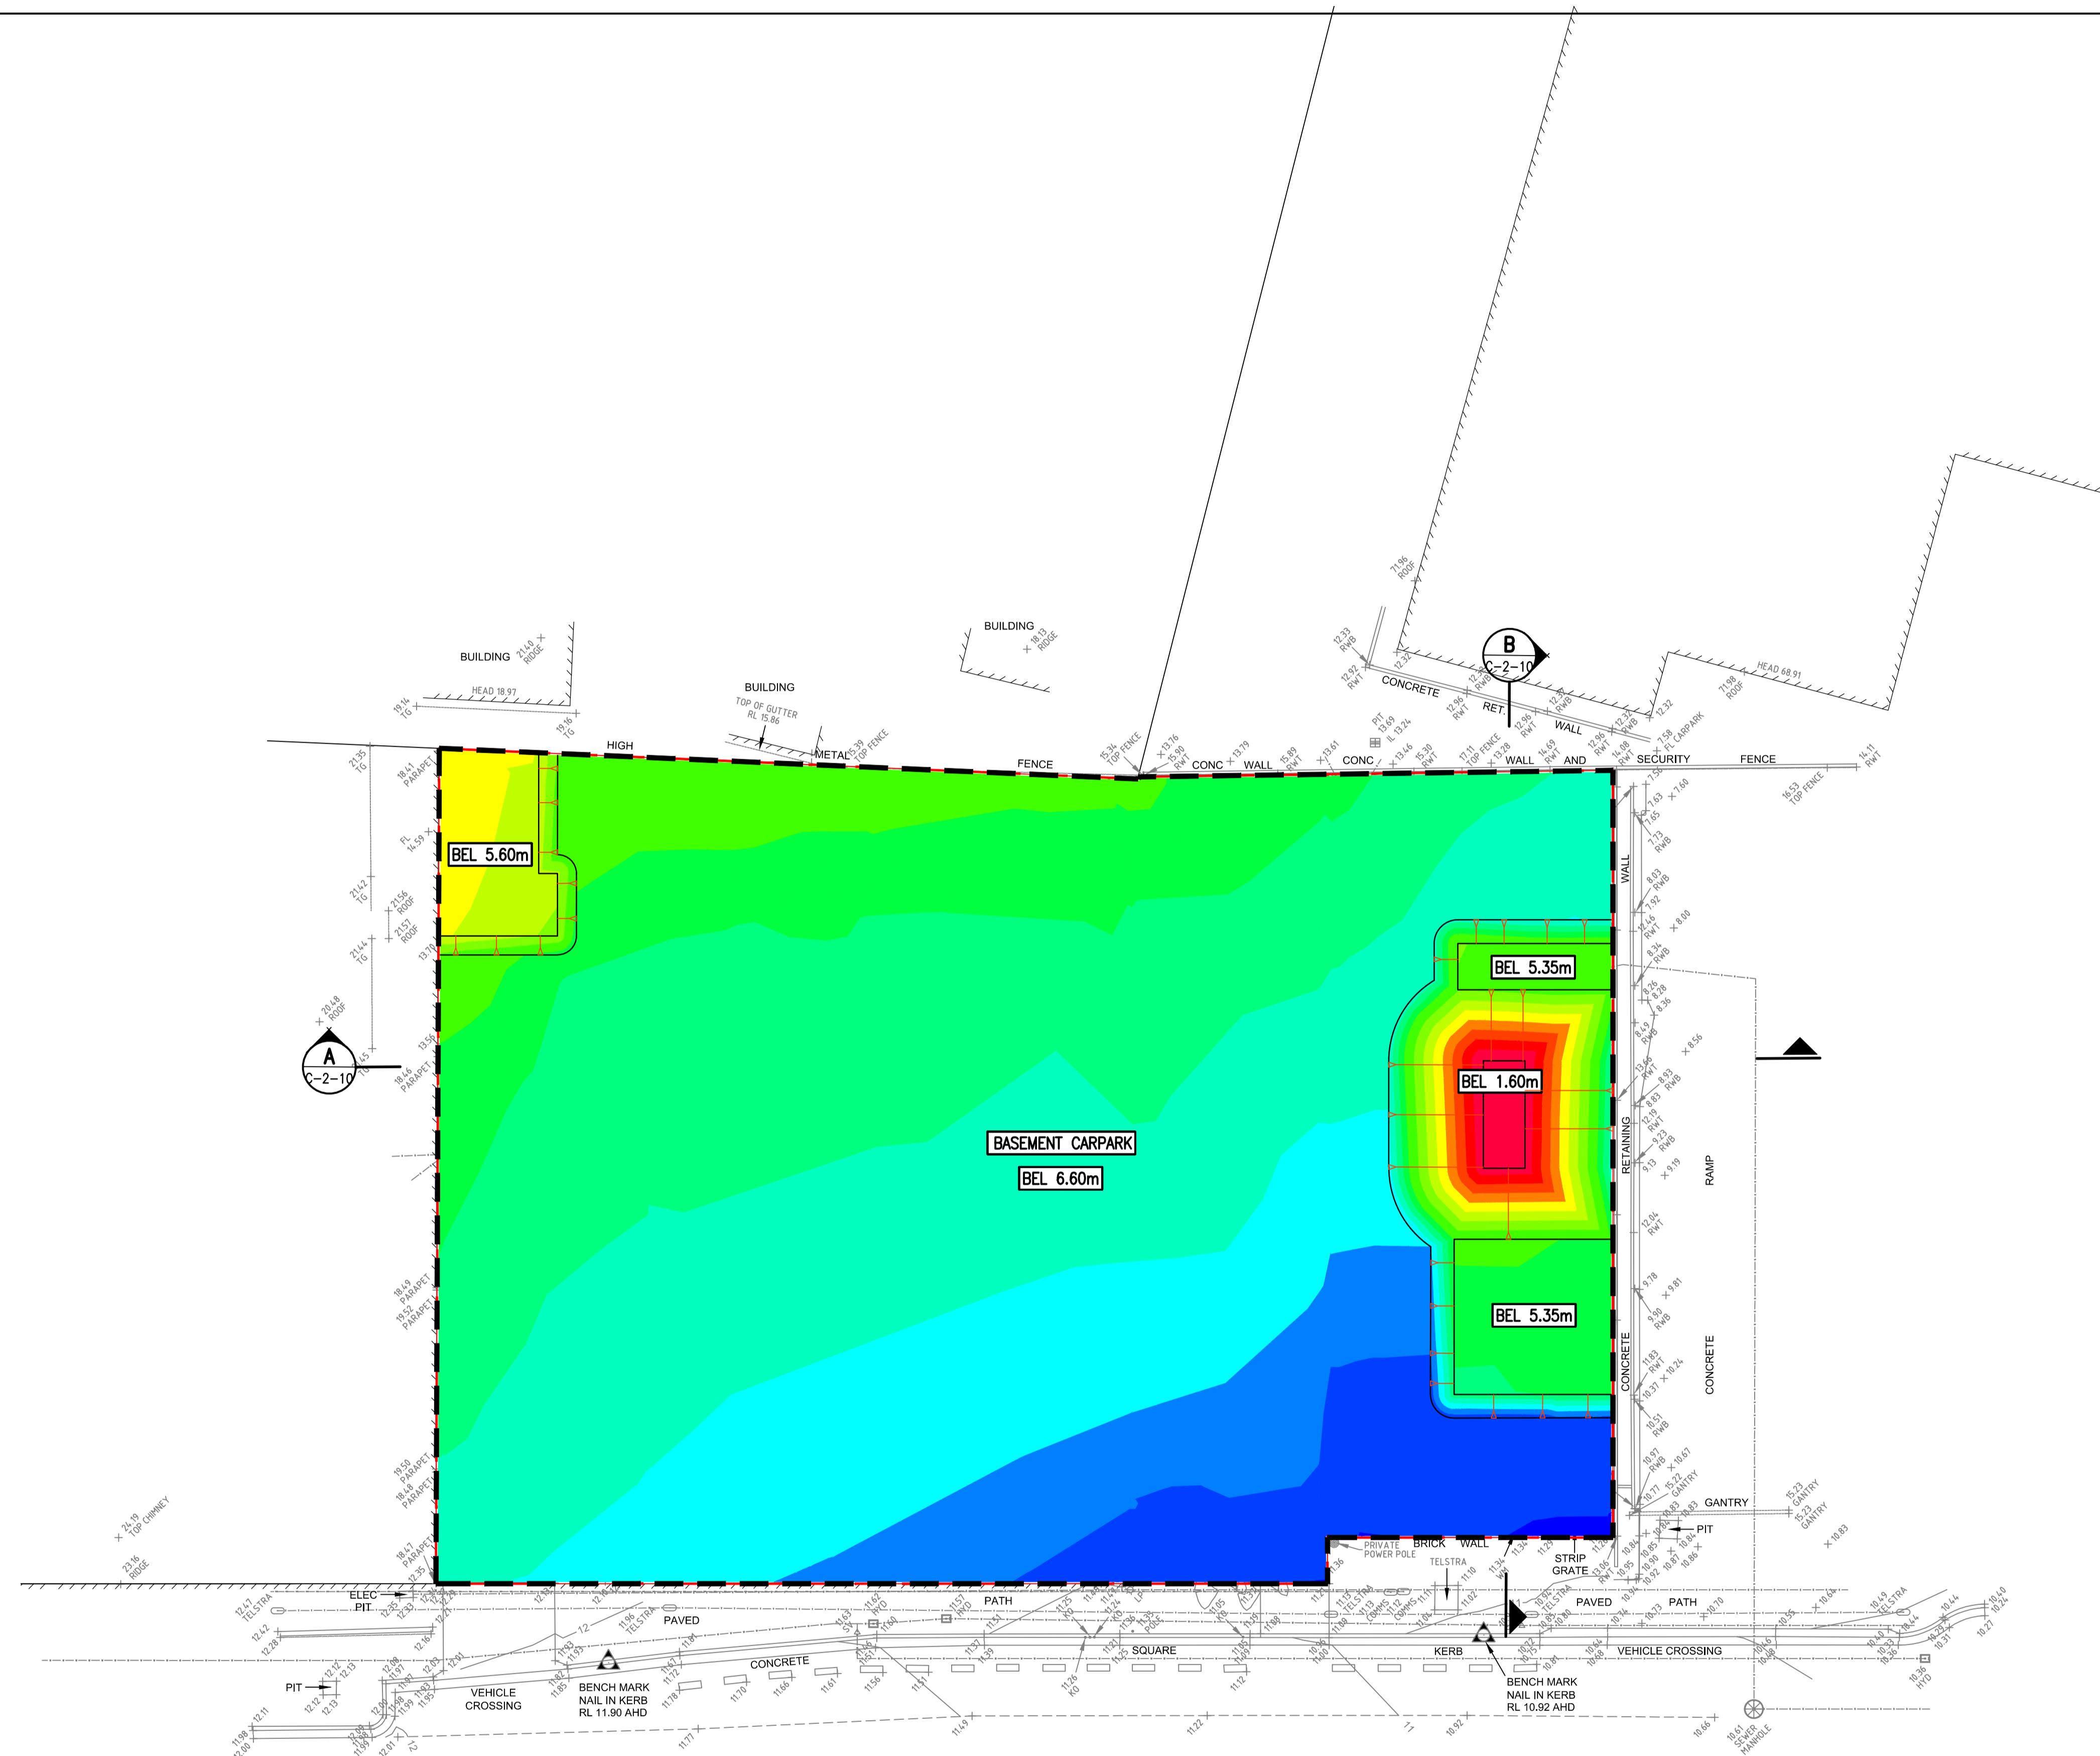

Rev Revision Description By App Date

1 ISSUED FOR DEVELOPMENT APPLICATION ZJ CR 15.01.19
2 ISSUED FOR DEVELOPMENT APPLICATION ZJ CR 01.03.19

Rev Revision Description By App Date

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ACN 010 589 748

Client



Title BULK EARTHWORKS PLAN

Project 2B-6 HASSALL STREET

PARRAMATTA

Scale at A1
AS SHOWN

Date 01.03.19

Drawn Z.JONES

Designer Z.JONES

Approved C.ROPE


Job Number 18570C

NOT FOR CONSTRUCTION


Drawing Number C-2-01

Revision 2

SCALE 1:200
mm
2 0 2 4 6 8m

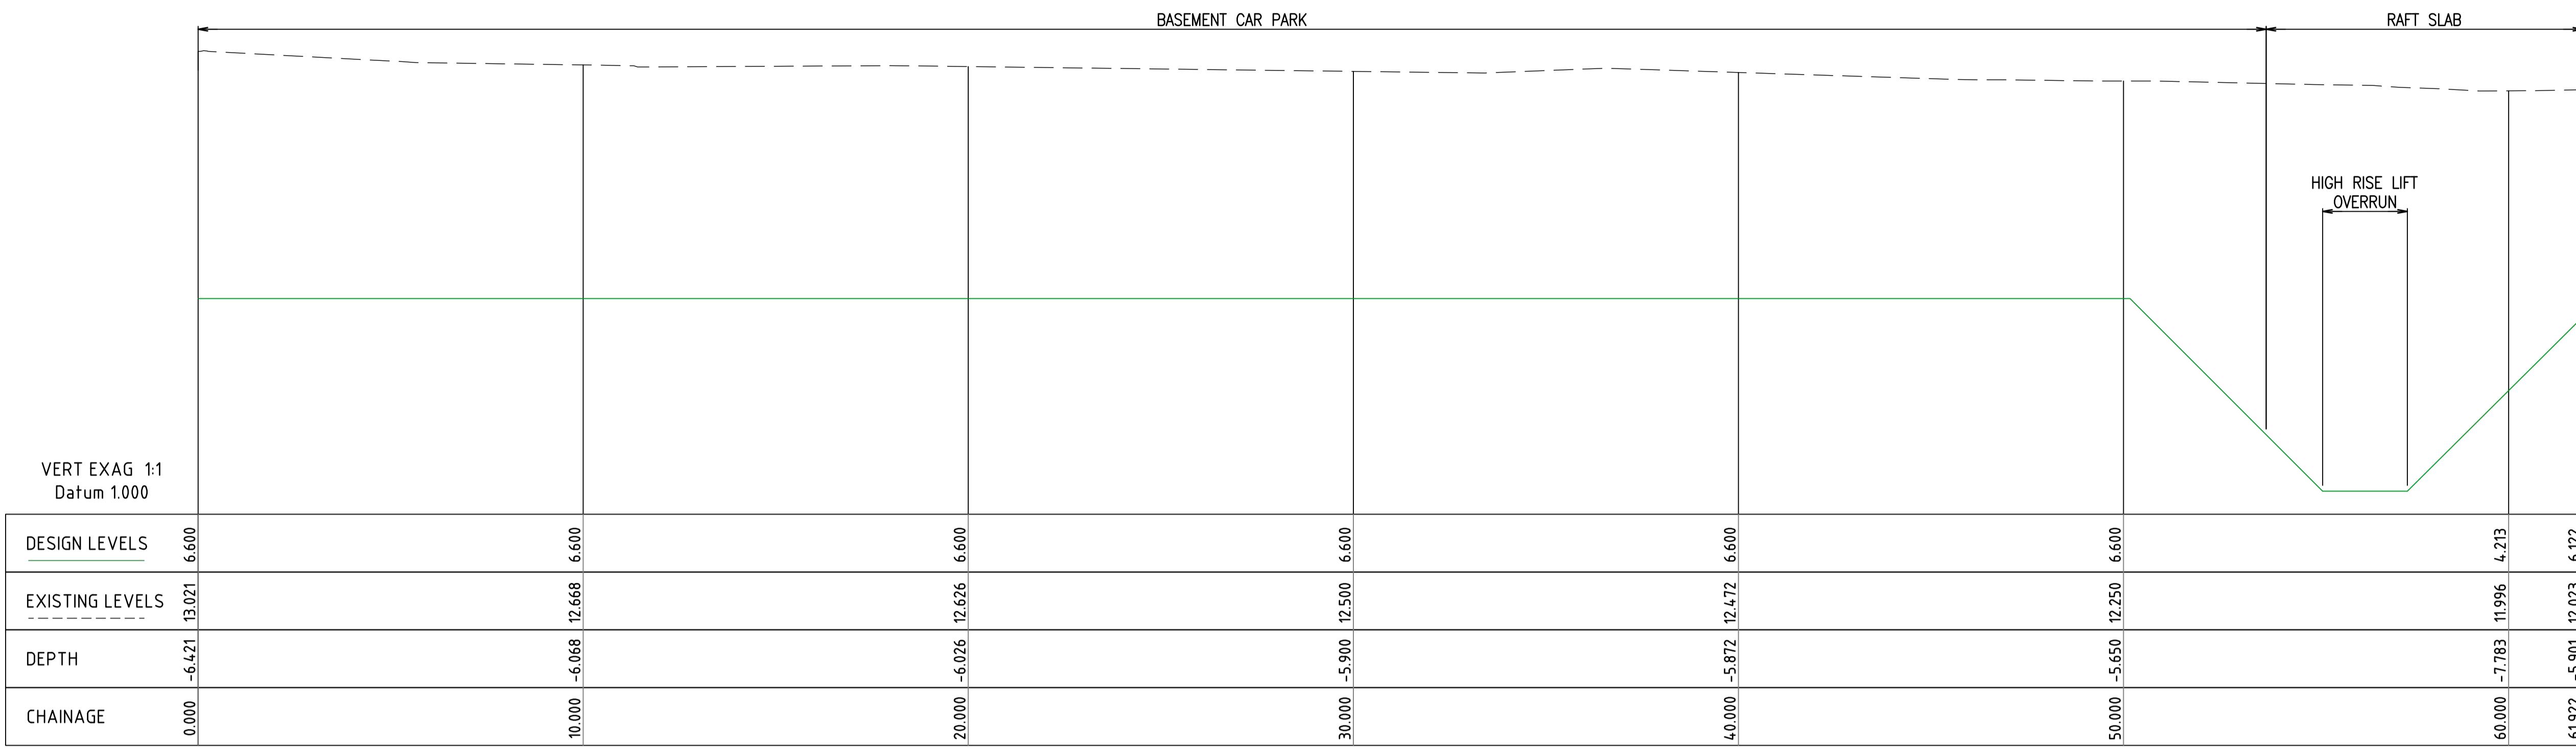

SECTION A - LONG SECTION

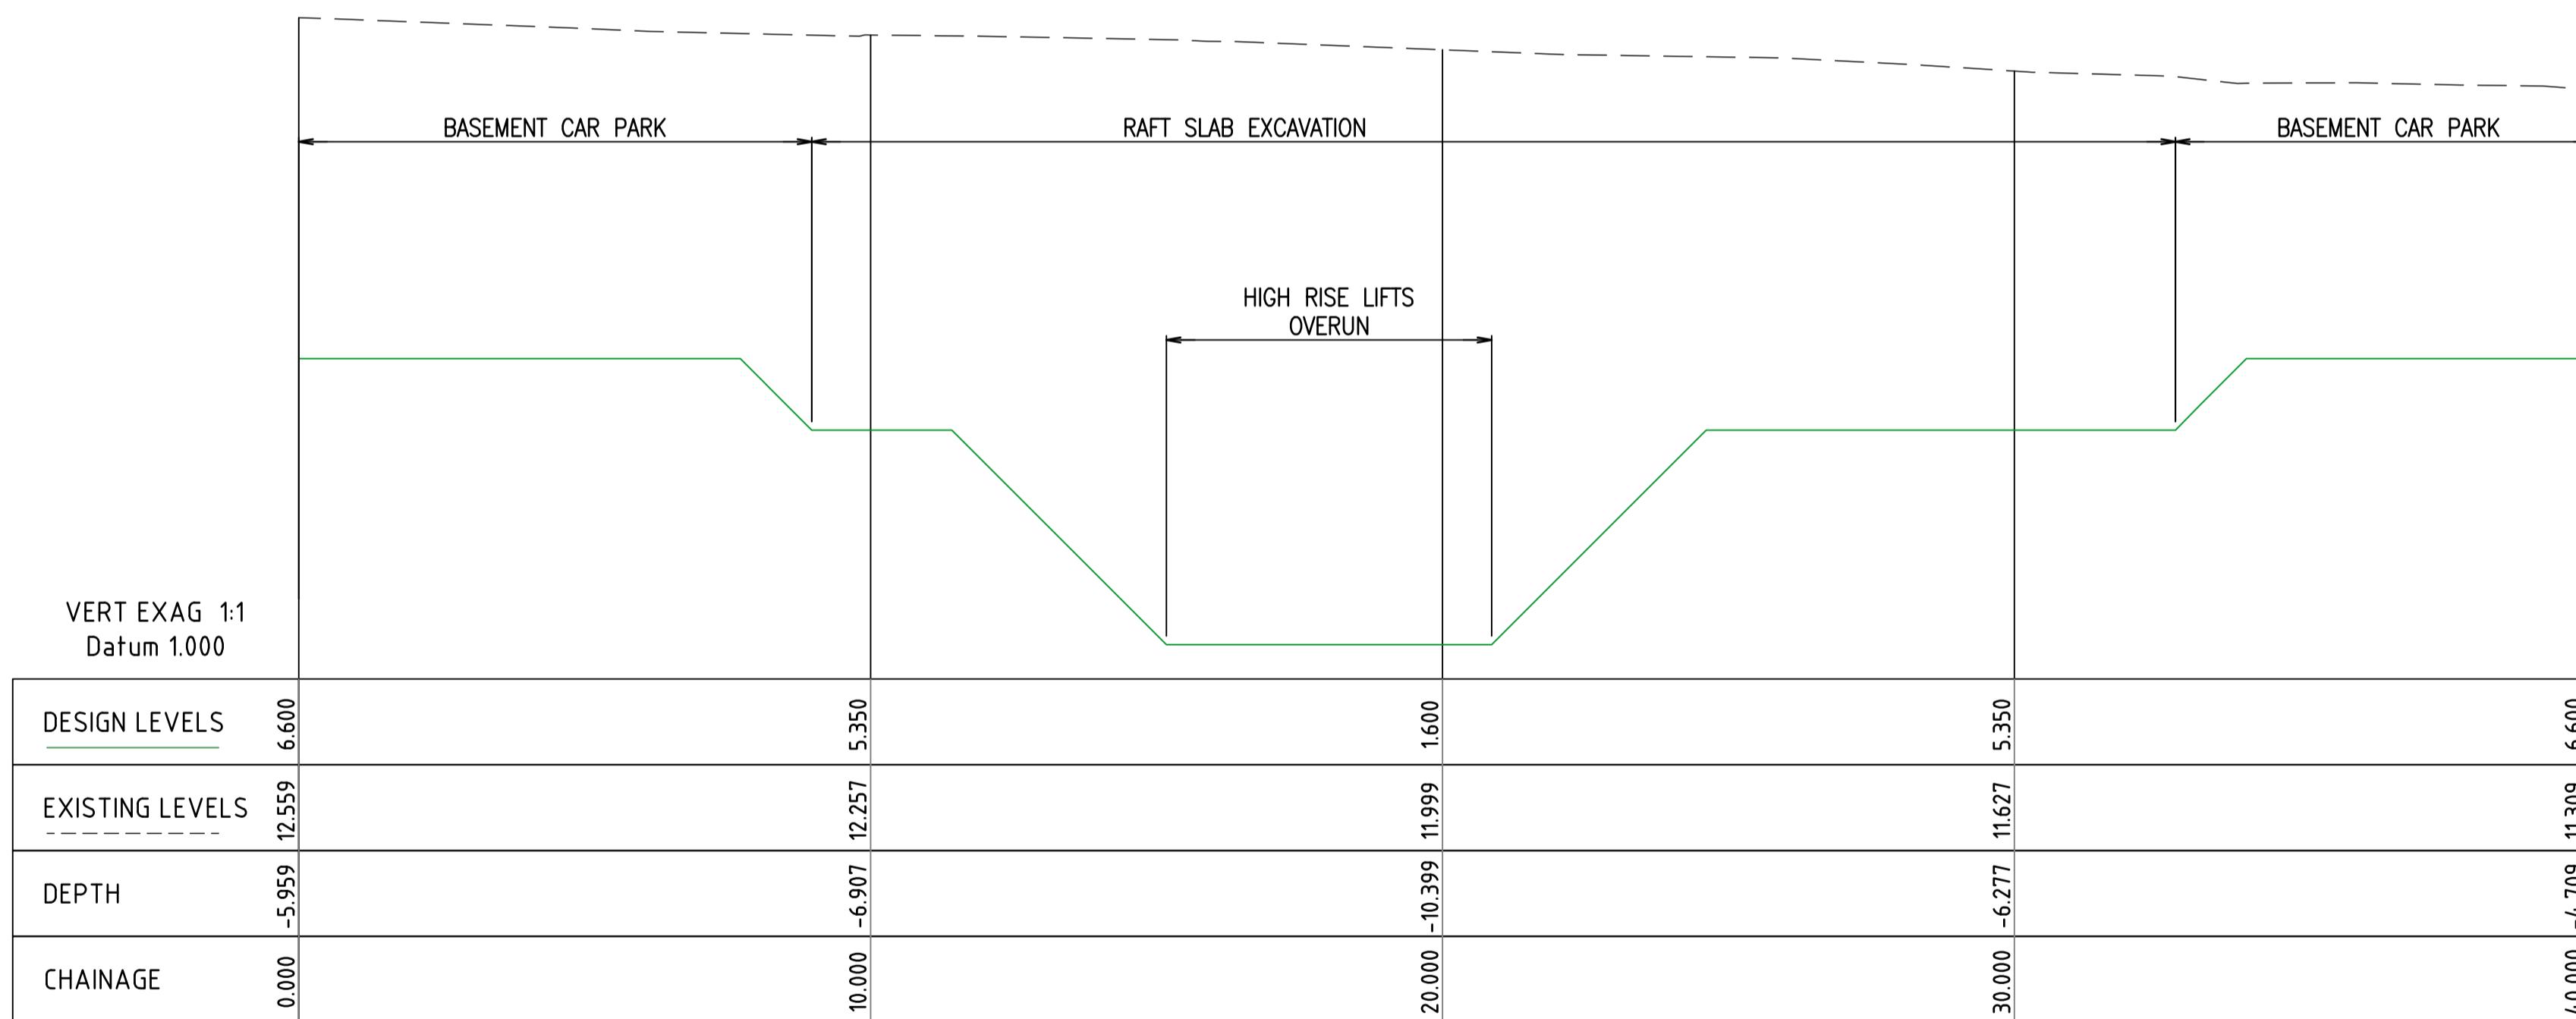

SECTION B - LONG SECTION

SCALE 1:100

Rev	Revision	Description	By	App	Date
1	ISSUED FOR DEVELOPMENT APPLICATION	ZJ CR			15.01.19
2	ISSUED FOR DEVELOPMENT APPLICATION	ZJ CR			01.03.19

Rev	Revision	Description	By	App	Date

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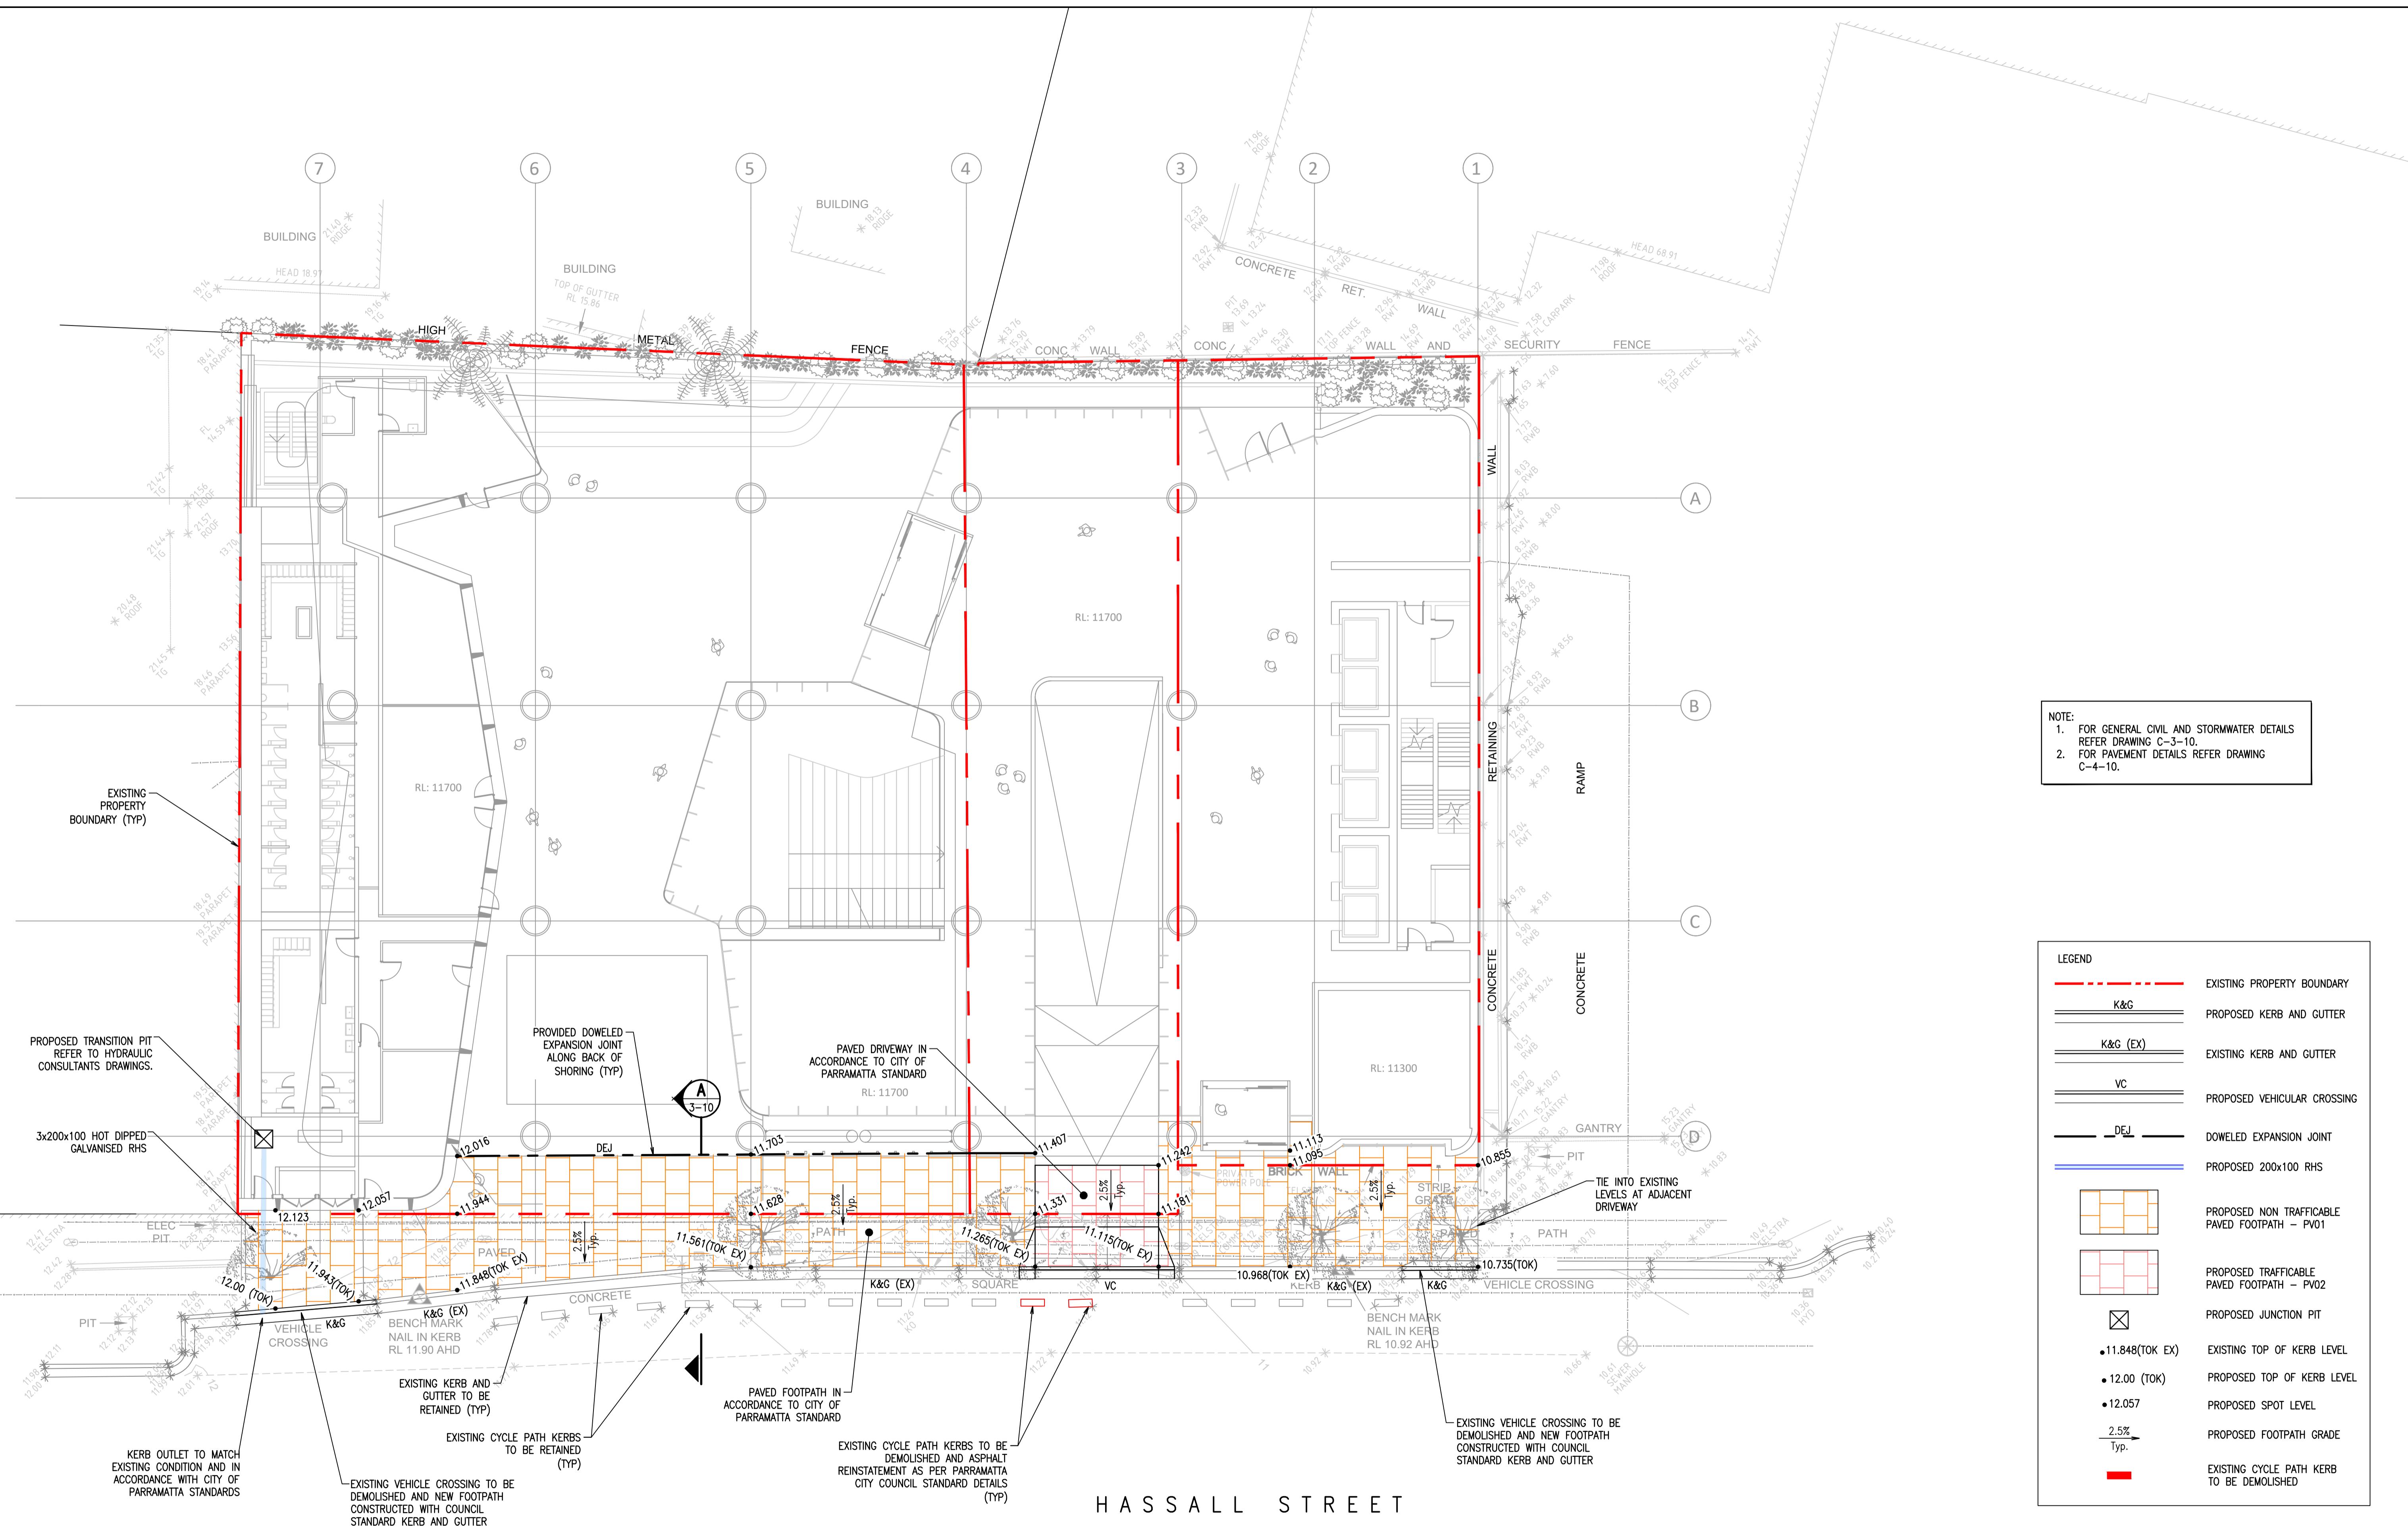
Client



Title
**BULK EARTHWORKS
SECTIONS**

Project
**2B-6 HASSALL STREET
PARRAMATTA**

Scale at A1 AS SHOWN	Drawn Z.JONES	Design Checker C.WAITE
Date 01.03.19	Approved Z.JONES	Approved C.ROPE
	Job Number 18570C	
	NOT FOR CONSTRUCTION	
Drawing Number C-2-10		Revision 2



SCALE 1:150
2 0 2 4 6 8m

Rev	Revision	Description	By	App	Date
1	ISSUED FOR DEVELOPMENT APPLICATION	ZJ CR 04.03.19			
2	ISSUED FOR DEVELOPMENT APPLICATION	ZJ CR 03.04.19			

Rev	Revision	Description	By	App	Date

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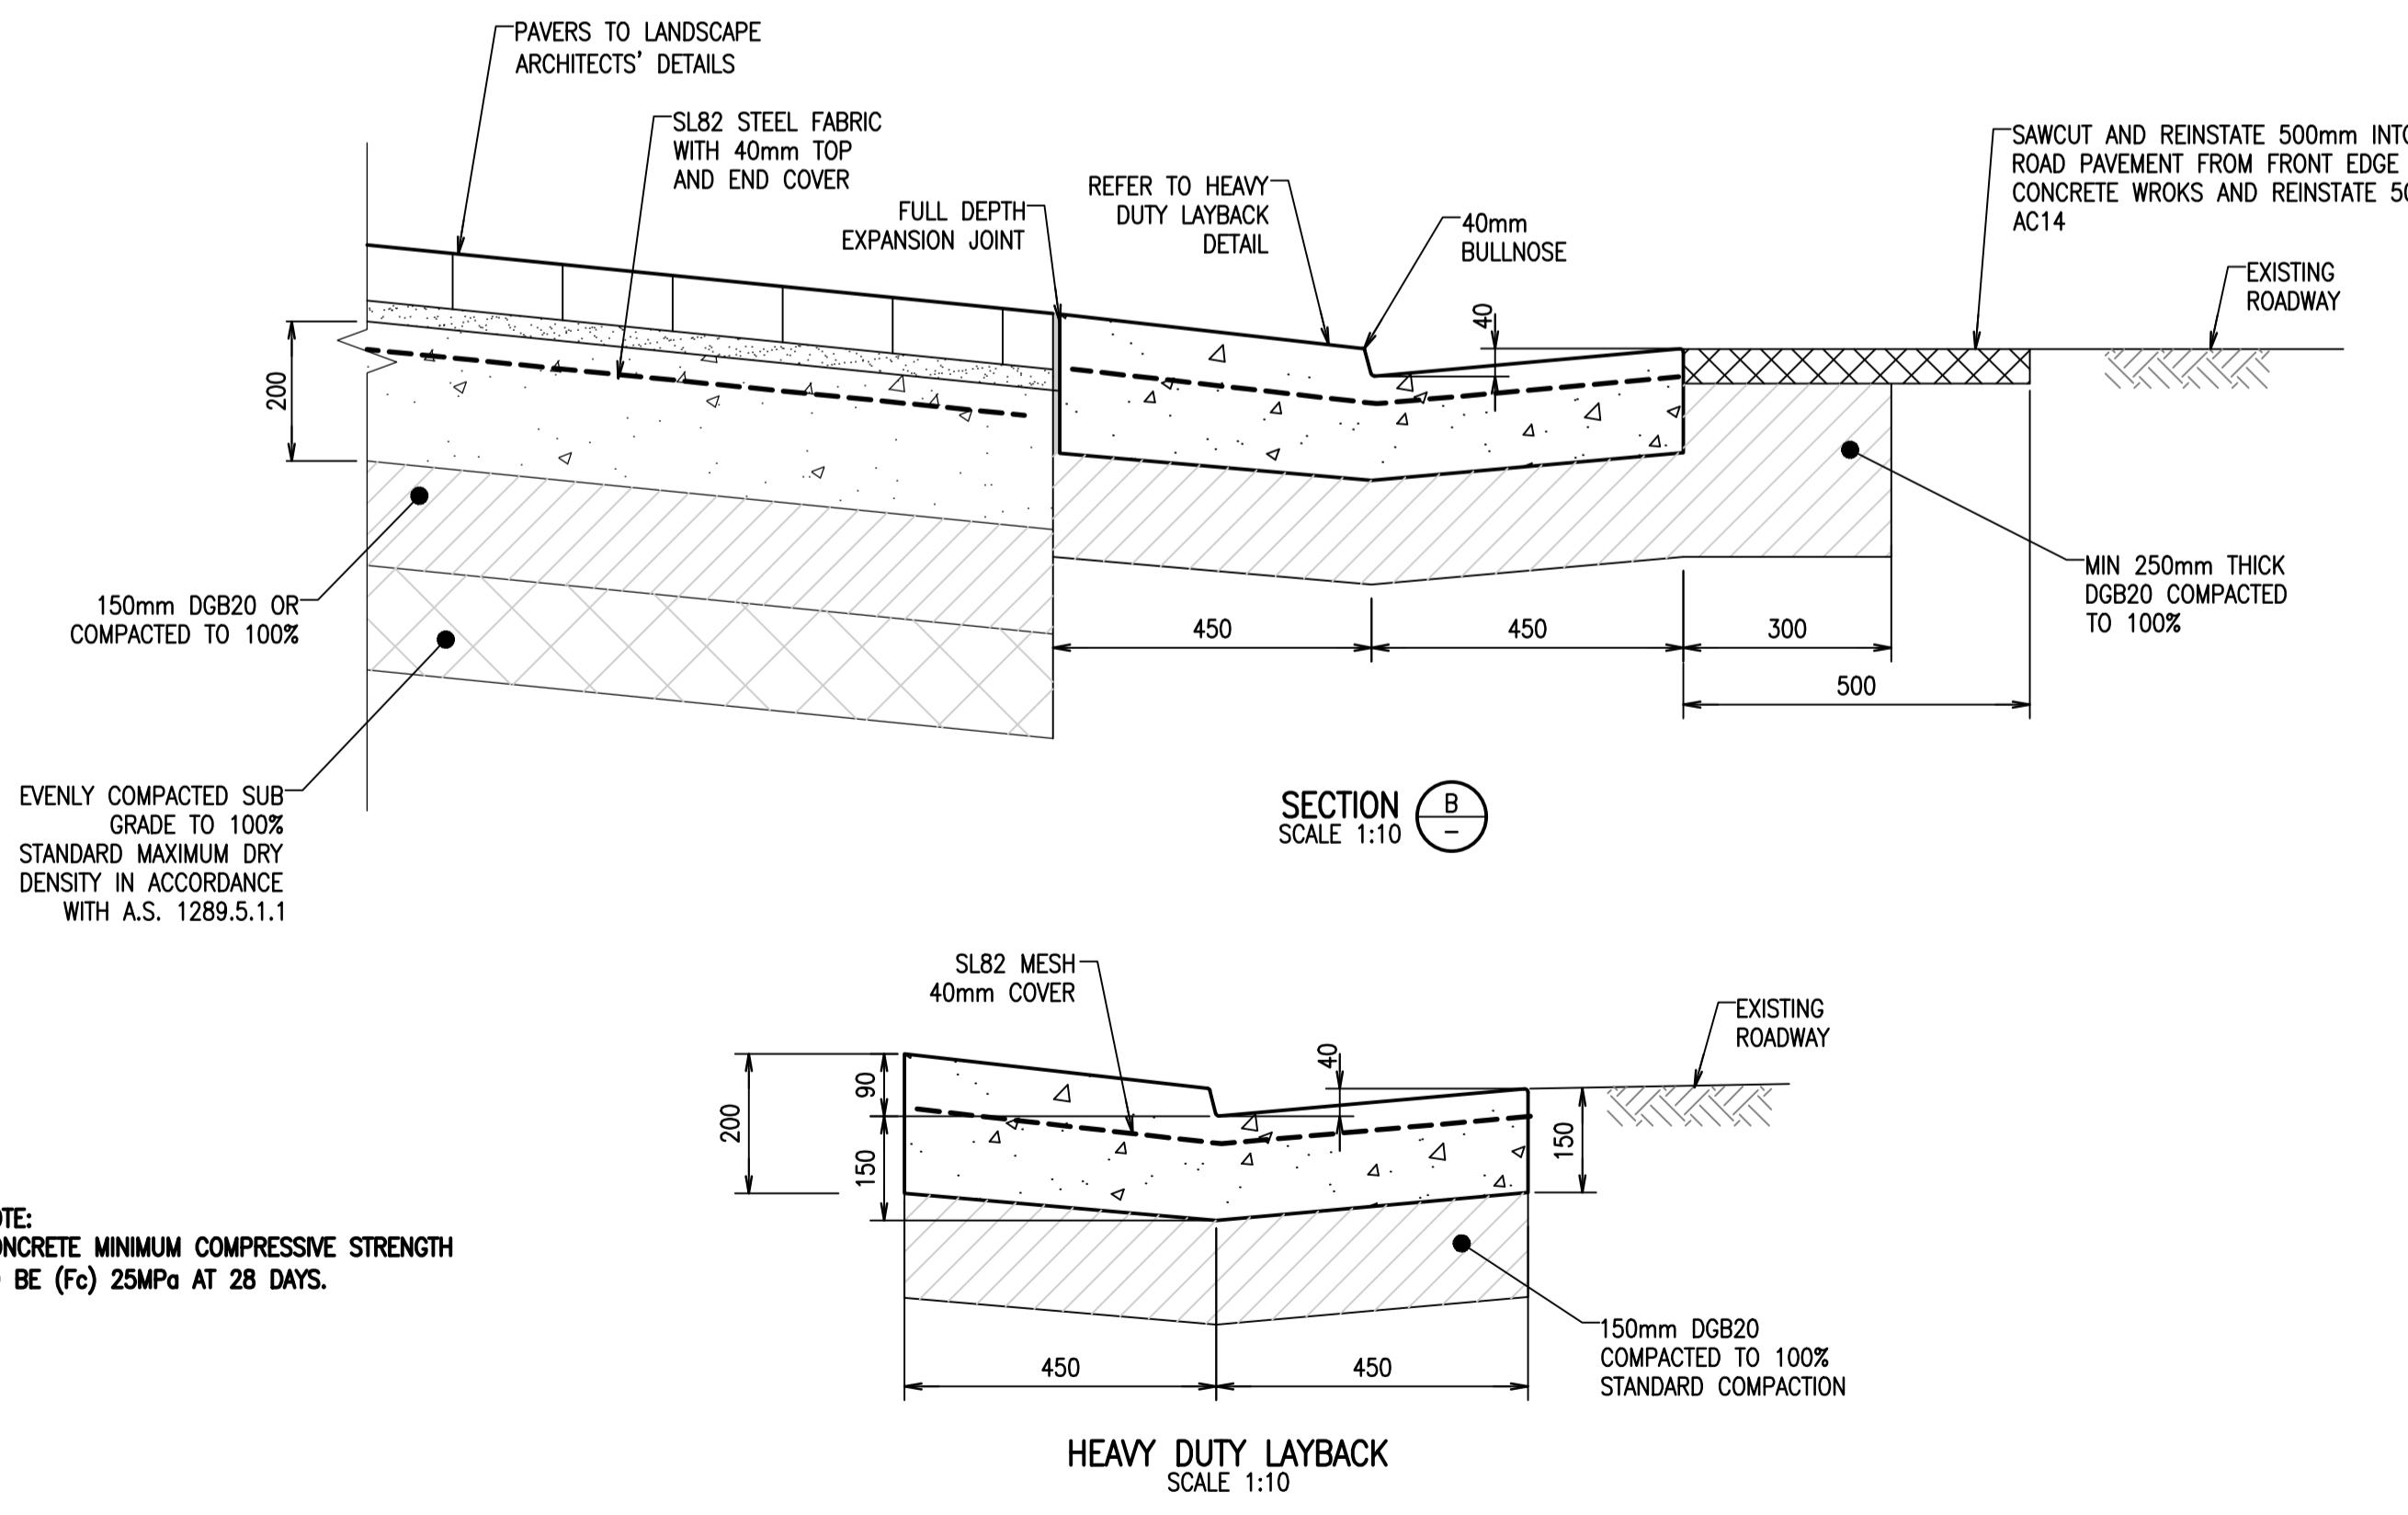
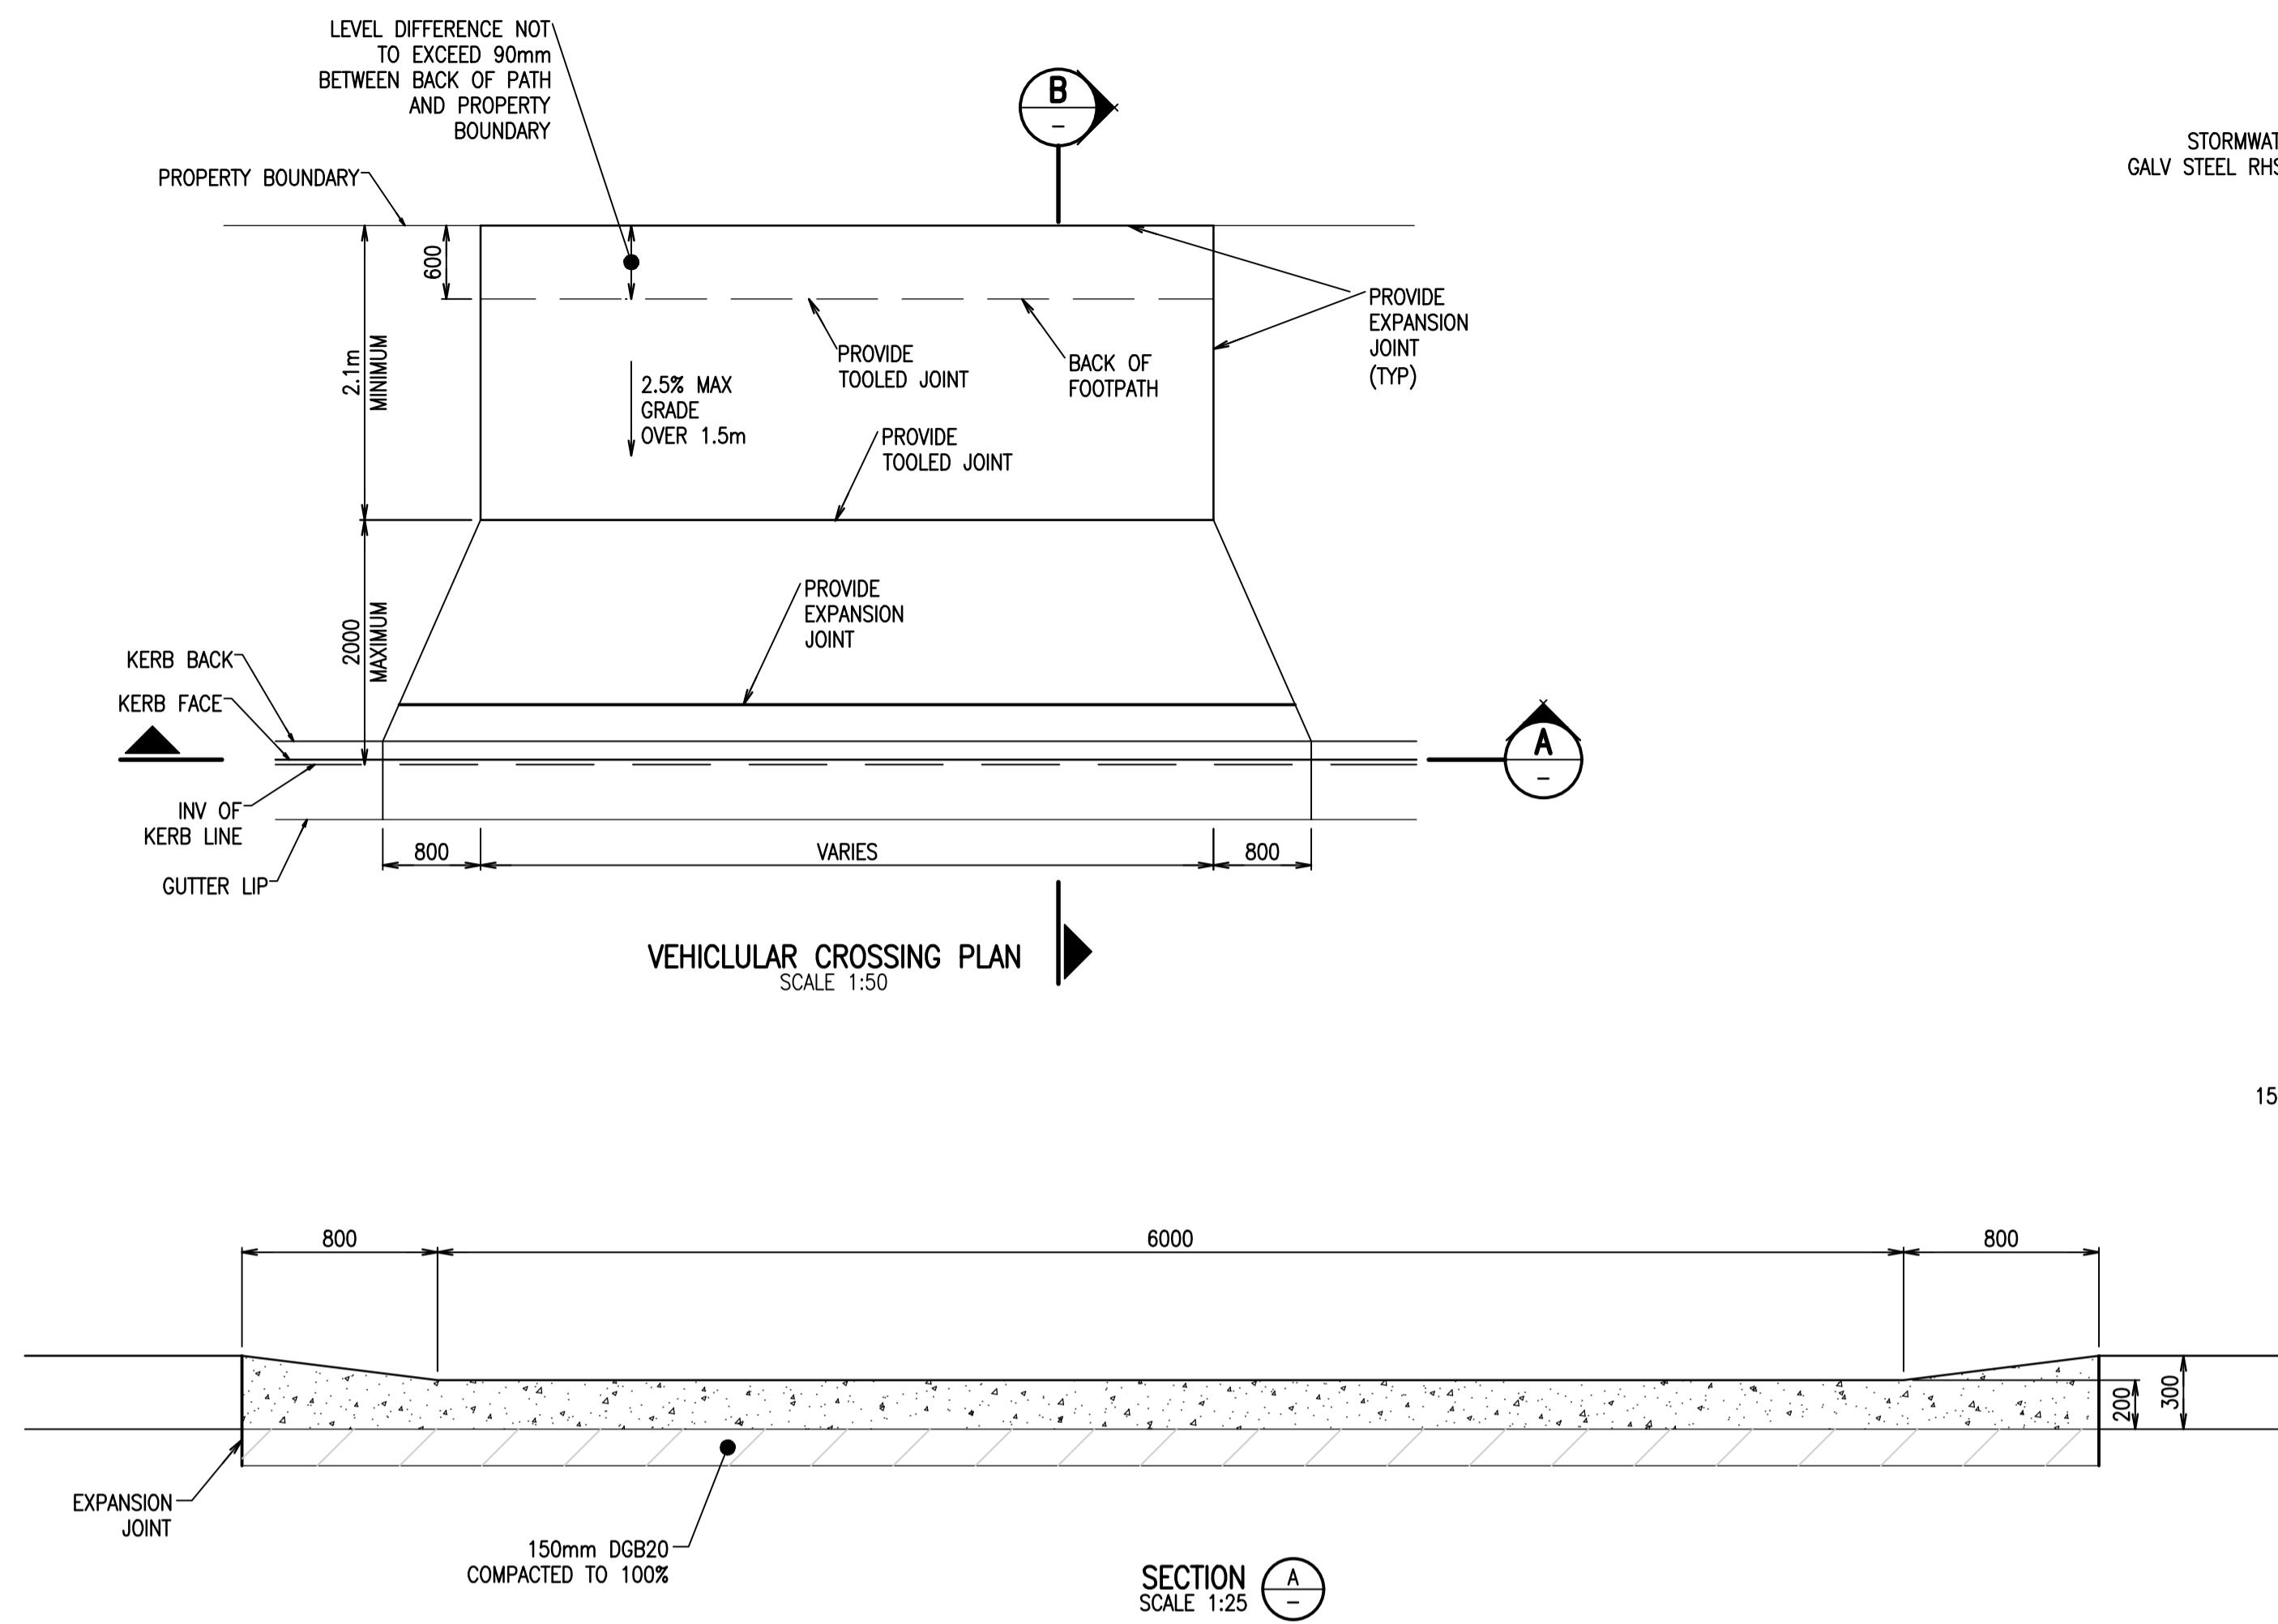
Client

Charter Hall


Title
GENERAL ARRANGEMENT PLAN
Project
2B-6 HASSALL STREET
PARRAMATTA

Scale at A1
AS SHOWN
Drawn
S.MANANDHAR
Date
03.04.19
Designer
C.ROPE
Approved
Job Number
18570C

NOT FOR CONSTRUCTION
Drawing Number
C-3-00
Revision
2




Rev	Revision	Description	By	App	Date	Rev	Revision	Description	By	App	Date
1	ISSUED FOR DEVELOPMENT APPLICATION		ZJ	CR	04.03.19						
2	ISSUED FOR DEVELOPMENT APPLICATION		ZJ	CR	03.04.19						

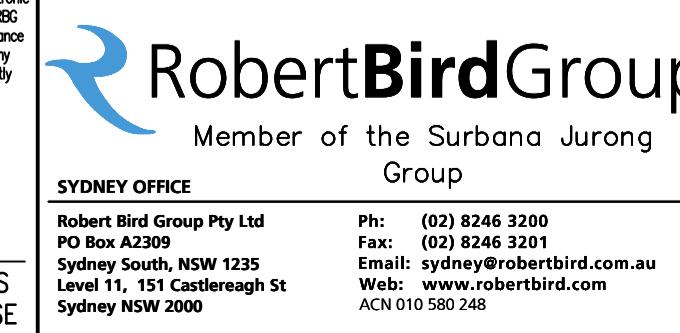


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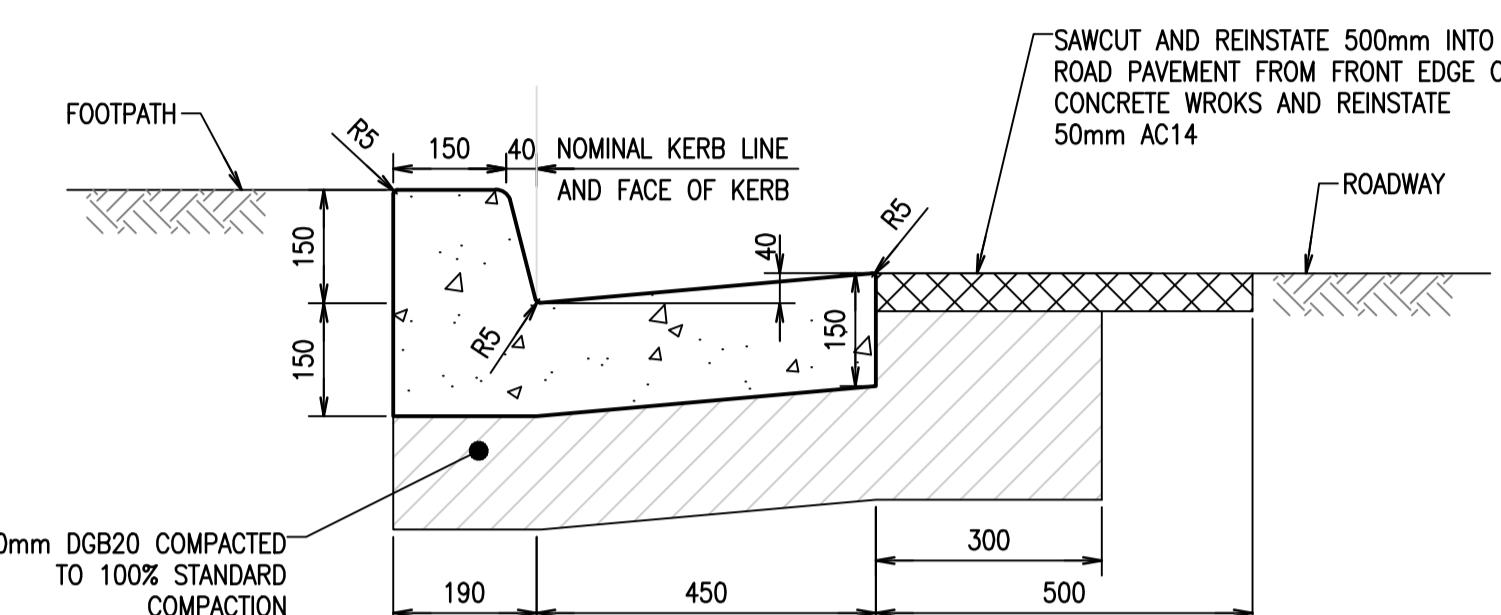
Charter Hall

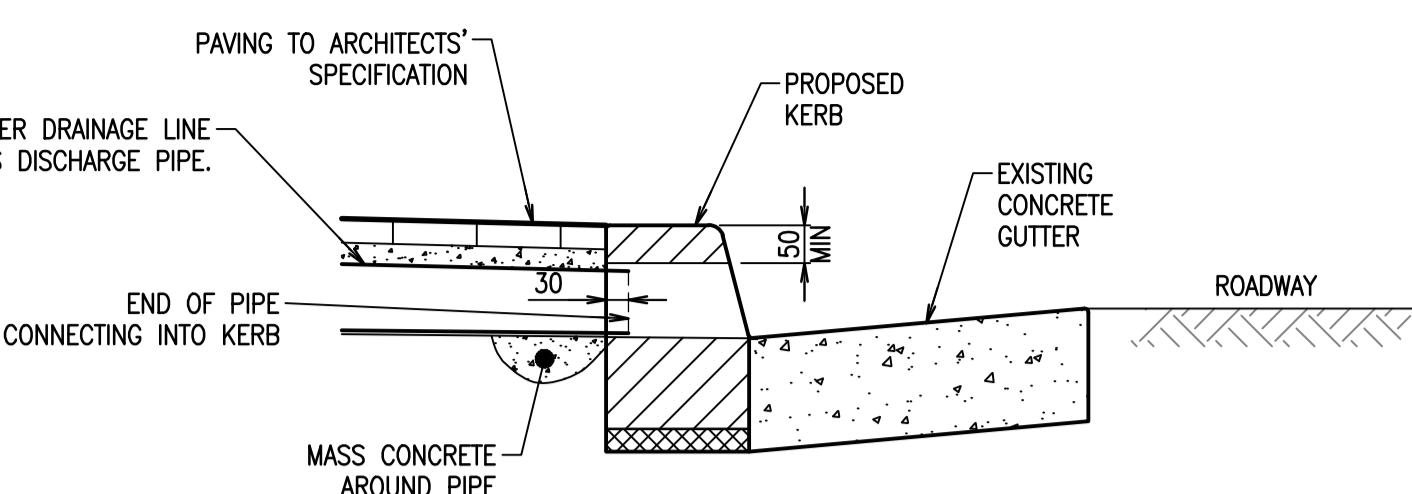


CONCRETE KERB STORMWATER OUTLET – SECTION
SCALE 1:10

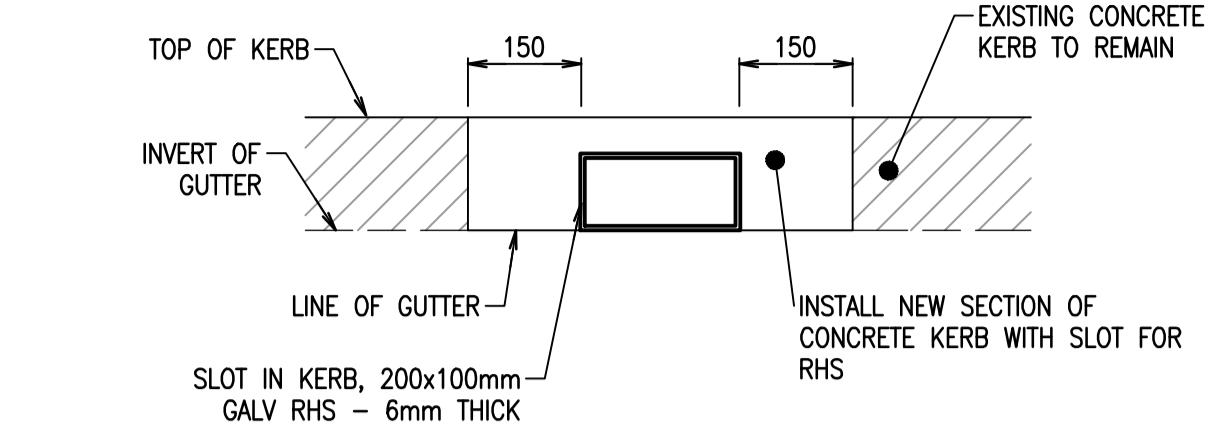


CONCRETE KERB STORMWATER OUTLET – ELEVATION
SCALE 1:10



KERB AND GUTTER (K&G)






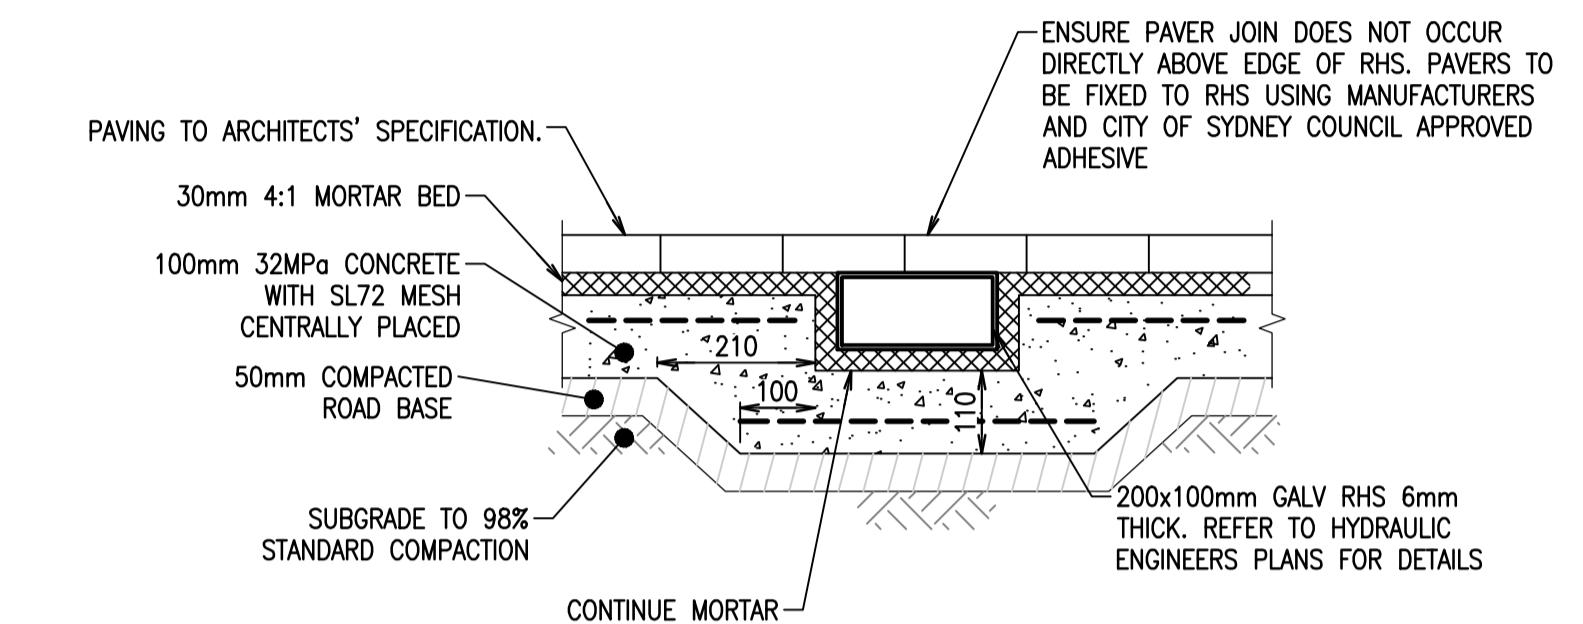


STORMWATER RHS WITHIN PAVEMENT DETAIL
SCALE 1:10

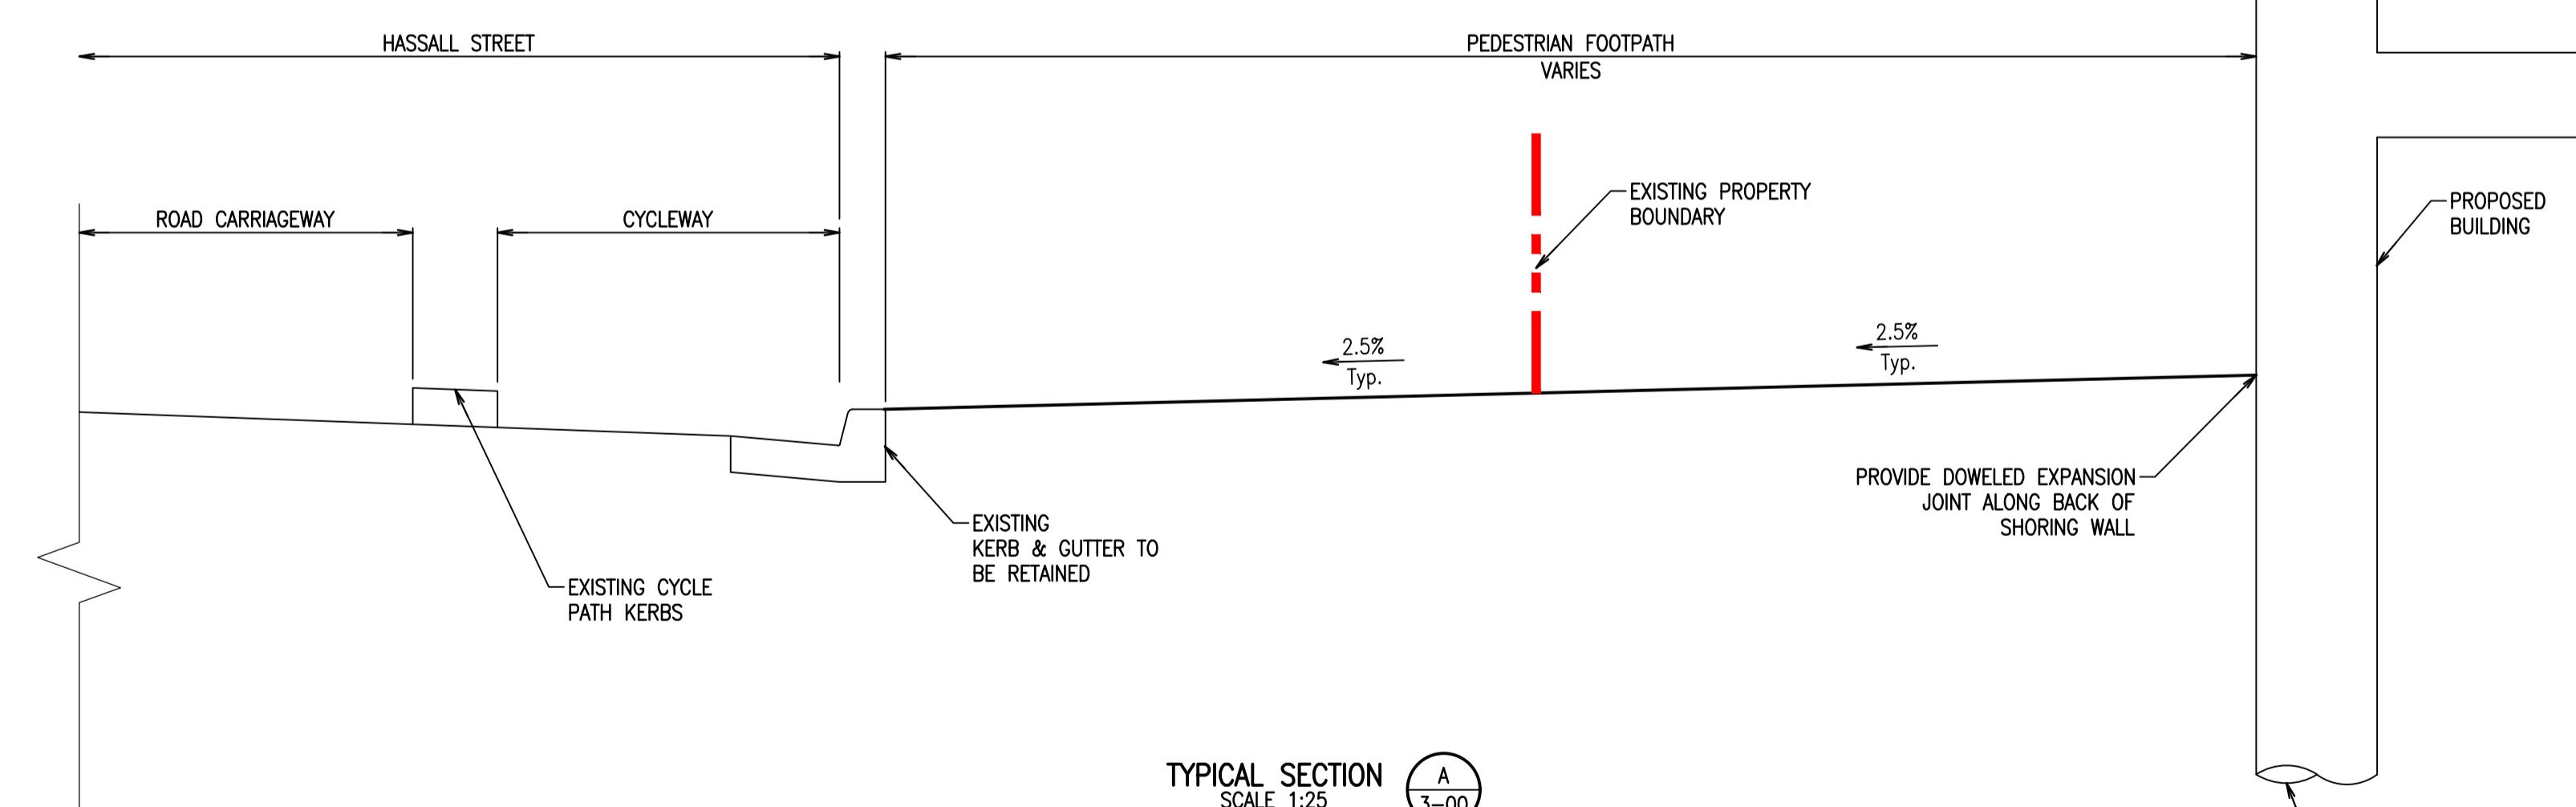

TYPICAL SECTION
SCALE 1:25 A
3-0

necker

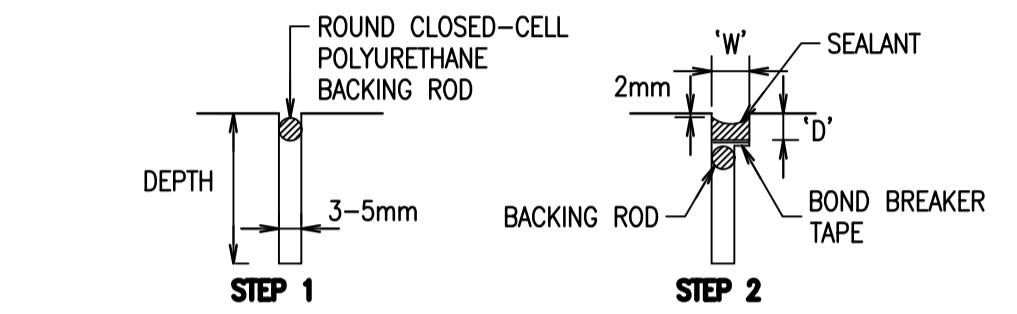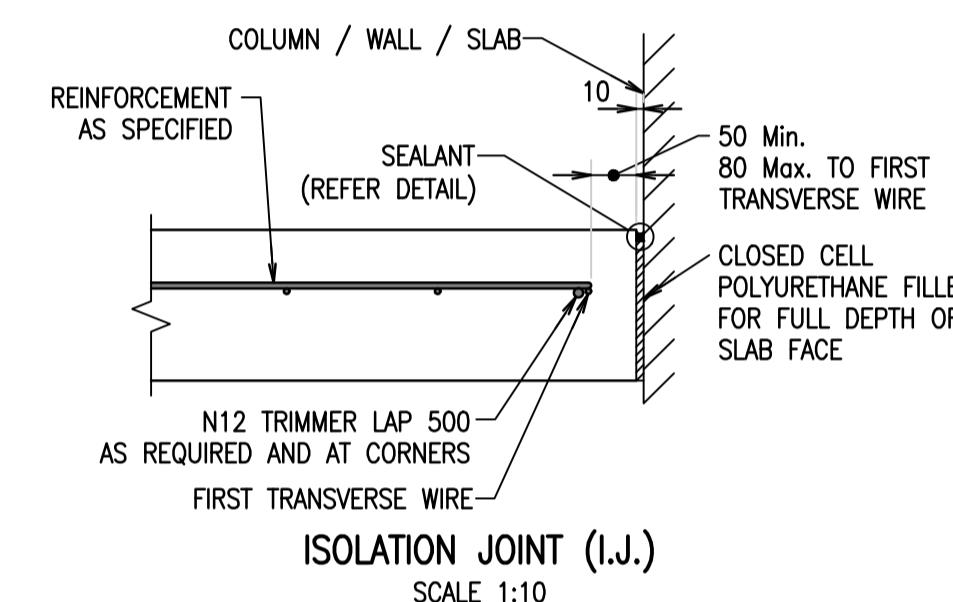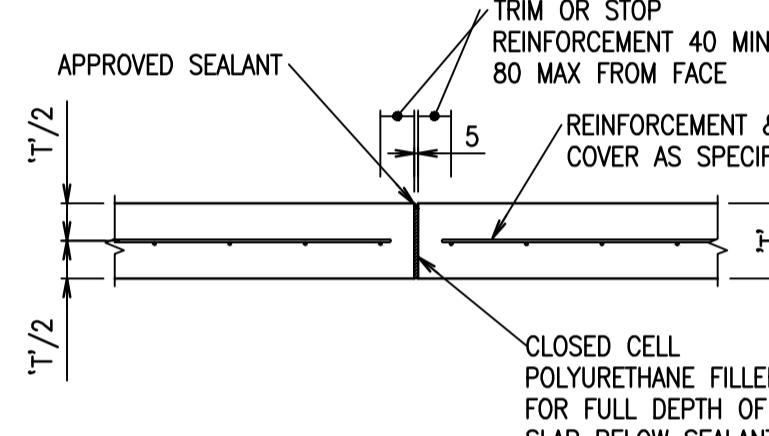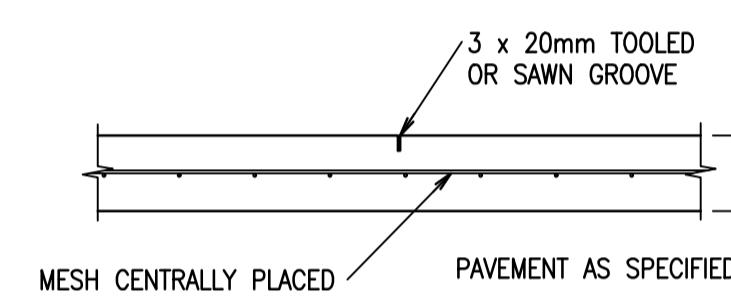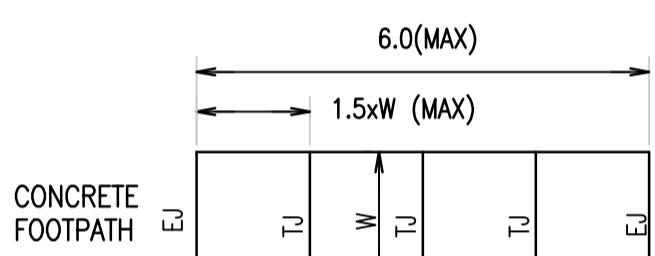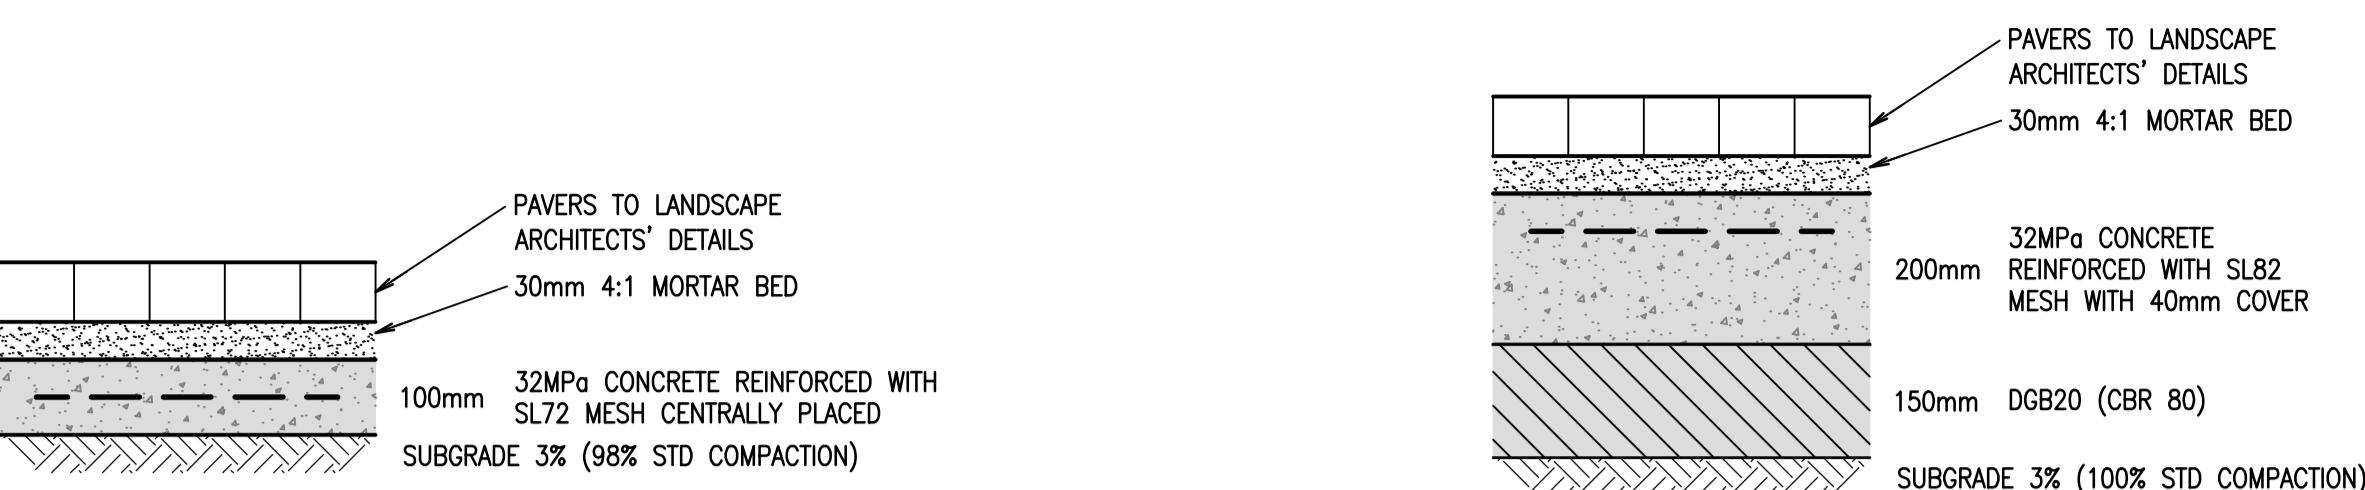


SEALANT DIMENSIONS		
MEAN SLAB LENGTH (m)	SEALANT WIDTH 'W' (mm)	SEALANT DEPTH 'D' (mm)
≤4	7 ± 1	7 ± 1
5	9 ± 2	7 ± 1
6	9 ± 2	7 ± 1
7	10 ± 2	8 ± 1
8	11 ± 2	9 ± 2
9	12 ± 2	10 ± 2
10	13 ± 2	10 ± 2
11	14 ± 2	11 ± 2
12	15 ± 2	12 ± 2
ALL (T.S.J.)	6	6
ALL (I.J. & E.J.)	10	8

NOTES:

1. FOR T.S.J. ONLY, CLEAN, PRIME AND SEAL INITIAL SAW CUT ONLY.



NOTES:

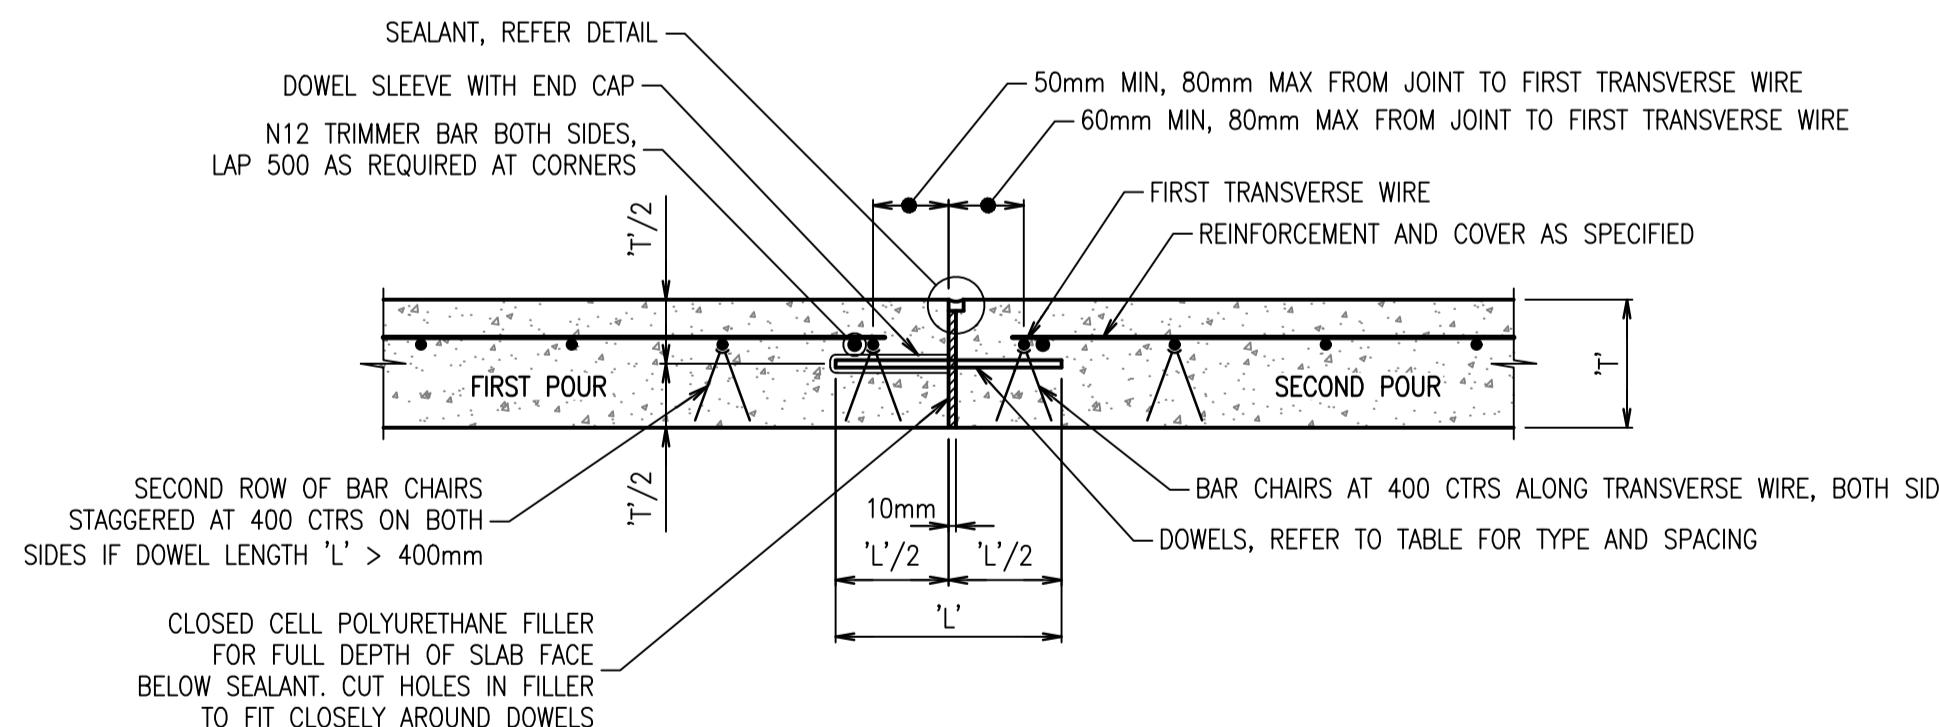

STEPS:

DOWEL / TIE BAR TABLE			
JOINT DESIGNATION	DOWEL / TIE	SPACING CTR-CTR	LENGTH 'L'
DEJ	10x110 DANLEY DIAMOND	450	155

- ALTERNATIVE SEALANTS MUST HAVE**
- MOVEMENT ACCOMMODATION FACTOR +/- 50%
 - PRIMER TO MANUFACTURER'S SPECIFICATION
 - INSTALLATION TO MANUFACTURER'S RECOMMENDATIONS
 - PRIOR APPROVAL BY SUPERINTENDENT.

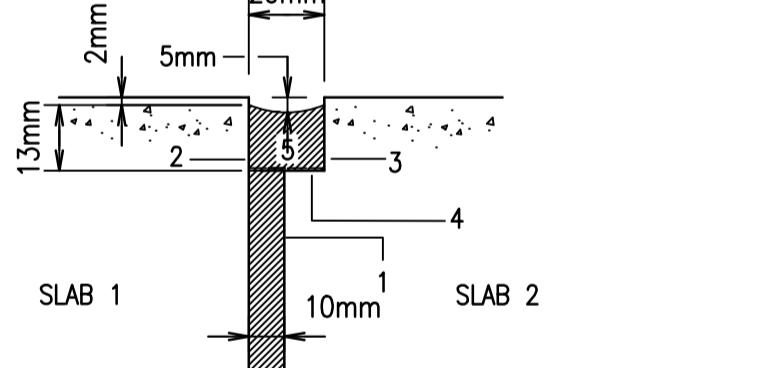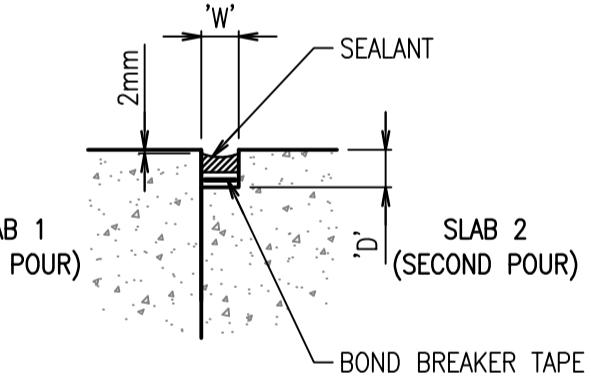

Rev Revision Description By App Date

1 ISSUED FOR DEVELOPMENT APPLICATION ZJ CR 04.03.19

2 ISSUED FOR DEVELOPMENT APPLICATION ZJ CR 03.04.19

Rev Revision Description By App Date

ZJ CR 03.04.19

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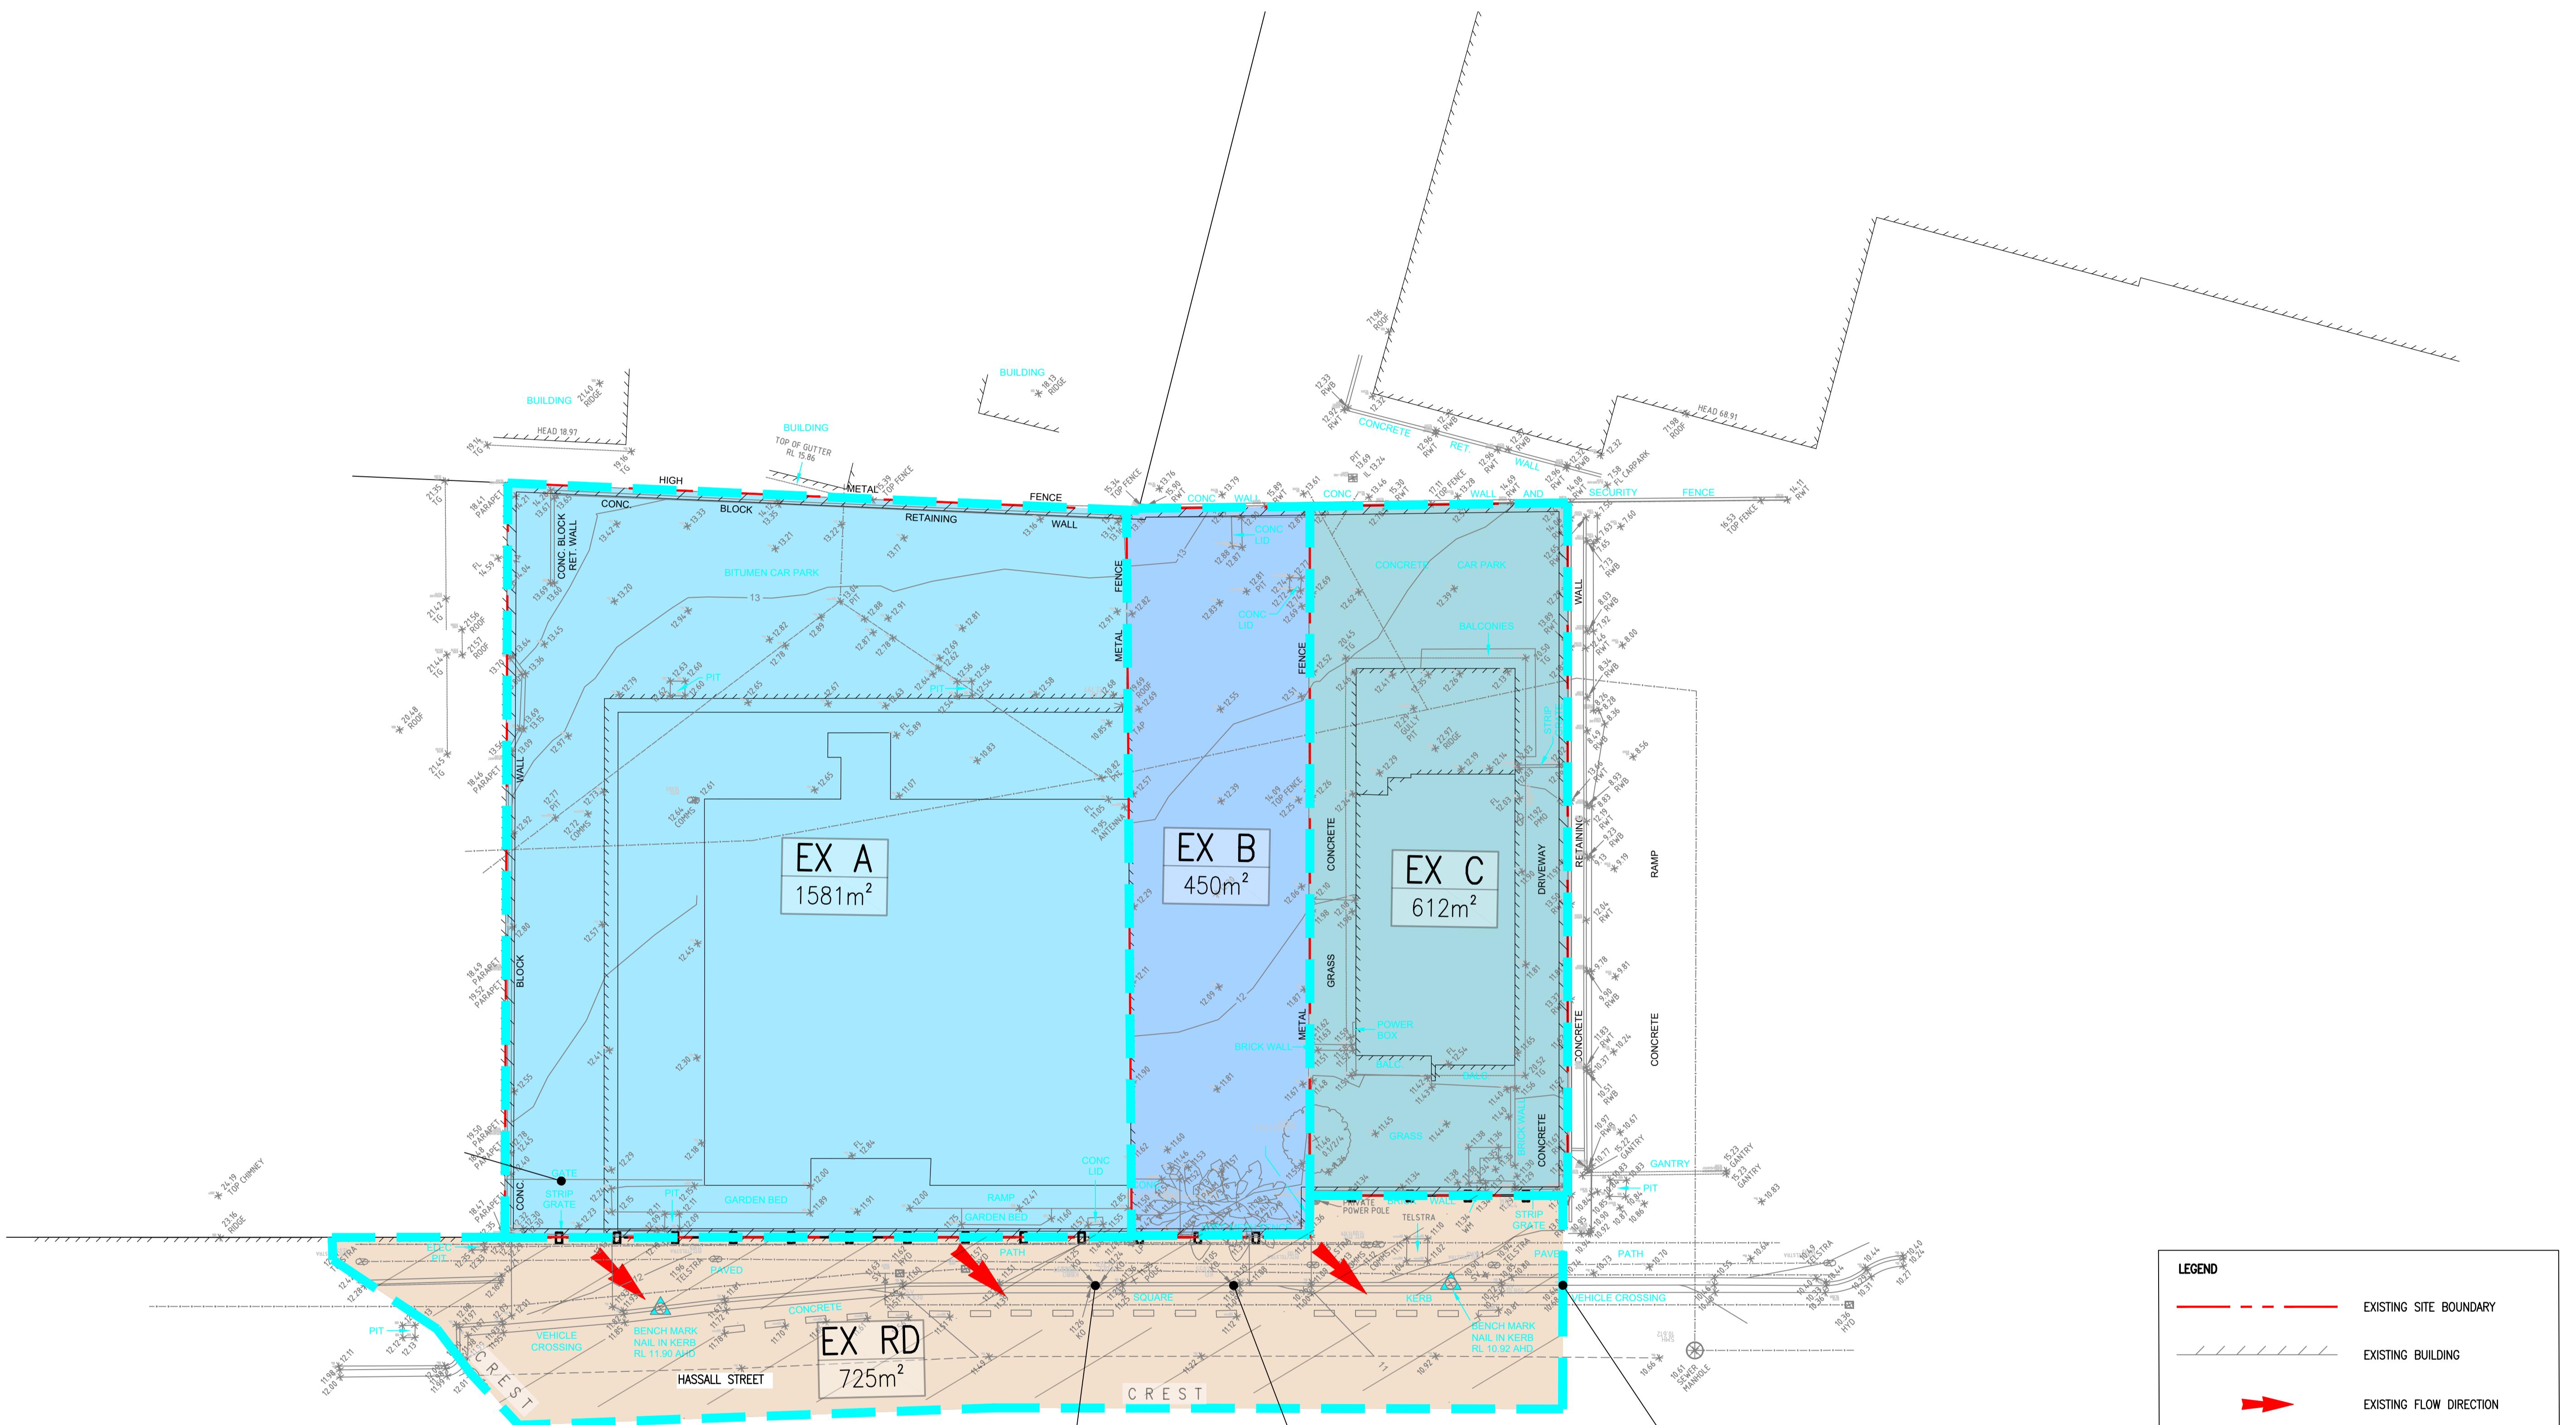
Charter Hall
2B-6 HASSALL STREET
PARRAMATTA

Title
PAVEMENT DETAILS

Project
2B-6 HASSALL STREET
PARRAMATTA
Drawing Number
C-4-10
Revision
2

Scale at A1
AS SHOWN
Drawn
S.MANANDHAR
Designer
Z.JONES
Approved
C.ROPE
Job Number
18570C
Design Checker

NOT FOR CONSTRUCTION



Rev Revision Description By App Date

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Title
STORMWATER PRE CATCHMENT ANALYSIS

Project
2B-6 HASSALL STREET PARRAMATTA



Scale at A1 AS SHOWN Drawn Z.JONES Design Checker

Date 04.03.19 Designer Z.JONES Approved

C.Rope Job Number 18570C

NOT FOR CONSTRUCTION

Drawing Number C-6-50 Revision 1

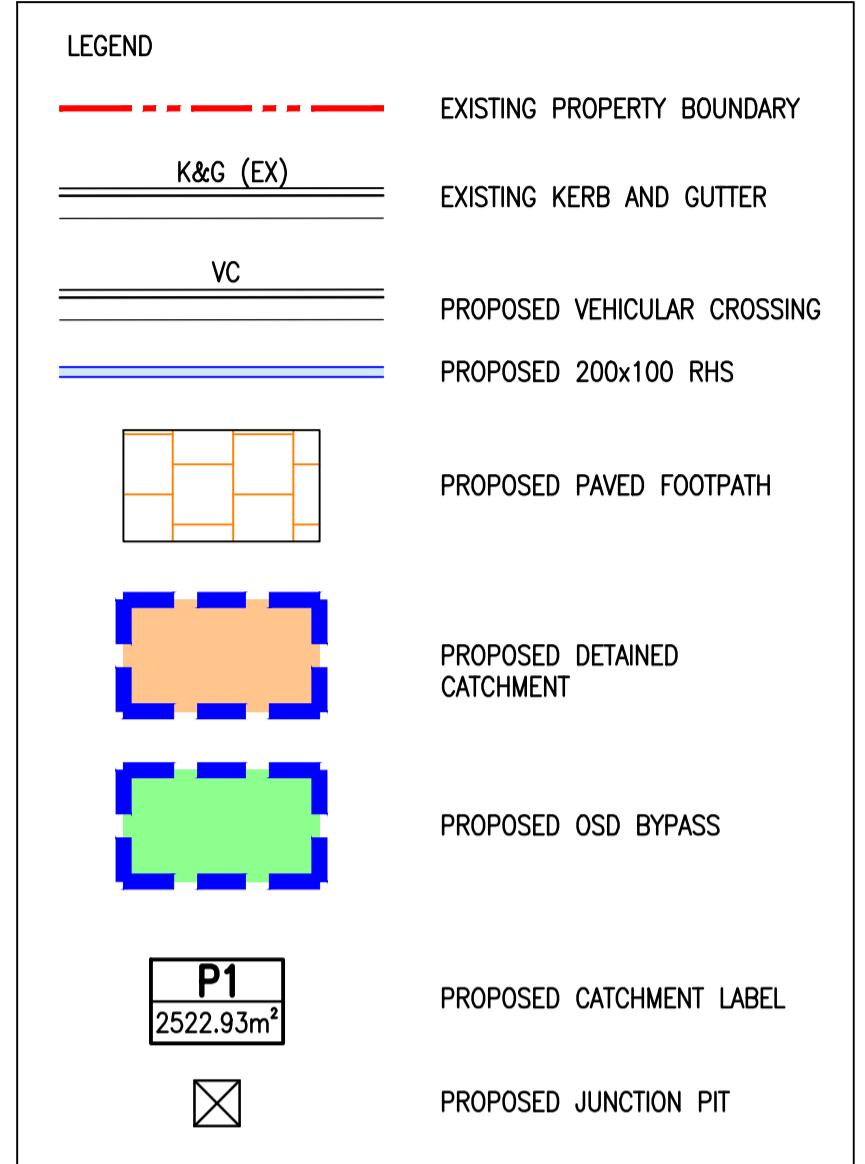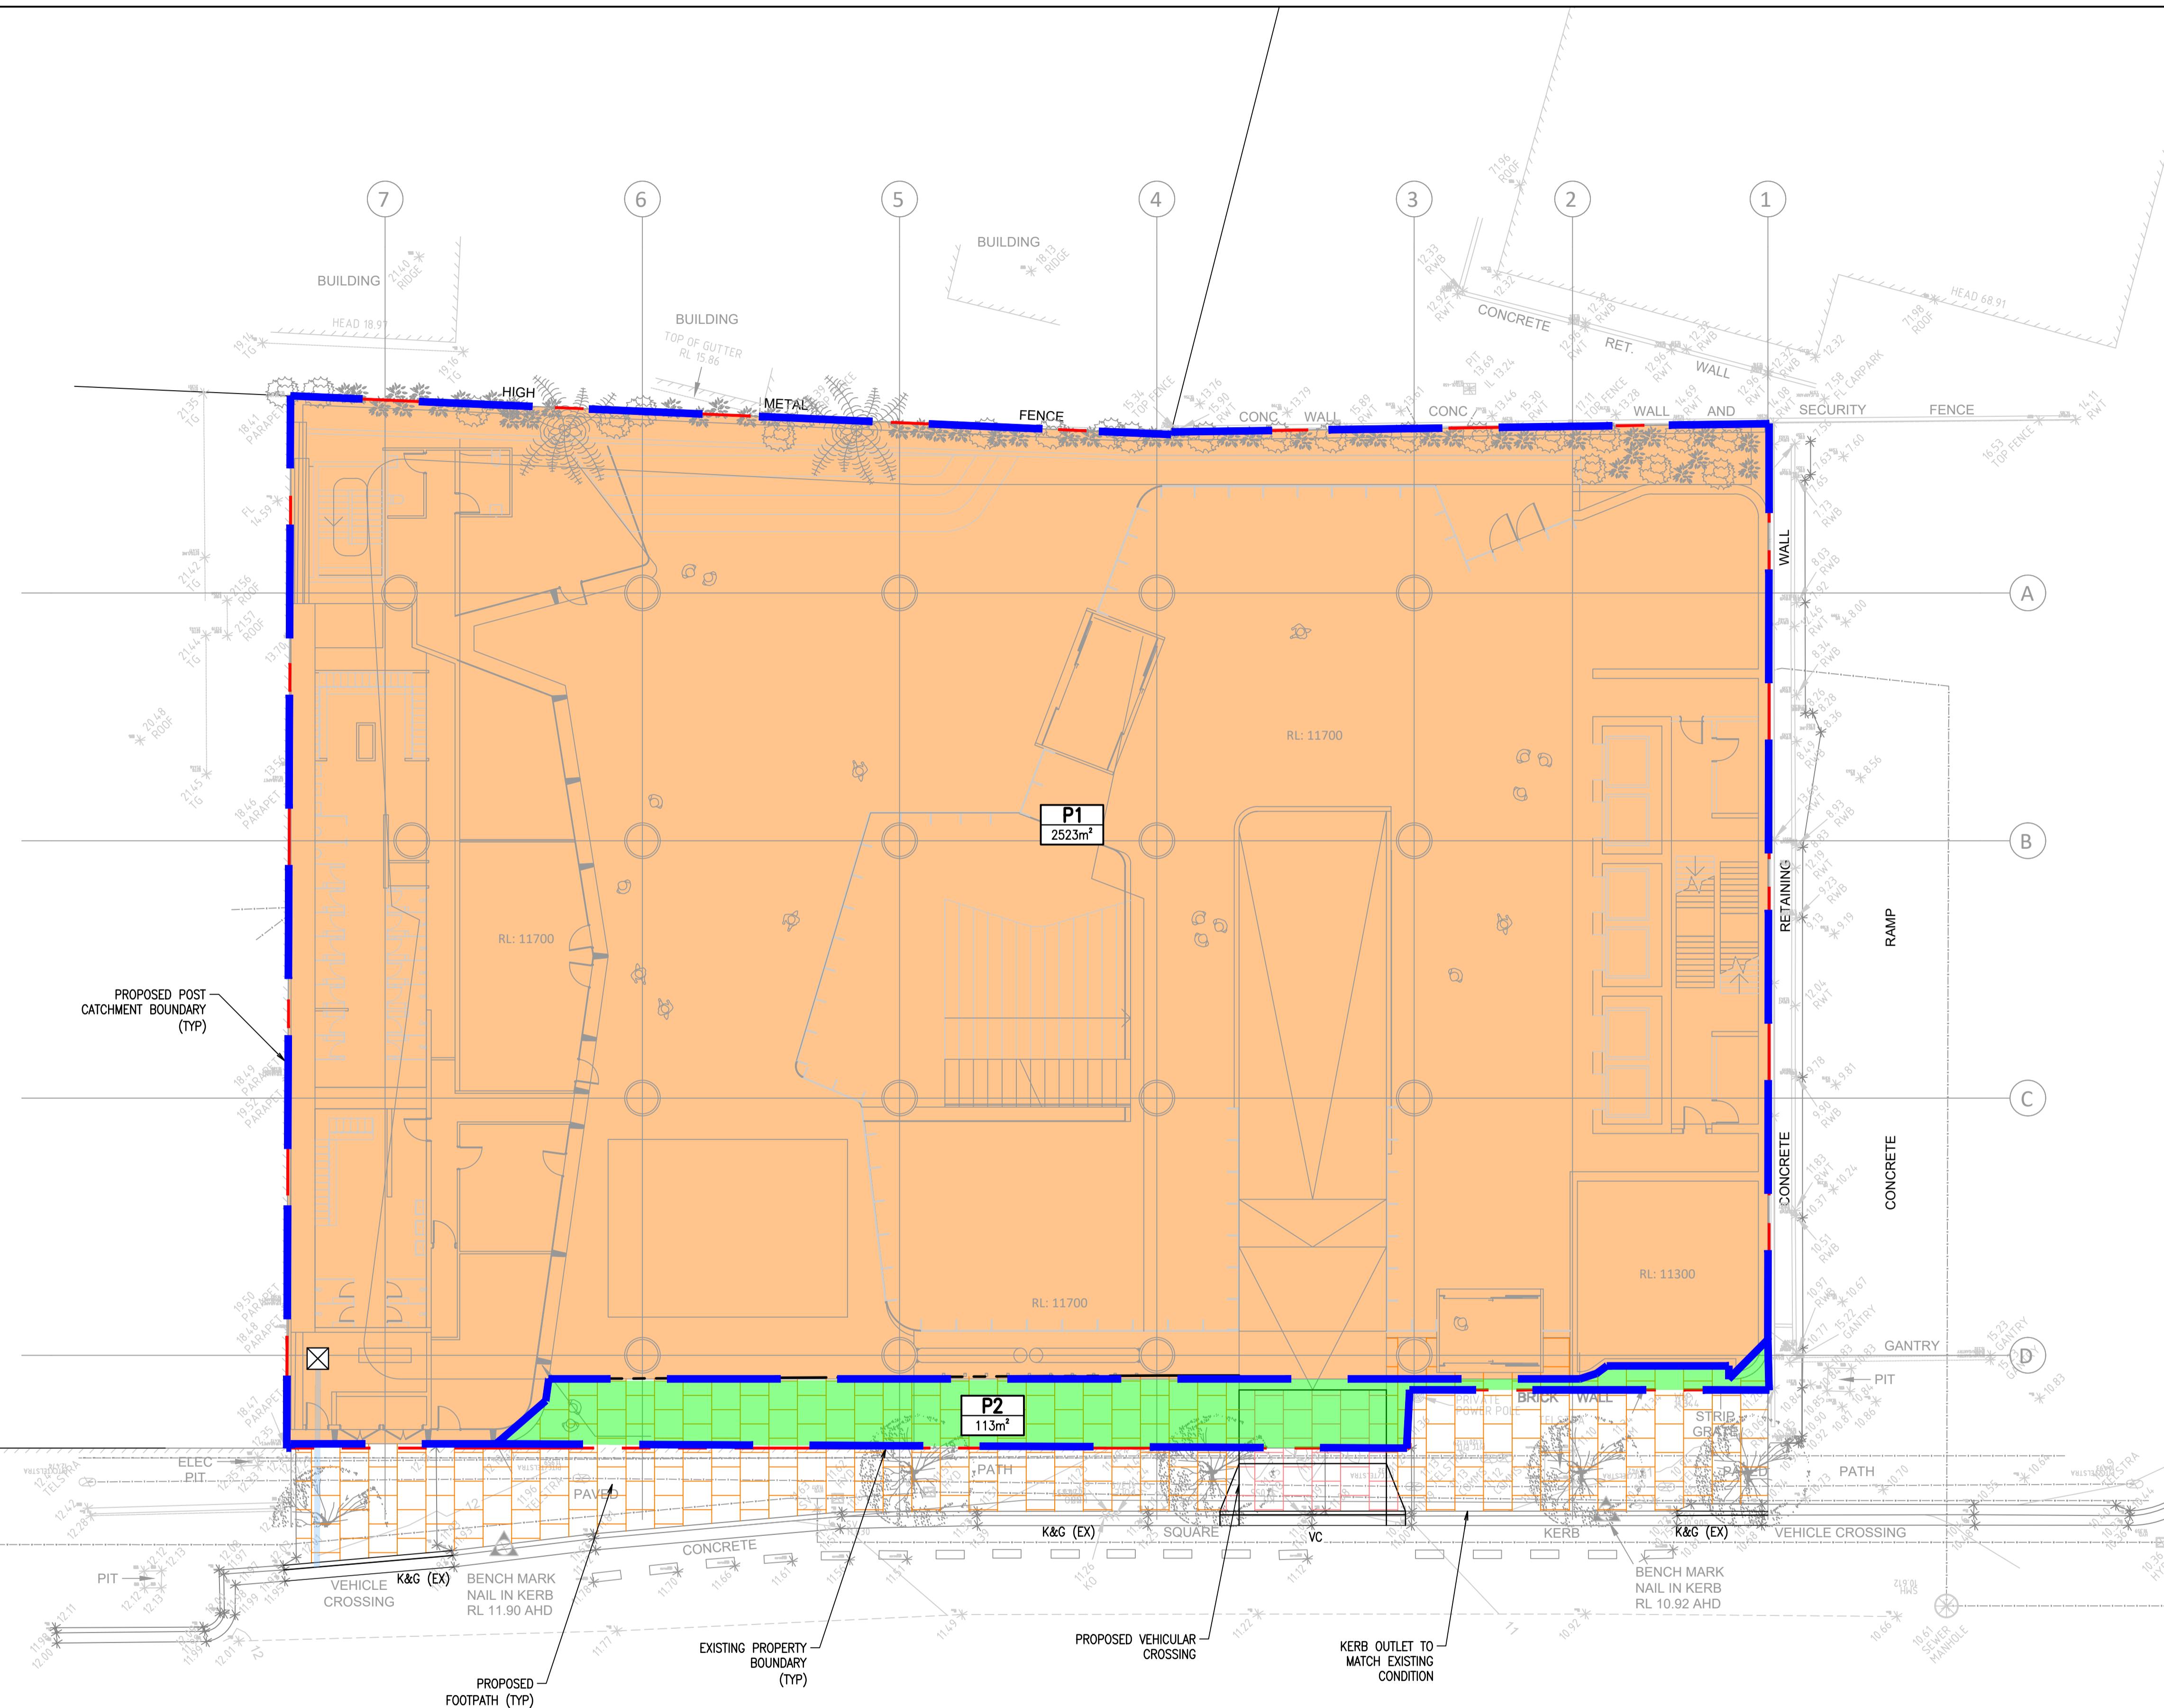

HASSALL STREET

A scale bar diagram for a 1:150 scale drawing. The top part shows the text "SCALE 1:150". Below it is a horizontal bar divided into four equal segments by vertical lines. The first segment is shaded dark grey, while the others are white. Below the bar, numerical markings are present: "2" under the first white segment, "0" under the second white segment, "2" under the third white segment, "4" under the fourth white segment, "6" under the fifth white segment, and "8m" under the sixth white segment. There are also small tick marks along the bottom edge of the scale bar.

Rev	Revision	Description
1	ISSUED FOR DEVELOPMENT	APPLICATION
2	ISSUED FOR DEVELOPMENT	APPLICATION

By	App	Date	Rev	Revision	Description
ZJ	CR	04.03.19			
ZJ	CR	03.04.19			

By	App	Date
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Title

STORMWATER POST CATCHMENT ANALYSIS

Project
**2B-6 HASSALL STREET
PARRAMATTA**

NOT FOR CONSTRUCTION
