






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7	06-08-2021	FINAL FOR SSDA

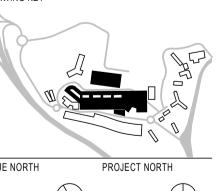


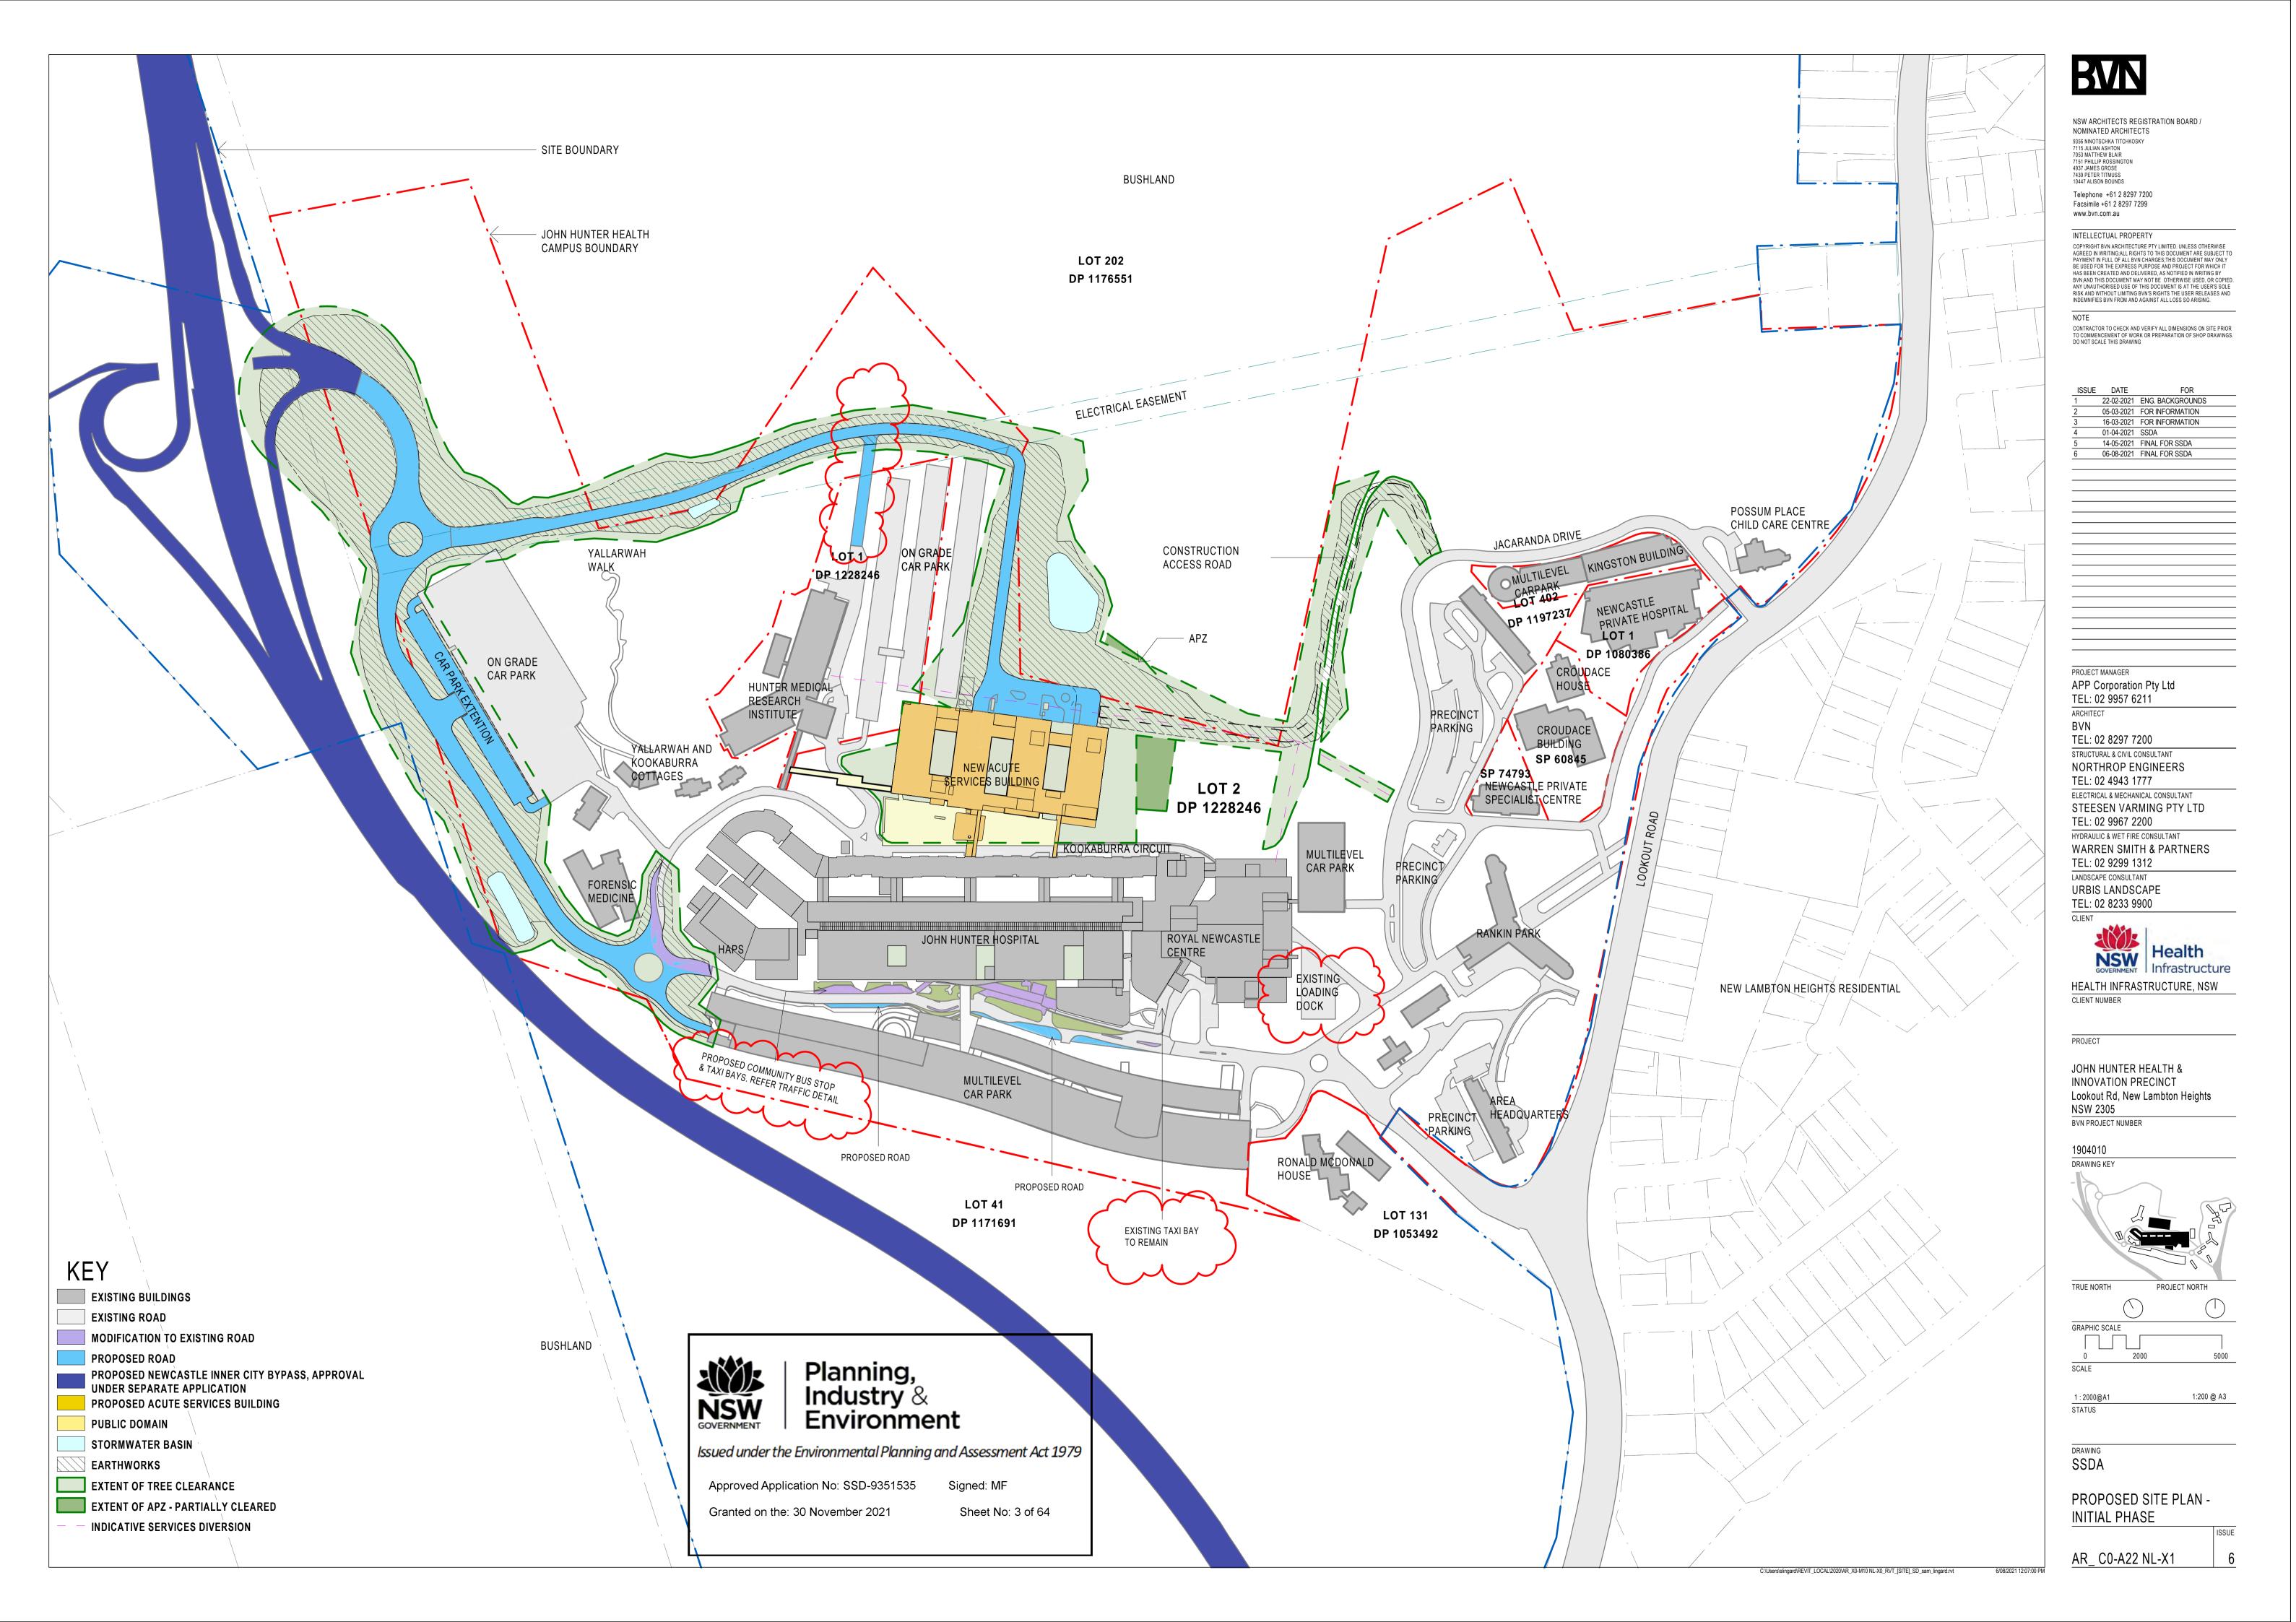


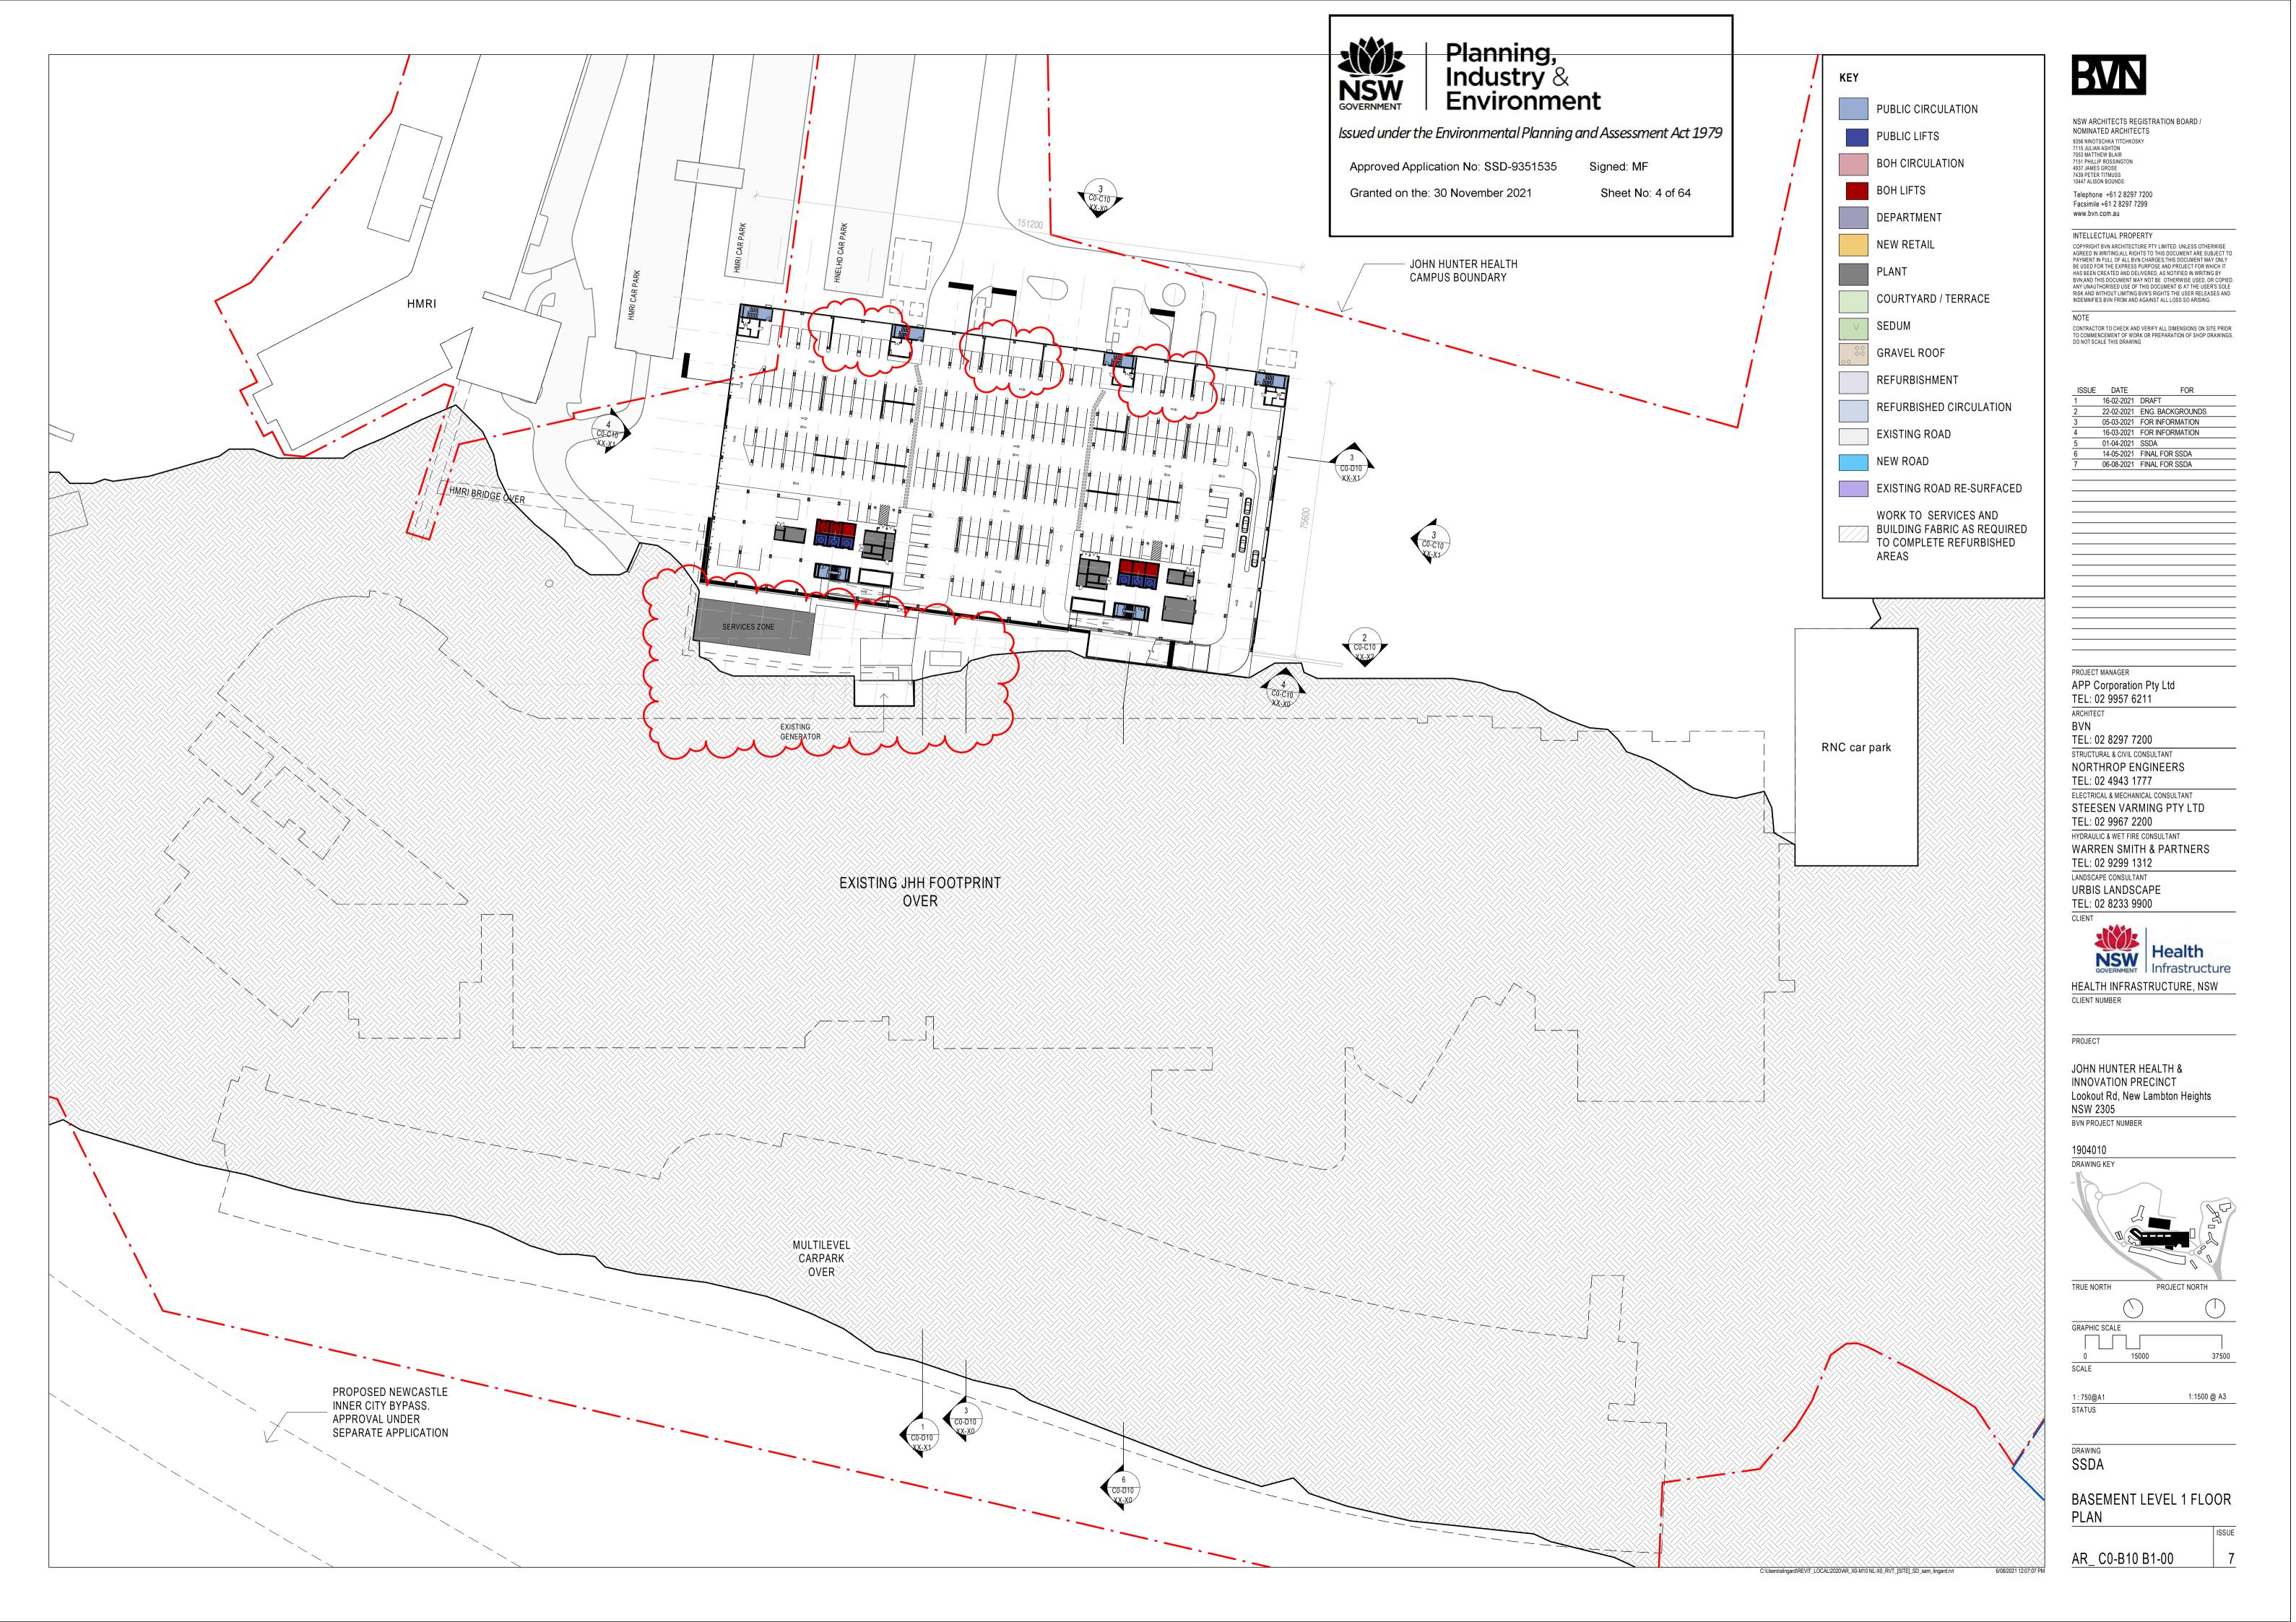


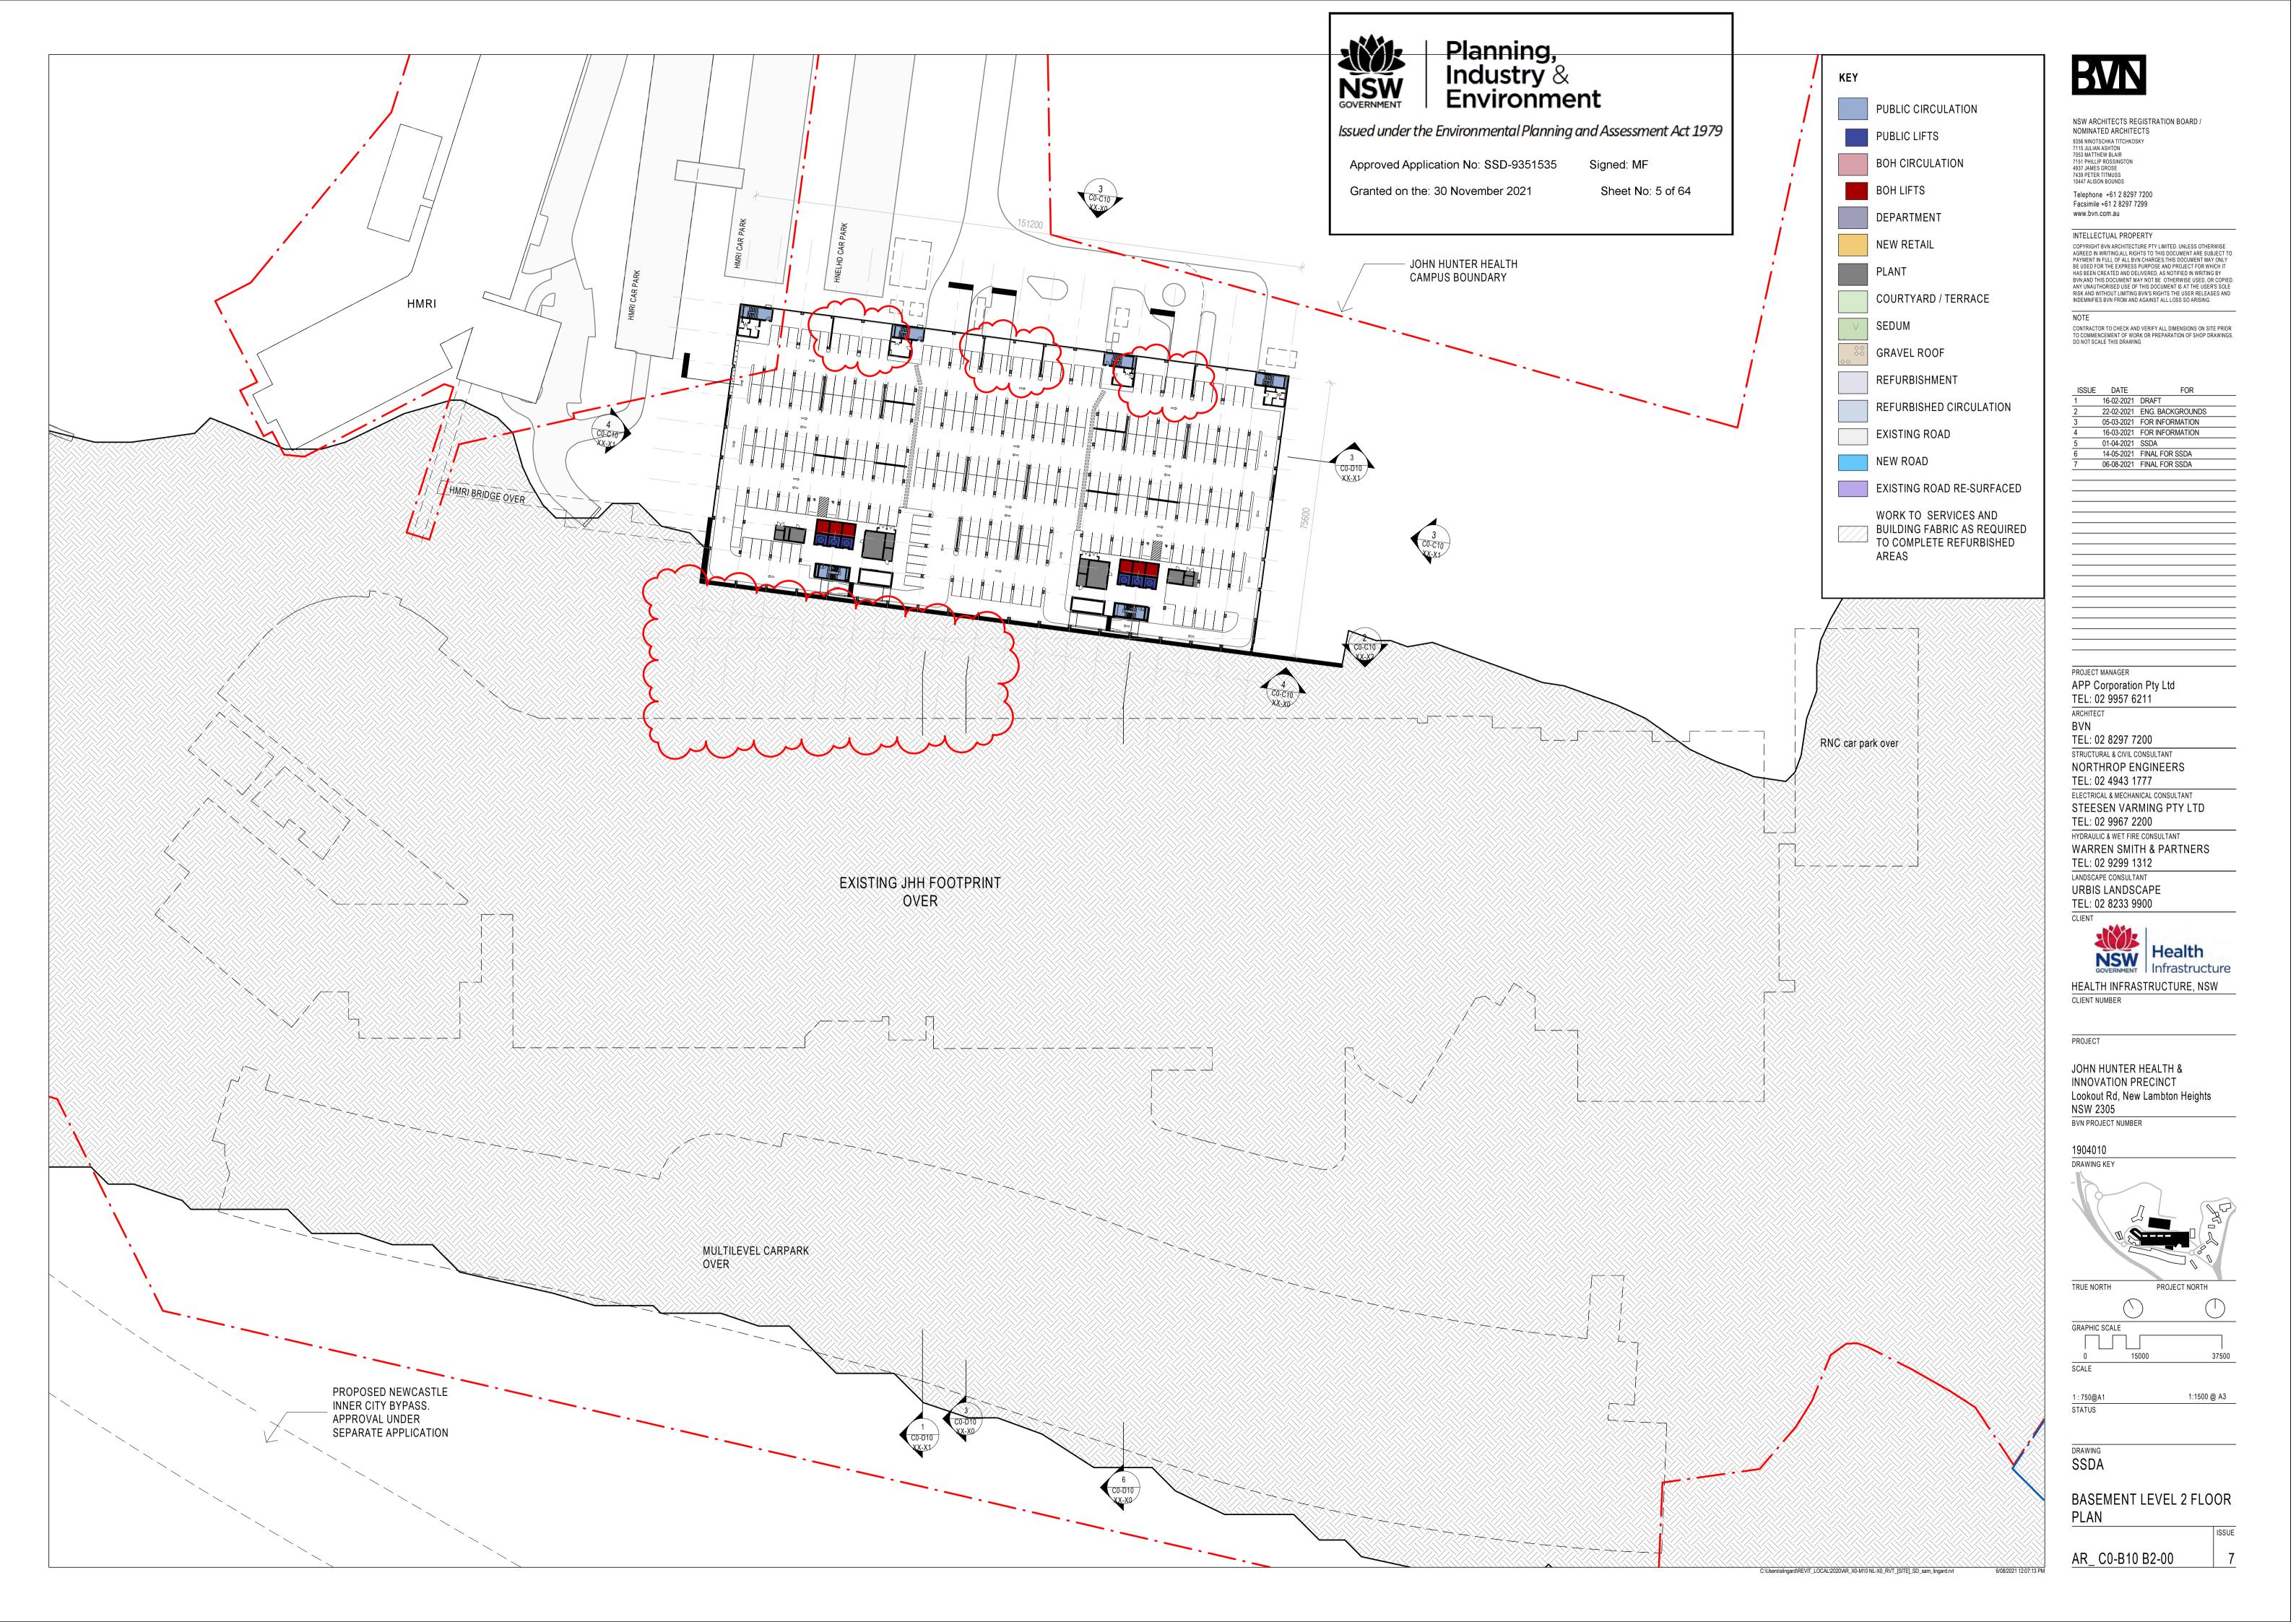


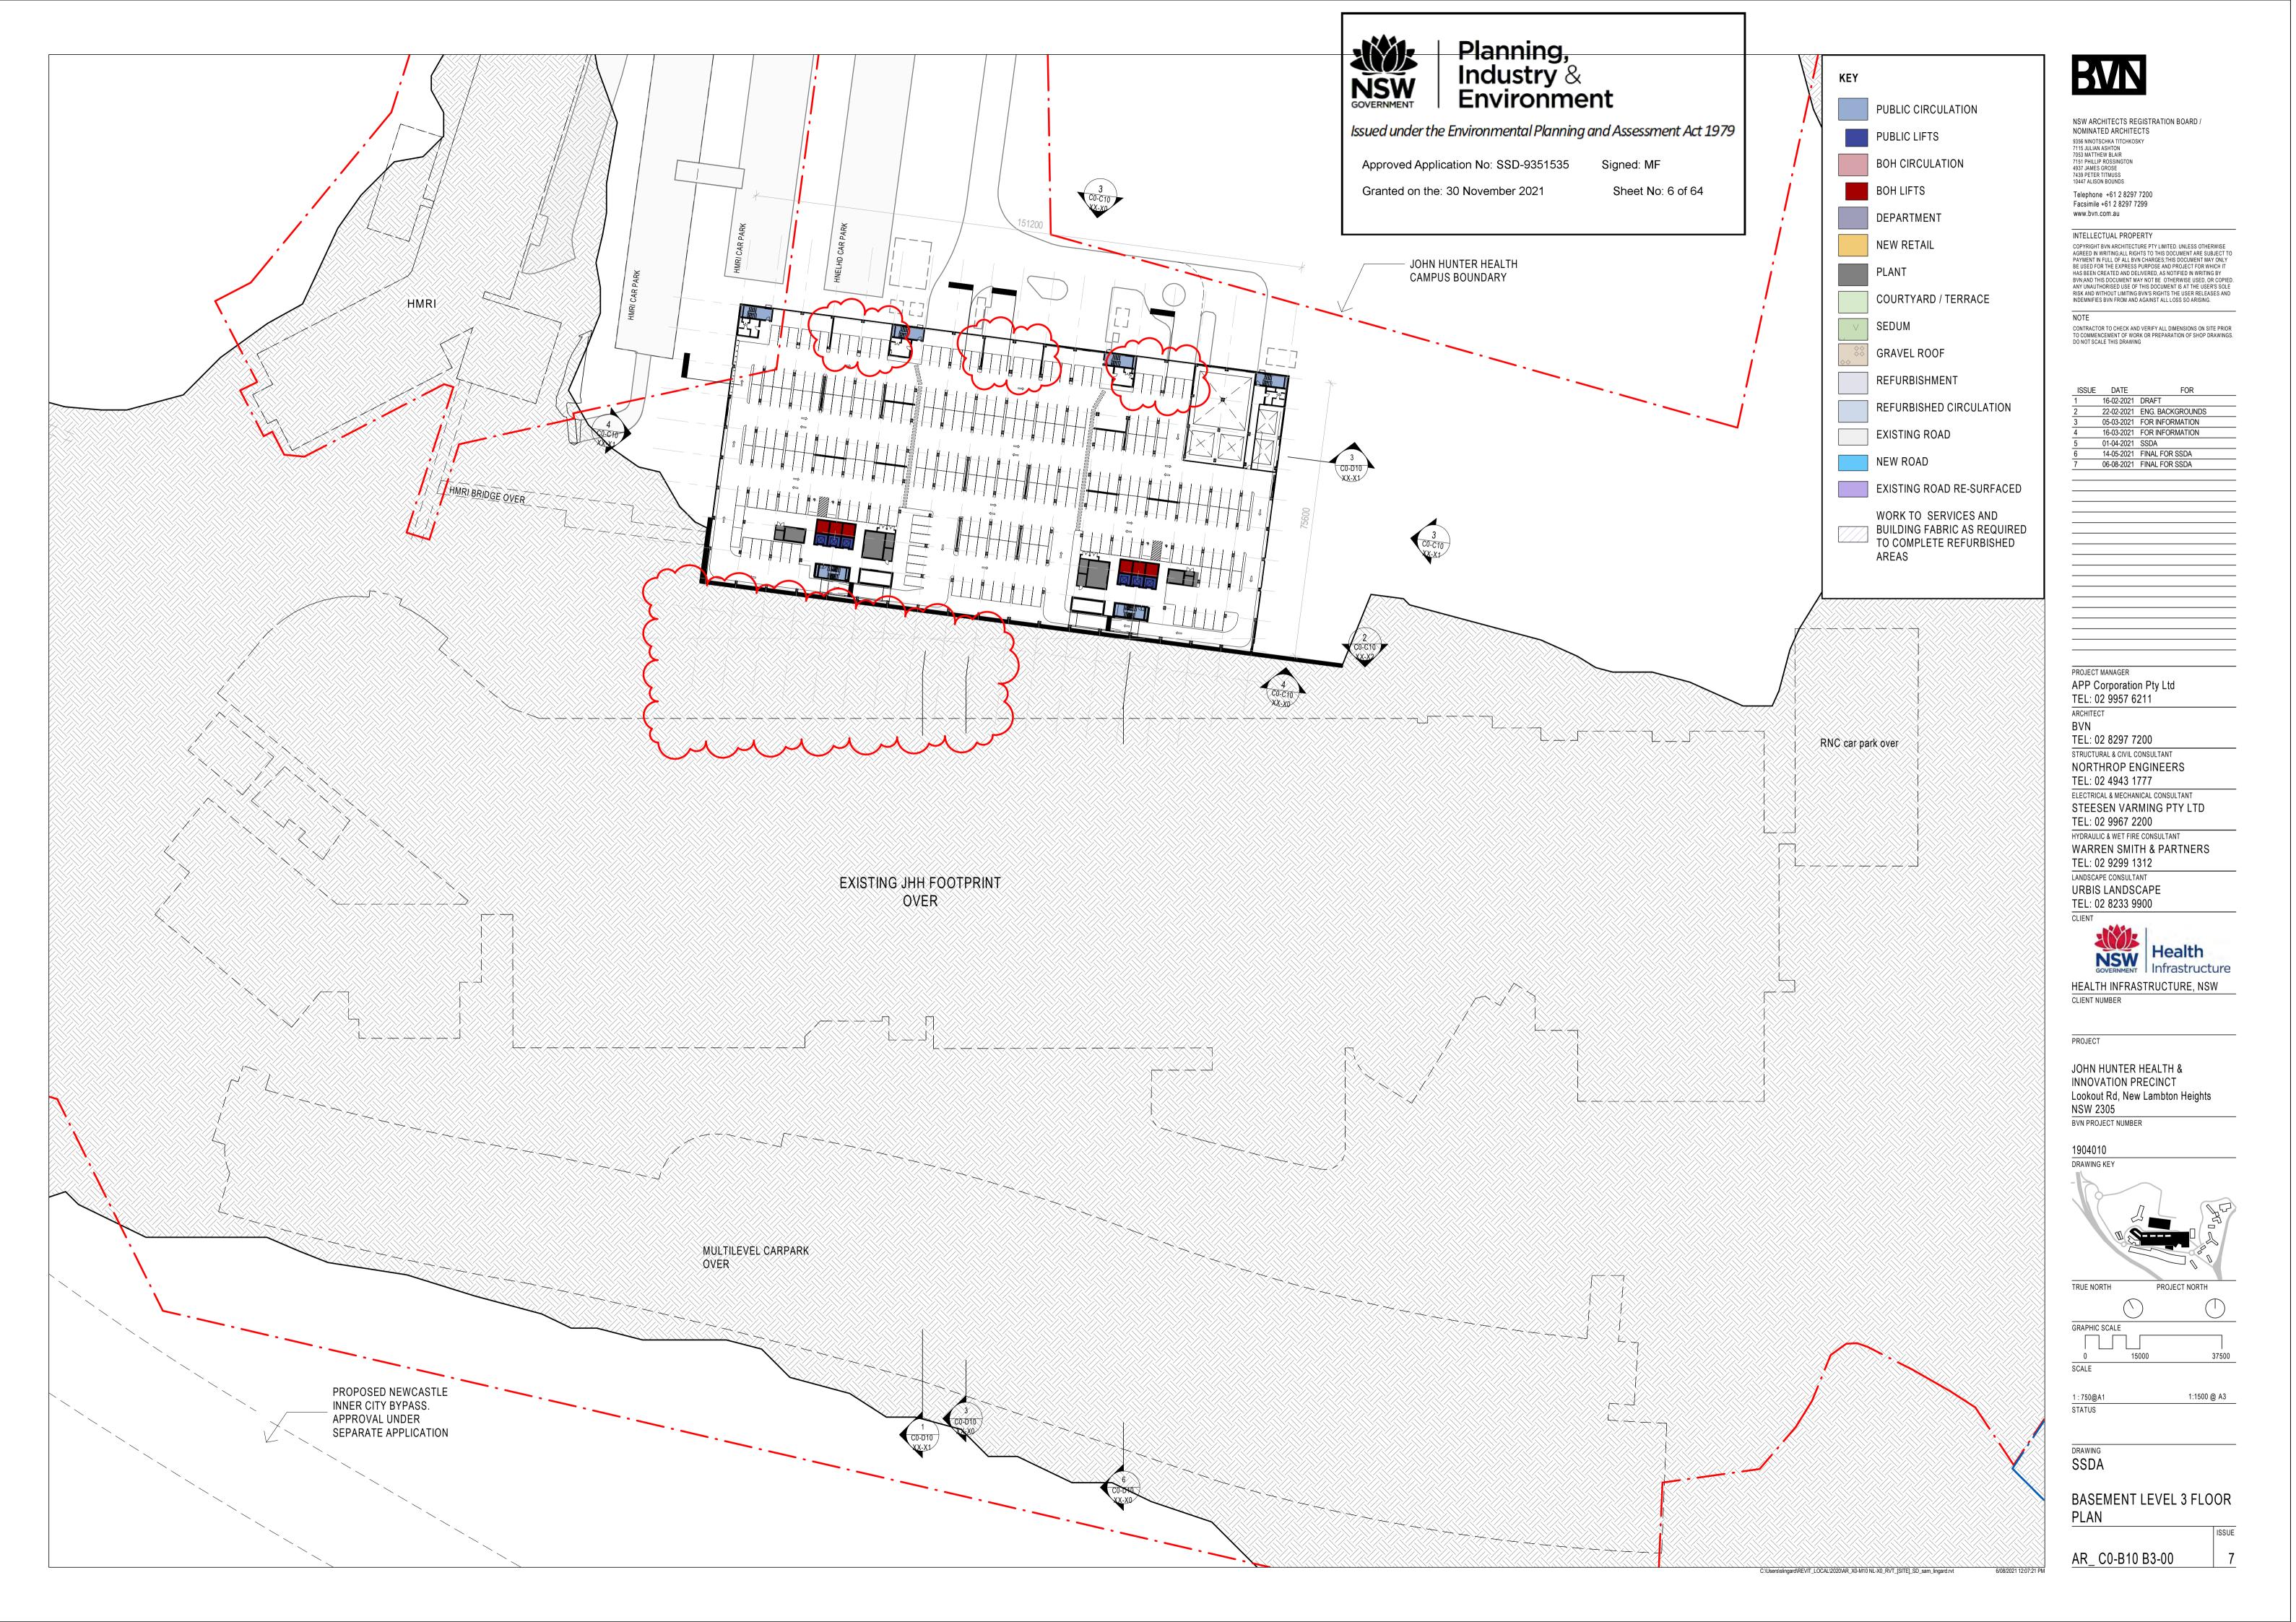


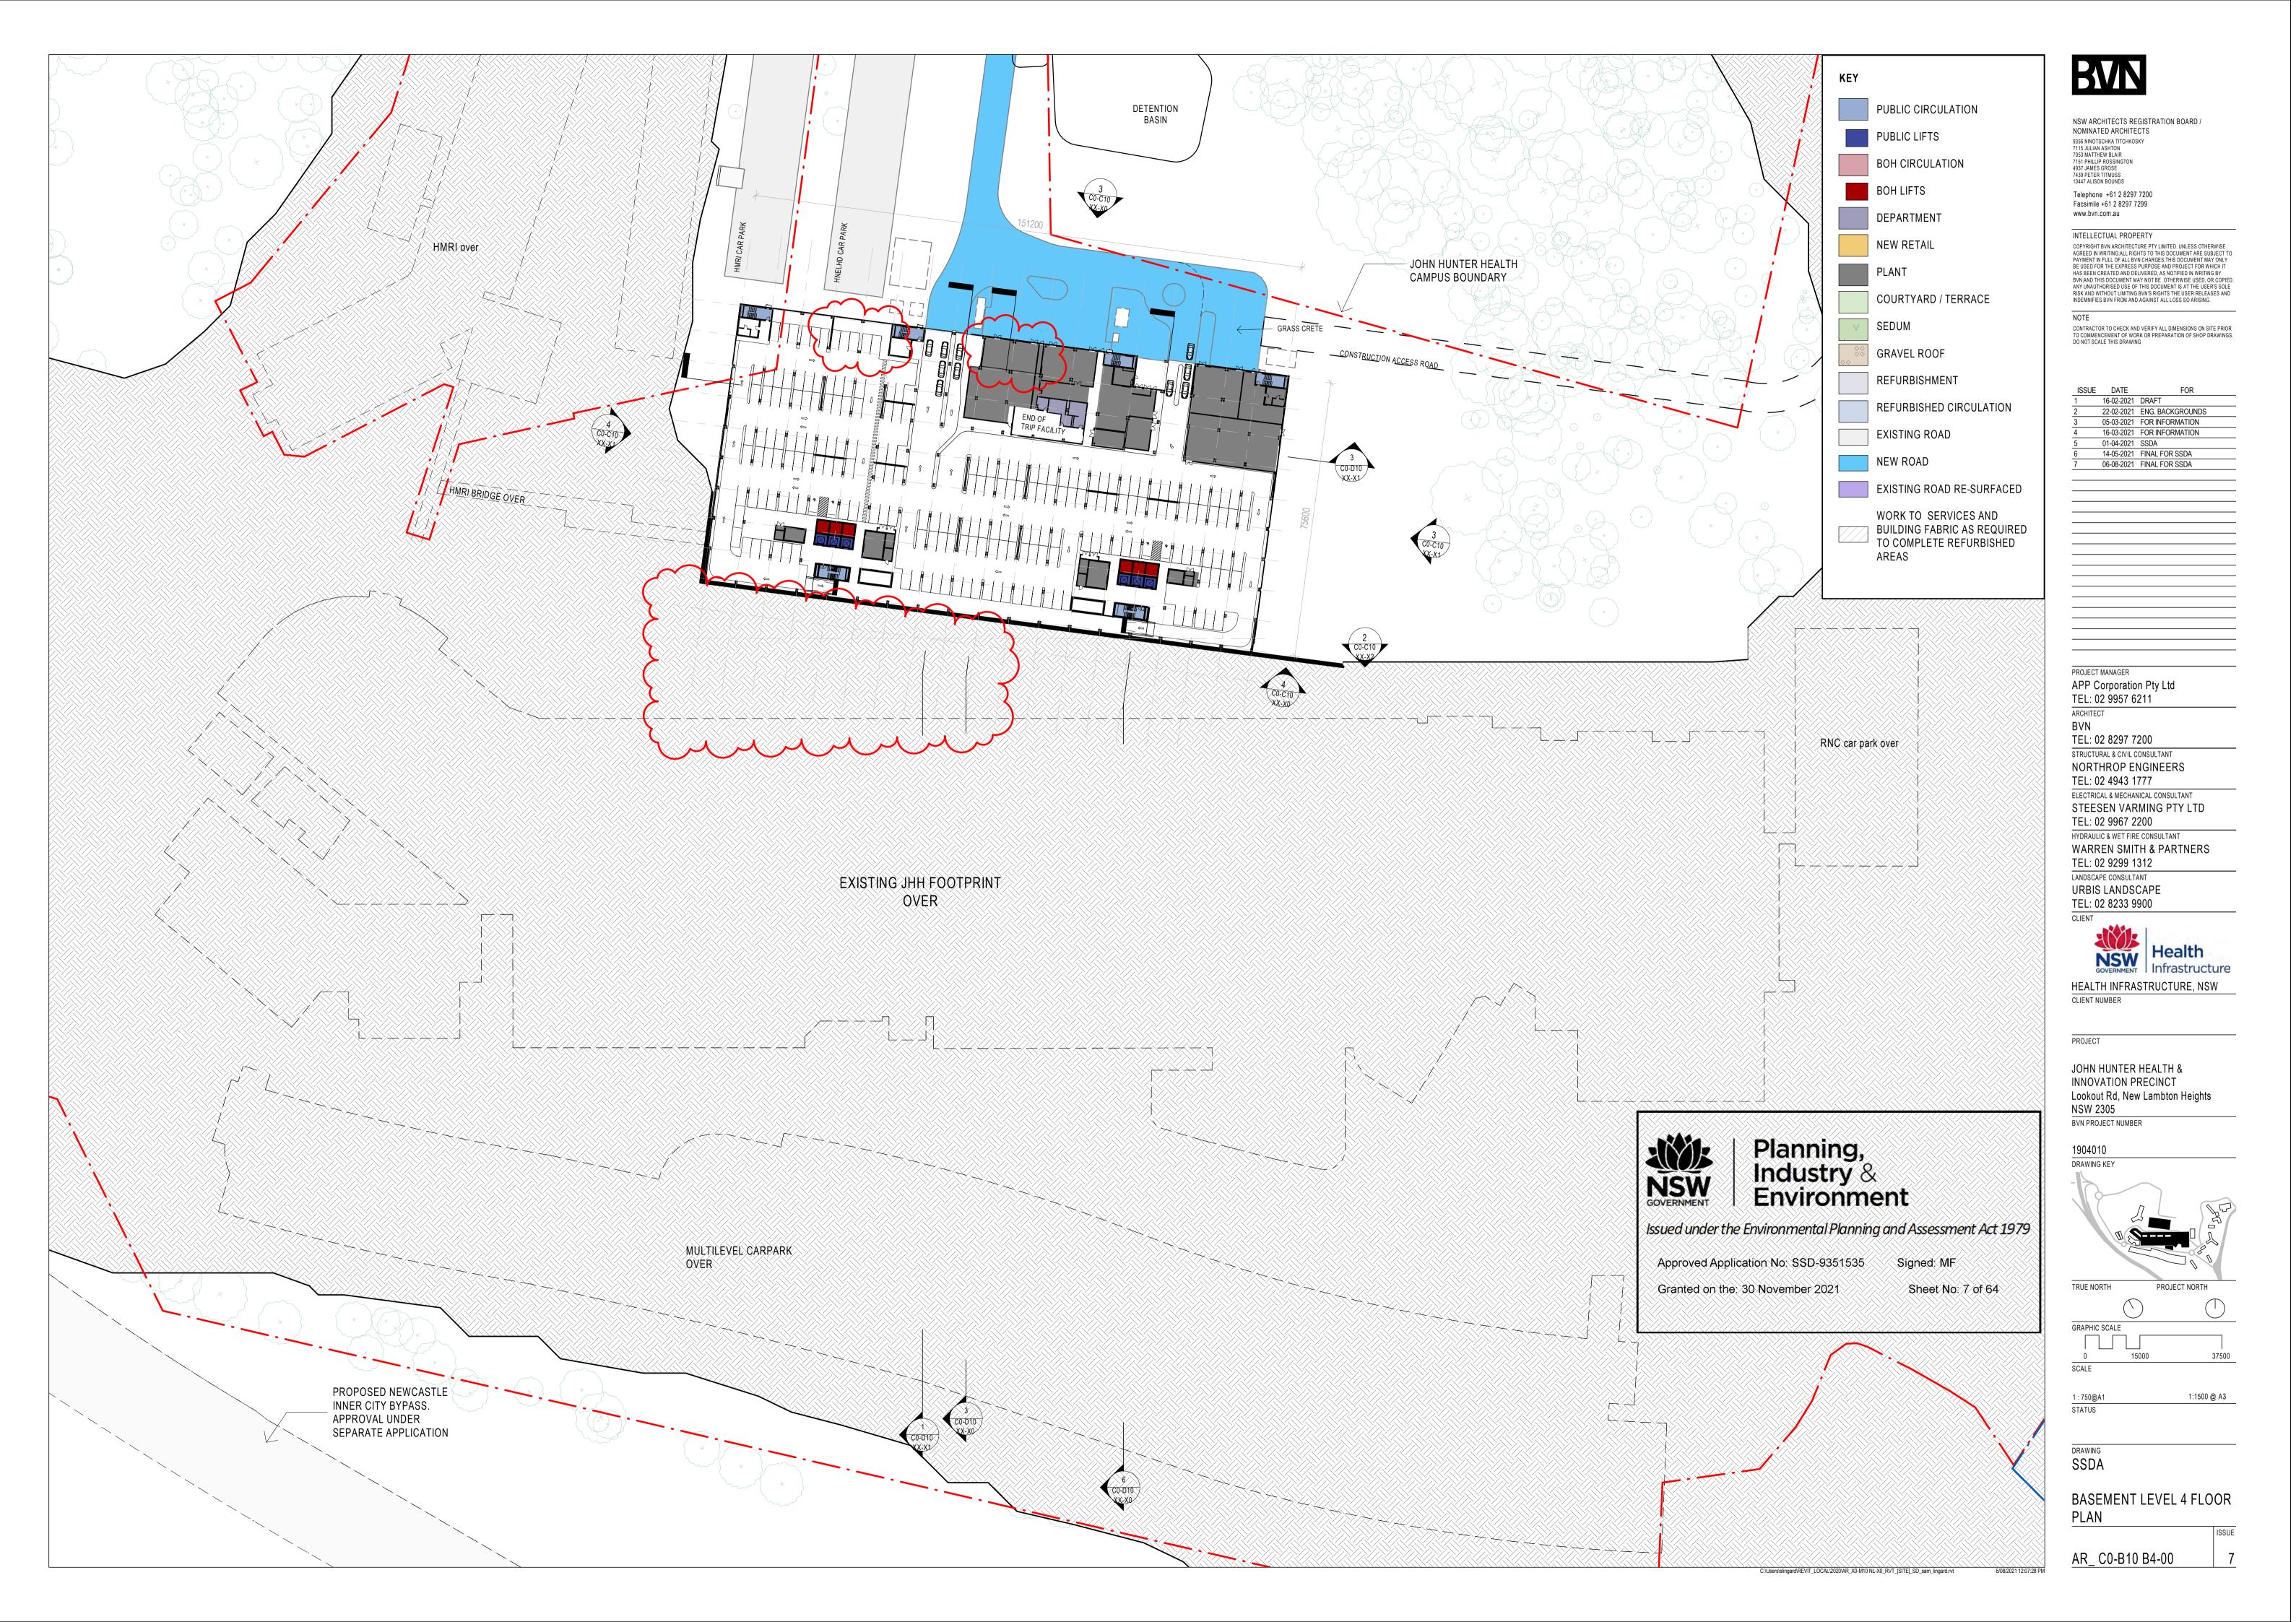


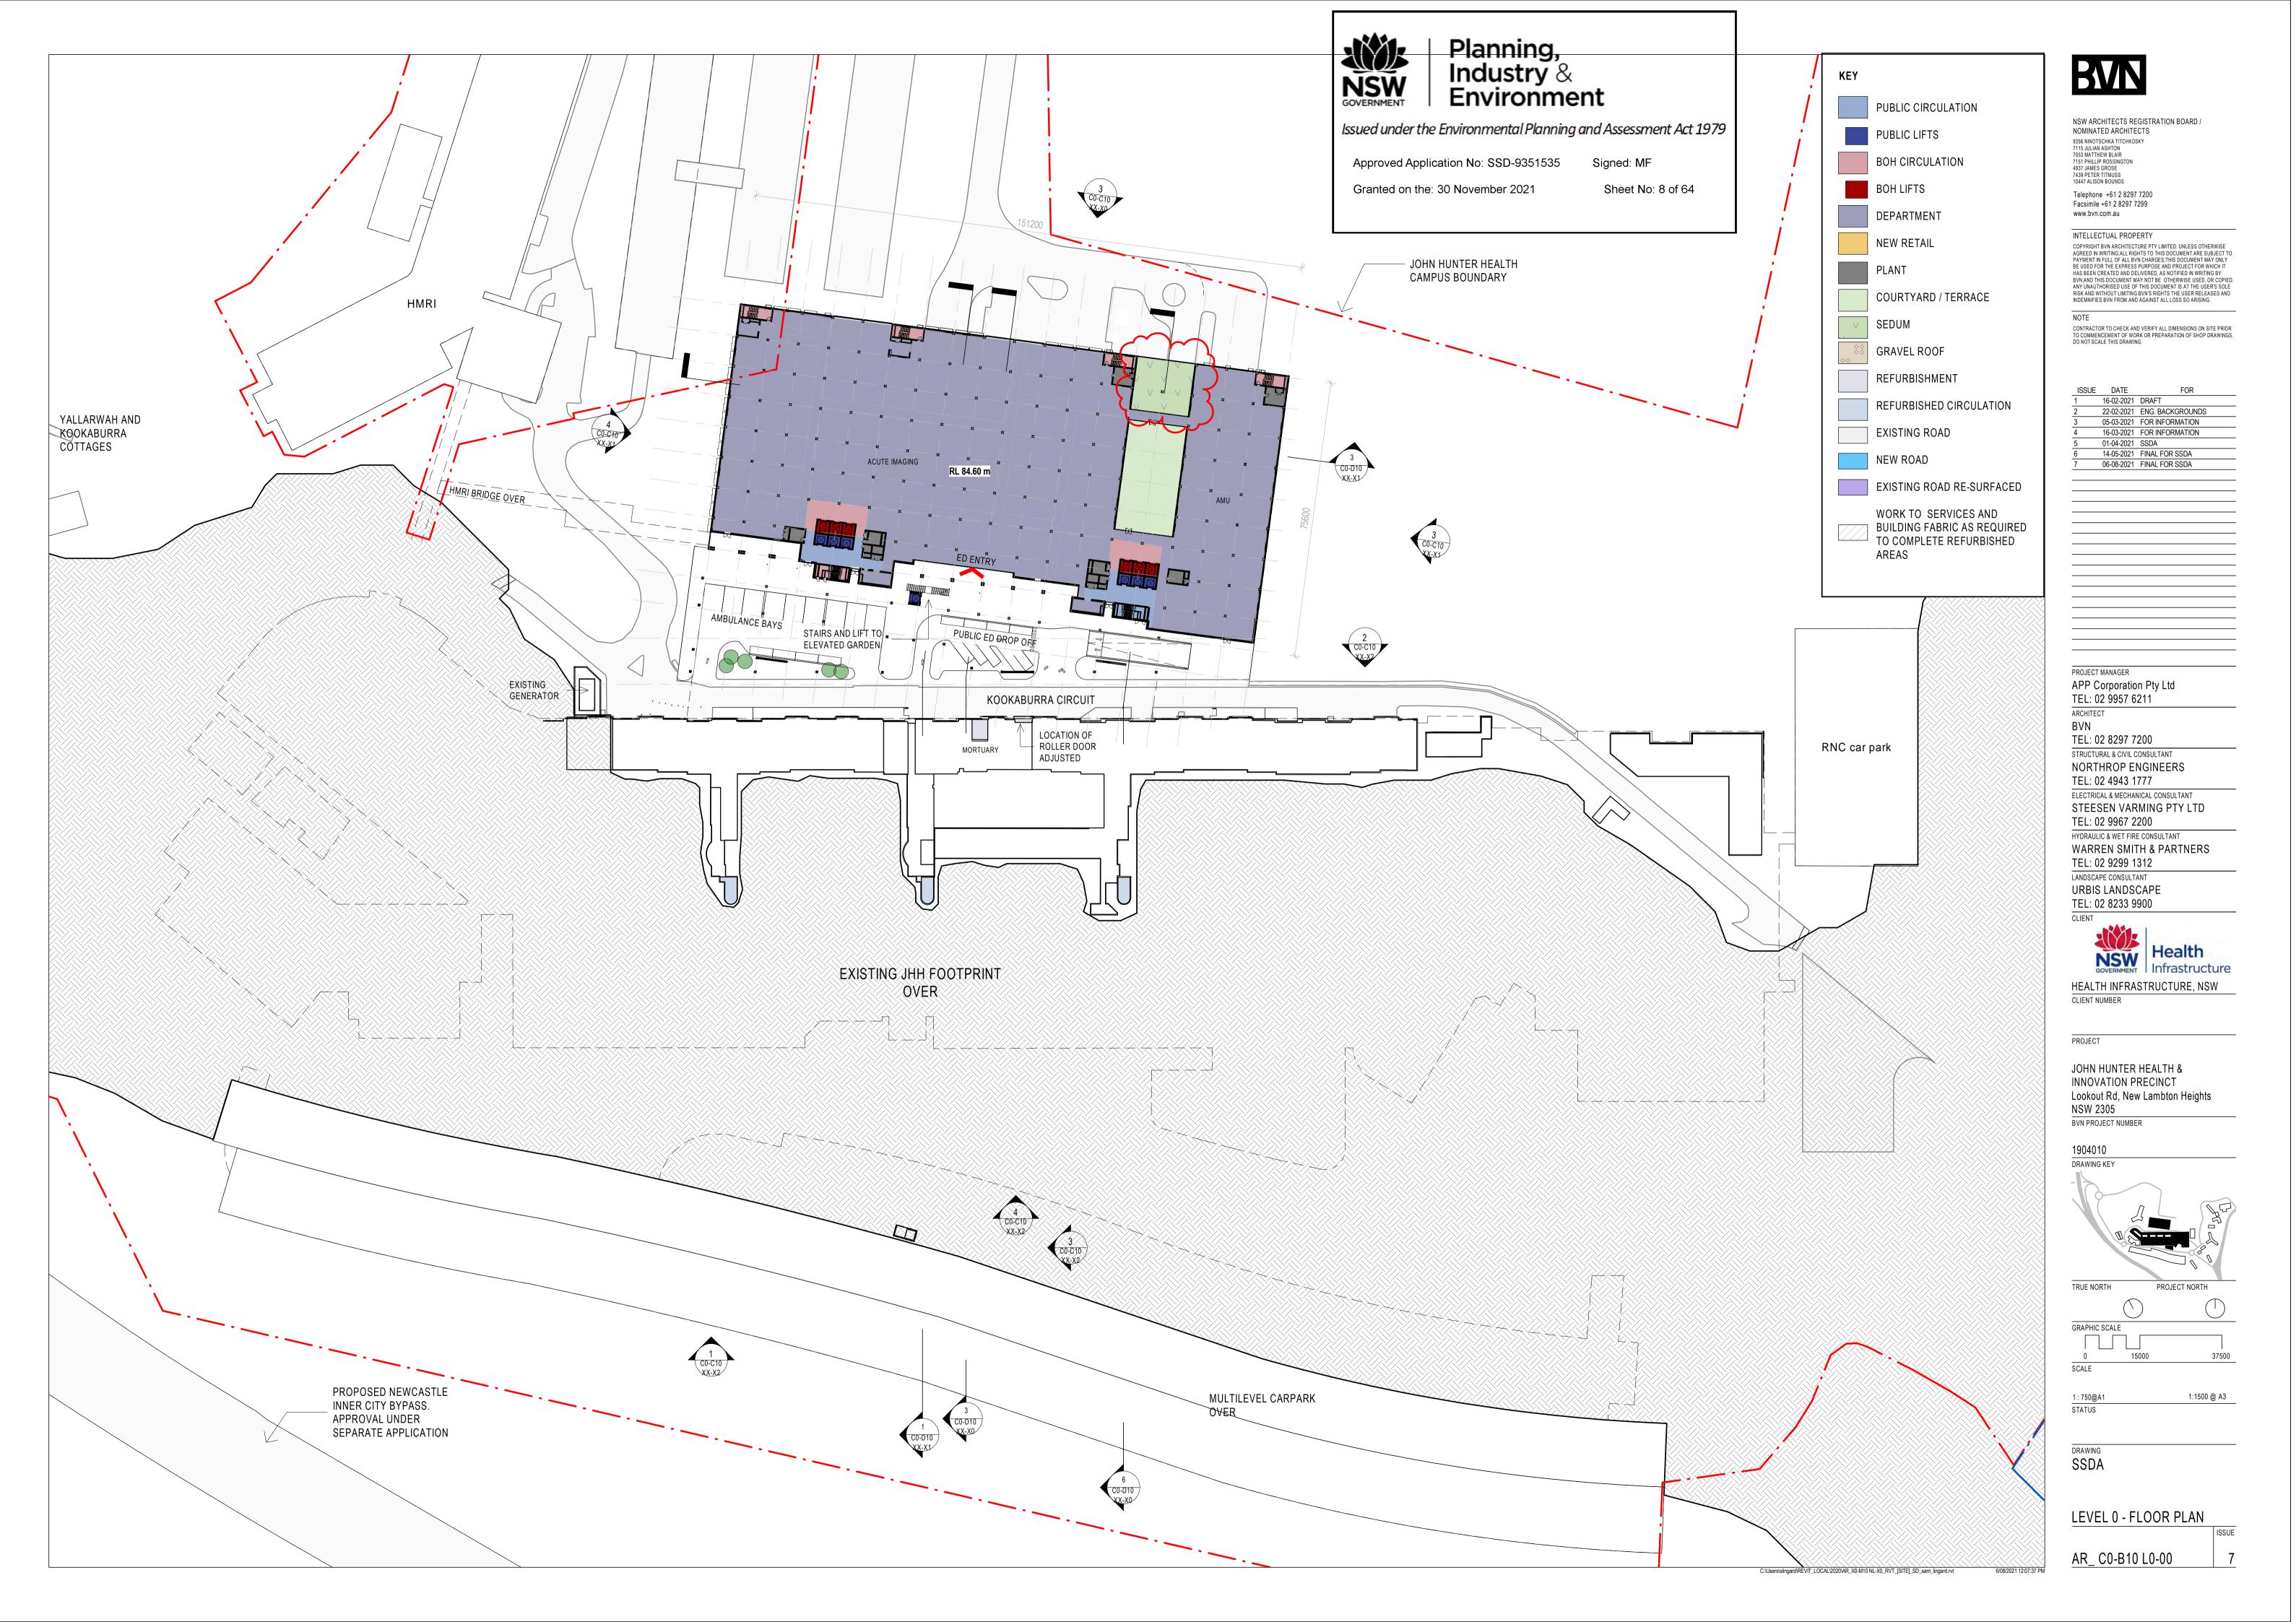


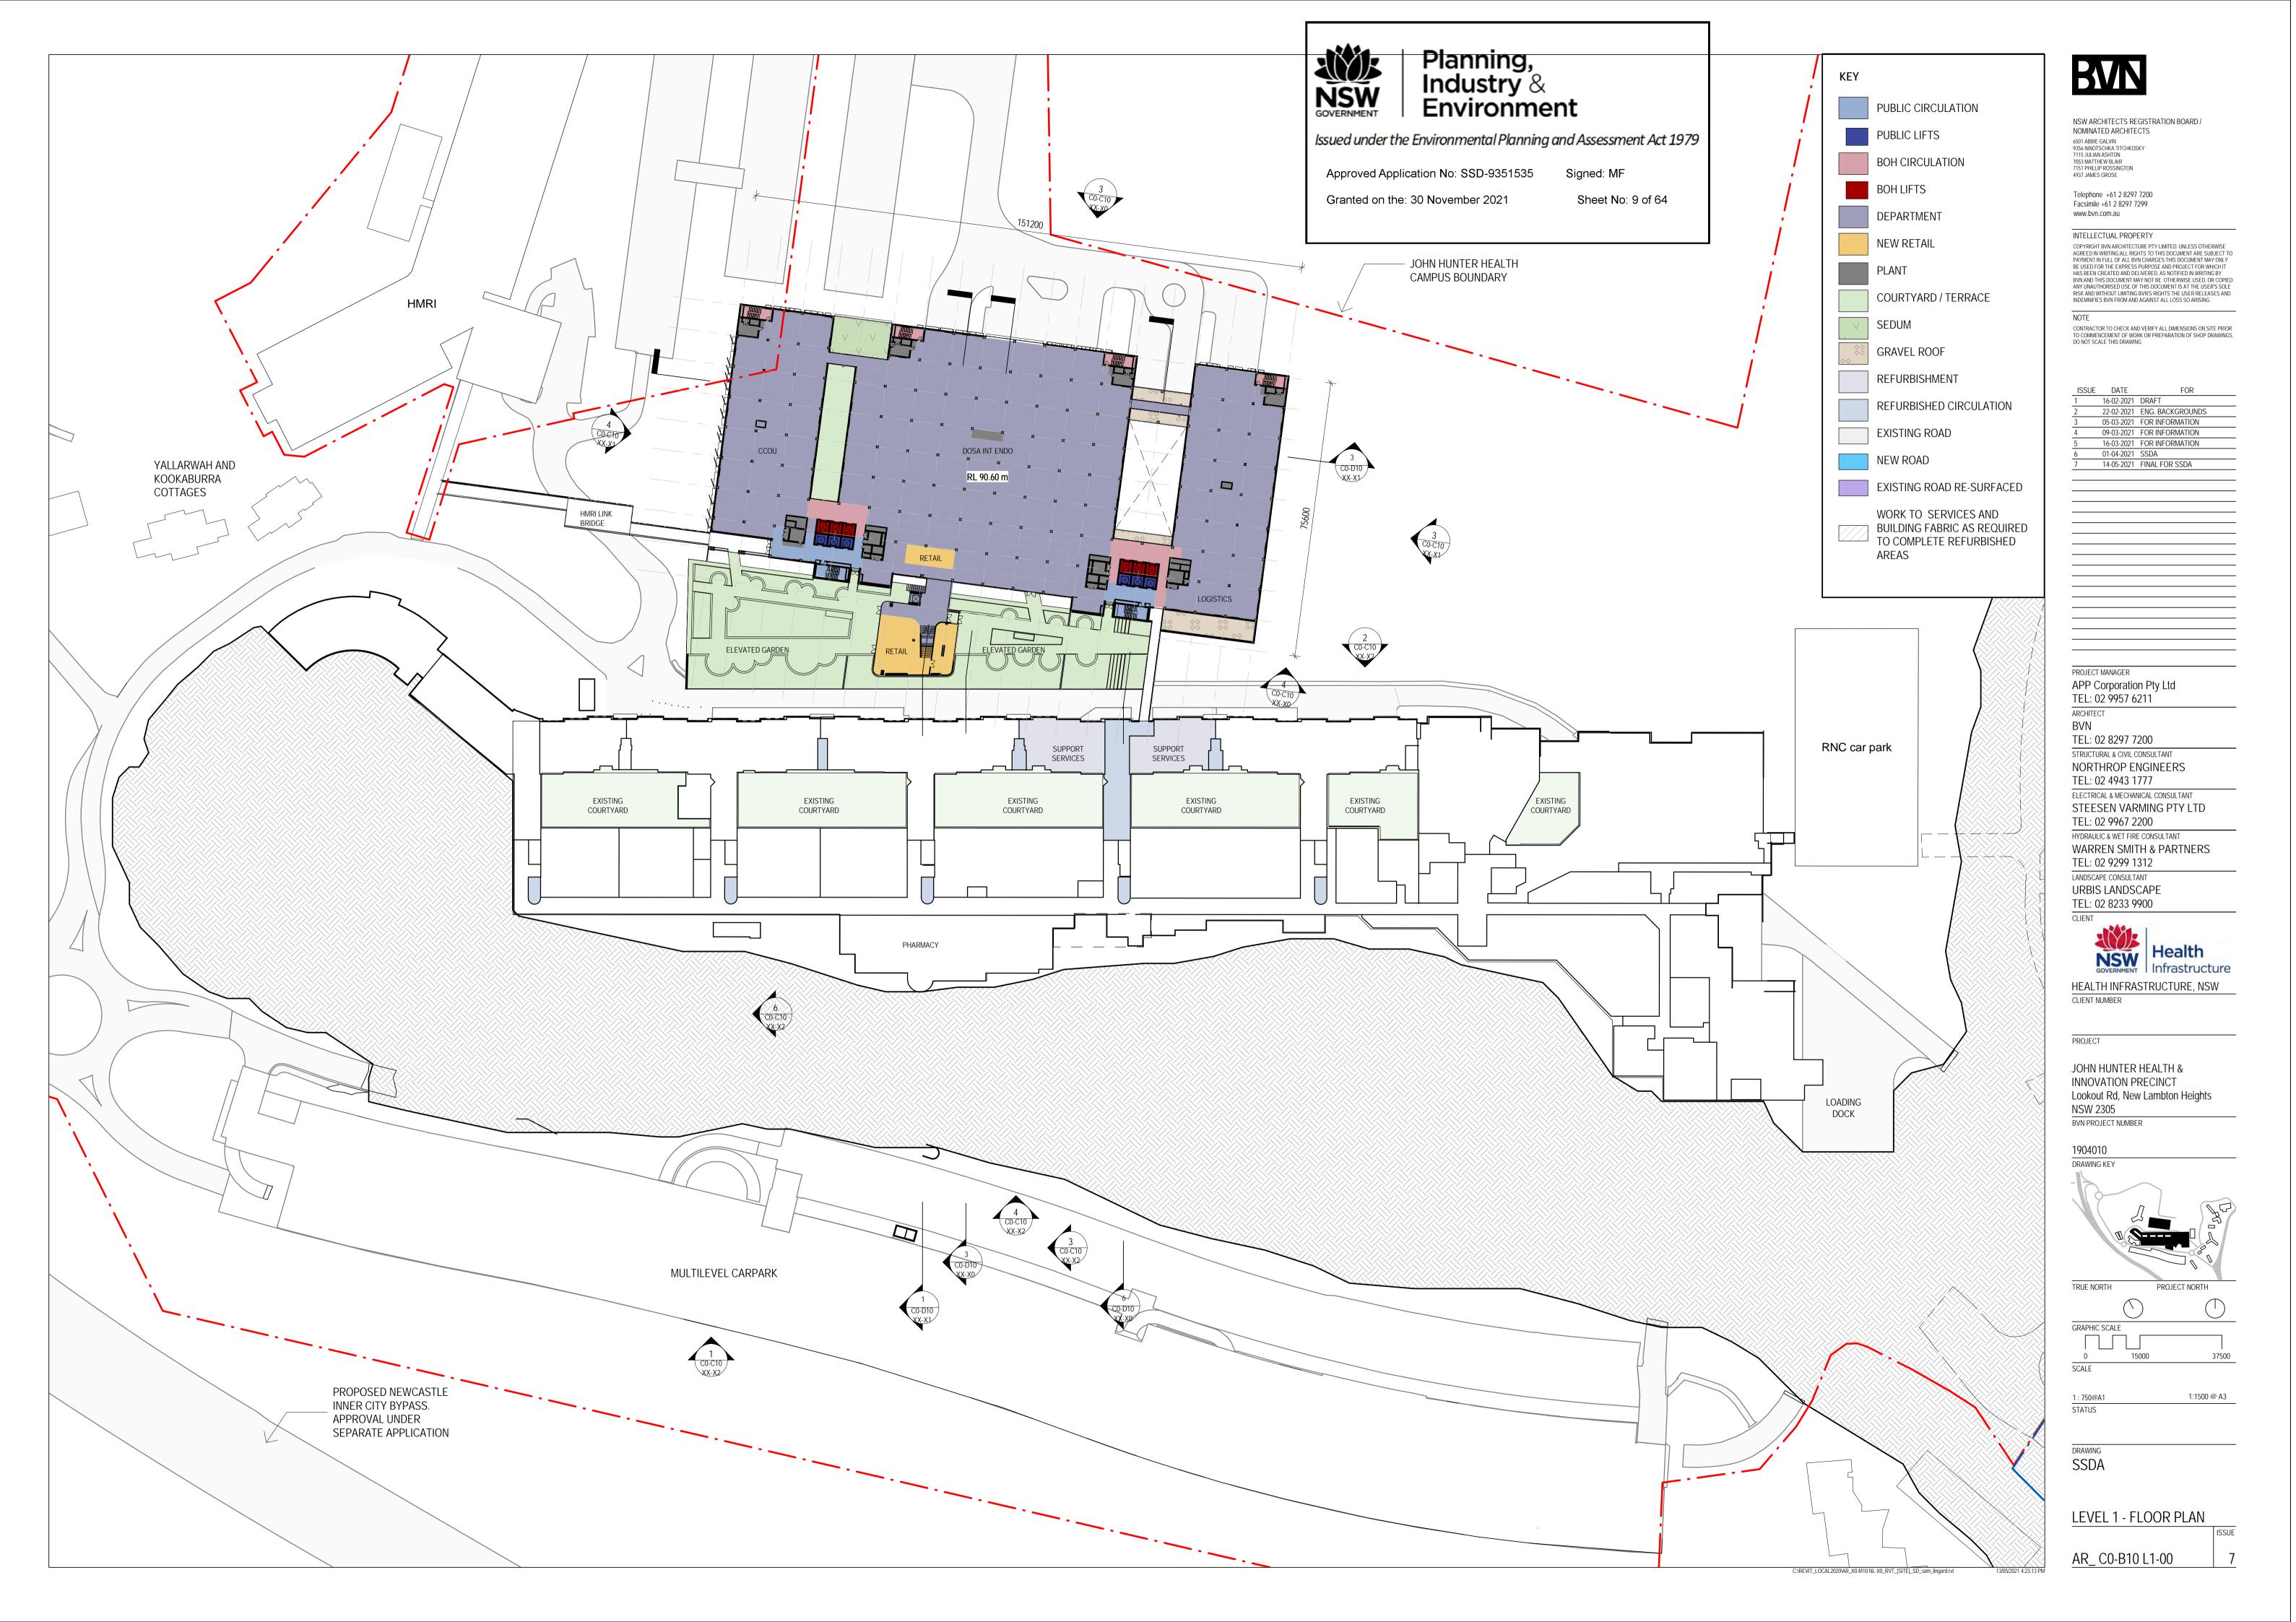

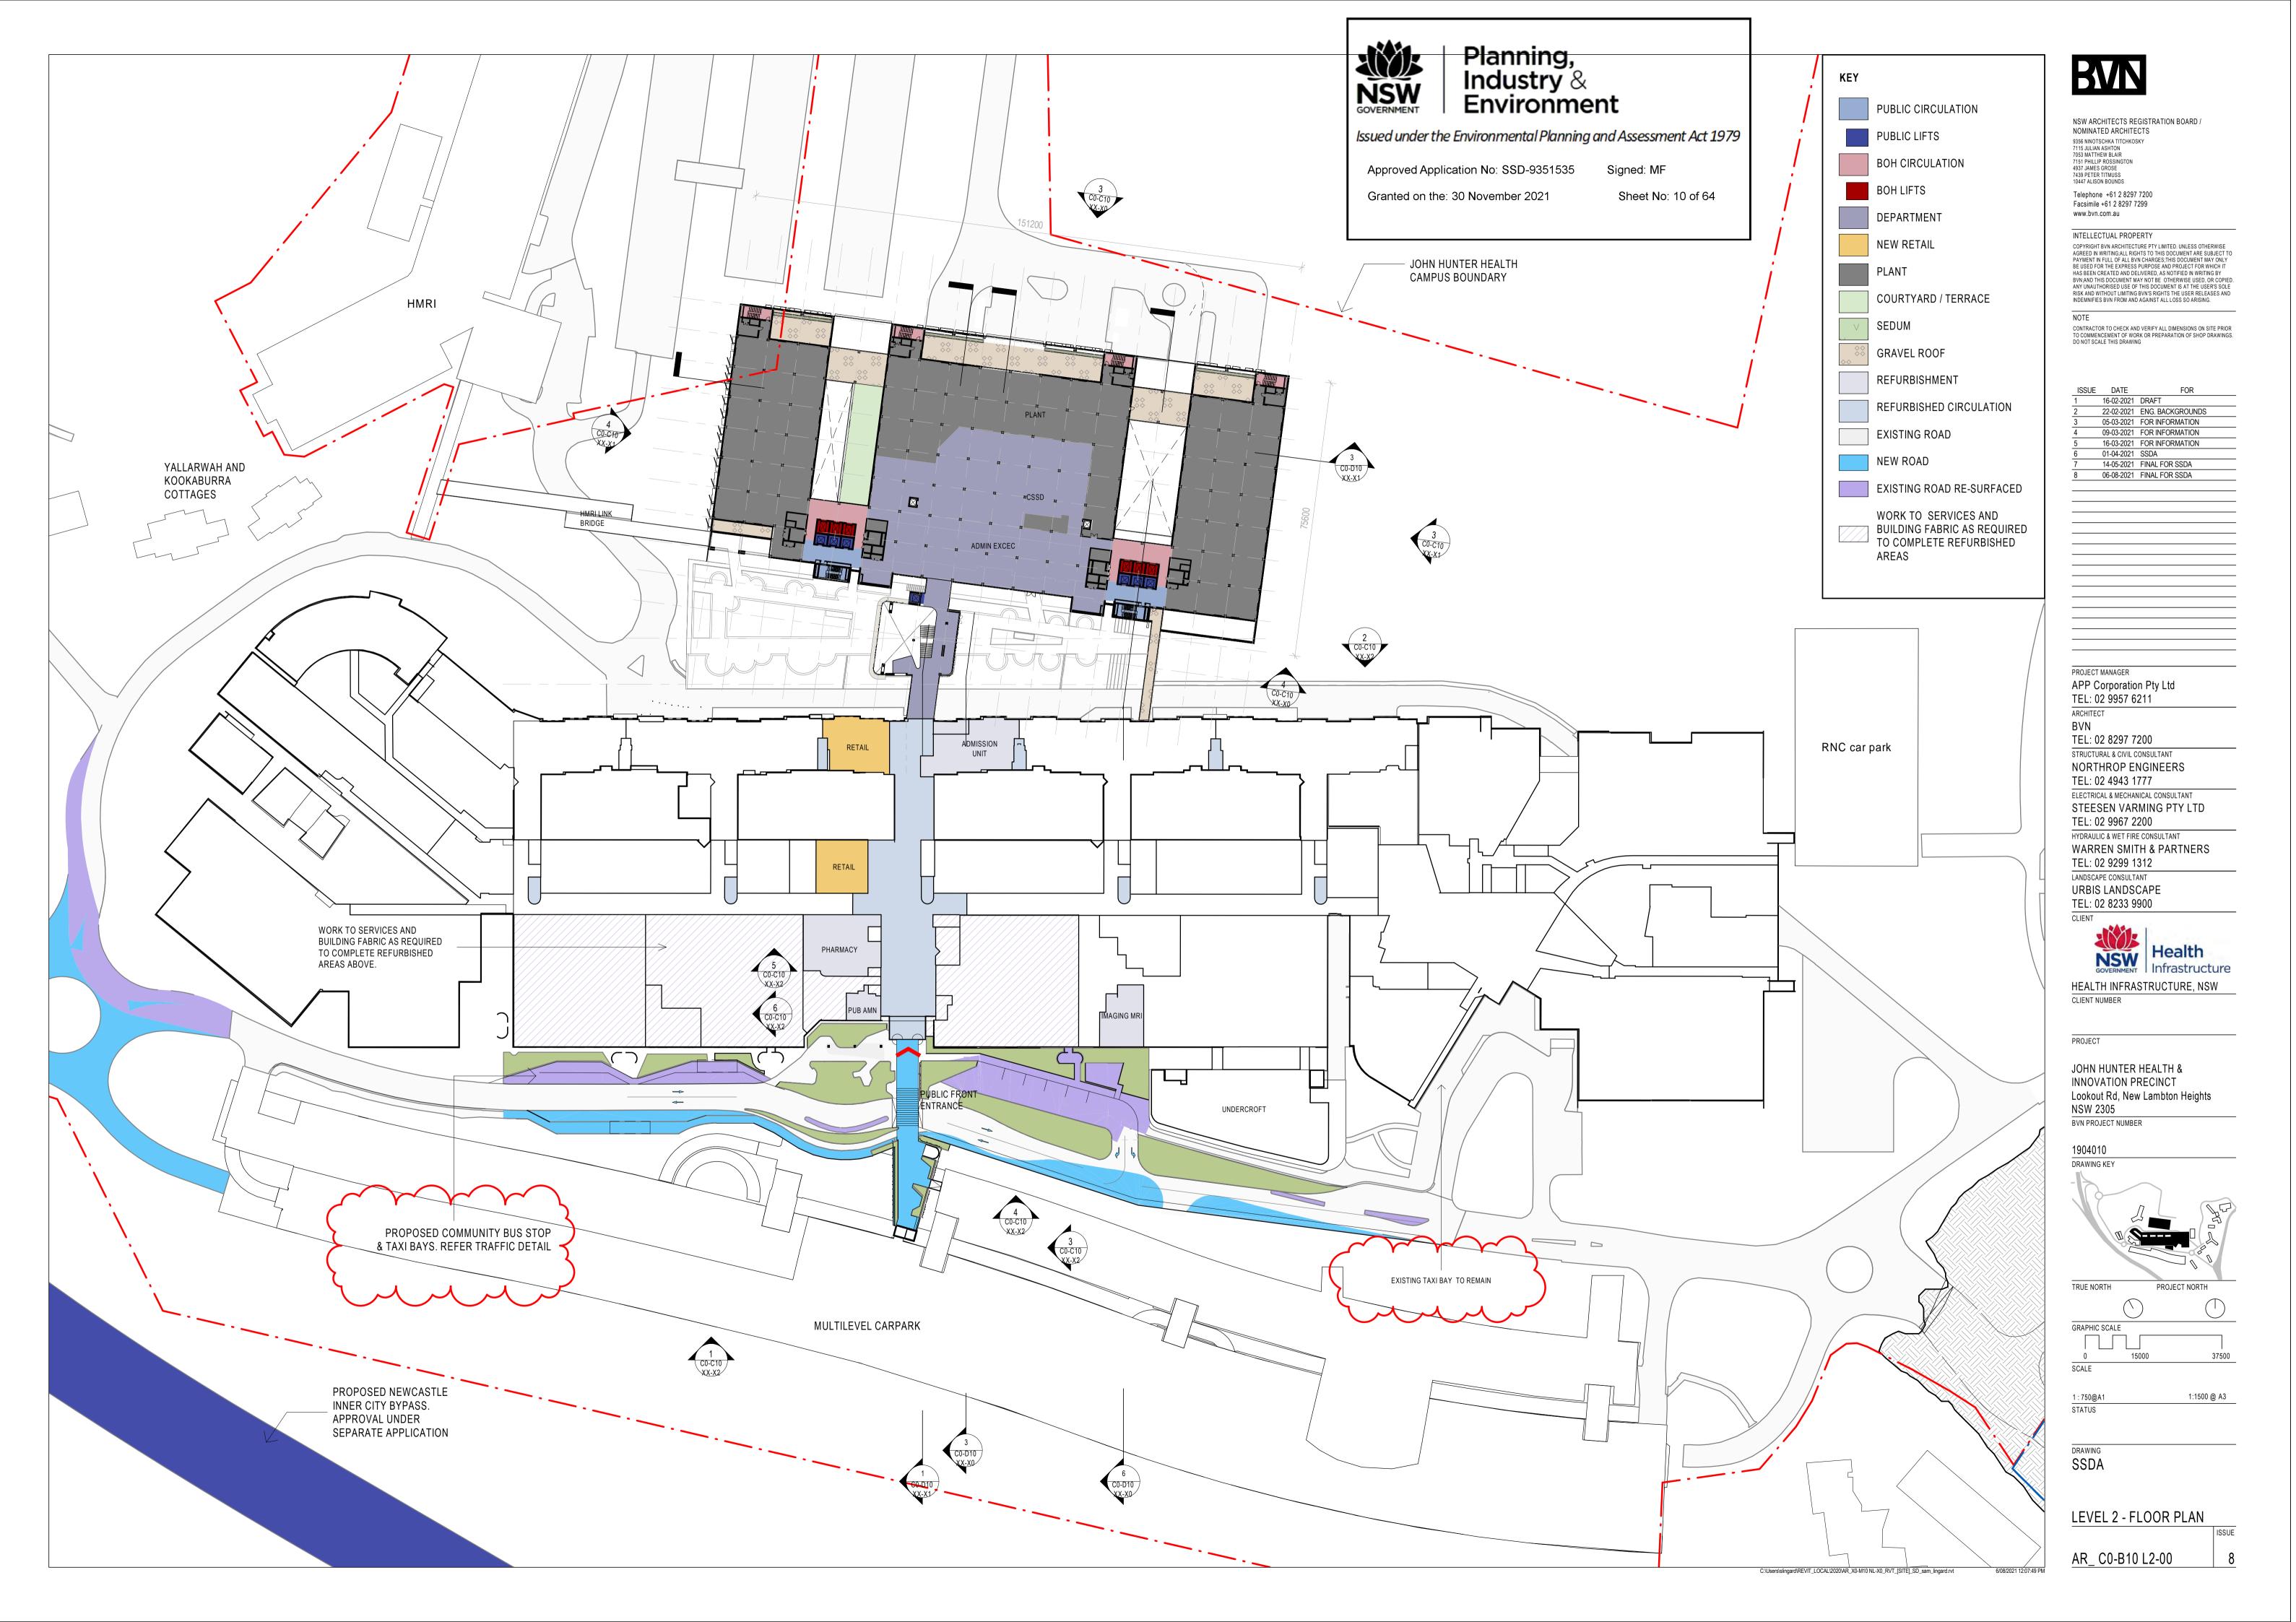


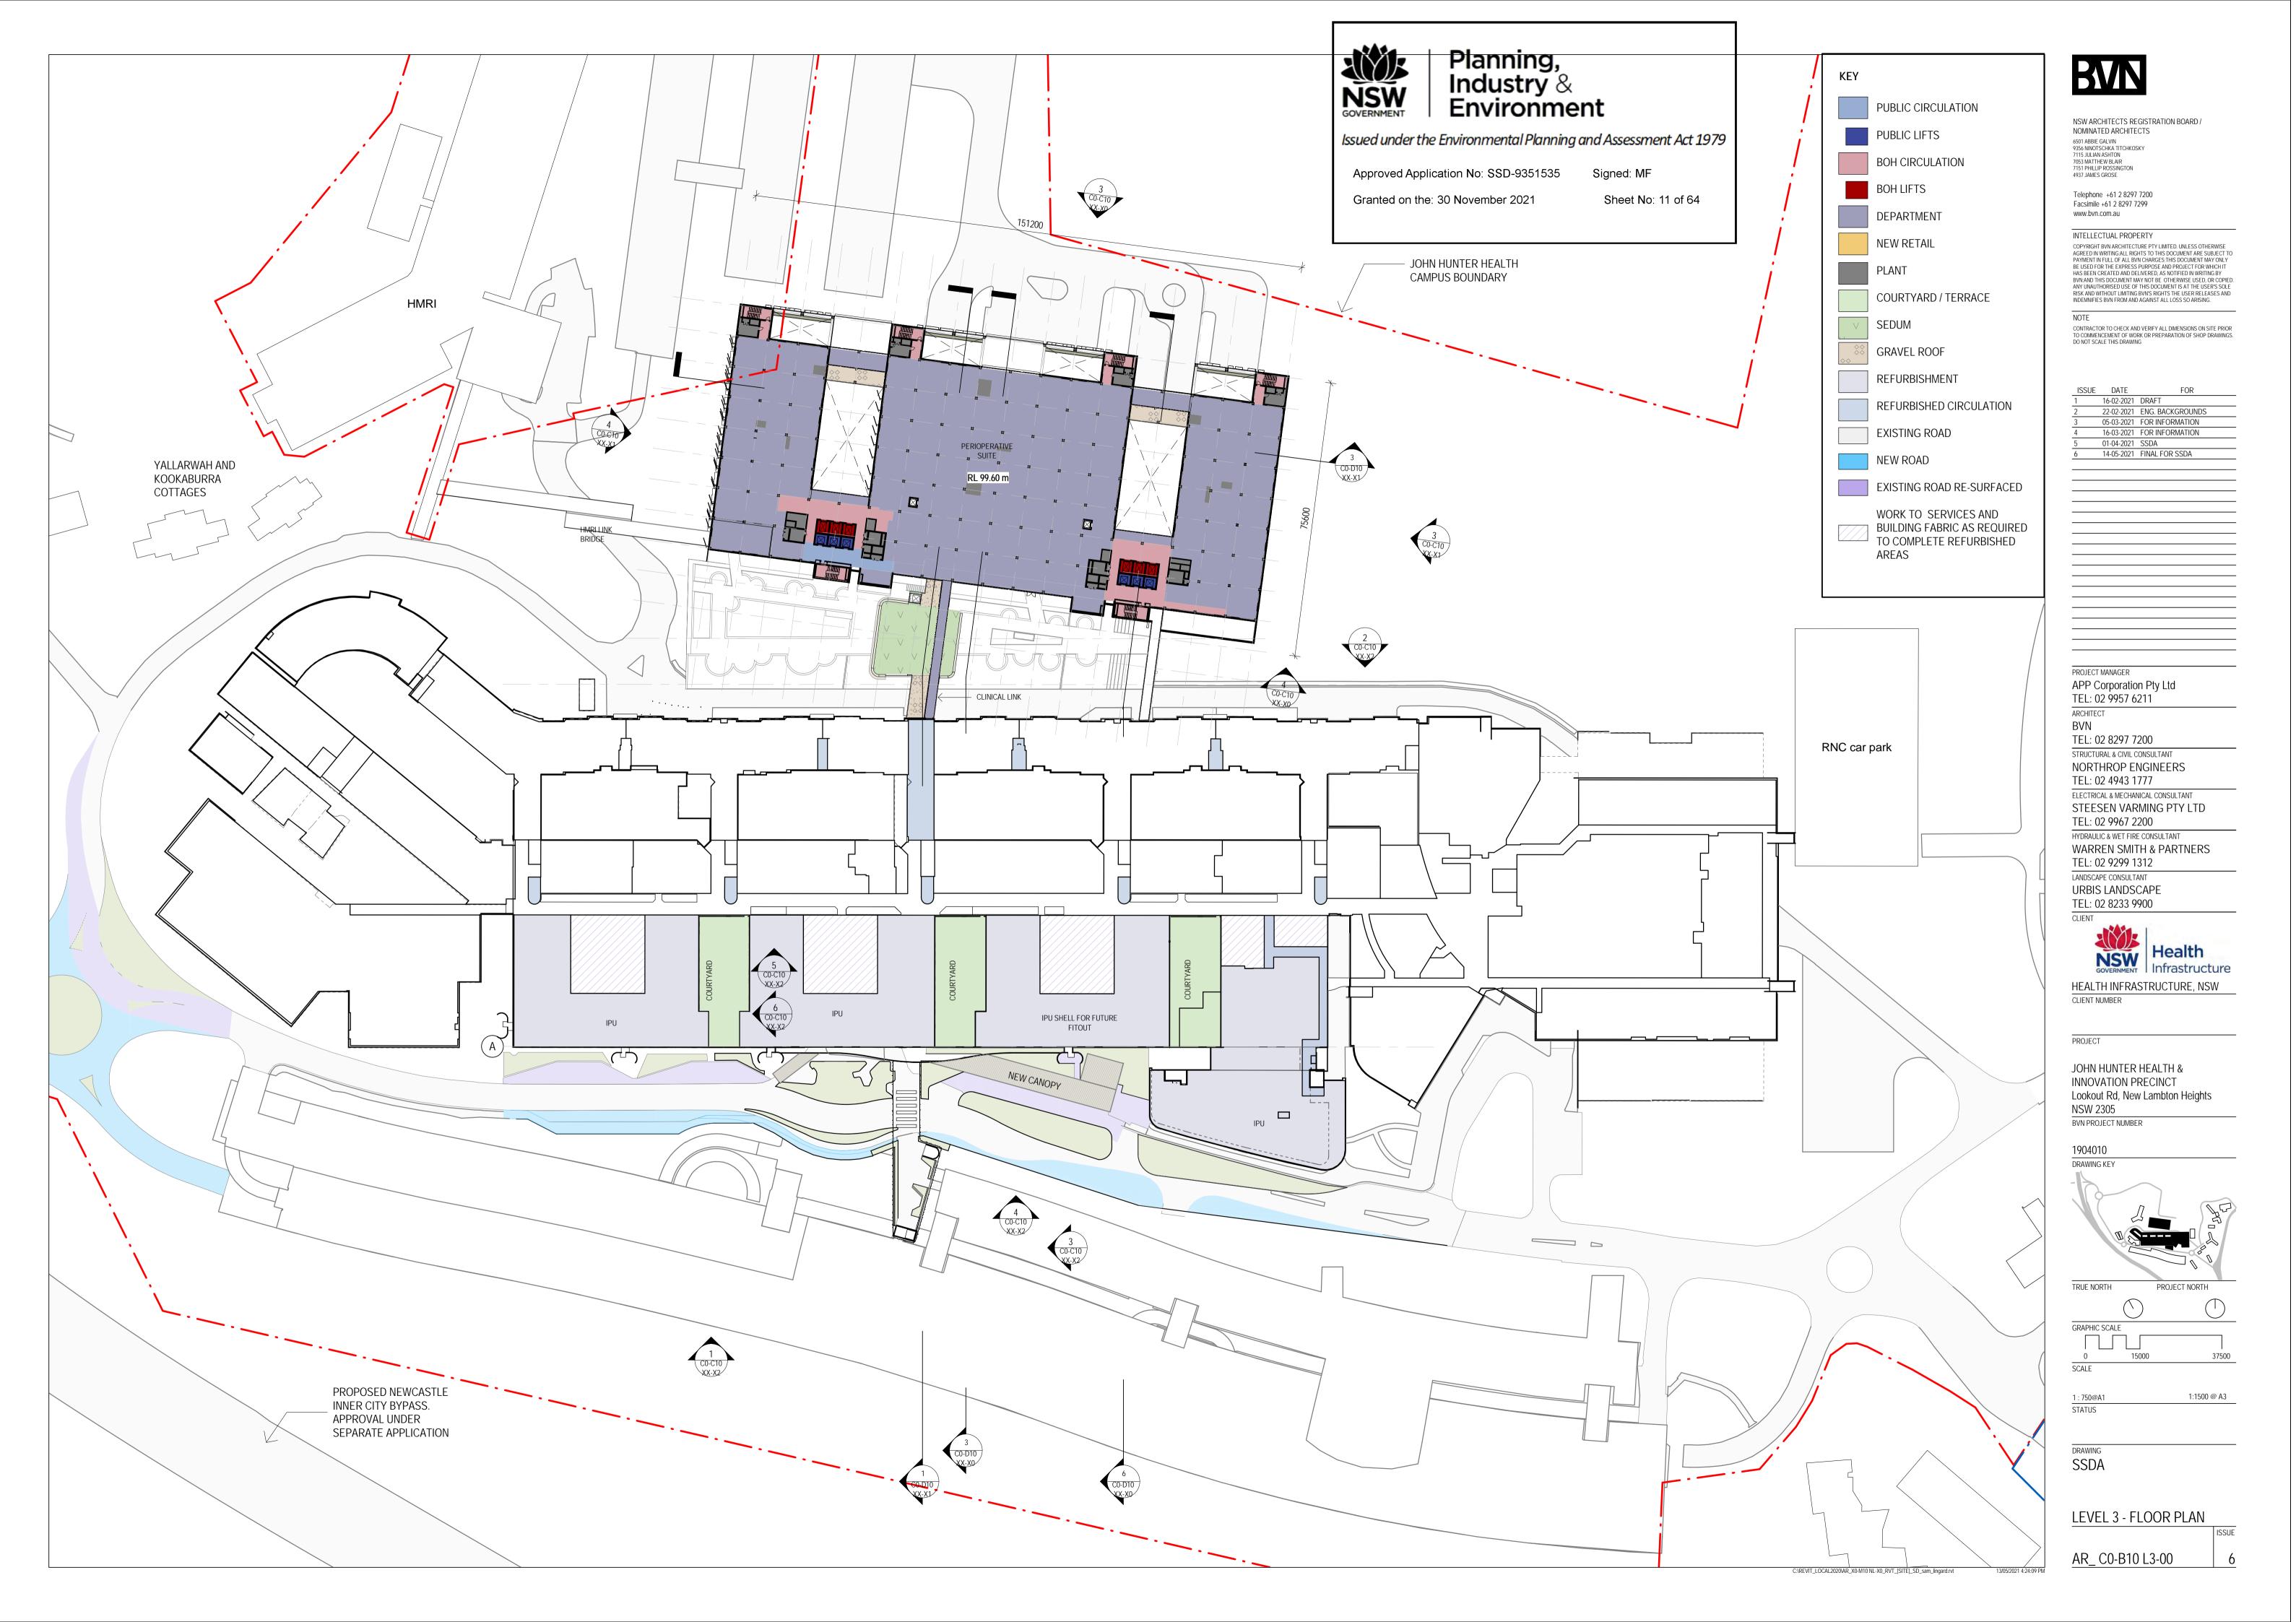


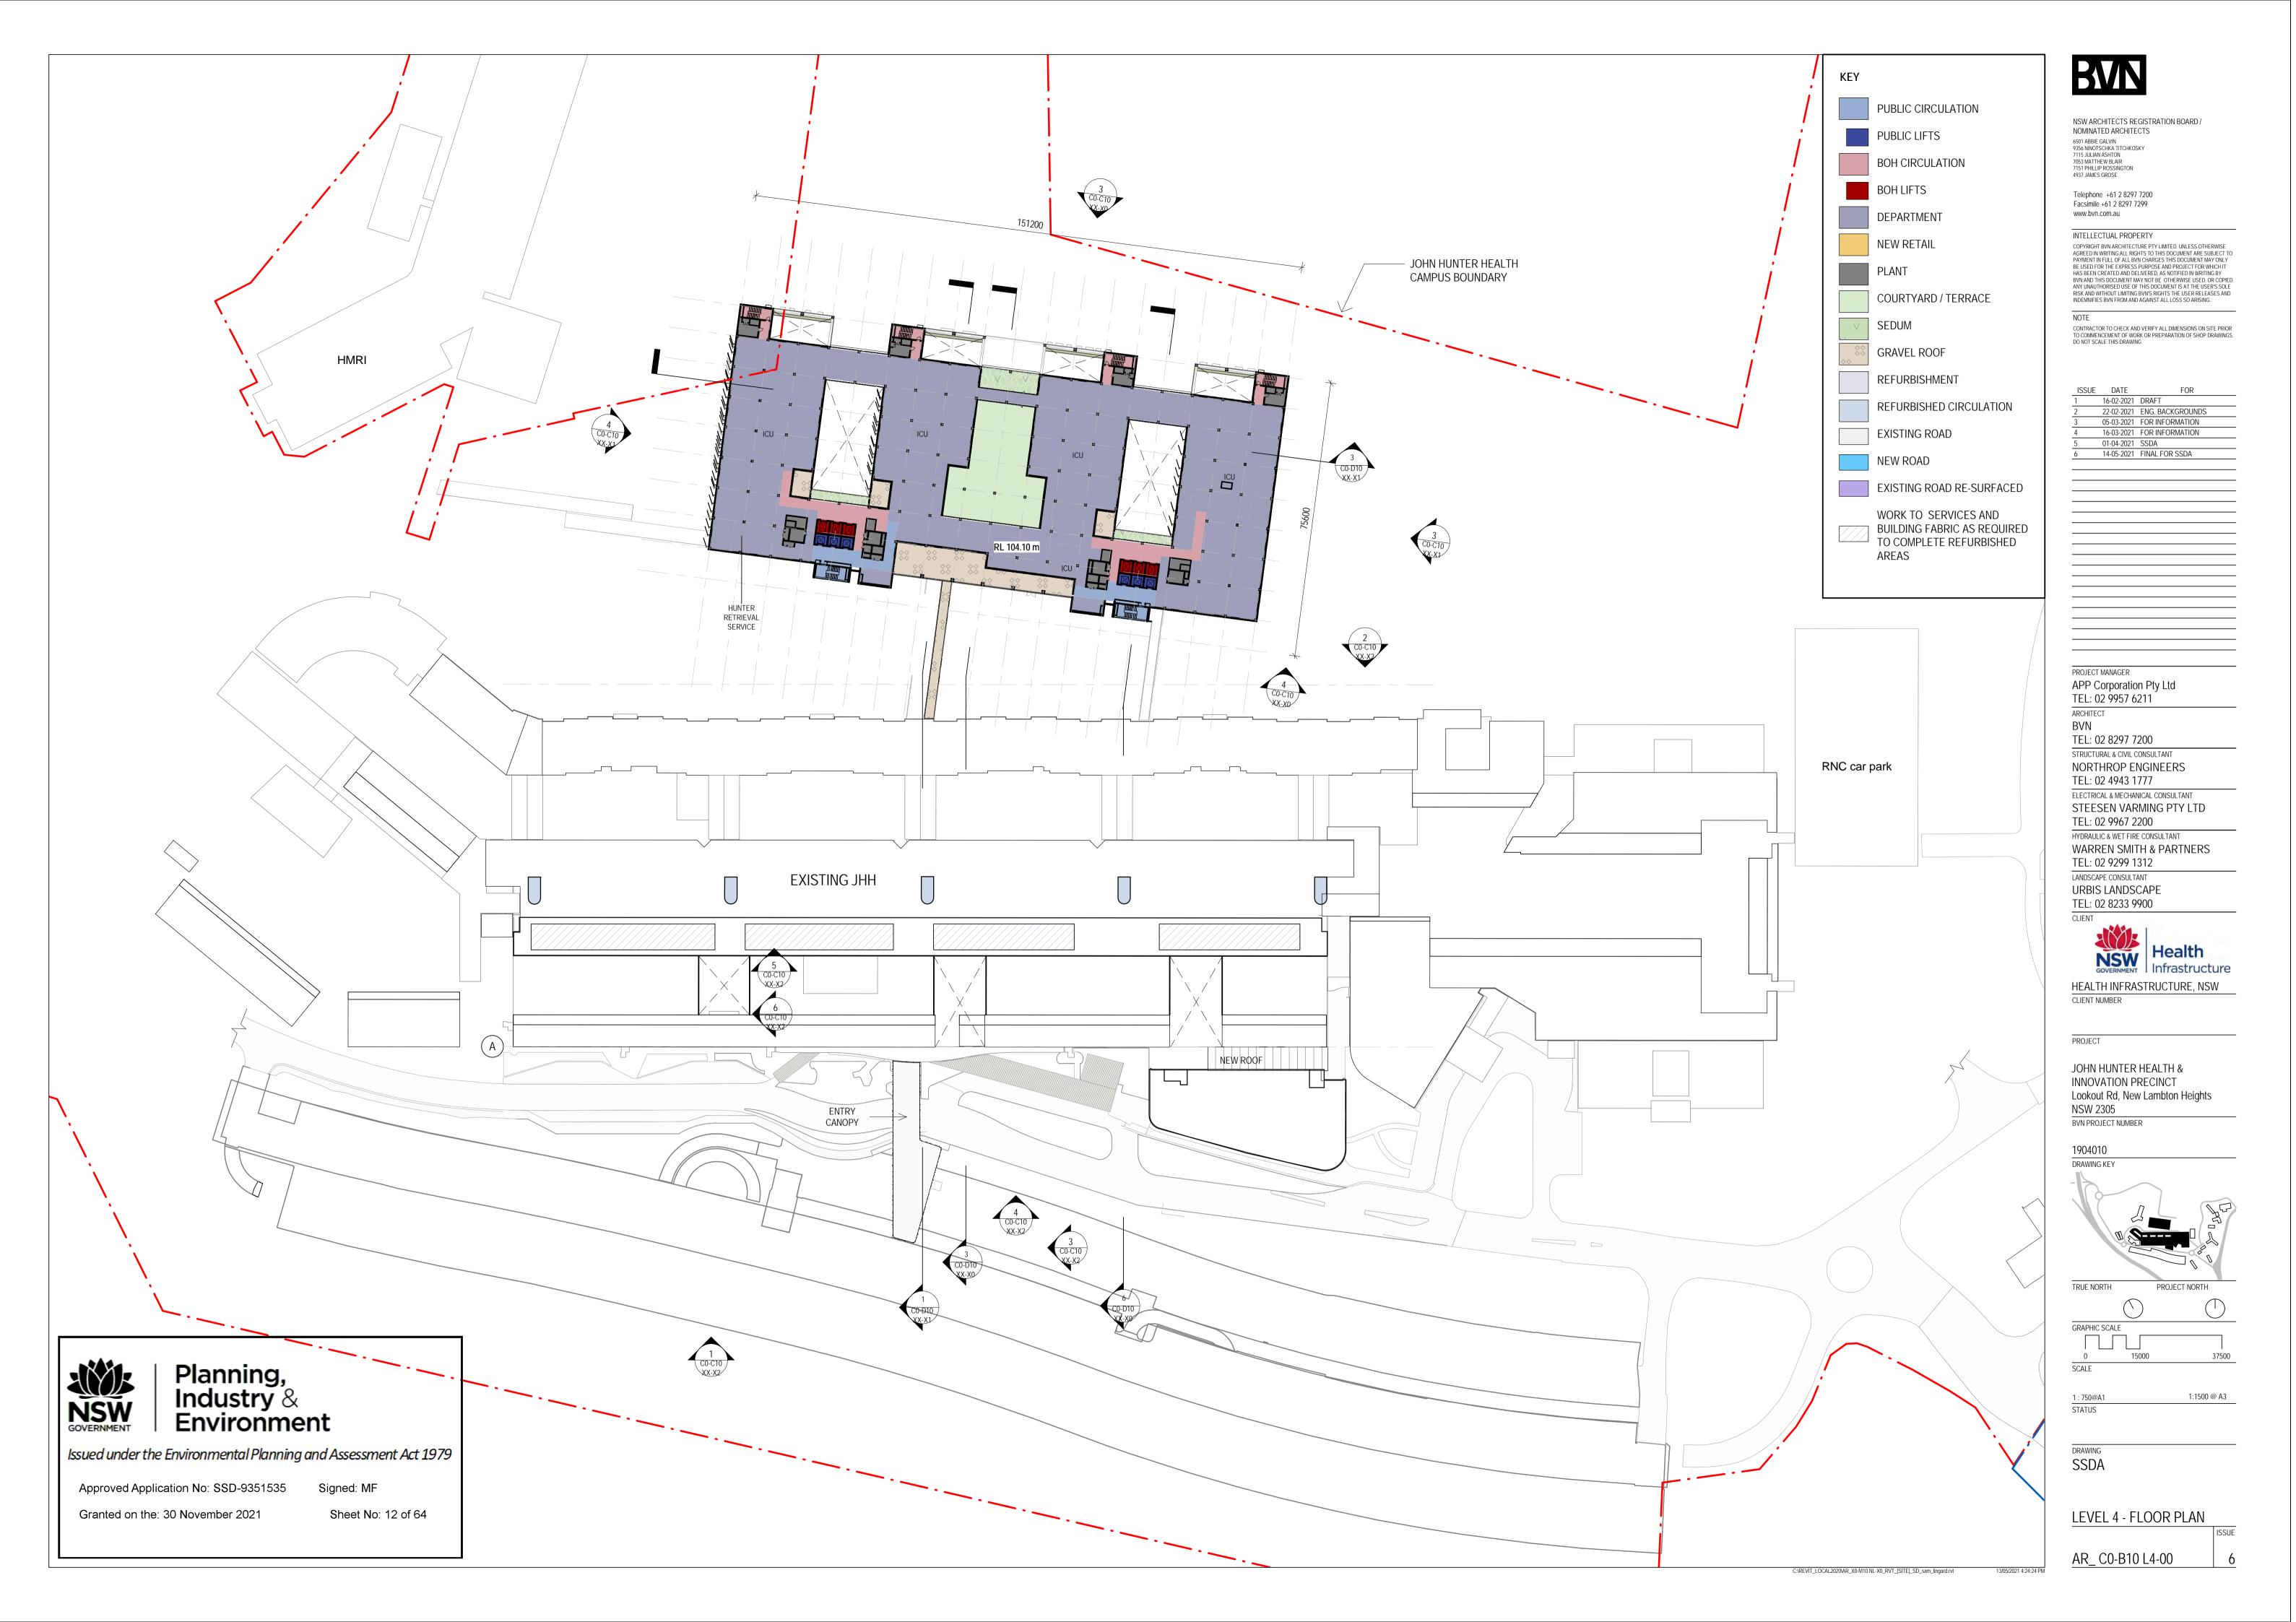

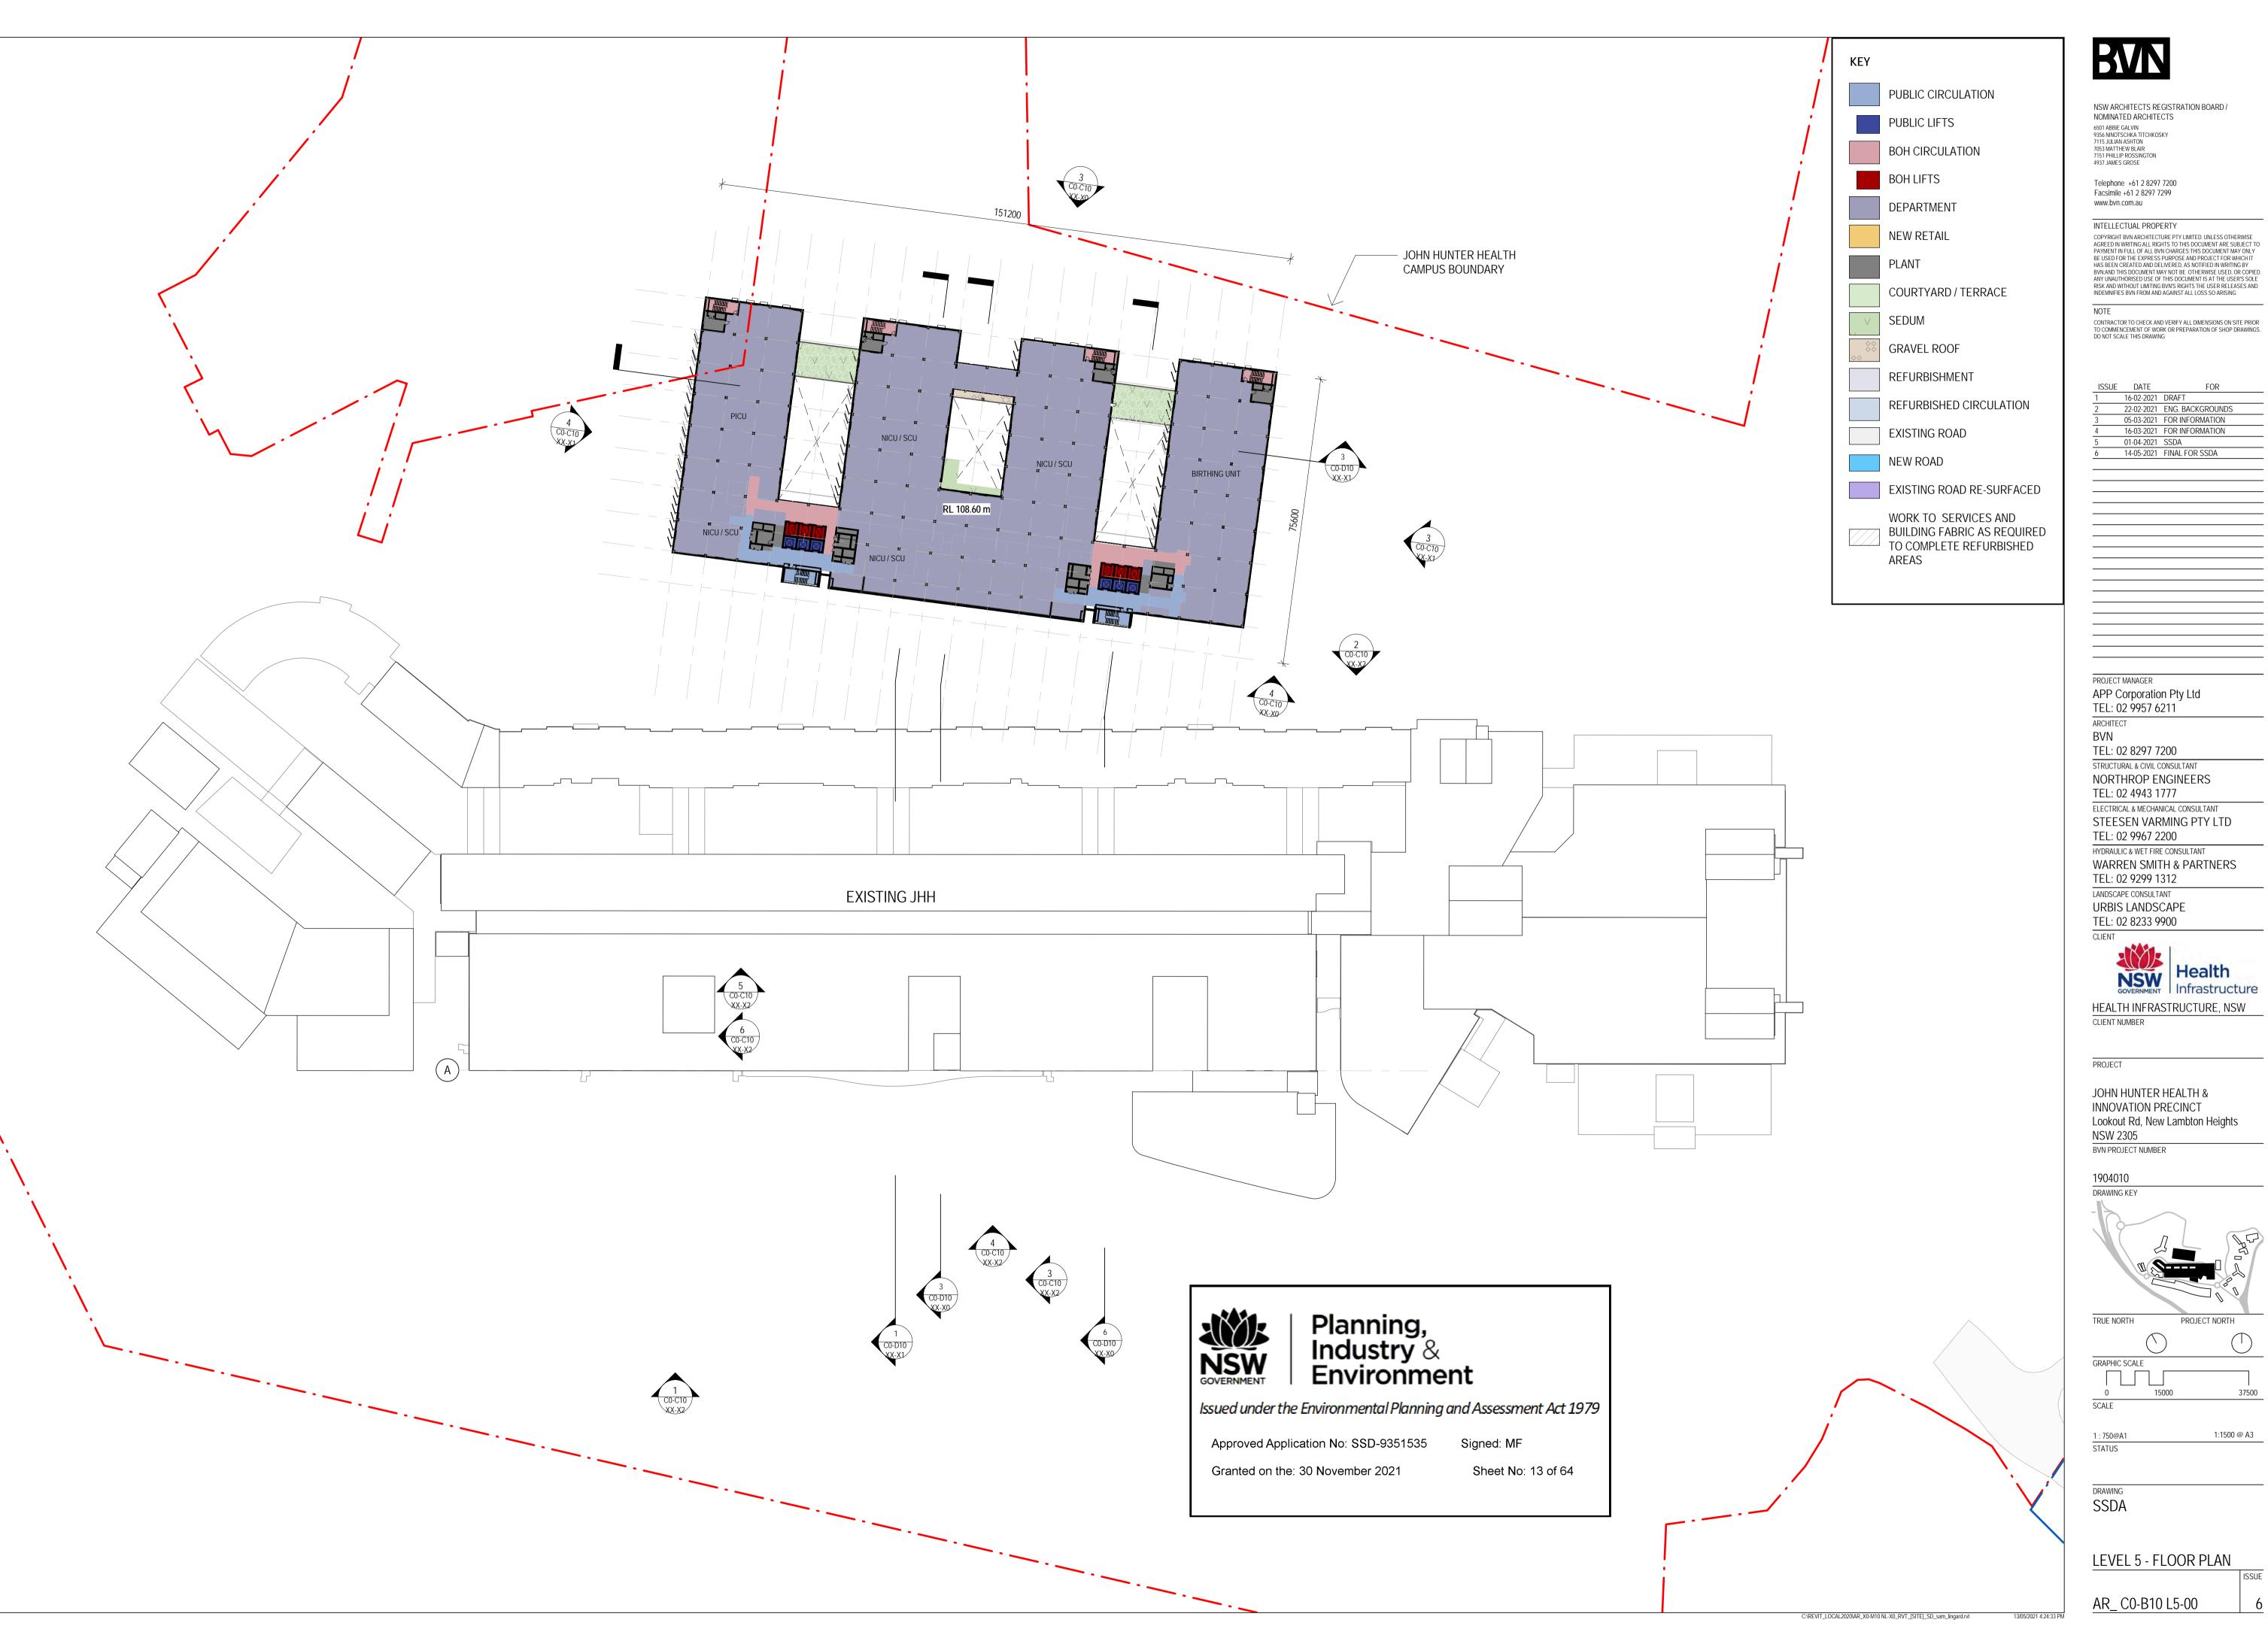

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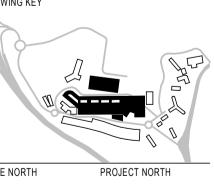
TEL: 02 9299 1312 LANDSCAPE CONSULTANT URBIS LANDSCAPE TEL: 02 8233 9900

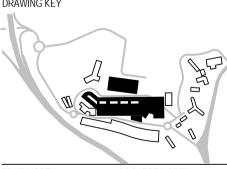

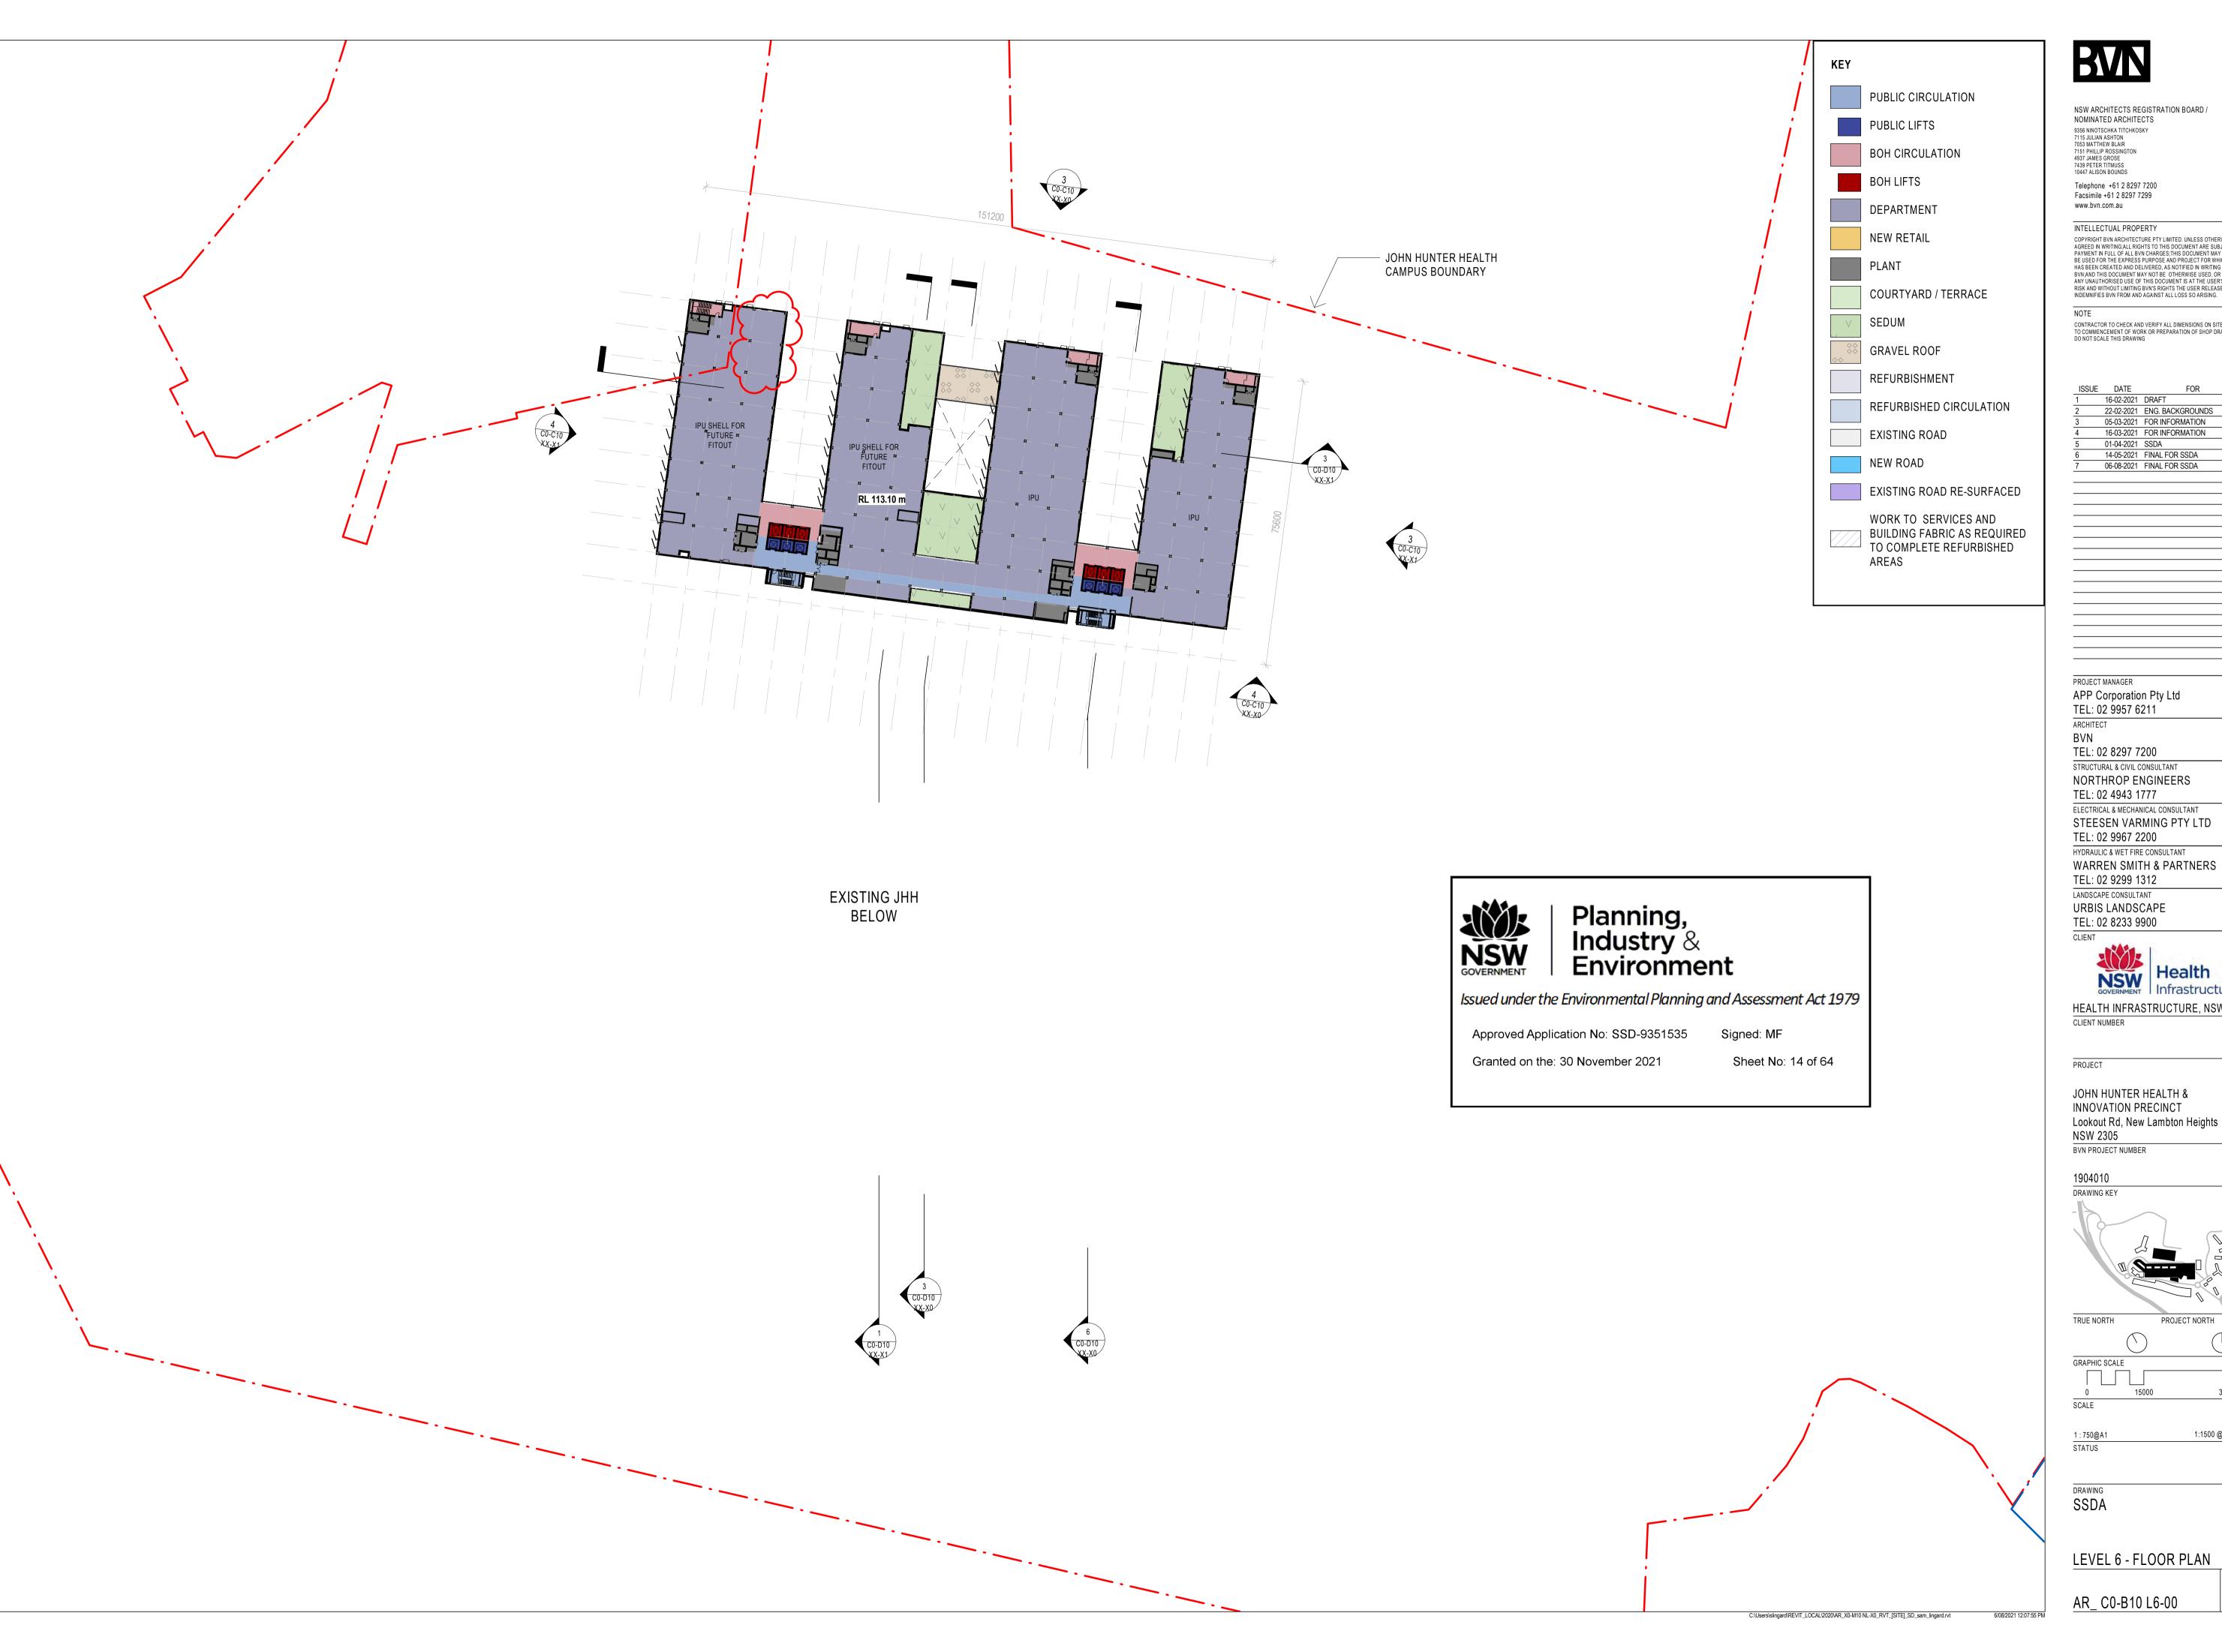HEALTH INFRASTRUCTURE, NSW

JOHN HUNTER HEALTH & INNOVATION PRECINCT Lookout Rd, New Lambton Heights NSW 2305

1904010 DRAWING KEY




TRUE NORTH GRAPHIC SCALE 37500

LEVEL 6 - FLOOR PLAN

AR_ C0-B10 L6-00

1:1500 @ A3

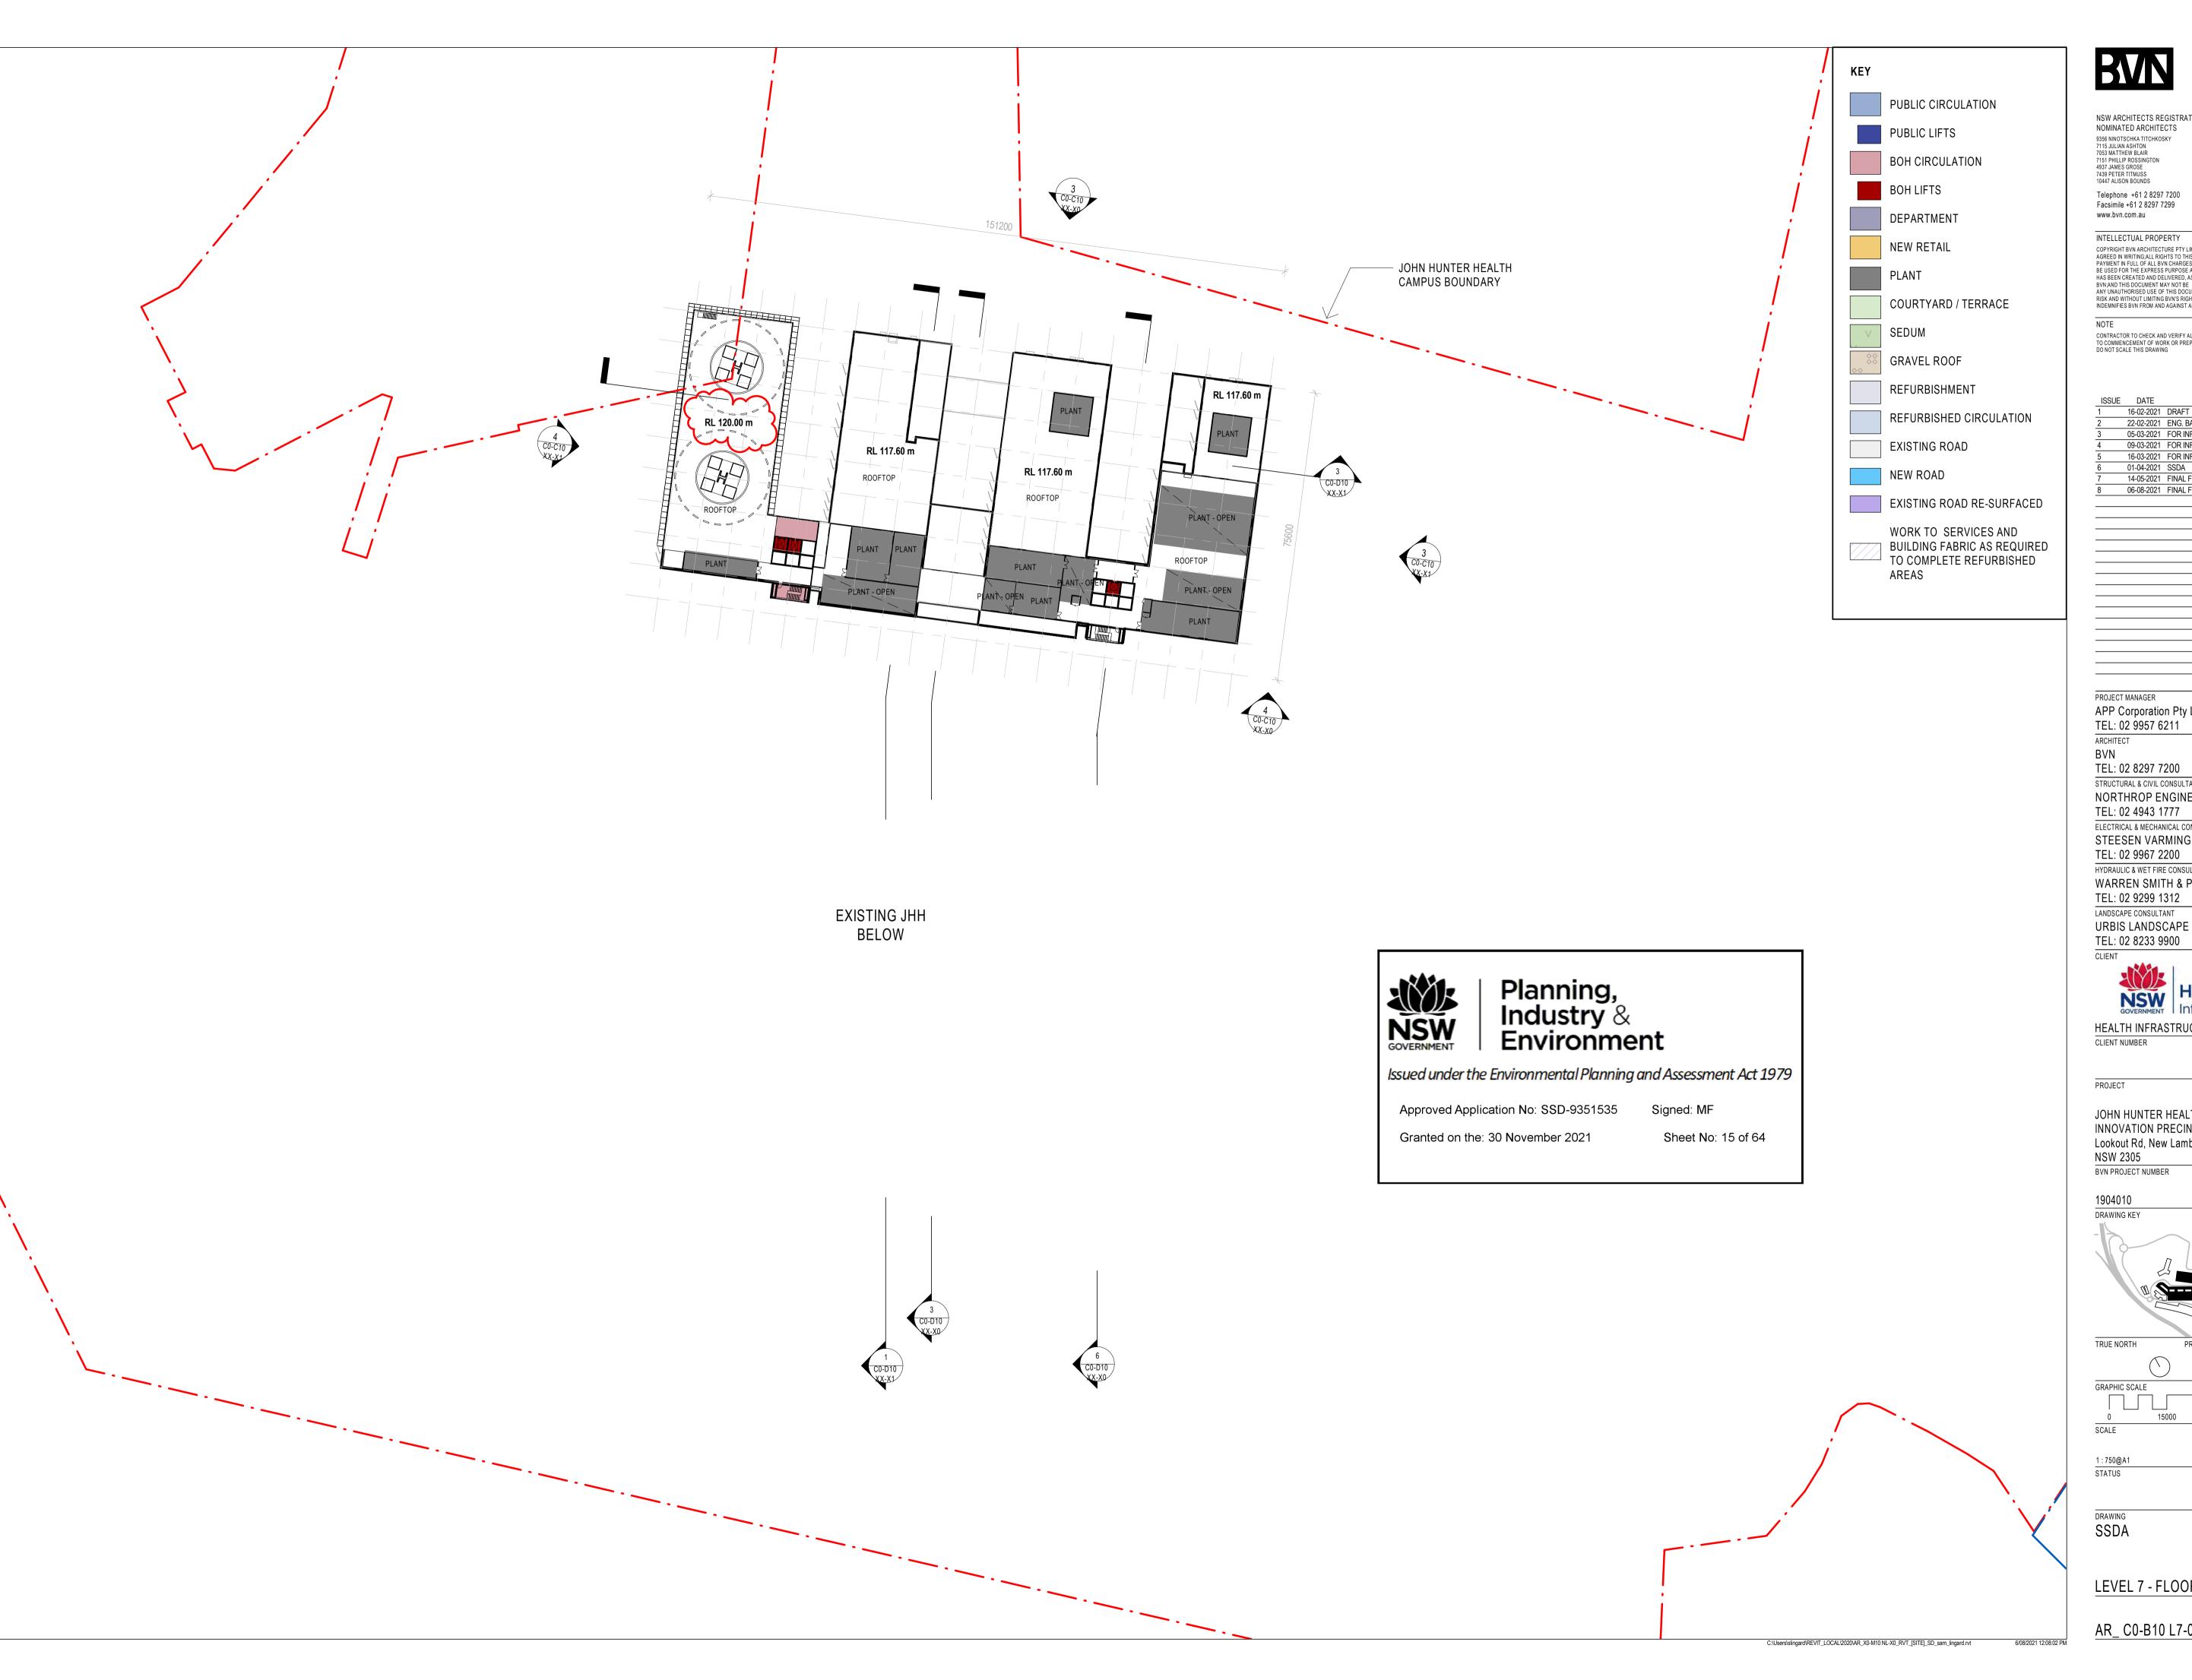

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PROJECT MANAGER APP Corporation Pty Ltd TEL: 02 9957 6211 ARCHITECT BVN TEL: 02 8297 7200


STRUCTURAL & CIVIL CONSULTANT NORTHROP ENGINEERS TEL: 02 4943 1777 ELECTRICAL & MECHANICAL CONSULTANT STEESEN VARMING PTY LTD TEL: 02 9967 2200 HYDRAULIC & WET FIRE CONSULTANT WARREN SMITH & PARTNERS TEL: 02 9299 1312



HEALTH INFRASTRUCTURE, NSW CLIENT NUMBER

JOHN HUNTER HEALTH & INNOVATION PRECINCT Lookout Rd, New Lambton Heights NSW 2305 BVN PROJECT NUMBER

1904010 DRAWING KEY

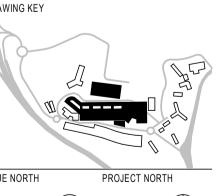

TRUE NORTH GRAPHIC SCALE 37500


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SSDA

LEVEL 7 - FLOOR PLAN

AR_ C0-B10 L7-00

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EXISTING JHH

BELOW

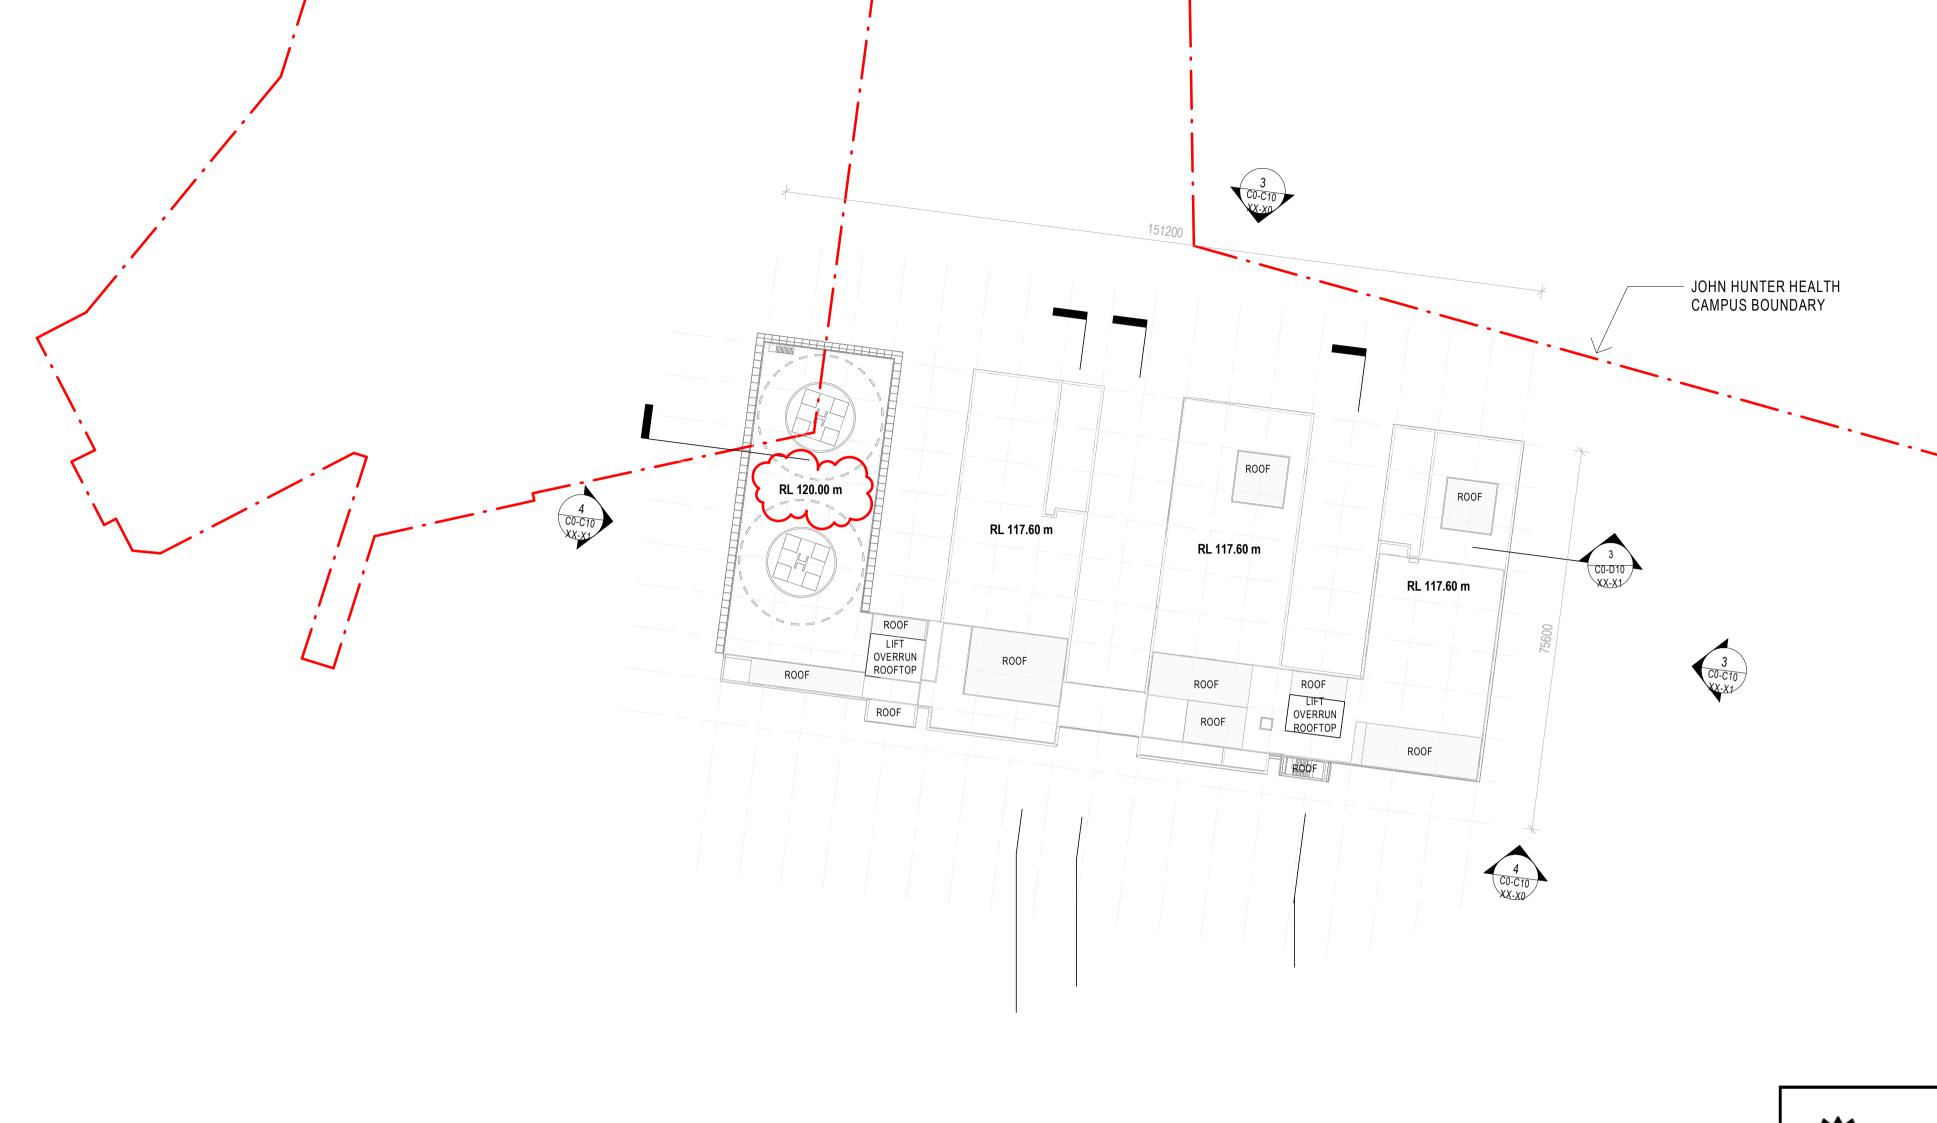Planning, Industry & Environment

Issued under the Environmental Planning and Assessment Act 1979


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Approved Application No: SSD-9351535

Granted on the: 30 November 2021

Signed: MF



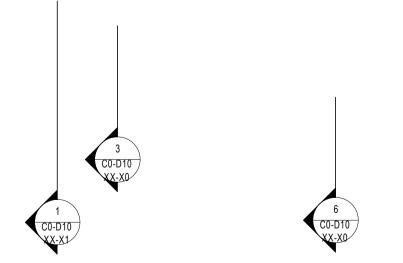

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BVN TEL: 02 8297 7200 STRUCTURAL & CIVIL CONSULTANT NORTHROP ENGINEERS

TEL: 02 4943 1777 ELECTRICAL & MECHANICAL CONSULTANT STEESEN VARMING PTY LTD TEL: 02 9967 2200 HYDRAULIC & WET FIRE CONSULTANT WARREN SMITH & PARTNERS TEL: 02 9299 1312

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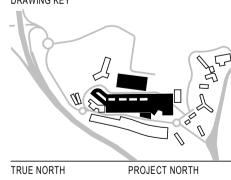


BVN PROJECT NUMBER

CLIENT NUMBER

JOHN HUNTER HEALTH & INNOVATION PRECINCT Lookout Rd, New Lambton Heights NSW 2305

1904010 DRAWING KEY



GRAPHIC SCALE 37500

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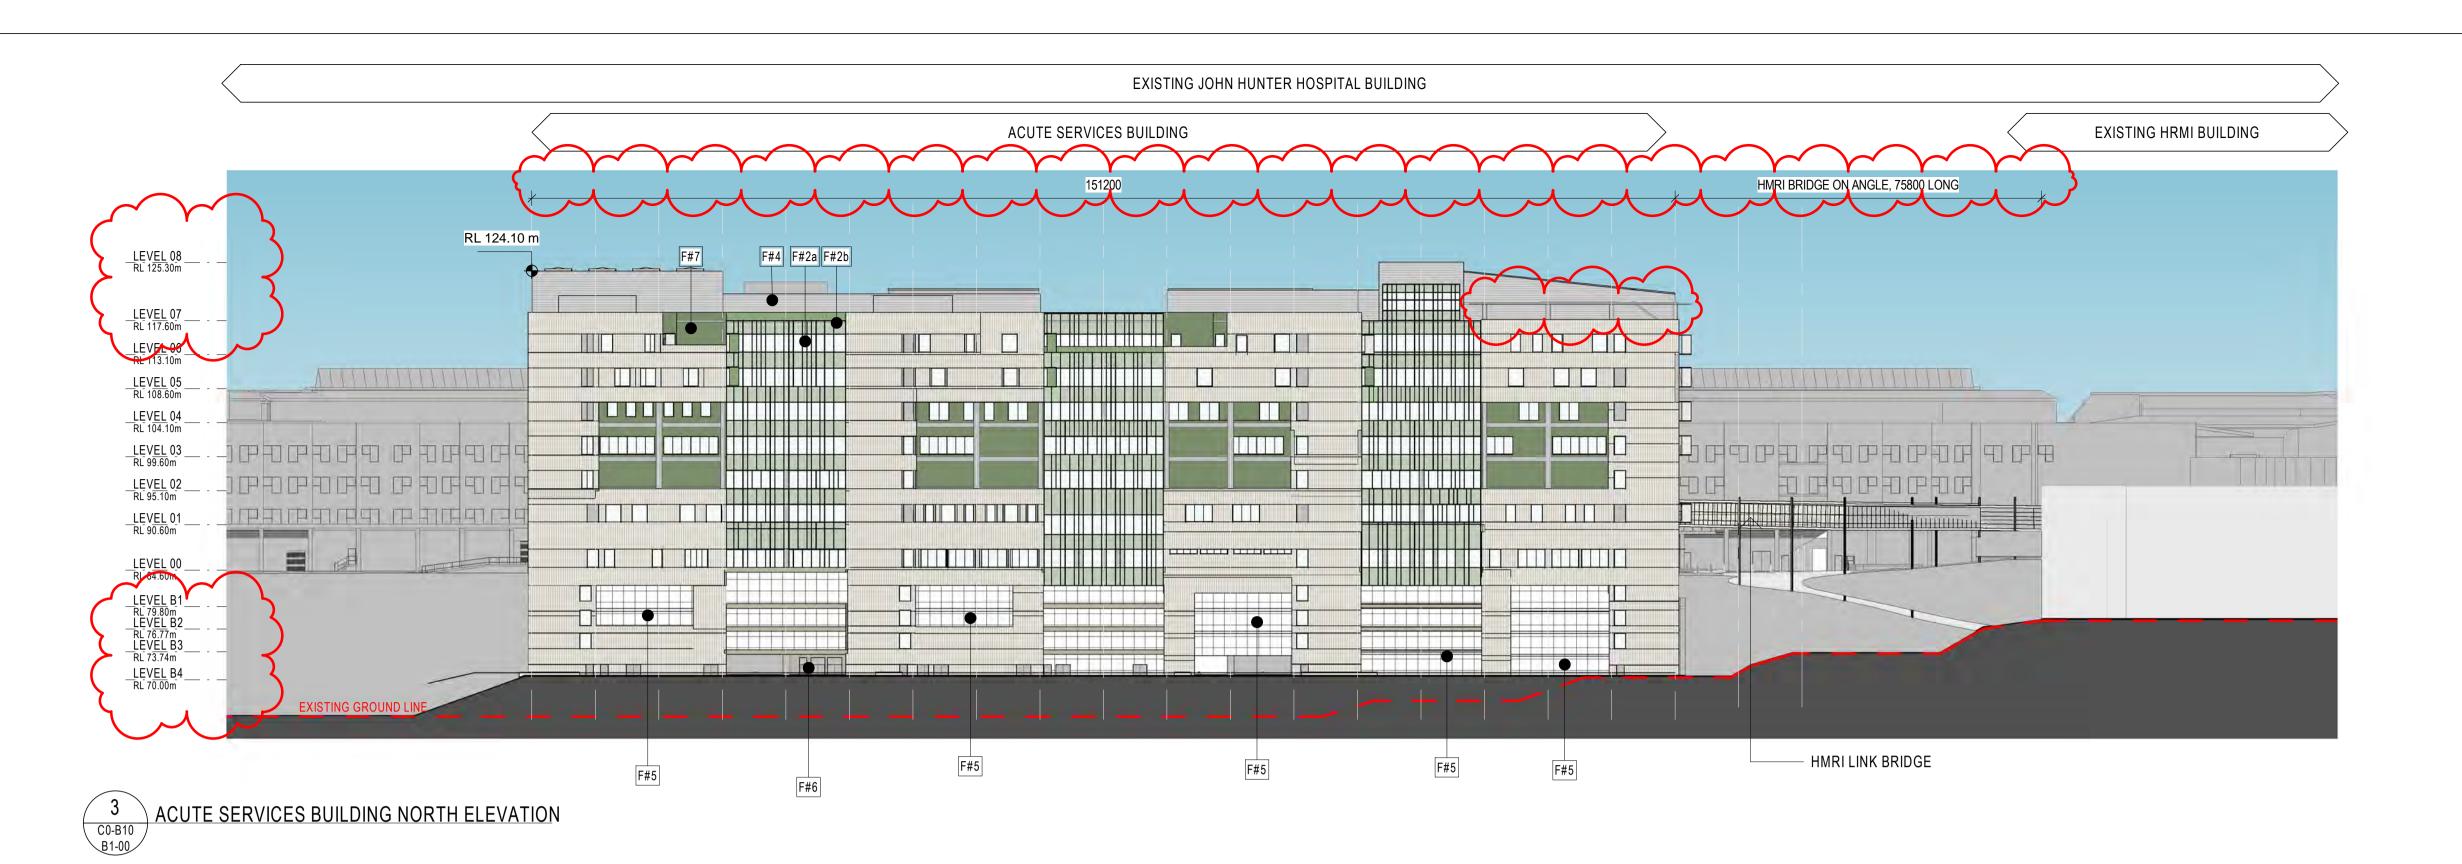
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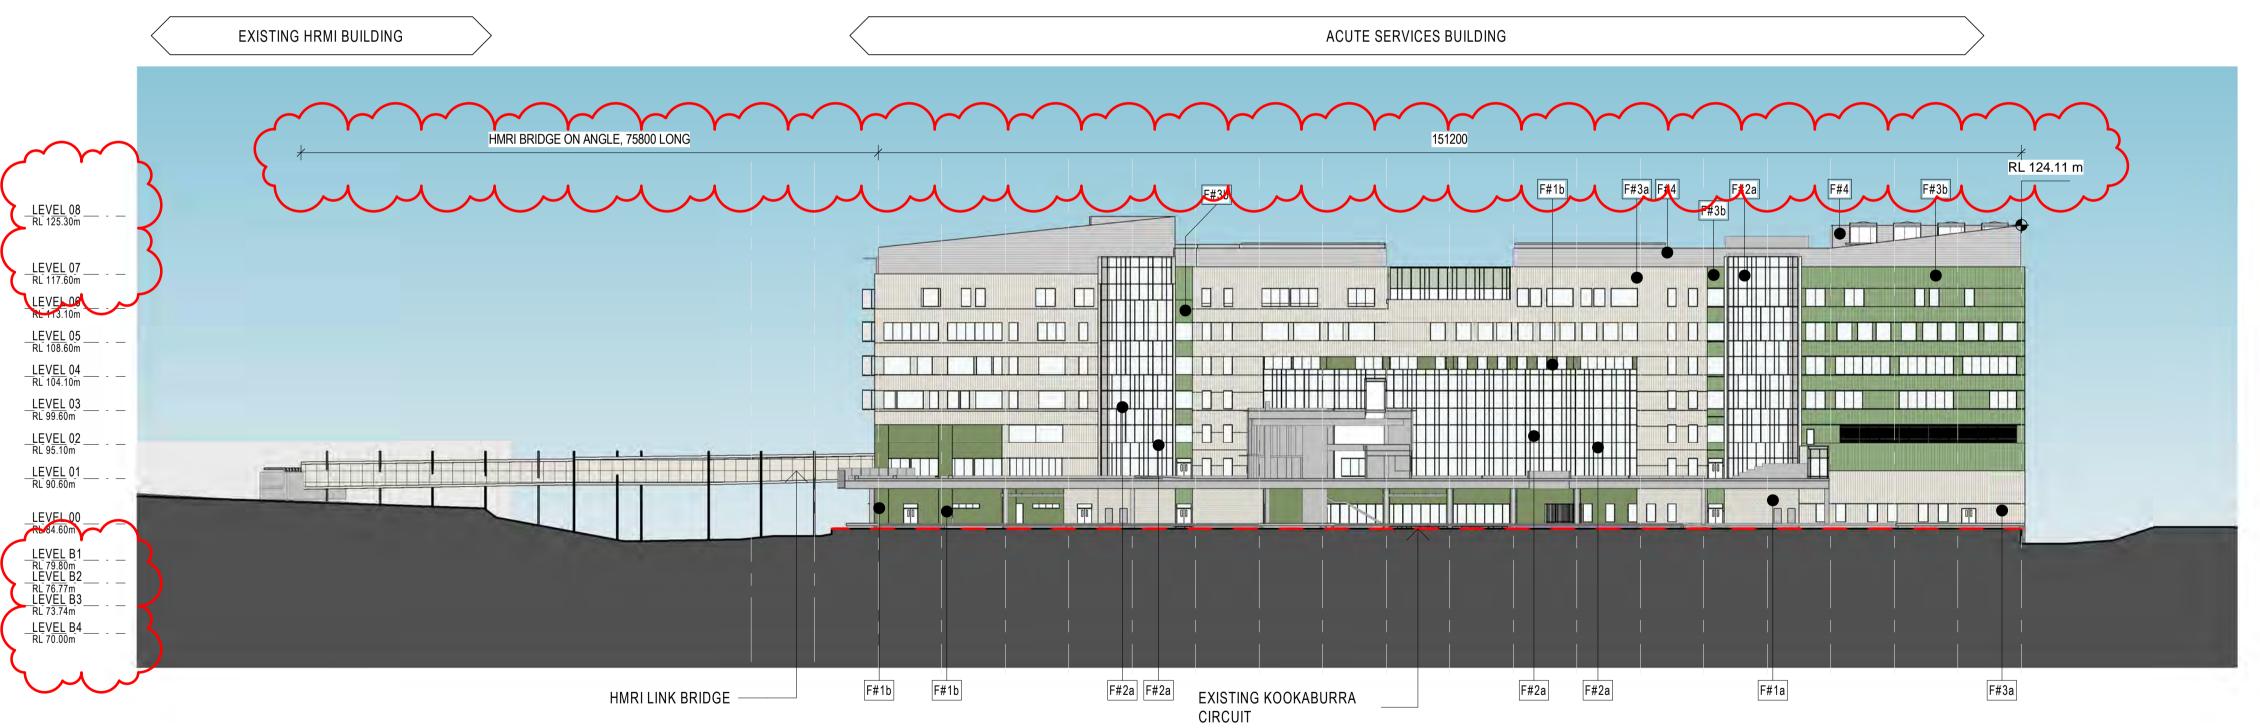
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SSDA

ROOF PLAN

AR_ C0-B10 L8-00









CODE	DESCRIPTION
B#2	Glazed Balustrade
F#1a	Integral pigment render
F#1b	Feature Finish
F#2a	High performance glazing - low-e coated clear vision glass - expressed mullions - aluminium
F#2b	Aluminium spandrels - expressed mullions
F#3a	Metal A Standing Seam cladding - module to suit building grid
F#3b	Metal B Flat panel cladding - expressed joints - module to suit building grid
F#4	Metal D -Standing Seam cladding
F#5	Carpark Façade A -flexible SS bridge safety mesh for ventilation

CODE

Carpark Façade B - Precast concrete

mineralised paint system - Expressed joints

F#10 Intergral colour insitu concrete

- class 2 off form concrete

F#7 CFC Cladding

F#11 Insitu Concrete

-Stained Finish

DESCRIPTION

- Panelised system cfc system with stained

F#9 Folded perforated aluminium panels of varies width

- integral pigment for full depth of colour

	BV	
l		

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LANDSCAPE CONSULTANT

URBIS LANDSCAPE

TEL: 02 8233 9900

Infrastructure HEALTH INFRASTRUCTURE, NSW

PROJECT

CLIENT NUMBER

JOHN HUNTER HEALTH & INNOVATION PRECINCT Lookout Rd, New Lambton Heights NSW 2305 BVN PROJECT NUMBER

1904010 DRAWING KEY


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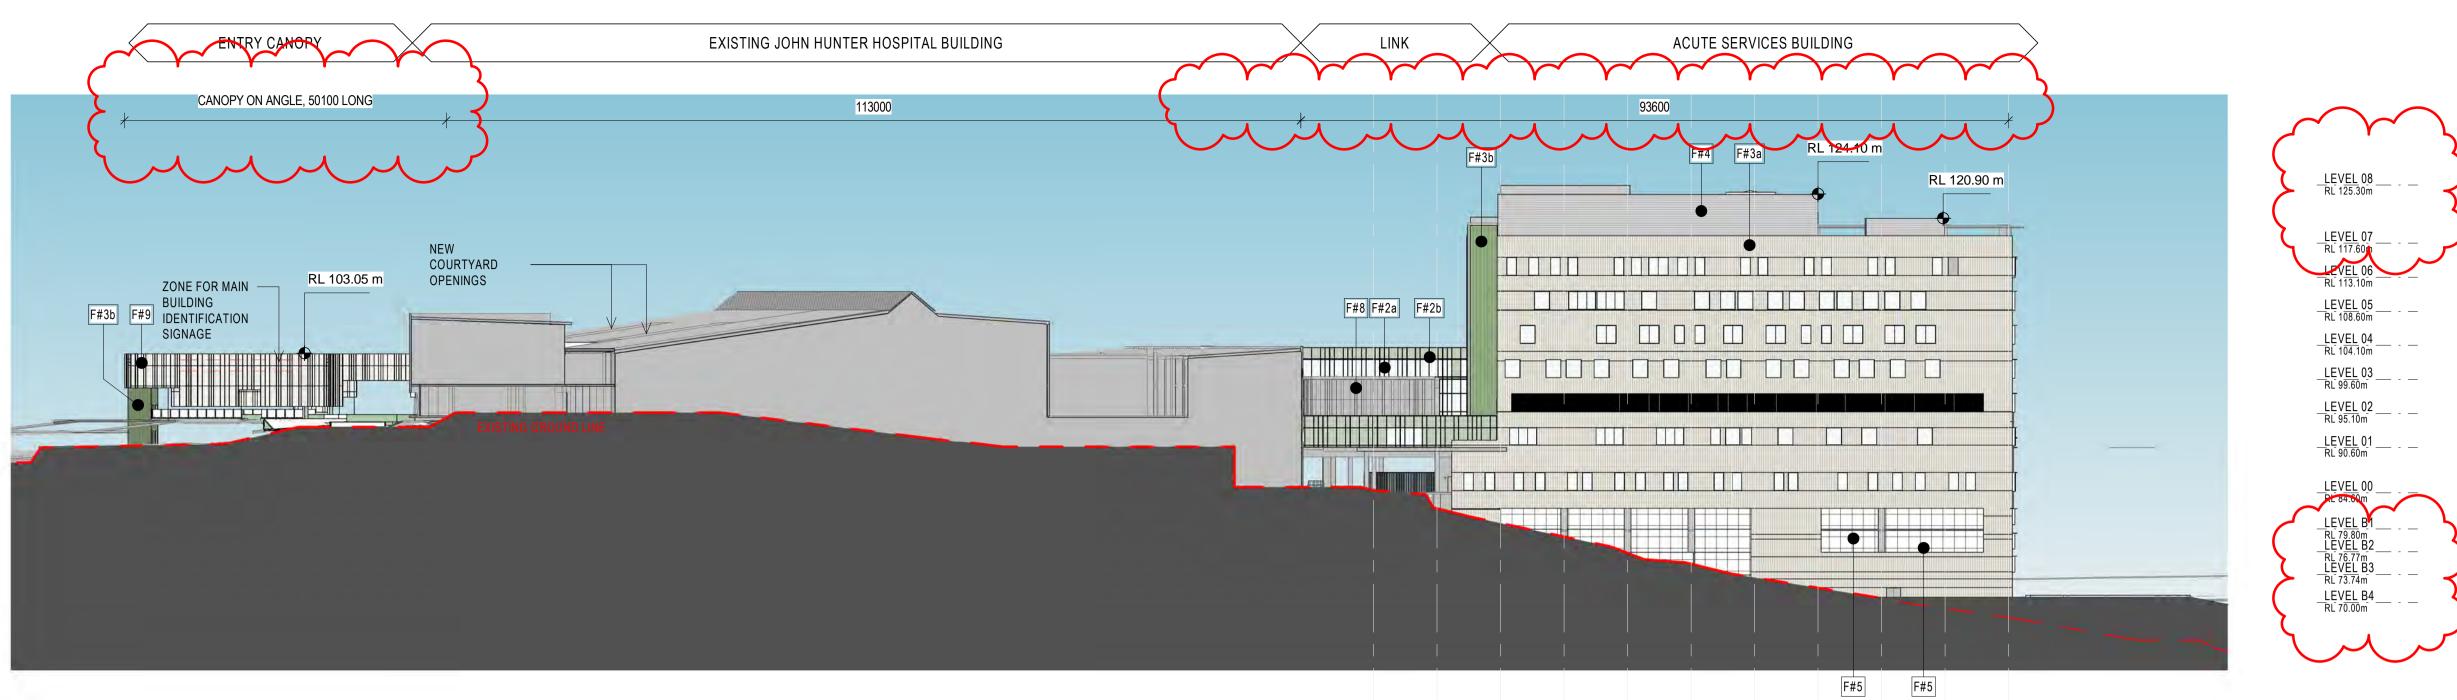
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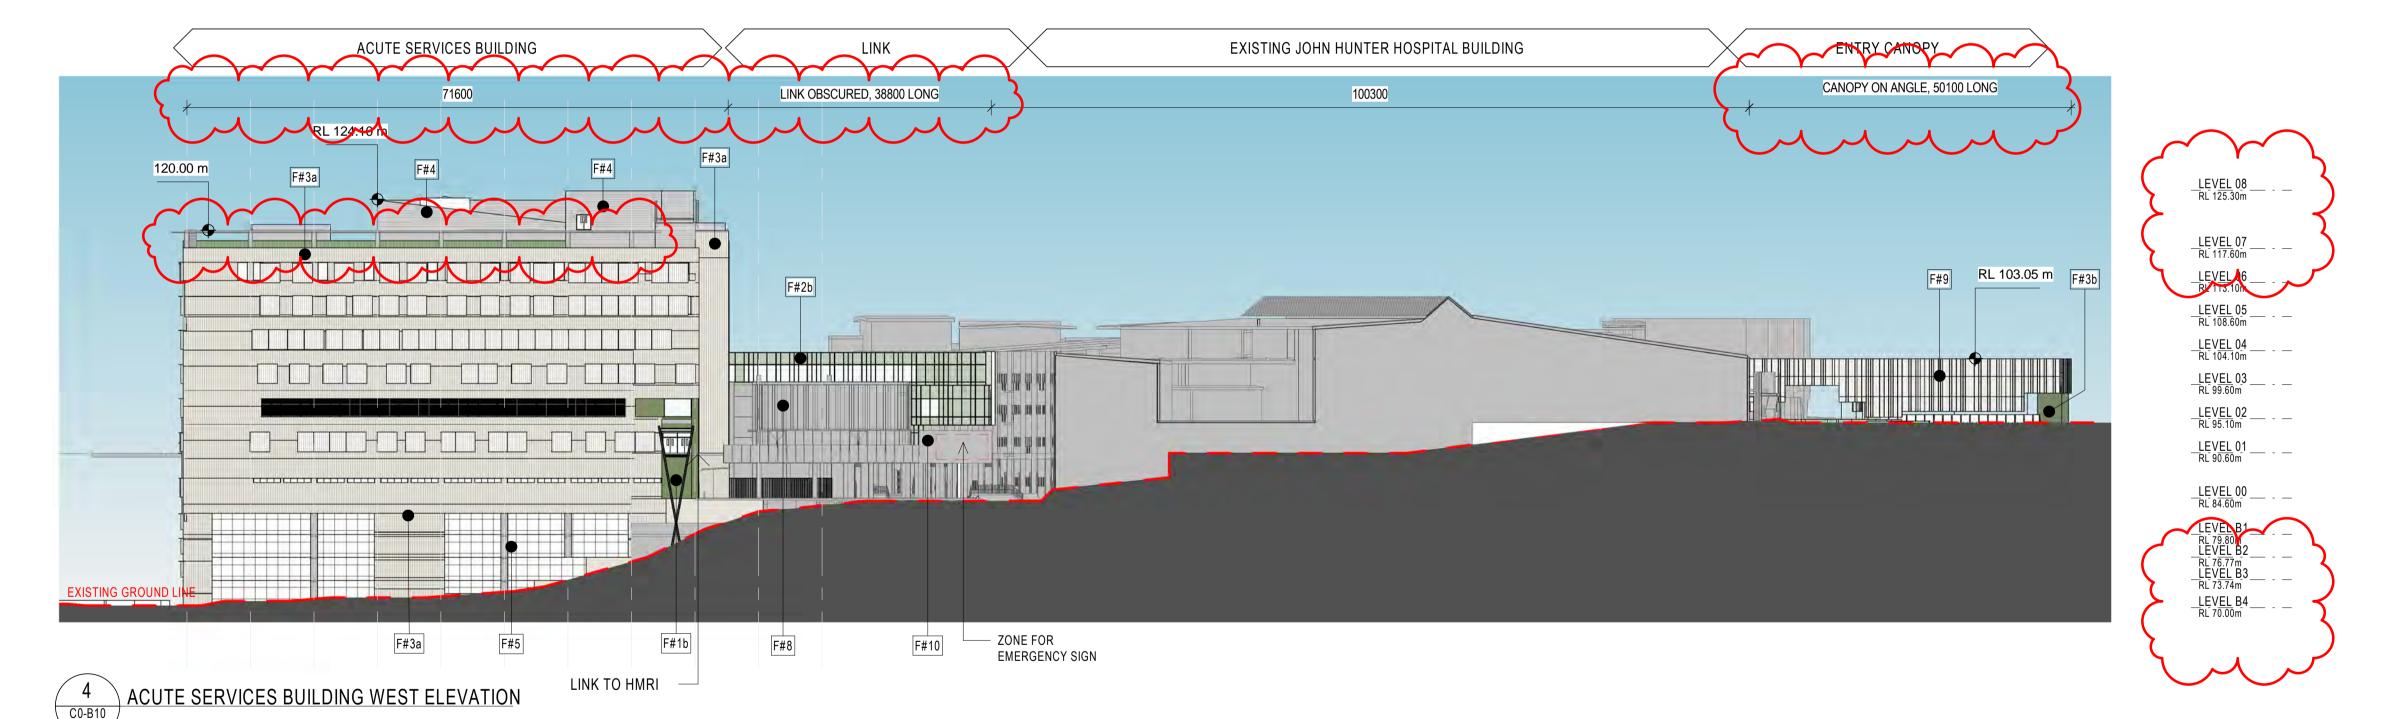
ELEVATIONS ACUTE SERVICES BUILDING


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	CODE	DESCRIPTION	
	B#2	Glazed Balustrade	
	F#1a	Integral pigment render	
	F#1b	Feature Finish	
	F#2a	High performance glazing - low-e coated clear vision glass - expressed mullions - aluminium	
	F#2b	Aluminium spandrels - expressed mullions	
	F#3a	Metal A Standing Seam cladding - module to suit building grid	
	F#3b	Metal B Flat panel cladding - expressed joints - module to suit building grid	
Ī	F#4	Metal D -Standing Seam cladding	
	F#5	Carpark Façade A -flexible SS bridge safety mesh for ventilation	

CODE

F#6 Carpark Façade B

F#7 CFC Cladding

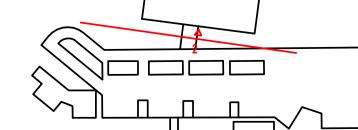F#11 Insitu Concrete

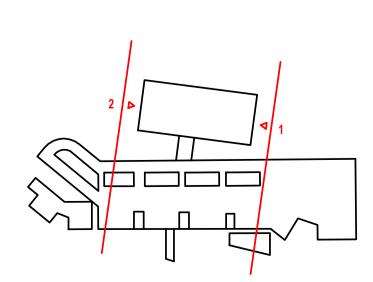-Stained Finish

- Precast concrete

mineralised paint system Expressed joints

Intergral colour insitu concrete - class 2 off form concrete

DESCRIPTION

Folded perforated aluminium panels of varies width

- Panelised system cfc system with stained

- integral pigment for full depth of colour

B A	V	

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HEALTH INFRASTRUCTURE, NSW CLIENT NUMBER

PROJECT

JOHN HUNTER HEALTH & INNOVATION PRECINCT Lookout Rd, New Lambton Heights NSW 2305 BVN PROJECT NUMBER

1904010 DRAWING KEY

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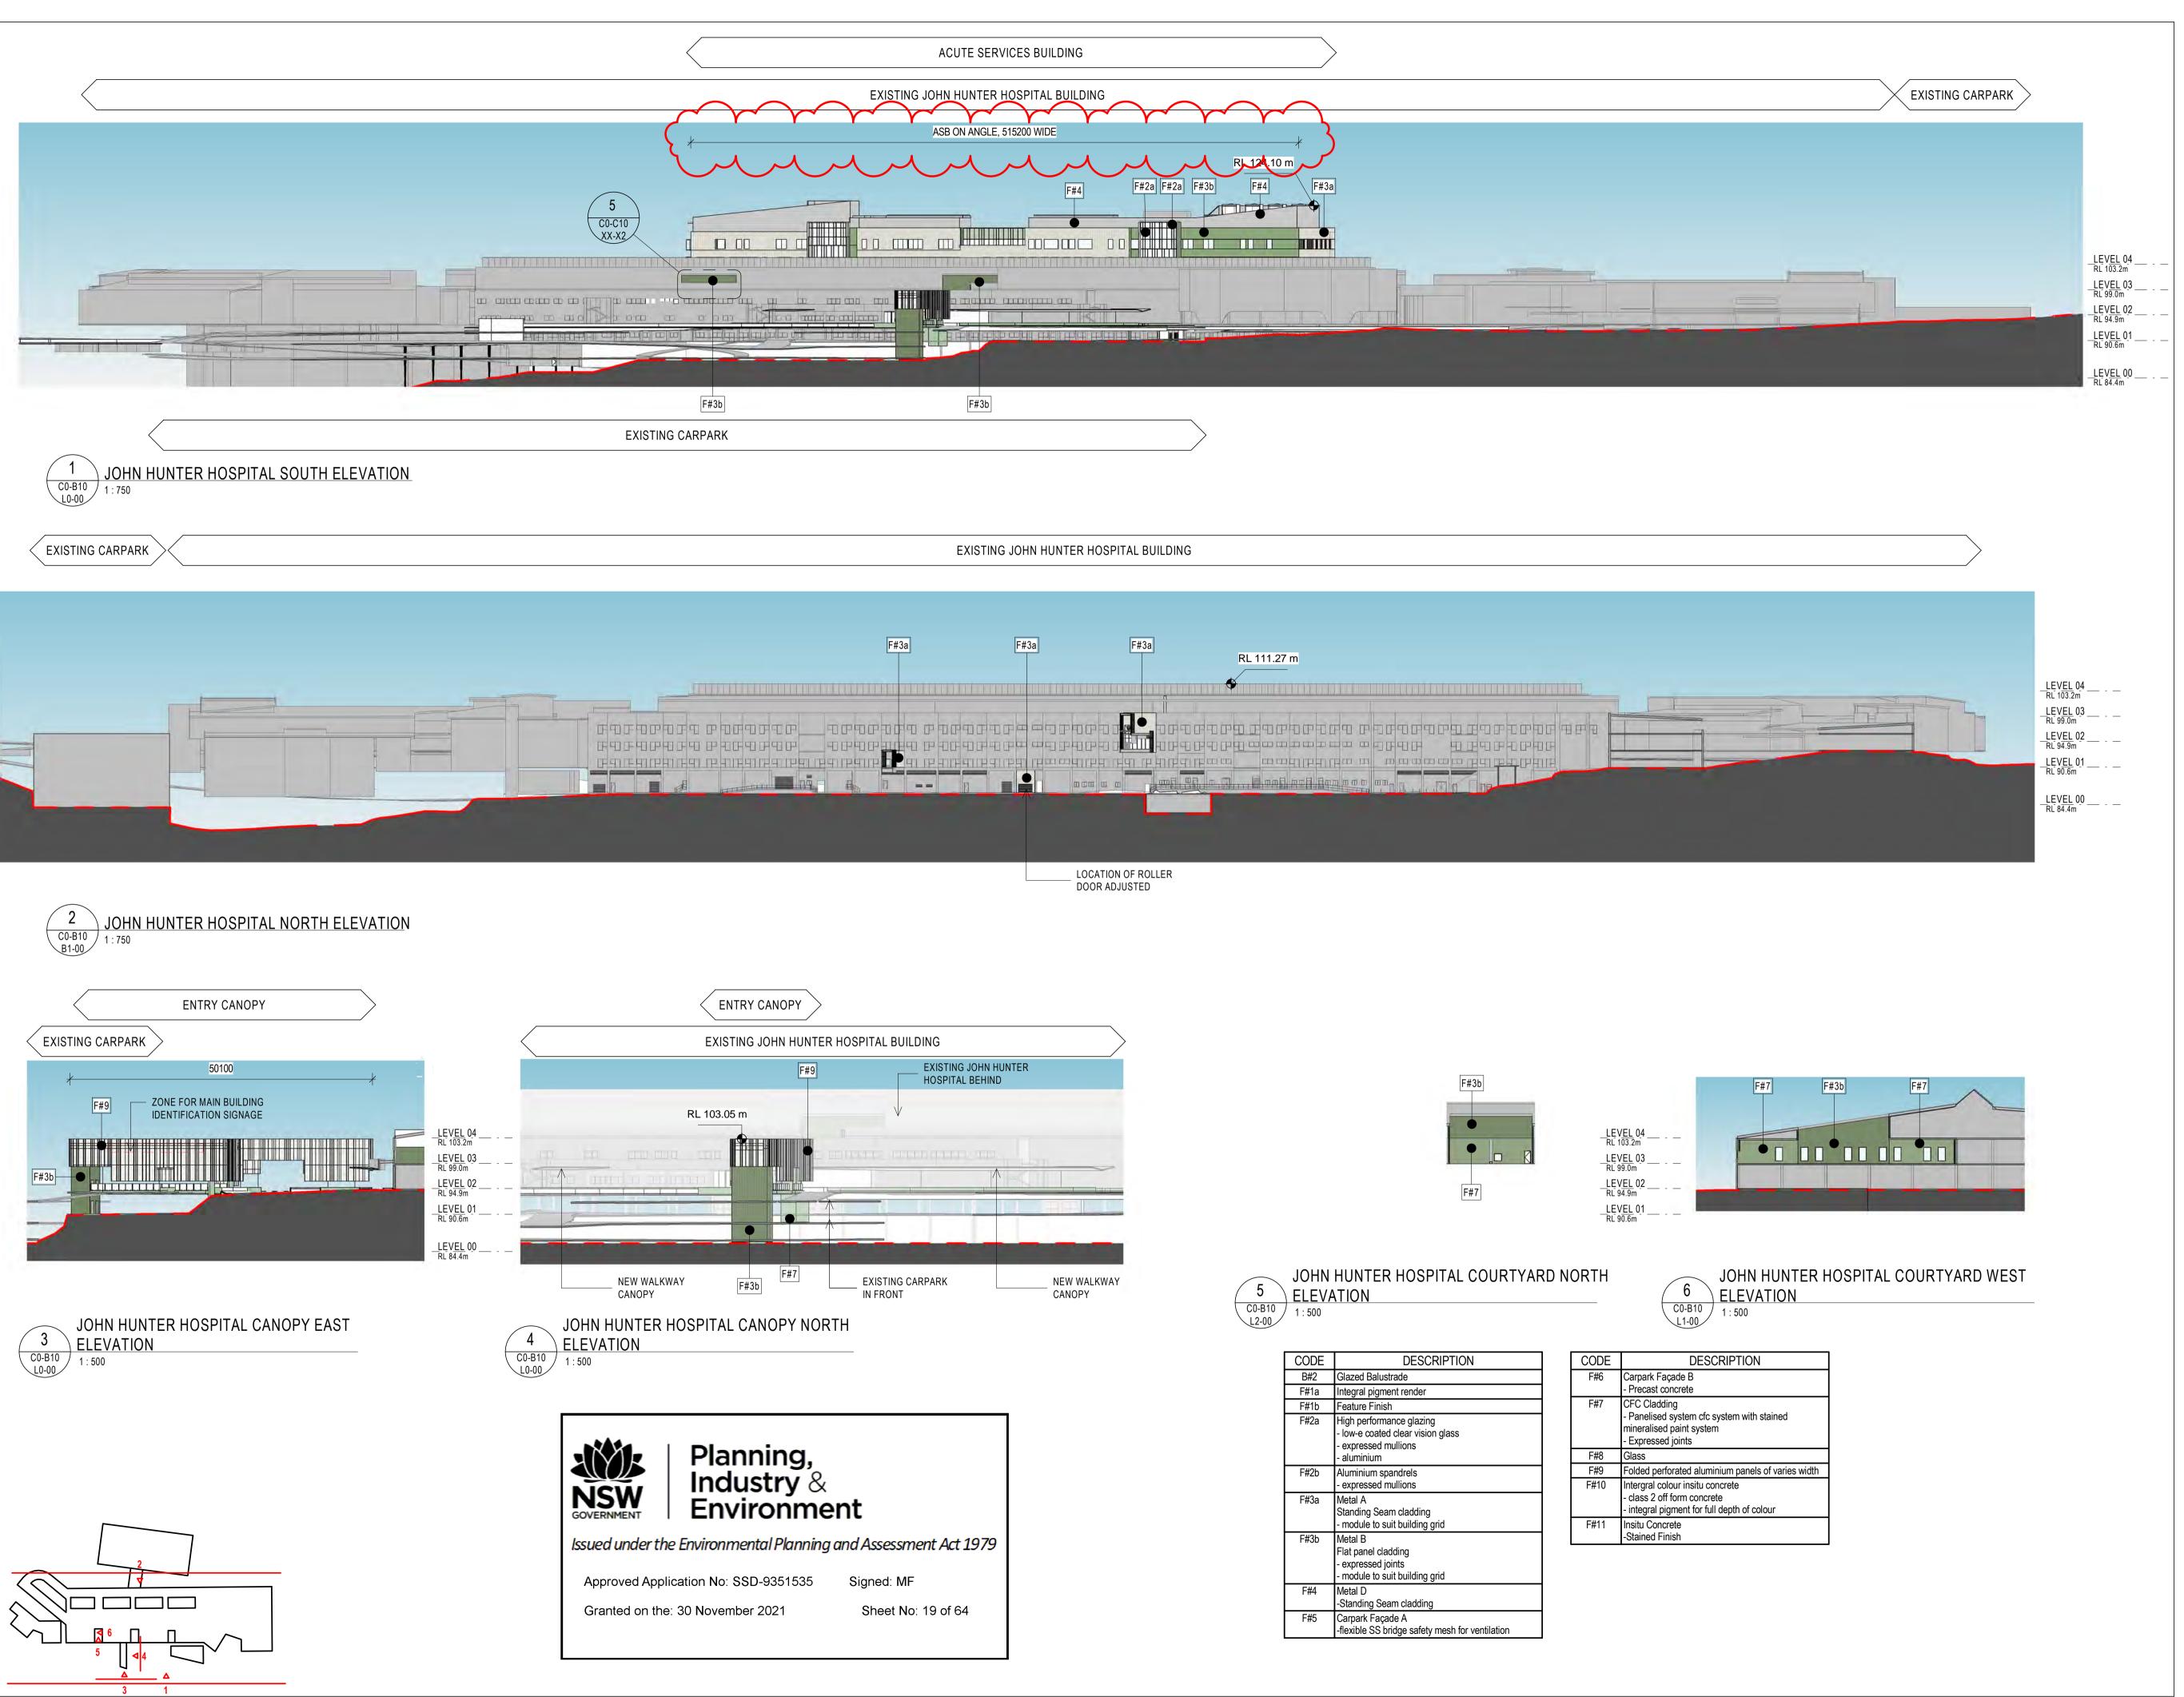
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ELEVATIONS ACUTE SERVICES BUILDING

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WARREN SMITH & PARTNERS TEL: 02 9299 1312 LANDSCAPE CONSULTANT URBIS LANDSCAPE TEL: 02 8233 9900

CLIENT NSW Infrastructure

HEALTH INFRASTRUCTURE, NSW CLIENT NUMBER

PROJECT

JOHN HUNTER HEALTH & INNOVATION PRECINCT Lookout Rd, New Lambton Heights NSW 2305

1904010

BVN PROJECT NUMBER

DRAWING KEY

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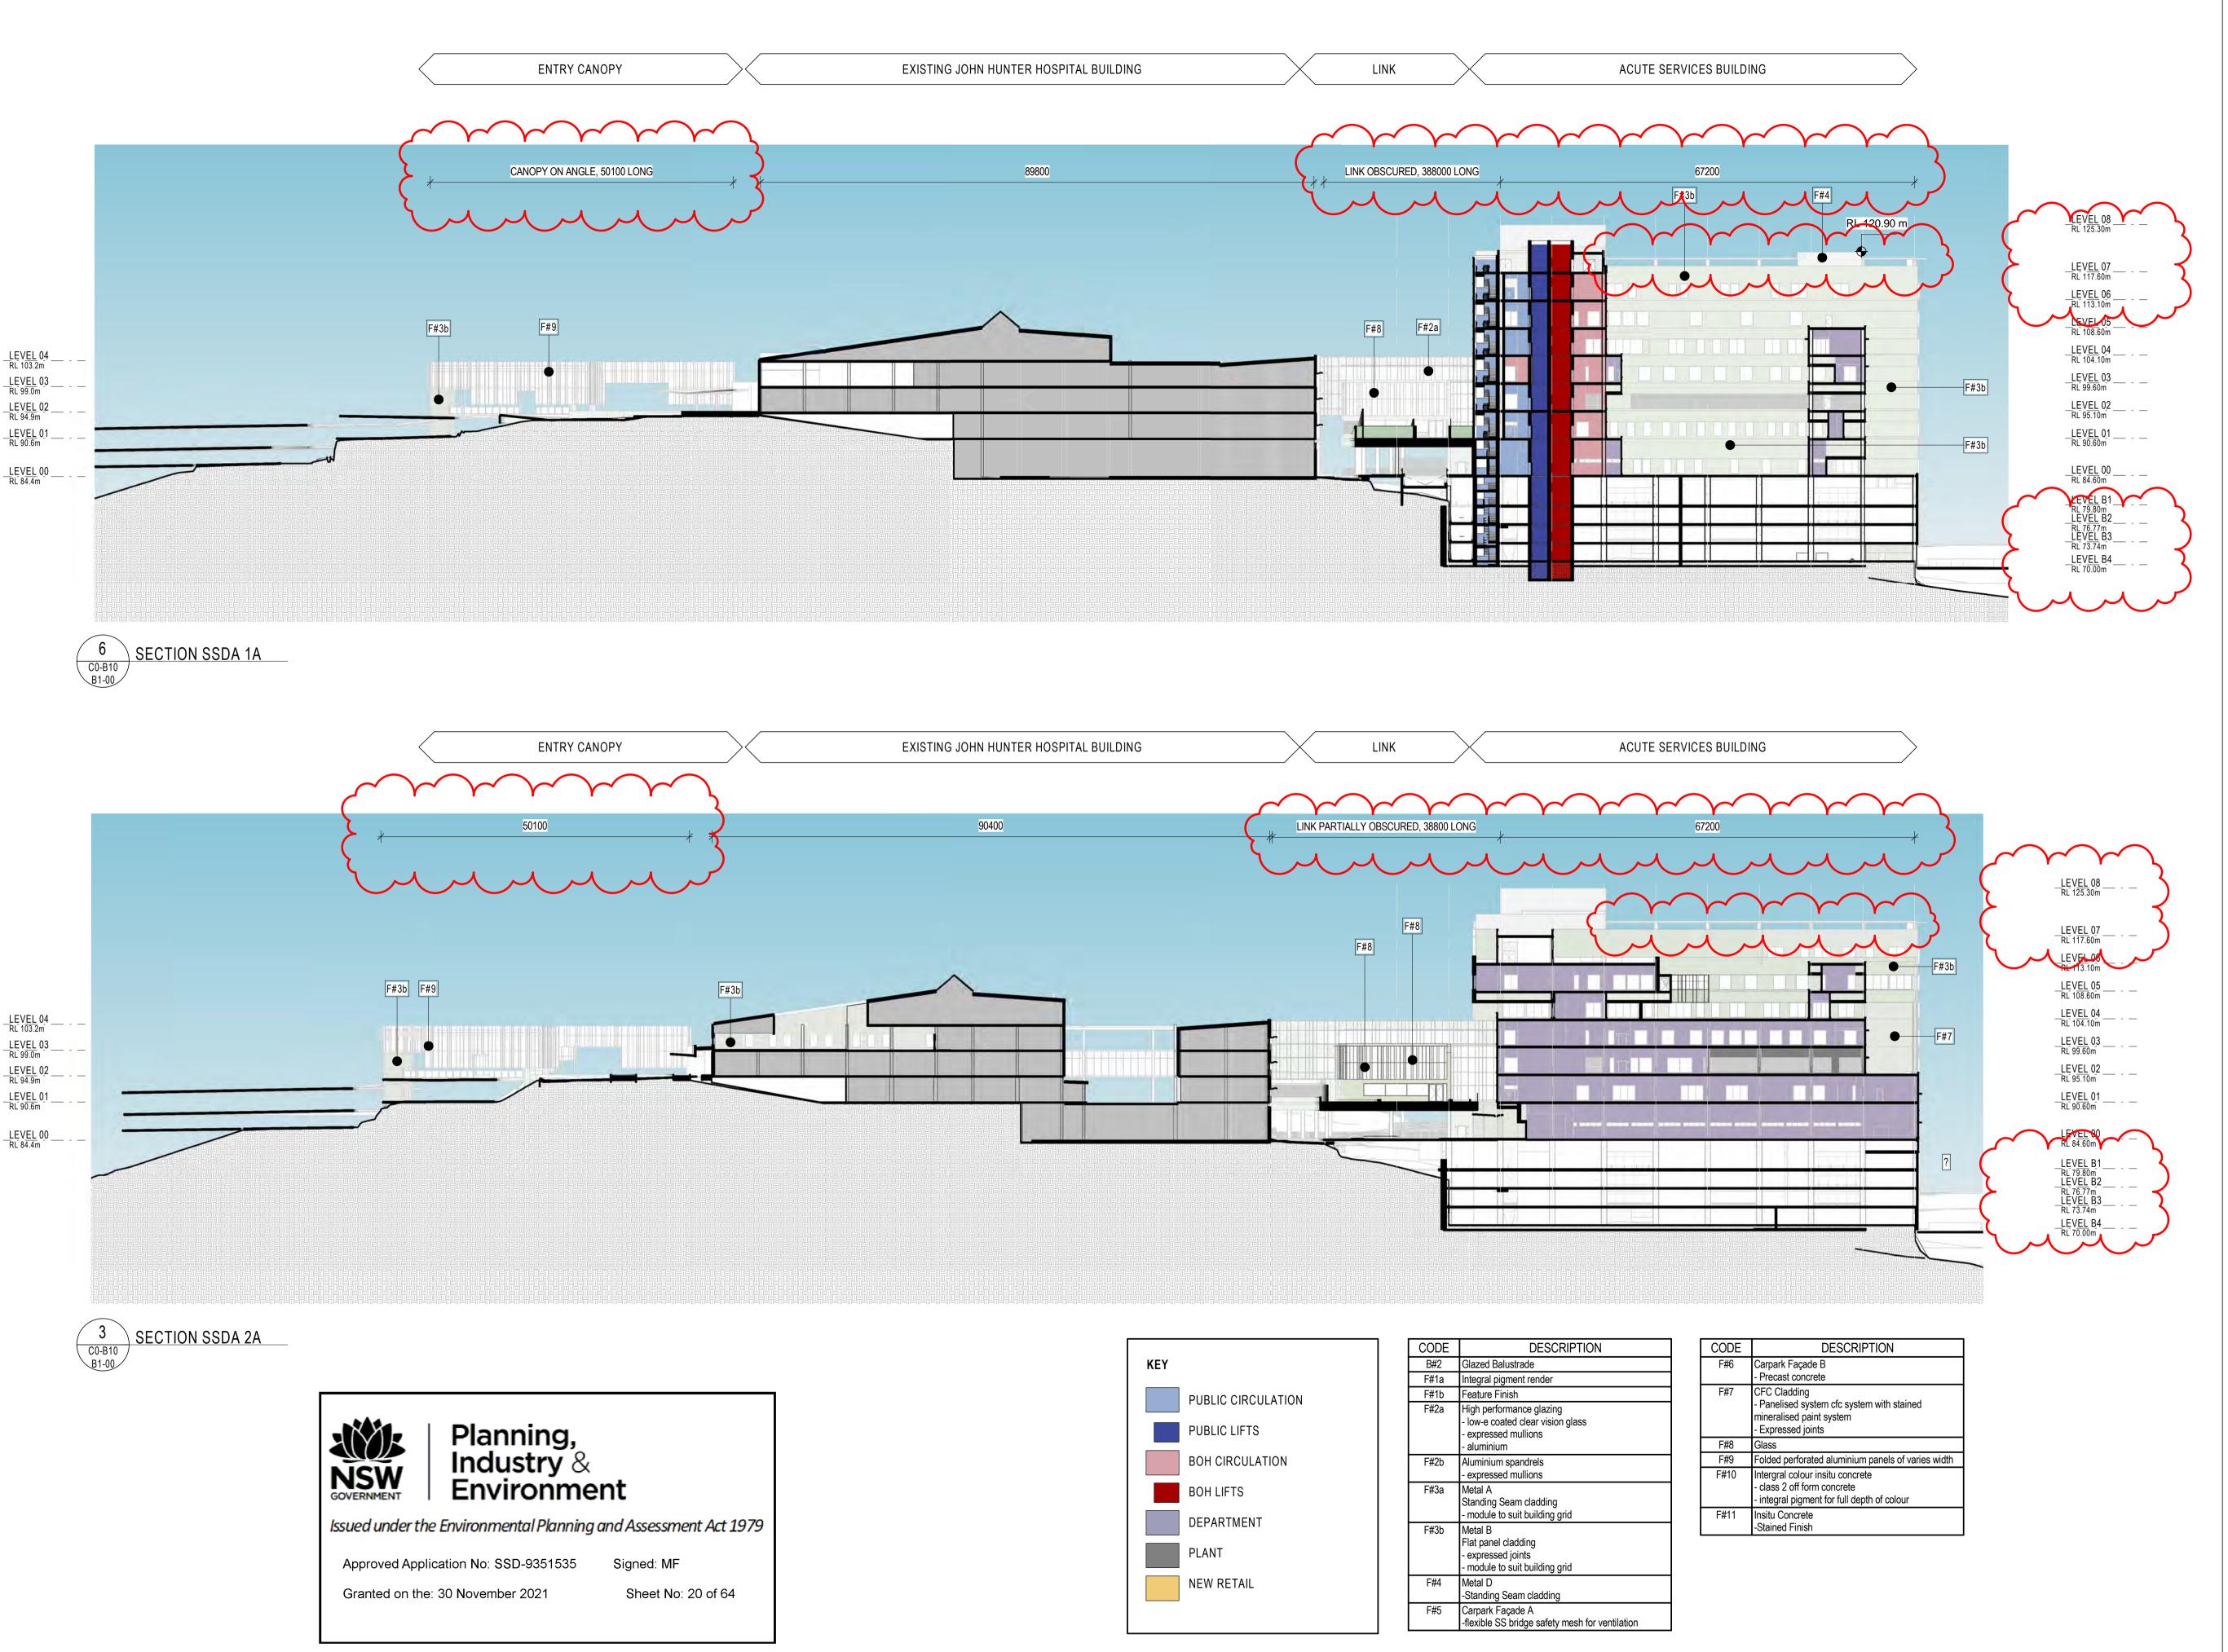
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ELEVATIONS - JOHN HUNTER HOSPITAL

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URBIS LANDSCAPE TEL: 02 8233 9900 CLIENT


NSW GOVERNMENT Infrastructure HEALTH INFRASTRUCTURE, NSW

PROJECT

CLIENT NUMBER

JOHN HUNTER HEALTH & INNOVATION PRECINCT Lookout Rd, New Lambton Heights NSW 2305 BVN PROJECT NUMBER

1904010 DRAWING KEY

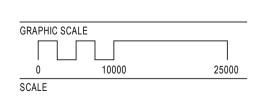

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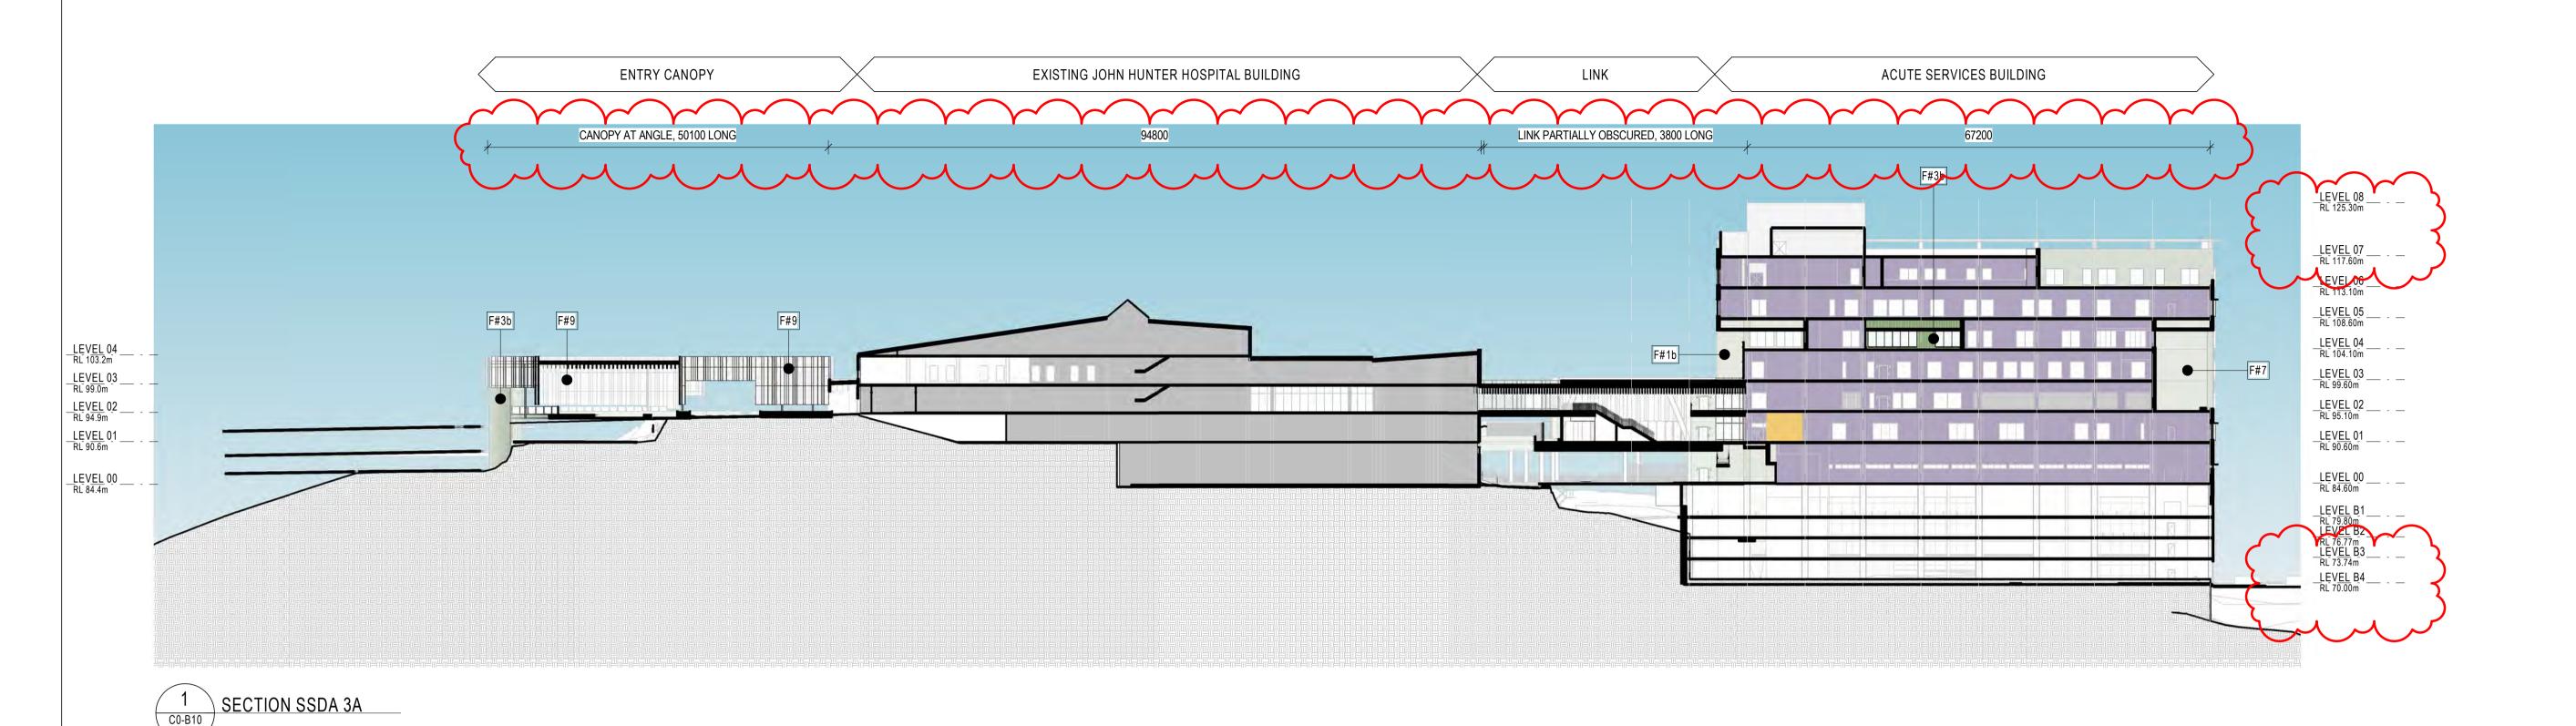
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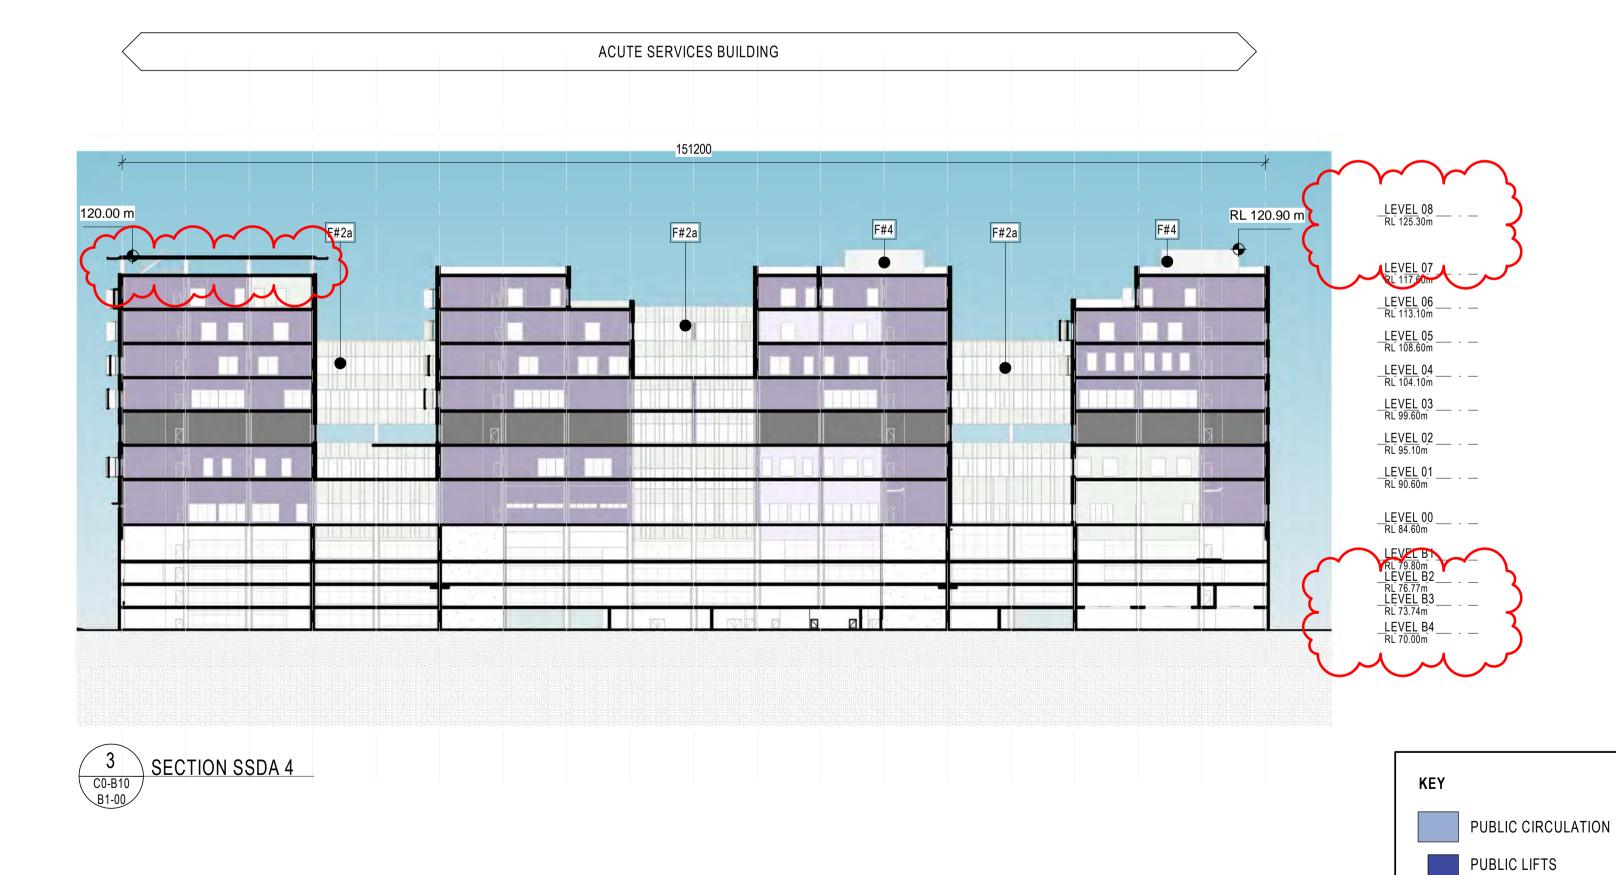
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BUILDING SECTIONS

AR_ C0-D10 XX-X0







Granted on the: 30 November 2021

CODE

BOH CIRCULATION

DEPARTMENT

NEW RETAIL

BOH LIFTS

PLANT

B#2 Glazed Balustrade F#1a Integral pigment render F#1b Feature Finish

F#2a High performance glazing

expressed joints

F#5 Carpark Façade A

module to suit building grid

-flexible SS bridge safety mesh for ventilation

-Standing Seam cladding

Issued under the Environmental Planning and Assessment Act 1979

Sheet No: 21 of 64

C:\Users\slingard\REVIT_LOCAL\2020\AR_X0-M10 NL-X0_RVT_[SITE]_SD_sam_lingard.rvt

Approved Application No: SSD-9351535 Signed: MF

DESCRIPTION	CODE	DESCRIPTION
Glazed Balustrade	F#6	Carpark Façade B
Integral pigment render		- Precast concrete
Feature Finish High performance glazing - low-e coated clear vision glass - expressed mullions	F#7	CFC Cladding - Panelised system cfc system with stained mineralised paint system - Expressed joints
- aluminium	F#8	Glass
Aluminium spandrels	F#9	Folded perforated aluminium panels of varies width
- expressed mullions Metal A Standing Seam cladding	F#10	Intergral colour insitu concrete - class 2 off form concrete - integral pigment for full depth of colour
- module to suit building grid Metal B	F#11	Insitu Concrete -Stained Finish
Flat panel cladding		

NSW ARCHITECTS REGISTRATION BOARD / NOMINATED ARCHITECTS 9356 NINOTSCHKA TITCHKOSKY 7115 JULIAN ASHTON 7053 MATTHEW BLAIR 7151 PHILLIP ROSSINGTON 4937 JAMES GROSE 7439 PETER TITMUSS 10447 ALISON BOUNDS

Telephone +61 2 8297 7200 Facsimile +61 2 8297 7299 www.bvn.com.au

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	ISSUE	DATE	FOR
	1	22-02-2021	ENG. BACKGROUNDS
	2	09-03-2021	FOR INFORMATION
	3	16-03-2021	FOR INFORMATION
	4	01-04-2021	SSDA
	5	14-05-2021	FINAL FOR SSDA
	6	06-08-2021	FINAL FOR SSDA

PROJECT MANAGER APP Corporation Pty Ltd TEL: 02 9957 6211 ARCHITECT BVN

TEL: 02 8297 7200 STRUCTURAL & CIVIL CONSULTANT NORTHROP ENGINEERS TEL: 02 4943 1777 ELECTRICAL & MECHANICAL CONSULTANT STEESEN VARMING PTY LTD TEL: 02 9967 2200 HYDRAULIC & WET FIRE CONSULTANT WARREN SMITH & PARTNERS

TEL: 02 9299 1312 LANDSCAPE CONSULTANT URBIS LANDSCAPE TEL: 02 8233 9900



HEALTH INFRASTRUCTURE, NSW CLIENT NUMBER

PROJECT

JOHN HUNTER HEALTH & INNOVATION PRECINCT Lookout Rd, New Lambton Heights NSW 2305 BVN PROJECT NUMBER

1904010 DRAWING KEY

GRAPHIC SC	CALE	
0	10000	25000
SCALE		
As indicated(@A1	1:1000 @ A3

STATUS

DRAWING SSDA

BUILDING SECTIONS

AR_ C0-D10 XX-X1

Approved Application No: SSD-9351535 Signed: MF

Granted on the: 30 November 2021

Sheet No: 22 of 64




DESCRIPTION:

Standing seam cladding, custom colour in matt finish, ref skin colourway

USAGE:

Typical Exterior Facade - ASB

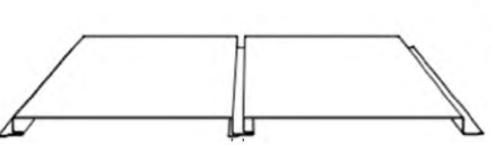

DESCRIPTION:

Flat panel cladding, expressed joints, 3 x custom colours, ref settings colourway

USAGE:

Typical Exterior Facade - ASB



DESCRIPTION:

DESCRIPTION:

colourway

USAGE:

Stained columns and slab edges, ref skin colourway below

USAGE:

Typical Exterior Facade - ASB

Render on FC or insitu concrete

substrates with a sand fine polished finish, ref settings

Typical Exterior Facade



DESCRIPTION:

Perforated Aluminium Screening, ref skin colourway

USAGE:

ASB Windows, Pavilion and Entrance Canopy



DESCRIPTION:

Flexible stainless steel bridge safety

USAGE:

Carpark Facade



DESCRIPTION:

Clear vision glass in champagne aluminium frame

USAGE:

Typical Exterior Facade - ASB

C:\Users\cskinner\REVIT_LOCAL\2020\AR_X0-M10 NL-X0_RVT_[SITE]_SD_skinner.cath.rvt



DESCRIPTION:

CFC with stained mineralised paint system, expressed joints filled with sealant, ref settings colourway

USAGE:

Typical Exterior Facade - ASB



DESCRIPTION:

Self supporting glass panels

USAGE:

Pavilion and Entrance Canopy



DESCRIPTION:

Textured glass screening

USAGE:

Pavilion and Entrance Canopy



BNV

NOMINATED ARCHITECTS

9356 NINOTSCHKA TITCHKOSKY 7115 JULIAN ASHTON 7053 MATTHEW BLAIR 7151 PHILLIP ROSSINGTON 4937 JAMES GROSE 7439 PETER TITMUSS 10447 ALISON BOUNDS

Telephone +61 2 8297 7200 Facsimile +61 2 8297 7299 www.bvn.com.au

INTELLECTUAL PROPERTY

ISSUE DATE

PROJECT MANAGER

ARCHITECT

TEL: 02 9957 6211

TEL: 02 8297 7200

TEL: 02 4943 1777

TEL: 02 9967 2200

TEL: 02 9299 1312

LANDSCAPE CONSULTANT

URBIS LANDSCAPE

STRUCTURAL & CIVIL CONSULTANT NORTHROP ENGINEERS

ELECTRICAL & MECHANICAL CONSULTANT STEESEN VARMING PTY LTD

HYDRAULIC & WET FIRE CONSULTANT

WARREN SMITH & PARTNERS

APP Corporation Pty Ltd

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14-05-2021 FINAL FOR SSDA

06-08-2021 FINAL FOR SSDA

CLIENT NUMBER

JOHN HUNTER HEALTH & INNOVATION PRECINCT Lookout Rd, New Lambton Heights NSW 2305 BVN PROJECT NUMBER

1904010 DRAWING KEY

GRAPHIC SCALE

1:1000 @ A3 @A1 STATUS

MATERIALS BOARD

AR_ C0-Y40 XX-X0

EXPLICIT COLOURS - SKIN COLOURWAY

IMPLICIT COLOURS - SETTINGS COLOURWAY

JOHN HUNTER HEALTH & INNOVATION PRECINCT

STATE SIGNIFICANT DEVELOPMENT APPLICATION LANDSCAPE ARCHITECTURE



LANDSCAPE PACKAGE / DRAWING REGISTER

DRAWING NUMBER	DRAWING TITLE	REVISION
LD_00-A00 XX-00	COVER SHEET	F
_D_00-A10 XX-01	LEGEND SHEET	Е
LD_00-A10 XX-02	PLANTING SCHEDULE STREETSCAPE	D
LD_00-A10 XX-03	PLANTING SCHEDULE ARRIVAL & ROOFTOPS	С
LD_00-A10-XX-04	PLANTING SCHEDULE COURTYARDS & INTERNAL	С
 _D_00-B01 NL-01	SHEET SPLIT SITE RELATED	F
 _D_B0-B20 NL-00	JHH ARRIVAL FORECOURT	С
_D_B0-B20 NL-X0	OVERALL ZONAL PLAN	F
LD_B0-B20 NL-X1	TREE REMOVAL PLAN	D
_D_B0-B60 NL-X1	SITE WIDE LANDSCAPE PLAN	D
_D_B0-B61 NL-01	ARRIVAL FORECOURT SECTIONS	С
LD_BA-B20 00-20	ASB BUILDING LEVEL 00	D
_D_BA-B20 01-20	ASB BUILDING LEVEL 01	D
_D_BA-B20 02-20	ASB BUILDING LEVEL 02	D
LD_BA-B20 03-20	ASB BUILDING LEVEL 03	D
LD_BA-B20 04-20	ASB BUILDING LEVEL 04	D
 LD_BA-B20 05-20	ASB BUILDING LEVEL 05	С
_D_BA-B20 06-20	ASB BUILDING LEVEL 06	С
 _D_BA-B20 B1-20	ASB BUILDING LEVEL B1	D
D_BA-B20 B2-20	ASB BUILDING LEVEL B2	D
LD_BA-B20 B3-20	ASB BUILDING LEVEL B3	D
D_BA-B20 B4-20	ASB BUILDING LEVEL B4	D
_D_BA-B60 00-01	ASB LEVEL 00 COURTYARD SOIL VOLUME DIAGRAM	D
_D_BA-B60 01-01	ELEVATED GARDEN SOIL VOLUME DIAGRAM	E
LD_BA-B60 01-02	ASB LEVEL 01 COURTYARD SOIL VOLUME DIAGRAM	D
_D_BA-B60 03-01	ELEVATED GARDEN - ROOF SOIL VOLUME DIAGRAM	С
LD_BA-B60 04-01	ASB LEVEL 04 COURTYARD SOIL VOLUME DIAGRAM	С
_D_BA-B60 NL-00	ARRIVAL FORECOURT SOIL VOLUME DIAGRAM	С
LD_BA-B61 00-01	ASB BUILDING LEVEL 00 COURTYARD SECTIONS	D
LD_BA-B61 00-02	ASB BUILDING LEVEL 00 ED ARRIVAL SECTION	С
LD_BA-B61 01-01	ASB BUILDING LEVEL 01 COURTYARD SECTIONS	D
_D_BA-B61 01-02	ASB BUILDING LEVEL 01 ELEVATED GARDEN SECTIONS	С
LD_BA-B61 04-01	ASB BUILDING LEVEL 04 COURTYARD SECTIONS	D
LD_BJ-B20 02-30	JHH BUILDING LEVEL 02	С
LD_BJ-B20 03-30	JHH BUILDING LEVEL 03	С
_D_BJ-B60 03-01	JHH COURTYARD #01 SOIL VOLUME DIAGRAM	С
_D_BJ-B60 03-02	JHH COURTYARD #02 SOIL VOLUME DIAGRAM	С
LD_BJ-B60 03-03	JHH COURTYARD #03 SOIL VOLUME DIAGRAM	С
_D_BJ-B61 03-01	JHH BUILDING LEVEL 03 COURTYARD 1 SECTIONS	С
LD_BJ-B61 03-02	JHH BUILDING LEVEL 03 COURTYARD 2 SECTIONS	С
LD_BJ-B61 03-03	JHH BUILDING LEVEL 03 COURTYARD 3 SECTIONS	С



Issued under the Environmental Planning and Assessment Act 1979

Approved Application No: SSD-9351535 Signed: MF

Granted on the: 30 November 2021 Sheet No: 23 of 64

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- 1. THE PLAN MUST BE READ IN CONJUNCTION WITH THE SPECIFICATION WHICH ALSO CONTAINS THE SCHEDULE OF LANDSCAPE WORKS AND PLANT
- 1. ALL DRAWINGS ARE TO BE READ IN CONJUNCTION WITH THE ASSOCIATED DRAWINGS BY OTHER CONSULTANTS, e.g. ENGINEERS.
- 2. DO NOT SCALE FROM DRAWING PACKAGE, USE NOMINATED DIMENSIONS AND LEVELS
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- TO THE SUPERINTENDENTS REPRESENTATIVE BEFORE PROCEEDING WITH WORKS

6. LOCATE AND PROTECT ALL UNDERGROUND SERVICES

- PRIOR TO EXCAVATION. MAKE GOOD ALL DAMAGE
- 7. THESE DRAWINGS ARE TO BE PRINTED IN COLOUR
- 8. FOR LEGEND REFER TO LEGEND SHEET LD_00-A10 XX-01
- 9. FOR DETAILED DESCRIPTION OF EACH LANDSAPE AREA REFER TO LANDSCAPE AREAS SCHEDULE
- 10. NUMBERS ON LANDSCAPE AREAS ARE REFERING TO THE LANDSACPE SPACE INDEX
- 11. IRRIGATION DESIGN TO BE DEVELOPED AND COORDINATED AT DESIGN DEVELOPMENT

F	SSDA ISSUE	PM	PJ	09/08/2021
Е	ECI TENDER	MK	PJ	16/07/2021
D	100% SCHEMATIC DESIGN	MK	PJ	08/04/2021
С	100% DRAFT SD ISSUE	SP	PJ	26/03/2021
В	75% SD ISSUE	MK	PJ	29/01/2021
Α	50% SD ISSUE	MK	PJ	14/12/2020
REV	DESCRIPTION	DWN	CHK	DATE

PROJECT NAME & ADDRESS

JOHN HUNTER HEALTH & INNOVATION PRECINCT

Lookout Rd, New Lambton Heights, NSW 2305

PROJECT DIRECTOR:

DRAWING TITLE **COVER SHEET**

PROJECT NO. ISSUE

SSDA SCALE


N.T.S

P0012689


LD_C0-A00 XX-00

REVISION

MIN. 300mm SOIL DEPTH, PREMIUM GARDEN SOIL MIX, GEOFABRIC FILTER AND DRAINAGE LAYER ON WATER CONCOURSE PRECAST CONCRETE PAVER 70mm THICK REINFORCED PEDESTAL PAVER. FINISH: SHOT-BLASTED. COLOURS AND TYPE TBC COURTYARD PRECAST CONCRETE PAVER 70mm THICK REINFORCED PEDESTAL PAVER. FINISH: SHOT-BLASTED. 4 COLOURS TO PATTERNED LAYOUT FSC HARDWOOD CERTIFIED TIMBER CONCOURSE PRECAST CONCRETE SMALL PAVER 40mm THICK PAVER TO PEDESTAL PANEL SUPPORT TILES. FINISH: SHOT-BLASTED. COLOURS AND TYPE TBC CONCOURSE BOUND GRAVEL PAVING 25mm THICK RESIN BOUND STONE PAVING TO PEDESTAL PANEL SUPPORT TILES. COLOUR AND TYPE TBC COURTYARD EXPOSED AGGREGATE PAVING 70mm THICK REINFORCED PEDESTAL PAVER EXPOSED AGGREGATE LOOK. FINISH: SHOT-BLASTED. COLOURS **EXISTING PLANTING** 50mm BLUESTONE CRAZY PAVE. FINISH: SAW CUT. COLOURS AND TYPE TBC FLAGSTONE IN GRAVEL 50mm BLUESTONE PAVE. FINISH: SAW CUT. COLOURS AND TYPE TBC. GRAVEL: BASALT ROCK BASALT ROCK 100mm THICK BASALT ROCK WITH 20% (min) CRUSHED GREEN GLASS TO STAINLESS STEEL EDGE. ALLOW LARGE AND MEDIUM AGGREGATE. COLOUR AND TYPE ARTIFICIAL TURF PRESTIGE 40mm THICK POT PLANTERS **VARIOUS SIZES**

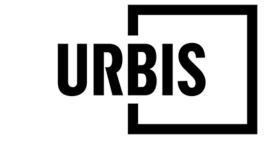

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DISCLAIMER

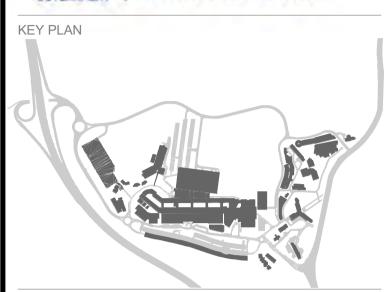ROOFS & FACADES

SEDUM GREEN ROOF

PATTERNED GRAVEL ROOF

FACADE PLANTER

100mm SOIL DEPTH, GEOFABRIC FILTER AND DRAINAGE

GRAVELS TO BE PROVIDED IN DIFFERENT SIZES AND

500mm SOIL DEPTH, GEOFABRIC FILTER AND DRAINAGE

COLOURS TO PROVIDE DISTINCT PATTERNS

CELL TO WATER PROOFING MEMBRANE

CELL TO WATER PROOFING MEMBRANE

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- TO THE SUPERINTENDENTS REPRESENTATIVE BEFORE PROCEEDING WITH WORKS

5. THE CONTRACTOR MUST REFER ANY DISCREPANCIES

- 6. LOCATE AND PROTECT ALL UNDERGROUND SERVICES PRIOR TO EXCAVATION, MAKE GOOD ALL DAMAGE
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B 100% SSDA ISSUE

REV DESCRIPTION

A 100% SSDA ISSUE

PROJECT NAME & ADDRESS

JOHN HUNTER HEALTH & INNOVATION

PRECINCT Lookout Rd, New Lambton Heights, NSW 2305

PROJECT DIRECTOR:

DRAWING TITLE LEGEND SHEET

ISSUE SSDA

SCALE N.T.S


PROJECT NO.

P0012689

DWN CHK DATE

DRAWING NO.



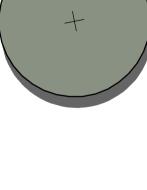

GARDEN WALL

KERB PLANTER WALL

PROPOSED MEDIUM SIZED TREE (8-12m MATURE HEIGHT)

CORTEN WALL



Issued under the Environmental Planning and Assessment Act 1979

Approved Application No: SSD-9351535 Signed: MF

Granted on the: 30 November 2021

Sheet No: 24 of 64

LD_C0-A10 XX-01

REVISION

PLANTING SCHEDULE SITEWIDE & ASB ARRIVAL

SEEDING MIX A1 & A2 - SMO AREA-8256,30 m2					
PLANT CODE	BOTANICAL NAME	COMMON NAME	MATURE HEIGHT AND SPREAD	CONTAINER SIZE	PLANTS PER M2
TREES					
ANG cos	Angophora costata	Smooth-Barked Apple	25e x 15m	100L, 200L, 400L	as shown
EUC gla	Eucelyptus globoides	White Stringybark	20m x 15m	1001., 2001.	ss shows
EUC plp	Eucalyptus piperita	Sydney Peoperaint	20m x 15m	100L 200L 400L	as shown
SYN glo	Syncarpia glomuliflura	Turpentine	16m x 8m	100L, 200L	as shown
ALL tor	Allocasuerna torutosa.	Forest Oak	10m x 7m	100L, 200L	as shown
SHRUBS					8
ACA mer	Acecia myrtifolia	Red-Sterrmed Watte	3m x 3.0m	300mm	0.5
BAN spi	Banksia spiriulosa	Hakrpin Banksia	3m x 2.5m	300mm	0.5
BRE obl	Braymia oblongifolia	Coffee Bush	Bests Sm	300mm	- 1
DAV all	Davissis ukotoka	Gorse Sitter Pes	2m x 1m	300mm	0.3
000 to	Dodonnes triguetra	Large-Leaf Hop Bush	3m x 2m	300mm	1
LEP pol	Leptosperman polygaliktium	Larron Sounted Tea Tree	3st x 2m	300mm	1
LEU lan	Leucapagon lanceolatus	Lance-leaved beared heath	2m x 1m	300mm	0.5
ZIE smi	Zioria smithii subsp smithii	Sandly ziena	2m x 1m	300mm	0.1
GRASSES & GROUNCOVERS					
DIA coe	Dianella caerulea var. producta	Blue Flax Lity	firm k 2mi	150mm	- 4
DIC nsp	Dictionsha repens	Ridney Weed	0.15m x 1.8m	150mm	4
ENT sir	Emiriosia stricta	Wity Parit	11.50m x 11.30m	150mm	2
IMP cyl	Imperata cylindrica	Blady glass	1.0m x 0.3m	150mm	- 1
MCst	Microlasma attpoldes	Weeping Rice Greek	0.30m s 0.50m	150mm	2
PRA pur	Praša purpurascens	Whiteroot	9.20m x 2m	159mm	-1
VIO hed	Viola haderacea	Ny-leaved Violet	0,15m s 1m	150mm	4
XAN tet	Xanthombous lutifulia	Grass Tree	2m x 1.5m	150mm	2

TURPENTINE FOREST	(65%), TUBESTOCK (35%) & 1	FREES SMOOTH-BARK	(ED APPLE - SY	DNEY PEPPE	RMINT -
AREA- 6521.04 m2	20	11.	500		
PLANT CODE	BOTANICAL NAME	COMMON NAME	MATURE HEIGHT AND SPREAD	CONTAINER SIZE	PLANTS PER M2
TREES					()
ANG cos	Angophora costata	Smooth-Barked Apple	25m x 15m	100L 200L	as shown
EUC gla	Eucelyptus globoldes	White Stringybark	20m x 15m	190L	as shown
EUC pip	Eucelyptus pipertia	Sydney Propertiest	20m x 15m	1001., 2001.	as shown
SYN glo	Syncarpia glomulifera	Turpensne	16m x 8m	100L	25 Shows
ALL for	Allocasserina torulosa	Forest Own	10m x 7m	100L	as shown
SHRUBS					
ACA myr	Acadia myrtifolia	Red-Sterroed Watte	Sm x 3:0m	300mm	0.5
BAN spi	Banksia spinulosa	Hairpin Bankata	3m x 2.5m	300mm	0.5
BRE onl	Breynia oblongitolia	Coffee Bush	3m x 3m	300mm	1
DAY uli	Daylesia ulicifolia	Corse Bitter Pex	2m x 1m	300mm	0.3
DOD tri	Dodonses triquetra	Large-Leaf Hop Blush	3m x 2m	300mm	. 1
LEP pol	Leptospermum polygarifolium	Lemon Scented Tea Tree	3m k 2m	300mm	
LEU iser	Leucopogon lanosolatus	Cance-leaved beared heath	2m x 1m	300mm	0.5
ZIE emi	Zieria umbhii subsp smithii	Sandly steria	2m ic 1m	300mm	0.1
GRASSES & GROUNCOVERS					
DIA cae	Dianella caerulea var. producta	Stue Flax Lity	far k 2m	150mm	- 4
DIC rep	Dichondia repens	Kidney Weed	0.15m x 1.8m	150mm	-4
ENT ab	Entolesia atrocta	Wiry Panic	0.50m x 0.30m	150mm	2
IMP cyl	Imperata cylindrica	Blady grass	1.0m x 0.3m	159mm	1
MCsi	Microlaena stipoides	Weeping Rice Grass	0.30m x 0.50m	150mm	2
PRA pur	Pretia purpureacens	Whiteroot	0.20m x 2m	150mm	1
VIO hed	Viola hederaces	Ny-teaved Violet	0.15m x 1m	150mm	4
XAN lat	Xanthomboea (atifolia	Gress Tres	2m x 1.5m	150mm	2

SITE WIDE WESTERN ROAD LANDSCAPE

AREA- 26712.20 m2	- 3	W	W		
PLANT CODE	BOTANICAL NAME	COMMON NAME	MATURE HEIGHT AND SPREAD	CONTAINER SIZE	PLANTS PER M2
SHRUBS			70		
ACA ter	Acadia terminalis	Sunstrine Wattle	3m x 2m	Seeding	0.01 grams
AGA ut	Acecia ulicifolia	Prickly Moses	2m x 2m	Seeding	0.01 grams
BAN spi	Banksia spinylasa	Holispin Banksia	3m x 2.5m	Seeding	0.01 grams
LEPTH	Leptospermum trinervium	Stender Tea-tree	6m x 1-6m	Seeding	0.01 grams
LOM sal	Lometia salicifoka	Wild Parsely	6m x 3m	Seeding	0.01 gram
FER lev	Personnia levis	Broad-Leaved Geebung	3m ic first	Seeding	0.01 grams
PER in	Peraconia lineans	Narrow Leaved Geebung	3m x 0.7m	Seeding	0.01 grams
PLfL euc	Puterasea suchita	Large-fower Bush-pea	1.5m x 2m	Seeding	0.01 grams
PITT und	Pitosporum undulatum	Bweet Pittosporum	12m x 7m	Seeding	0.01 grams
XXVI lat	Xianthonhossa (atifolia	Grass Tree	2m x 1.5m	Seeding	0.01 grans
TET jun	Telratheca juncea	Black-ryed Susan	0.5m x 0.3m	Seeding	0.01 grams
GRASSES & GROUNCOVERS	400				
ENT str	Emolesia stricta	Wiry Panic	0.50m x 0.30m	Seeding	0.01 grams
IMP cyl	Imperata cyrindrica	Blady grass	1.0m x 0.3m	Seeding	0.01 grams
THE aux	Themsels acatralis	Kangaroo Grass	1m x 0.5m	Beeding	0.01 grams
PTE esc	Pteridium esculentum	Bracken Fem	2m x 1.2m	Seeding	0.01 grams
LOM obl	Comendra obliqua	Teislad Matrush	0.60m k 0.50m	Seeding	0.01 grams

NOTE: Trees as shown - Large tree pot sizes to be dispursed evenly throughout the area.

TREES, SEEDING (75%) & TUI AREA-3067.63 m2					
PLANT CODE	BOTANICAL NAME	COMMON NAME	MATURE HEIGHT AND SPREAD	CONTAINER SIZE	PLANTS PER M2
TREES					2
ANG cos	Angophora costata	Smooth-Barked Apple	25m x 15m	400L	as shown
COR gun:	Corymbia gummillera	Red Bloodwood	20m x 10m	400L	as shows
EUC dap	Eucalyptus capitellata	Brown Stringybark	20m ic 10m	100L	as shown
EUC gla	Eucalyptus globoldess	White Stringybark	20m x 15m	400L	as shown
EUC pun	Eucelyptus punctets	Grey Gum	25m x 10m	100L	as stown
SYN gio	Syncarpia glomulifera	Turpersne	16m x 8m	100L	as shown
ALL for	Afocasueira torulosa	Forest Own	10m x 7m	400L	an afewn
GRASSES & GROUNCOVERS					1
BAUjun	Baymea junces	Bare Twig Rush	1.0m x 1.0m	Seeding and 90mm Tubestock	0.01 grams / 6
CAR app	Carex appressa	Buedoin	1.0m x 1.0m	Seeding and 90mm Tubestock	0.01 grams / 6
GAH six	Gahnia sieberiana	Red-full saw-sedge	2.0m x 2.0m	Seeding and 60mm Tubestock	0.01 grams / 0.5
IMP ayr	Imperata cylindrica	Baidy Grass	1.0m x 0.3m	Seeding and 60mm Tubestock	0.01 grams) 4
ISO nod	Isolepis nodosa	Knobby Club Rush	1.0m x 2m	Seeding and 60mm Tubestock	0.01 grams / 0.5
JUN uni	Juncus ustatus	Tassel Sedge	1.0m x 1.0m	Seeding and 50mm Tubestock	0.01 grams / f
LOW los	Lomandra longifolia	Spiny-head-mat-rush	1.3m x 1.0m	Seeding and 50mm Tubestock	0.01 grams / f
GRASSES & GROUNCOVERS	THAT FALL IN APZ ZONE				
LOM tan	Tanika® Lomandra longifolia "LM300" PBR	Lomandra Tanika	0.60m x 0.65m	Seeding and 90mm Tubestock	0.01 grams / 0.5
LOM nya	Nyalas Lomandra longifola "LM400" PBR	Lomandra Nyalla	0.80m x0.90m	Seeding and 90mm Tubestock	0.01 grams / 0.5
LOM lon	Lomendra longifolie Katrinus Deluxe' PBR	Lomandra longifolia	0.70m x 0.70m	Seeding and 50mm Tubestock	0.01 grams / 0.5
LR)m	Just Right® Liriope muscani LIRJ PBR	Liriope Just Right	0.50m x 0.50m	Seeding and 50mm Tubestock	0.01 grams / 1
LRisa	Isabelia® Unope muscari 'EIRF' PBR	Liriope Isabella	0.46m x 0.50m	Seeding and 50mm Tubestock	0.01 grams / 0.3
LRame	Arcethys!™ Liriope muscari LIRTP PBR	Liriope Amethyst	0.40m x 0.40m	Seeding and 50mm Tubestock	0.01 grams / 1
CAR gla	Aussie Rantsler™ Carpobrotus glaupescens 'CAR10' PBR	Carpobrotus glaucescens	0.30m x 2m	Seeding and 90mm Tubestock	0.01 grams / 1
CAS gla	Free Fall** Casuarina glauca prostrate "CASU1" PBR	Caluarina glauca	0.20m s 2m	Sweding and Street Tubestock	0.01 grams / 0.5
ENT atr	Entolesia stricta	Wiry Parec	0.50m x 0.30m	Seeding	0.01 grams
IMP cyl	Imperata cylindrica	Blady grass	1.0m k.0.3m	Seeding	0.01 grams
THE was	Thereotic australis	Karganic Griss	1m x II.5m	Beeding	0.01 grams
PTE est	Plendium exculentum	Bracken Fent	2m x 1.2m	Seeding	0.01 grams
LOM obt	Lomandra obliqua	Twisted Matrush	0.50m x 0.50m	Seeding	0.01 grams

TREES, SEEDING & TUBESTOCK - SMOOTH-BARKED APPLE - RED BLOODWOOD OPEN FOREST

BOTANICAL NAME

COMMON NAME

HEIGHT AND CONTAINER PLANTS PER

SIZE

SPREAD

APZ PLANTING

AREA-27240.5 m2

PLANT CODE

ANG cos	Angophora costata	Smooth-Barked Apple	25m x 15m	100L	as shown
COR gum:	Corymbia gummfera	Red Bloodwood	30m x 10m	100L	as altown:
EUC cap	Eucalyptus capitellata	Brown Stringybark	20m x 10m	100L	as shown
EUC gla	Eucalyptus globoldes	White Stringybark	20m x 15m	190L	as shown
EUC pen	Eucelyptus periculate	Grey Inunberk	25m x 15m	100L	resorts as
SYN glo	Syncarpia glomulifera	Turpensner	16m x 8m	100L	as shown.
ALL for	Allocasuarina torulosa	Forest Own	10m x 7m	100L	as shown
SHRUBS					*
AGA ter	Acadia terminaks	Sunshine Wattle	3m x 2m	Seeding and 90mm Tubestock	0.01 grams / 0
ACA uli	Acasia ulicifolia	Prickly Moses	2m x 2m	Seeding and 90mm Tubestock	0.01 grams / 0
BAN spi	Banksia spinulosa	Hairgin Bariksia	3m.x 2.5m	Seeding and 50mm Tubestock	0.01 grams / 0
LEP III	Leptospermum trinervium	Siender Tea- tree	6m x 1-6m	Seeding and Glass Tubestock	0.01 grams /
LOW saf	Lometia salicifolia	Wild Parsely	6m x 3m	Seeding and 60mm Tubestock	0.01 grams / 0
PER lev	Persoonia levis	Broad-Leaved Geebung	3m x 1m	Seeding and 60mm Tubestock	0.01 grams /
PER in	Persoonia linearia	Narrow Leaved Geebung	3m x 0.7m	Seeding and 50mm Tubestock	0.01 grams /
PUL euc	Pullenses euchilis	Large-flower Bush-pea	1.5m x 2m	Seeding and 50mm Tubestock	0.01 grams./ 0
PITT und	Pitosporum undulatum	Sweet Pittosporum	12m x 7m	Seeding and 50mm Tubestock	0.01 grams./ 0
XANIar	Xanthonhoes latifolia	Grass Tree	2m x 1.5m	Seeding and 50mm Tubestock	0.01 grams./ 0
TET jun	Teltritheca juncea	Black-eyed Susan	0.5m x 0.3m	Seeding and 50mm Tubestock	0.01 grams /
CDACCEC & CDOUNT	DOGUEDO				-
GRASSES & GROUNI	Tankati Lomandra	Transaction of the same	Ť	Sweding and	e Pomeno a mana
	longifolia "LM300" PBR	Lomendra Tanika	0.60m k 0.66m	S0mm Tubestock	0.01 grams / 0
LOM san			C. C. and	Seeding and	Anna Control (Control
COM tan COM riya	Nyalati Lomandra longifolia "LM400" PBR	Comendra Nysila	0.88m x0.90m	50mm Tubestock	0.01-grams / 0
100.10.00.	longifolia "LM400" PBR Lomandra longifolia Katrinus	Lomandra Nyalia Lomandra longifolia	0.80m x0.90m 0.70m x 0.70m	Sooting and	0.01 grams / 0 0.01 grams / 0
LOM riya	longifolia "LM400" PBR	Carrier and Carrie	12	50mm Tubestock	0.01 grams / 0
LOM nya LOM ton	iongifolia 1,M400' PBR Lomandre longifolia Kaminus Detuve' PBR Just Rightth Linope muscari 1,R7 PBR Isabela® Linope muscari 1,RF	Lomandra longifolia	0.70m x 0.70m	Streen Tubestock Seeding and Streen Tubestock Seeding and Streen Tubestock Seeding and	0.01 grams / 0 0.01 grams /
LOM rya LOM ion UR jus	iongifolia 1,M400 PBR Lomandra longifolia Kathinus Ostuni PBR Just Rightib Linope muscari 1,RJ PBR Isabelia® Cinope muscari 1,RF PBR Amethyst™ 1,0ope	Lomandra longifolia Liviope Just Right	0.70m x 0.70m 0.50m x 0.50m	Sümm Tubestock Seeding and Sümm Tubestock Seeding and Sümm Tubestock Seeding and Sümm Tubestock Seeding and	0.01 grams / 0.01
LOM riya LOM fon LIR jus LIR iss	iongifolia 1,M400' PBR Lomandra longifolia Kaminus Ostuve' PBR Just Righttli Linope musoari 1,RJ PBR Isabela® Linope musoari 1,RF PBR	Lorrandra lorigifolia Liriope Just Right Liriope Isabella	0.70m x 0.70m 0.50m x 0.50m 0.40m x 0.50m	Sümm Tubestock Seeding and Sümm Tubestock Seeding and Sümm Tubestock Seeding and Sümm Tubestock	0.01 grams / 0.01 grams / 0.01 grams / 0.01 grams /
COM riya COM fon UR jus UR iss UR ame	iongifulia 1,M400° PBR Lomandra longifulia Kaminus Dakwe' PBR Just Righttlb Linope musoari 1,R7 PBR Isabela® Linope musoari 1,IRF PBR Amethyst™ Linope musoari 1,IRTP* PBR Aussie Rambler™ Carpobrotus	Lonandra longifolia Liriope Just Right Liriope Isasella Liriope Amethyst	0.70m x 0.70m 0.50m x 0.50m 0.40m x 0.50m 0.40m x 0.40m	Sümm Tubestock Seeding and Sümm Tubestock Seeding and Sümm Tubestock Seeding and Sümm Tubestock Seeding and Sümm Tubestock Seeding and Sümm Tubestock	0.01 grams /
COM rya LOM ion UR jus UR iss UR ane: CAR gla	iongifolia 1,M400* PBR Lomandra longifolia Kaminus Oatuve* PBR Just Rightth Linope muscari 1,R7 PBR Isabelast Linope muscari 1,RF PBR Amethyst** Linope muscari 1,RTP PBR Aussie Rambler** Carpotrotus glaudescens CAR10* PBR Free Fall*** Casuarina glauce	Lomandra longifolia Liriope Just Right Liriope Isabella Liriope Amethyst Carpobrotus glaucescens	0.70m x 0.70m 0.50m x 0.50m 0.40m x 0.50m 0.40m x 0.40m 0.30m x 2m	Sümm Tubestock Seeding and	0.01 grams / 0.01
LOM rya LOM lon LIR jus LIR iss LIR ame CAR gla GAS gla	iongifulia 1,M400* PBR Lomandra longifulia Kaminus Dature* PBR Just Rightth Linope muscari 1,RF, PBR Isabela® Linope muscari 1,RF PBR Amethyst™ Linope muscari 1,RFP PBR Aussie Rambler™ Cerpobratus glaucescens CAR10* PBR Free Fall™ Casuarina glauce prostatus CAS01* PBR	Lomandra longifolia Liriope Just Right Liriope tradella Liriope Amethyst Carpobrotus glaucescens Casuarina glauca	0.70m x 0.70m 0.60m x 0.50m 0.40m x 0.50m 0.40m x 0.40m 0.30m x 2m 0.20m x 2m	Sümm Tubestock Seeding and Sümm Tubestock Seeding and Sümm Tubestock Seeding and Sümm Tubestock Seeding and Sümm Tubestock Seeding and Sümm Tubestock Seeding and Sümm Tubestock	£
COM rya LOM ion LIR jus LIR iss LIR ame CAR gla CAS gla ENT str	iongifulia 1,M400* PBR Comandra longifulia Kanninus Oakwar PBR Just Rightill Linope muscari 1,RJ PBR Isabella® Uniope muscari 1,RF PBR Amethyst™ Linope muscari 1,RTP* PBR Aussie Rambler™ Carpobrotus glaucescens CARnif PBR Free Fall™ Casuarina glauca prostrate CAS01* PBR Erronssea atricta	Lomandra longifolia Liriope Just Right Liriope Instella Liriope Amethyst Carpobrotus glaucescens Casuarina glauca Winy Panic	0.70m x 0.70m 0.50m x 0.50m 0.40m x 0.50m 0.40m x 0.40m 0.30m x 2m 0.20m x 2m 0.50m x 0.30m	Somm Tubestock Seeding and Somm Tubestock	0.01 grams / 0.01 grams
COM roya COM fon LIR jus LIR ame CAR gla CAS gla ENT se	iongifolia 1,M400' PBR Lomandra longifolia Kaminus Dakwe' PBR Just Righttl Linope muscari 1,R/ PBR Isabeta®-Linope muscari 1,IRF PBR Amethyst™ Linope muscari 1,RTP PBR Aussie Rambler™ Carpobrotus glaucescens CAR10' PBR Free Fall™ Casuarina glauce prostrate CAS01' PBR Entonsele atricta	Lomandra longifolia Liriope Just Right Liriope baseella Liriope Amethyst Carpobrotus glaucescens Casuarina glauca Wiry Panic Blady grass	0.70m x 0.70m 0.50m x 0.50m 0.40m x 0.50m 0.40m x 0.40m 0.30m x 2m 0.20m x 2m 0.50m x 0.30m 1.0m x 0.30m	Sümm Tubestock Seeding and Sümm Tubestock Seeding	0.01 grams / 0.01

AREA-4,497m2					
PLANT CODE	BOTANICAL NAME	COMMON NAME	MATURE HEIGHT AND SPREAD	CONTAINER SIZE	PL/ PE
SHRUBS			1,141,		
ACA myr	Acadia myrtifolia	Red-Sterrined Wattle	3m x 3.0m	300mm	0
ACA ter	Acada terminalia	Surehine Wattle	3m x 2m	300mm	0
ACA us	Acacia ulicifolia	Prickly Masses	2m x 2m	300mm	
AOM smì	Acmena smithi	Common Lifty Pilly	5m x 3m	300mm	0
BAN spi	Banksia spiruktasi	Heispio Bankala	5m x 2.9m	300mm	
CALIE	Callistemon 'Little John'	Battlebrush	0.90m x 1.5m	300mm	.0
DAY uti	Daviesia ulicitota	Gorse Bitter Pea	2m x tm	300avm	
DOR sec	Dorywrites excelse.	Cymea Lify	4m x 2m	300mm	0
EPA pui	Epacris pulchella	NSW Corni Heath	1.5m x 1m	300mm	8
GRE GC	Gravities 'Gold Cluster'	Gold Cluster Grevities	0.3m x tm	300mm	
LEP III	Lieptospermum trinsrivium	Stender Tea-tree	dmx 1-des	300mm	1
LEUlan	Leucopogon lanceolatus	Cance-leaved beared heath	2m ic 1m	300mm	0
LIC rain	Licuata namaayi	Fan Palm	15m High	300mm	
LOMai	Lomette stivifoks	Wild Pareety	Om x 3m	300mm	. 0
MAC com	Macrozamia communis	Burrawang	2.0m x 2.0m	300mm	0
PER In	Persoonia linearis	Narrow Leaved Geeburg	Sm x 0.7m	300mm	
PULWI	Putersea vilous	Hairy Pos Bush	2m x 3m	300mm	0
TEL spe	Telopea speciosissima	Waratah	3m x 3m	300mm	1
XAN IIII.	Xanthombosa fatifolia	Grana True	2m x 1.5m	150mm	d
	301	0.	.00	200	0
SHADE TOLERANT SHRUBS, 6	GRASSES & GROUNDCOVER	rs .			
AGL red	Aglachema commutatum 'Red Varentine'	Chinese evergreen	0.6m x 0.60m	150mm	
CHL com	Chlorophytum comosum	Spidar Plant	0.6m s.0.25	150mm	1
DRA or	Draceens Infrascials	Mother in Laws Tongue	1.2m x 0.2m	300mm	8 3
MON del	Monstera deliciosa	Spitt-Leaf Philodendron	2.5m x 2m	300mm	
WON ade	Monatere edensonii	Swiss Chesse Plant	9m x 1m	300mm	8 3
EPI aur	Epipremnum aureum	Devils My	tex te	300mm	تال
ANT and	Anthurium andravanum	Flamingo Lily	0.6m k.0.4m	150mm	3
ASP eta	Aspidatra stator	Cast Iron Plant	1.2m x 1.5m	300mm	
CAL seb	Calathea zebrina	Zebra Plant	1m x 2m	300mm	
CAL mili	Calathea meksyana	Peacock Plant	0.8m x 0.8m	300mm	
SPA wel	Spathsphyllum welfail	Penca by	1.0m x 1.0m	300mm	
PIL pep	Plies peperomoides	Chinese Money Plant	0.3m k 0.3m	300mm	
PHI san	Philodendron xanadu	Philodendron	169 x 169	300mm	ĵ.
MC mus	Microsorum musfolium 'Crocodyllus'	Crocodile Fem	1.5m x 1.5m	300mm	
ZAM zam	Zamioculcas zamitoks	ZZ Planti	8.9m x 0.9m	300mm	

Tail Sedge

oporum parvifolium "Yareena" Yareena Creeping Bootsalia

Short Haired Plume Grass

Common Tussock Grass

Kangaroo Grass

Ivy-leaved Viglet

Soft Water Fern

False Bracken

Prickly Rasp Ferri

Carex appressa

Hope musceri

Pos labiliardient

Viola hederaces.

Doodia aspera

Calochisens dubin

hemeda avstraks

Dichelachne micranthe

,omendin longifolie "Nyella"

plenum australasicum



Issued under the Environmental Planning and Assessment Act 1979

0.10m x 0.9m

fm x 0.80m

 $0.5m \times 0.5m$

6.9m x 0.7m

1m x 0.5m

1m x 0.5m

0.15m x 1m

0.10m x 1m

1.2m x 1.2m

Ser x 1.5m

0.4m x 0.6m

2m x 1.5m

150mm

1200 2000

150mm

150mm

150mm

150mm

300mm

300mm

150mm

150mm 5

150mm 5


150mm 5

Signed: MF Approved Application No: SSD-9351535

Granted on the: 30 November 2021 Sheet No: 25 of 64

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Infrastructure

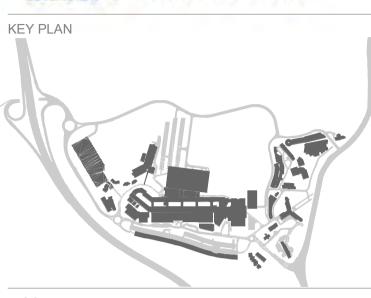

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GENERAL NOTES

- 1. THE PLAN MUST BE READ IN CONJUNCTION WITH THE SPECIFICATION WHICH ALSO CONTAINS THE SCHEDULE OF LANDSCAPE WORKS AND PLANT SCHEDULE.
- 1. ALL DRAWINGS ARE TO BE READ IN CONJUNCTION WITH THE ASSOCIATED DRAWINGS BY OTHER CONSULTANTS, e.g. ENGINEERS.
- 2. DO NOT SCALE FROM DRAWING PACKAGE, USE NOMINATED DIMENSIONS AND LEVELS
- 3. REFER TO THE TREE PROTECTION PLAN (AND POTENTIAL TREE ASSESSMENT REPORT) FOR DETAILS OF EXISTING TREES TO BE REMOVED, RETAINED OR TRANSPLANTED
- 5. THE CONTRACTOR MUST REFER ANY DISCREPANCIES TO THE SUPERINTENDENTS REPRESENTATIVE BEFORE PROCEEDING WITH WORKS
- 6. LOCATE AND PROTECT ALL UNDERGROUND SERVICES PRIOR TO EXCAVATION. MAKE GOOD ALL DAMAGE
- 7. THESE DRAWINGS ARE TO BE PRINTED IN COLOUR
- 8. FOR LEGEND REFER TO LEGEND SHEET LD_00-A10 XX-01
- 9. FOR DETAILED DESCRIPTION OF EACH LANDSAPE AREA REFER TO LANDSCAPE AREAS SCHEDULE
- 10. NUMBERS ON LANDSCAPE AREAS ARE REFERING TO THE LANDSACPE SPACE INDEX
- 11. IRRIGATION DESIGN TO BE DEVELOPED AND COORDINATED AT DESIGN DEVELOPMENT

	D	SSDA ISSUE	PM	PJ	09/08/202
	С	ECI TENDER	MK	PJ	16/07/202
ĺ	В	100% SCHEMATIC DESIGN	MK	PJ	08/04/202
ĺ	Α	100% DRAFT SD ISSUE	SP	PJ	26/03/202
•	REV	DESCRIPTION	DWN	CHK	DATE

PROJECT NAME & ADDRESS

JOHN HUNTER HEALTH & INNOVATION PRECINCT

Lookout Rd, New Lambton Heights, NSW 2305

PROJECT DIRECTOR: Approver

PLANTING SCHEDULE

STREETSCAPE

SCHEMATIC DESIGN

N.T.S

P0012689

PROJECT NO.

DRAWING NO. LD_C0-A10 XX-02



PLANTING ELEVATED GARDEN, SCHEDULE ARRIVAL, JHH INTERNAL STREET & ASB CAR PARK FACADE

PLANT CODE	BOTANICAL NAME	COMMON NAME	MATURE HEIGHT AND SPREAD	CONTAINER SIZE	PLANT: PER M
TREES	The second	Technology (
ALL tor	Africasuerina torulosa	Forest Oak	10m x 7m	100L	as show
TRO Insur	Tristaniopsis lauritia	Water Gum	15m x 6m	100L	as show
WAT 50:	Waterhouses floribunda	Weeping Lilly Pilly	10m x 8m	100L	as-show
ELA ret	Elaeocarpus reticulatus	Blueberry Ash	12m x 5m	1001	as show
EUC moil	Eucalyptus moluccana	Grey Box	15m x Sm	100L	as show
CUP ana	Cupaniopsis anacardoides	Tuckeroo	12m x 6m	100L	46 Show
BAN int	Banksis integrifolia	Coastal Banksia	15m x 6m	200L	as show
BRA jar	Brachychilon Jarilderie Red	Jerildene Red	9m x 7m	100L	as show
OLE sur	Olea europea	Common Ofive	7m x 4m	200L	as show
TATE and	2	Easthmanth Danner	Tree 4 fee	2001	as show
PYR 504	Pyrus 'Southworth Dencer' Legeratroems indicar's Literature	Southworth Dencer	7m x 4.5m	500F	46 SUOW
LAG nat	Netster	Natchez	fim x 6m	100L	as show
GSS-CALLED					900
SHRUBS					Si .
ACA mer	Acacia myrtifolia	Red-Sterrened Wattle	3m x 3.0m	300mm	0.15
ACA tur	Acacia terminaks	Sunstine Watte	3m x 2m	300mm	0.25
ACA uti	Acada ulicitolia	Prickly Moses	2m x 2m	300mm	0.25
ACM smi	Acmena ansitra	Common Lilly Pilly	Sm x 3m	300mm	0.15
SAN spi	Banksia spinulosa	Hairpin Banksia	3mx25m	300mm	0.2
CAL III	Call istemon 'Little John'	Bottlebrush	0.90m x 1.5m	300mm	0.75
DAV vii	Daviesia ulicitolia	Gorse Ster Pea	2m x 1m	300mm	S. 10
DOR esc	Coryenthes excelse	Gymea Lify	Am x 2m	300mm	0.75
	357		3	2 -117	0.75
EPA pui	Epacris pulchella	NSW Coral Heath	1.5m x fm	300mm	31
SRE GC	Grevilles 'Gold Cluster'	Gold Citater Grevilles	0.5m s fm	300mm	1
EP III	Leptospermum trinenium	Siender Tea-tree	6m x 1-8m	300mm	0.5
.EU ian	Leucopogon lanceclatus	Cance-leaved beared health	2m x 1m	300mm	- 1
JC ram	Licusta nemasyi	Fign. Patrn	15m High	300mm	3
OW sil	Lometia silafolia	Wild Parsely	6m k-3m	300mm	0.15
WAC com	Macrozamia communis	Burrawarg	2.0m x 2.0m	300mm	0.25
TER in	Persoonia literaria	Narrow Leaved Geeburg	3m x 0.7m	300mm	1.25
POLVI	Pultenasa viilosa	Hairy Pea Bush	2m k 3m	300mm	0.15
FEL ape	Teropea speciosissimo	Wantsh:	3m x 3m	300mm	0.2
GAN Let	Xanthorhosa tatifotia	Grass Tree	2m s 1.5m	150mm	0.15
*****		19099			0.12
GRASSES & GROUNCOVERS					9
Vil mi	Anigozanthos hybrid	Arrigozumbos Amber Valvet	0.50m x 0.40m	150mm	- 5
VVI NI	'Arritan' Velvet		II SUM X Q AUM	totamen	೦ ನ
Wi gdi	Anigocanthos hybrid "Evertesting Gold"	Anapozanthos Everteating Gold	0.50m x 0.40m	150mm	
AUS fu	Austrodenthonia fulva	Wallatry Green	0.10m ± 0.9m	150mm	. 3
3AU art	Baumee articulata	Jointed Twig Rush	2.5m x 2m	150mm	0.5
CAR app	Carrio appressia	Tall Sedge	1m x 0.80m	150mm	3
OHR apt	Chrysocephelum apiculwium	Yellow Buttons	0.3m x 0.5m	150mm	- 5
CYM mf	Cymbopogon refractus	Sarbed Wire Grass	444,63649	150mm	- 8
AND COLUMN TO THE REAL PROPERTY OF THE PERSON OF THE PERSO		9000 TO 6000 CO 6000	- CALL COMMO	7 7033100	-
DIA case	Dienelle ceerulee var. producte	Blue Flan Lity	1et x 2m	150mm	0.5
DIC mic	Dichelachne micrantha	Short Haired Plume Grass	*	150mm	- 5
ECH case	Echinopogon caespitosus	Hedgehog Grass	4	150mm	- 5
ENT str	Eminiana shicia	Wiry Paris:	0.50m x 0.30m	150mm	*
415 sca	Hibbertia scandene	Snake Vine	3m x 5m	150mm	0.5
MP cyl	Imperata cyfindrica	Bady grass	1.0m x 0.3m	150mm	5
SO nod	lacieges redonar	Knobby Club Rush	1m x 1m	150mm	. 3
UN sei:	Junicus usitatus	Tussock Rush	1.2m x 0.5m	150mm	(6)
.Rmus	Liriope muscari	Lity Turl	0.5m x 0.5m	150mm	- 5
OM lon:	Lomandra longifoka	Spiny-Headed Mat-Rush	1.2m x 1.0m	150mm	2
1050000 10000	Water to	AND TO STATE OF STATE OF	2 10-07-07	(C (1)-0)	0. (-)
VIVO per	Myoporum parvifolium "Yareena"	Yareeca Creeping Boobialia	0.10m x 1m	150mm	- 2
POAJab	Pos labiliardieli	Common Tussock Grass	1m × 0.5m	150mm	- 8
PRA pur	Prete purpurascens	Weiteroot	0.20m x 2m	150mm	1
THE nue	Themedis australia	Kangaroo Grass	1m x 0.5m	150mm	- 5
AO hed	Viola hederacea	Native Wolet	0.15m x 1m	150mm	- 6
ZIE smi	Zierra smithii subsp amithii	Sandity Joine	2m x 1m	300mm	- 2
	Andrew Constitution				
SENSORY PLANTING	#c 1	25			22
N.L. wich	Allum achoevroprasum	Chrysn	0.8m x.0.1m	150mm	10
U.O ver	Alce vera harbadensis	Alon	0.6m x 0.90m	150mm	- 3
RA pac	Brachyscome 'Pacific Reef'	Native Dality	0.2m x 0.3m	150mm	
Pi max	Briza maxima	Greater Quaking Grees	0.6m x 0.3m	150mm	
DAL off	Calendula officinalis	Pot Marigoid	0.6m x 0.6m	150mm	- 8
DOS atr		Chorocate coarses	0.75m x 0.45m	150mm	5
	Cosmos atrosanguineus	3.70 37.70 7.77	1999 THE RESERVE TO BE STORY OF THE STORY OF THE RESERVE TO BE STORY OF THE RESERVE TO BE STORY OF THE RESERVE TO BE STORY OF THE STORY	7 11(0)(10)(0)	1 22
EL is	Helichrysum balicum	Curry Plant	0.90m x 0.50m	150mm	- 5
40U cor	Houtsynia cordata 'Chameleon'	Chameleon Plant	0.30m k 0.30m	150mm	- 5
AV to	Lavandula angustifolia	Lavender	0.90m k 0.90m	150mm	- 3
MS all	Miscanthus digostachyus Nanus	Miscanthus	8	150mm	5
	Variegatus/		k .	U. 116 24 10	96
€L αi	Pelargonium crispum	Lemon Sounted Geranium		150mm	- 5
EN alo	Pennisetum alopecuroides	Fourtain Grass		150mm	- 5
HL90	Phromis fruticosa	Jenusalen Sage		150mm	. 5
NOS off	Rosmerinus officinalis	Rosemary		150mm	5
SAL arg	Solvia argentea	Silver Sage	12 1	150mm	- 5
STA byz	Stachys byzantina	Lamb's Ear's		150mm	5
AMPRIL 10	Mi		no .	11	
FERNS	- 0.	9/			0.5
ISP aus	Aspierium australasicum	Bird's Nest Fem	1.2m x 1.2m	300mm	. 1
SLE car	Blacknum cartilaginaum	Soft Water Fern	5.5m x 1.5m	300mm	0.75
200 asp	Doodin servers	Drickly Dann Earn	0. Am y Other	1500000	56

			MATURE	Superior	in markets
PLANT CODE	BOTANICAL NAME	COMMON NAME	HEIGHT AND SPREAD	CONTAINER SIZE	PER M
TREES ANG con	According contrib	Grooth Rushed Aresin	Ster v Hon	400L	
ANG to	Angophora costata Angophora floribunda	Smooth-Barked Apple Rough-Barked Apple	26m x 16m 26m x 20m	200L	as show
BAC at	Sackhousia citriodora	Lemon Scorded Myrtle	20m x 6m	400L	as shown
EUC glo	Eucalyptus glotoidea	White Stringybark	20m x 15m	200L	at shown
EUC pip	Eucelyptus piperita	Bydney Peppermint	20m x 15m	2001.	as shows
EUC mail	Eucslyptus meluocens	Grey Bax	75m x 5m	400L	45 shows
SYN gio	Syncarpia glornalitara	Turpentine	16m s day	200L	as shown
ALL for	Allocasuarina torutosa	Forest Owk	10m x 7m	200L	45 STOWN
TRI Imar	Trislamiopeis Isurina	Water Gurr	15m x Gm	500F	85-Show
CUP ana BAN int	Cupaniopsis anacardioides Sanksia integnifolis	Tuckeroo Coastal Banksia	12m x 5m	500F 500F	as shows
GRA jer	Brachychitan 'Jeniderie Red'	Jerilderie Red	9m x 7m	100L	as show
OLE tur	Otea europea	Common Olive	7m x 4m	200L	as show
PYR sou	Pyrus 'Southworth Dencer'	Southworth Dancer	7m.x 4.5m	200L	as show
LAG hat	Lagershoemia indica x L.fauriei Waterboy	Natchez:	film x 6m	100L	as shown
900000000					
SHRUBS	(V-11-11-11-11-11-11-11-11-11-11-11-11-11		,		
ACA myr	Acsicia myrtifolia	Red-Sterroed Watte	3m x 3.0m	300mm	0.3
ACA ter	Acadia terminata	Sunshine Wattle	3m x 2m	300mm	0.0
ACM smi	Acmenia emitté	Common Lifty Pilly	Sen x Sen	300mm	0.3
BAN spi CAL III	Banksis spirulosa Callaterres 3 title, kiter	Hairpin Bankata Bottlebourb	3m x 2.5m	300mm	0.3
DAY UI	Callistemon "Little John" Daviesia uliofolia	Bottlebrush Gorse Bitter Pen	0.90m x 1.5m 2m x 1m	300mm	- 1
DOR exc	Dorventhes excelsa	Gymea Lify	2m x 1m 4m x 2m	300mm	0.5
EPA pui	Epociis pulchello	NSW Coral Heath	1.5m x 1m	300mm	0.5
GRE GC	Grevillea 'Gold Cluster'	Gold Cluster Grevilles	0.3m x tm	300mm	3
LEP HI	Leptospermum trinervium	Siender Tea-trea	6m x 1-8m	300mm	-
LIC rain	Licoata ramsayi	Fan Palm	15m High	300mm	1
LOWISH	Lomatia silafolia	Wild Parsely	Hei x 3m	300mm	0.2
MAC com	Macrozamia communis	Burrawarg	2.0m s 2.0m	300mm	0.5
PER in	Persoonia Insuns	Nerrow Leaved Geebung	2m x 0.7m	300mm	-35
TEL apw	Теюрия ариссиваяти	Warshaft	3m x 3m	300mm	0.3
XAN let	Xanthombosa latifulia	Grass Tree	2m x 1-5m	150mm	0.0
GRASSES & GROUNCOVERS	Angozanthos Hybrid	1			e e
ANI vel	Amber Veherl Anigozanthos hybrid	Anigozanthos Anther Velvel Anigozanthos Everlasting	0.50m x 0.40m	150mm	33
ANI gal	Evertastico Gold*	Gott	0.50m k 0.40m	150mm	3
AUS Ni BAU art	Austrodenthonia felva Baumee articulata	Wallaby Grass	0.10m x 0.9m 2.5m x 2m	150mm	0.5
CAR app	Carex appressa	Jointed Twig Rush Tall Sedge	1m x 0.80m	150mm	1
CHR api	Chryspoophalum apiculatum	Yellow Buttons	0.3m x 0.5m	150mm	2
DIA con	Dienelle ceerulee ver. producte	Bue Flax Lify	Tet x.2m	150mm	0.5
ENT atr	Emplosiu atricta	Wiry Panic	0.50m x 0.50m	150mm	4
HB sca	Hibbertia scandens	Sneke Vine	3m x 5m	150mm	0.2
MP cyl	Imperate cylindrica	Mady grass	1.0m x 0.3m	150mm	*
SO nod	Jepiepie modoka	Knobby Club Rush	fm x 1m	150mm	4
UN unt	Juneus usitytus	Tussock Rush	1.3m x 0.5m	150mm	2
EP lat	Lepidosperma laterale	Variable Sword Sedge	1.0m x 1.0m	150mm	
LIR mos	Liriope muscari	Lify Tori	0.5m x 0.5m	150mm	2
LOM lon	Lorrandra longifolia	Spirry-Headed Mat-Rush	5.2m x 3.0m	150mm	135
MYO par	Myoporum parvifolium "Yareena"	Yareena Creeping Boobialia	0,10m ± 1m	150mm	1
POA No	Poatabiliardien	Common Tuskock Gress	1m x 0.5m	150mm	2
PRA pur	Pratia purpurascens	Whiteroot	0.20m x 2m	150mm	0.5
THE aus	Therede australia	Kangaroo Grass	1m x 0.5m	150mm	2
VIO hed ZIE sms	Viola hadersous Zieria smithi subap smithi	Ny-tenned Violet	0.15m x 1m 2m x 1m	- 150mm - 300mm	1
and and	zversa sveteni sučisp sredni	Slandity Johna	20 x 101	JAMIN	10 II
CCNCODA DI ANAMA					
SENSORY PLANTING	Manager 1997	es	CI participation		0 44
N.O. vec	Allium schoenoprasum Alce vera barbadensis	Chives. Alor	0.6m x 0.1m	150mm	10
N,O vec BRA par.	Brachyscome Pacific Reef	Notive Datey	0.2m x 0.3m	150mm	- 5
IRI max	Uniza massima	Greater Quaking Grees	0.6m x 0.3m	150mm	5
CALoff	Catendula officinalis	Pat Marigold	0.6m k 0.6m	150mm	- 5
008 atr	Coarros atrosanguneus	Chalpoate coarses	0.75m x 0.45m	150mm	- 6
4EX. On	Helichrysum talloum	Curry Plant	0.90m x 0.50m	150mm	
40U car	Houtleyria contata 'Chameleon'	Chameleon Plant	0.30m k 0.30m	150mm	
AV sp	Lavendula angustifolia	Lavender	0.90m x 0.90m	150mm	3
AB all	Miscanthus dégistachyus Yéanus Vanegatus	Miscarytyca		150mm	.6
EL on	Pierargonium oriiipum	Lemon Scantad Geranium	§	150mm	. 5
TEN altr	Pennisetum alopecumides	Fountain Grass		150mm	- 5
PHL fru	Phiomis hubicosa	Jerusalem Sage		150mm	- 5
ROS aff	Rosmerinus officendis	Howevery		150mm	5
SAL arg	Salvia argentiea	Silver Sage		150mm	
STA byz	Stachys byzantina	Lamtr's Ear's		150mm	
rrnue					ii.
FERNS	Ppersonal property and a second	Direct Marie Prince	4 Sec - 4 Sec	260	25 152
SP aus SLE cur	Aspienium australasium Blechnum cartilagineum	Bird's Nest Fem Soft Water Fem	1.5m x 1.5m	300mm	0.75
more falls.	secretary camedinaria.	esen semme cum	Frant & LDMI	300mm	4.72
OOG sep	Doodia aspera	Prickly Rasp Fem	0.4m x 0.6m	150mm	

PLANT CODE	BOTANICAL NAME	COMMON NAME	MATURE HEIGHT AND SPREAD	CONTAINER SIZE	PLANT PER M
SHADE TOLERANT SHRUBS,	GRASSES & GROUNDCOVER	IS			,
AGL red	Aglaonema commutatum Red Valentrei	Chinase evergreen	0.6m x 0.60m	150mm	-31
CHL com	Chlorophytum comosum	Spider Plant	0.6m x 0.25	150mm	1
DRA H	Draceens trifasciata	Mother in Laws Tongue	1.2m x 0.9m	300mm	
MON del	Monstera deliciosa	Split-Leaf Philodendron	2.5m x 2m	300mm	.01
MON ada	Monstera adensonii	Swiss Cheese Plant	9m x 1m	300mm	9 14
EPI aur	Epiproenum auteum	Devils My	1re x 1m	300mm	1
ANT and	Anthurium andraeanum	Flamingo Lily	0.6m x 0.4m	150mm	
ASP ela	Aspidistra elatior	Cast Iron Plant	1.2m x 1.5m	300mm	
CAL 200	Catalhea zebrine	Zebra Ptent	1erx 2m	300mm	3
CAL min	Calathea mekoyana	Peacock Plant	0.8m x 0.6m	300mm	. 1
SPA wwf	Spathquiytum walkali	Patien By	1.0m x 1.0m	300mm	- 13
PIL pap	PViea paparomioidas	Chinasa Morey Plant	0.3m x 0.3m	300mm	1
PHI san	Philodendron sanadu	Philodendron	1m x 1m	300mm	1
MC mus	Microsorum musifolium 'Cronndylium'	Grocodile Fern	1.5m x 1.5m	380mm	- 3
ZAM zam	Zamioculoss zamitoka	ZZ Plant	0.9m x 0.9m	300mm	

PLANT CODE	BOTANICAL NAME	COMMON NAME	MATURE HEIGHT AND SPREAD	CONTAINER SIZE	PLANT PER M
SHADE TOLERANT SHRUBS,		S			800
AGL red	Aglabretra commutatum Red. Valentine	Chinase evergreen	0.6m x 0.60m	150mm	- 3
CHL com	Chlorophytum comosum	Spider Plant	0.6m x 0.25	150mm	- 5
EPI aur	Epipremium aureum	Devils by	1m x 1m	300mm	- 4
ANT and	Anthurium andraeanum	Flamingo Uly	0.6m x 0.4m	150mm	- 19
CAL zeb	Calathea zebrina	Zobra Plant	1m (c2m)	300mm	-#
CALmak	Calahea mekoyana	Peacock Plant	0.8m x 0.6m	300mm	-4
SPA wai	Spathiphylium wallasi	Pleace bly	1.0m x 1.0m	300mm	4
PHL peop	Plies peperomicidae	Chinasa Money Plant	0.3m x 9.3m	300mm	- 4
ZAM zars	Zamioruácas zamiltoka	ZZ Plant	0.9m x 0.9m	300mm	- 4
GRASSES & GROUNDCOVERS					
AUS NI	Austrodanthonia fulva	Wallaby Grass.	0.10m x 0.9m	150mm	- 5
CAR apo	Carex appressa	Tall Sedge	tm x 0.60m	150mm	- 3
DNC mic	Dichelachne micrantha	Short Haired Plume Grass	3	150mm	. 5
LRmus	Liriope muscari	Lify Torf	0.5m x 0.5m	150mm	- 5
LOM rya	Lomendra longifolia 'Nyalla'	Spary-Headed Mat-Hush Nysita	0.9e+x 0.7m	150mm	- 5
MYO per	Myoporum parvifolium "Yareena"	Yareana Creeping Bootishs	0.10m x 1m	150mm	- 5
POAlidi	Pos Wolferden	Common Tipsacce Grana	5m x 0.5m	150mm	
THE says.	Thereople australia	Kangamo Grees	1m x 0.5m	150mm	5
VID heat	Viola hederaces	lvy-leaved Violet	0.15m x 1m.	150mm	. 5
CENCODY DI ANTINO					
SENSORY PLANTING	Allium schoenoprasum	Chives	0.6m x 0.1m	150mm	
ALO ver	Aice vera barbadensis	Aloe	0.6m x 0.90m	150mm	
BRA pac	Brachyscome 'Pacific Reef'	Native Daley	0.2m x 0.3m	150mm	- 5
BRI max	Briza maxima	Greater Duaking Grass	0.6m x 0.3m	150mm	- 6
CAL off	Catendula officinaria	Pot Mangold	0.6m x 0.6m	150mm	5
COS atr	Coarros airoxanguinaus	Chalcoste cosmos	0.75m x 0.45m	150mm	
HES, its.	Helichrynum folksum	Curry Plant	0.00m x 0.50m	150mm	
HOU car	Houttuynia cordata "Chameleon"	Chameleon Plant	0.30m x 0.30m	150mm	6.
LAV sp	Lavandula angustifolia	Lawender	0.90m x 0.90m	150mm	- 5
MSol	Miscanthus oligostactryus Nanus Variesatus	Misconthus		150mm	- 5
PEL at	Pelargovium orispum	Lemon Scented Geranium		150mm	- 10
PEN aro.	Pennisetum alopeocroides	Fountain Grass		150mm	- 8
PHL fru	Phiomis fruticose	Jerusalom Sage		150mm	- 5
ROS off	Rosmarinus officinalis.	Rosemary	1	150mm	5
SAL arg	Salvia argentea	Silver Sage		150mm	- 5
STA 552	Stachys byzantina	Lamb's Ear's	1	150mm	- 6


AREA-79m2							
PLANT CODE	BOTANICAL NAME	COMMON NAME	MATURE HEIGHT AND SPREAD	CONTAINER SIZE	PLANTS PER M2		
CLIMBERS					()		
Bit sce	Billardiera scandens-	Apple Berry	f.5m x.3m	150mm	0.3		
EUS lat	Eustrephus (atifolius	Wonibal Berry	Sim x Sm	150mm	0.1		
HAR wn	Hardenbergia violacea	Purple Coral Pea	1.5m x 1.5m	150mm	0.0		
PAN jas	Pandorea jasminoides 'Lady Cl/	Lady Di Bower of Beauty	0.1m x 2m	150mm	0.5		
PAR tri	Parthenosissus tricuspidata	Boston My	9-15m tall	150mm	.7		
PYR ven	Pyrostegia venusta	Orange Trumpet	Sec x 1m	150mm	- 1		
TRA jas	Trachelospermum jaaminoides	Stor Jawrine	3m x 1-2m	150mm	2		



Issued under the Environmental Planning and Assessment Act 1979


Approved Application No: SSD-9351535 Signed: MF

Granted on the: 30 November 2021 Sheet No: 26 of 64

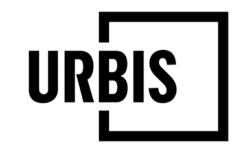

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Health Infrastructure

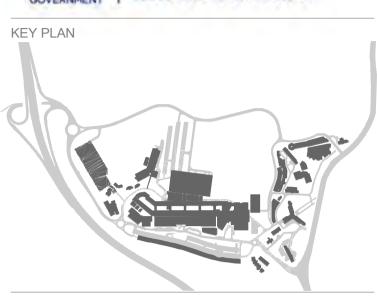

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GENERAL NOTES

- 1. THE PLAN MUST BE READ IN CONJUNCTION WITH THE SPECIFICATION WHICH ALSO CONTAINS THE SCHEDULE OF LANDSCAPE WORKS AND PLANT SCHEDULE.
- 1. ALL DRAWINGS ARE TO BE READ IN CONJUNCTION WITH THE ASSOCIATED DRAWINGS BY OTHER CONSULTANTS, e.g. ENGINEERS.
- 2. DO NOT SCALE FROM DRAWING PACKAGE, USE NOMINATED DIMENSIONS AND LEVELS
- 3. REFER TO THE TREE PROTECTION PLAN (AND POTENTIAL TREE ASSESSMENT REPORT) FOR DETAILS OF EXISTING TREES TO BE REMOVED, RETAINED OR TRANSPLANTED
- TO THE SUPERINTENDENTS REPRESENTATIVE BEFORE PROCEEDING WITH WORKS

5. THE CONTRACTOR MUST REFER ANY DISCREPANCIES

- 6. LOCATE AND PROTECT ALL UNDERGROUND SERVICES PRIOR TO EXCAVATION. MAKE GOOD ALL DAMAGE
- 7. THESE DRAWINGS ARE TO BE PRINTED IN COLOUR
- 8. FOR LEGEND REFER TO LEGEND SHEET LD_00-A10 XX-01
- 9. FOR DETAILED DESCRIPTION OF EACH LANDSAPE AREA REFER TO LANDSCAPE AREAS SCHEDULE
- 10. NUMBERS ON LANDSCAPE AREAS ARE REFERING TO THE LANDSACPE SPACE INDEX
- 11. IRRIGATION DESIGN TO BE DEVELOPED AND COORDINATED AT DESIGN DEVELOPMENT

B 100% SSDA ISSUE A 100% SSDA ISSUE REV DESCRIPTION DWN CHK DATE

PROJECT NAME & ADDRESS JOHN HUNTER HEALTH & INNOVATION PRECINCT

Lookout Rd, New Lambton Heights, NSW 2305

PROJECT DIRECTOR: Approver

PLANTING SCHEDULE

ARRIVAL & ROOFTOPS PROJECT NO.

SSDA SCALE N.T.S P0012689

DRAWING NO.

LD_C0-A10 XX-03

REVISION

PLANTING SCHEDULE ASB COURTYARDS

PLANT CODE	BOTANICAL NAME	COMMON NAME	MATURE HEIGHT AND SPREAD	CONTAINER SIZE	PLANTS PER M2
SHADE TOLERANT SPECIES LEVEL 00 COURTYARD- 60-70 LEVEL 01 COURTYARD- 50%	0%	-t.			
LEVEL 04 COURTYARD- 0%					
TREES	Listania manaka	1	100	444	
V.S. tot Fill tour	Alioceruanna torulosa Tristaniopsis laurina	Forest Colk Water Gum	10m e 7m 15m x 6m	100L	as shown
VAT to	Waterhouses floributida	Weeping Lilly Pilly	10m x 8m	100L	as above
LA reti	Elaeocarpus reficulatus	Busterry Ash	12m x 5m	100L	as shows
UC moi	Eucalyptus moluccana	Grey Box	15m x 5m	100L	as shown
NIP and NA 100	Cyamopsis anacardioides Cyamos cooperi	Tuckeroo Lacy Tree Fern	12m x 5m	100L	as shown
SAN int	Banksia Integnifolia	Coestal Bartoia	15m x 6m	200L	As shown
RA jer	Brachychilon Janktone Red	Jerislana Radi	9m x 7m	100L	as shown
X.E eur	Otes europeis	Common Ofive	7m x 4m	200L	as shown
YR sou	Pyrus 'Southworth Dencer' Laperstroems indica x Lifeuriei	Southworth Dancer	7m x 4.5m	200L	se shows
AG nat	'Natures'	Natcher	Bri x 0m	100L	as shown
SPOTTED GUM - GREY IRONB	ADK ODEN ENDEST - SHOIL	RC			
CAUI	Acada ulcibia	Prickly Moses	2m x 2m	300mm	0.5
SAN spi	Banksia spinulosa	Harpin Banksia	3m x 2.5m	300mm	0.5
SPE obi	Breynia oblongitolia	Coffee Bush	3m×3m	300mm	0.3
DAV uli	Daviesia ulcifolia	Gorse Bitter Pea	2m k 1m	300mm	1
DOD tri	Oodonaee triquetre Epazris pulchella	KSW Cond Heath	3m x 2m 1.5m x 1m	300mm 300mm	0.5
WAC com	Macrozzmia communis	Burrowarg	2.0m x 2.0m	150mm	0.5
UL suc	Pateness suchis	Large-Rower Bush-pea	1.5m x 2m	300mm	0.5
SMOOTH-BARKED APPLE - R	Acida luminata	Sunstrine Wattle	3m x 2m	300mm	0 22118
ACA uli	Acada ulidifolis	Prickly Moses	2m x 2m	300mm	0.5
SION (g):	Banksia spinutosa.	Hairpis Barksia	3m x 2.5m	300mm	0.5
EP tri	Explosipermum trinervium	Stander Tea-tree	6m x 1-6m	300mm	1
OM sil	Lometia silaitolia	Wild Parsely	6m x 3m	300mm	0.3
ER lev	Persoonia levis Persoonia linearte	Broad-Leaved Geebung Namow Leaved Geebung	3m x 0.7m	300mm	
ULeur	Pullenaea euchila	Large-flower Bush-sea	1.5m x 2m	300mm	0.6
ETjun	Tetrothece junces	Brack-eyed Susan	0.5m x 0.3m	300mm	4
SMOOTH BARKED APPLE - S			_		
VCA myr SAN sqsi	Acadia myrtifolia Banksia apinulosa	Red-Stormed Wattle Hairpin Stankata	3m x 3.9m 2m x 2.5m	300mm 300mm	0.15
PRE ohl	Breynia oblongifolia	Coffee Bush	3m x 3m	300mm	0.25
DAV ult	Daviesia ultofolia	Gorse Bitter Pea	2m x 1m	300mm	0.15
000 tri	Dodonies triquetra	Large-Leef Hop Bush	3m x 2m	300mm	0.2
.EP pot .EU lwn	Leptospermum polygalitoitum Leucopogon lanceolutus	Lemon Scented Tea Tree Lance-leaved beared heath	3m k 2m 2m x 1m	300mm 300mm	0.75
CANTIN	Xanthomboss latifolia	Grass Tree	2m x 1.5m	150mm	0.25
ZIE smi	Zioria smithii subsp smithii	Sandity zieria	2m x 1m	300mm	3
	3/4	th.	85		
ENDEMIC SHRUBS	Ö	-			
NCA myr	Acada myttfolia Acada larminalia	Red-Stemmed Wattle Sunshma Wattle	3m x 3.0m	300mm 300mm	0.3
VCM smi	Acrena smithii	Common Lifty Pilly	5m x 3m	300mm	0.3
DALR	Callistemon 'Little John'	Botlebrush	0.90m x 1.5m	300mm	0.0
DOPE exc	Doryanthus excelus	Gyrrau Lify	Am x 2m	300mm	0.5
SPOTTED GUM - GREY IRONB	ADV ODEN ENDEST - CDAS	CEC & COUINCOVEDO			01 0
SL sen	Sitardiana scandena	Apple-barry	1.5m s 3m	150mm	0.3
NT str	Entolwsia stricta	Wiry Pares	0.50m x 0.30m	150mm	4
MP cyl	Imperata cylindrica	Blady grass	1.0m x 0.3m	150mm	4
OM lon	Lepidosperrei laterate Lorsandra longilota	Variable Sword Sedge Spiry-Headed Mat-Rush	1.0m x 1.0m	150mm	+
OM muf	Lomendra multiflora subsp.	Many Flowered Mat-Rush	0.5m x 0.5m	150mm	2
AC st	Microlaena stipoides	Weeping Rice Grass	0.30m x 0.50m	150mm	2
Pi ma	Ericelamon australasius	Was Flower	2m x 1m	300em	1
RE GC	Grevillea 'Gold Chuster'	Gold Cluster Grevitea	0.3m x 1m	300mm	1
EP pot EP tri	Leptospermum polygalifolium Leptospermum timeriium	Lernon Scented Tea Tree Standar Tea-tree	3m x 2m 6m x 1-6m	300mm	0.5
EU len	Leucopagori lamosolatus	Lance-leaved beared heath	2m x 1m	300mm	1
/C ram	Licuala ramsayi	Fan Pakri	15m High	300mm	-1
OM sil	Lomatia stialfolia	Wild Parsely	fim x 3m	300mm	0.3
ER lav	Persoonia levis Persoonia linearis	Broad-Leaved Geebung Narrow Leaved Geebung	3m x 1m 3m x 0.7m	300mm 300mm	3
UL WI	Puterwee vilose	Heiry Pea Brah	2m x 5m	300mm	0.3
Til. spe	Telopes speciosissims	Warnteh	3m x 3m	300mm	0.3
ET jun	Tetrathoce juncee	Black-dyed Susan	0.5m x 0.3m	300mm	
ON lat	Xanthorrhoes latifolia	Grass Tree	2m x 1-5m	150mm	0.0
SMOOTH-BARKED APPLE - R	ED BLOODWOOD OPEN FOR	EST - GRASSES & GRO	UNCOVERS		
INT #	Erriciosia stricta	Wiry Paris	0.50m x 0.30m	150mm	4
MP cyl	Imperata cylinthica	Blady grass	1.0m x 0.3m	150mm	4
OM ob/	Comendra oblique	Twinled Matrush	0.50m x 0.50m	150mm	2
THE aus	Thomada australia	Kangaroo Grass	1m x 0.5m	150mm	2
TE-SE	Plendum esculentum	Bracken Fern	2ex x 1.2m	150mm	1 2
SMOOTH BARKED APPLE - SY	DNEY PEPPERMINT -TURP	ENTINE FOREST GRAS	SES & GROUN	COVERS	
	The same of the same of the same				0.5
	Dienelle zeerulee ver. producte	Stue Flux Lity	1m x 2m	150mm	C. Made
DIA com DIC rep	Dienelle caerulee ver, producte Dichondra repene	Stue Flax Lify Kidney Weed	0.15m x 1.8m	150mm	0.5

1.0m x 0.5m

0.38m x 0.55mv

0.20m x.2m

0.15m x.1m

150mm

150mm

150mm

Blady grass.

Weeping Rice Grass

mparata cylindrica

ENDEMIC GRASSES 8					
ANI vei	Angozanthos hybrid 'Amber Velver'	Anigozanthos Amber Velvet	0.50m x 0.40m	150mm	- 34
ANI gol	Anigozanthos hybrid 'Evertasting Gold'	Anigozanthoe Evertaiding Gold	0.50m x 0.40m	150mm	- 14
AUSTV	Austrodanthonia fulva	Wallaby Grass.	0.10m ± 0.9m	150mm	4
BAU art	Baumea articulata	Jointed Twig Rush	2.5m s 2m	150mm	1
CAR app	Саткх эрдгиная	Tall Sedge	1m x 9.80m	150mm	0.5
CHR api	Chrysocephalum apiculatum	Yellow Buttons	0.3m k 0.5m	150mm	
CYM ref.	Cymbopogon refractus:	Barbed Wire Grass	1m x 05m	150mm	- 3
DIA cae	Dianella caerulea var. producta	Blue Flax Lify	fm x 2m	150mm	
DIC mic	Dichelachne micrantha	Short Haired Plume Grase	0.5m x 0.2m	150mm	- 5
ECH cas	Extenapagon caespitasus	Hedgehog Gress	0.3m x 0.2m	150mm	. 5
HIB sca	Hibbertia scandens:	Steke Vine	3m x 5m	150mm	0.2
ISO nost	Isolepis nodosa	Knobby Club Rush	Set ic 1m	150mm	- 1
AJN sai	Junicus settetus	Turnock Rush	1.2m x 0.5m	150mm	3
LIRmus	Liriope muscari	Lify Turf	0.5m x 0.5m	150mm	1
MYO per	Myaporum parvifolium "Yareena"	Yareena Creeping Boobialia	0.10m x 1m	150 rym	2
POA NO	Pos labiliardiell	Common Tussock Grass	1m x 0.5m	150mm	-1
PRA pur	Profits purpuroscens	Whitergot	0.20m x 2m	150mm	. 1
THE aus	Themeda australis	Kangaroo Grass	tm x 0.5m	150mm	- 3
VIO bed	Viola haderacea	lvy-leaved Violet	0.15m x 1m	150mm	- 3
ZIE emi	Zieria svetki subap sretkii	Sandity zieria	2m x 1m	300mm	4
	- 1 1 1 1 1 1 1 1 1 1 1 1 1 1 1 1 1 1 1	View 100-141-1			
FERNS					
ASP aux	Asplement australasicum	Birts's Next Ferri	1.2m x 1.2m	300mm	4
BLE car	Blechnum cartilagineum	Boft Water Fern	1.5e x 1.5m	300mm	0.75
000 asp	Doodia ascena	Prickly Resp Fern	0.4m x 0.6m	150mm	. 1
CAL dub	Calochiaena dubia	False Bracken	2m x 1.5m	300mm	0.75
MANAGEMENT AND LINES AND ADDRESS OF THE PARTY OF THE PART	322	N-	000 000		300
SENSORY PLANTING	i	W	300 90		200
ALLisch	Allium achoenoprasum	Chryse	0.6m x 0.1m	150mm	- 5
ALO vec	Alce vera borbadensis	Aloe:	0.6m x 0.90m	150mm	3 3
BRA pac	Brachyscome Pacific Reef	Native Dakey	0.2m x 0.3m	150mm	- 3
BRI max	Briza mesima	Greater Quaking Grees	0.6m x 0.3m	150mm	
CAL off	Calendula officinalis	Pot Martgold	0.6m x 0.6m	150mm	2
COS altr	Coarros atrosanguineos	Characate coersos	0.75m x 0.45m	150mm	3
HEL its	Helichrysum falktum	Gurry Plant	0.90m x 0.50m	150mm	- 2
HOU car	Houttuynia cordata "Chameleon"	Chameleon Plant	0.36m x 0.30m	150mm	4
LAV sp	Lavandula angustifolia	Lavender	0.90m x 0.90m	150mm	-31
MIS-oil	Miscanthus oligostadnyus Narus Variegetus'	Miscanthus	1.5m x tm	150mm	5
	Company and a second	a company and a second	00-00-	460	10 S

puntain Grass

Silver Sage

omb's Ears

Rosmarinus officinalis

Salvia argentea .

rusarum Sage

1.5m x 5m

non is tim

150mm

150mm

2.4m x 1.2m

0.9m x 0.6m




Issued under the Environmental Planning and Assessment Act 1979

Approved Application No: SSD-9351535

Signed: MF

Granted on the: 30 November 2021

Sheet No: 27 of 64

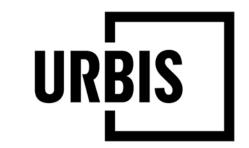

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 B
 100% SSDA ISSUE
 MK
 PJ
 13/05/20

 A
 100% SSDA ISSUE
 MK
 PJ
 23/04/20

 REV
 DESCRIPTION
 DWN
 CHK
 DATE

PROJECT NAME & ADDRESS

JOHN HUNTER HEALTH & INNOVATION PRECINCT

Lookout Rd, New Lambton Heights, NSW 2305

PROJECT DIRECTOR: Approver

PLANTING SCHEDULE

COURTYARDS & INTERNAL

ISSUE PROJECT NO

SSDA SCALE N.T.S P0012689

REVISION

LD_C0-A10-XX-04

В




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Granted on the: 30 November 2021

Sheet No: 28 of 64

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D 100% SCHEMATIC DESIGN PM PJ 09/08/2021 MK PJ 16/07/2021 MK PJ 08/04/2021 C 100% SCHEMATIC DESIG C 100% DRAFT SD ISSUE B 75% SD ISSUE A 50% SD ISSUE SP PJ 26/03/2021 MK PJ 29/01/2021 MK PJ 14/12/2020 REV DESCRIPTION DWN CHK DATE

PROJECT NAME & ADDRESS JOHN HUNTER HEALTH & INNOVATION PRECINCT

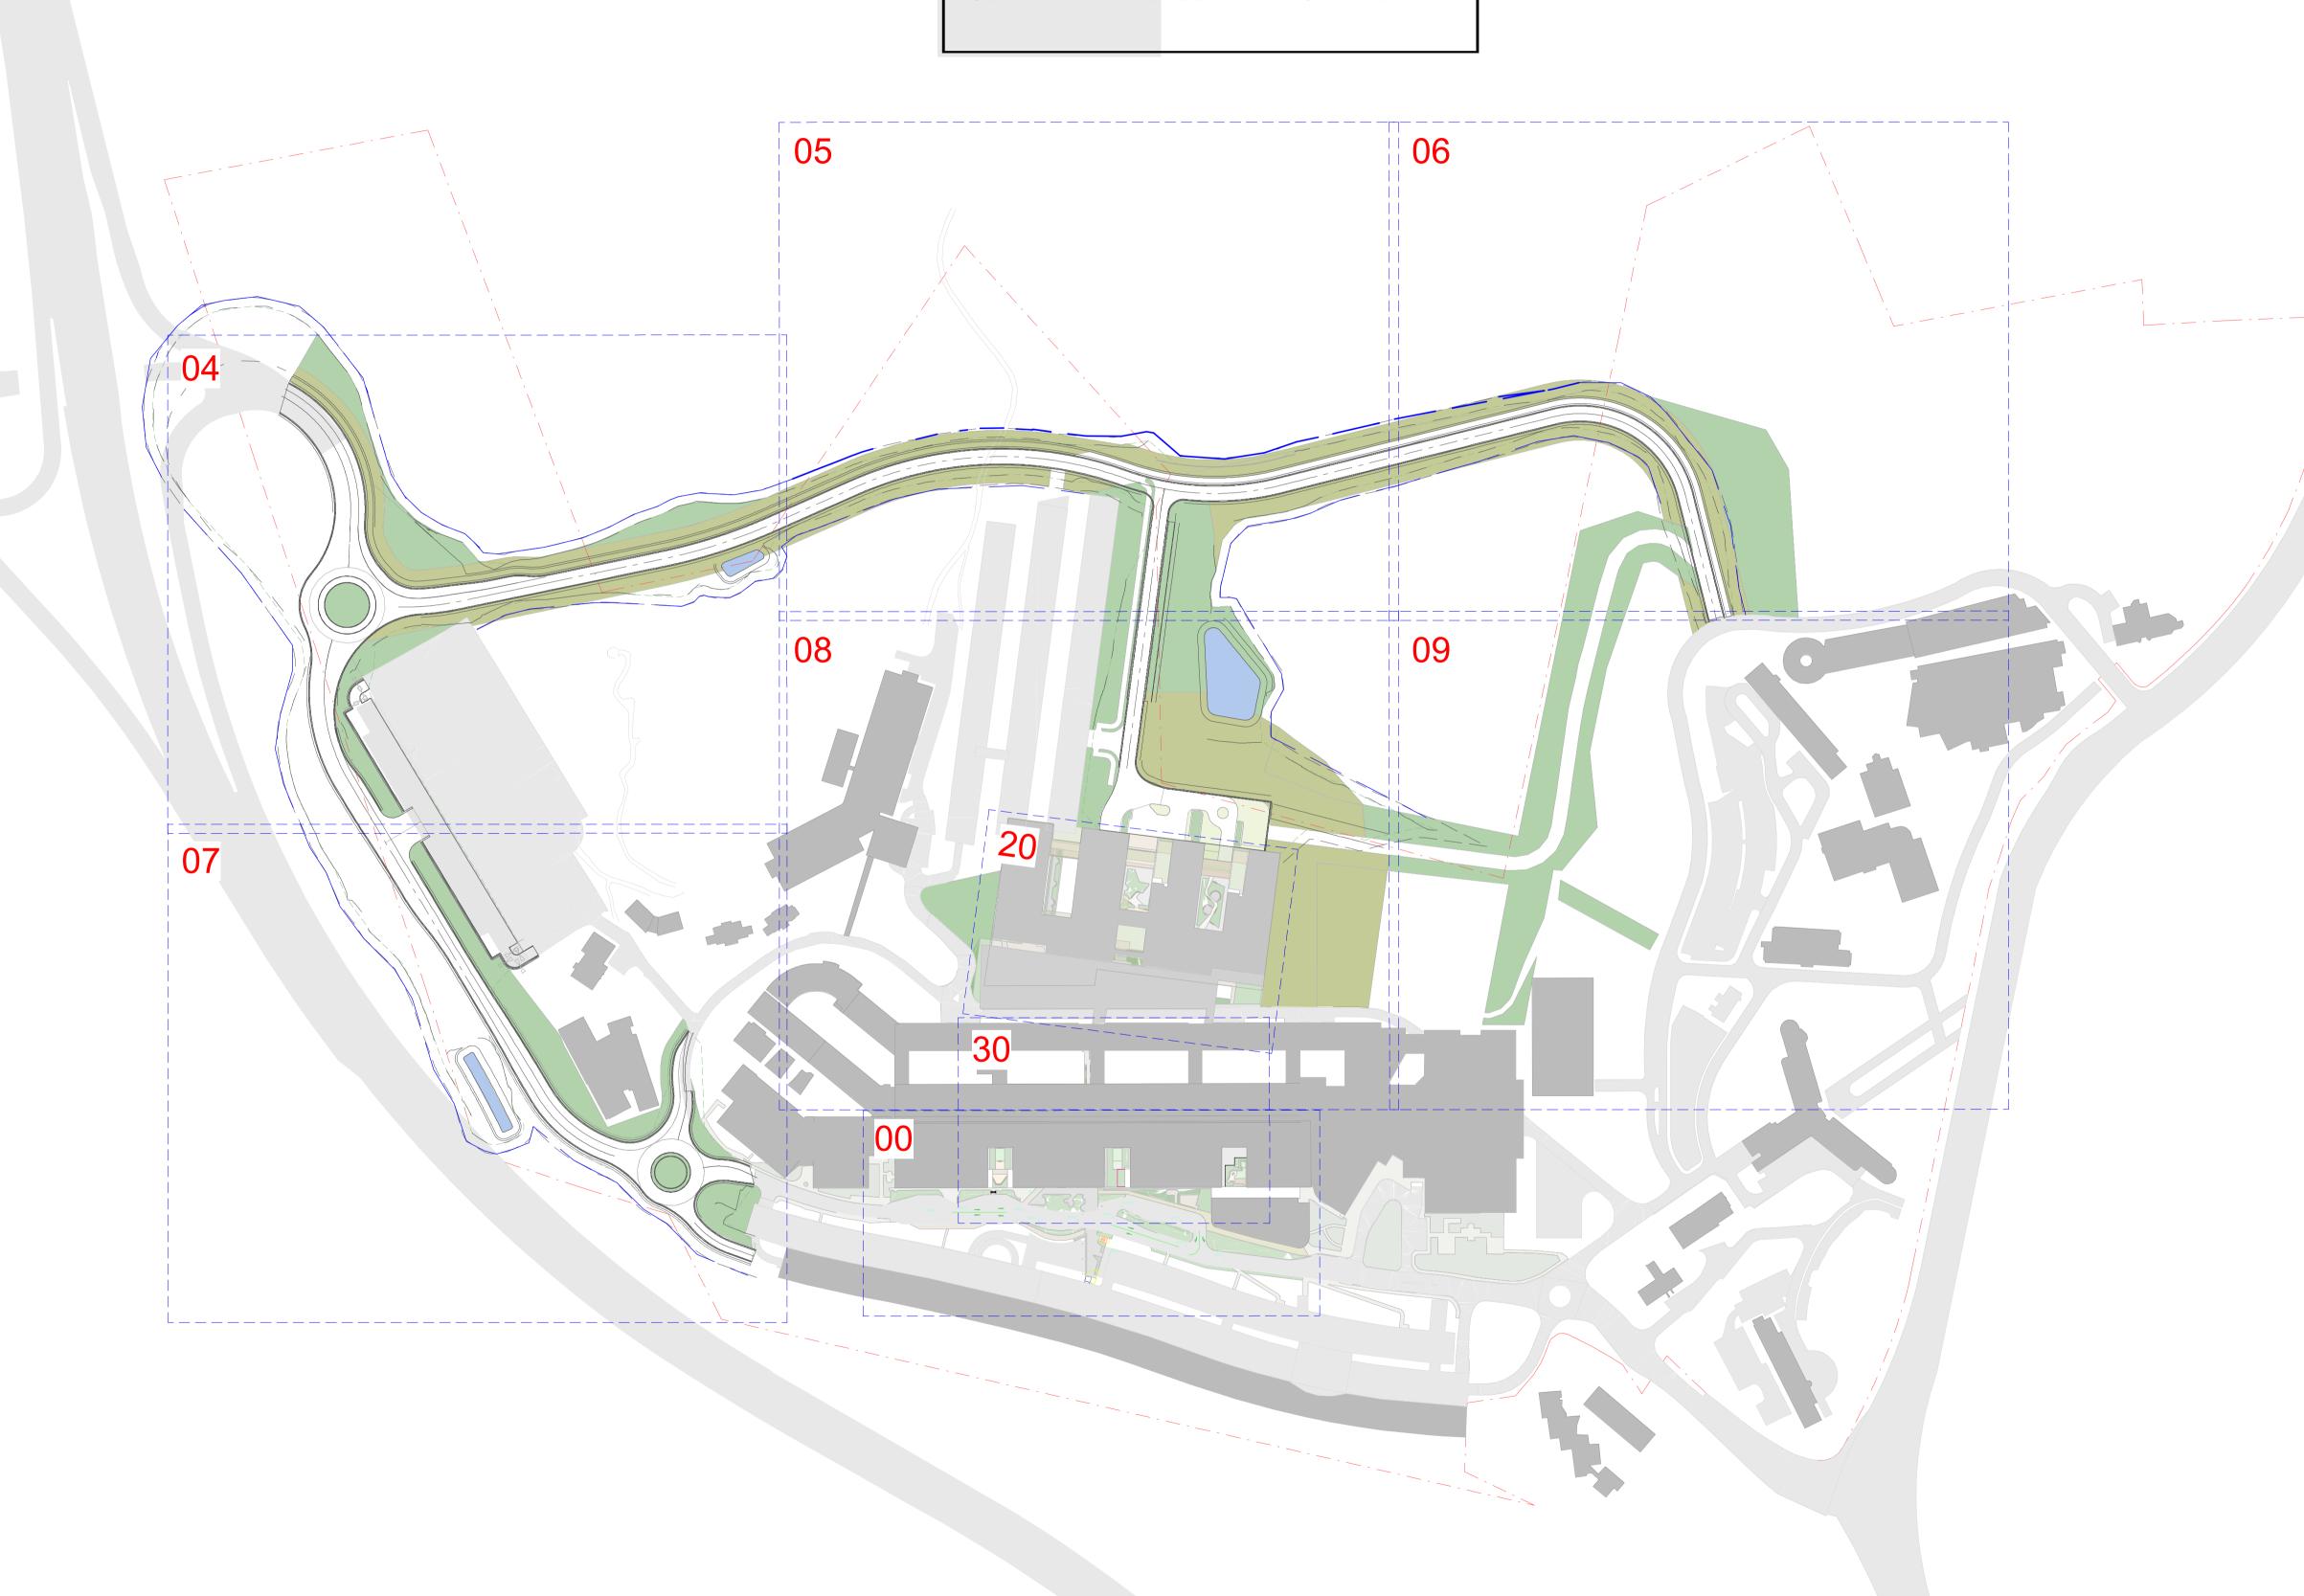Lookout Rd, New Lambton Heights, NSW 2305

PROJECT DIRECTOR:

DRAWING TITLE SHEET SPLIT SITE RELATED

PROJECT NO.

SSDA SCALE

1 : 2000 @A1


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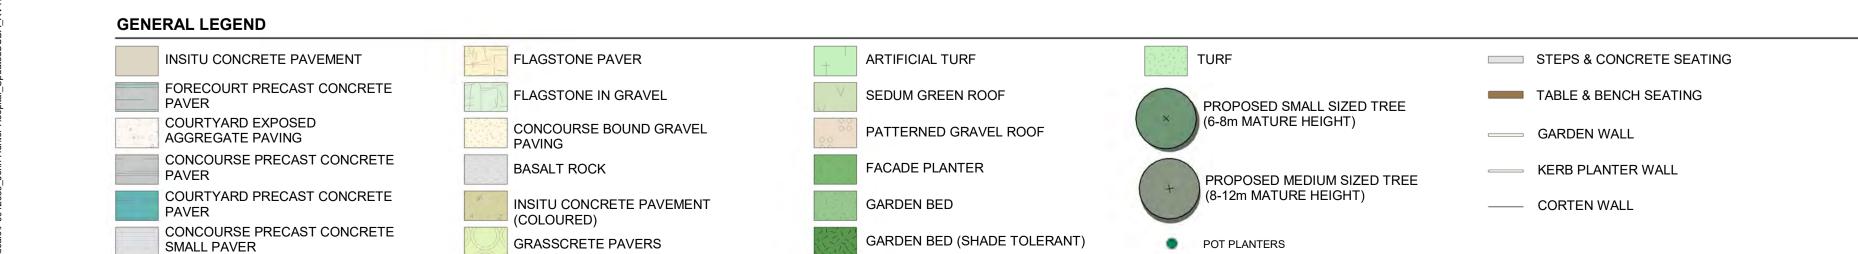







Approved Application No: SSD-9351535 Signed: MF

Granted on the: 30 November 2021 Sheet No: 29 of 64

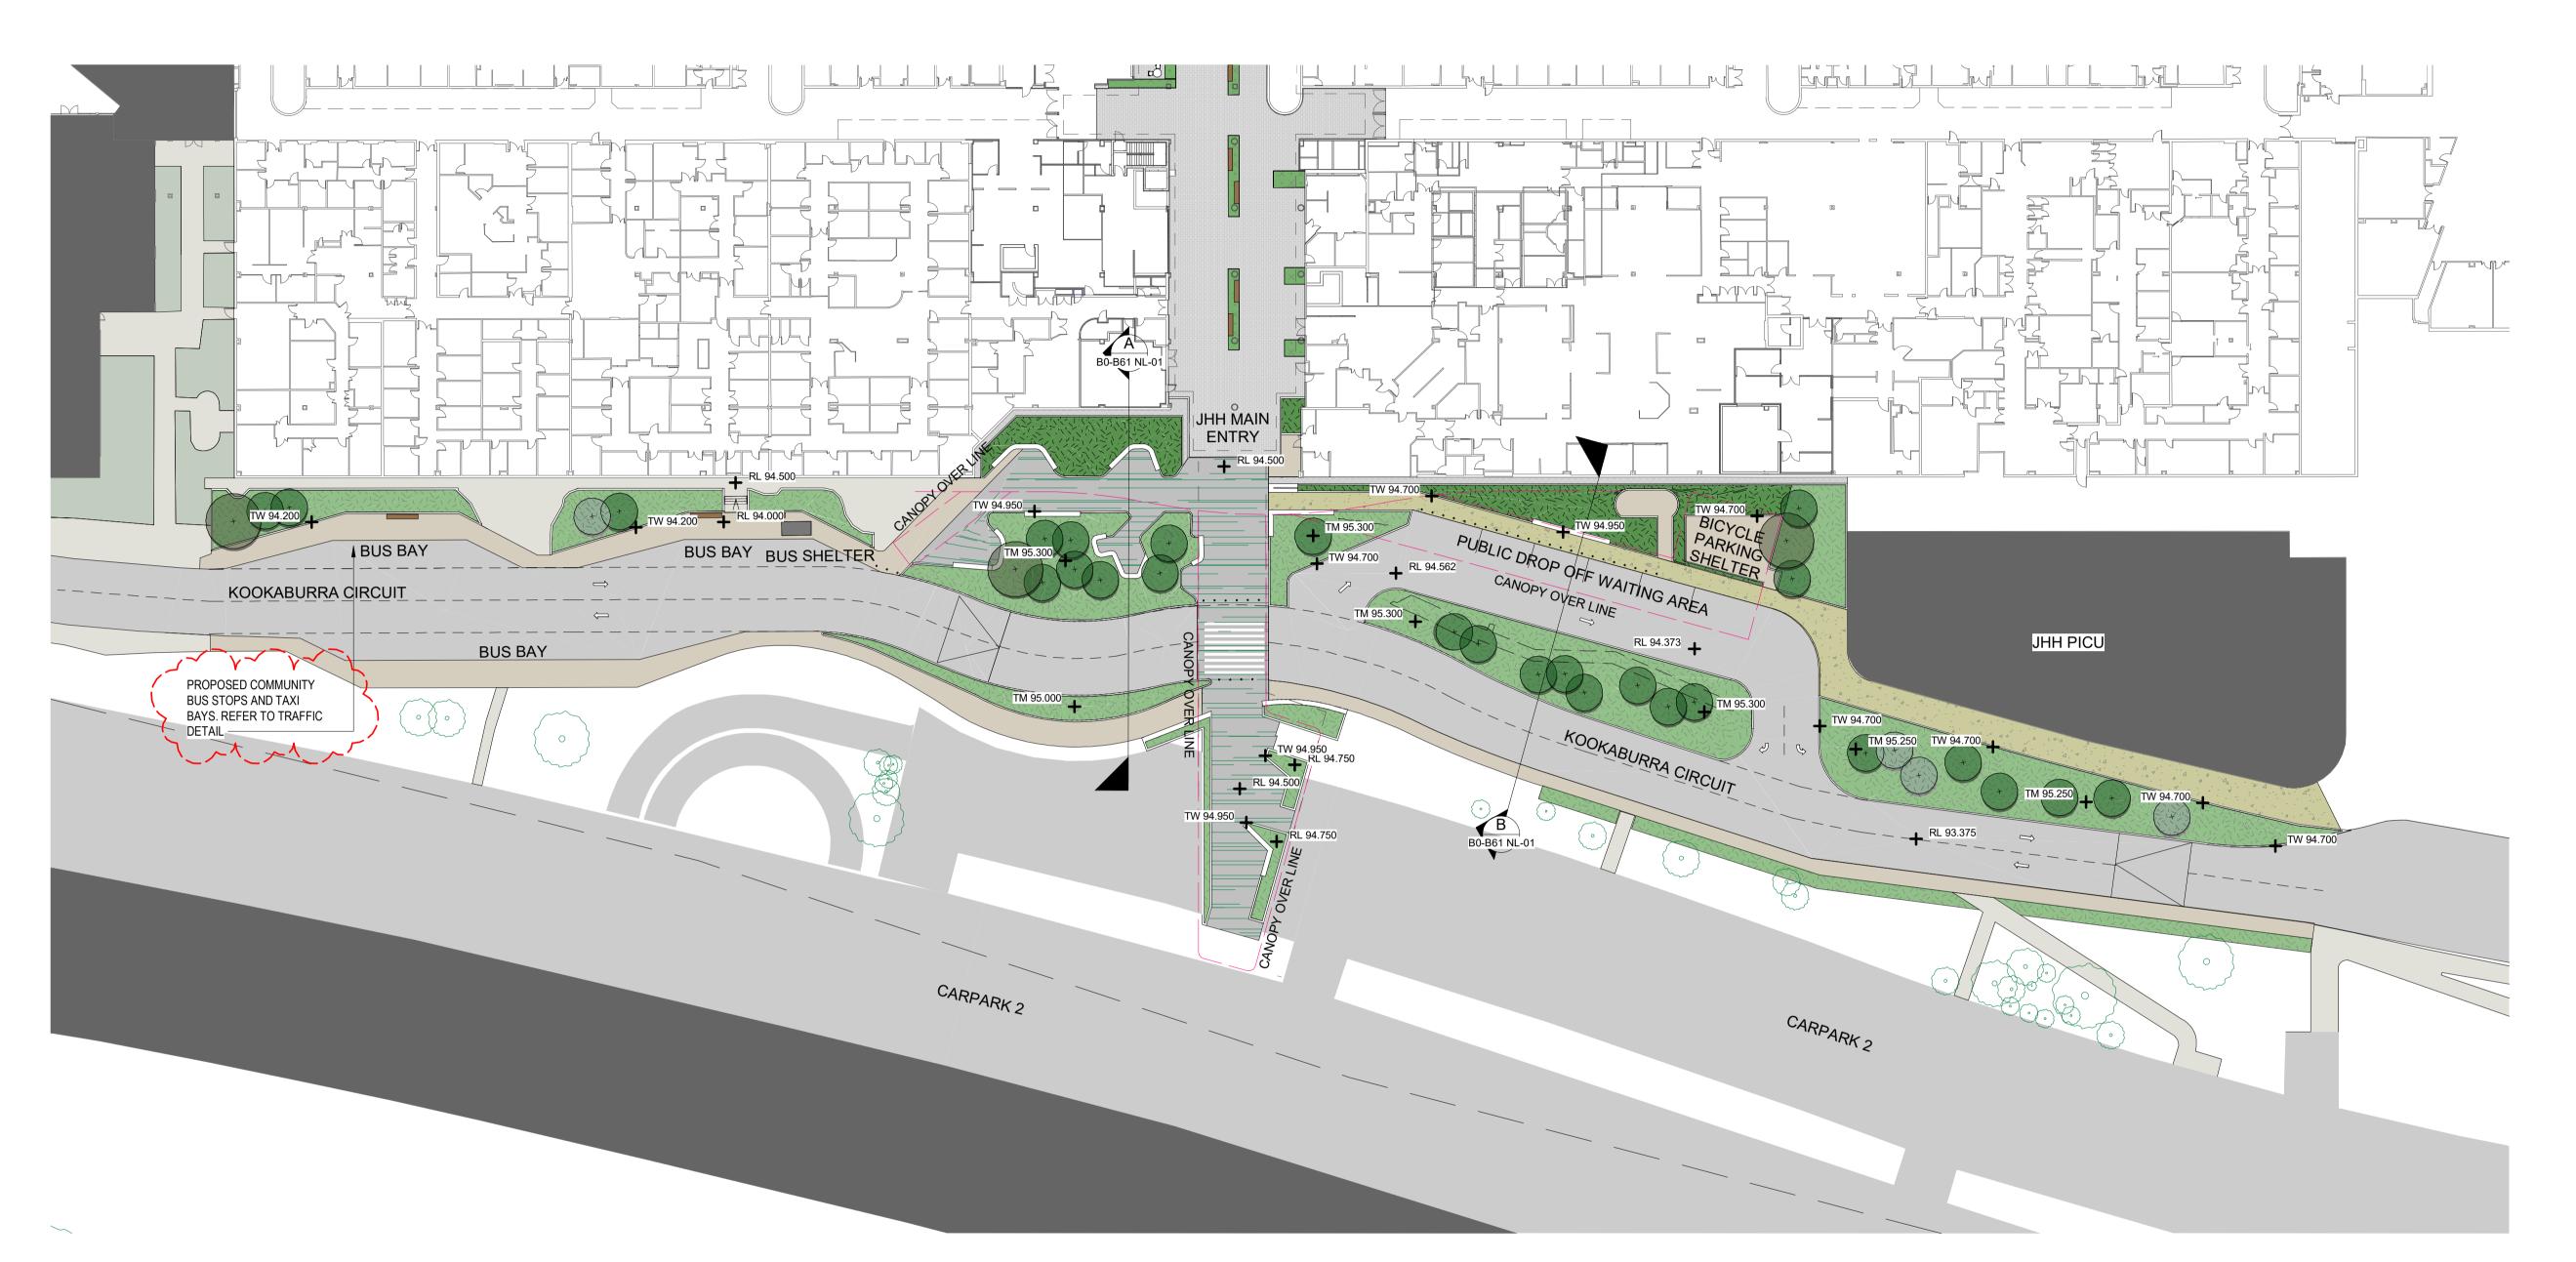

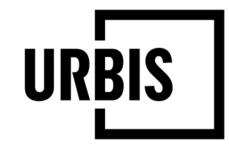

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D	SSDA ISSUE	PM	PJ	09/08/202
С	ECI TENDER	MK	PJ	16/07/202
В	100% SCHEMATIC DESIGN	MK	PJ	08/04/202
Α	100% DRAFT SD ISSUE	SP	PJ	26/03/202
REV	DESCRIPTION	DWN	CHK	DATE

PROJECT NAME & ADDRESS

JOHN HUNTER HEALTH & INNOVATION PRECINCT

Lookout Rd, New Lambton Heights, NSW 2305

PROJECT DIRECTOR:

JHH ARRIVAL FORECOURT

PROJECT NO. ISSUE

SSDA SCALE

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P0012689

REVISION

DRAWING NO. LD_C0-B20 NL-00





Signed: MF Approved Application No: SSD-9351535

Granted on the: 30 November 2021

Sheet No: 30 of 64





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PROJECT NAME & ADDRESS

JOHN HUNTER HEALTH & INNOVATION PRECINCT

Lookout Rd, New Lambton Heights, NSW 2305

PROJECT DIRECTOR:

OVERALL ZONAL PLAN

PROJECT NO. ISSUE

SSDA SCALE


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DRAWING NO.

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REV	DESCRIPTION	DWN	CHK	DATE

REVIDESCRIPTION

PROJECT NAME & ADDRESS

JOHN HUNTER HEALTH & INNOVATION PRECINCT

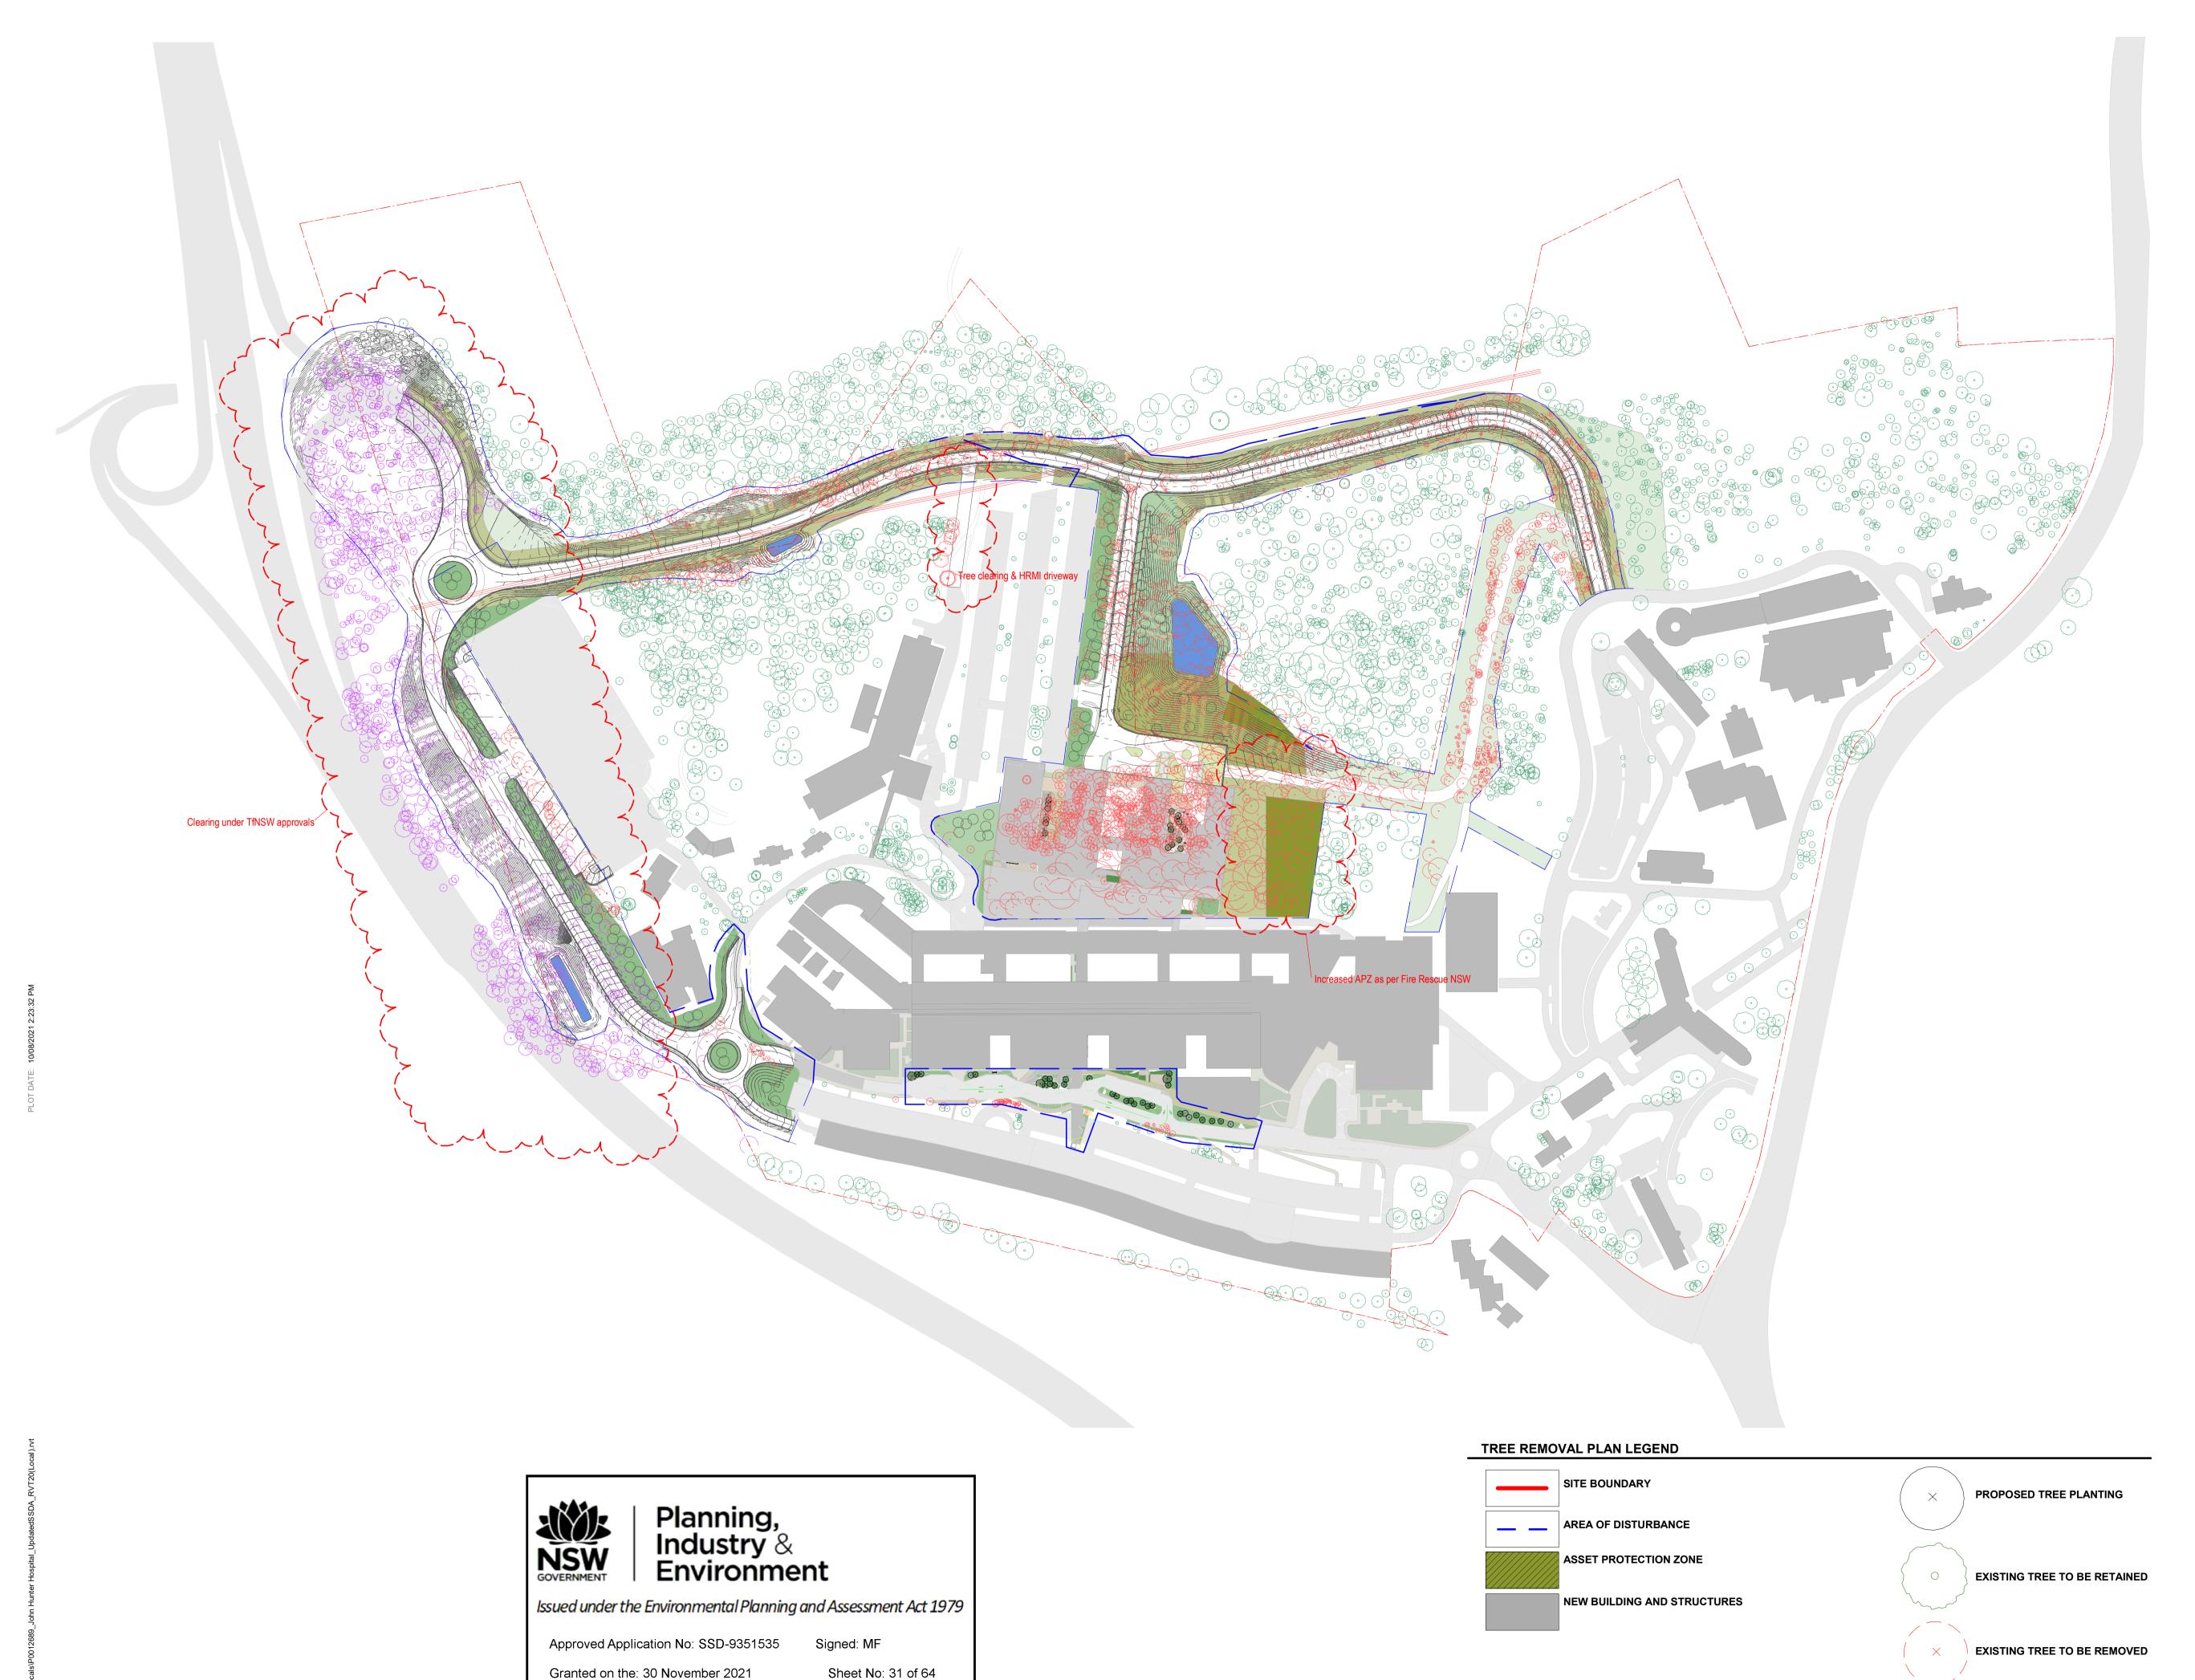Lookout Rd, New Lambton Heights, NSW 2305

PROJECT DIRECTOR: Approver

DRAWING TITLE

TREE REMOVAL PLAN

SSDA

PROJECT NO.

SCALE
As indicated @A1


MATURE TREE SIZE WITHIN APZ



P0012689


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PROJECT NAME & ADDRESS

JOHN HUNTER HEALTH & INNOVATION PRECINCT

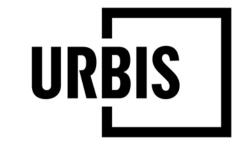Lookout Rd, New Lambton Heights, NSW 2305

PROJECT DIRECTOR: Approver

SITE WIDE LANDSCAPE PLAN

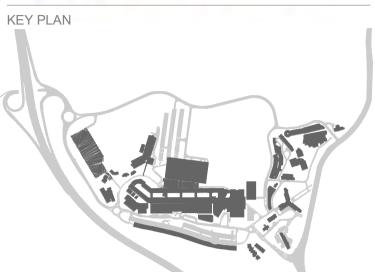PROJECT NO. ISSUE

P0012689


As indicated @A1



DRAWING NO. LD_C0-B60 NL-X1

EXTENT OF SELECTIVE TREE CLEARANCE FOR APZ REFER TO BUSHFIRE REPORT


A SECTION A - ARRIVAL FORECOURT (1:100)
LD_B0-B20 NL-02

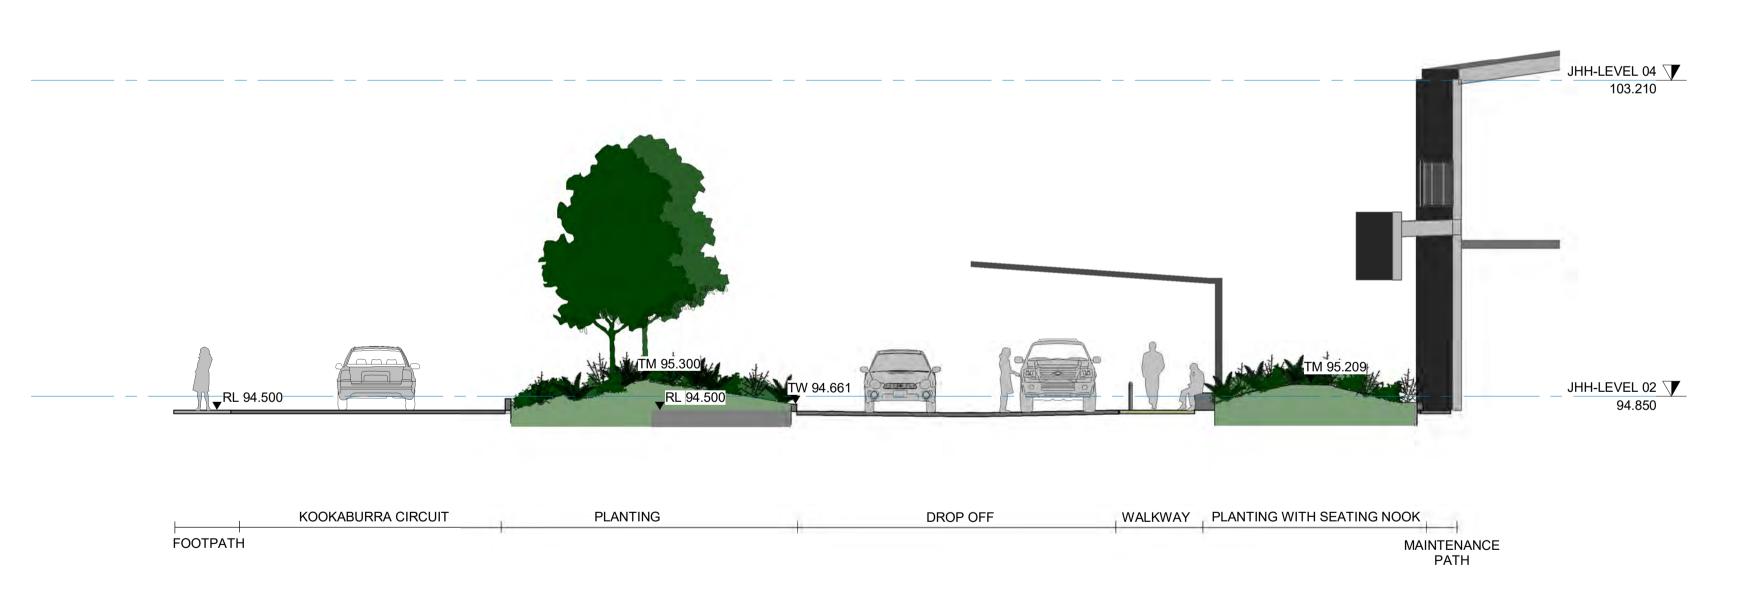

B 800 Arrival Forecourt - Section 2 (1:100)

LD_B0-B20 NL-02




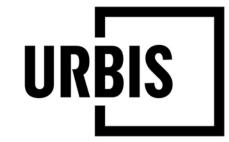

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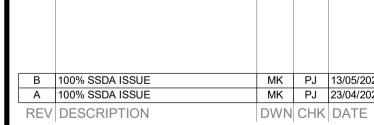
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11. IRRIGATION DESIGN TO BE DEVELOPED AND COORDINATED AT DESIGN DEVELOPMENT



PROJECT NAME & ADDRESS

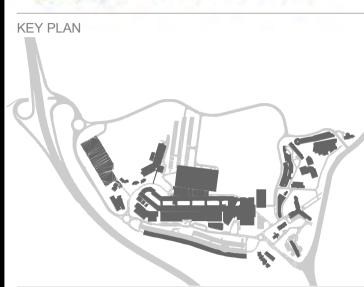JOHN HUNTER HEALTH & INNOVATION PRECINCT

Lookout Rd, New Lambton Heights, NSW 2305

PROJECT DIRECTOR: Phil James

ARRIVAL FORECOURT

SECTIONS

ISSUE PROJECT NO.

SSDA SCALE P0012689


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DRAWING NO.

LD_C0-B61 NL-01

REVISION






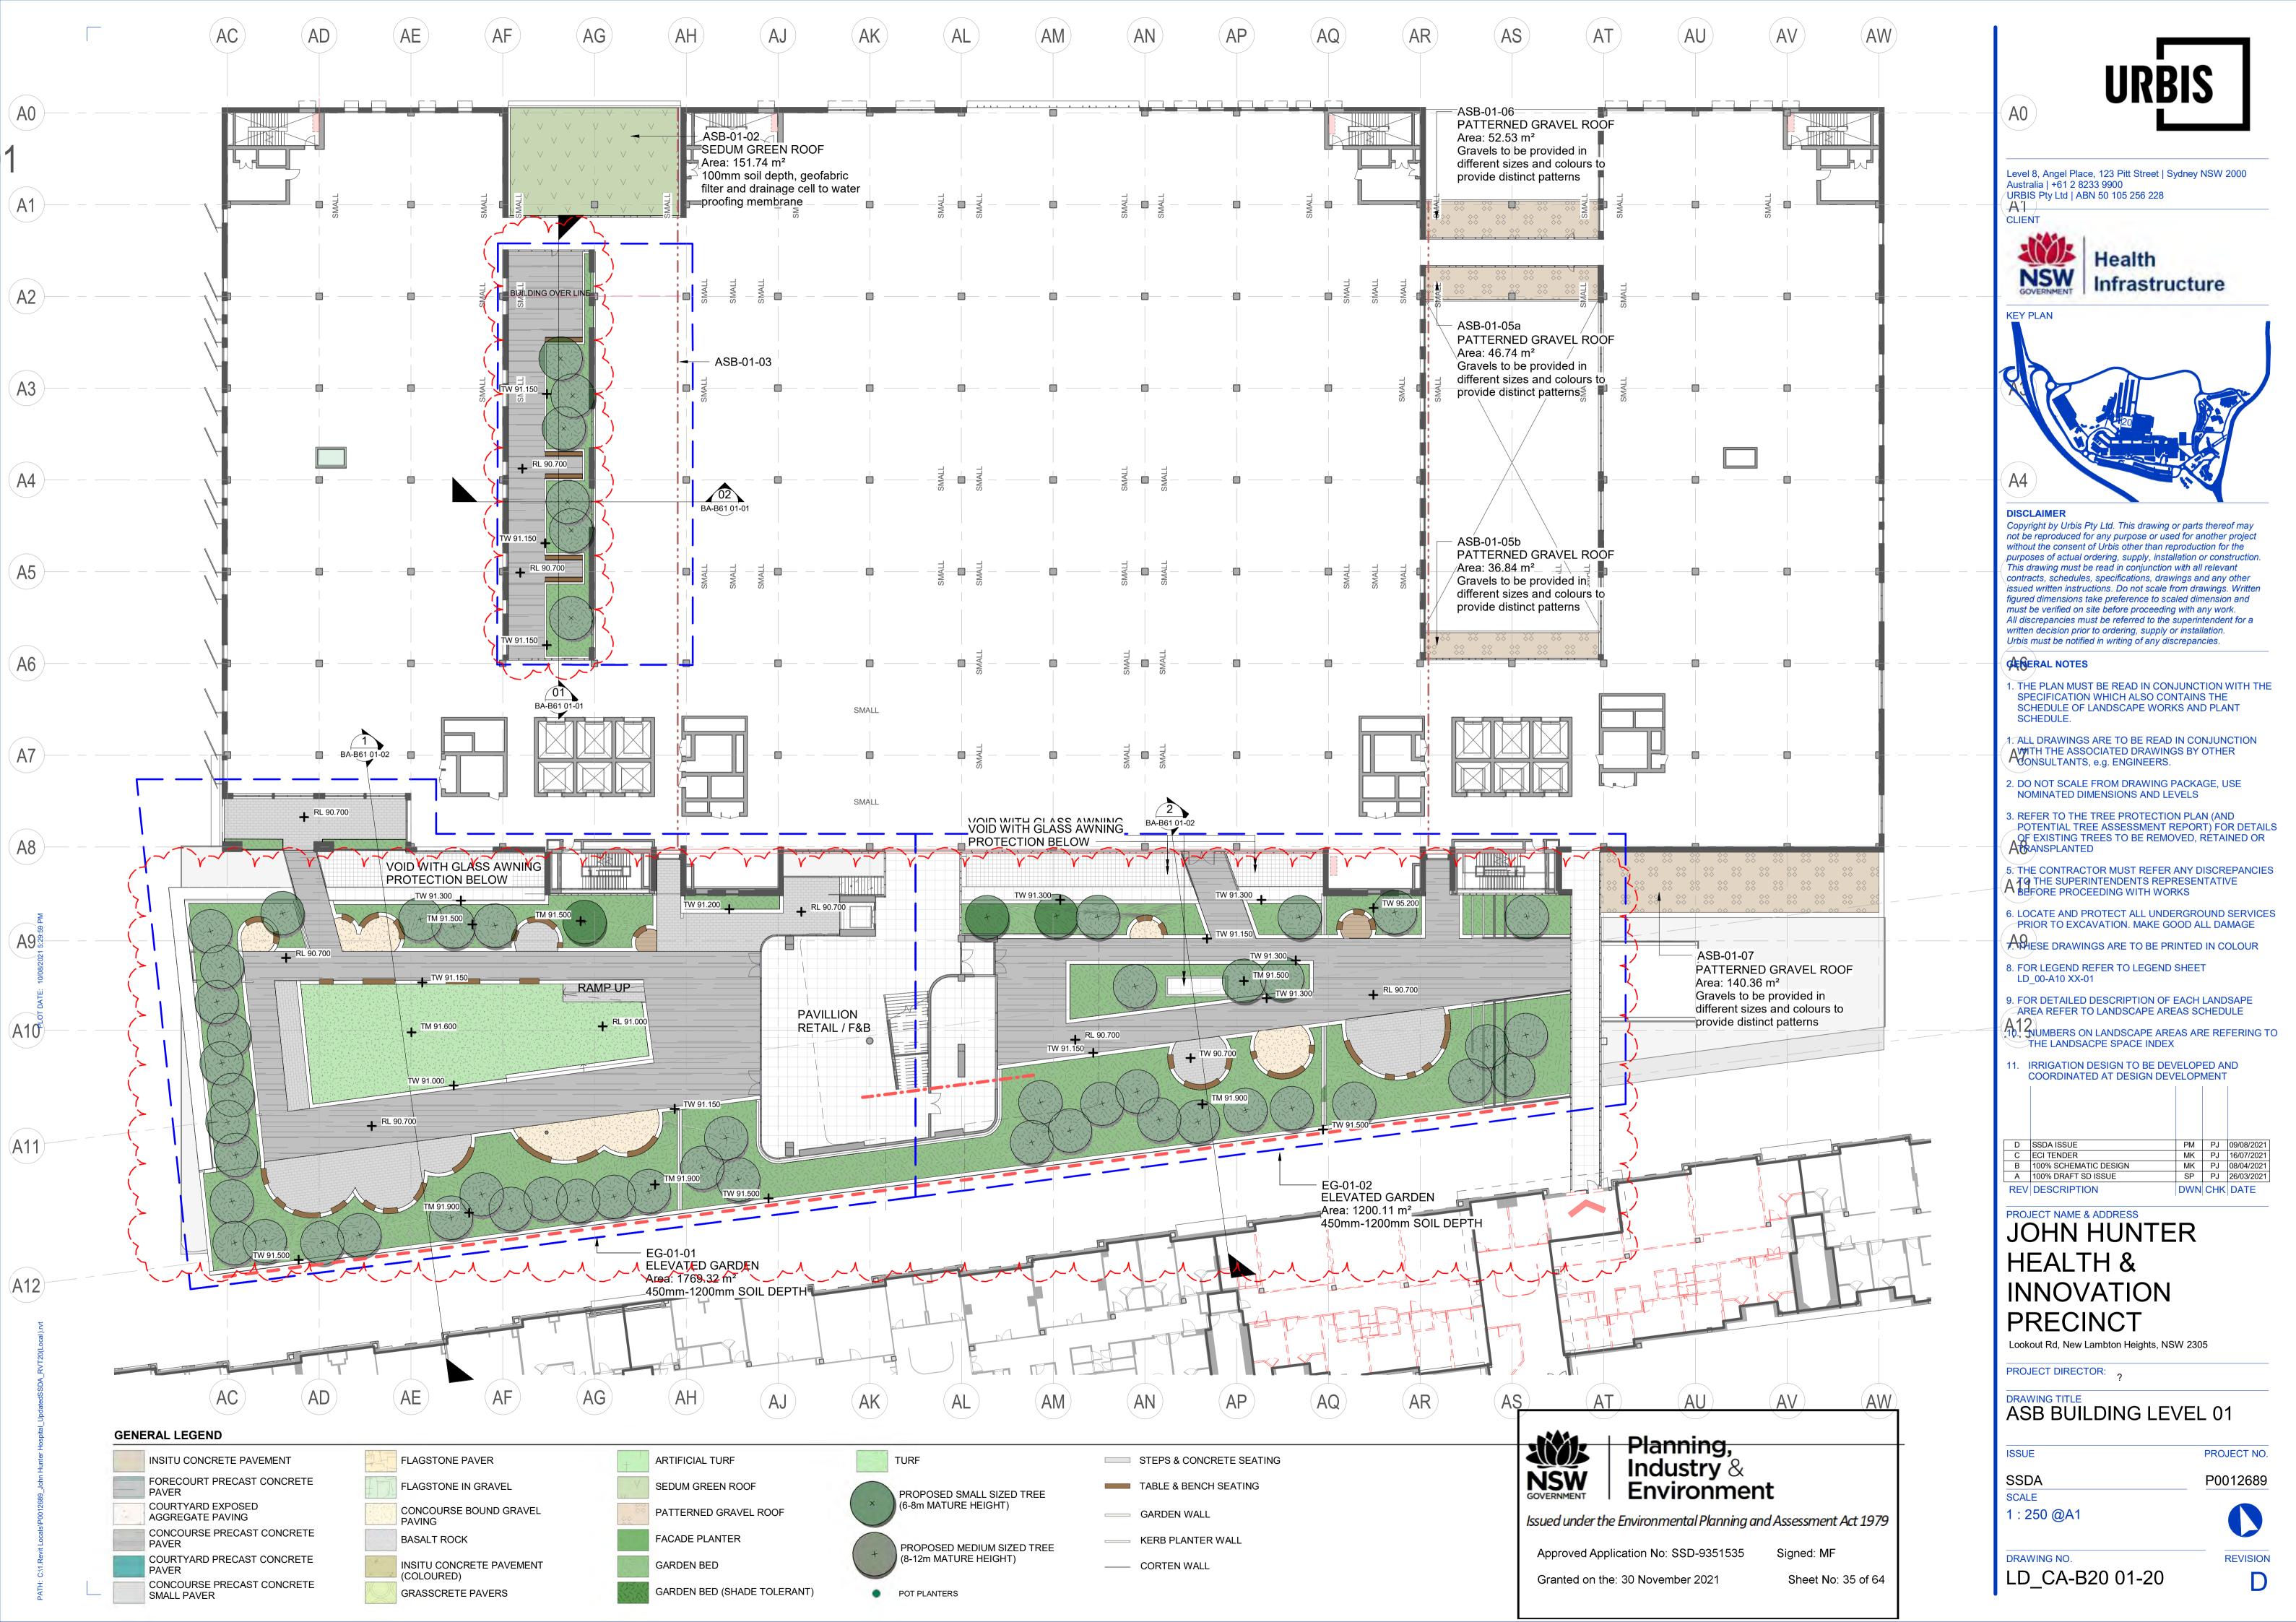




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REVISION В

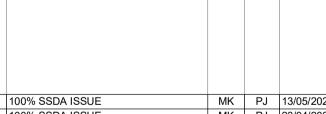



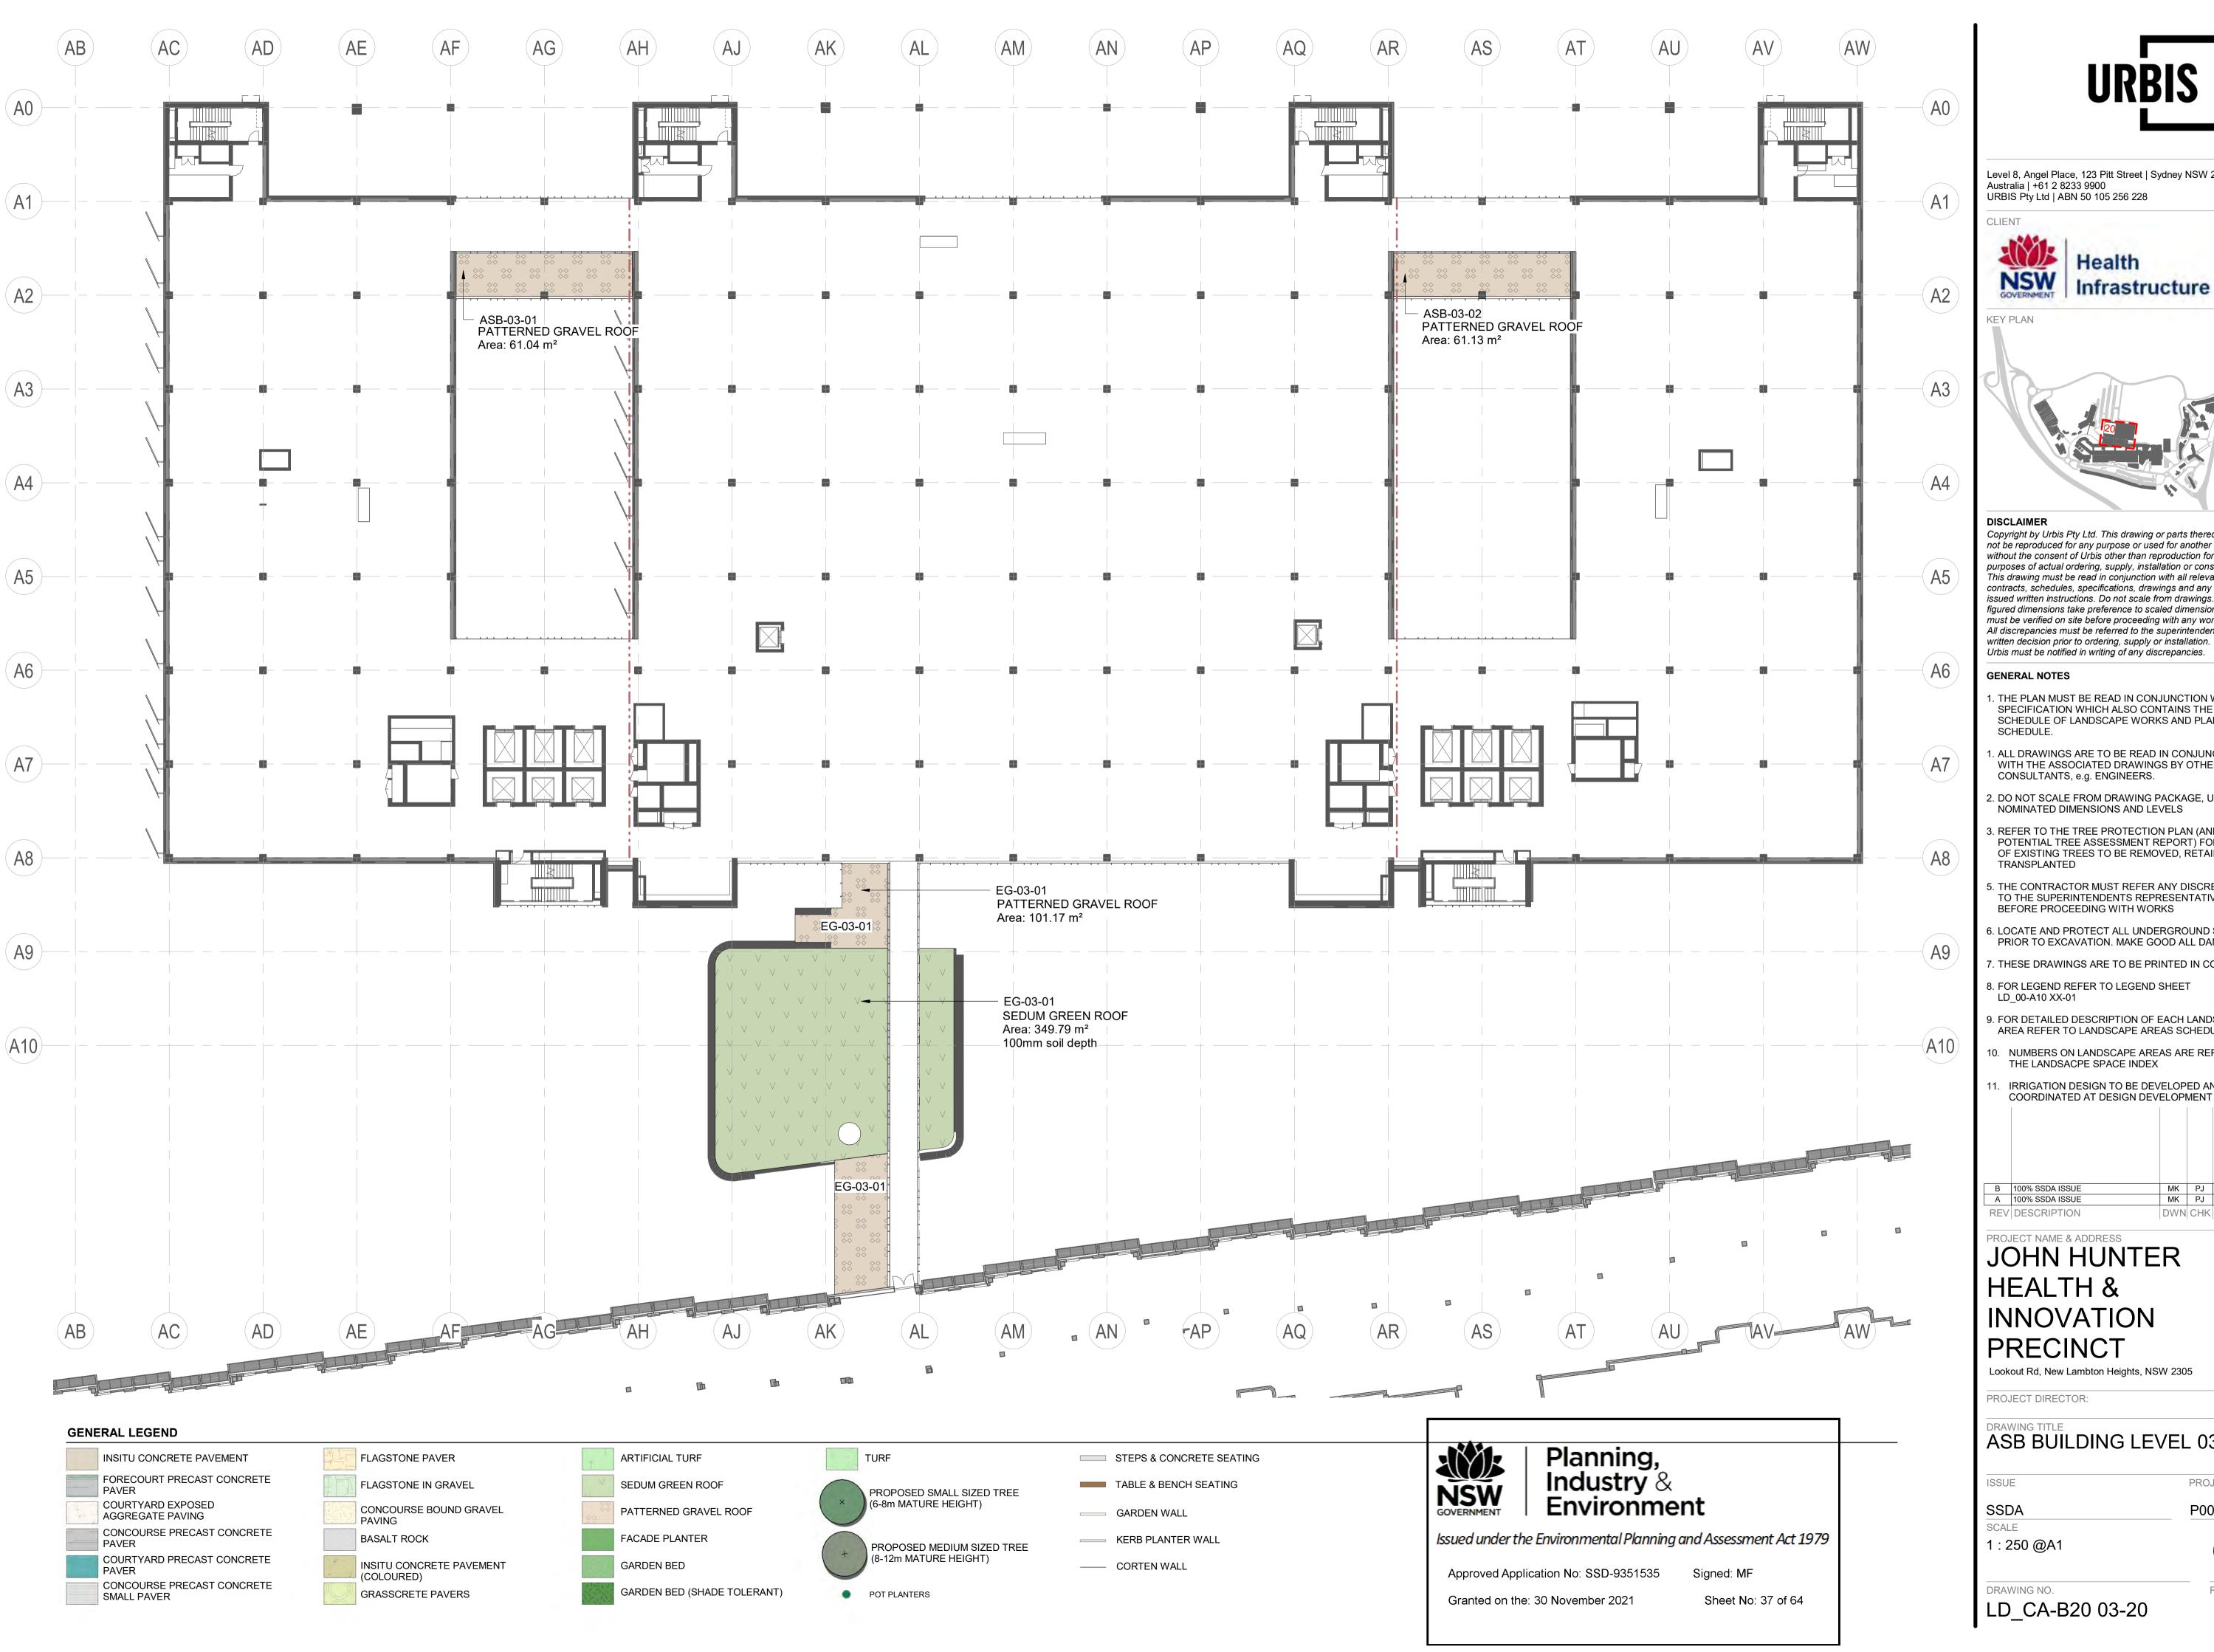


KEY PLAN

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PROJECT NAME & ADDRESS

JOHN HUNTER HEALTH & INNOVATION **PRECINCT**

Lookout Rd, New Lambton Heights, NSW 2305


PROJECT DIRECTOR:

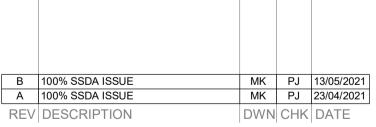ASB BUILDING LEVEL 03

P0012689

PROJECT NO.

LD_CA-B20 03-20

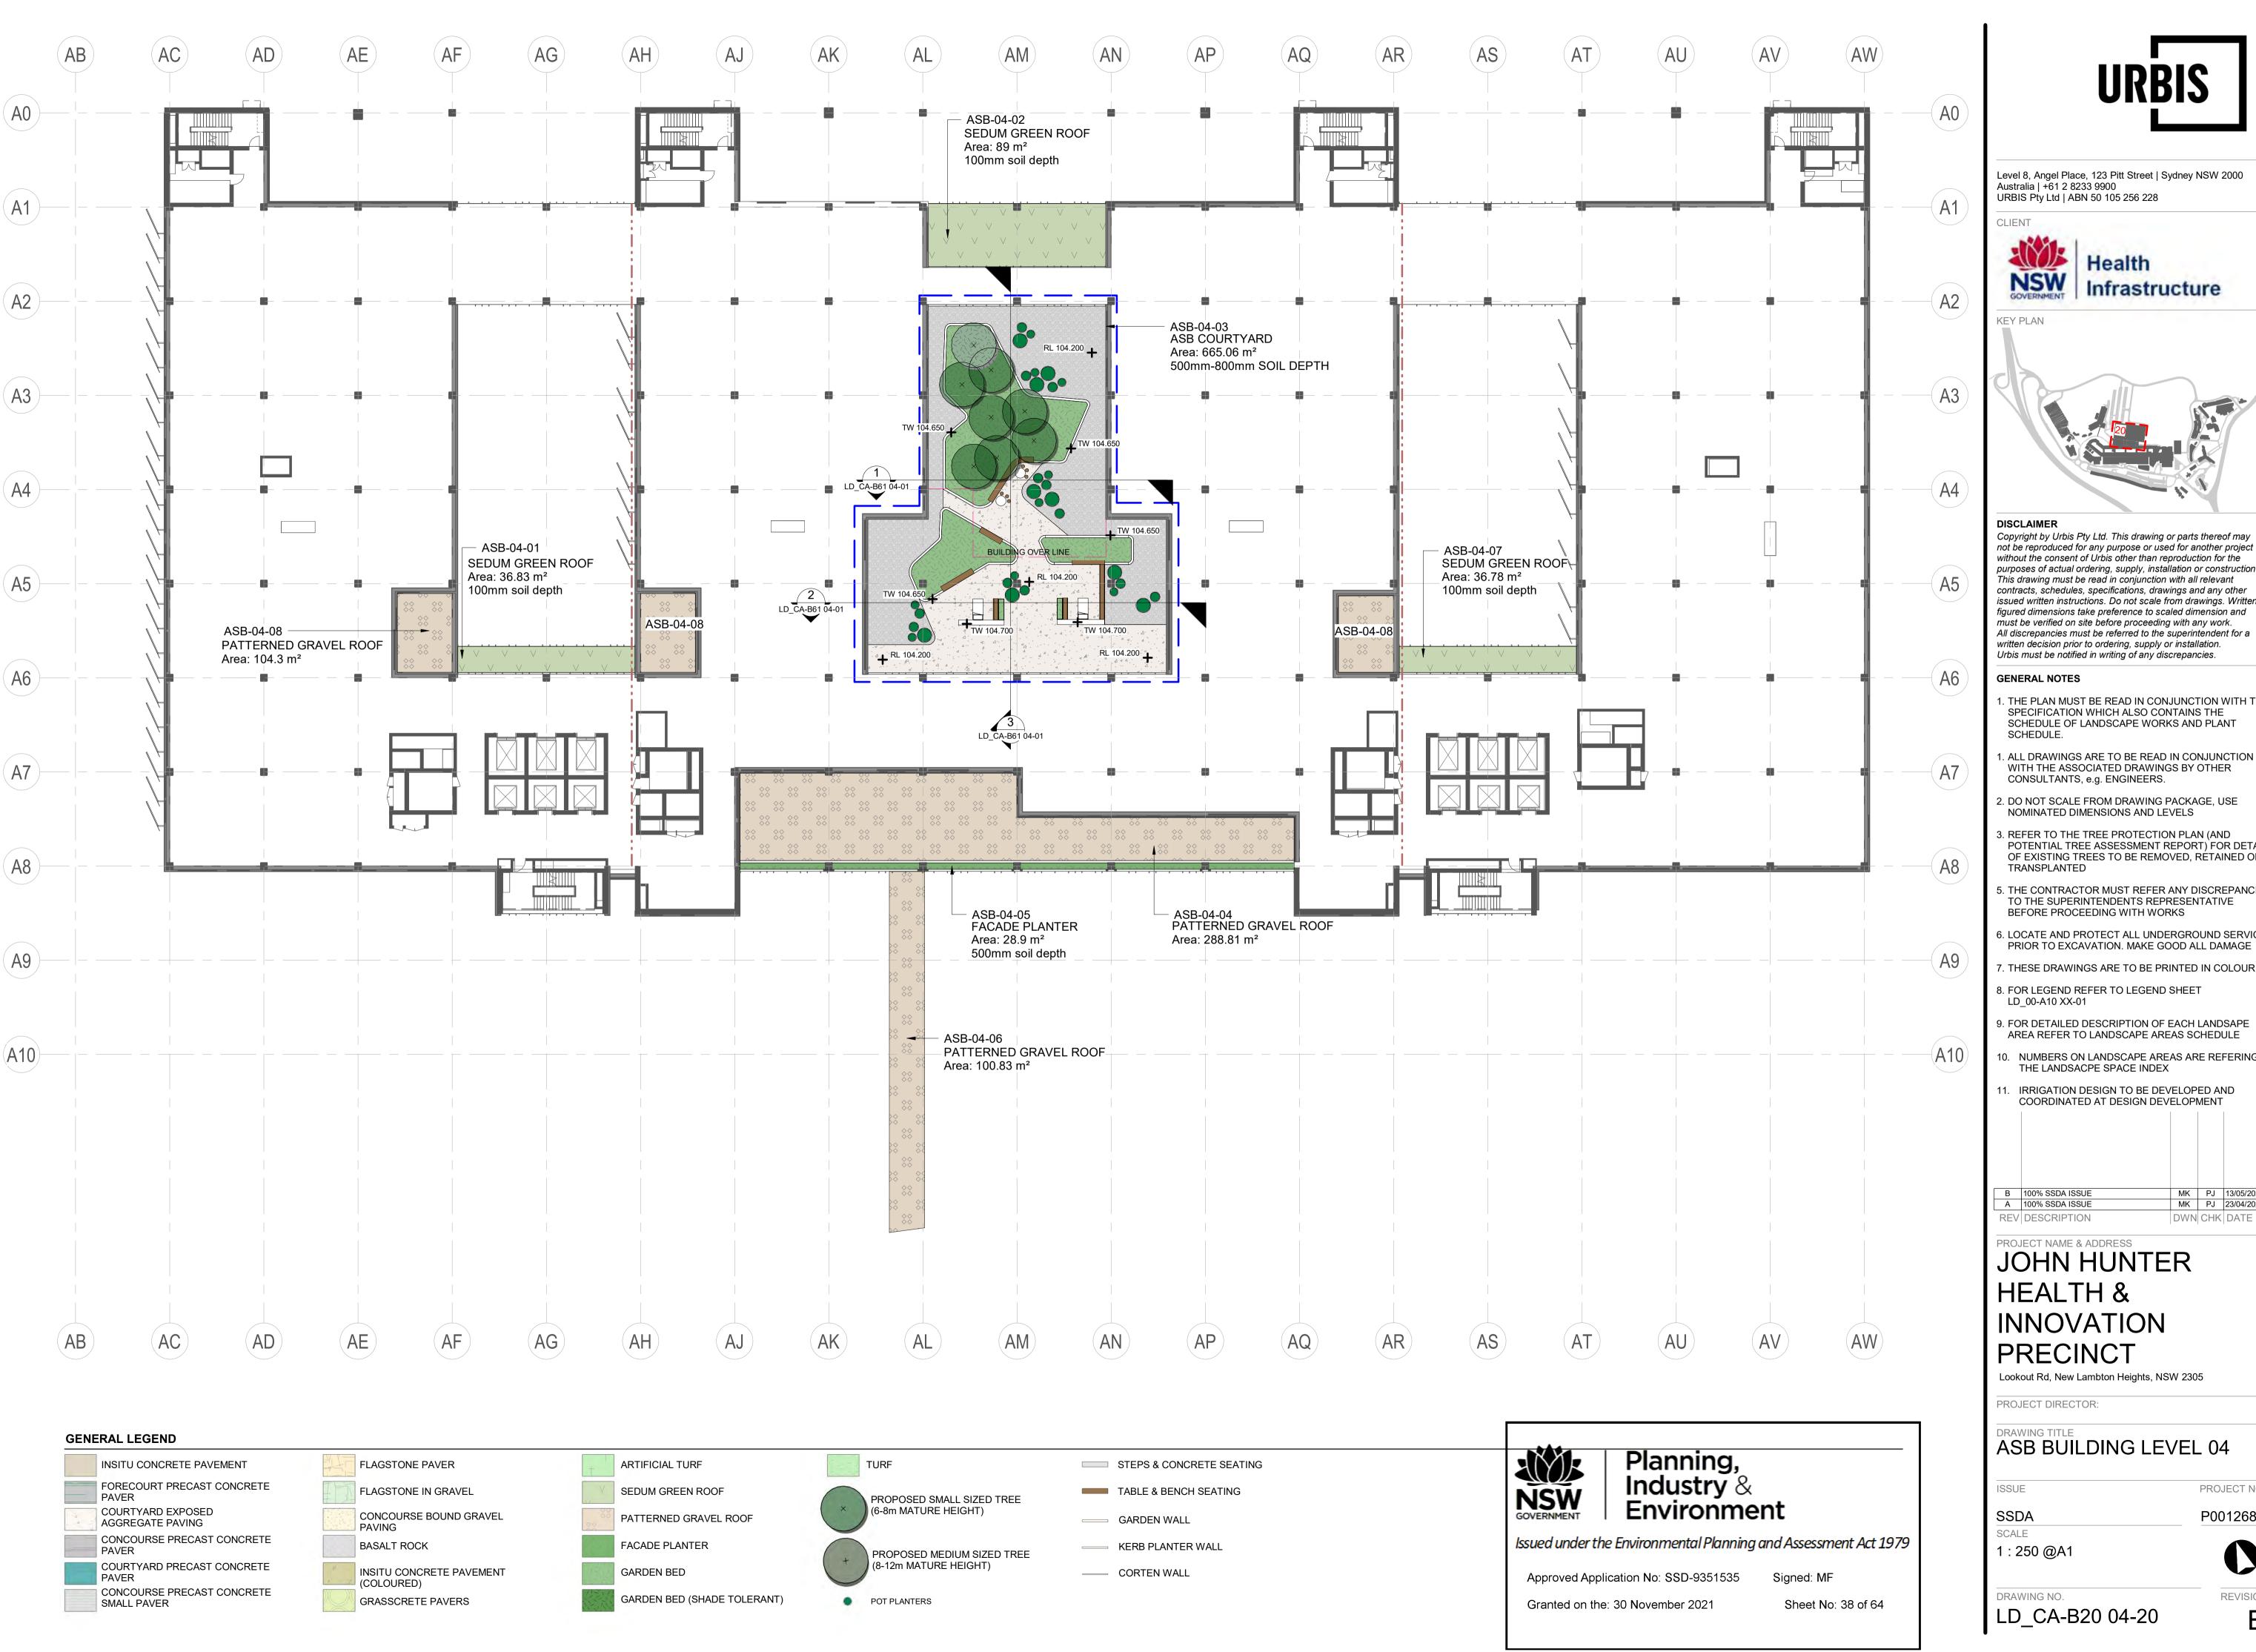





KEY PLAN



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MK PJ 13/05/2021 MK PJ 23/04/2021 B 100% SSDA ISSUE A 100% SSDA ISSUE

REV DESCRIPTION DWN CHK DATE

JOHN HUNTER HEALTH & INNOVATION PRECINCT

Lookout Rd, New Lambton Heights, NSW 2305

PROJECT DIRECTOR:


ASB BUILDING LEVEL 04

ISSUE

PROJECT NO.

P0012689

DRAWING NO. LD_CA-B20 04-20

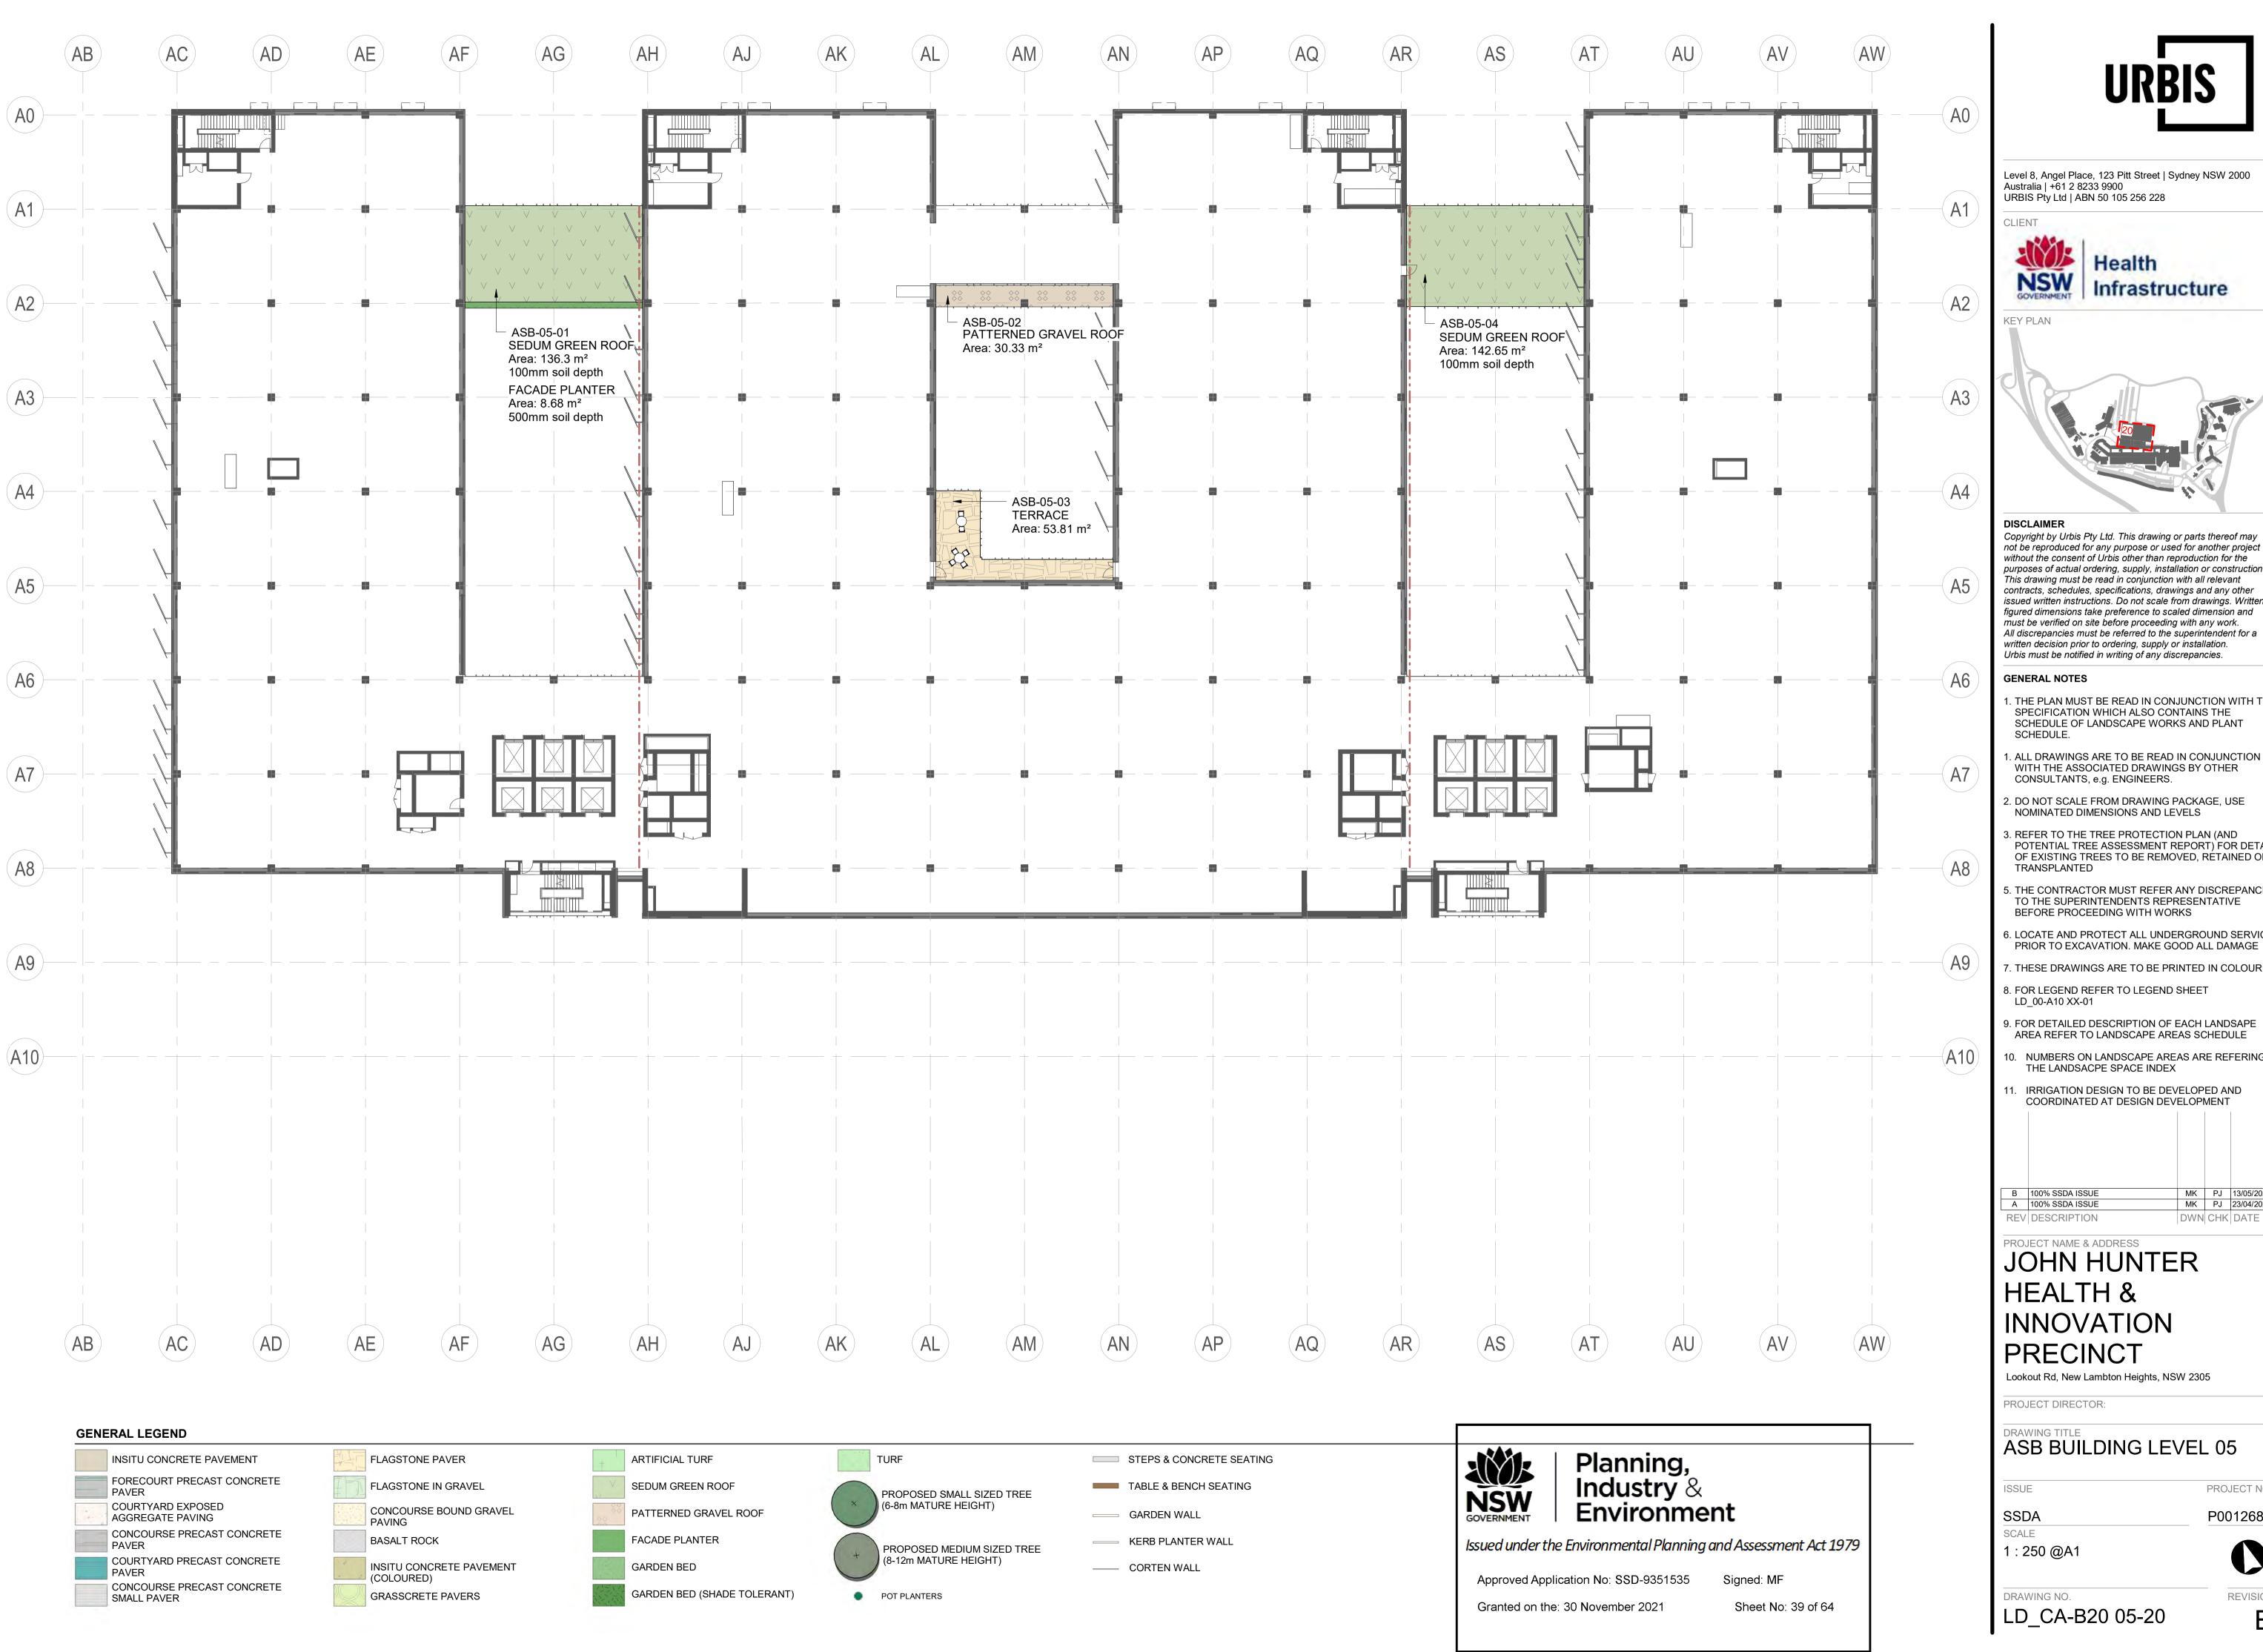



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MK PJ 13/05/2021 MK PJ 23/04/2021 DWN CHK DATE


INNOVATION

Lookout Rd, New Lambton Heights, NSW 2305

ASB BUILDING LEVEL 05

P0012689

PROJECT NO.

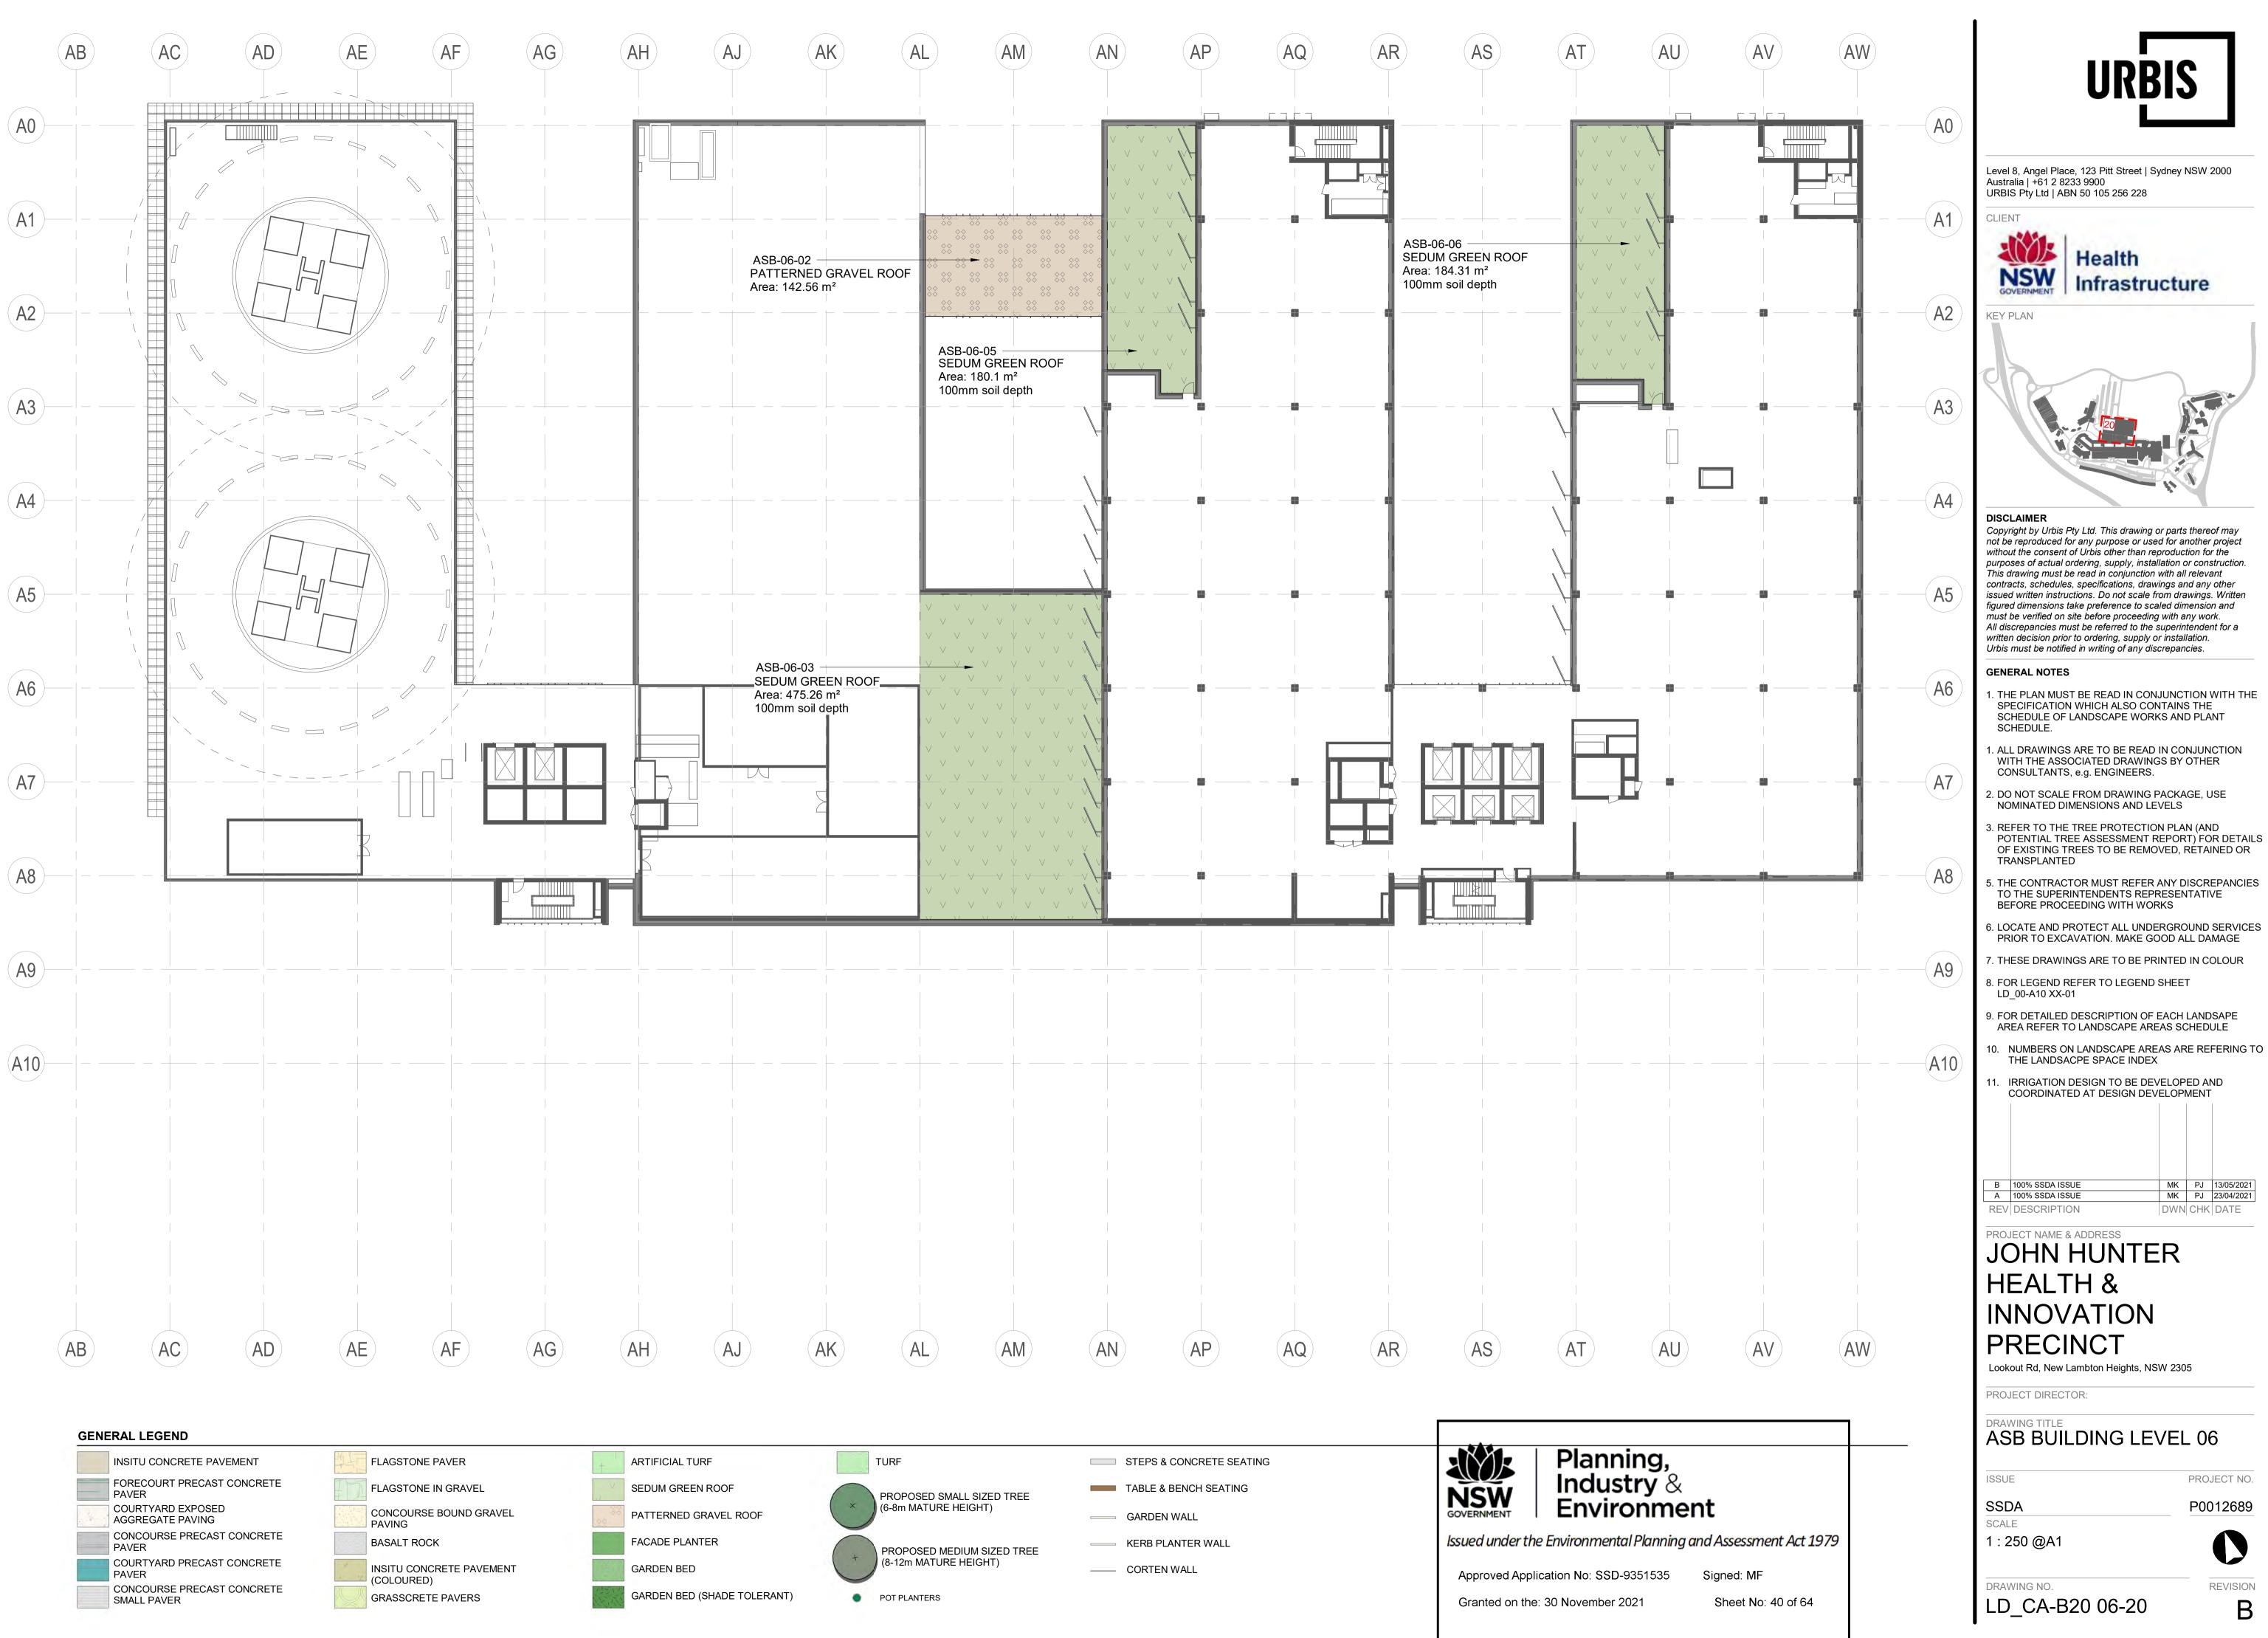

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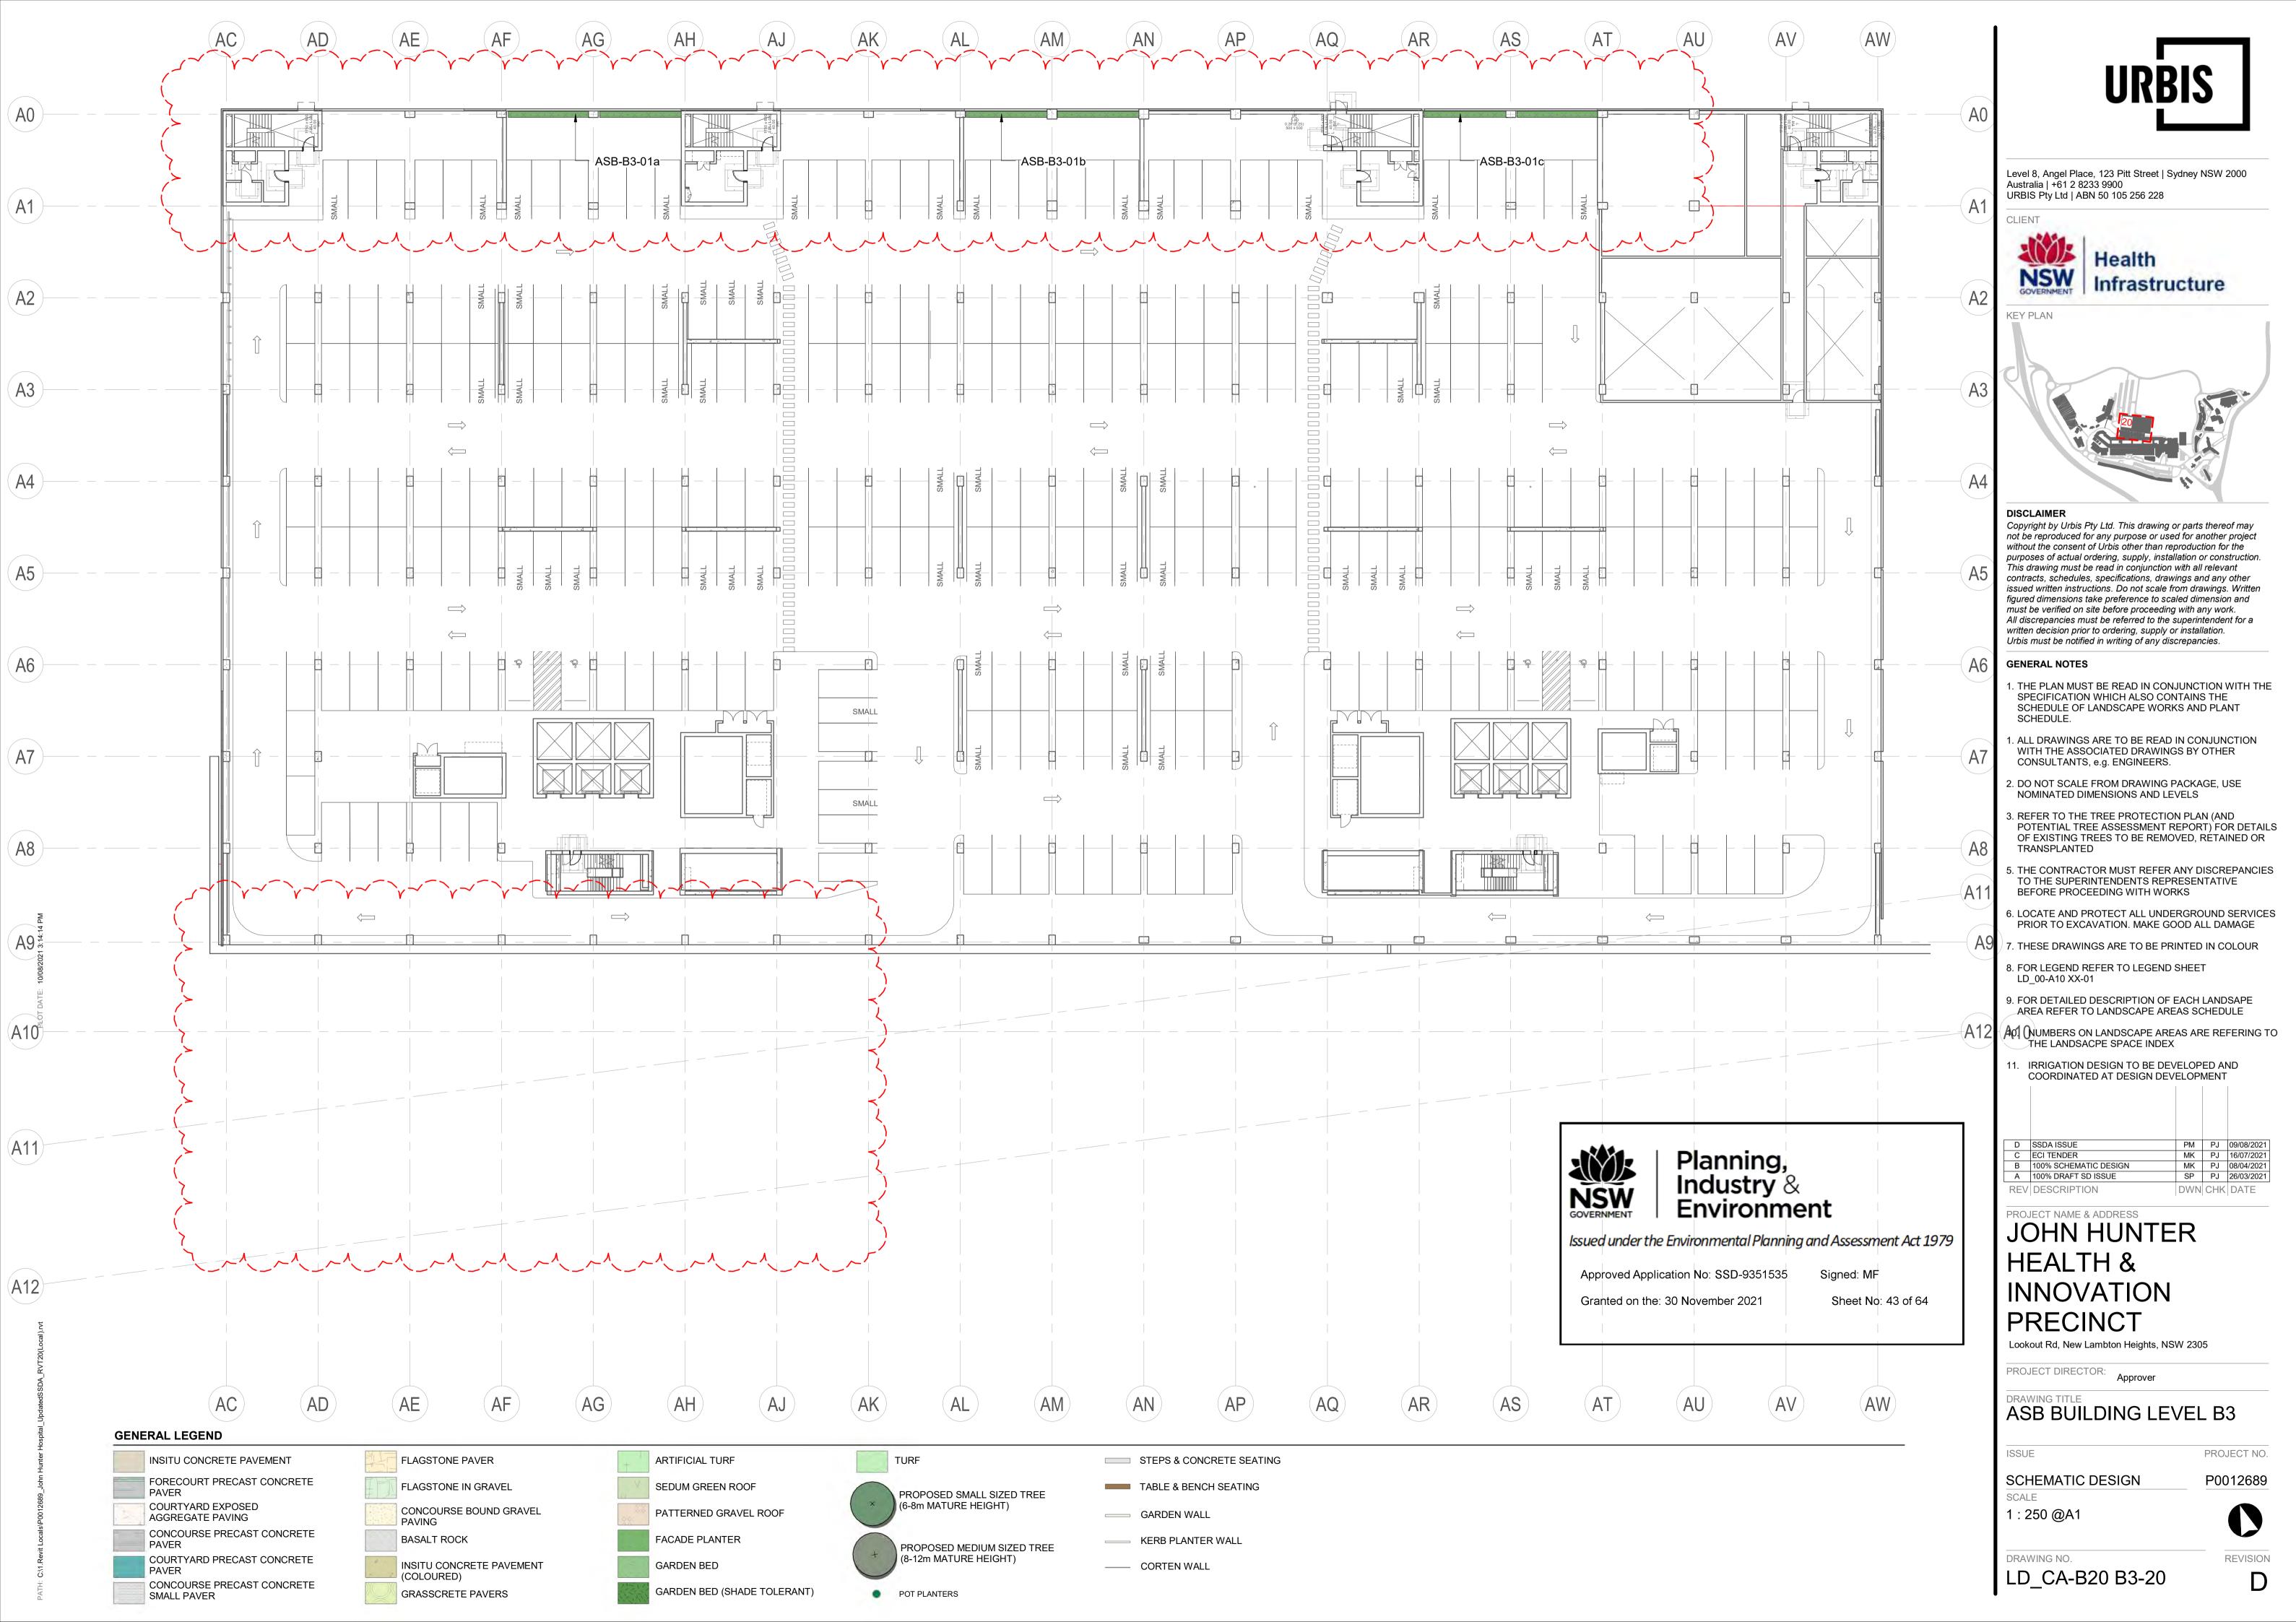
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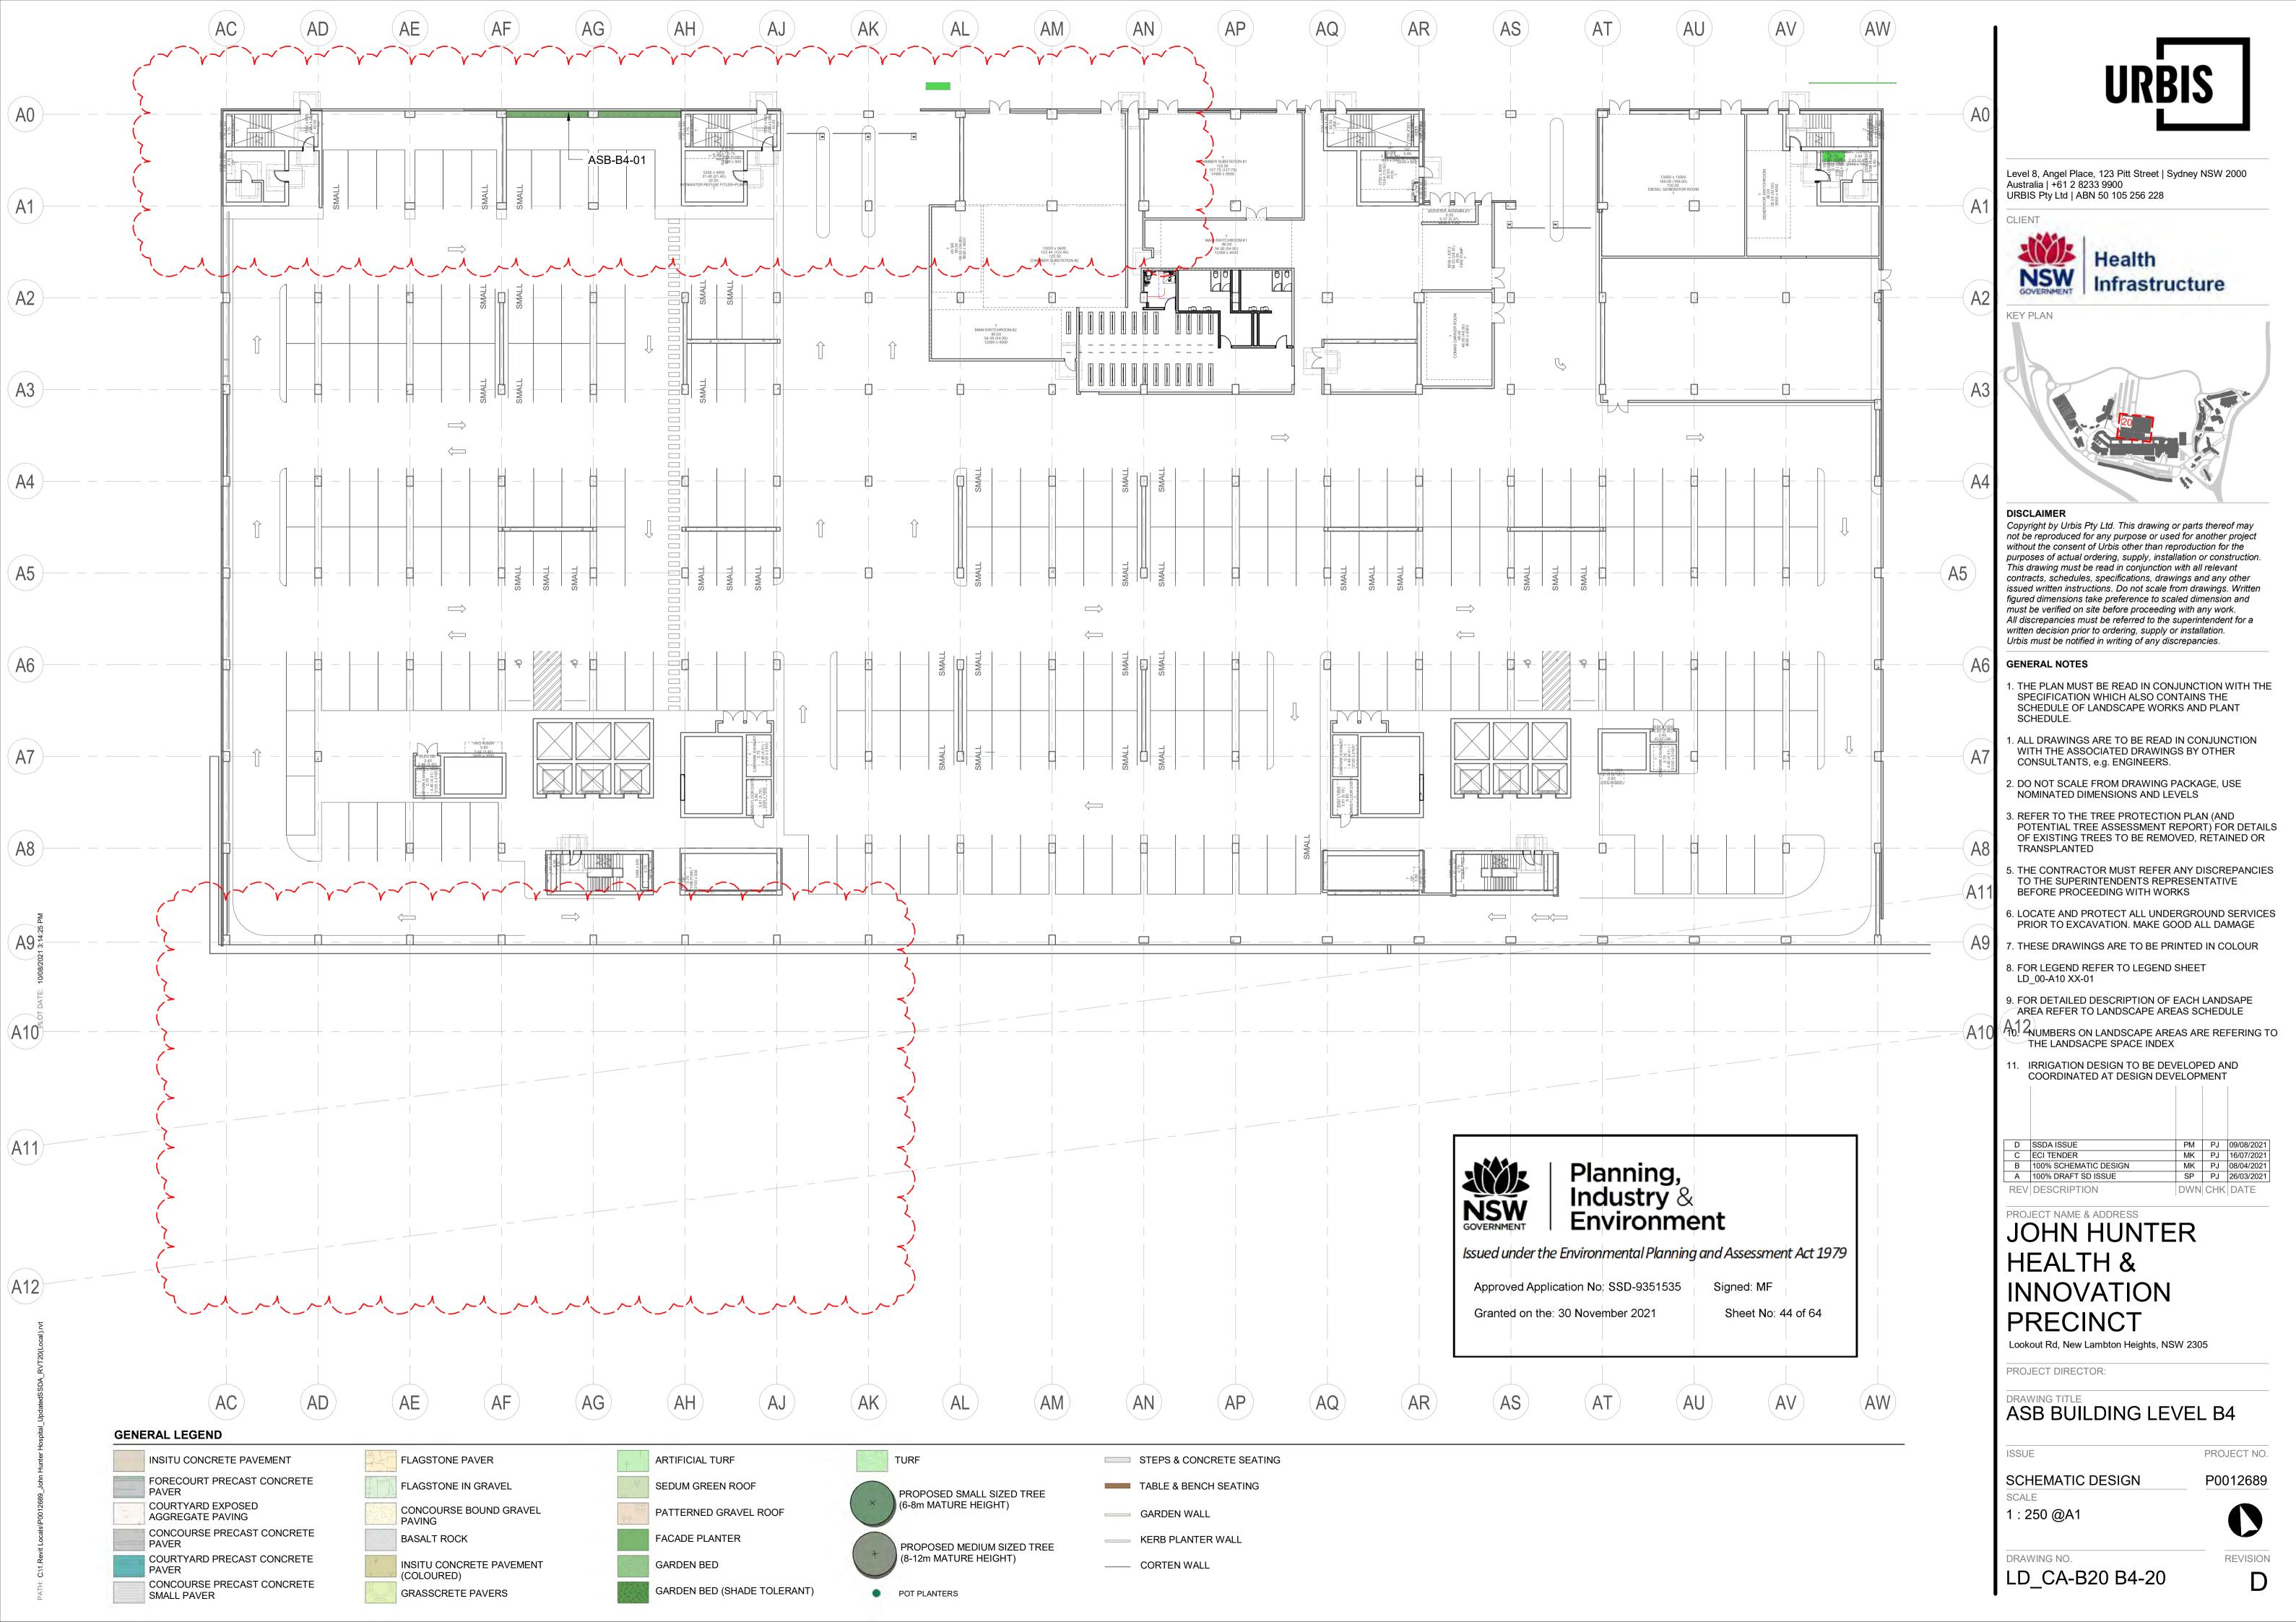
MK PJ 13/05/2021 MK PJ 23/04/2021

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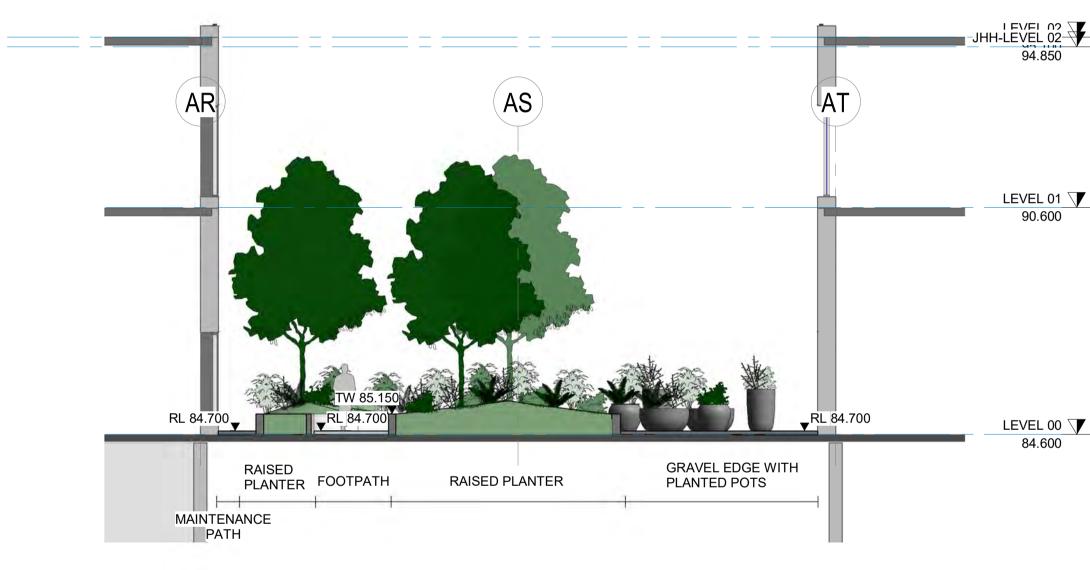









1 CROSS SECTION 1 - ASB BUILDING LEVEL 00 - COURTYARD (1:100) LD_BA-B20 00-22



2 SECTION 2 - ASB BUILDING L00 - COURTYARD (1:100)

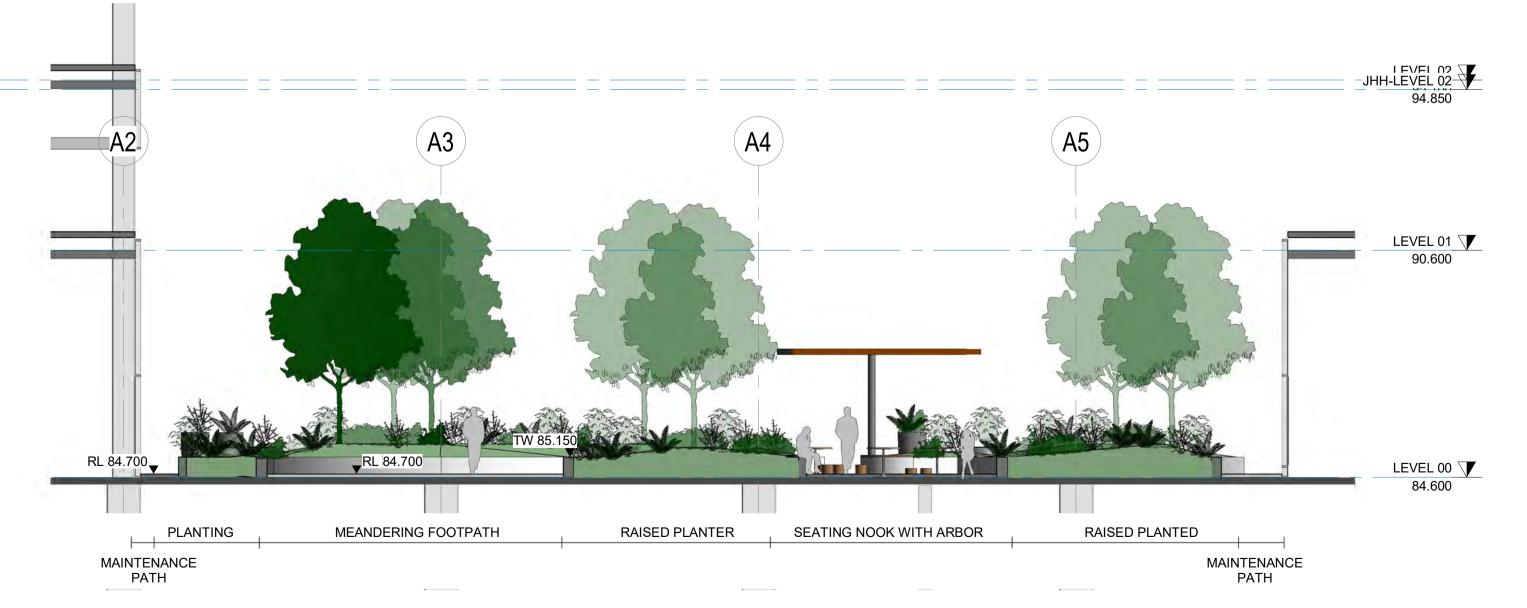


3 SECTION 3 - ASB BUILDING L00 - COURTYARD (1:100)

LD_BA-B20 00-22



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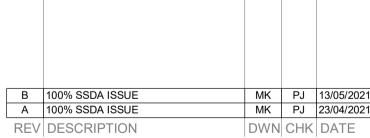


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PROJECT NAME & ADDRESS

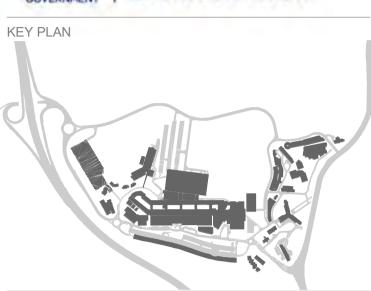JOHN HUNTER HEALTH & INNOVATION PRECINCT

Lookout Rd, New Lambton Heights, NSW 2305

PROJECT DIRECTOR:

Planning, Industry &

Approved Application No: SSD-9351535

Granted on the: 30 November 2021

Environment

Issued under the Environmental Planning and Assessment Act 1979

Signed: MF

Sheet No: 45 of 64

ASB BUILDING LEVEL 00 COURTYARD SECTIONS


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DRAWING NO.

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REVISION В



1 SECTION 1 - ASB BUILDING LOO - ED ARRIVAL (1:100) LD_BA-B20 00-22

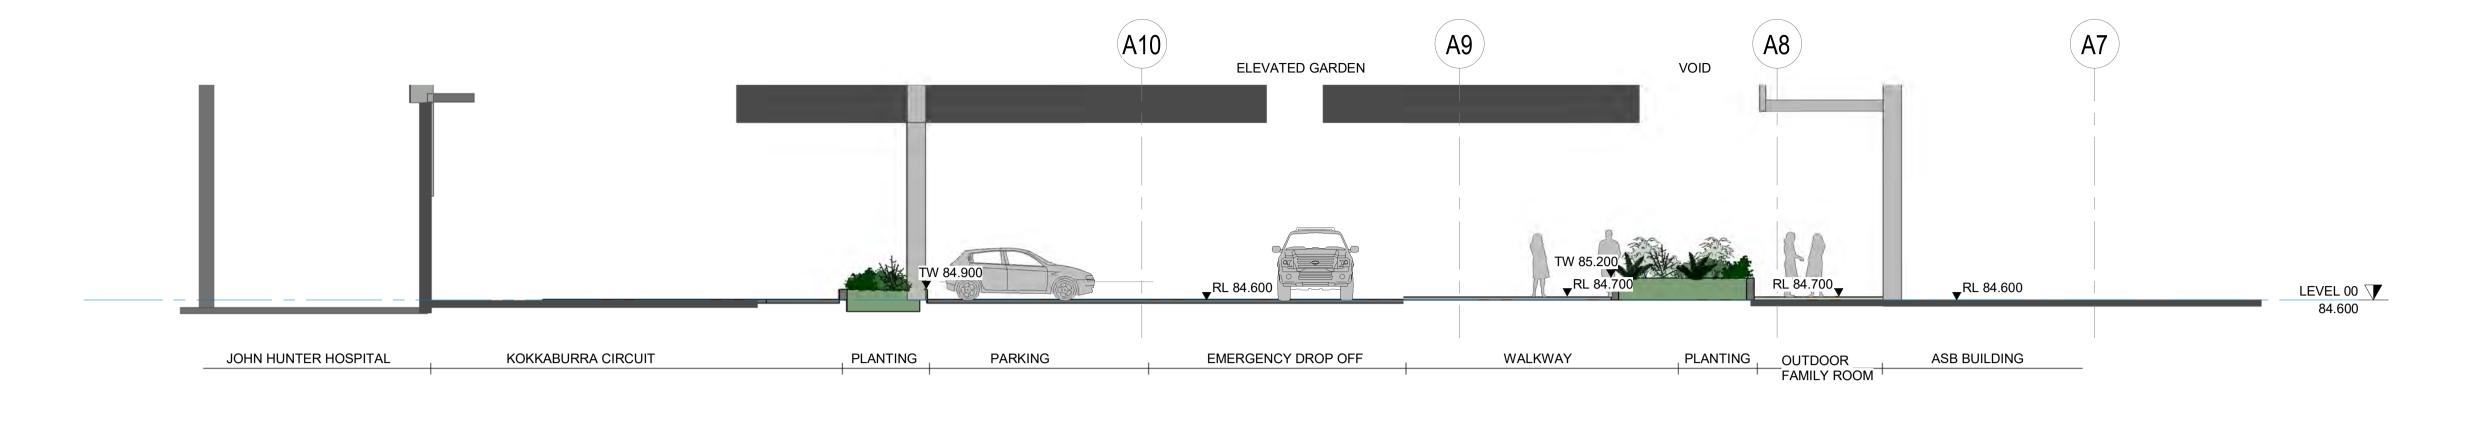


Issued under the Environmental Planning and Assessment Act 1979

Approved Application No: SSD-9351535 Signed: MF

Granted on the: 30 November 2021

Sheet No: 46 of 64

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B 100% SSDA ISSUE A 100% SSDA ISSUE MK PJ 13/05/2021 MK PJ 23/04/2021

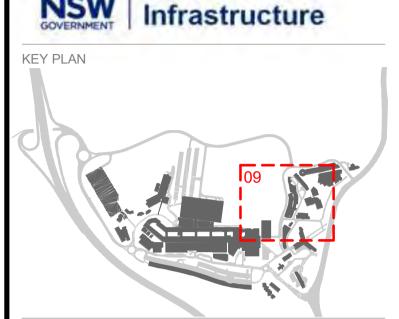REV DESCRIPTION DWN CHK DATE

PROJECT NAME & ADDRESS

JOHN HUNTER HEALTH & INNOVATION PRECINCT

Lookout Rd, New Lambton Heights, NSW 2305

PROJECT DIRECTOR: Approver

ASB BUILDING LEVEL 00 **ED ARRIVAL SECTION**

PROJECT NO.


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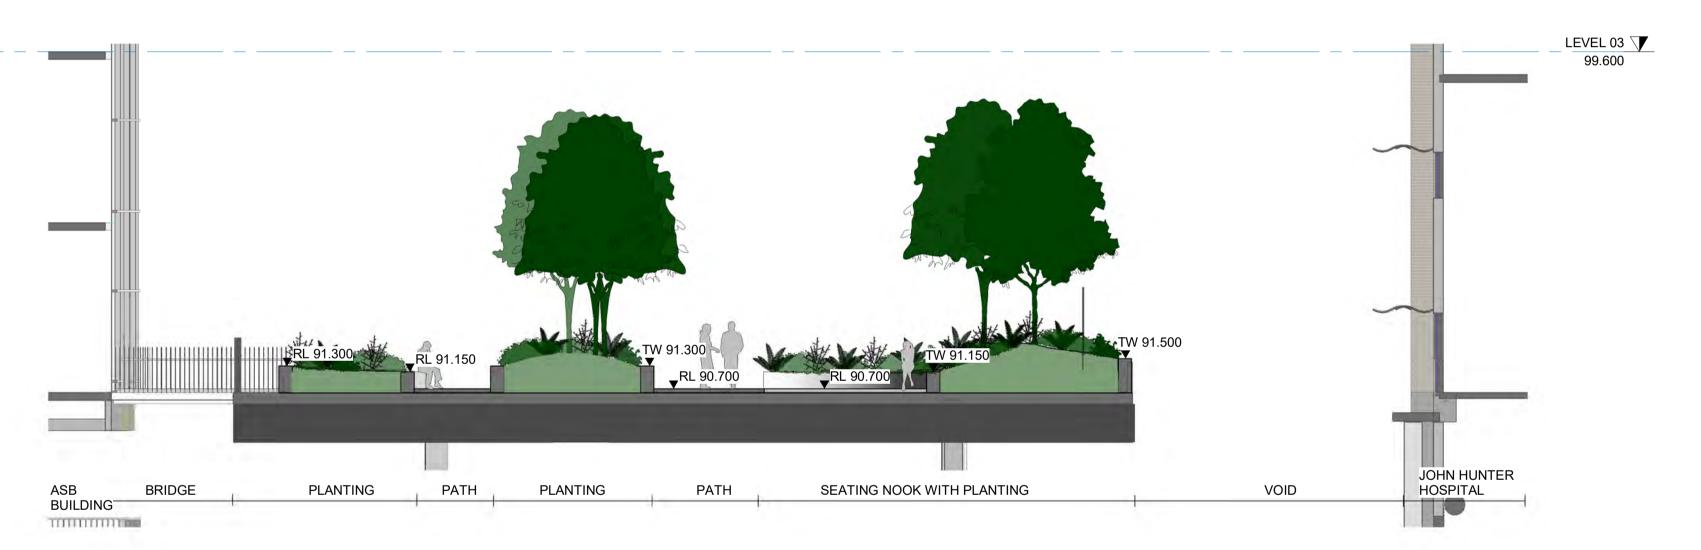
DRAWING NO.

LD_CA-B61 00-02

REVISION



1 SECTION 1 - ELEVATED GARDEN (1:100) LD_BA-B20 00-21

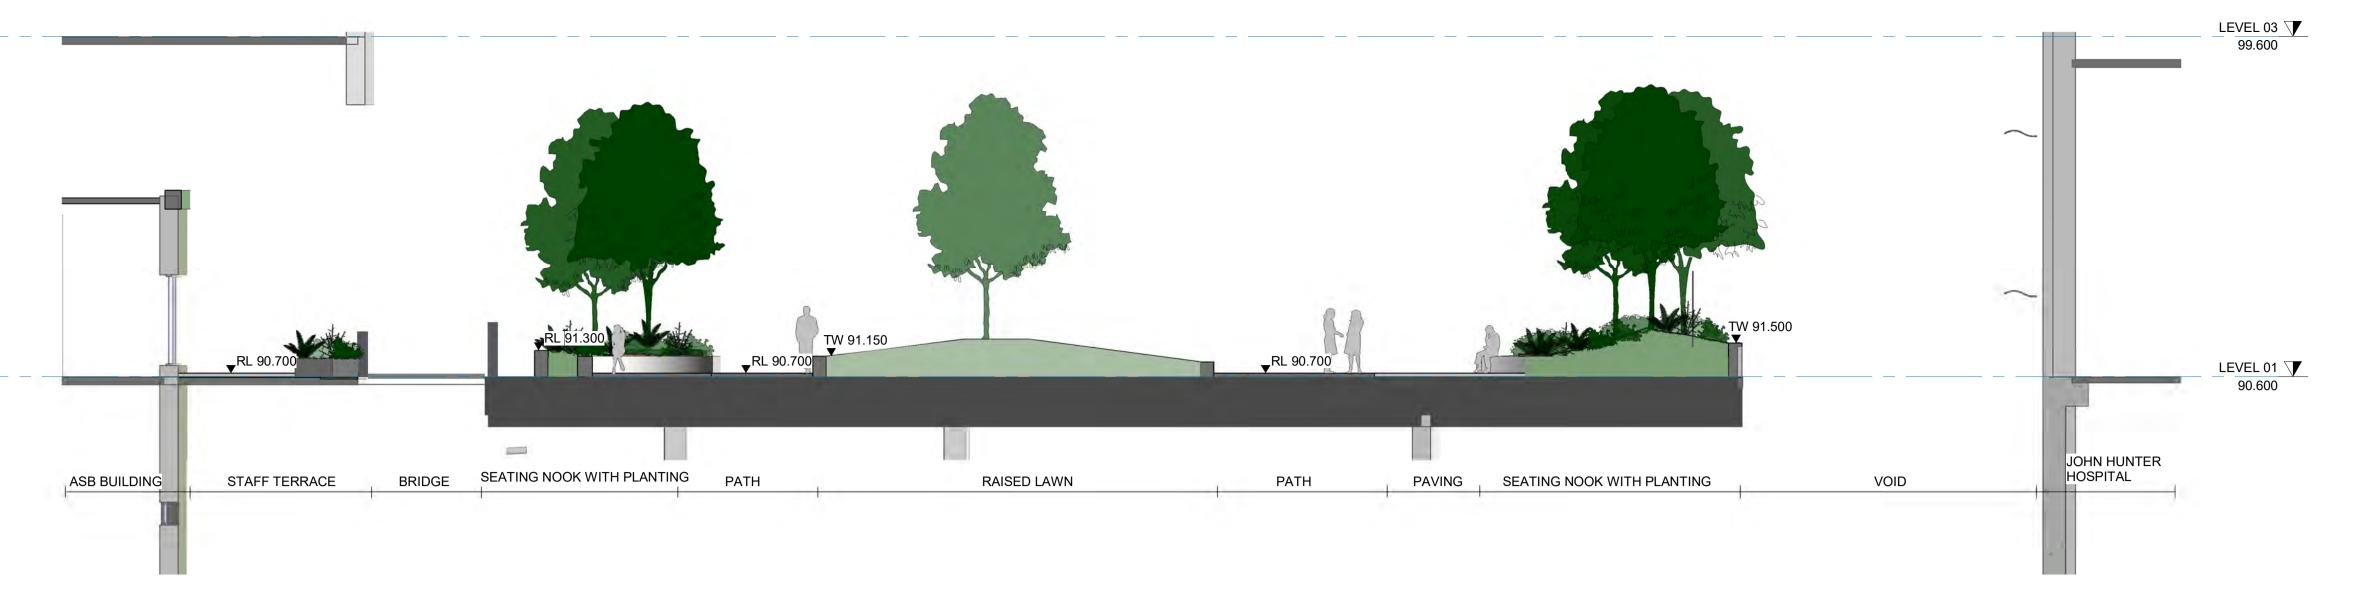

2 SECTION 2 - ELEVATED GARDEN (1:100)


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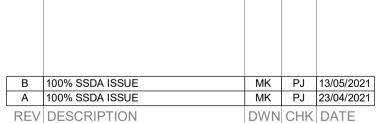
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REV DESCRIPTION

PROJECT NAME & ADDRESS JOHN HUNTER HEALTH & INNOVATION PRECINCT

Lookout Rd, New Lambton Heights, NSW 2305

PROJECT DIRECTOR: Approver

ASB BUILDING LEVEL 01 ELEVATED GARDEN

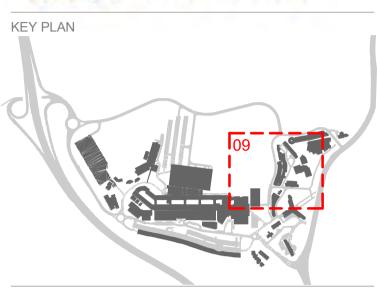SECTIONS


SSDA SCALE

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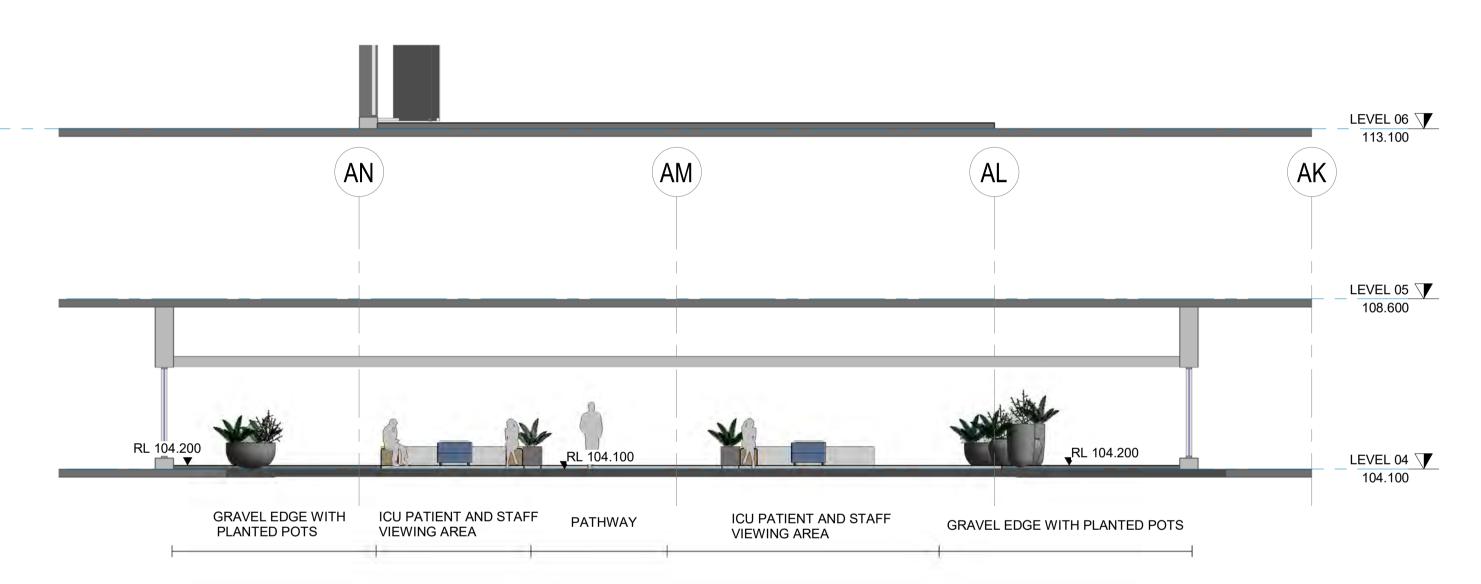
PROJECT NO.

P0012689




1 SECTION 1 - ASB BUILDING L04 - COURTYARD (1:100)

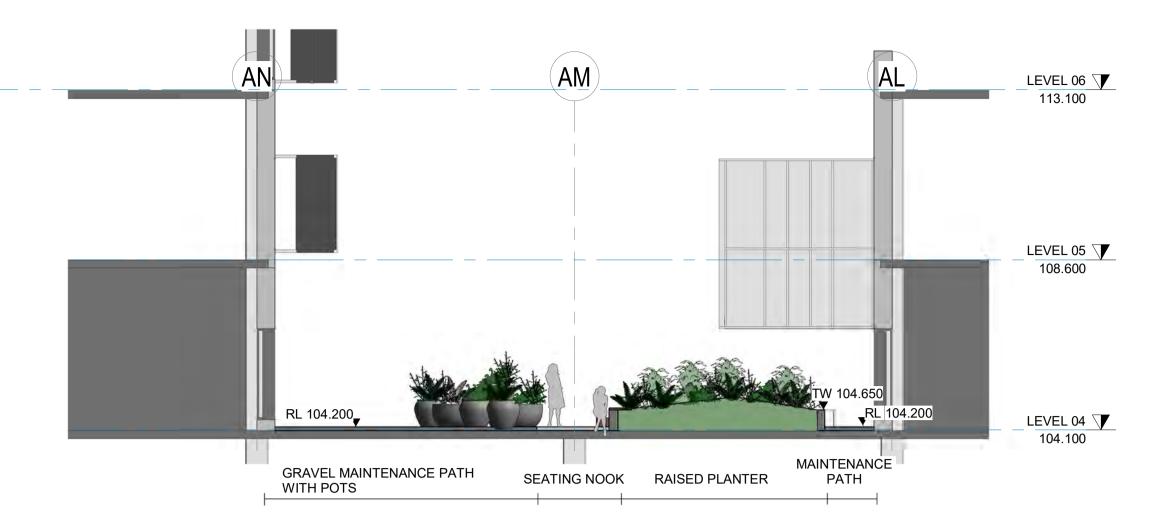LD_BA-B20 04-21



2 SECTION 2 - ASB BUILDING L04 - COURTYARD (1:100)

LD_BA-B20 03-21

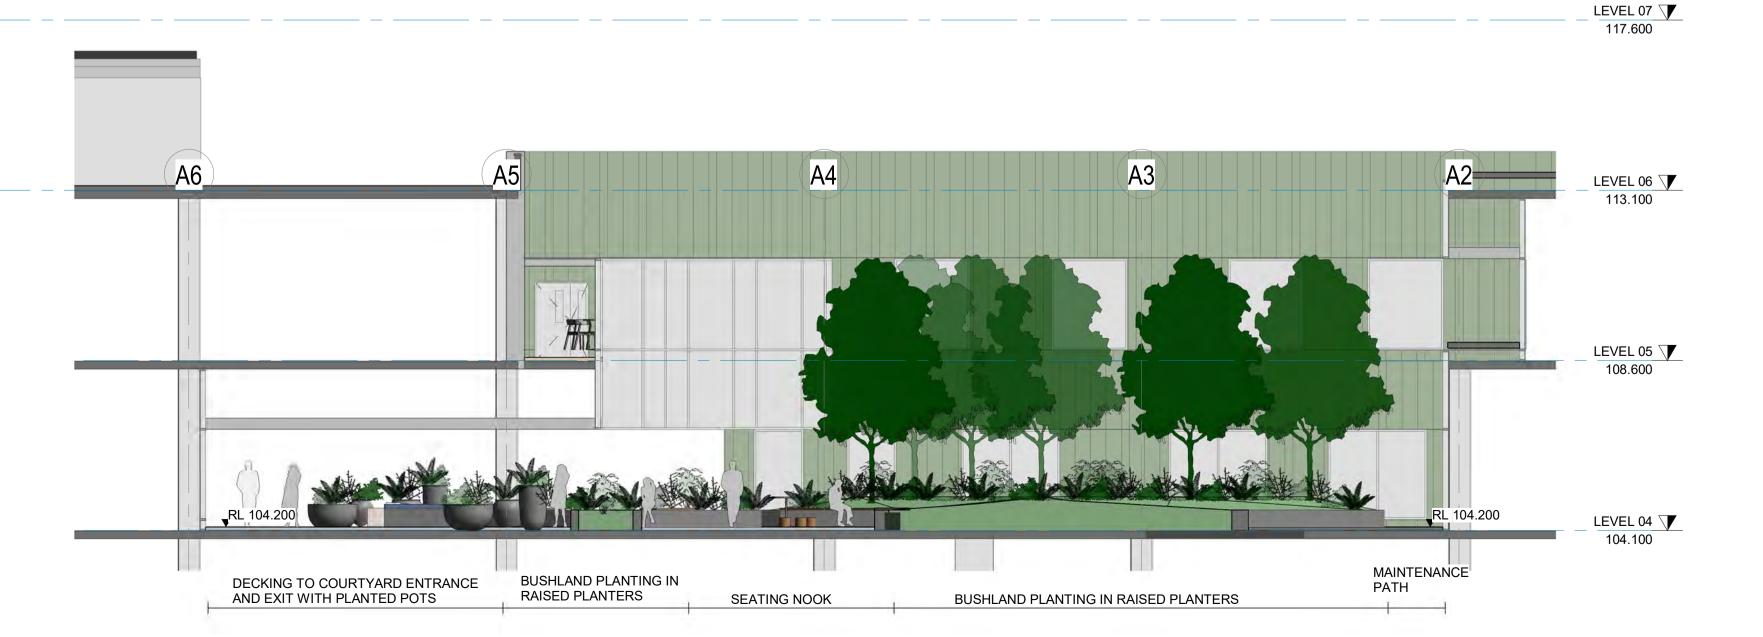



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Sheet No: 48 of 64

Approved Application No: SSD-9351535 Signed: MF


Granted on the: 30 November 2021

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В	100% SSDA ISSUE	MK	PJ	13/05/20
Α	100% SSDA ISSUE	MK	PJ	23/04/20
REV	DESCRIPTION	DWN	CHK	DATE

PROJECT NAME & ADDRESS

JOHN HUNTER HEALTH & INNOVATION PRECINCT

Lookout Rd, New Lambton Heights, NSW 2305

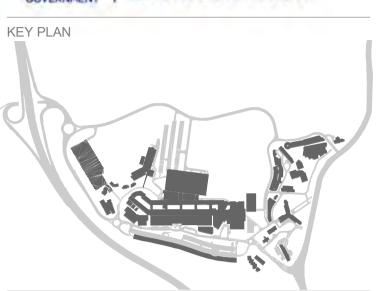PROJECT DIRECTOR:

ASB BUILDING LEVEL 04
COURTYARD SECTIONS

ISSUE PROJECT NO.

P0012689

REVISION

В

SCALE

SSDA


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DRAWING NO.

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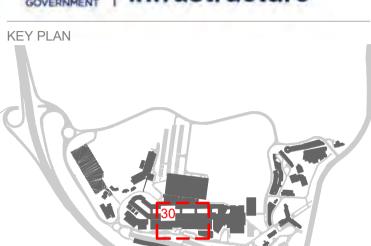
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3 SECTION 2 - ASB BUILDING L04 - COURTYARD (1:100)







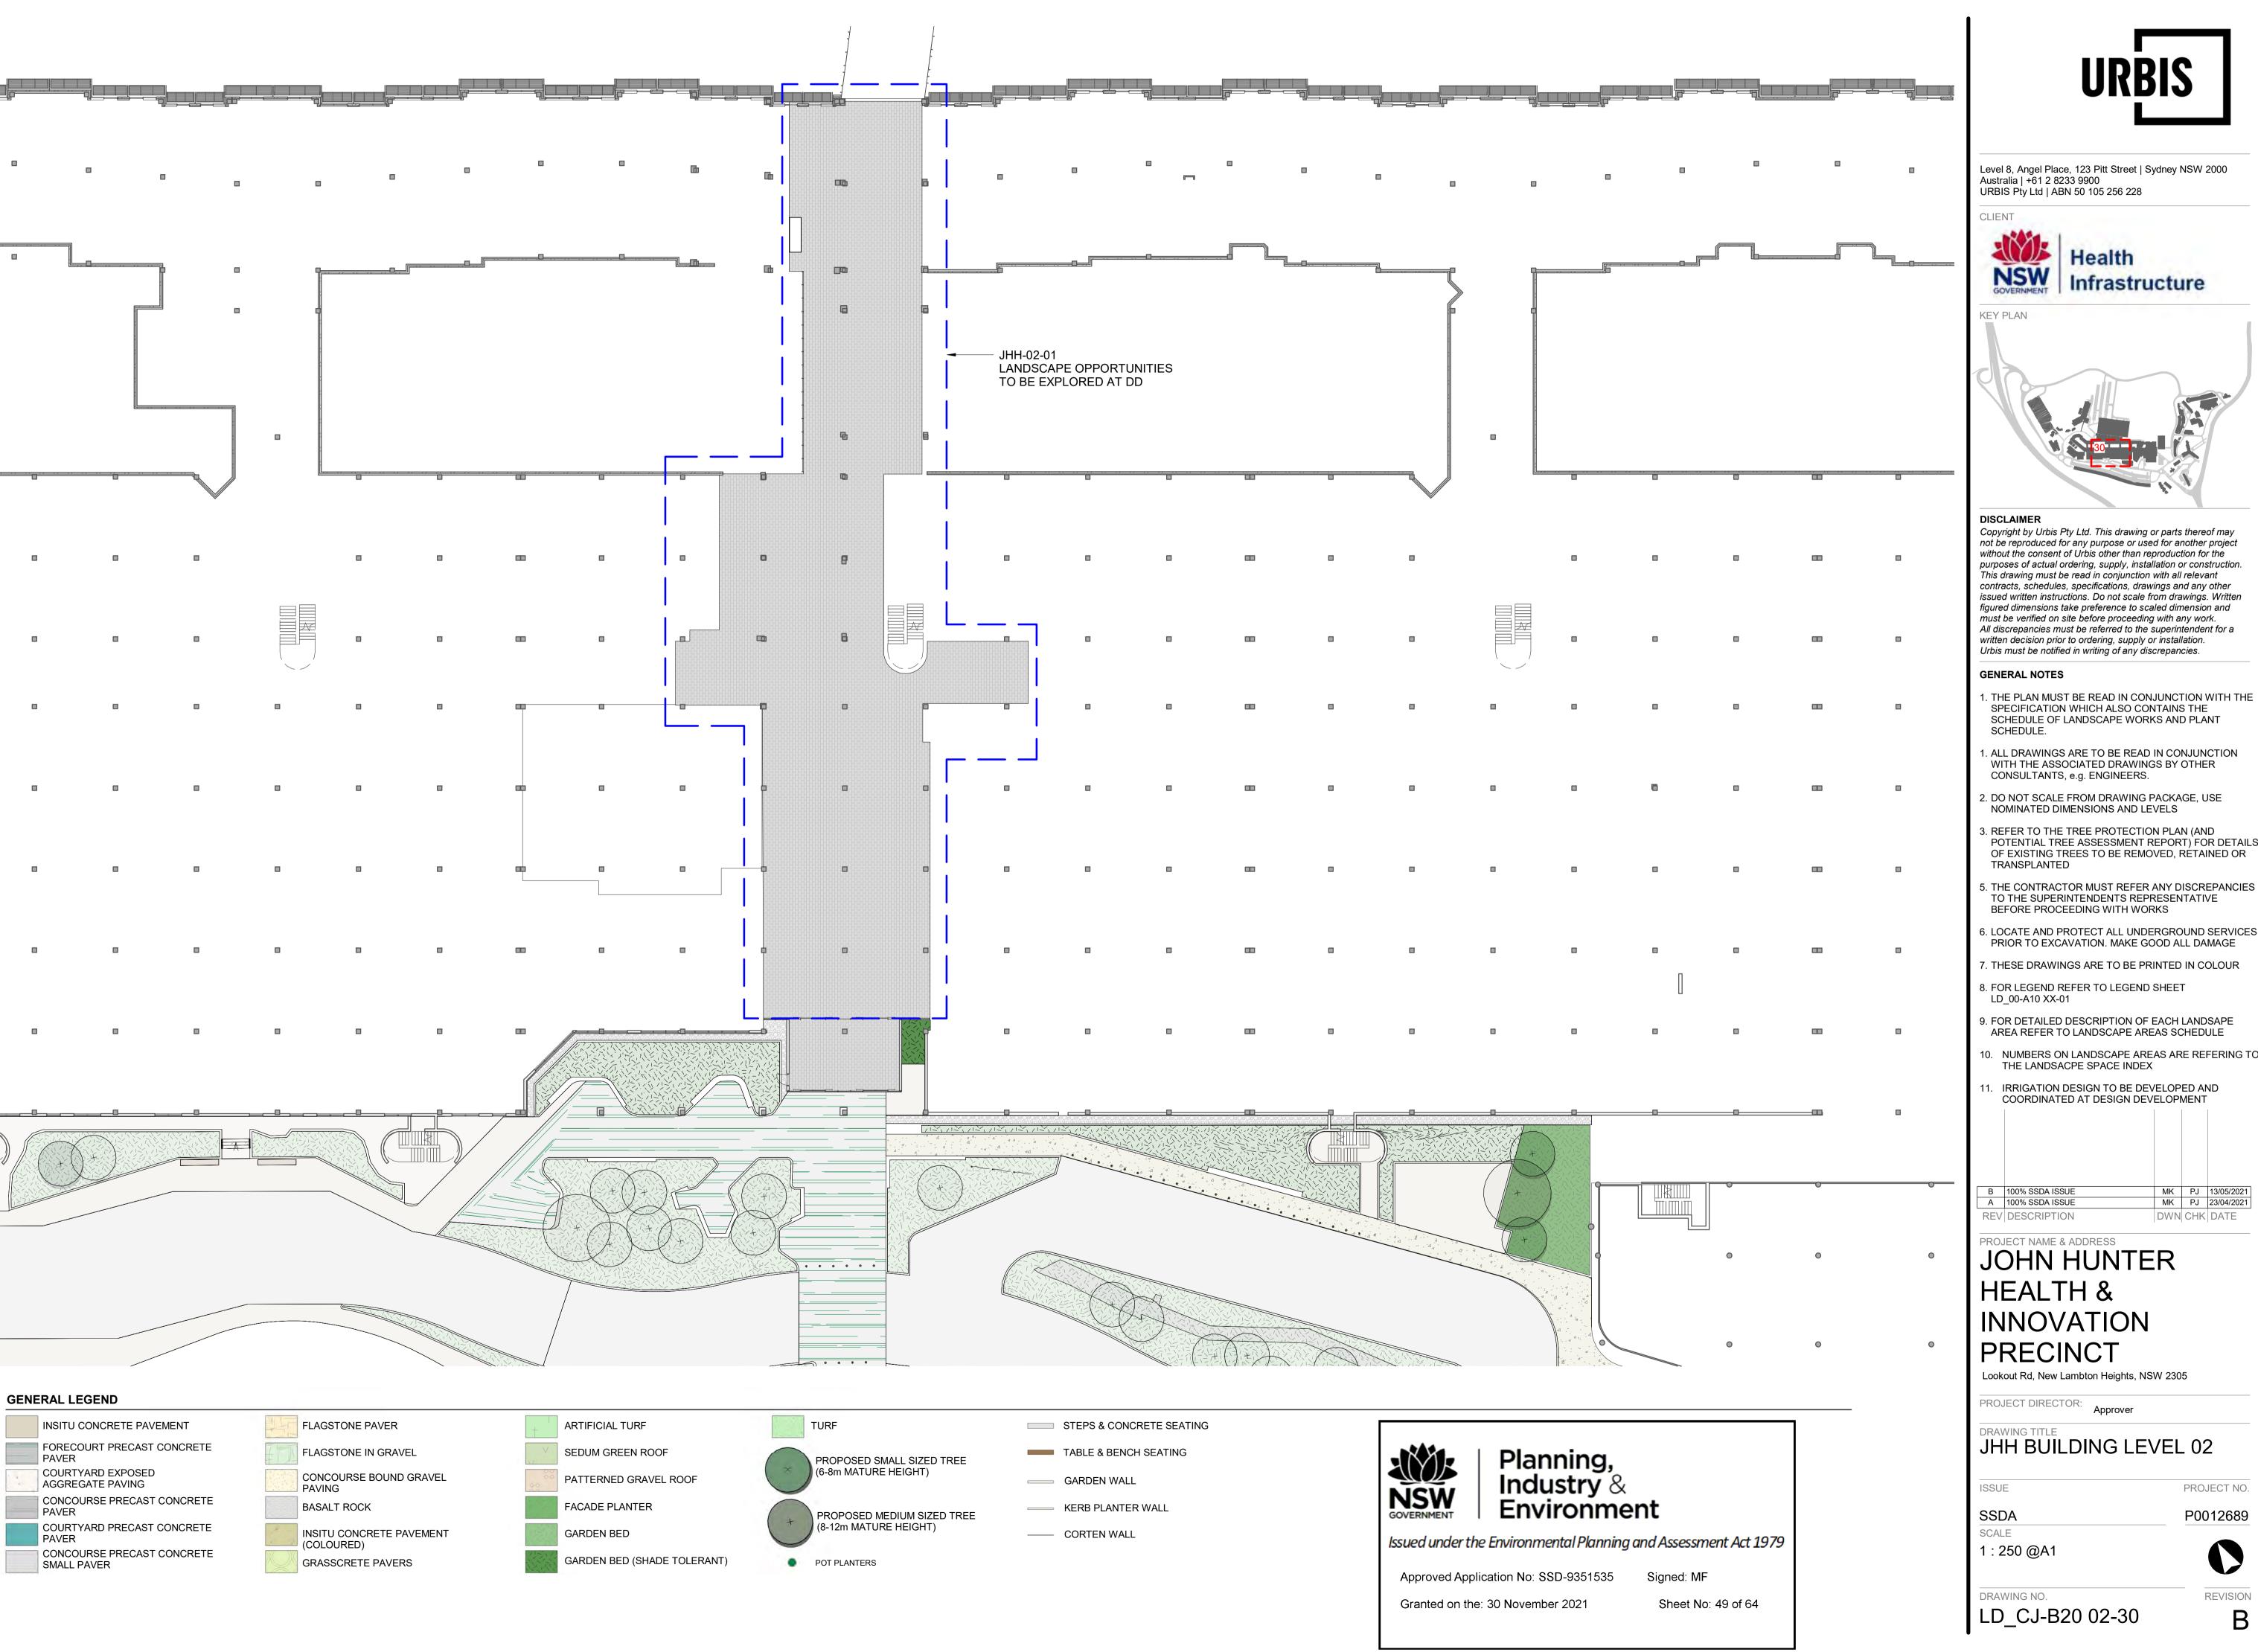

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JOHN HUNTER HEALTH & INNOVATION PRECINCT

Lookout Rd, New Lambton Heights, NSW 2305


PROJECT DIRECTOR: Approver


JHH BUILDING LEVEL 02

PROJECT NO.


P0012689

LD CJ-B20 02-30

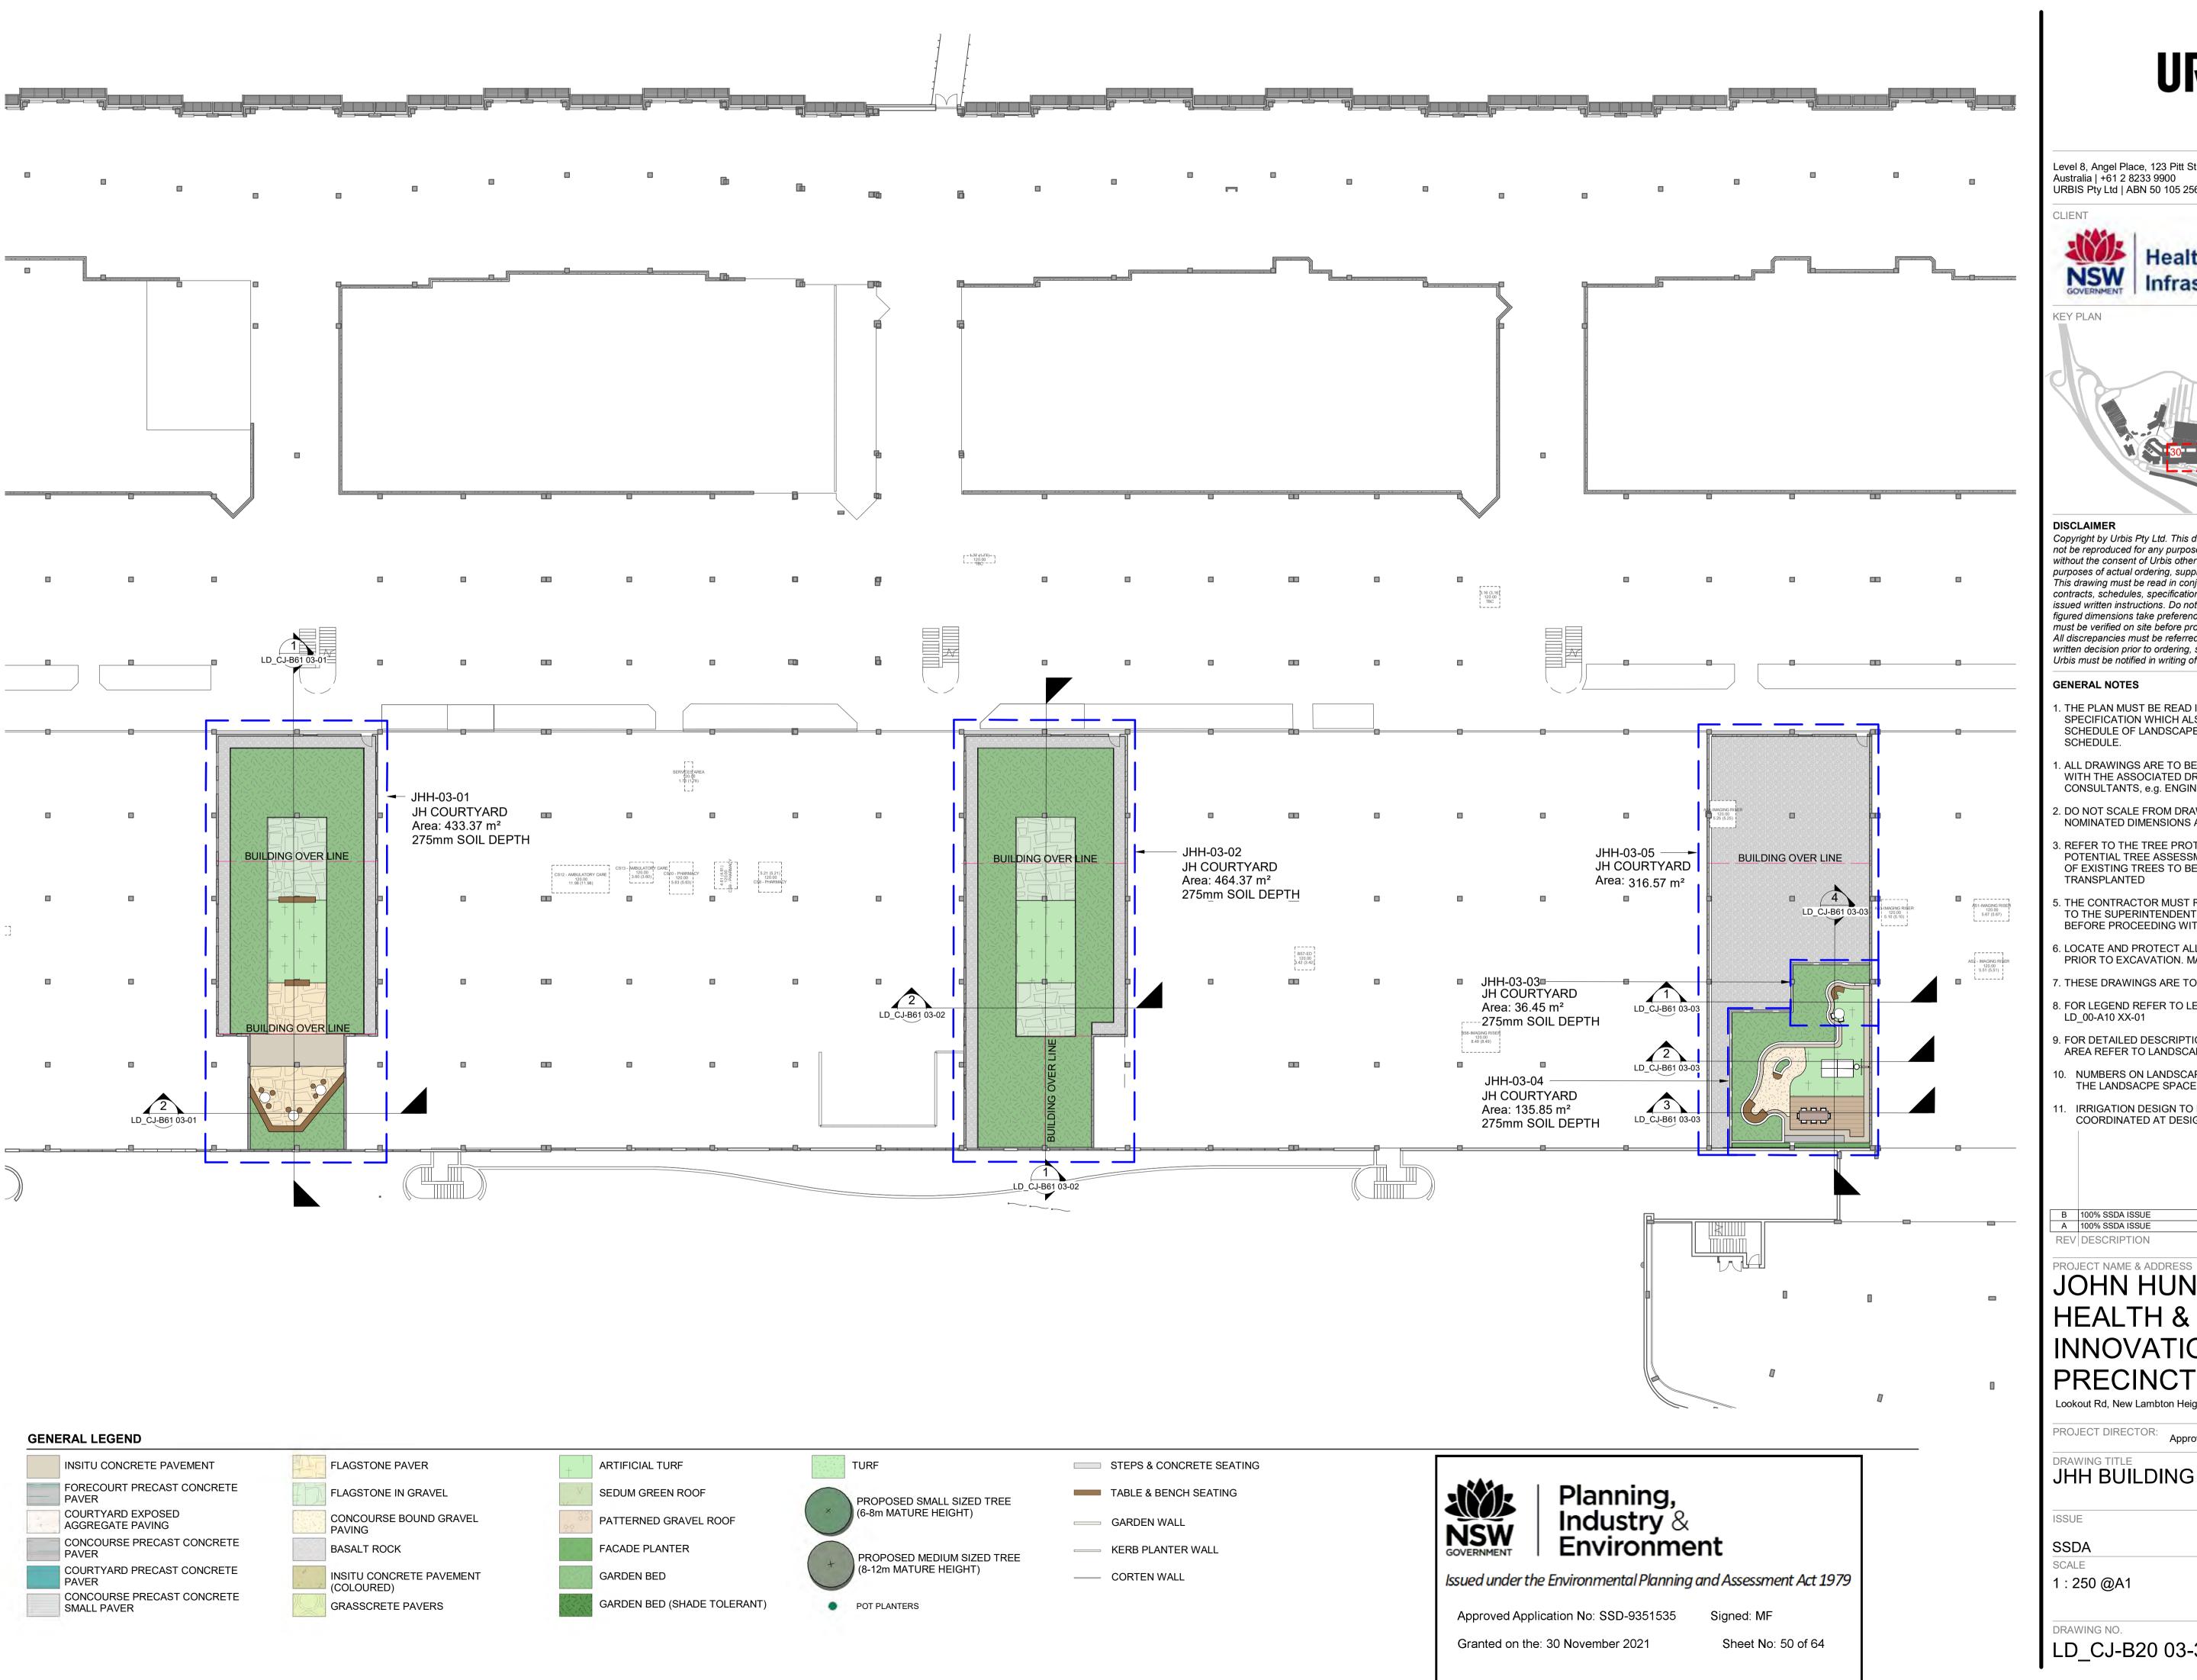

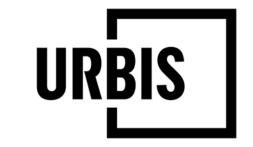



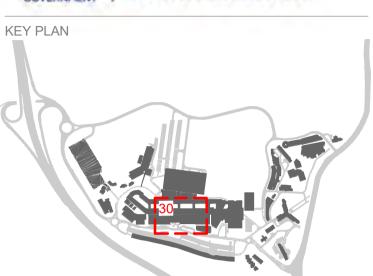

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- 6. LOCATE AND PROTECT ALL UNDERGROUND SERVICES PRIOR TO EXCAVATION. MAKE GOOD ALL DAMAGE
- 7. THESE DRAWINGS ARE TO BE PRINTED IN COLOUR
- 8. FOR LEGEND REFER TO LEGEND SHEET LD_00-A10 XX-01
- 9. FOR DETAILED DESCRIPTION OF EACH LANDSAPE AREA REFER TO LANDSCAPE AREAS SCHEDULE
- 10. NUMBERS ON LANDSCAPE AREAS ARE REFERING TO THE LANDSACPE SPACE INDEX
- 11. IRRIGATION DESIGN TO BE DEVELOPED AND COORDINATED AT DESIGN DEVELOPMENT

MK PJ 13/05/2021 MK PJ 23/04/2021 B 100% SSDA ISSUE A 100% SSDA ISSUE

REV DESCRIPTION

JOHN HUNTER HEALTH & INNOVATION PRECINCT

Lookout Rd, New Lambton Heights, NSW 2305


PROJECT DIRECTOR: Approver

JHH BUILDING LEVEL 03


PROJECT NO. P0012689

DWN CHK DATE

LD_CJ-B20 03-30

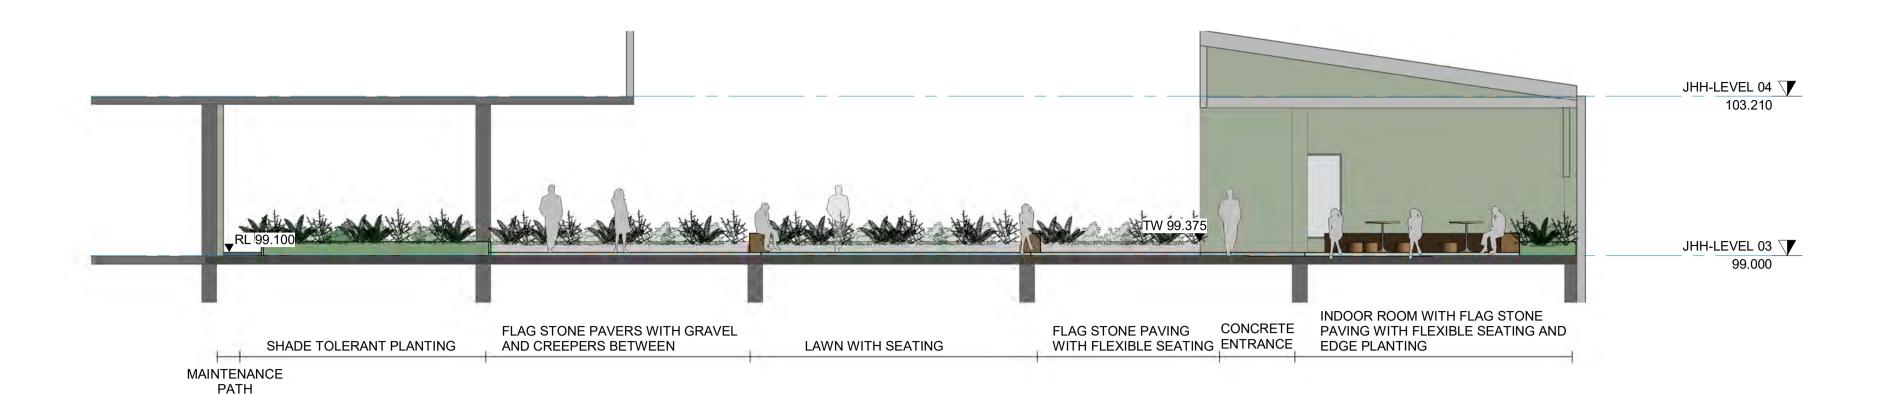

1 SECTION 1 - JH BUILDING LEVEL 03 - COURTYARD 1 (1:100)
LD_BJ-B20 03-32

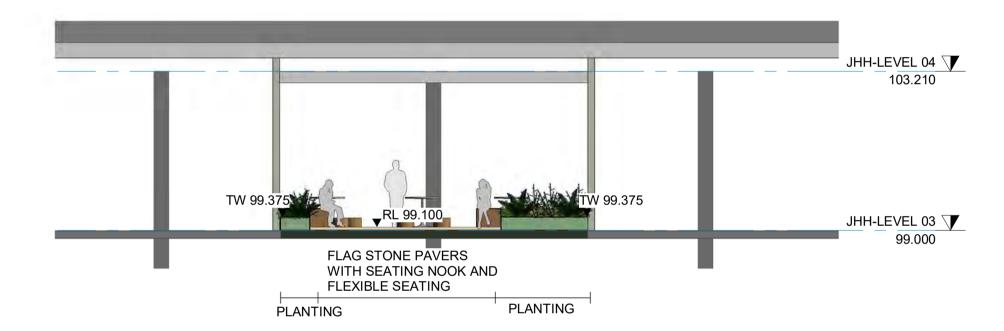

2 SECTION 2 - JH BUILDING LEVEL 03 - COURTARD 1 (1:100)
LD_BJ-B20 03-32



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Approved Application No: SSD-9351535 Signed: MF


Granted on the: 30 November 2021 Sheet No: 51 of 64

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- TO THE SUPERINTENDENTS REPRESENTATIVE BEFORE PROCEEDING WITH WORKS

 6. LOCATE AND PROTECT ALL UNDERGROUND SERVICES PRIOR TO EXCAVATION. MAKE GOOD ALL DAMAGE

5. THE CONTRACTOR MUST REFER ANY DISCREPANCIES

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B 100% SSDA ISSUE MK PJ 13/05/2021
A 100% SSDA ISSUE MK PJ 23/04/2021

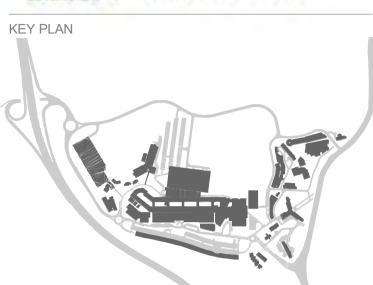DEV DESCRIPTION DATE

REV DESCRIPTION DWN CHK DATE

PROJECT NAME & ADDRESS

JOHN HUNTER HEALTH & INNOVATION PRECINCT

Lookout Rd, New Lambton Heights, NSW 2305

PROJECT DIRECTOR:

JHH BUILDING LEVEL 03
COURTYARD 1 SECTIONS

SUE PROJECT I

SCALE


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1 : 100 @A1


DRAWING NO.

LD_CJ-B61 03-01

REVISION

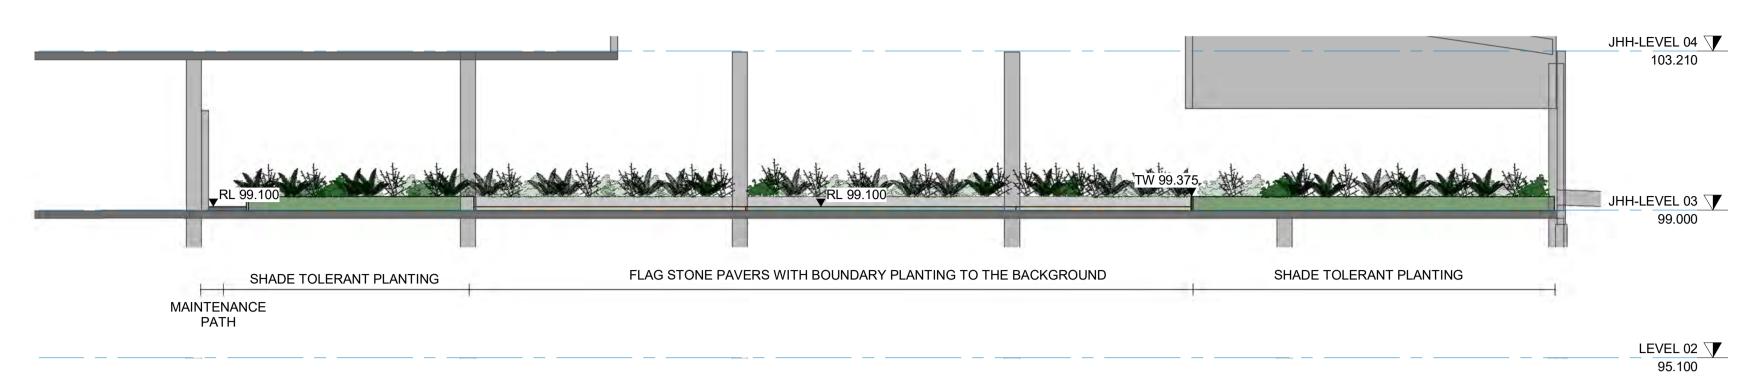

1 SECTION 1 - JH BUILDING LEVEL 03 - COURTYARD 2 (1:100)

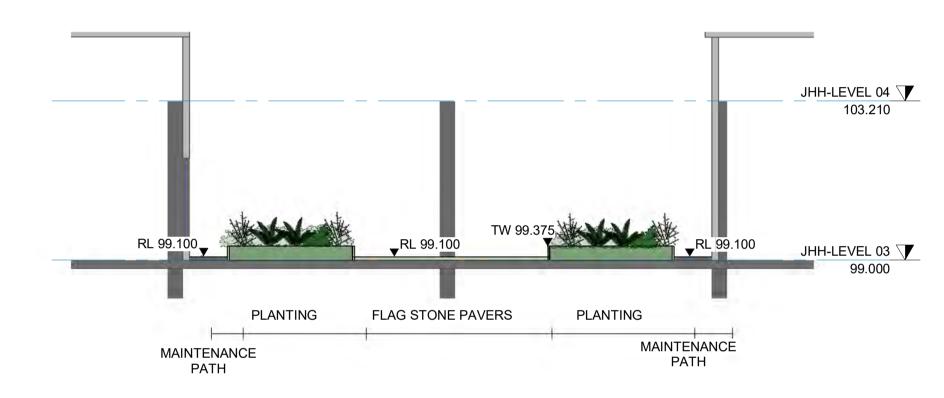

2 SECTION 2 - JH BUILDING LEVEL 03 - COURTARD 2 (1:100)



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Approved Application No: SSD-9351535


Signed: MF

Granted on the: 30 November 2021

Sheet No: 52 of 64

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B 100% SSDA ISSUE A 100% SSDA ISSUE MK PJ 13/05/2021 MK PJ 23/04/2021 REV DESCRIPTION DWN CHK DATE

PROJECT NAME & ADDRESS

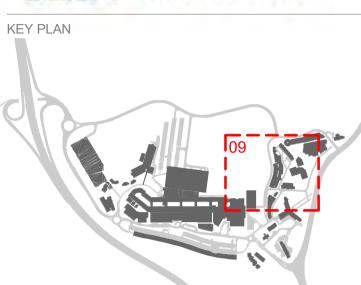JOHN HUNTER HEALTH & INNOVATION PRECINCT

Lookout Rd, New Lambton Heights, NSW 2305

PROJECT DIRECTOR: Approver

DRAWING TITLE JHH BUILDING LEVEL 03

COURTYARD 2 SECTIONS

SSDA SCALE


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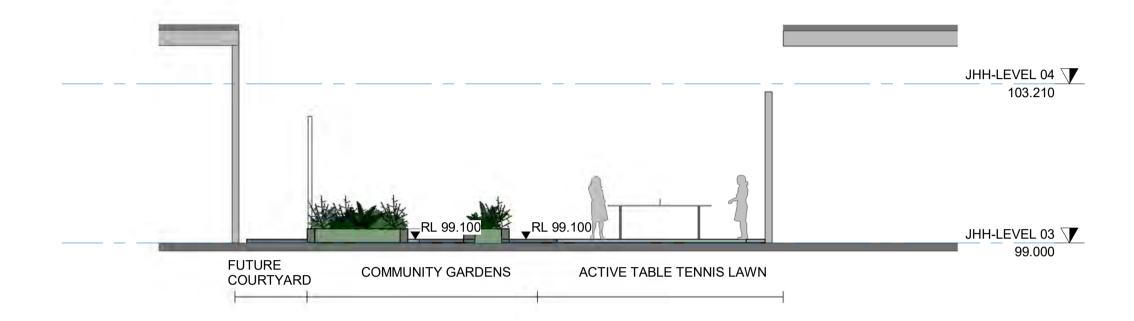


DRAWING NO. LD_CJ-B61 03-02







SECTION 1 - JH BUILDING LEVEL 03 - COURTARD 3 (1:100)

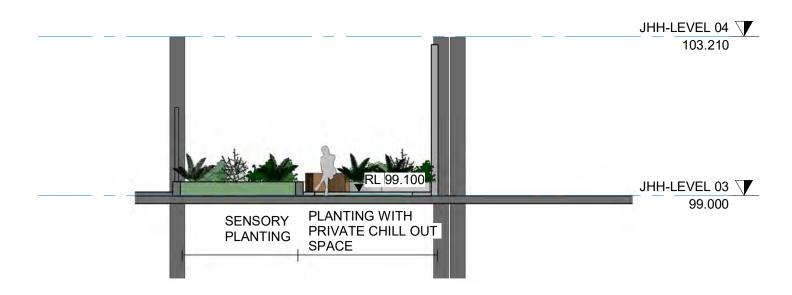

2 SECTION 2 - JH BUILDING LEVEL 03 - COURTARD 3 (1:100)

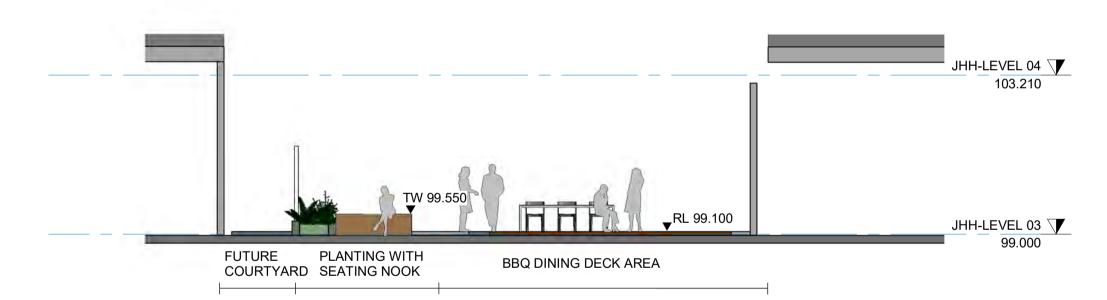

3 SECTION 3 - JH BUILDING LEVEL 03 - COURTARD 3 (1:100)

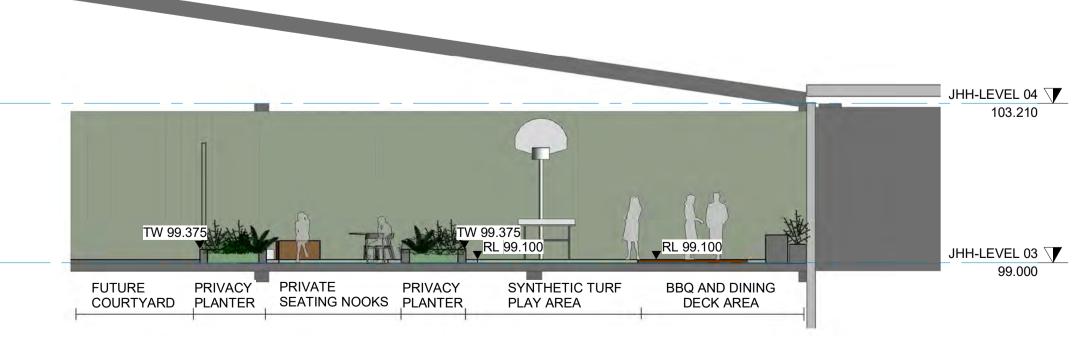

4 SECTION 4 - JH BUILDING LEVEL 03 - COURTARD 3 (1:100)



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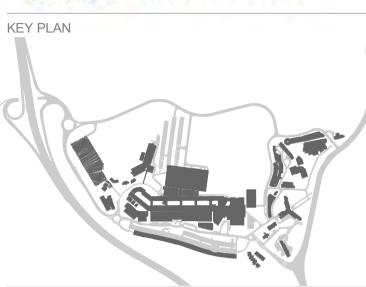
Approved Application No: SSD-9351535

Signed: MF

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MK PJ 13/05/2021 MK PJ 23/04/2021

B 100% SSDA ISSUE A 100% SSDA ISSUE REV DESCRIPTION DWN CHK DATE

PROJECT NAME & ADDRESS

JOHN HUNTER HEALTH & INNOVATION PRECINCT

Lookout Rd, New Lambton Heights, NSW 2305

PROJECT DIRECTOR: Approver

DRAWING TITLE

JHH BUILDING LEVEL 03 COURTYARD 3 SECTIONS

SSDA SCALE

1:100@A1


DRAWING NO.

LD_CJ-B61 03-03

REVISION

JOHN HUNTER HEALTH AND INNOVATION PRECINCT

LOOKOUT ROAD, NEW LAMBTON HEIGHTS **CIVIL SSDA PACKAGE**

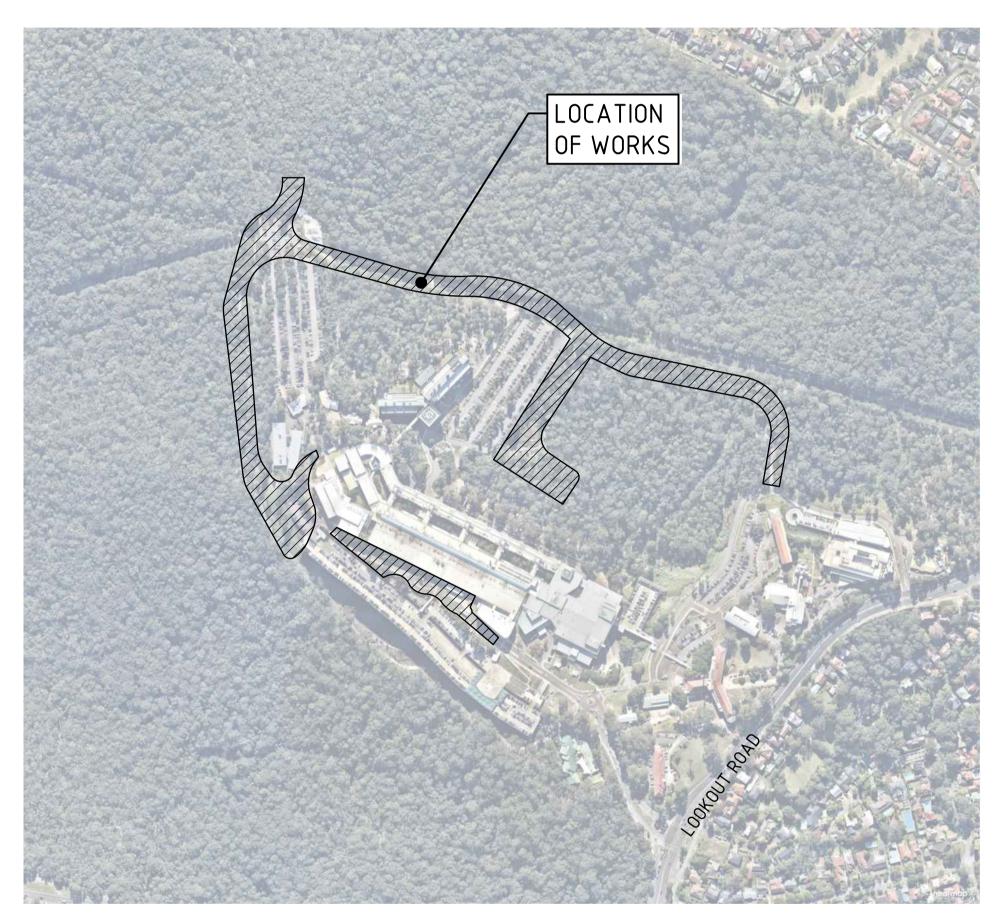

LOCALITY PLAN

DRAWING SCHEDULE

DRAWING TITLE

COVER SHEET, LOCALITY PLAN AND DRAWING SCHEDULE

SOIL AND WATER MANAGEMENT PLAN SOIL AND WATER MANAGEMENT DETAILS SOIL AND WATER MANAGEMENT NOTES

BULK EARTHWORKS PLAN

CIVIL WORKS ARRANGEMENT PLAN

C400-DA ROAD SETOUT PLAN C401-DA **ROAD TYPICAL SECTIONS**

ROAD LONG SECTIONS - SHEET 1 ROAD LONG SECTIONS - SHEET 2 ROAD LONG SECTIONS - SHEET 3



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Approved Application No: SSD-9351535

Granted on the: 30 November 2021

Sheet No: 54 of 64

REVISION DESCRIPTION | ISSUED | VER'D | APP'D | DATE 2 ISSUED FOR REVIEW CS 09.11.20 3 ISSUED FOR SCHEMATIC DESIGN CS 29.01.21 4 ISSUED FOR DRAFT SSDA CS 25.02.21 5 ISSUED FOR DRAFT SSDA LS CS 09.03.21 6 ISSUED FOR SSDA LS CS 31.03.21 CS 30.07.21 7 ISSUED FOR SSDA

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JOHN HUNTER HEALTH AND INNOVATION PRECINCT

> LOOKOUT ROAD, NEW LAMBTON HEIGHTS N.S.W


CIVIL ENGINEERING PACKAGE **COVER SHEET, LOCALITY PLAN**

AND DRAWING SCHEDULE

NL191366 RAWING NUMBER

NORTHROP CONSULTING ENGINEERS PTY LTD


P.O. Box 180, Charlestown NSW 2290 Ph (02) 4943 1777 Fax (02) 4943 1577 Email newcastle@northrop.com.au ABN 81 094 433 100

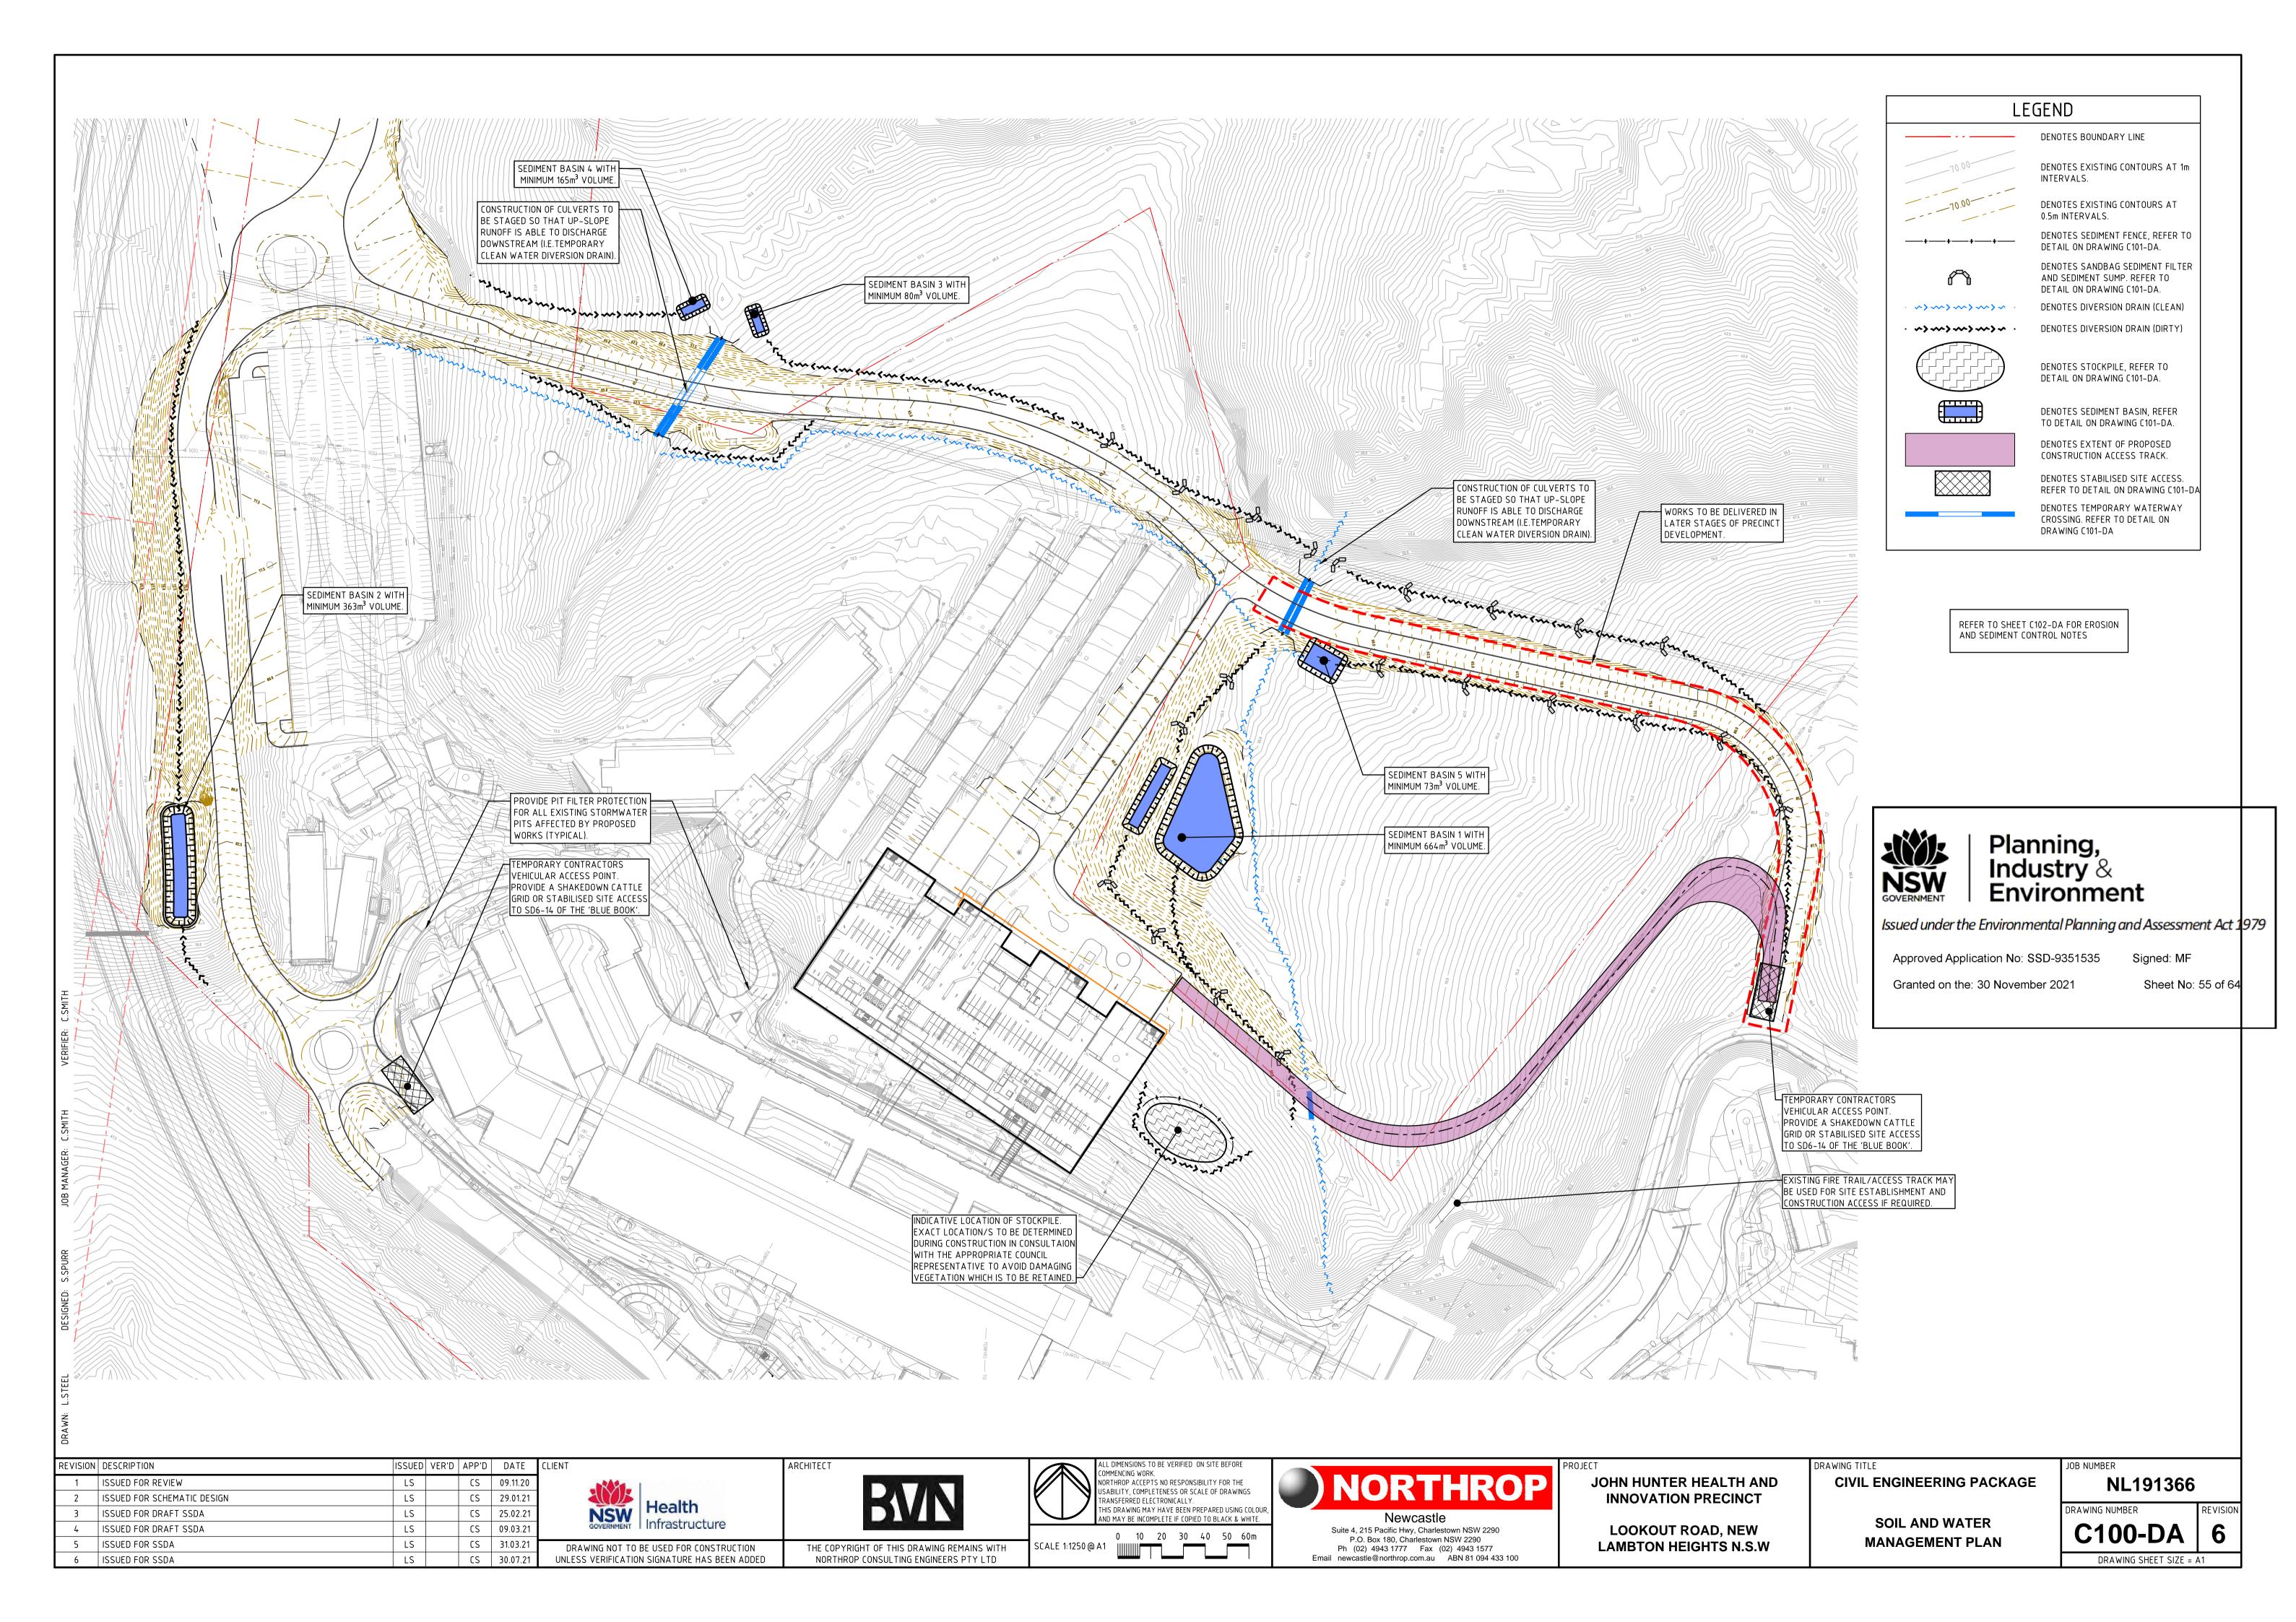

CONSTRUCTION NOTES

- 1. PROHIBIT ALL TRAFFIC UNTIL THE ACCESS WAY IS CONSTRUCTED.
- 2. STRIP ANY TOPSOIL AND PLACE A NEEDLE-PUNCHED TEXTILE OVER THE BASE OF THE CROSSING.
- 3. PLACE CLEAN, RIGID, NON POLLUTING AGGREGATE OR GRAVEL IN THE 100mm TO 150mm SIZE CLASS OVER THE FABRIC TO A MINIMUM DEPTH OF 200mm.
- 4. PROVIDE A 3m WIDE CARRIAGEWAY WITH SUFFICIENT LENGTH OF CULVERT PIPE TO ALLOW LESS THAN A 3(H): 1 (V) SLOPE ON SIDE BATTERS.
- 5. INSTALL A LOWER SECTION TO ACT AS AN EMERGENCY SPILLWAY IN GREATER THAN DESIGN STORM
- 6. ENSURE THAT CULVERT OUTLETS EXTEND BEYOND THE TOE OF FILL EMBANKMENTS.

TEMPORARY WATERWAY CROSSING (SD 5-1)

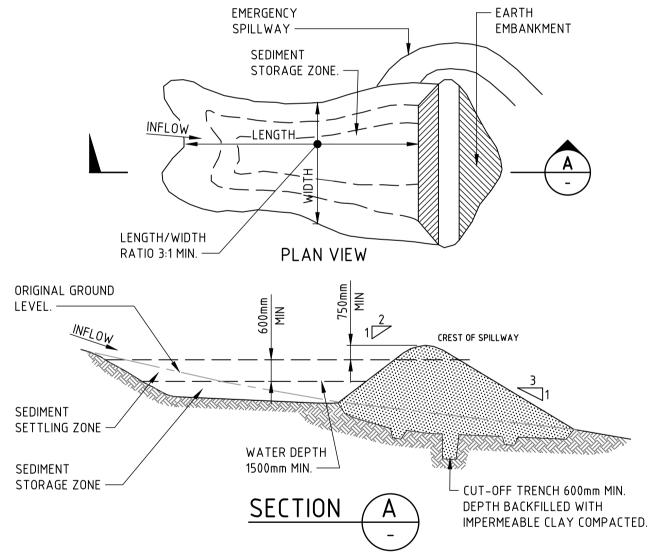


CONSTRUCTION NOTES

6 ISSUED FOR SSDA

- REMOVE ALL VEGETATION AND TOPSOIL FROM UNDER THE DAM WALL AND FROM WITHIN THE STORAGE AREA.
- 2. CONSTRUCT A CUT-OFF TRENCH 500mm DEEP AND 1200mm WIDE ALONG THE CENTRELINE OF THE EMBANKMENT EXTENDING TO A POINT ON THE GULLY WALL LEVEL WITH THE RISER CREST.
- 3. MAINTAIN THE TRENCH FREE OF WATER AND RECOMPACT THE MATERIALS WITH EQUIPMENT AS SPECIFIED IN THE SWMP TO 95 PER CENT STANDARD PROCTOR DENSITY.
- 4. SELECT FILL FOLLOWING THE SWMP THAT IS FREE OF ROOTS, WOOD, ROCK, LARGE STONE OR FOREIGN MATERIAL
- 5. PREPARE THE SITE UNDER THE EMBANKMENT BY RIPPING TO AT LEAST 100mm TO HELP BOND COMPACTED FILL
- 6. SPREAD THE FILL IN 100mm TO 150mm LAYERS AND COMPACT IT AT OPTIMUM MOISTURE CONTENT FOLLOWING THE
- CONSTRUCT THE EMERGENCY SPILLWAY.
- 8. REHABILITATE THE STRUCTURE FOLLOWING THE SWMP.

(APPLIES TO 'TYPE D' AND 'TYPE F' SOILS ONLY) EARTH BASIN - WET (SD 6-4)


CS 30.07.2

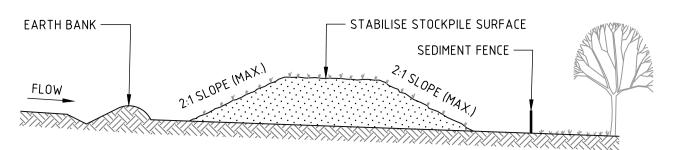

CONSTRUCTION NOTES

- 1. PLACE STOCKPILES MORE THAN 2m (PREFERABLY 5m) FROM EXISTING VEGETATION, CONCENTRATED WATER FLOW, ROADS AND HAZARD AREAS.
- 2. CONSTRUCT ON THE CONTOUR AS LOW, FLAT, ELONGATED MOUNDS.
- 3. WHERE THERE IS SUFFICIENT AREA, TOPSOIL STOCKPILES SHALL BE LESS THAN 2m IN HEIGHT.
- 4. WHERE THEY ARE TO BE IN PLACE FOR MORE THAN 10 DAYS, STABILISE FOLLOWING THE APPROVED ESCP OR SWMP TO REDUCE THE C-FACTOR TO LESS THAN 0.10.
- 5. CONSTRUCT EARTH BANKS (STANDARD DRAWING 5-5) ON THE UPSLOPE SIDE TO DIVERT WATER AROUND STOCKPILES AND SEDIMENT FENCES (STANDARD DRAWING 6-8) 1 TO 2m DOWNSLOPE.


STOCKPILES (SD 4-1)

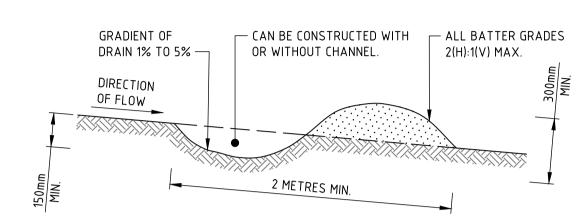

CONSTRUCTION NOTES

- BUILD WITH GRADIENTS BETWEEN 1 AND 5 PERCENT.
- 2. AVOID REMOVING TREES AND SHRUBS IF POSSIBLE WORK AROUND THEM.
- 3. ENSURE THE STRUCTURES ARE FREE OF PROJECTIONS OR OTHER IRREGULARITIES THAT COULD IMPEDE WATER
- 4. BUILD THE DRAINS WITH CIRCULAR, PARABOLIC OR TRAPEZOIDAL CROSS SECTIONS, NOT V SHAPED.
- 5. ENSURE THE BANKS ARE PROPERLY COMPACTED TO PREVENT FAILURE.
- 6. COMPLETE PERMANENT OR TEMPORARY STABILISATION WITHIN 10 DAYS OF CONSTRUCTION.


NOTE: ONLY TO BE USED AS TEMPORARY BANK WHERE MAXIMUM UPSLOPE LENGTH IS 80 METRES. EARTH BANK - LOW FLOW (SD 5-5)

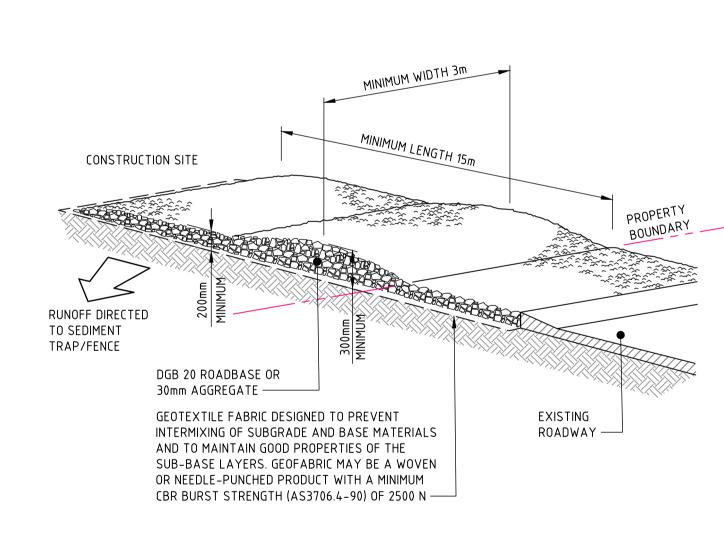

CONSTRUCTION NOTES

- 1. STRIP THE TOPSOIL, LEVEL THE SITE AND COMPACT THE SUBGRADE.
- 2. COVER THE AREA WITH NEEDLE-PUNCHED GEOTEXTILE.
- CONSTRUCT A 200mm THICK PAD OVER THE GEOTEXTILE USING ROAD BASE OR 30mm AGGREGATE.
- 4. ENSURE THE STRUCTURE IS AT LEAST 15 METRES LONG OR TO BUILDING ALIGNMENT AND AT LEAST 3 METRES
- 5. WHERE A SEDIMENT FENCE JOINS ONTO THE STABILISED ACCESS, CONSTRUCT A HUMP IN THE STABILISED ACCESS TO DIVERT WATER TO THE SEDIMENT FENCE.


STABILISED SITE ACCESS (SD 6-14)

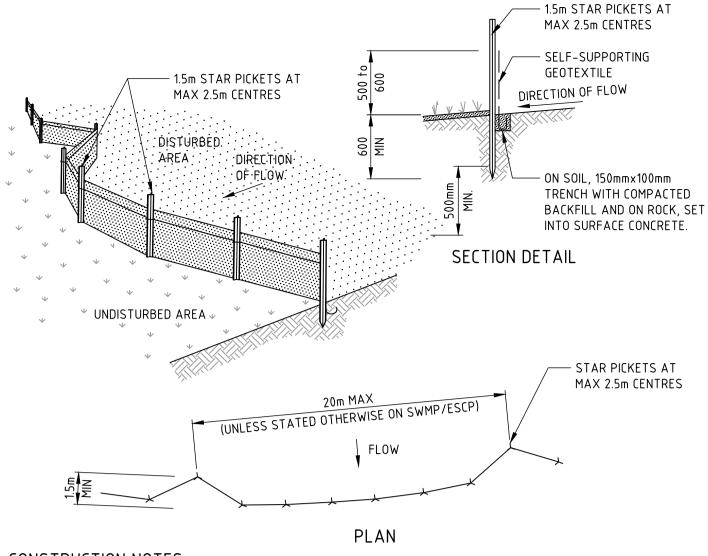

CONSTRUCTION NOTES

- CONSTRUCT SEDIMENT FENCES AS CLOSE AS POSSIBLE TO BEING PARALLEL TO THE CONTOURS OF THE SITE, BUT WITH SMALL RETURNS AS SHOWN IN THE DRAWING TO LIMIT THE CATCHMENT AREA OF ANY ONE SECTION. THE CATCHMENT AREA SHOULD BE SMALL ENOUGH TO LIMIT WATER FLOW IF CONCENTRATED AT ONE POINT TO 50 LITRES PER SECOND IN THE DESIGN STORM EVENT, USUALLY THE 10-YEAR EVENT
- 2. CUT A 150mm DEEP TRENCH ALONG THE UPSLOPE LINE OF THE FENCE FOR THE BOTTOM OF THE FABRIC TO BE ENTRENCHED.
- 3. DRIVE 1.5 METRE LONG STAR PICKETS INTO GROUND AT 2.5 METRE INTERVALS (MAX) AT THE DOWNSLOPE EDGE OF THE TRENCH. ENSURE ANY STAR PICKETS ARE FITTED WITH SAFETY CAPS.
- FIX SELF-SUPPORTING GEOTEXTILE TO THE UPSLOPE SIDE OF THE POSTS ENSURING IT GOES TO THE BASE OF THE TRENCH. FIX THE GEOTEXTILE WITH WIRE TIES OR AS RECOMMENDED BY THE MANUFACTURER. ONLY USE GEOTEXTILE SPECIFICALLY PRODUCED FOR SEDIMENT FENCING. THE USE OF SHADE CLOTH FOR THIS PURPOSE IS NOT SATISFACTORY.
- 5. JOIN SECTIONS OF FABRIC AT A SUPPORT POST WITH A 150mm OVERLAP.
- 6. BACKFILL THE TRENCH OVER THE BASE OF THE FABRIC AND COMPACT IT THOROUGHLY OVER THE GEOTEXTILE.

SEDIMENT FENCE (SD 6-8)

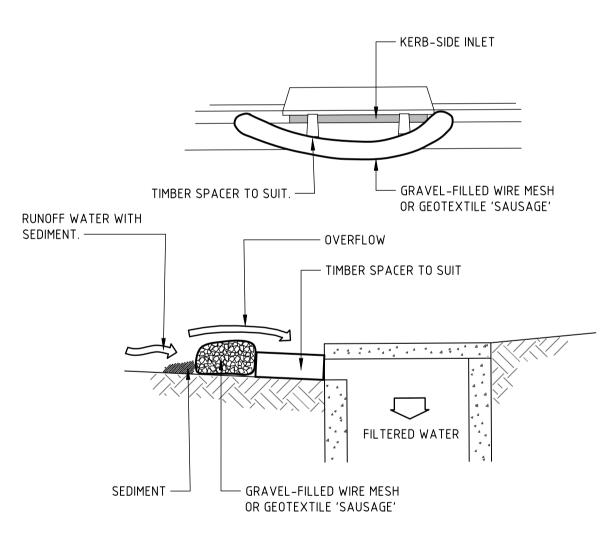

NOTE: THIS PRACTICE ONLY TO BE USED WHERE SPECIFIED IN APPROVED SWMP/ESCP.

CONSTRUCTION NOTES

- 1. INSTALL FILTERS TO KERB INLETS ONLY AT SAG POINTS.
- 2. FABRICATE A SLEEVE MADE FROM GEOTEXTILE OR WIRE MESH LONGER THAN THE LENGTH OF THE INLET PIT AND FILL IT WITH 25mm TO 50mm GRAVEL.
- 3. FORM AN ELLIPTICAL CROSS-SECTION ABOUT 150mm HIGH x 400mm WIDE.
- 4. PLACE THE FILTER AT THE OPENING LEAVING AT LEAST A 100mm SPACE BETWEEN IT AND THE KERB INLET. MAINTAIN THE OPENING WITH SPACER BLOCKS.
- 5. FORM A SEAL WITH THE KERB TO PREVENT SEDIMENT BYPASSING THE FILTER.
- 6. SANDBAGS FILLED WITH GRAVEL CAN SUBSTITUTE FOR THE MESH OR GEOTEXTILE PROVIDING THEY ARE PLACED SO THAT THEY FIRMLY ABUT EACH OTHER AND SEDIMENT-LADEN WATERS CANNOT PASS BETWEEN.

MESH AND GRAVEL INLET FILTER (SD 6-11)

Industry & **Environment**

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Approved Application No: SSD-9351535

Signed: MF

Granted on the: 30 November 2021

Sheet No: 56 of 64


REVISION DESCRIPTION |ISSUED| VER'D | APP'D | DATE 1 ISSUED FOR REVIEW CS 09.11.20 2 ISSUED FOR SCHEMATIC DESIGN LS CS 29.01.21 ISSUED FOR DRAFT SSDA CS 25.02.21 LS CS 09.03.21 4 ISSUED FOR DRAFT SSDA CS 31.03.21 5 ISSUED FOR SSDA LS

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Ph (02) 4943 1777 Fax (02) 4943 1577 Email newcastle@northrop.com.au ABN 81 094 433 100 JOHN HUNTER HEALTH AND **INNOVATION PRECINCT**

> LOOKOUT ROAD, NEW LAMBTON HEIGHTS N.S.W

CIVIL ENGINEERING PACKAGE

SOIL AND WATER MANAGEMENT DETAILS NL191366

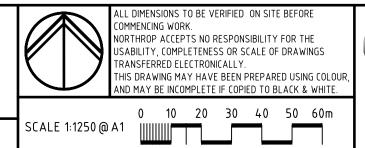DRAWING NUMBER

DRAWING SHEET SIZE = A1

6

- PRIOR TO ANY ACTIVITIES ONSITE, THE RESPONSIBLE PERSON(S) IS TO BE NOMINATED. THE RESPONSIBLE PERSON(S) WILL BE RESPONSIBLE FOR THE EROSION AND SEDIMENT CONTROL (ESC) MEASURES ONSITE.
- 3. THE APPROVED SWMP MUST BE AVAILABLE ON-SITE FOR INSPECTION BY COUNCIL OFFICERS WHILE WORK ACTIVITIES ARE OCCURRING.
- 4. ALL EROSION AND SEDIMENT CONTROL MEASURES MUST BE APPROPRIATE FOR THE SEDIMENT TYPE(S) OF THE SOILS ONSITE. IN ACCORDANCE WITH THE BLUE BOOK (MANAGING URBAN STORMWATER - SOILS AND CONSTRUCTION. LANDCOM. 2004). OR OTHER CURRENT RECOGNISED INDUSTRY STANDARD FOR EROSION AND SEDIMENT CONTROL FOR AUSTRALIAN CONDITIONS. THIS INCLUDES SEDIMENT TRAPS, TREATMENT OF CAPTURED WATER, AND LINING OF CHANNELS.
- NO LAND-DISTURBING ACTIVITIES ON THE SITE SHALL OCCUR UNTIL ALL PERIMETER ESC MEASURES, SEDIMENT BASINS. AND ASSOCIATED TEMPORARY DRAINAGE CONTROLS, HAVE BEEN CONSTRUCTED AND ARE FULLY OPERATIONAL, IN ACCORDANCE WITH CURRENT BEST PRACTICE ESC. THIS IS UNLESS SUCH CLEARING IS REQUIRED FOR THE PURPOSE OF INSTALLING SUCH MEASURES, IN WHICH CASE ONLY THE MINIMUM CLEARING REQUIRED TO INSTALL SUCH MEASURES SHALL OCCUR.
- ADDITIONAL ESC MEASURES MUST BE IMPLEMENTED, AND A REVISED SWMP IS TO BE SUBMITTED FOR APPROVAL TO THE CERTIFIER (WITHIN FIVE (5) BUSINESSDAYS OF ANY SUCH AMENDMENTS) IN THE EVENT
- (i) THERE IS A HIGH PROBABILITY THAT SERIOUS OR MATERIAL ENVIRONMENTAL HARM MAY OCCUR AS A RESULT OF SEDIMENT LEAVING THE SITE; OR
- (ii) THE IMPLEMENTED WORKS FAIL TO ACHIEVE COUNCIL'S WATER QUALITY OBJECTIVES SPECIFIED IN THESE CONDITIONS; OR
- (iii) SITE CONDITIONS SIGNIFICANTLY CHANGE; OR
- (iv) SITE INSPECTIONS INDICATE THAT THE IMPLEMENTED WORKS ARE FAILING TO ACHIEVE THE "OBJECTIVE" OF
- (v) A COPY OF ANY AMENDED SWMP MUST BE FORWARDED TO AN APPROPRIATE COUNCIL OFFICER. WITHIN FIVE (5) BUSINESSDAYS OF ANY SUCH AMENDMENTS.
- 7. ALL REASONABLE AND PRACTICABLE MEASURES MUST BE TAKEN TO ENSURE STORMWATER RUNOFF FROM ACCESS ROADS AND STABILISED ENTRY/EXIT SYSTEMS. DRAINS TO AN APPROPRIATE SEDIMENT CONTROL
- 8. THE APPLICANT MUST ENSURE AN ADEQUATE SUPPLY OF ESC. AND APPROPRIATE POLLUTION (I FAN-UP MATERIALS ARE AVAILABLE ON-SITE AT ALL TIMES. THIS INCLUDES CHEMICALS/AGENTS TO TREAT TURBID WATER IN BASINS.
- SEDIMENT DEPOSITED OFF SITE AS A RESULT OF ON-SITE ACTIVITIES MUST BE COLLECTED AND THE AREA CLEANED/REHABILITATED AS SOON AS REASONABLE AND PRACTICABLE.
- 10. NEWLY SEALED HARD-STAND AREAS (E.G. ROADS, DRIVEWAYS AND CAR PARKS) MUST BE SWEPT THOROUGHLY AS SOON AS PRACTICABLE AFTER SEALING/SURFACING TO MINIMISE THE RISK OF COMPONENTS OF THE SURFACING COMPOUND ENTERING STORMWATER DRAINS.
- 11. STOCKPILES OF ERODIBLE MATERIAL MUST BE PROVIDED WITH AN APPROPRIATE PROTECTIVE COVER (SYNTHETIC OR ORGANIC) IF THE MATERIALS ARE LIKELY TO BE STOCKPILED FOR MORE THAN 10 DAYS.
- 12. STOCKPILES, TEMPORARY OR PERMANENT, SHALL NOT BE LOCATED IN AREAS IDENTIFIED AS NO-GO ZONES (INCLUDING, BUT NOT LIMITED TO, RESTRICTED ACCESS AREAS, BUFFER ZONES, OR AREAS OF NON-DISTURBANCE) ON THE ESCP/SWMP;
- 13. PRIORITY MUST BE GIVEN TO THE PREVENTION, OR AT LEAST THE MINIMISATION, OF SOIL EROSION, RATHER THAN THE TRAPPING OF DISPLACED SEDIMENT.
- 14. MEASURES USED TO CONTROL WIND EROSION MUST BE APPROPRIATE FOR THE LOCATION AND PREVENT SOIL EROSION AT ALL TIMES, INCLUDING WORKING HOURS, OUT OF HOURS, WEEKENDS, PUBLIC HOLIDAYS, AND DURING
- 15. THE APPLICATION OF LIQUID OR CHEMICAL-BASED DUST SUPPRESSION MEASURES MUST ENSURE THAT SEDIMENT-LADEN RUNOFF RESULTING FROM SUCH MEASURES (E.G. RUNOFF OF EXCESS WATER) DOES NOT CREATE A TRAFFIC OR ENVIRONMENTAL HAZARD.
- 16. PRIOR TO THE CONTROLLED DISCHARGE (E.G. DE-WATERING ACTIVITIES FROM EXCAVATIONS AND SEDIMENT BASINS) OF ANY WATER FROM THE SITE DURING CONSTRUCTION, THE FOLLOWING WATER QUALITY OBJECTIVES MUST BE ACHIEVED:
 - a) TOTAL SUSPENDED SOLIDS (TSS) TO A MAXIMUM 50MG/L;
 - b) TURBIDITY (NTUS) TO A MAXIMUM OF 60 NTU MEASURED BY A TURBIDITY METER;
- c) WATER PH BETWEEN 6.5 AND 8.5 UNLESS OTHERWISE REQUIRED BY THE COUNCIL; AND
- d) EC LEVELS NO GREATER THAN BACKGROUND LEVELS.
- 17. PRIOR TO ANY FORECAST WEATHER EVENT LIKELY TO RESULT IN SEDIMENT LADEN RUNOFF ON THE SITE, ANY EXISTING DETENTION BASINS/TRAPS SHALL BE DEWATERED TO PROVIDE SUFFICIENT CAPACITY TO CAPTURE SEDIMENT LADEN WATER FROM THE SITE PRIOR TO THE WEATHER EVENT.
- 18. ANY SEDIMENT-LADEN WATER CAPTURED ONSITE MUST BE TREATED TO ENSURE IT WILL ACHIEVE COUNCIL'S WATER QUALITY OBJECTIVES SPECIFIED IN THESE CONDITIONS, PRIOR TO ITS RELEASE FROM SITE. A SAMPLE OF THE RELEASED TREATED WATER MUST BE KEPT ONSITE IN A CLEAR CONTAINER WITH THE SAMPLE DATE

- 19. NO ALUMINIUM BASED PRODUCTS MAY BE USED TREAT TURBID WATER (FLOCCULATING/COAGULANTS) ONSITE WITHOUT THE PRIOR WRITTEN PERMISSION FROM AN APPROPRIATE COUNCIL OFFICER. THE APPLICANT MUST HAVE A DEMONSTRATED ABILITY TO USE SUCH PRODUCTS CORRECTLY AND WITHOUT ENVIRONMENTAL HARM PRIOR TO ANY APPROVAL
- 20. THE CHEMICAL/AGENT (FLOCCULATING/COAGULANTS) USED IN TYPE D AND TYPE F BASINS TO TREAT TURBID WATER CAPTURED IN THE BASIN MUST BE APPLIED IN CONCENTRATIONS SUFFICIENT TO ACHIEVE COUNCIL'S WATER QUALITY OBJECTIVES, SPECIFIED IN THESE CONDITIONS, WITHIN THE X-DAY RAINFALL DEPTH USED TO CALCULATE THE CAPACITY OF THE BASIN, AFTER A RAINFALL EVENT.
- 21. ALL MANUFACTURERS INSTRUCTIONS MUST BE FOLLOWED FOR THE USE OF ANY CHEMICALS/AGENTS USED ONSITE, EXCEPT WHERE APPROVED BY THE RESPONSIBLE PERSON OR AN APPROPRIATE COUNCIL OFFICER.
- 22. ANY BASIN MUST BE DEWATERED AS SOON AS PRACTICAL, ONCE WATER CAPTURED IN THE BASIN ACHIEVES COUNCIL'S WATER QUALITY OBJECTIVES, SPECIFIED IN THESE CONDITIONS.
- 23. THE APPLICANT MUST ENSURE THAT ON EACH OCCASION A TYPE F OR TYPE D BASIN WAS NOT DE-WATERED PRIOR TO BEING SURCHARGED BY A FOLLOWING RAINFALL EVENT, A REPORT IS PRESENTED TO AN APPROPRIATE COUNCIL OFFICER WITHIN 5 DAYS IDENTIFYING THE CIRCUMSTANCES AND PROPOSED AMENDMENTS, IF ANY, TO THE BASIN'S OPERATING PROCEDURES.
- 24. WHERE MORE THAN ONE STAGE IS TO BE DEVELOPED AT ONE TIME, OR BEFORE THE PRECEDING STAGE IS COMPLETE, THE SEDIMENT BASIN(S) FOR THESE STAGES MUST HAVE SUFFICIENT CAPACITY TO CATER FOR ALL AREA DIRECTED TO THE BASIN(S).
- 25. ALL SEDIMENT BASINS MUST REMAIN FULLY OPERATIONAL AT ALL TIMES UNTIL THE BASIN'S DESIGN CATCHMENT ACHIEVES 70% GROUND COVERAGE, OR SURFACE STABILISATION ACCEPTABLE TO COUNCIL.
- 26. SETTLED SEDIMENT MUST BE REMOVED AS SOON AS REASONABLE AND PRACTICABLE FROM ANY SEDIMENT BASIN IN ACCORDANCE WITH THE BLUE BOOK
- 27. ALL SEDIMENT CONTROL DEVICES (OTHER THAN SEDIMENT BASINS) MUST BE DE-SILTED AND MADE FULLY OPERATIONAL AS SOON AS REASONABLE AND PRACTICABLE AFTER RUNOFF-PRODUCING RAINFALL, OR IF THE SEDIMENT RETENTION CAPACITY OF THE DEVICE FALLS BELOW 75% OF THE DESIGN RETENTION CAPACITY.
- 28. PROCEDURES FOR INITIATING A SITE SHUTDOWN, WHETHER PROGRAMMED OR UN-PROGRAMMED, MUST INCORPORATE REVEGETATION OF ALL SOIL DISTURBANCES UNLESS OTHERWISE APPROVED BY COUNCIL. THE STABILISATION WORKS MUST NOT RELY UPON THE LONGEVITY OF NON-VEGETATED EROSION CONTROL BLANKETS, OR TEMPORARY SOIL BINDERS.
- 29. ALL ESC MEASURES MUST BE INSPECTED:
- a) AT LEAST DAILY (WHEN WORK IS OCCURRING ON-SITE); AND
- b) AT LEAST WEEKLY (WHEN WORK IS NOT OCCURRING ON-SITE): AND
- c) WITHIN 24HRS OF EXPECTED RAINFALL; AND
- d) WITHIN 18HRS OF A RAINFALL EVENT THAT CAUSES RUNOFF ON THE SITE). 30. WRITTEN RECORDS MUST BE KEPT ONSITE OF ESC MONITORING AND MAINTENANCE ACTIVITIES CONDUCTED
- DURING THE CONSTRUCTION AND MAINTENANCE PERIODS, AND BE AVAILABLE TO COUNCIL OFFICERS ON
- 31. ALL SITE MONITORING DATA INCLUDING RAINFALL RECORDS, DATES OF WATER QUALITY TESTING, TESTING RESULTS AND RECORDS OF CONTROLLED WATER RELEASES FROM THE SITE, MUST BE KEPT IN AN ON-SITE REGISTER. THE REGISTER IS TO BE MAINTAINED UP TO DATE FOR THE DURATION OF THE APPROVED WORKS AND BE AVAILABLE ON-SITE FOR INSPECTION BY COUNCIL OFFICERS ON REQUEST
- 32. WATER QUALITY SAMPLES FROM SEDIMENT BASIN(S) MUST BE TAKEN AT A DEPTH NO LESS THAN 200MM BELOW THE WATER SURFACE WITHIN THE BASIN.
- 33. ALL ENVIRONMENTAL INCIDENTS MUST BE RECORDED IN A FIELD LOG THAT MUST REMAIN ACCESSIBLE TO ALL RELEVANT REGULATORY AUTHORITIES ON REQUEST.
- 34. ALL MATERIALS REMOVED FROM ESC DEVICES DURING MAINTENANCE, OR DECOMMISSIONING, WHETHER SOLID OR LIQUID, MUST BE DISPOSED OF IN A MANNER THAT DOES NOT CAUSE ANY ONGOING EROSION OR POLLUTION
- 35. INSTALL SEDIMENT PROTECTION FILTERS ON ALL NEW AND EXISTING STORMWATER INLET PITS IN ACCORDANCE WITH EITHER THE MESH AND GRAVEL INLET FILTER DETAIL SD6-11 OR THE GEOTEXTILE INLET FILTER DETAIL SD6-12 OF THE 'BLUE BOOK'.
- 36. ESTABLISH ALL REQUIRED SEDIMENT FENCES IN ACCORDANCE WITH DETAIL SD6-8 OF THE 'BLUE BOOK'.
- 37. ALL TRENCHES INCLUDING ALL SERVICE TRENCHES AND SWALE EXCAVATION SHALL BE SIDE-CAST TO THE HIGH SIDE AND CLOSED AT THE END OF EACH DAYS WORK.
- 38. ALL VEGETATION TO BE REMOVED SHALL BE MULCHED ONSITE AND SPREAD/STOCKPILED AS DIRECTED BY THE SUPERINTENDENT
- 39. ANY SURPLUS MATERIAL SHALL BE REMOVED FROM SITE AND DISPOSED OF IN ACCORDANCE WITH EPA
- 40. CONSTRUCT AND MAINTAIN ALL MATERIAL STOCKPILES IN ACCORDANCE WITH DETAIL SD4-1 OF THE 'BLUE BOOK' (INCLUDING CUT-OFF SWALES TO THE HIGH SIDE AND SEDIMENT FENCES TO THE LOW SIDE).
- 41. ENSURE STOCKPILES DO NOT EXCEED 2.0m HIGH. PROVIDE WIND AND RAIN EROSION PROTECTION AS REQUIRED IN ACCORDANCE WITH THE 'BLUE BOOK'.
- 42. PROVIDE WATER TRUCKS OR SPRINKLER DEVICES DURING CONSTRUCTION AS REQUIRED TO SUPPRESS DUST.
- 43. ONCE CUT/FILL OPERATIONS HAVE BEEN FINALIZED ALL DISTURBED AREAS THAT ARE NOT BEING WORKED ON SHALL BE RE-VEGETATED AS SOON AS IS PRACTICAL, ALTERNATIVELY SPECIFIED EROSION AND SEDIMENT CONTROL MEASURES ARE TO BE RETAINED.

SEDIMENT BASIN CALCULATION

THE SITE IS LOCATED WITHIN THE NEWCASTLESOIL LANDSCAPE, WHICH HAS THE FOLLOWING PROPERTIES (IN ACCORDANCE WITH TABLE C13 OF THE "BLUE BOOK"):

- SEDIMENT TYPE F
- SOIL HYDROLOGY GROUP A
- K-FACTOR OF 0.016 (WORST CASE)

THE SIZING OF THE SEDIMENT STORAGE VOLUME OF THE SITES PROPOSED SEDIMENTATION BASINS WERE CALCULATED BY APPLYING THE REVISED UNIVERSAL SOIL LOSS EQUATION (RUSLE) METHOD

SOIL LOSS = R K LS P C

CALCULATED BY THE RUSLE METHOD:

- WHERE; R = RAINFALL EROSIVITY FACTOR = 2590
 - 2 YEAR, 6 HOUR STORM INTENSITY = 10.9 mm/hr
 - LS = SLOPE LENGTH/GRADIENT FACTOR = 0.7
 - K = SOIL ERODIBILITY FACTOR = 0.016
 - P = EROSION CONTROL PRACTICE (P-FACTOR) = 1.3 (TYPICAL)
 - C = GROUND COVER (C-FACTOR) = 1.0 (TYPICAL FOR STRIPPED SITE)

THE REMAINING VARIABLES ARE PRESENTED WITHIN THE TEMPORARY SEDIMENT BASIN CAPACITY TABLE. THE SETTLING ZONE VOLUME OF THE BASIN WAS CALCULATED FOR A 2 MONTHS SOIL LOSS AS

> SETTLING ZONE VOLUME = 10 CV RX-DAY, Y-%ILE x CATCHMENT AREA WHERE RX-DAY, Y-%TILE = 30.5 mm/hr

[5 DAY, 80th PERCENTILE RAINFALL EVENT, NEWCASTLE]

TOTAL BASIN VOLUME						
SITE	Су	TOTAL CATCHMENT AREA (ha)	SETTLING ZONE VOLUME (m³)	SEDIMENT STORAGE VOLUME (m³)	TOTAL BASIN VOLUME (m³)	
SEDIMENT BASIN 1	0.5	3.29	502	162	664	
SEDIMENT BASIN 2	0.5	2.3	350	13	363	
SEDIMENT BASIN 3	0.5	0.49	74	6	80	
SEDIMENT BASIN 4	0.5	0.84	128	37	165	
SEDIMENT BASIN 5	0.5	0.047	72	1	73	

GROUND COVER FACTORS EXCEED THE FOLLOWING LIMITS:

THE LONG TERM GROUND COVER FACTORS FOR THE CONSTRUCTION WORKS IS NOT TO

LAND	MAXIMUM C-FACTOR	REMARKS
WATERWAYS AND OTHER AREAS OF CONCENTRATED FLOWS, POST CONSTRUCTION	0.05	APPLIES AFTER TEN WORKING DAYS OF COMPLETION OF FORMATION AND BEFORE CONCENTRATED FLOWS ARE APPLIED. FOOT AND VECHICULAR TRAFFIC IS PROHIBITED IN THIS AREA AND 70% GROUND COVER IS REQUIRED.
STOCKPILES, POST CONSTRUCTION	0.10	APPLIES AFTER TEN WORKING DAYS FROM COMPLETION OF FORMATION. 60% GROUND COVER IS REQUIRED.
ALL LANDS, INCLUDUNG WATERWAYS AND STOCKPILES, DURING CONSTRUCTION	0.15	APPLIES AFTER 20 DAYS OF INACTIVITY, EVEN THOUGH WORKS MAY BE INCOMPLETE. 50% GROUND COVER IS REQUIRED.

REVEGETATION

TEMPORARY SEED MIX

SOWING SEASON	SEED MIX
AUTUMN/WINTER	0ATS @40kg/Ha + JAPANESE MILLET @10kg/Ha
SPRING/SUMMER	OATS @10kg/Ha + JAPANESE MILLET @40kg/Ha

THESE PLANT SPECIES ARE FOR TEMPORARY REVEGETATION ONLY. THEY WILL ONLY PROVIDE PROTECTION FROM EROSION FOR SIX MONTHS. WHERE THE LOTS ARE TO BE LEFT UNDEVELOPED FOR A LONGER PERIOD, THE CONTRACTOR SHALL SEEK ADVICE FROM THE SITE SUPERINTENDENT AS TO MORE APPROPRIATE REVEGETATION METHODS.


REVISION DESCRIPTION |ISSUED| VER'D | APP'D | DATE 1 ISSUED FOR REVIEW CS 09.11.20 2 ISSUED FOR SCHEMATIC DESIGN LS CS 29.01.21 3 ISSUED FOR DRAFT SSDA CS 25.02.21 4 ISSUED FOR DRAFT SSDA LS CS 09.03.21 5 ISSUED FOR SSDA LS CS 31.03.2 6 ISSUED FOR SSDA LS CS 30.07.21



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LOOKOUT ROAD, NEW

LAMBTON HEIGHTS N.S.W

SOIL AND WATER MANAGEMENT NOTES

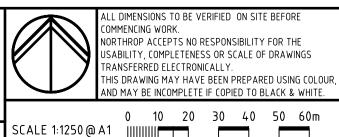Approved Application No: SSD-9351535

Granted on the: 30 November 2021

CIVIL ENGINEERING PACKAGE

Planning,

Industry &


Environment

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Sheet No: 57 of 64

NL191366 DRAWING NUMBER




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SITE EARTHWORKS NOTES

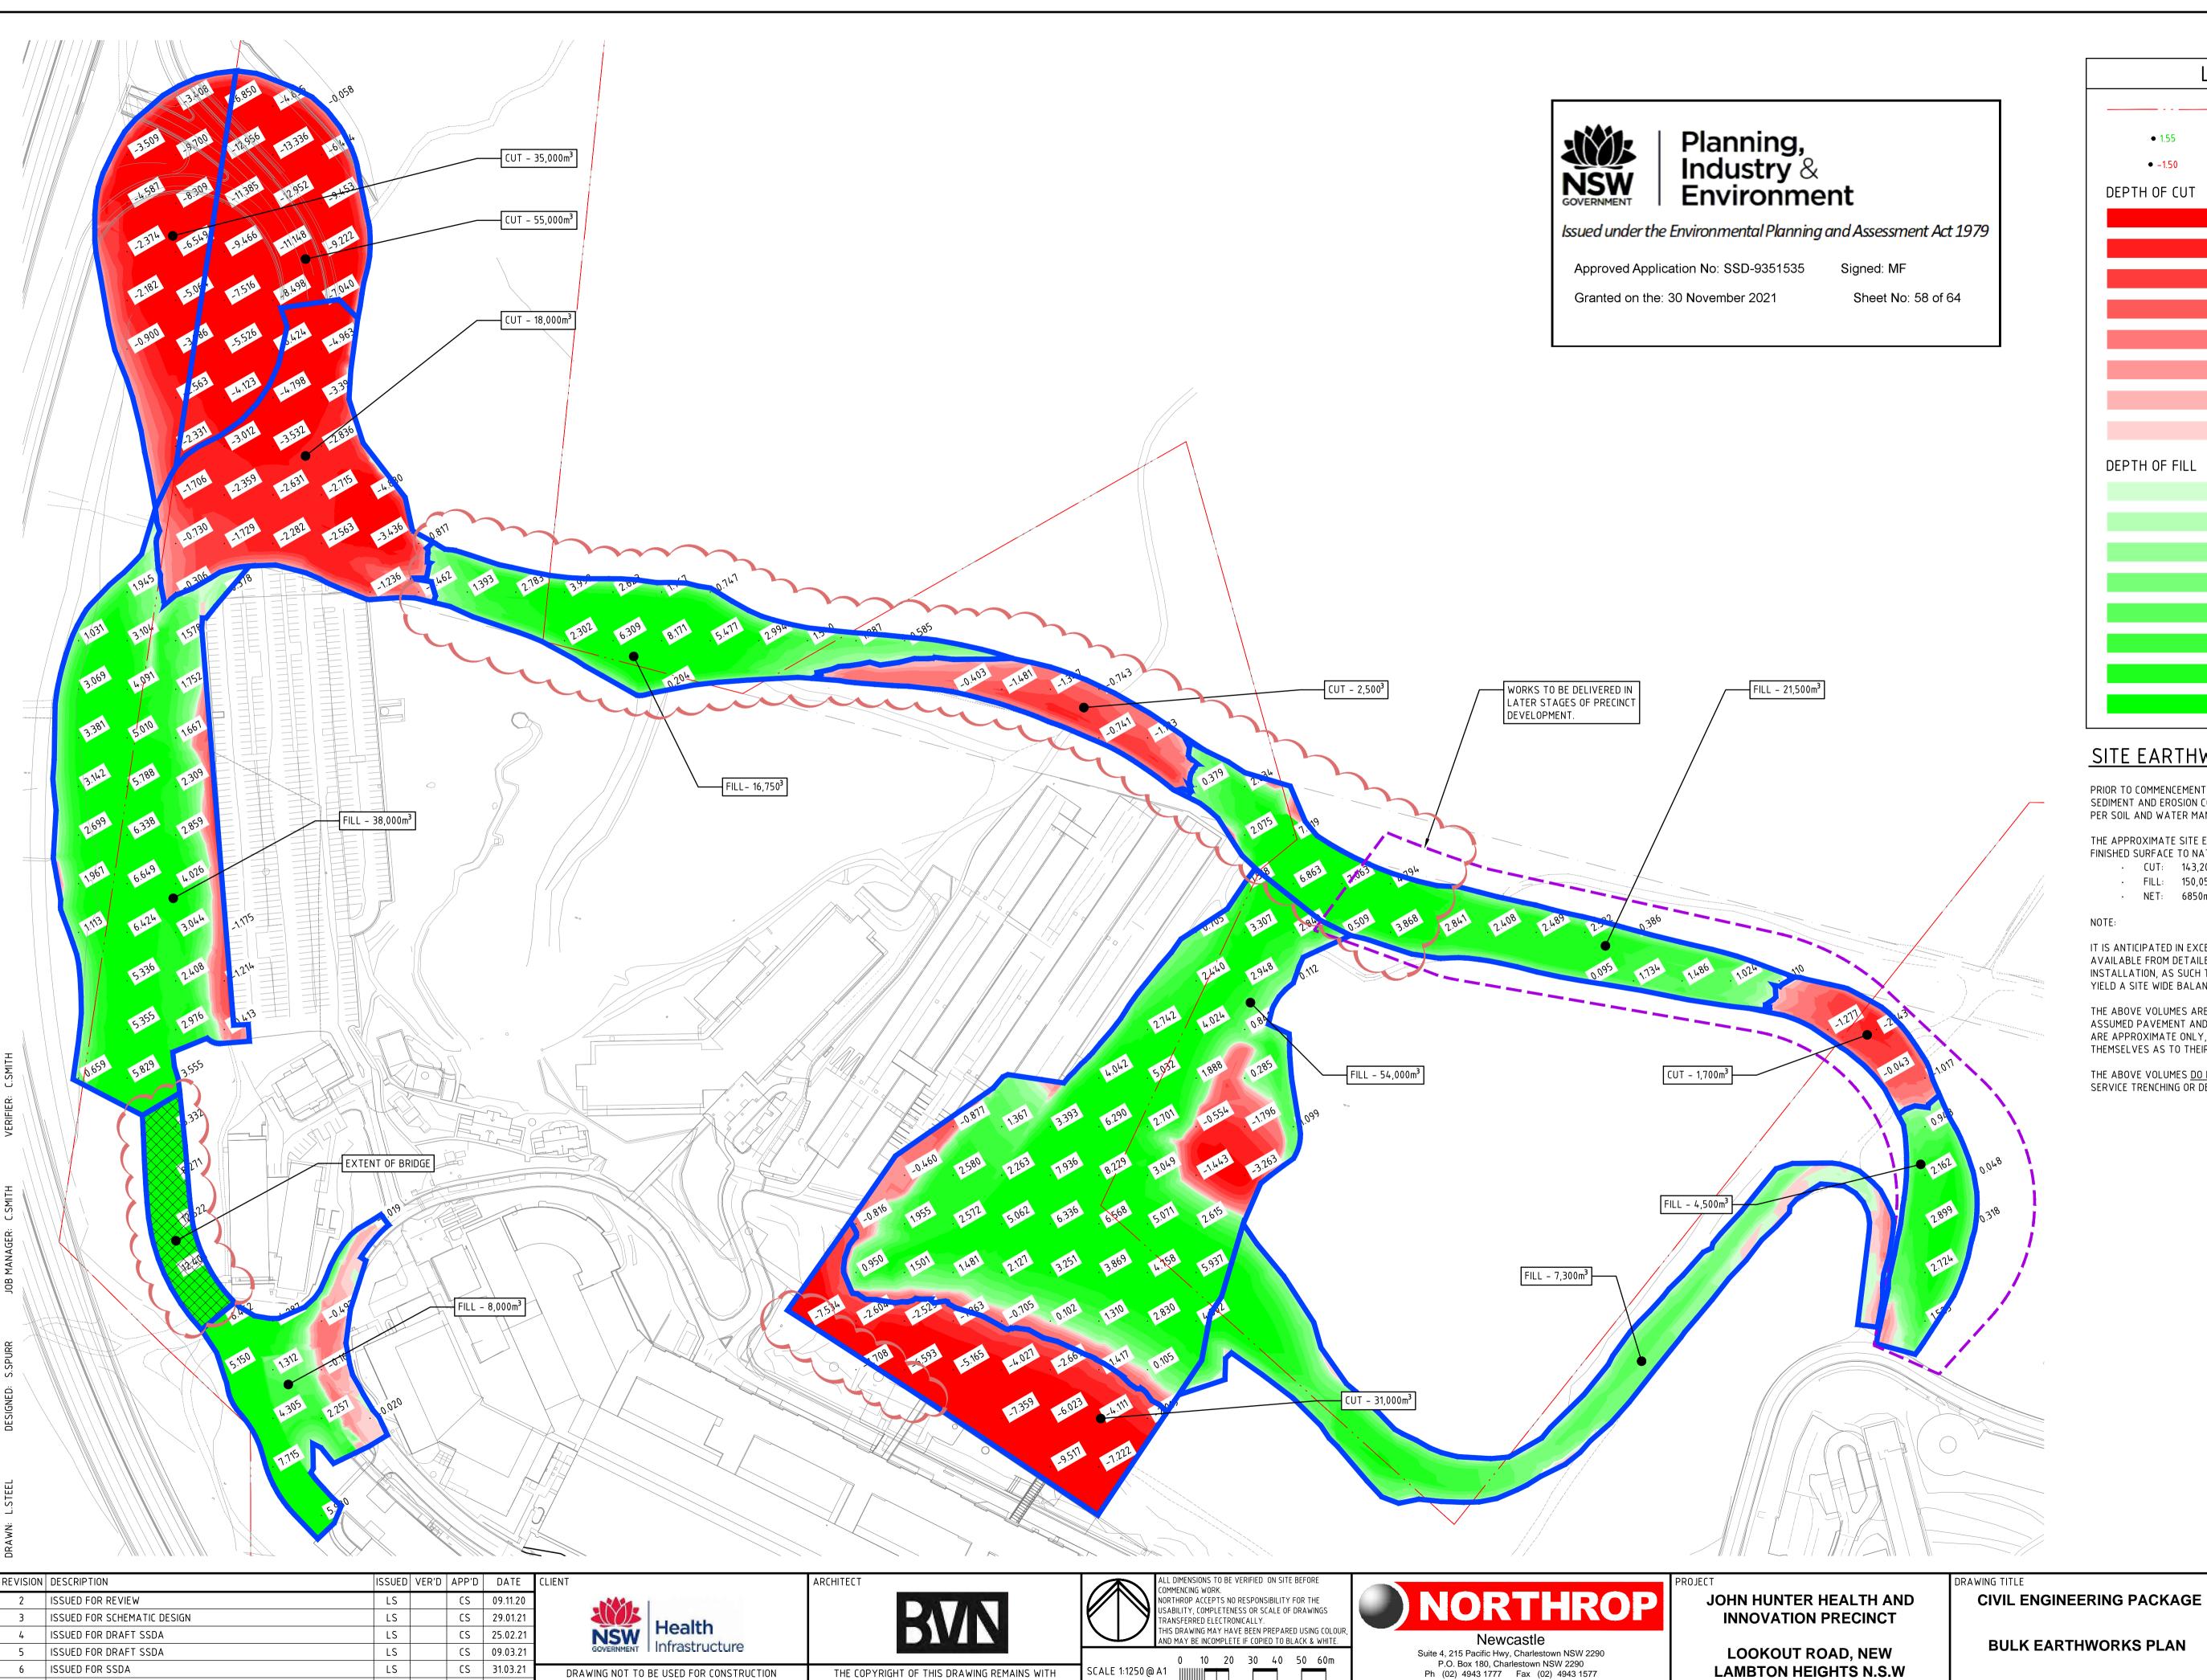PRIOR TO COMMENCEMENT OF EARTHWORKS ENSURE THAT ALL SEDIMENT AND EROSION CONTROL MEASURES ARE INSTALLED AS PER SOIL AND WATER MANAGEMENT GUIDELINES.

THE APPROXIMATE SITE EARTHWORKS VOLUMES ARE BASED ON FINISHED SURFACE TO NATURAL SURFACE.

· CUT: 143,200m³ FILL: 150,050m³

· NET: 6850m³(FILL)

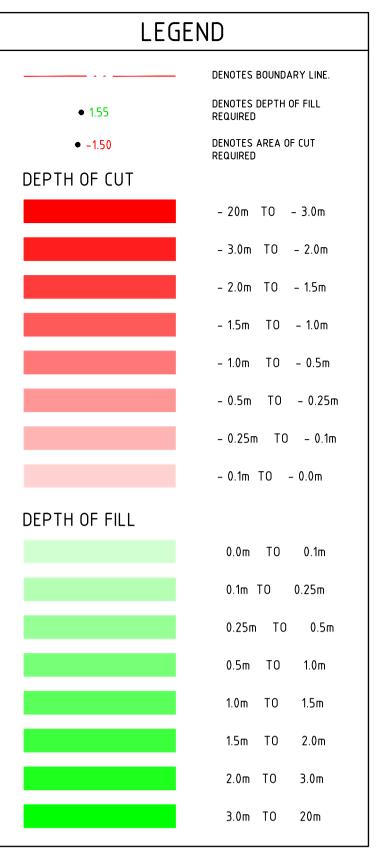IT IS ANTICIPATED IN EXCESS OF 10,000m3 OF SPOIL WILL BE AVAILABLE FROM DETAILED EXCAVATION AND SERVICE TRENCH INSTALLATION, AS SUCH TOTAL NET CUT/FILL IS EXPECTED TO YIELD A SITE WIDE BALANCE.


THE ABOVE VOLUMES ARE BASED ON SUPPLIED SURVEY DATA AND ASSUMED PAVEMENT AND BULK EARTHWORKS DEPTHS, AS SUCH ARE APPROXIMATE ONLY, THE CONTRACTOR SHALL SATISFY THEMSELVES AS TO THEIR ACCURACY.


THE ABOVE VOLUMES <u>DO NOT</u> INCLUDE A STRIPPING ALLOWANCE, SERVICE TRENCHING OR DETAILED EXCAVATION.


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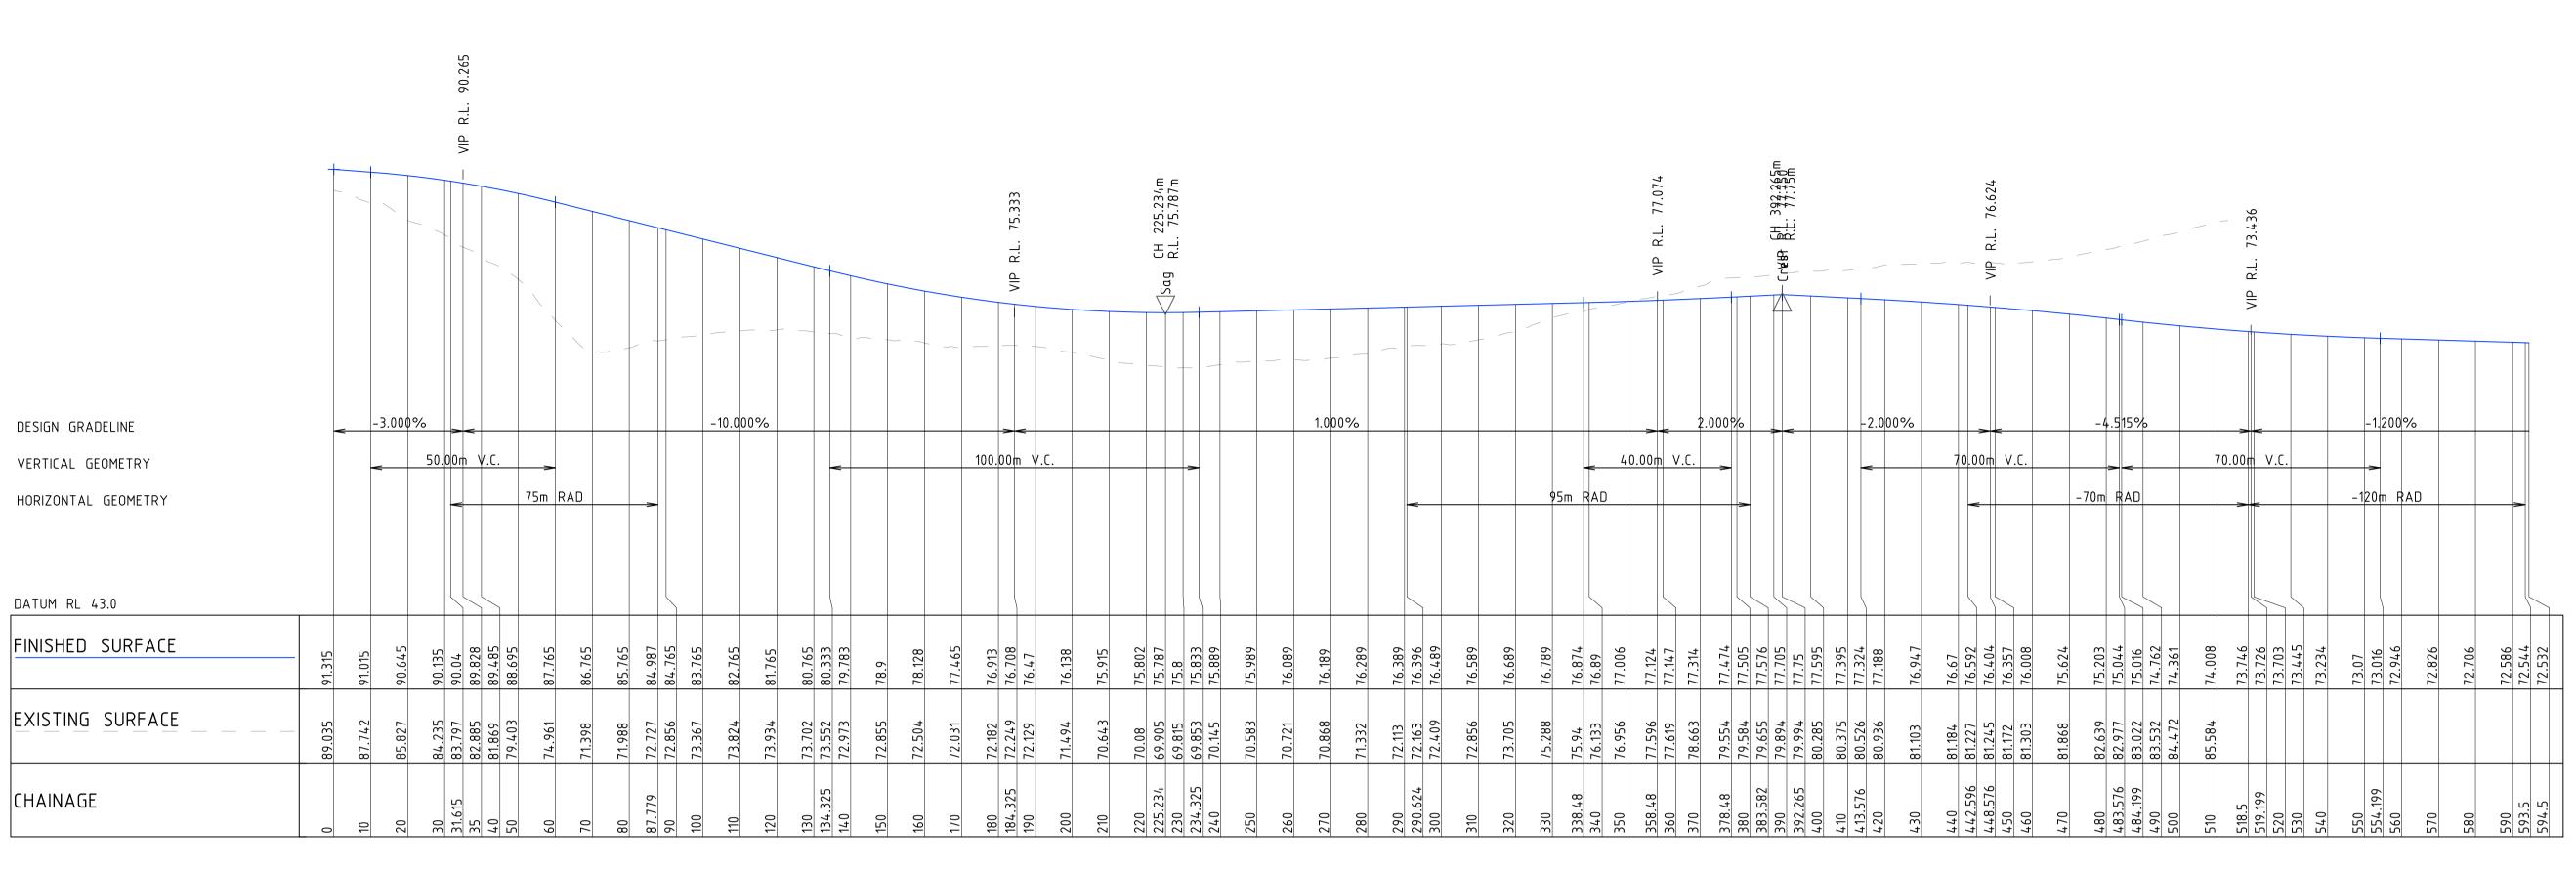
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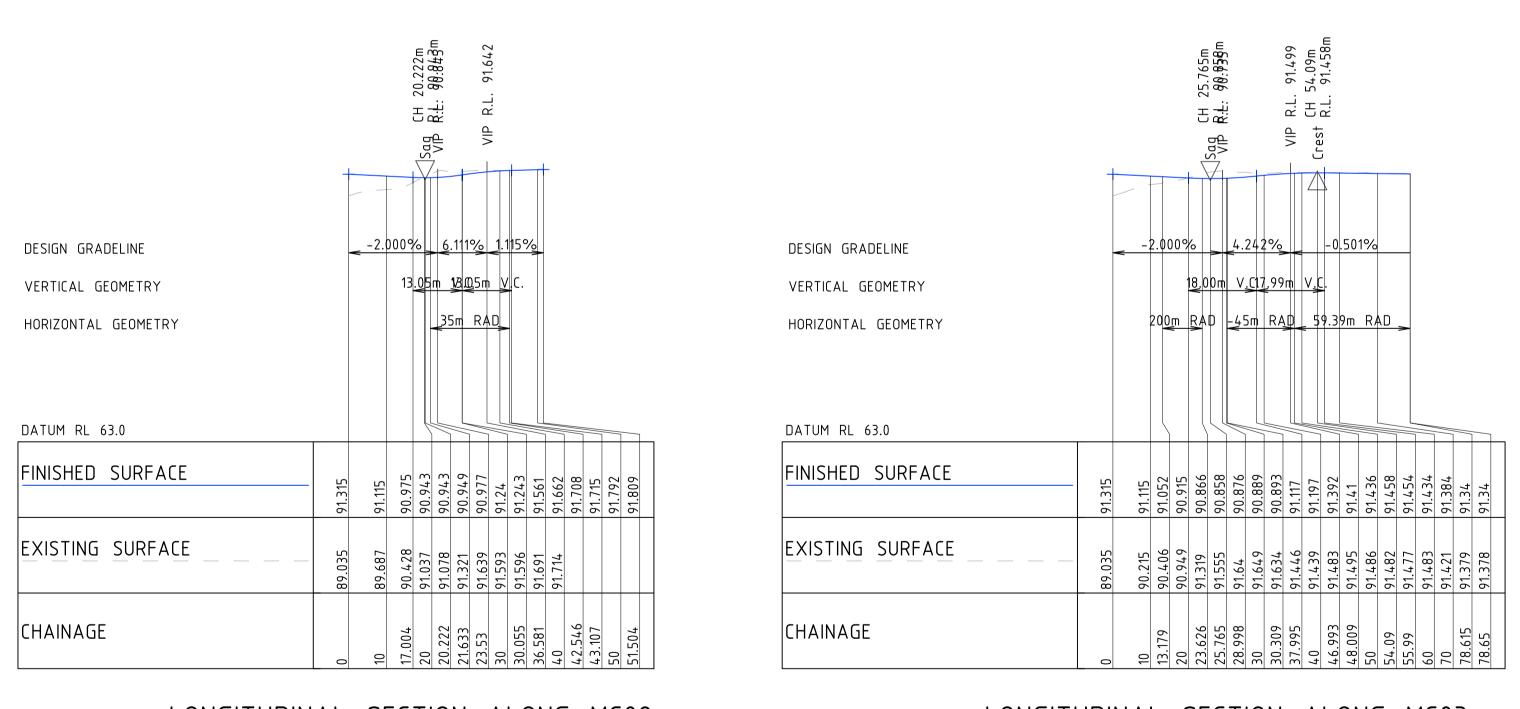




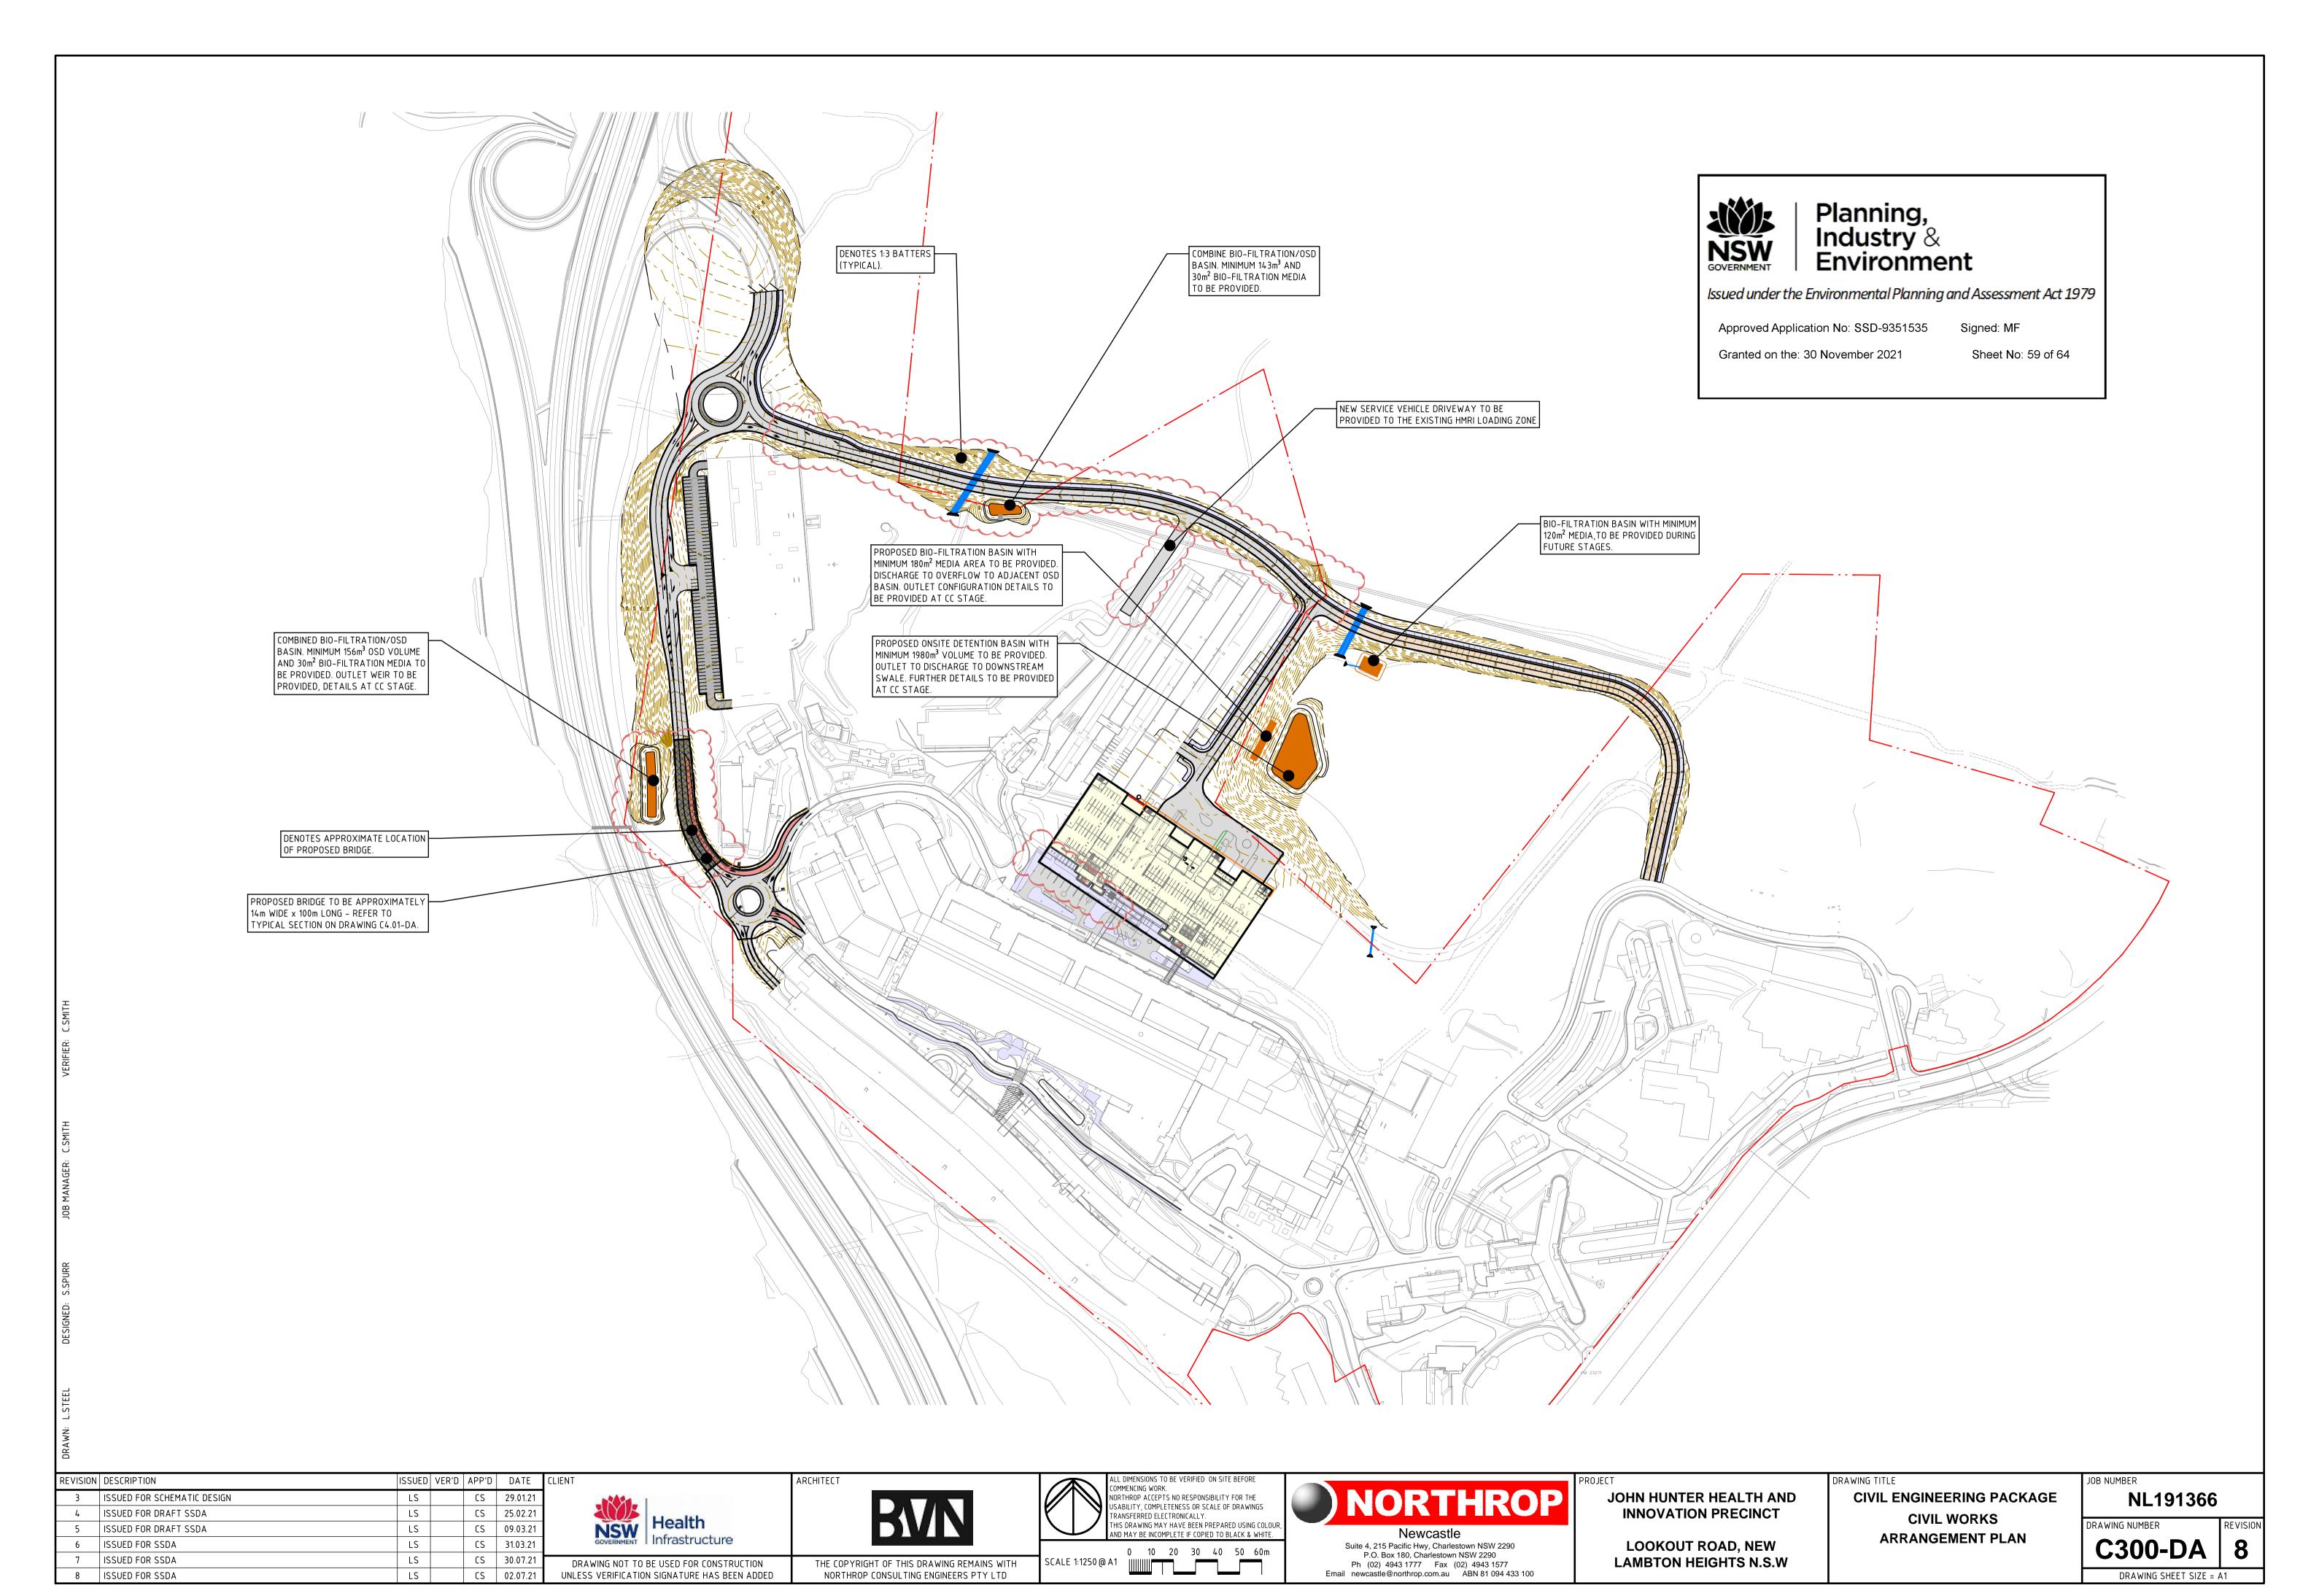

LONGITUDINAL SECTION ALONG MC01

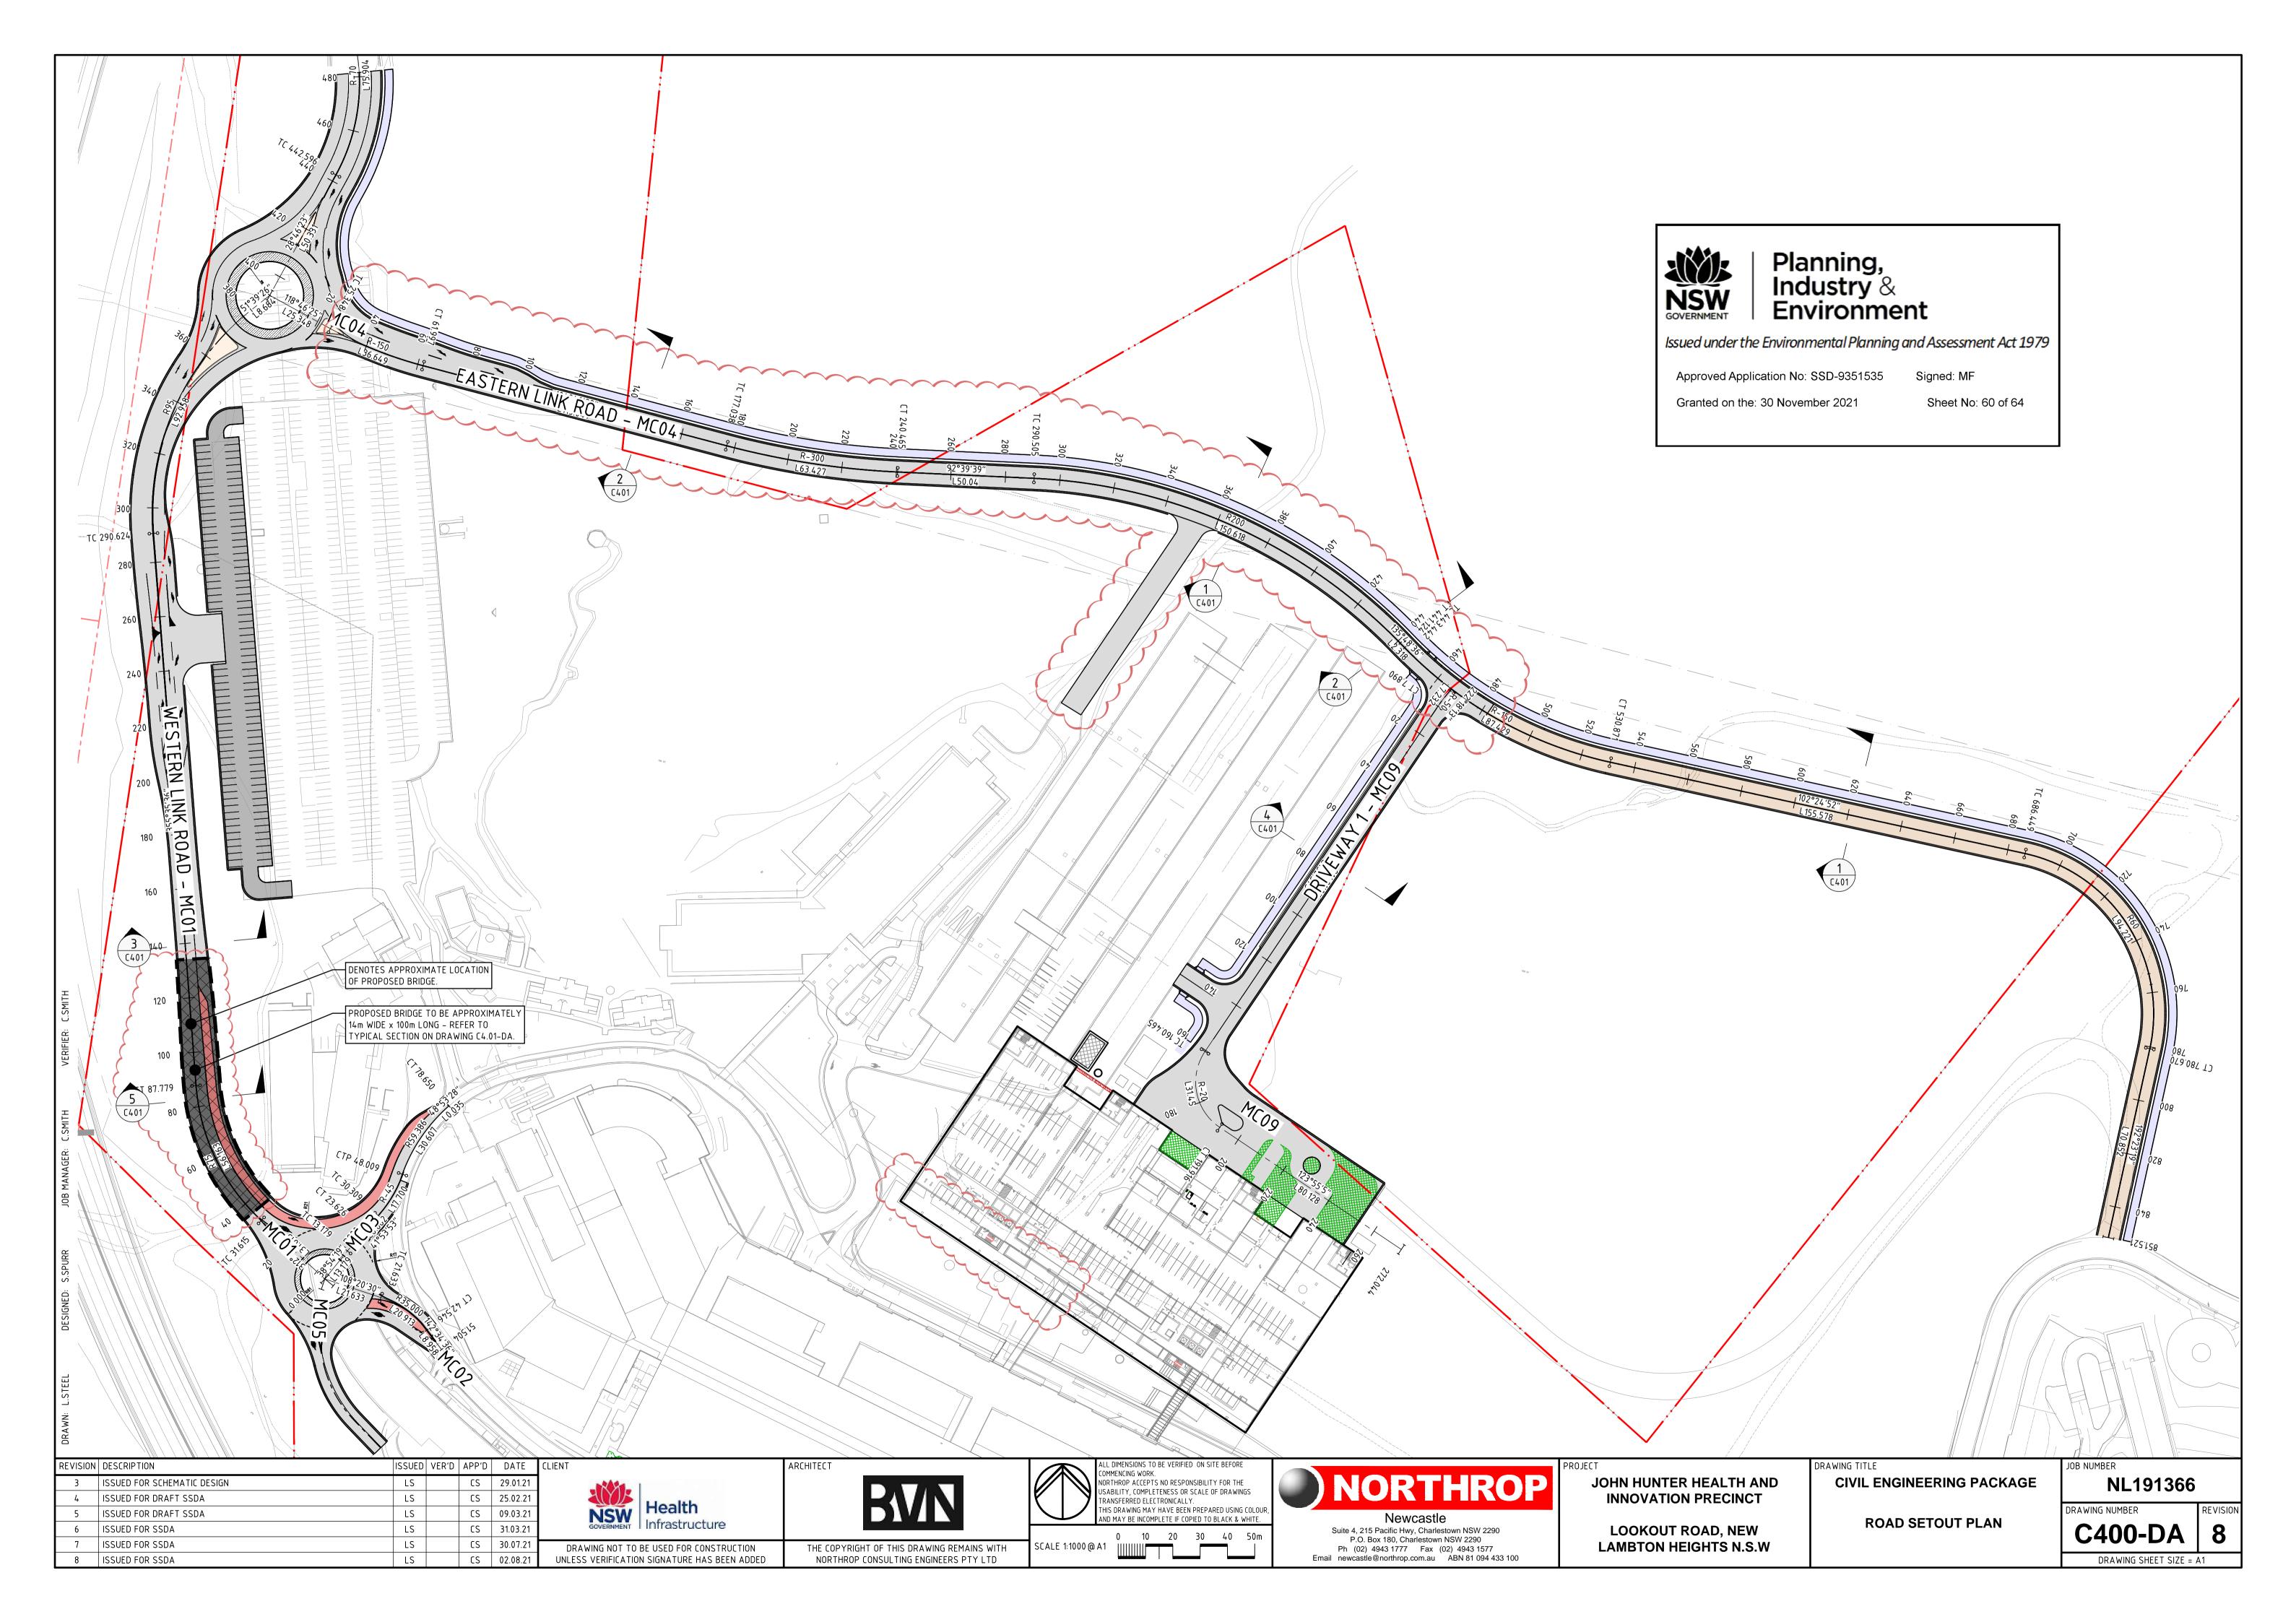HORIZONTAL SCALE 1:1000@A1 VERTICAL SCALE 1:400@A1

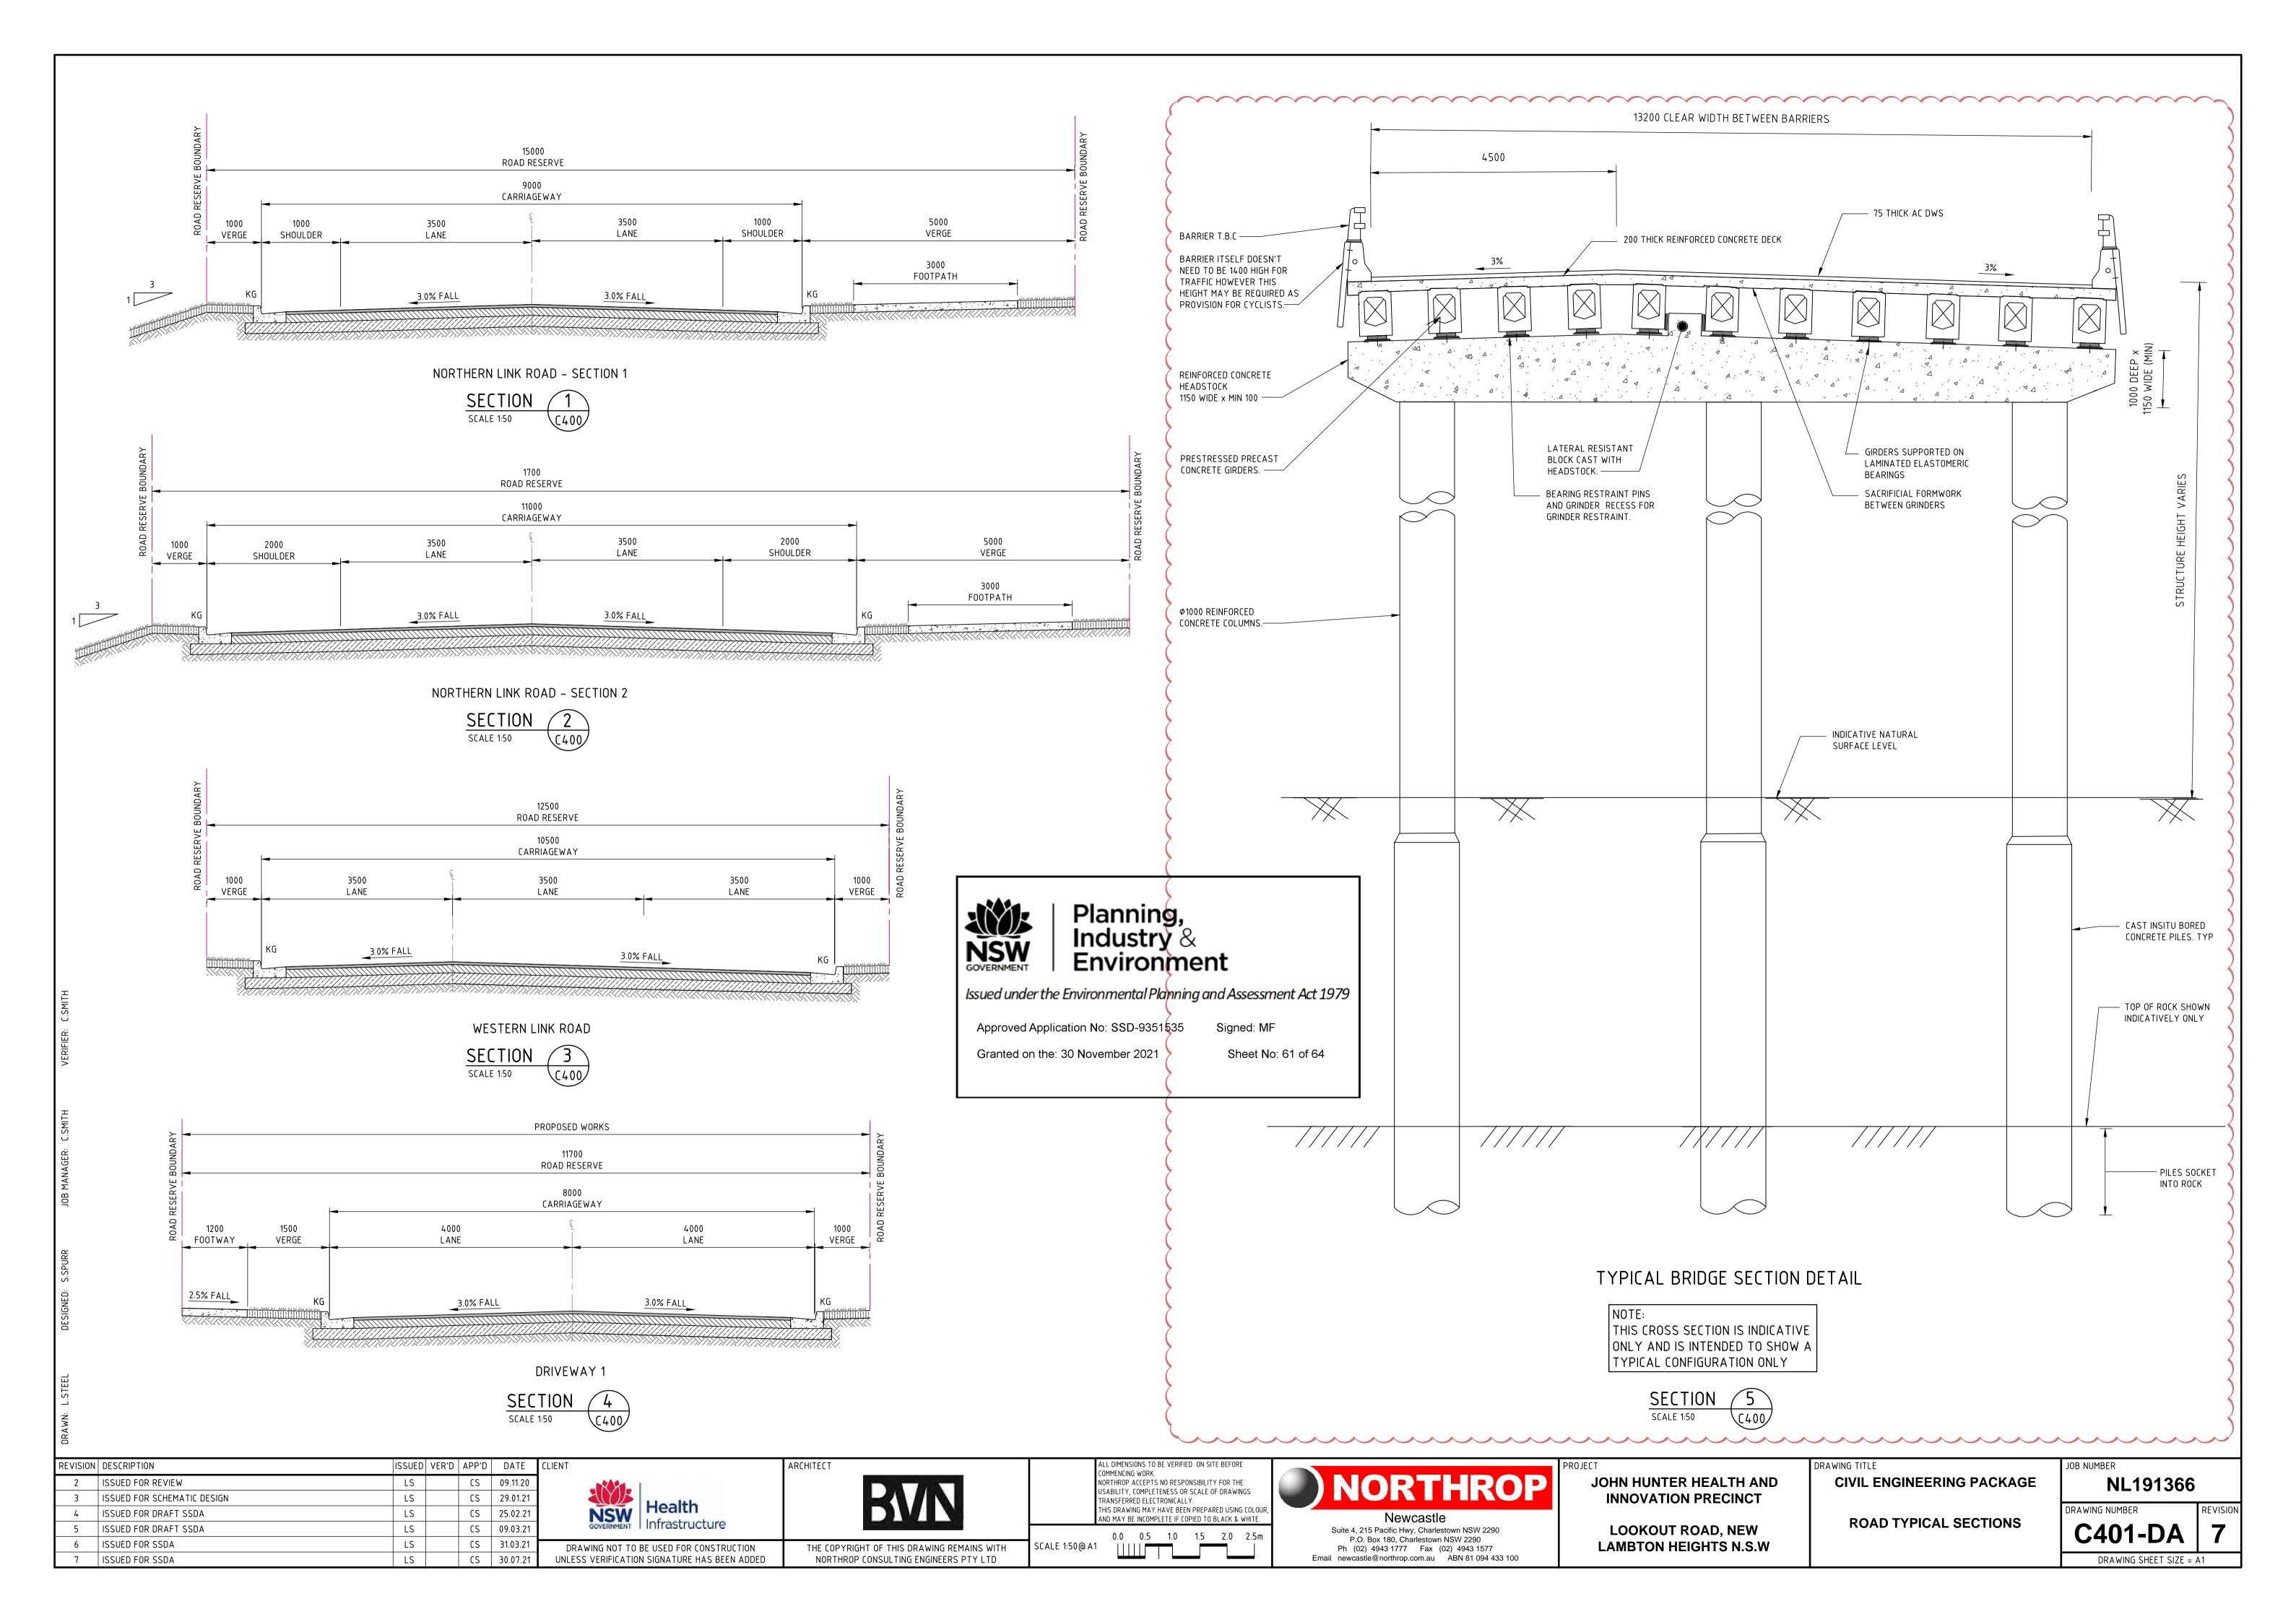

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LONGITUDINAL SECTION ALONG MC02 HORIZONTAL SCALE 1:1000@A1 VERTICAL SCALE 1:400@A1

LONGITUDINAL SECTION ALONG MC03 HORIZONTAL SCALE 1:1000@A1 VERTICAL SCALE 1:400@A1

REVISION	DESCRIPTION	ISSUED	VER'D	APP'D	DATE
2	ISSUED FOR REVIEW	LS	·	CS	09.11.20
3	ISSUED FOR SCHEMATIC DESIGN	LS		CS	29.01.21
4	ISSUED FOR DRAFT SSDA	LS		CS	25.02.21
5	ISSUED FOR DRAFT SSDA	LS		CS	09.03.21
6	ISSUED FOR SSDA	LS		CS	31.03.21
7	ISSUED FOR SSDA	LS		cs	30.07.21





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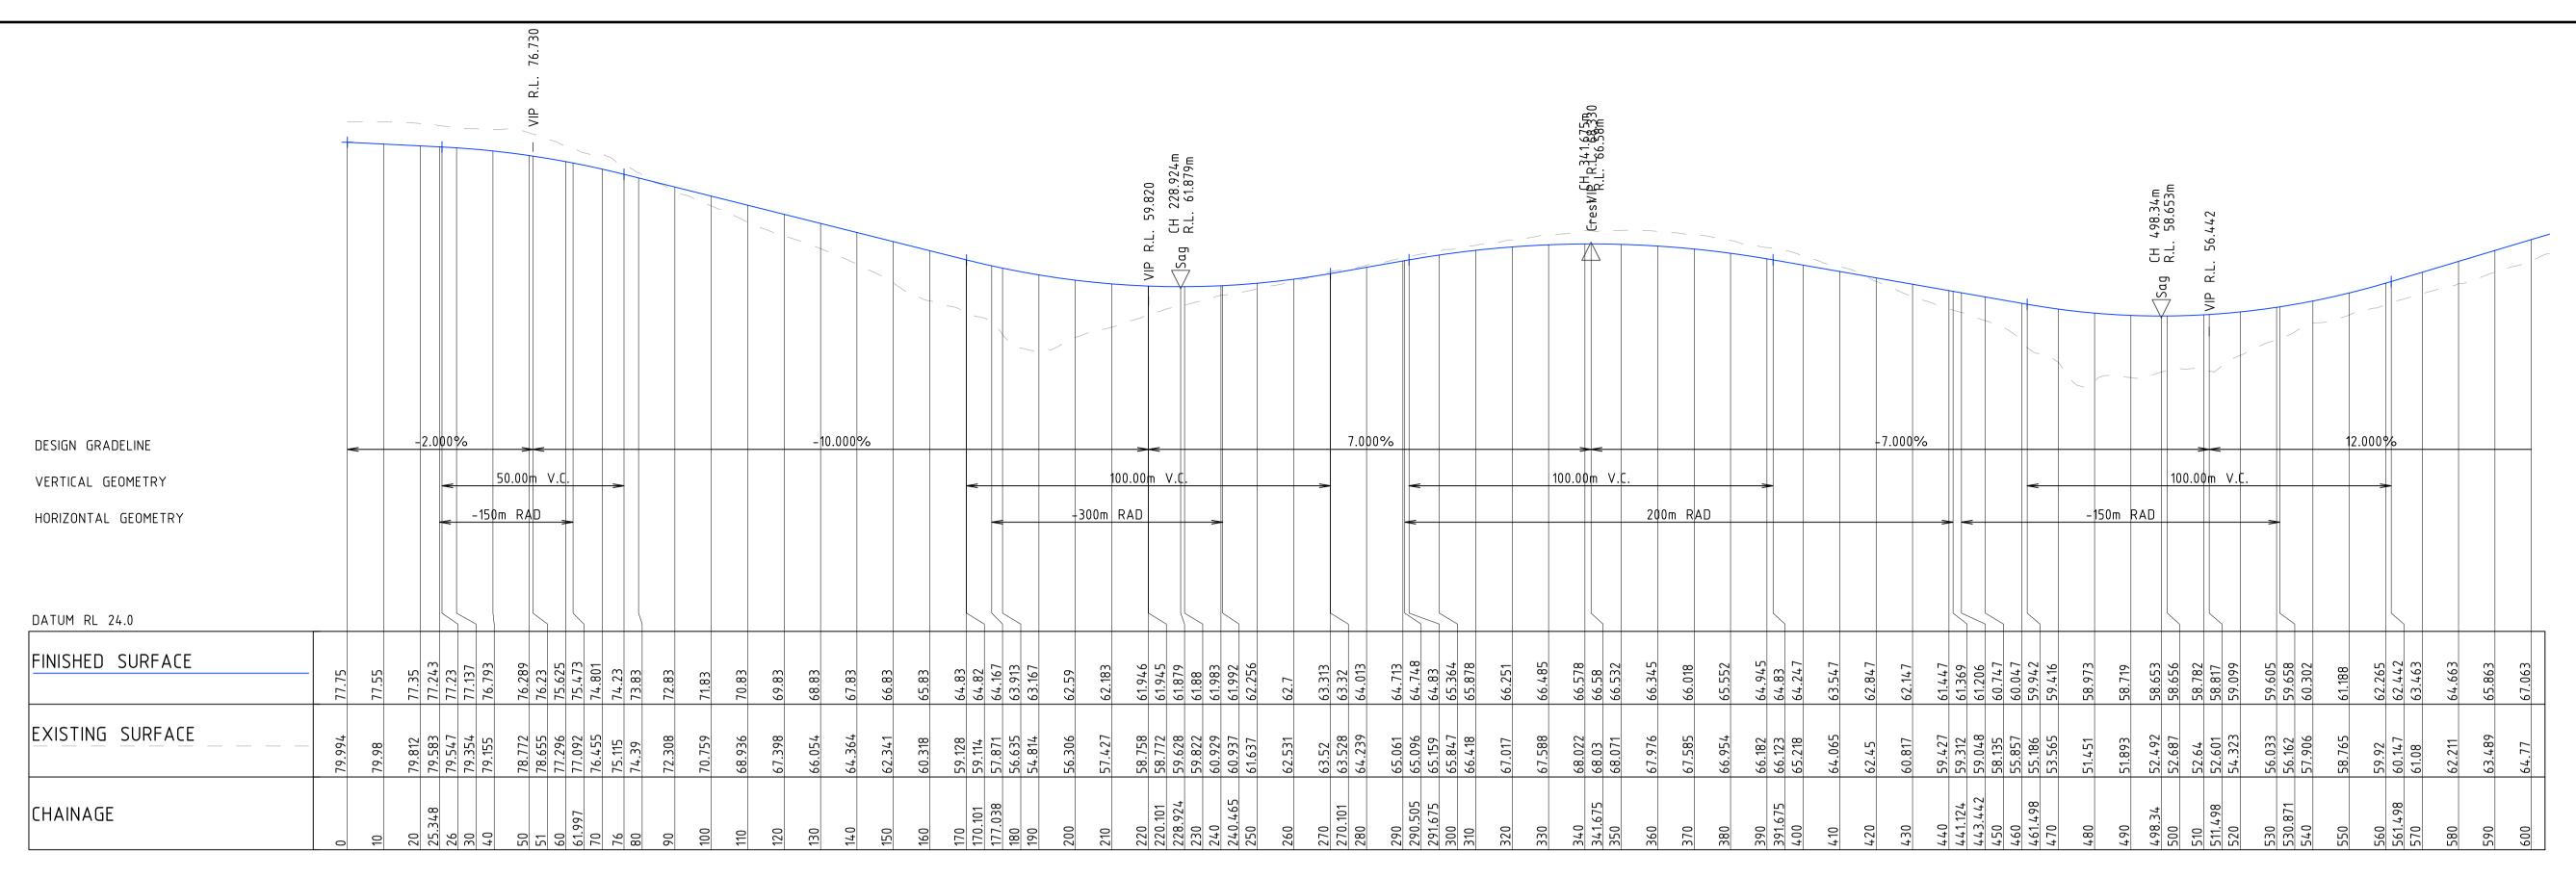
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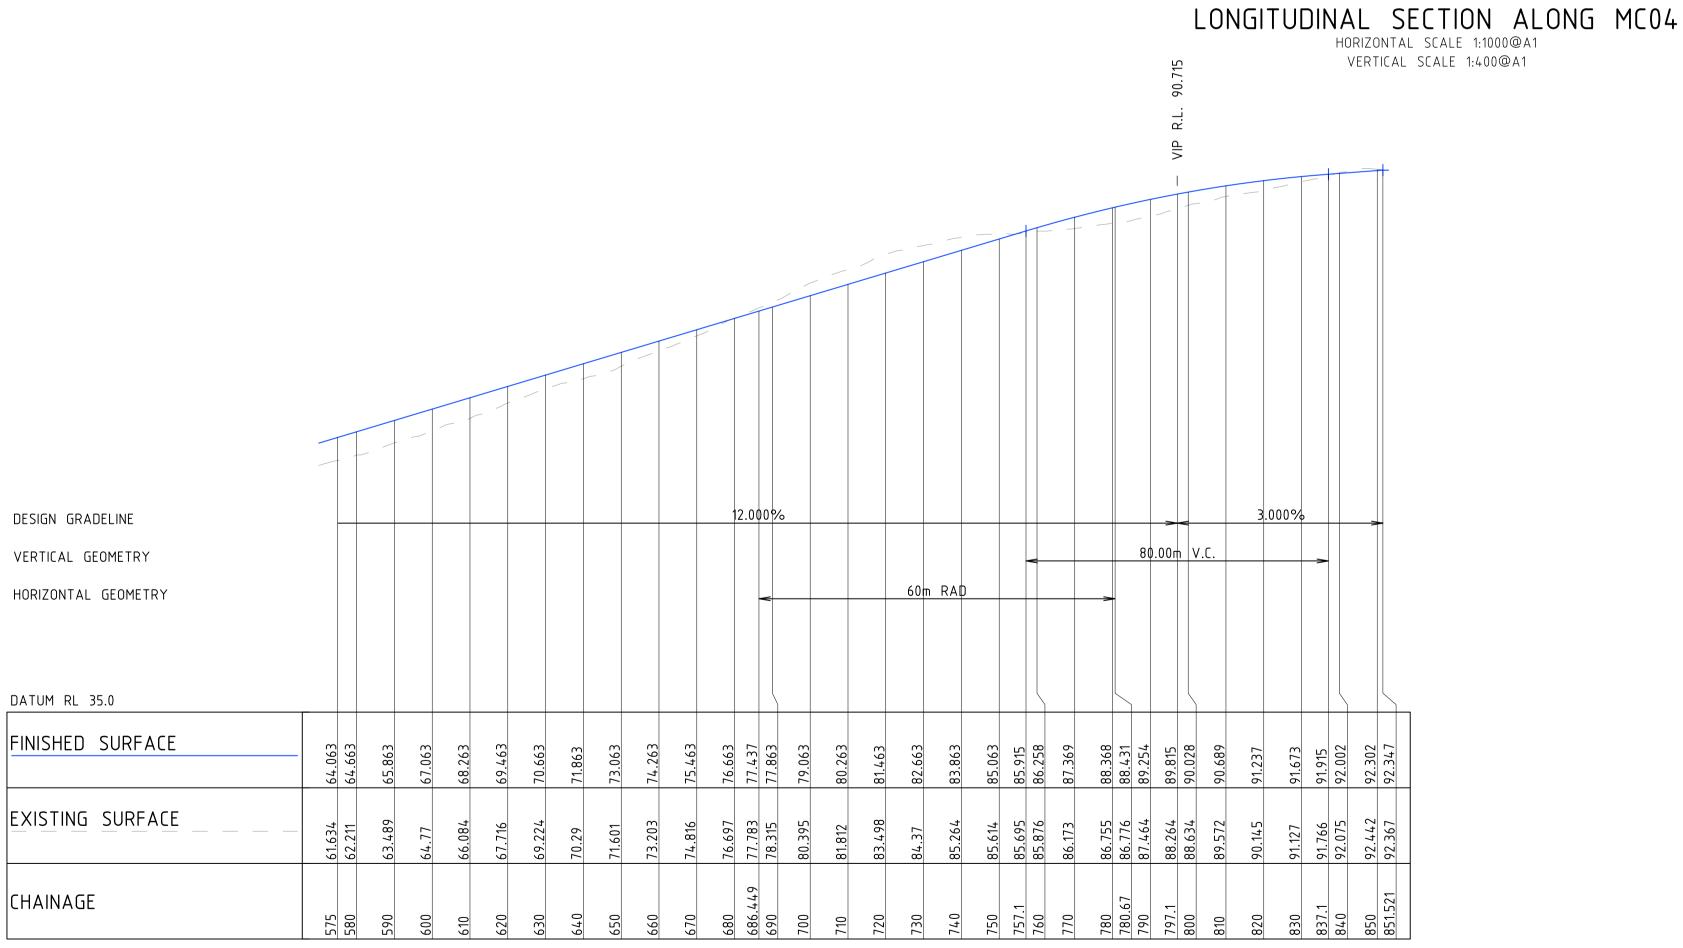
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LOOKOUT ROAD, NEW **LAMBTON HEIGHTS N.S.W** CIVIL ENGINEERING PACKAGE ROAD LONG SECTIONS SHEET 1

JOB NUMBER
NL191366

DRAWING NUMBER C501-DA







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LONGITUDINAL SECTION ALONG MC04

HORIZONTAL SCALE 1:1000@A1 VERTICAL SCALE 1:400@A1

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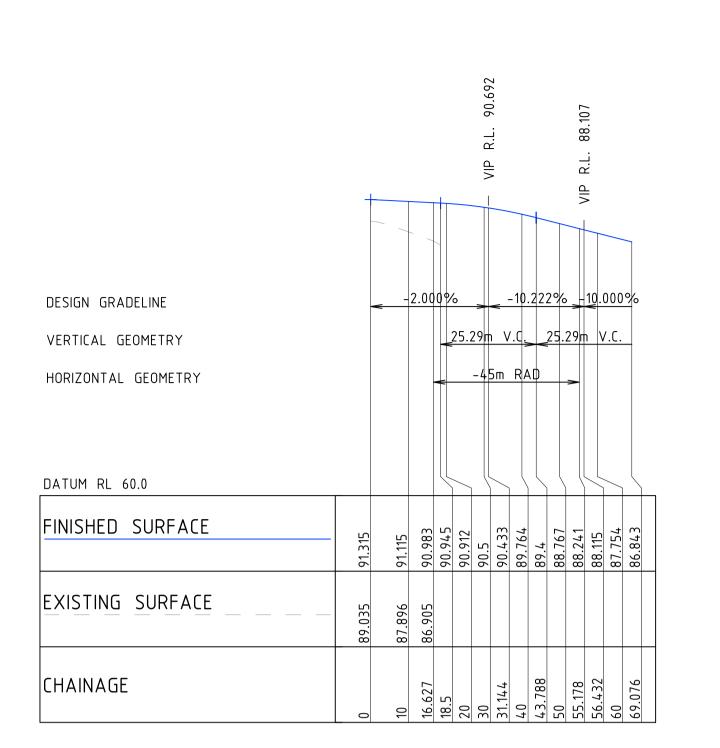
CIVIL ENGINEERING PACKAGE

ROAD LONG SECTIONS

SHEET 2

JOB NUMB	ER		
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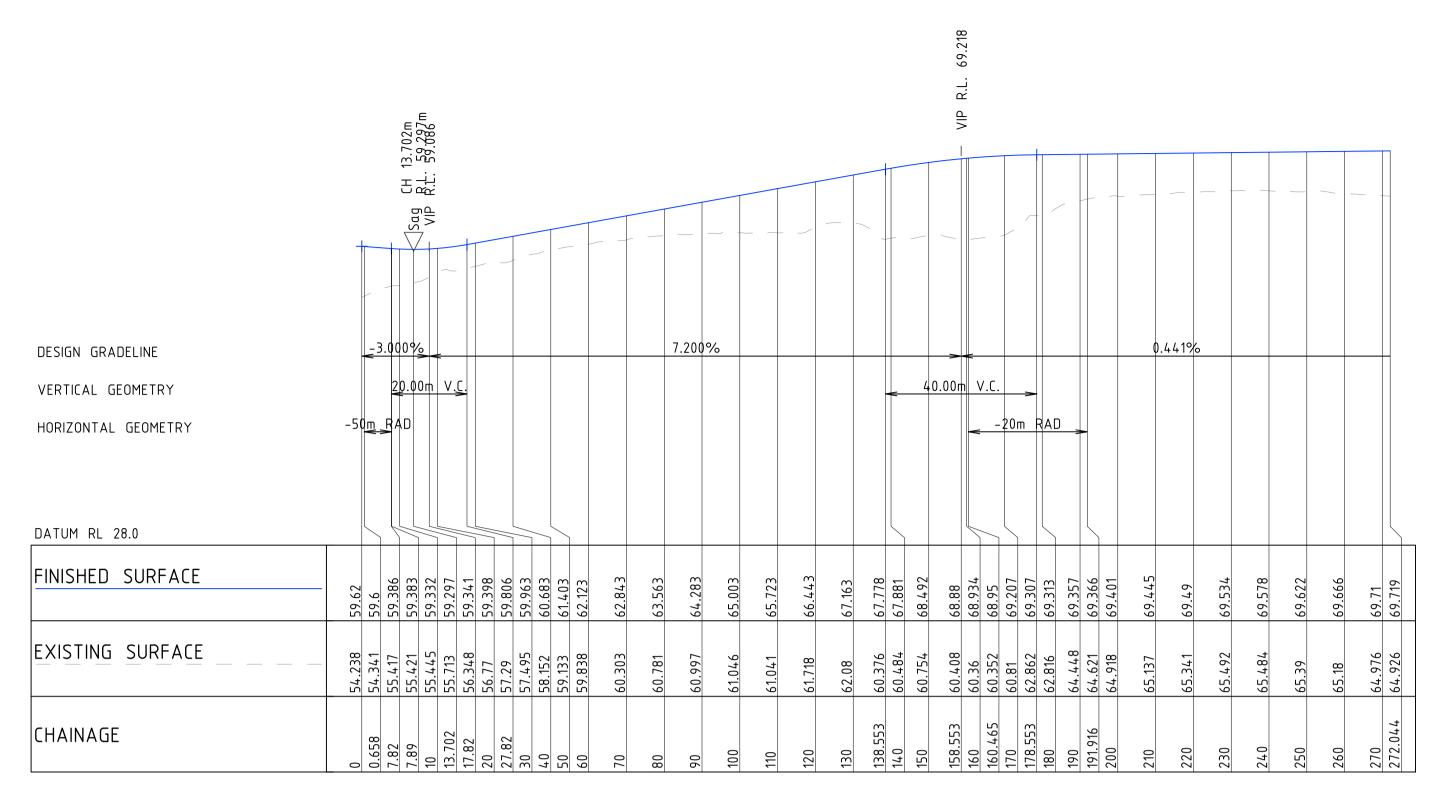
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LONGITUDINAL SECTION ALONG MC05

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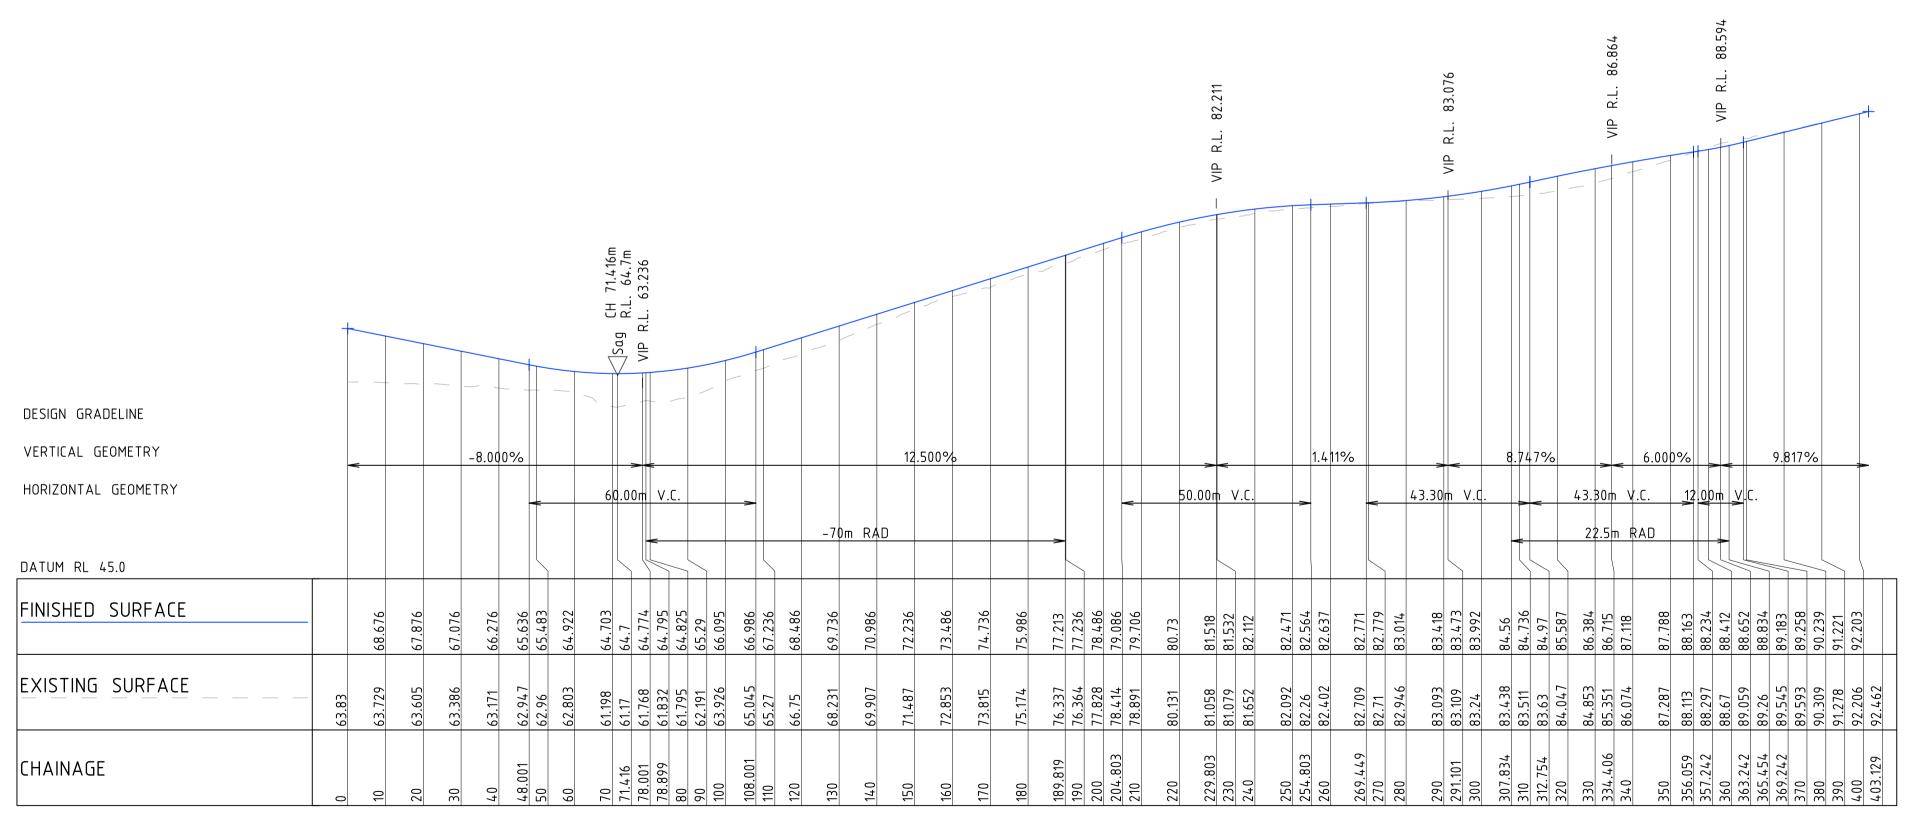
VERTICAL SCALE 1:400@A1



LONGITUDINAL SECTION ALONG MC09

HORIZONTAL SCALE 1:1000@A1

VERTICAL SCALE 1:400@A1



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Sheet No: 64 of 64

LONGITUDINAL SECTION ALONG MCT01
HORIZONTAL SCALE 1:1000@A1

VERTICAL SCALE 1:400@A1

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ROAD LONG SECTIONS

SHEET 3

JOB I	NUMB	ER				
		NL	.19) 1	36	5

C503-DA REVISION

DRAWING SHEET SIZE = A1