PROJECT: SAINTS PETER & PAUL ASSYRIAN PRIMARY SCHOOL

PLANSET: CIVIL WORKS PLAN - STAGE 01

CLIENT: ASSYRIAN SCHOOLS LTD.



LOCALITY PLAN
N.T.S.

## NSW DEPARTMENT OF PLANNING AND ENVIRONMENT SSDA 9210 LGA: FAIRFIELD CITY COUNCIL

17 & 19 KOSOVICH PLACE, CECIL PARK, NSW LOTS 2320 & 2321, DP 1223137

REV DESCRIPTION	DATE	DRAWN D	DESIGNED	CHECKED	APPRVD	GRID DATUM PROJE	JECT MANAGER	CLIENT
F MINOR AMENDMENTS	20/09/2018	CG	CG/EZ	DG	TH			ASSYRIAN SCHOOLS LTD.
E AMENDED FROM CLIENT COMMENTS	20/09/2018	CG	CG/EZ	DG	TH			ASSITIAN SCHOOLS LID.
D MINOR AMENDMENT	14/09/2018	GM	MD	MD	TH	DISCLAIMER & COPYRIGHT		PROJECT NAME/PLANSET TITLE
C MINOR AMENDMENT	11/09/2018	GM D	OG/CG/EZ	Z DG	TH	This plan must not be used for construction unless significant continues and the continues are constructed and the construction unless significant continues and the continues are constructed and the continues are continued and the continu	s signed as approved by	ST PETER & PAUL ASSYRIAN PRI. SC
B AMENDED DESIGN BASED ON ARCHITECTURE	05/09/2018	GM D	OG/CG/EZ	Z DG	TH	principal certifying authority.  All measurements in millimetres unless otherwise spe		
A INITIAL RELEASE	5/09/2018	LZ/GM/CG	CG/EZ	DG	TH	This drawing must not be reproduced in whole or part		CIVIL WORKS PLAN - STAGE 01
						consent of Martens & Associates Pty Ltd.	and manded prior minion	17 &19 KOSOVICH PLACE, CECIL PARK, NSW
						(C) Copyright Martens & Associates Pty Ltd	Ltd	LOTS 2302 & 2321, DP 1223167
/ A3 LANDSCAPE (A1LC_v02.0.01)	L					1		

PS04-A050  CONSTRUCT PS04-B300 PS04-B310  EARTHWORI PS04-C100 PS04-C200 PS04-C201 PS04-C500  ROADWORK	E ENG FON MA E SED E SED KS E EAR E EAR	VER SHEET SINEERING OVERVIEW PLAN ANAGEMENT WORKS DIMENT & EROSION CONTROL PLAN DIMENT & EROSION CONTROL DETAILS RTHWORKS GRADING PLAN RTHWORKS SITE SECTIONS (SHEET 1)
CONSTRUCT PS04-B300 PS04-B310 EARTHWORK PS04-C100 PS04-C200 PS04-C201 PS04-C500 ROADWORK	ION MARE SED SED SED SED SED SED SED SED SED SE	ANAGEMENT WORKS DIMENT & EROSION CONTROL PLAN DIMENT & EROSION CONTROL DETAILS RTHWORKS GRADING PLAN
PS04-B300 PS04-B310 EARTHWORI PS04-C100 PS04-C200 PS04-C201 PS04-C500 ROADWORK	E SED  KS  E EAR  E EAR  E EAR	DIMENT & EROSION CONTROL PLAN DIMENT & EROSION CONTROL DETAILS RTHWORKS GRADING PLAN
PS04-B310 EARTHWORI PS04-C100 PS04-C200 PS04-C201 PS04-C500 ROADWORK	E SED KS E EAR E EAR	RTHWORKS GRADING PLAN
EARTHWORI PS04-C100 PS04-C200 PS04-C201 PS04-C500 ROADWORK	KS E EAR E EAR	RTHWORKS GRADING PLAN
PS04-C100 PS04-C200 PS04-C201 PS04-C500 ROADWORK	E EAR E EAR	
PS04-C200 PS04-C201 PS04-C500 ROADWORK	E EAR	
PS04-C201 PS04-C500 ROADWORK	E EAR	THWORKS SITE SECTIONS (SHEET 1)
PS04-C500 ROADWORK		· · · - · · - · · · · · · · · · · · · ·
ROADWORK	_	RTHWORKS SITE SECTIONS (SHEET 2)
	E EAR	RTHWORKS CUT-FILL PLAN
DCA/ DAGA	S	
PS04-D100	E ROA	ADWORKS PLAN
PS04-D200	F I	VEWAY (21-MRL01) AND CARPARK AISLE (21-MRL02) IGITUDINAL & TYPICAL SECTIONS
PS04-D201	E CAR	RPARK AISLE (21-MRL03) LONGITUDINAL & TYPICAL SECTIONS
DRAINAGE V	VORKS	)
PS04-E100	E DRA	AINAGE PLAN
PS04-E200	E DRA	AINAGE DETAILS (SHEET 1)
PS04-E201	E DRA	AINAGE DETAILS (SHEET 2)
PS04-E300	E DRA	AINAGE LONGITUDINAL SECTIONS (SHEET 1)
PS04-E301	E DRA	AINAGE LONGITUDINAL SECTIONS (SHEET 2)
PS04-E302	E DRA	NINAGE PIT SCHEDULE
		CATCHMENT PLAN, MODEL AND RESULTS
PS04-E700	E WA	TER QUALITY CATCHMENT PLAN, MODEL AND RESULTS
FINAL CIVIL	WORK	S
PS04-G400	E CON	ICEPT PAVEMENT DESIGN
UTILITIES A	ND SEI	RVICES
PS04-H200	c SITE	E PLAN – WASTEWATER MANAGEMENT
PS04-K100		E PLAN - 1 IN 20 YEAR ARI, 1 IN 100 YEAR ARI AND PMF FLOOD ENTS


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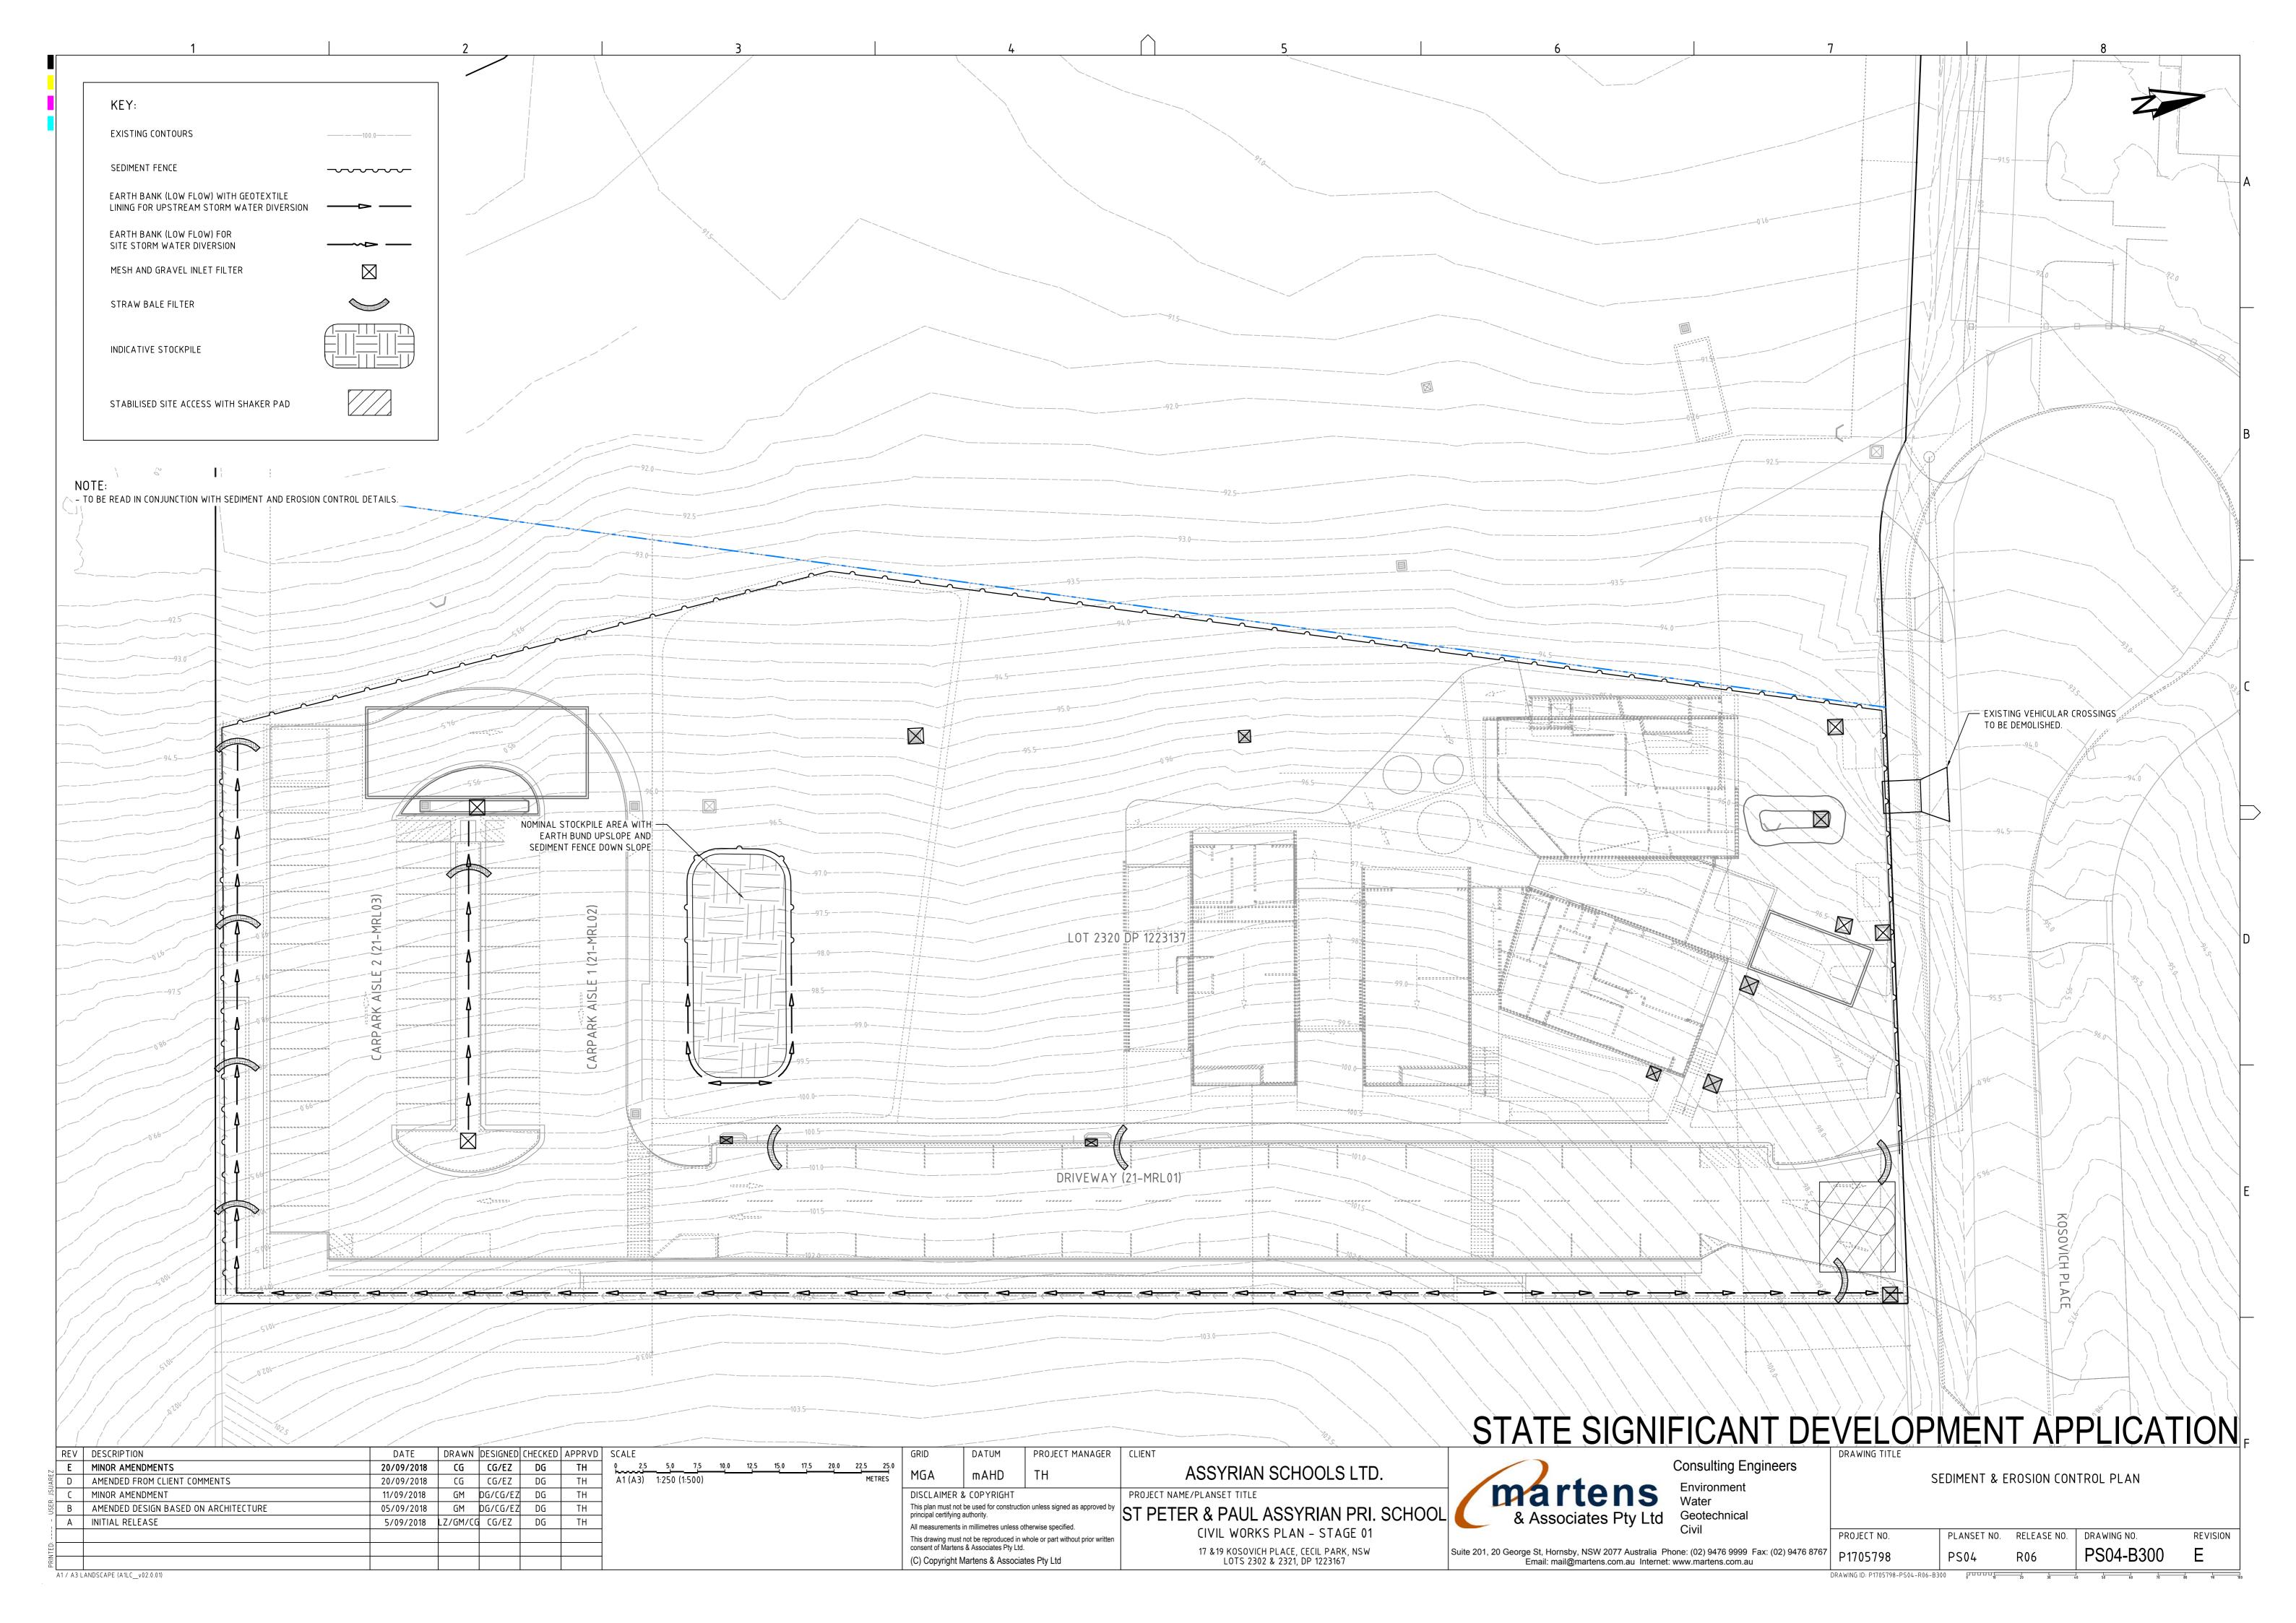
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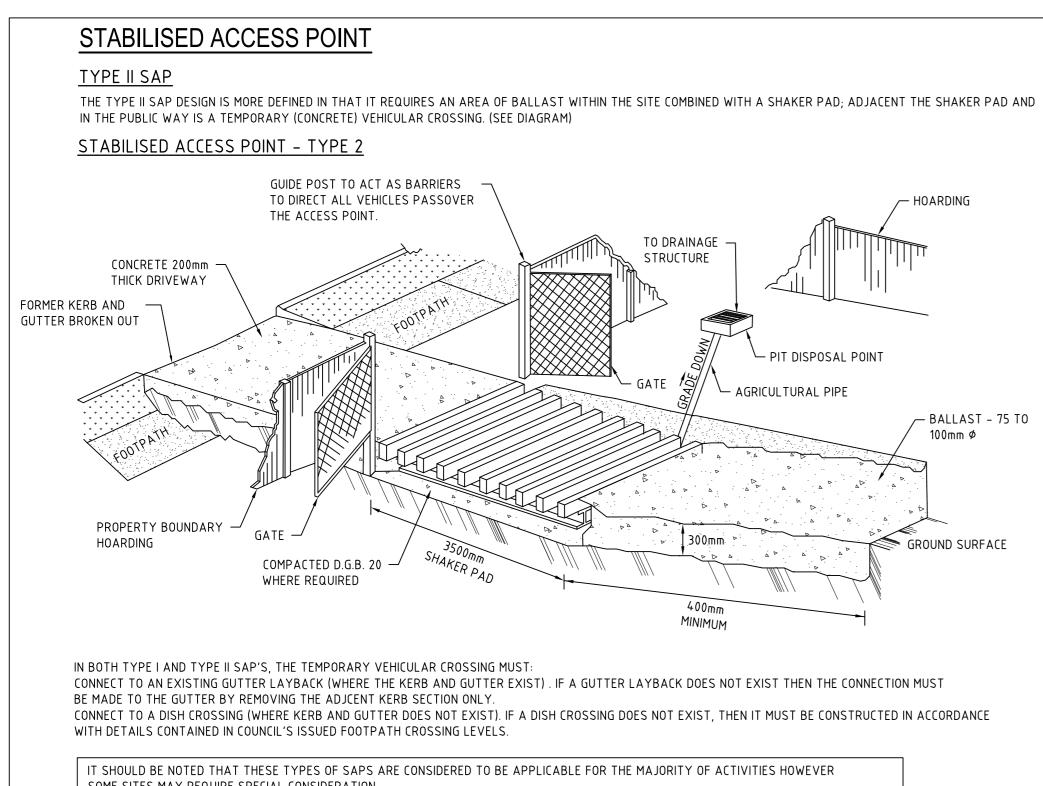
STATE SIGNIFICANT DEVELOPMENT APPLICATION



	CO	VER SHEET		
ECT NO	DI ANCET NO	DELEACE NO	DD A MINE NO	DEVICION
ECT NO. <b>05798</b>	PLANSET NO. PS04	RELEASE NO.	PS04-A000	REVISION <b>F</b>
ID: P1705798-PS04-R06-A0	00 0 0 10	20 30 4	0 50 60 70	80 90





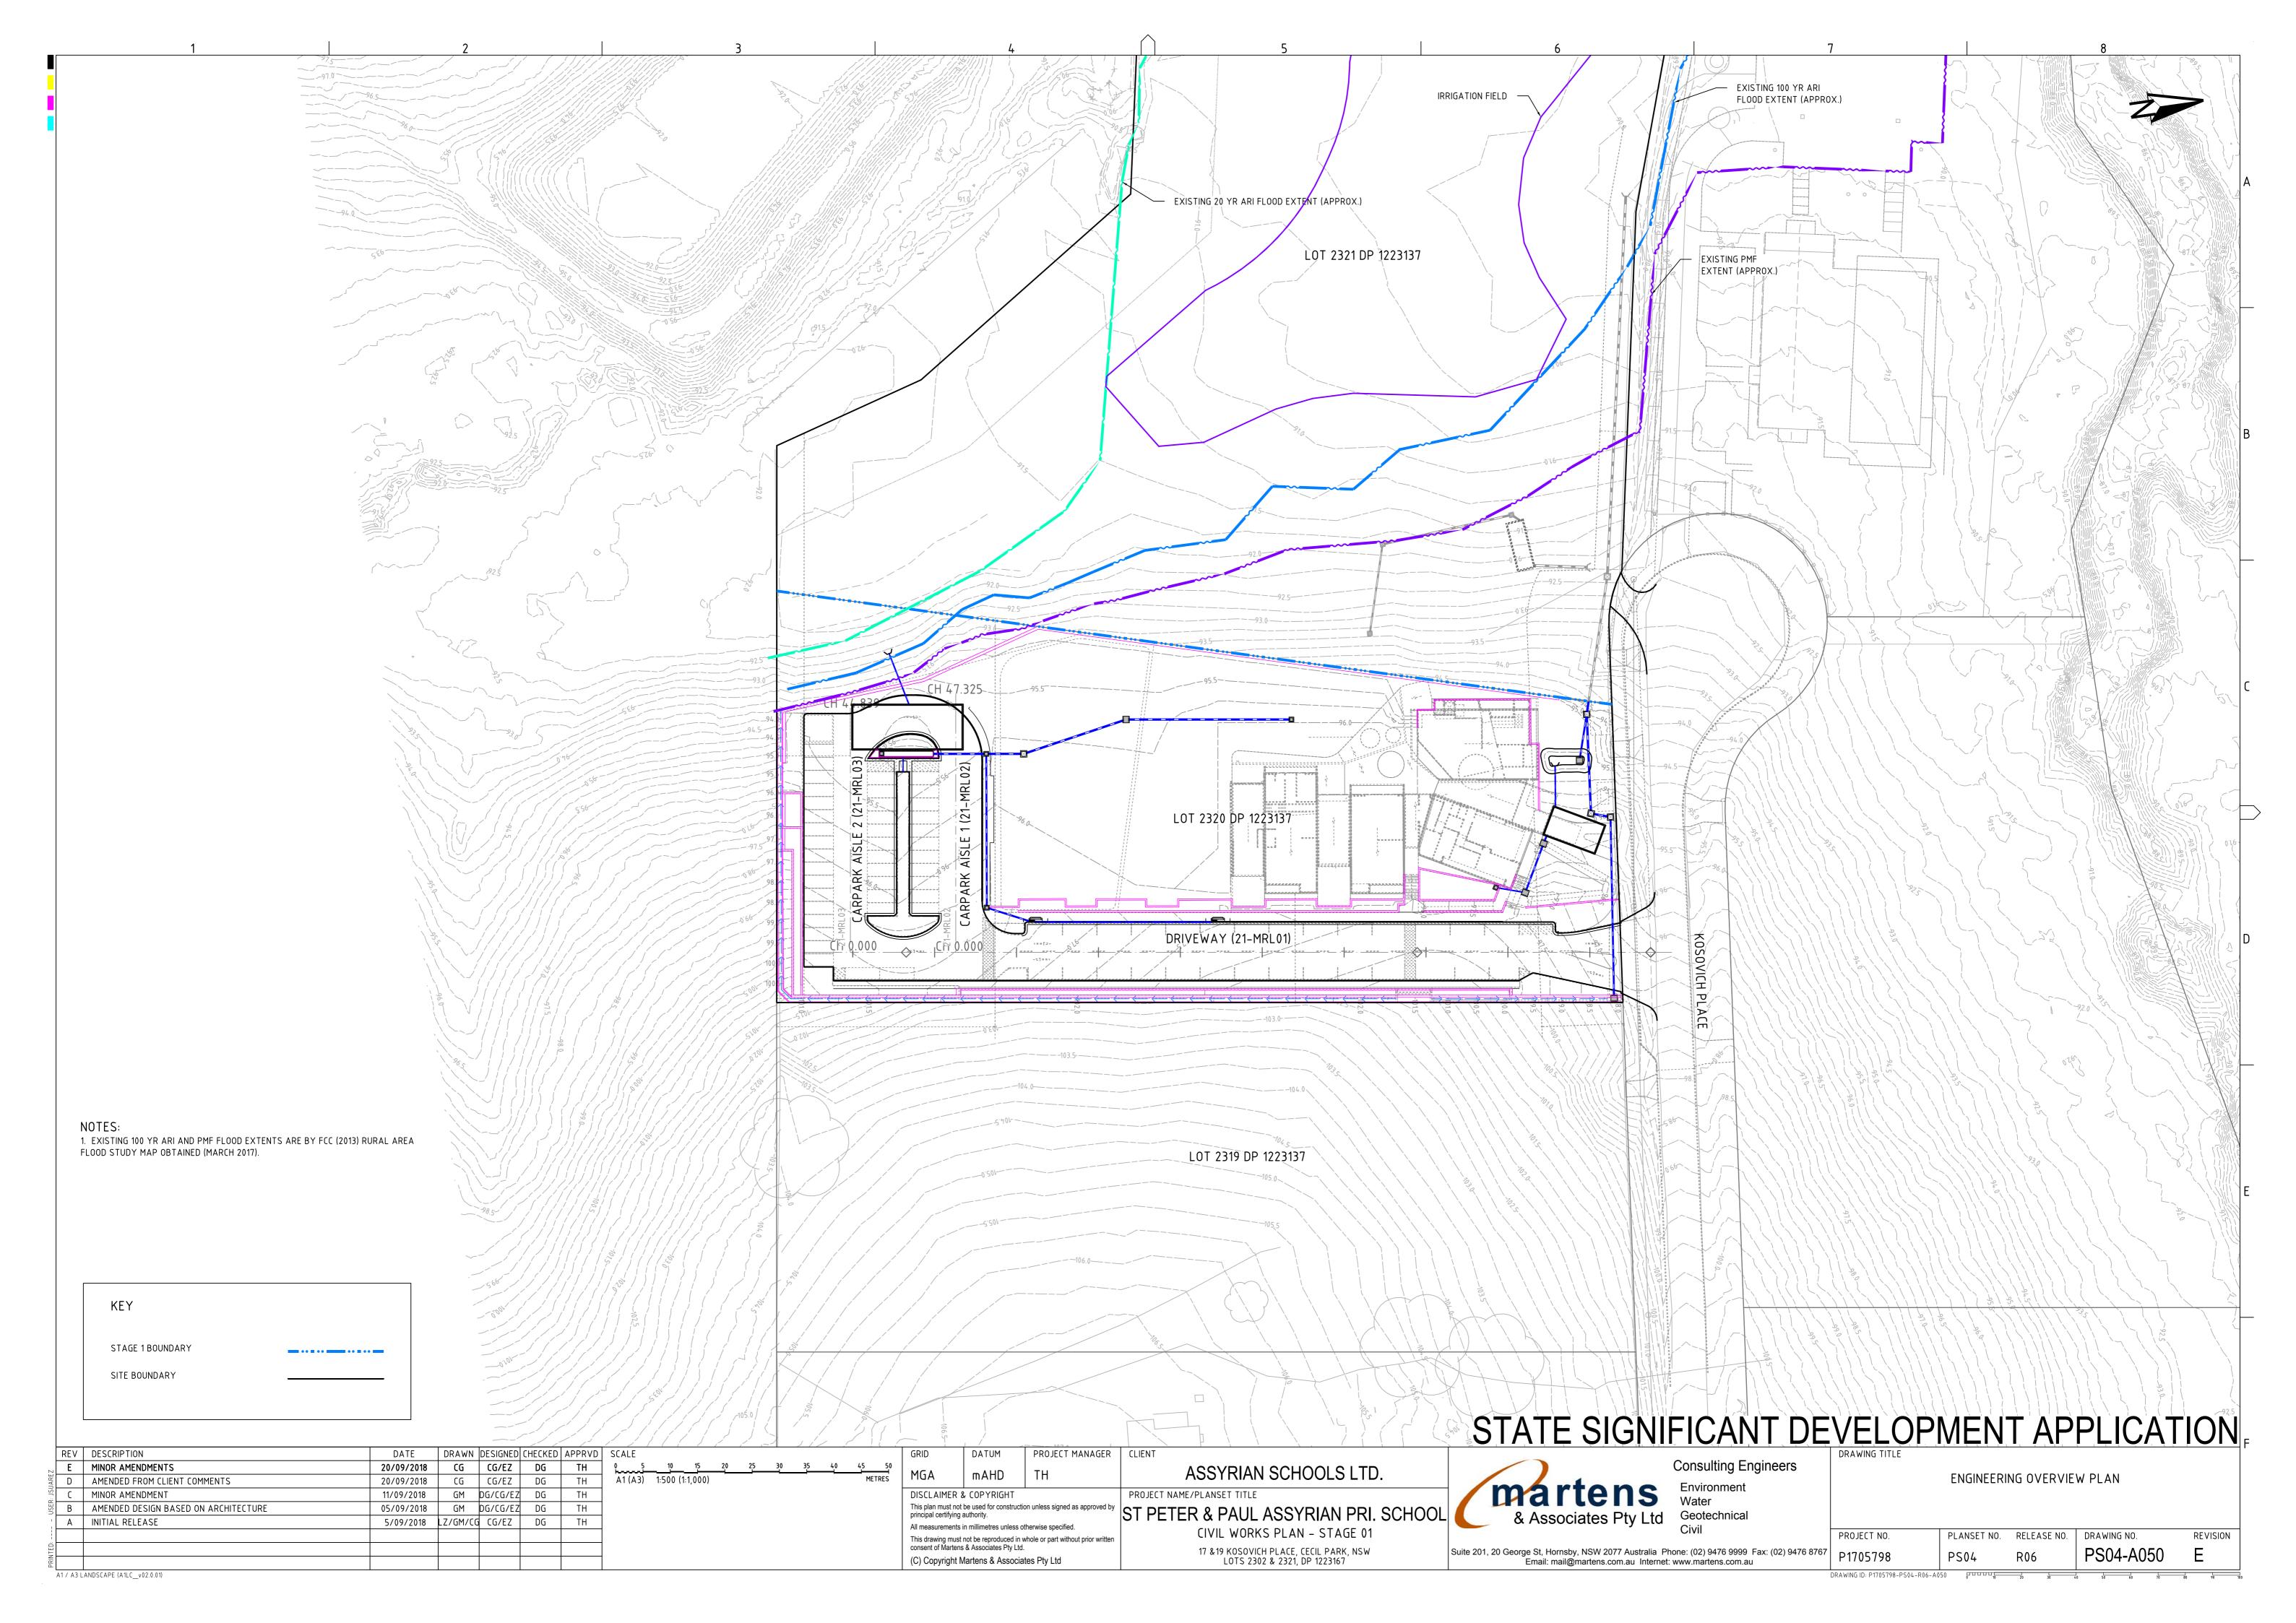

### SHAKER PAD (CATTLE GRID)


A CORRECTLY DESIGNED AND INSTALLED SHAKER PAD WILL ASSIST IN PREVENTING SEDIMENT TRANSFERE FROM A SITE. ANY STABILISED ACCESS POINT (SAP) CAN BE DESIGNED WITH A SHAKER PAD (COMPULSOPRY IN TYPE II SAP'S)


SHAKER PADS CAN BE DESIGNED AND CONSTRUCTED TO ENABLE RE-USE ON FUTURE PROJECTS.


### THE SHAKER PAD:

- MUST BE DESIGNED AND CERTIFIED BY A PRACTICING STRUCTURAL ENGINEER. THE CERTIFIED DESIGN SHOULD BE SUBMITTED WITH THE RELEVENT
- CAN BE CONSTRUCTED FROM ANY SUITABLE MATERIAL.
- MUST BE LOCATED ON A SUITABLY PREPARED AND COMPACTED SUB-GRADE/BASE MATERIAL
- MUST BE SITUATED SUCH THAT THE RUNGS OF THE SHAKER PAD ARE LEVEL WITH THE ADJOINING NATURAL SURFACE.
- MUST BE A MINIMUM OF 3.5m IN LENGTH.
- MUST BE A MINIMUN OF 3.5m IN WIDTH.
- MUST HAVE CLEAR SPACING BETWEEN RUNGS OF 200 250mm.
- RUNGS MUST HAVE A MAXIMUM WIDTH (BEARING AREA) OF 75mm.
- MUST HAVE A MINIMUM CLEAR DEPTH OF 300mm IE FORM THE ROP OF THE RUNG TO THE FINISHED SUB-GRADE/BASE LEVEL.

THE SHAKER PAD MUST BE PROVIDED WITH SUITABLE BARRIERS AT THE SIDES TO ENSURE THAT ALL TYRES OF VEHICLES LEAVING THE SITE

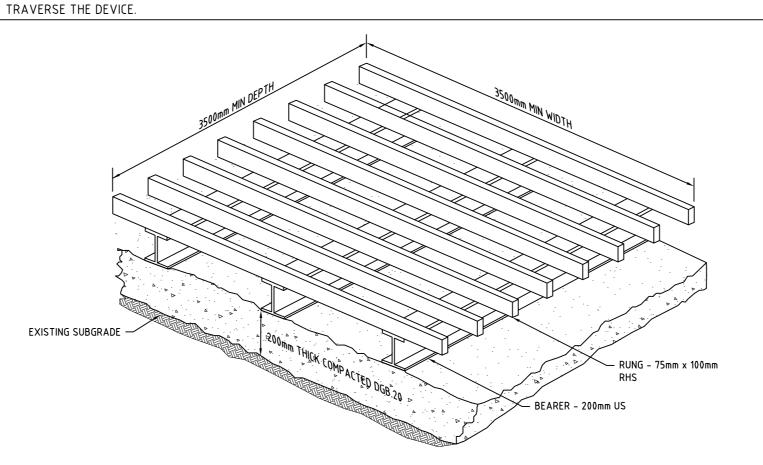

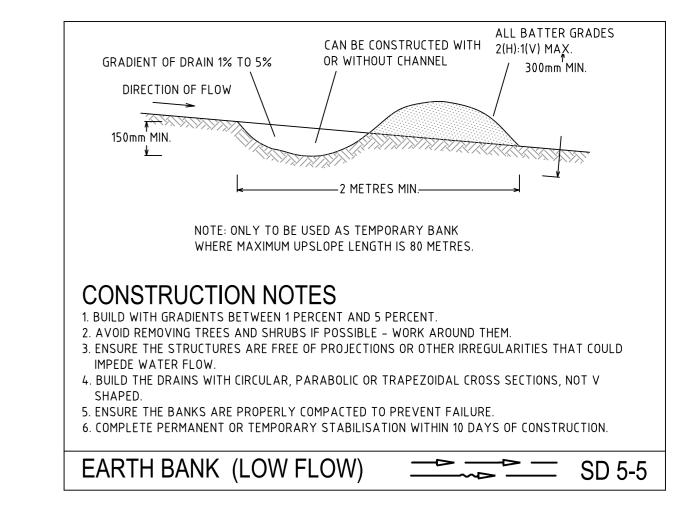

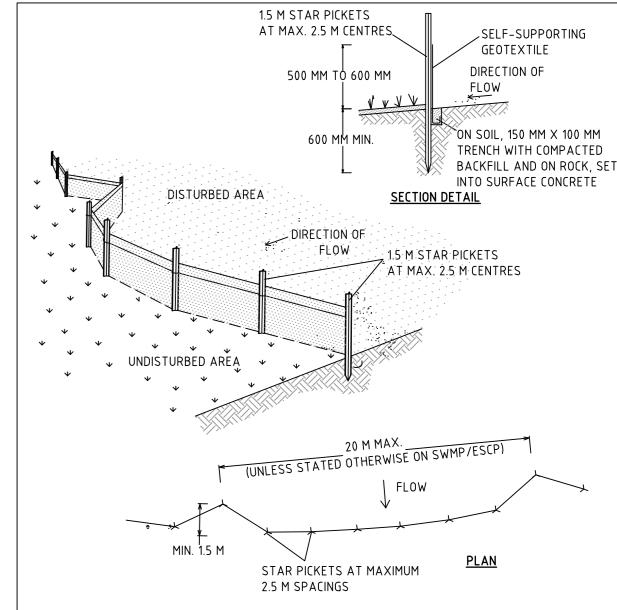

### **CONSTRUCTION NOTES**

1. CONSTRUCT SEDIMENT FENCES AS CLOSE AS POSSIBLE TO BEING PARALLEL TO THE CONTOURS OF THE SITE, BUT WITH SMALL RETURNS AS SHOWN IN THE DRAWING TO LIMIT THE CATCHMENT AREA OF ANY ONE SECTION.THE CATCHMENT AREA SHOULD BE SMALL ENOUGH TO LIMIT WATER FLOW IF CONCENTRATED AT ONE POINT TO 50 LITRES PER SECOND IN THE DESIGN STORM EVENT, USUALLY THE

2. CUT A 150-MM DEEP TRENCH ALONG THE UPSLOPE LINE OF THE FENCE FOR THE BOTTOM OF THE

FABRIC TO BE ENTRENCHED.


3. DRIVE 1.5 METRE LONG STAR PICKETS INTO GROUND AT 2.5 METRE INTERVALS (MAX) AT THE DOWNSLOP EDGE OF THE TRENCH. ENSURE ANY STAR PICKETS ARE FITTED WITH SAFETY CAPS. 4. FIX SELF-SUPPORTING GEOTEXTILE TO THE UPSLOPE SIDE OF THE POSTS ENSURING IT GOES TO THE BASE OF THE TRENCH. FIX THE GEOTEXTILE WITH WIRE TIES OR AS RECOMMENDED BY THE MANUFACTURER. ONLY USE GEOTEXTILE SPECIFICALLY PRODUCED FOR SEDIMENT FENCING. THE USE OF SHADE CLOTH FOR THIS PURPOSE IS NOT SATISFACTORY.


5. JOIN SECTIONS OF FABRIC AT A SUPPORT POST WITH A 150-MM OVERLAP.

6. BACKFILL THE TRENCH OVER THE BASE OF THE FABRIC AND COMPACT IT THOROUGHLY OVER THE GEOTEXTILE.

SEDIMENT FENCE

STATE SIGNIFICANT DEVELOPMENT APPLICATION

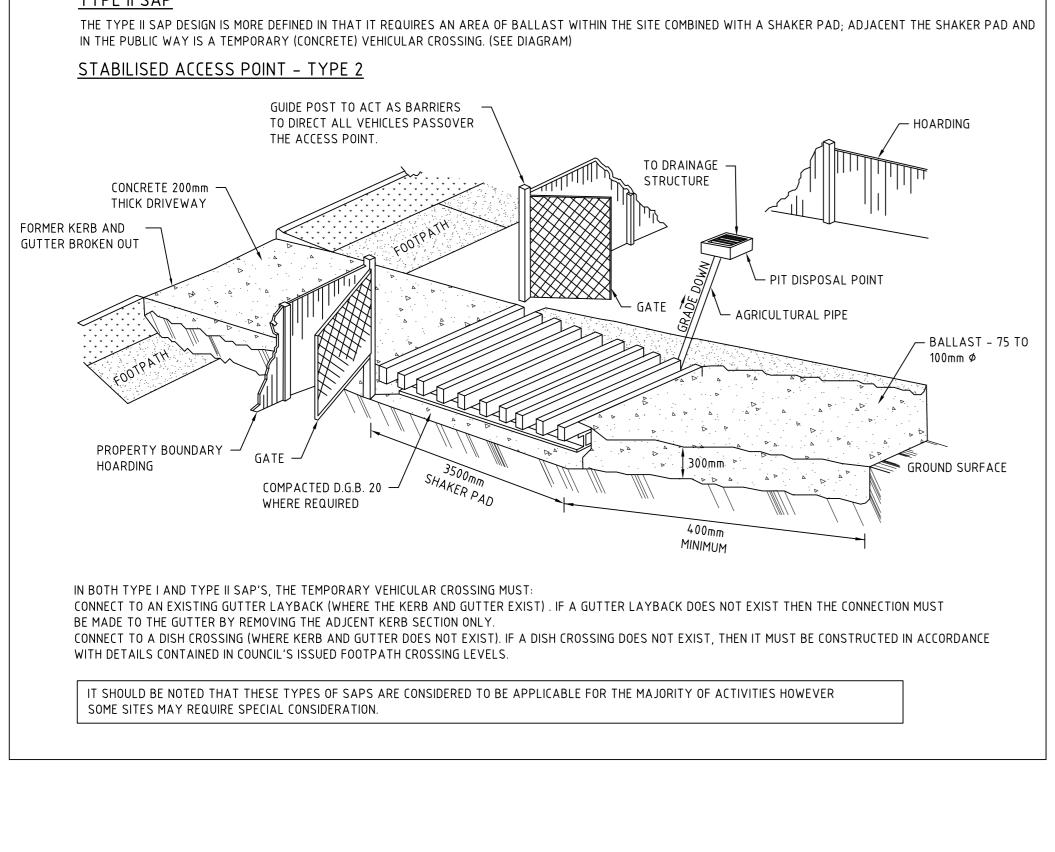

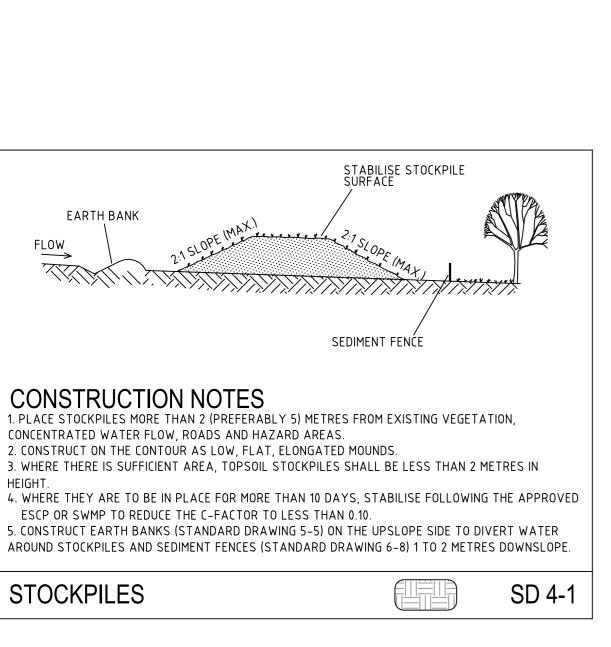

20/09/2018

11/09/2018

05/09/2018

DRAWN DESIGNED CHECKED APPRVD SCALE

DG


CG | CG/EZ | DG


GM DG/CG/EZ DG

GM DG/CG/EZ DG

CG CG/EZ

5/09/2018 LZ/GM/CG CG/EZ DG

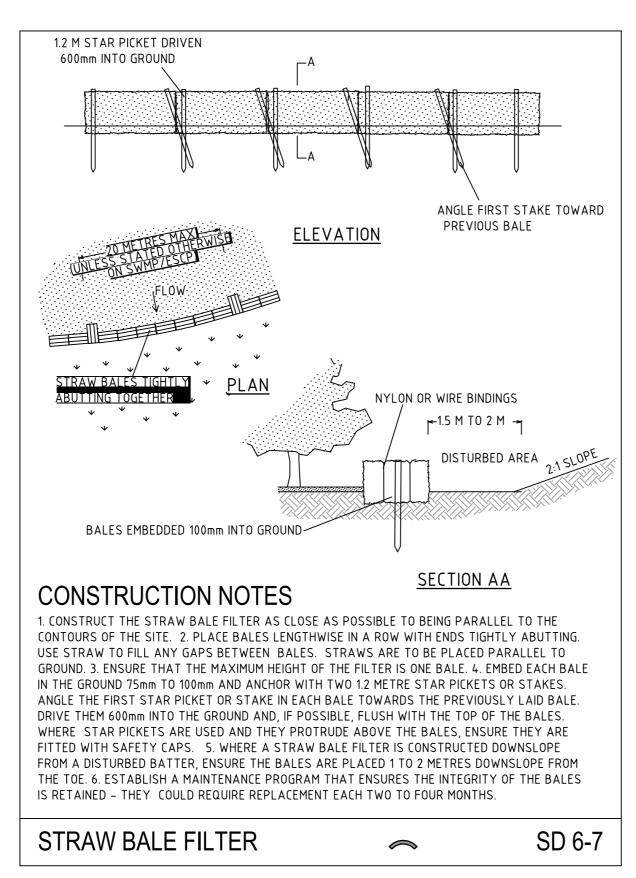

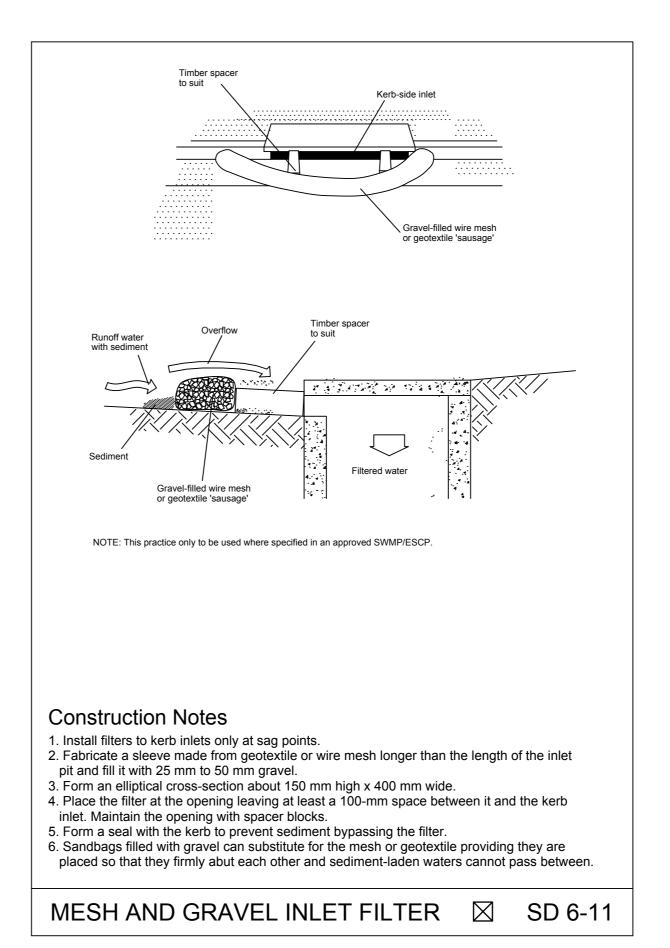

MENT EACH TWO TO FOUR MONTHS.		
	SD 6-7	

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Consulting Engineers

SEDIMENT & EROSION CONTROL DETAILS PROJECT NO. RELEASE NO. DRAWING NO. REVISION PS04-B31 DRAWING ID: P1705798-PS04-R06-B310

A1 / A3 LANDSCAPE (A1LC\_v02.0.01)

A | INITIAL RELEASE


REV | DESCRIPTION


MINOR AMENDMENTS


MINOR AMENDMENT

AMENDED FROM CLIENT COMMENTS

AMENDED DESIGN BASED ON ARCHITECTURE

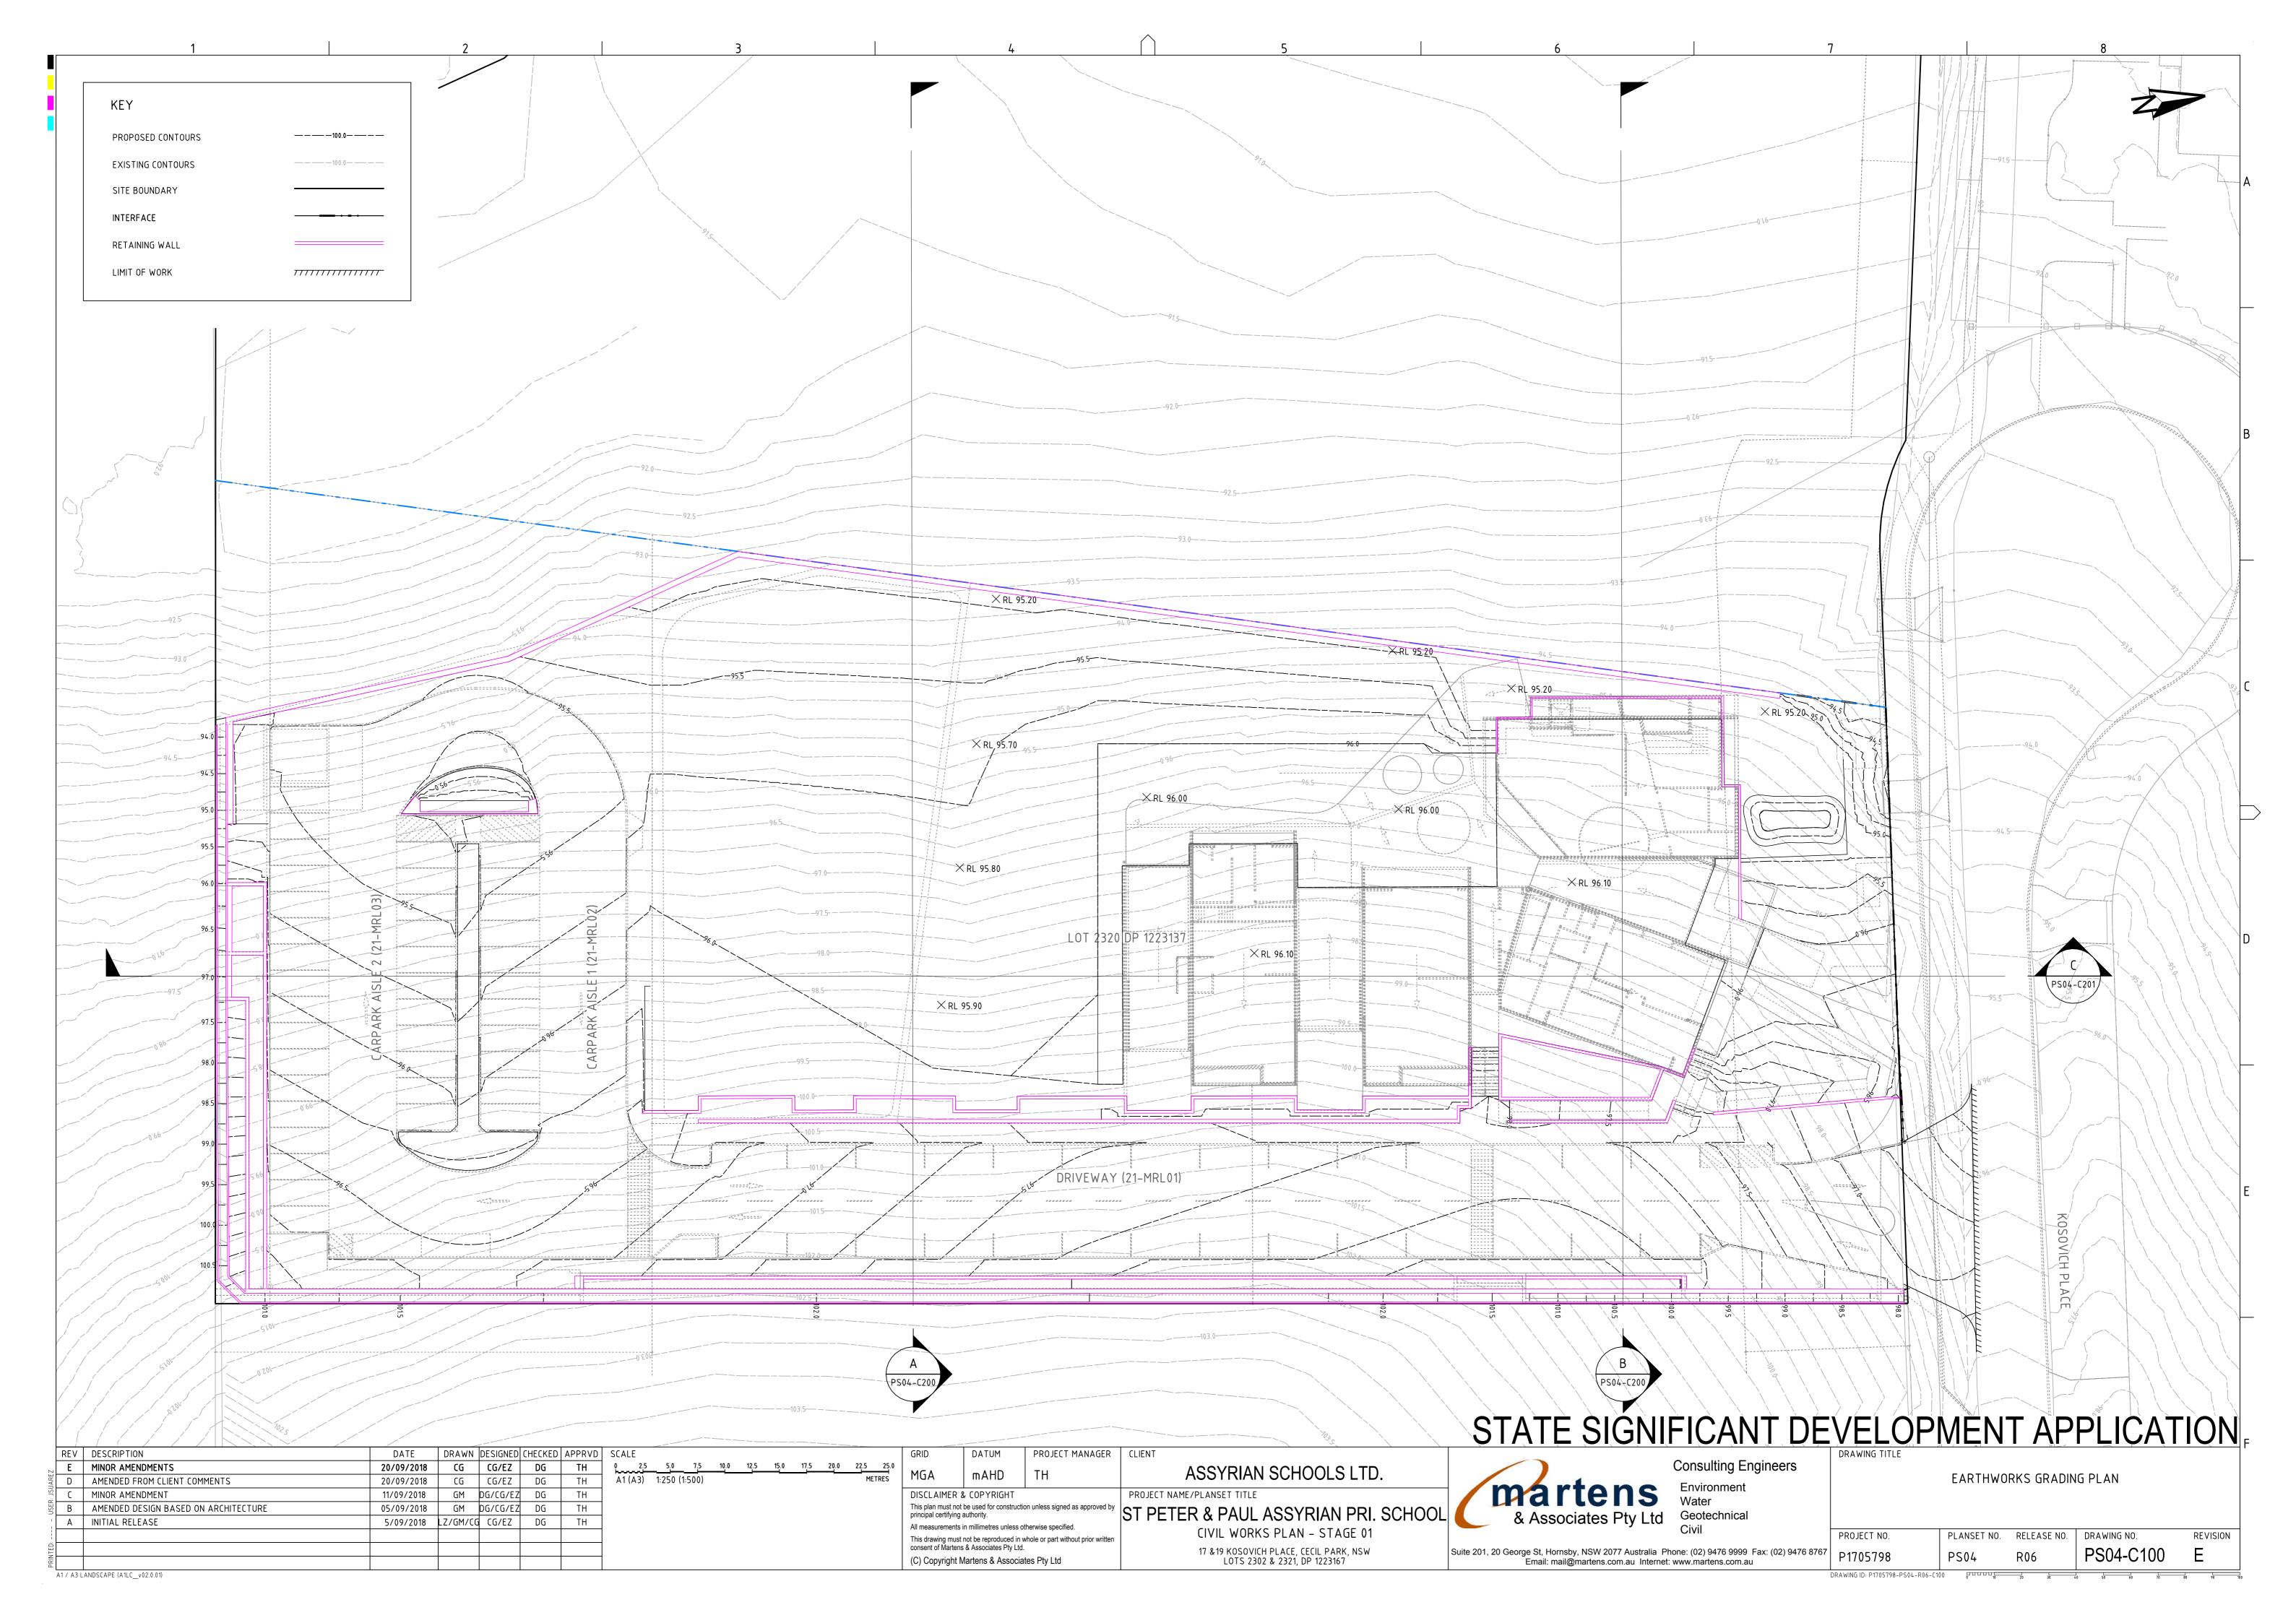

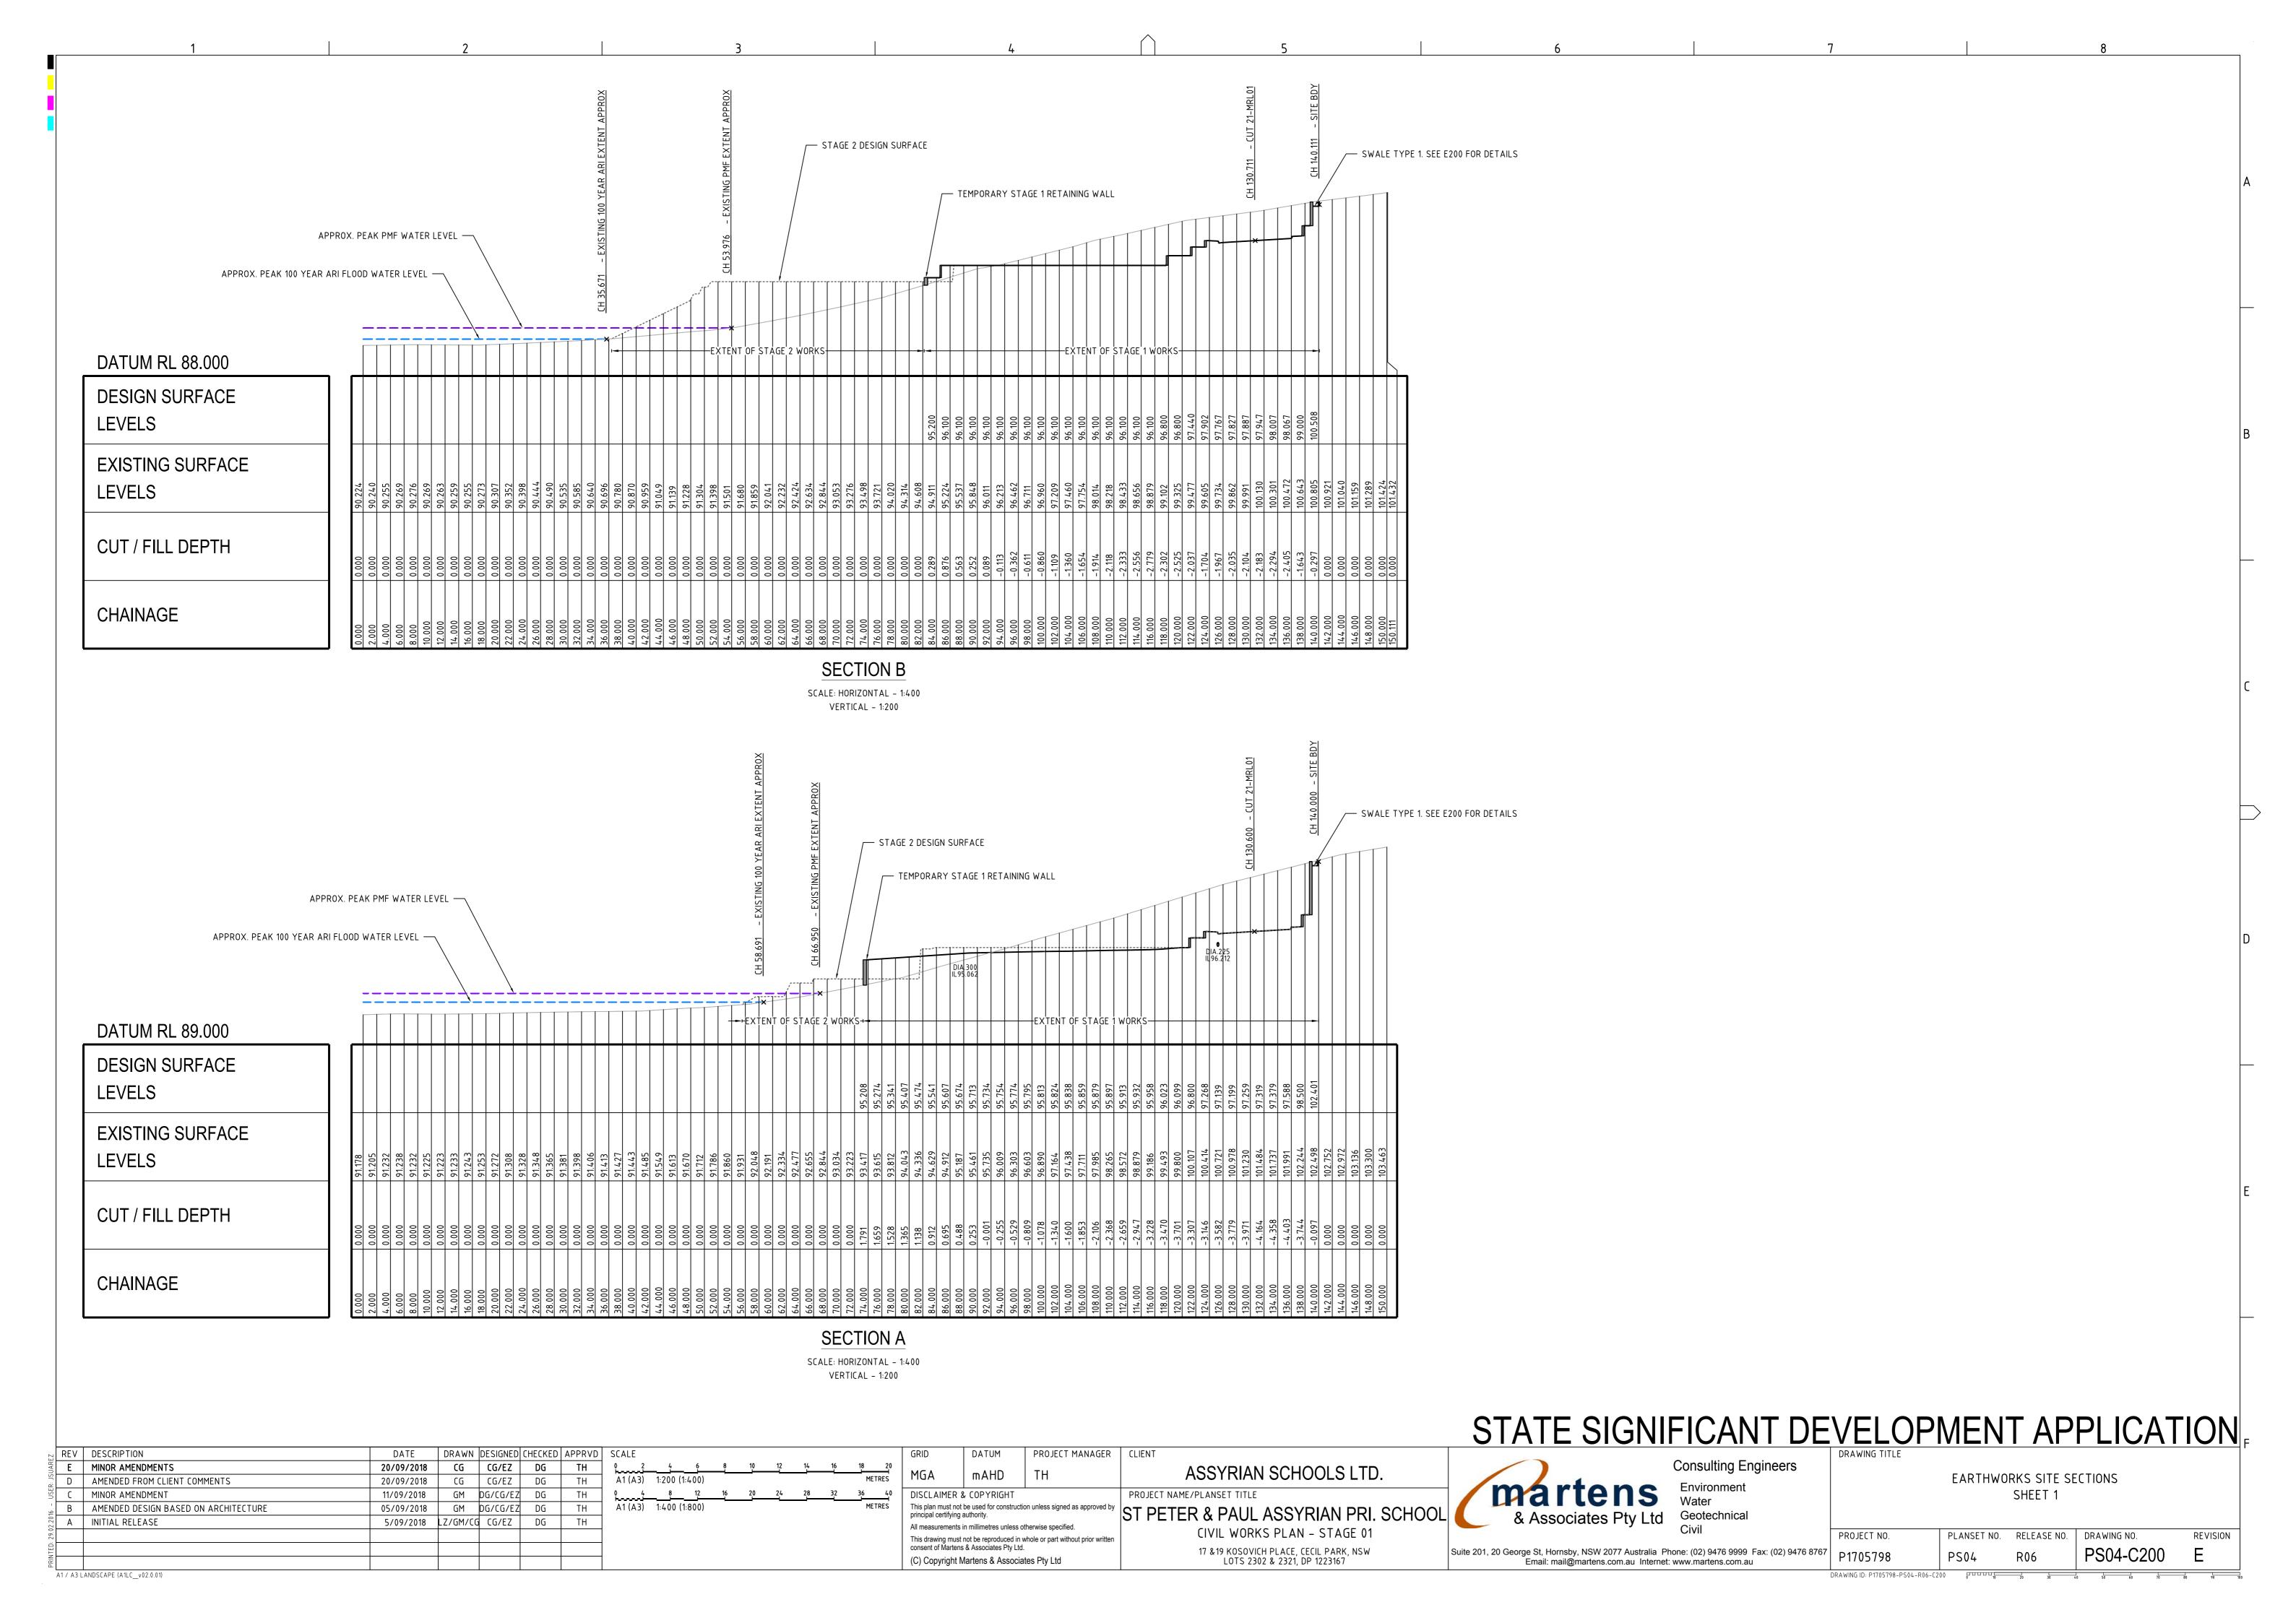

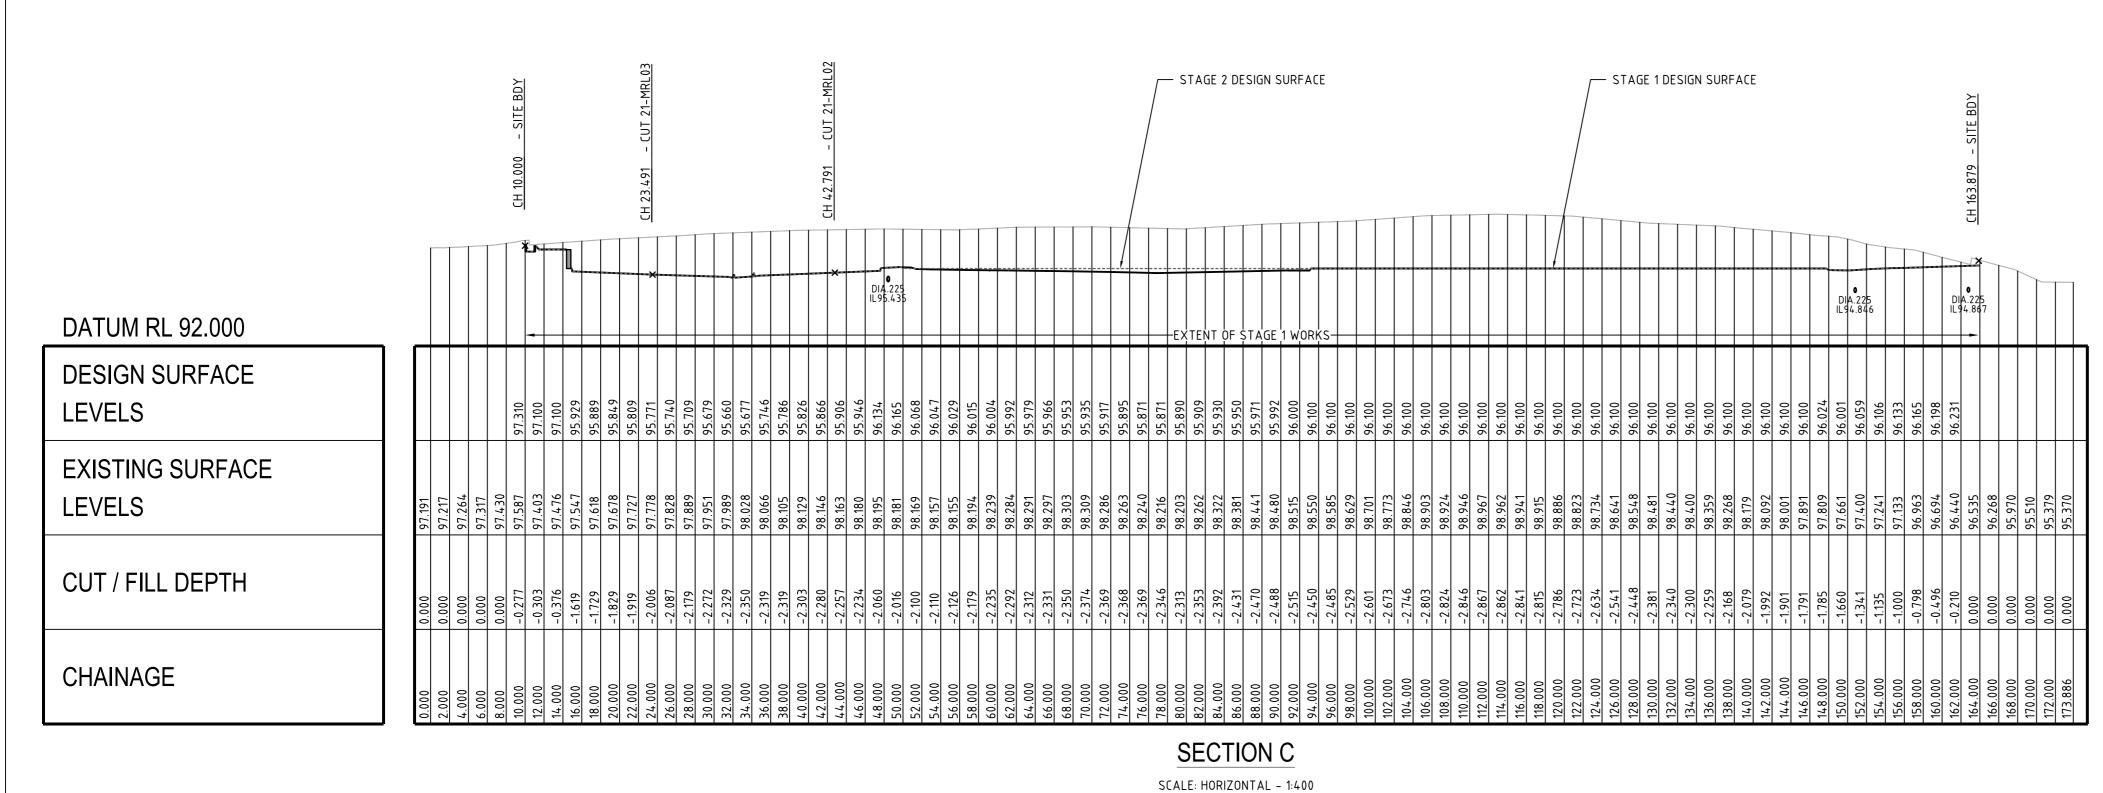

VERTICAL - 1:200

DRAWN DESIGNED CHECKED APPRVD SCALE REV DESCRIPTION E MINOR AMENDMENTS CG CG/EZ DG 20/09/2018 A1 (A3) 1:200 (1:400) AMENDED FROM CLIENT COMMENTS CG CG/EZ DG 20/09/2018 TH GM DG/CG/EZ DG TH MINOR AMENDMENT A1 (A3) 1:400 (1:800) B AMENDED DESIGN BASED ON ARCHITECTURE GM DG/CG/EZ DG TH A INITIAL RELEASE 5/09/2018 LZ/GM/CG CG/EZ DG (C) Copyright Martens & Associates Pty Ltd

A1 / A3 LANDSCAPE (A1LC\_v02.0.01)


PROJECT MANAGER | CLIENT ASSYRIAN SCHOOLS LTD.  $\mathsf{mAHD}$ PROJECT NAME/PLANSET TITLE DISCLAIMER & COPYRIGHT This plan must not be used for construction unless signed as approved by ST PETER & PAUL ASSYRIAN PRI. SCHOOL principal certifying authority. All measurements in millimetres unless otherwise specified. CIVIL WORKS PLAN - STAGE 01 This drawing must not be reproduced in whole or part without prior written consent of Martens & Associates Pty Ltd. 17 &19 KOSOVICH PLACE, CECIL PARK, NSW LOTS 2302 & 2321, DP 1223167


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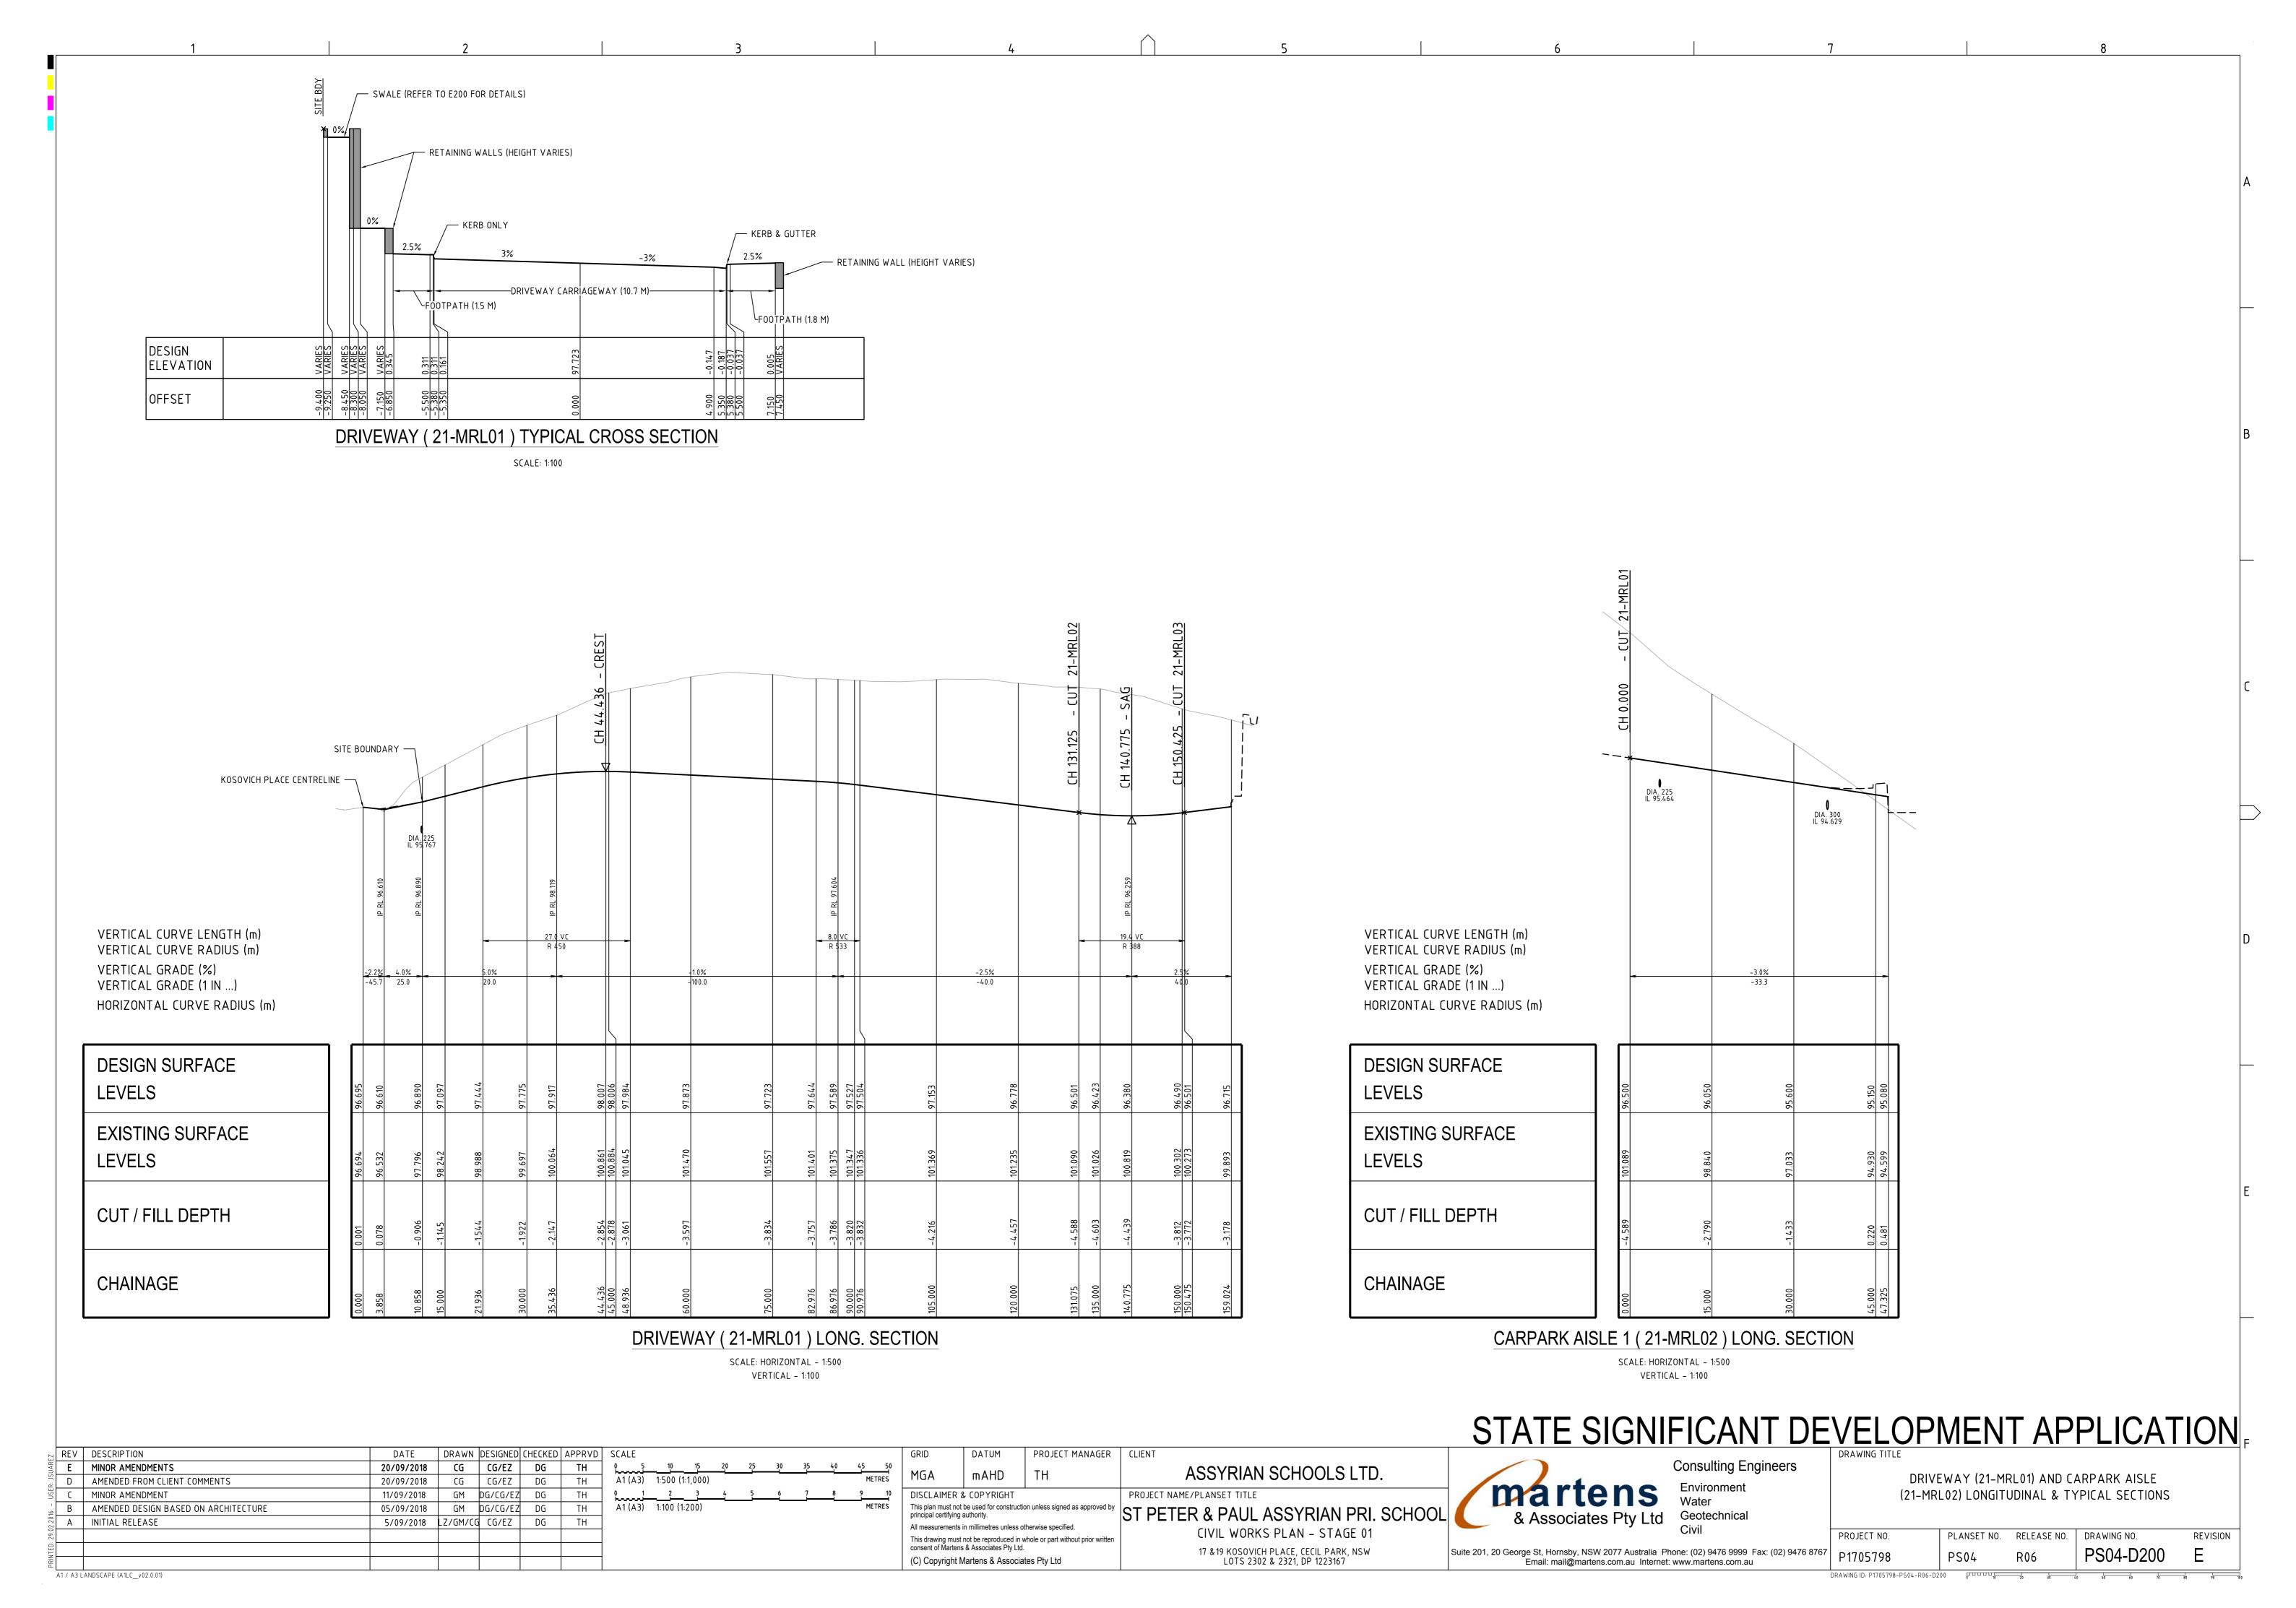
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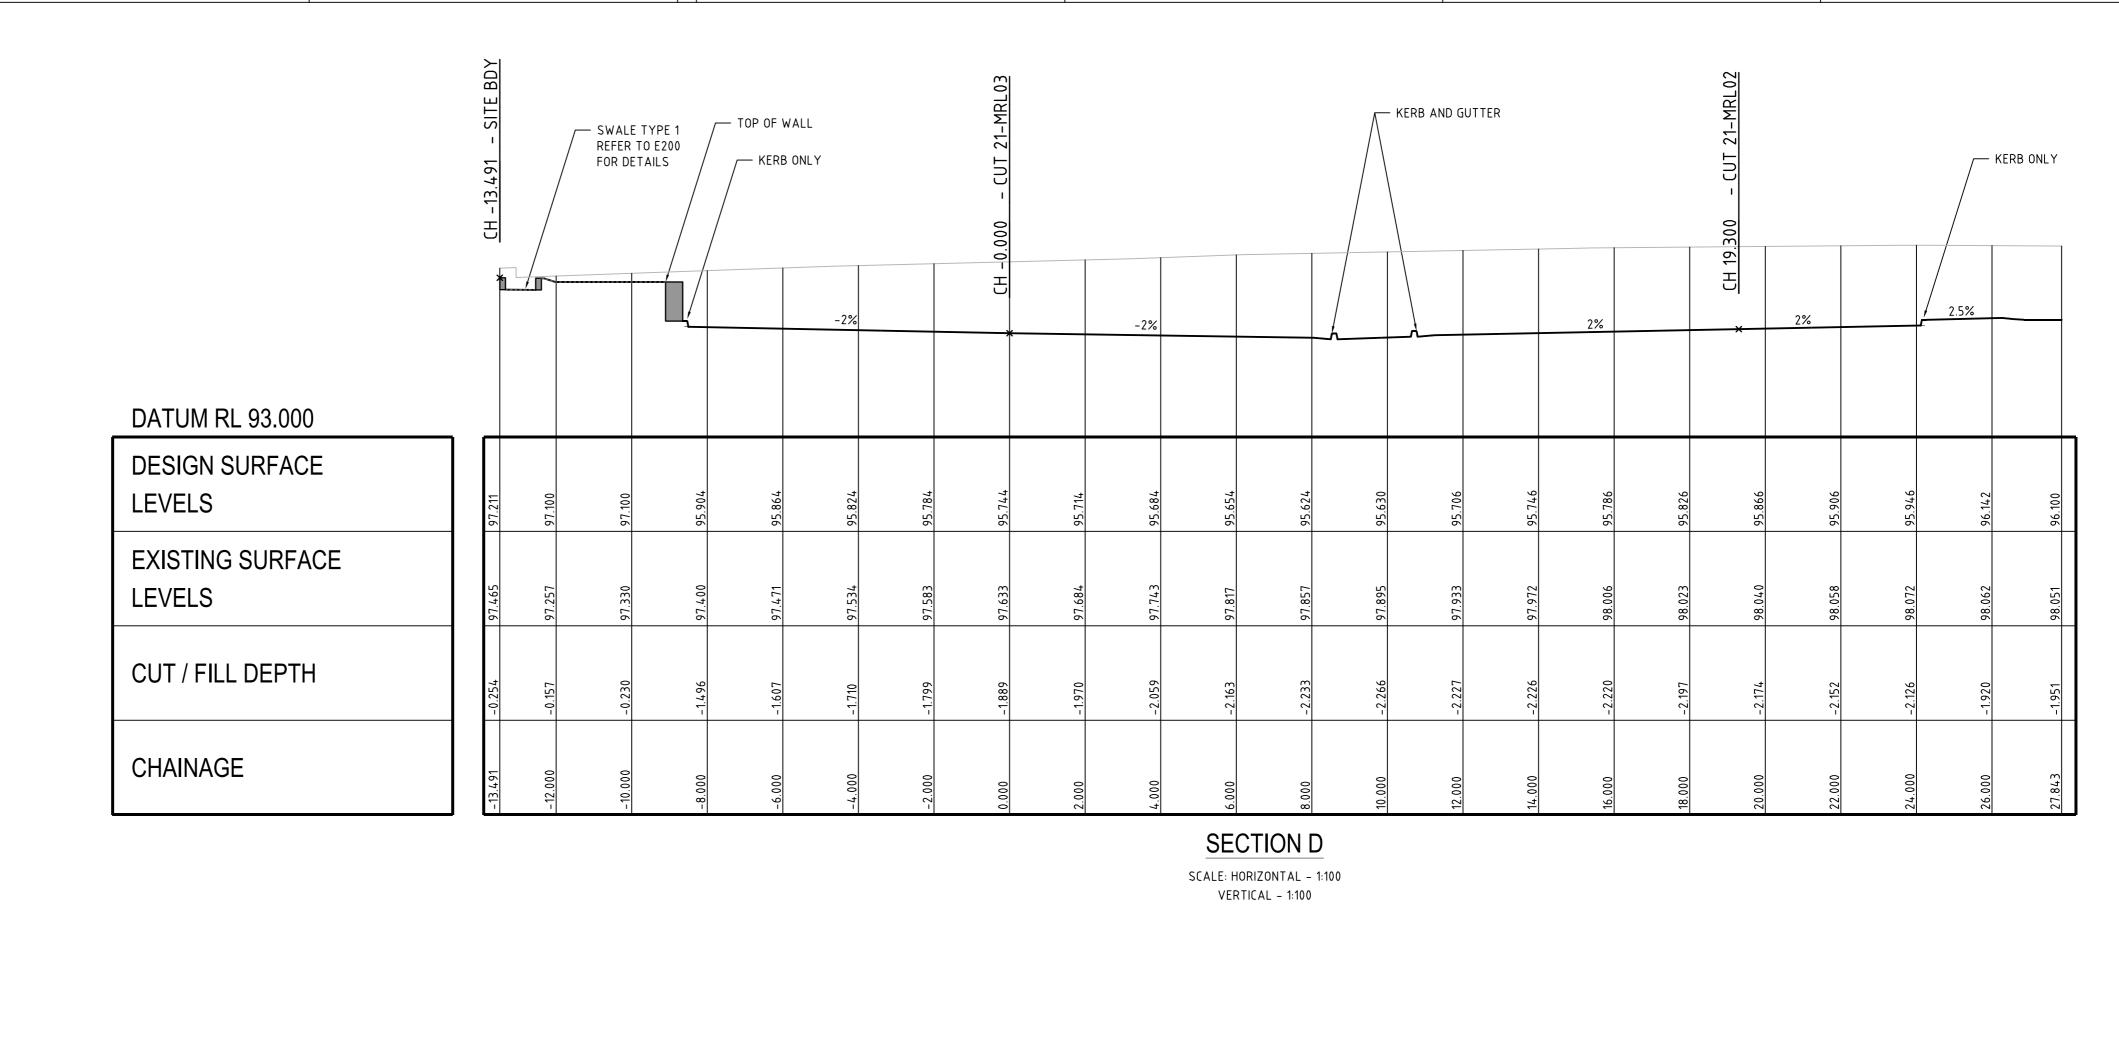
STATE SIGNIFICANT DEVELOPMENT APPLICATION

EARTHWORKS SITE SECTIONS SHEET 2 PROJECT NO. PLANSET NO. RELEASE NO. DRAWING NO. REVISION PS04-C201 DRAWING ID: P1705798-PS04-R06-C201





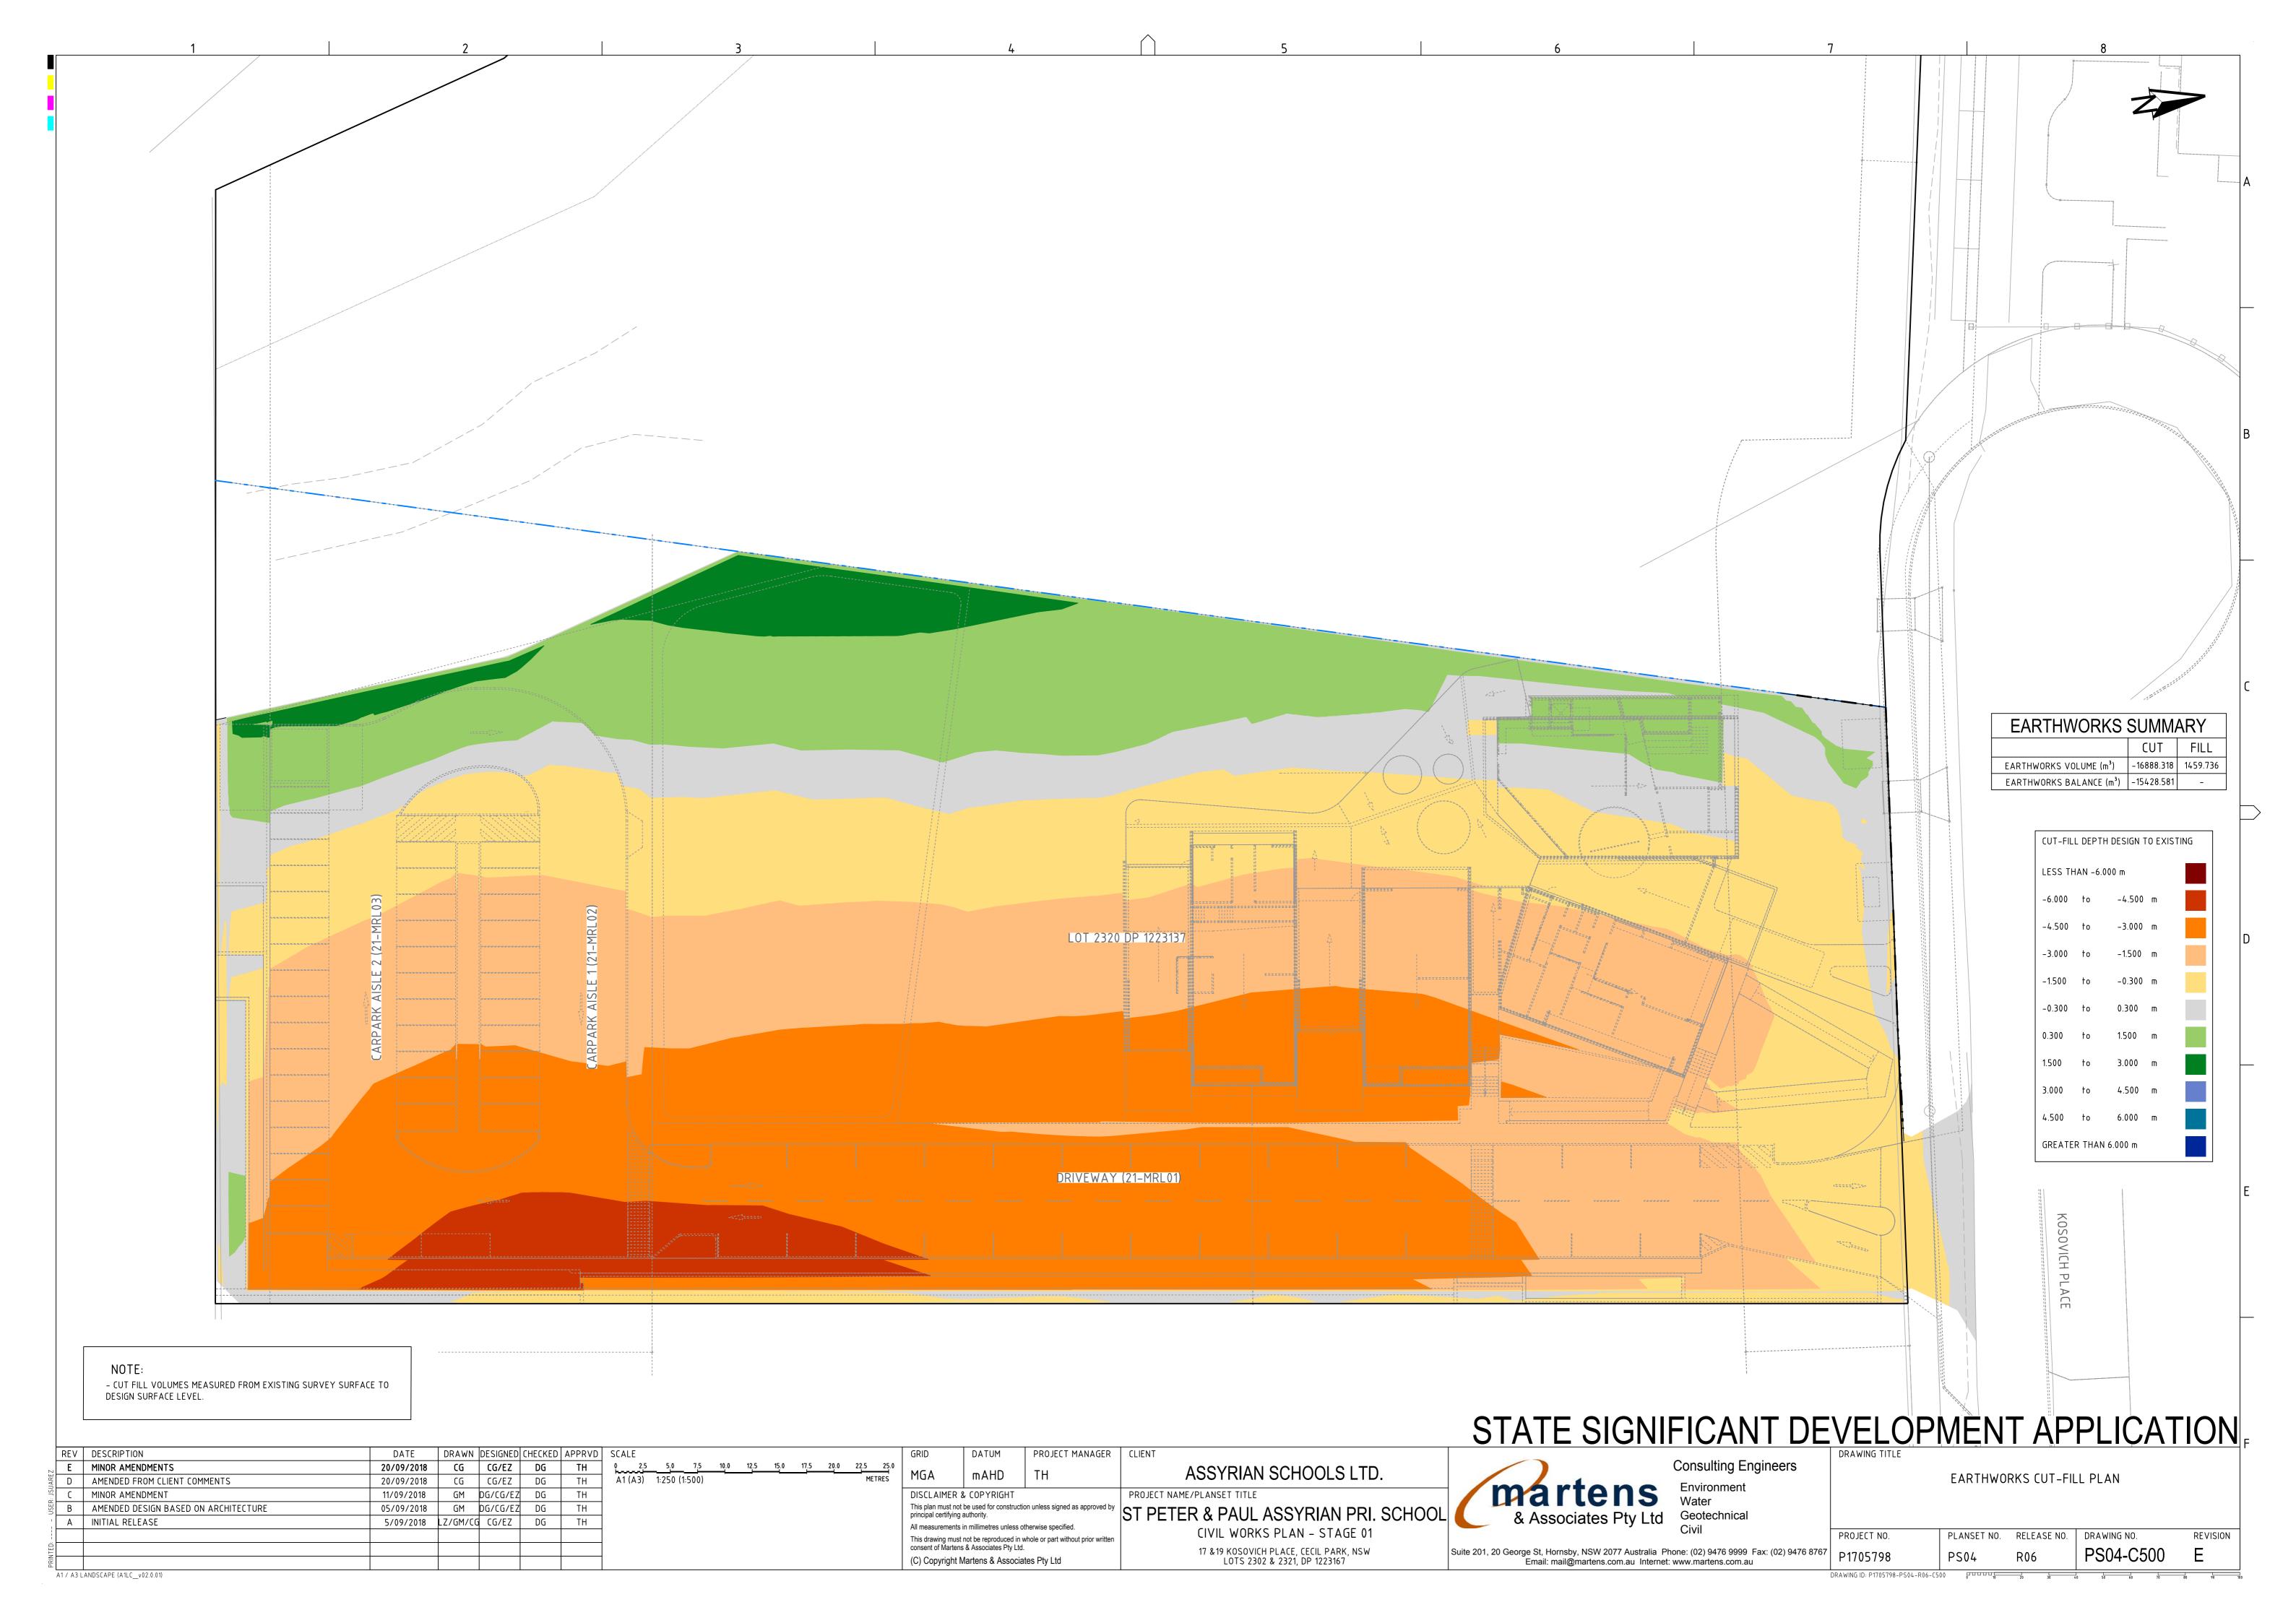

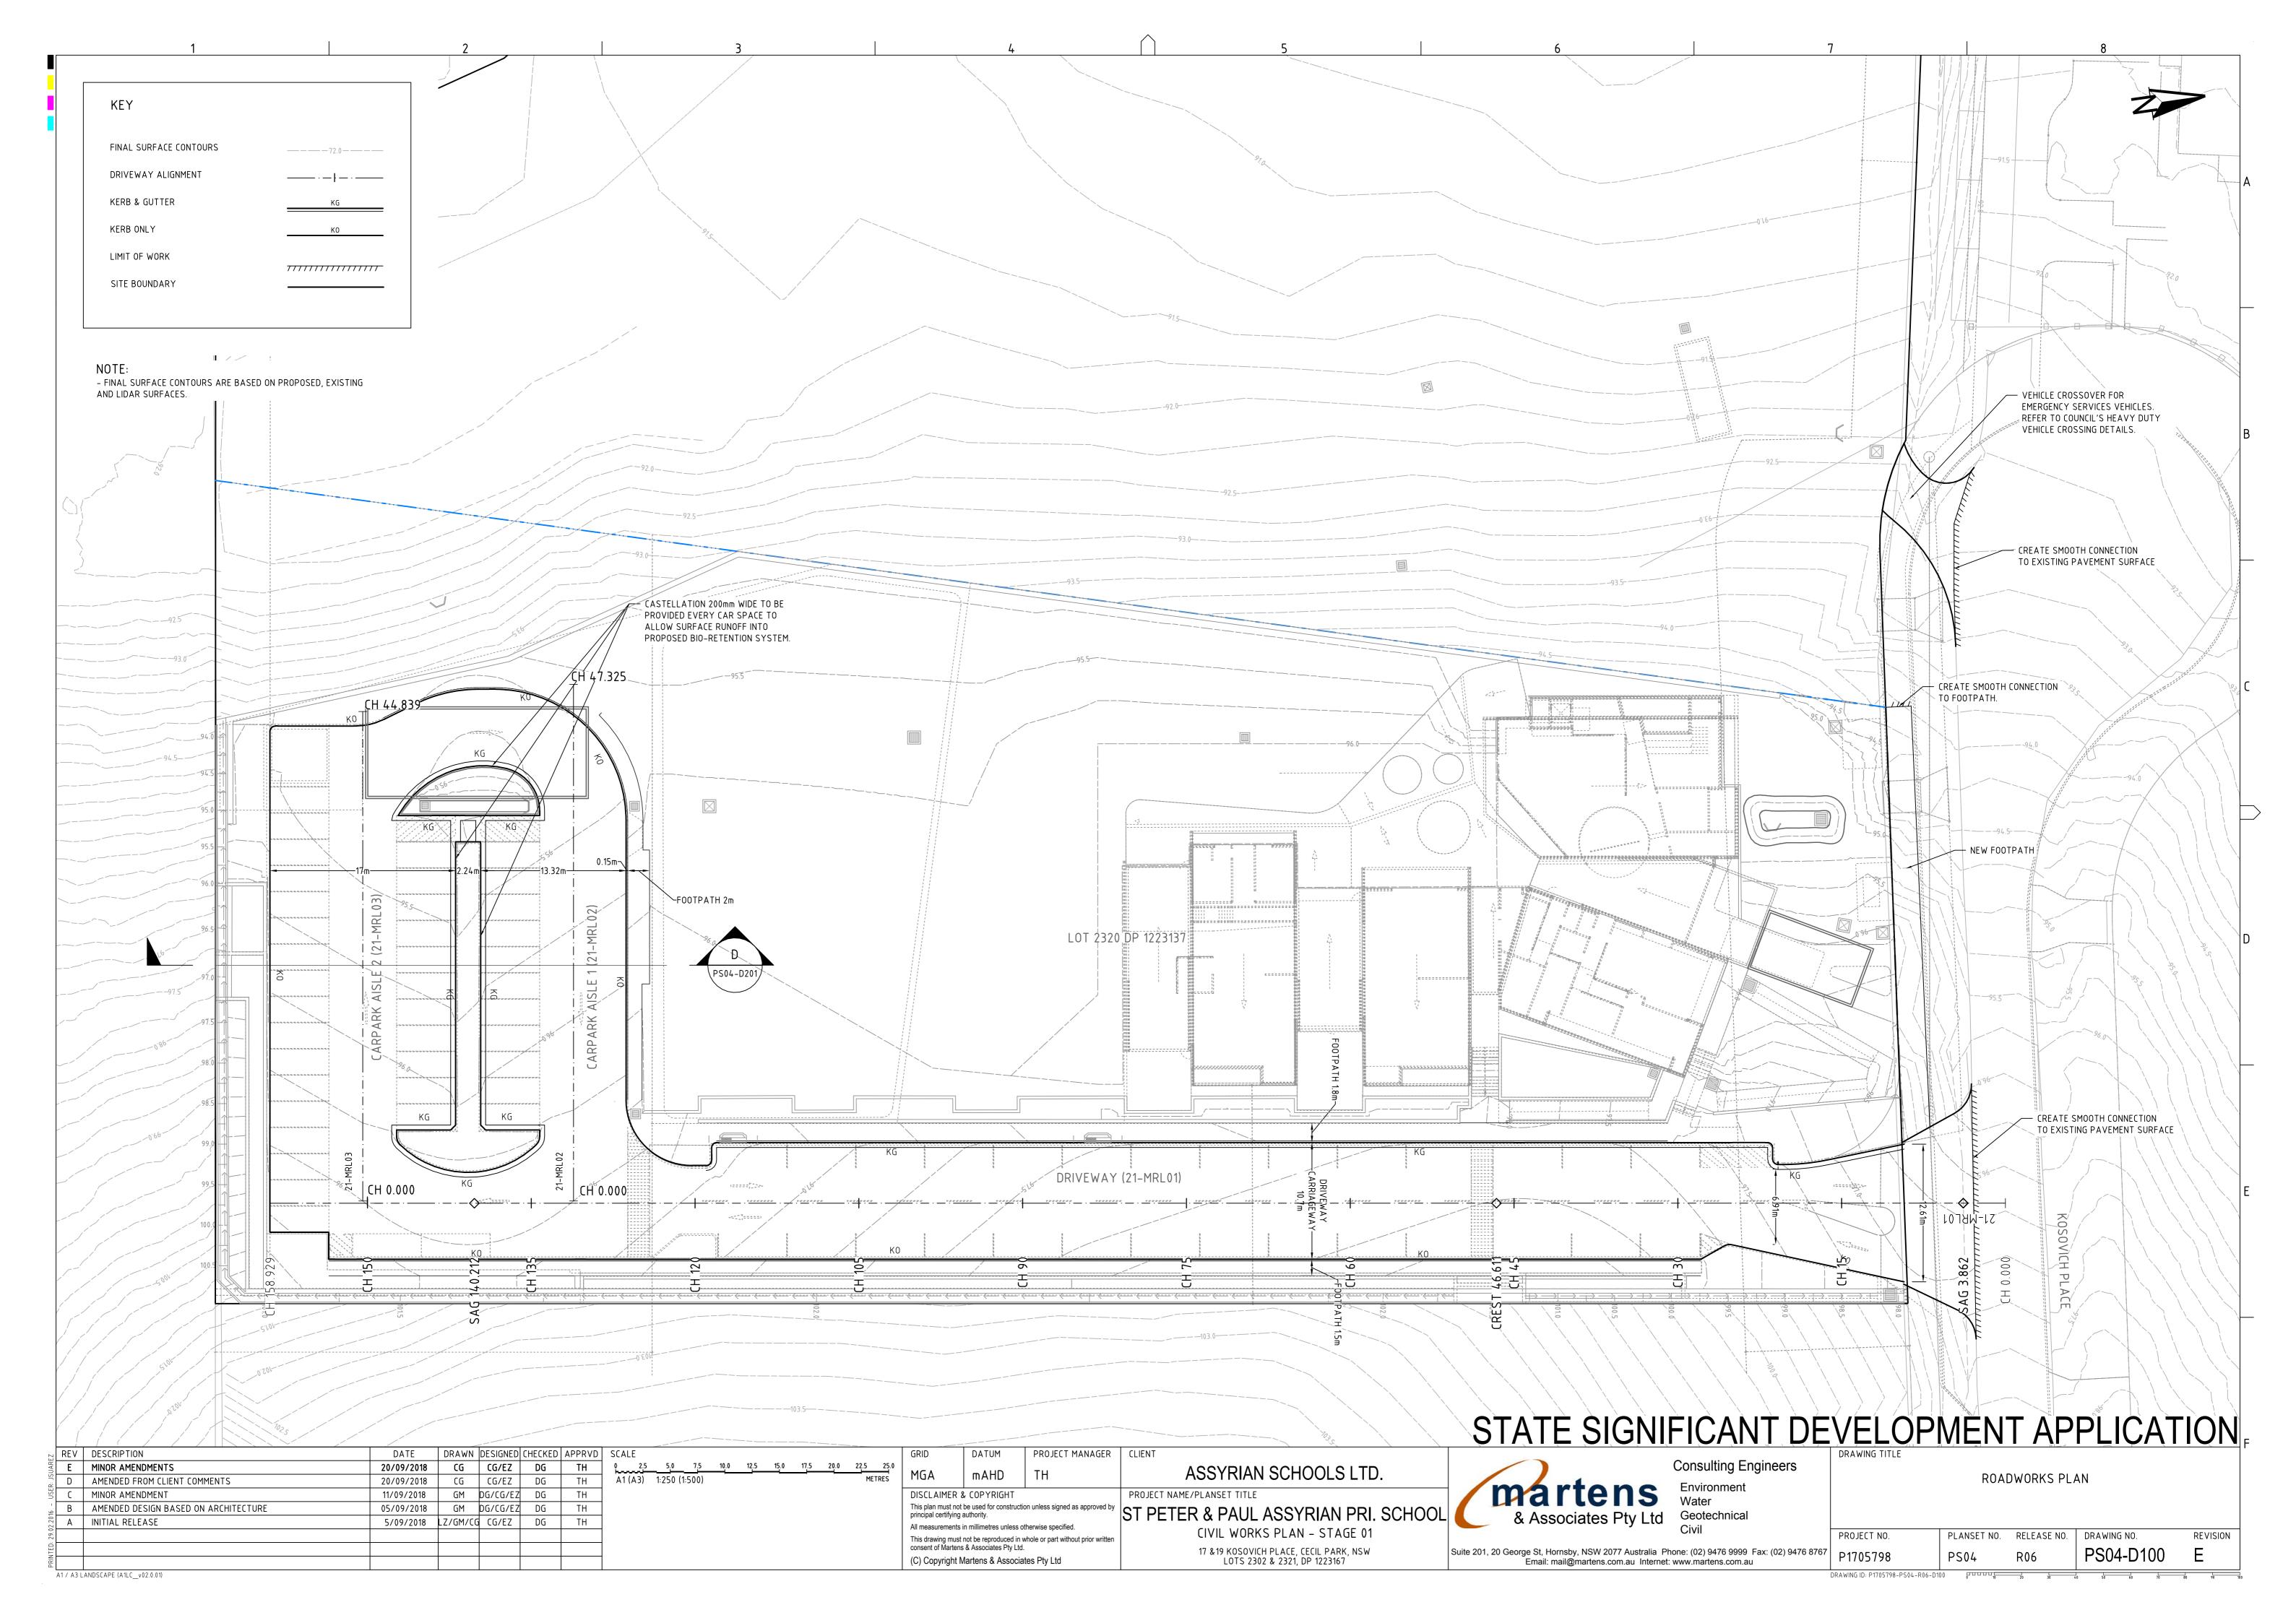

VERTICAL CURVE LENGTH (m) VERTICAL CURVE RADIUS (m) VERTICAL GRADE (%) VERTICAL GRADE (1 IN ...) HORIZONTAL CURVE RADIUS (m) DESIGN SURFACE **LEVELS** 95.476 95.453 **EXISTING SURFACE** 96.463 **LEVELS** CUT / FILL DEPTH CHAINAGE

CARPARK AISLE 2 (21-MRL03) LONG. SECTION

DRAWN DESIGNED CHECKED APPRVD SCALE

TH

TH

TH

TH

A1 (A3) 1:500 (1:1,000)

0 1 2 3 4 5 6 A1 (A3) 1:100 (1:200)

CG CG/EZ DG

CG CG/EZ DG

GM DG/CG/EZ DG

SCALE: HORIZONTAL - 1:500 VERTICAL - 1:100

05/09/2018 GM DG/CG/EZ DG

5/09/2018 LZ/GM/CG CG/EZ DG

20/09/2018

20/09/2018

STATE SIGNIFICANT DEVELOPMENT APPLICATION Consulting Engineers

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CARPARK AISLE (21-MRL03) LONGITUDINAL & TYPICAL SECTIONS

PROJECT NO. PLANSET NO. RELEASE NO. DRAWING NO. REVISION PS04-D201 DRAWING ID: P1705798-PS04-R06-D201

A1 / A3 LANDSCAPE (A1LC\_v02.0.01)

A INITIAL RELEASE


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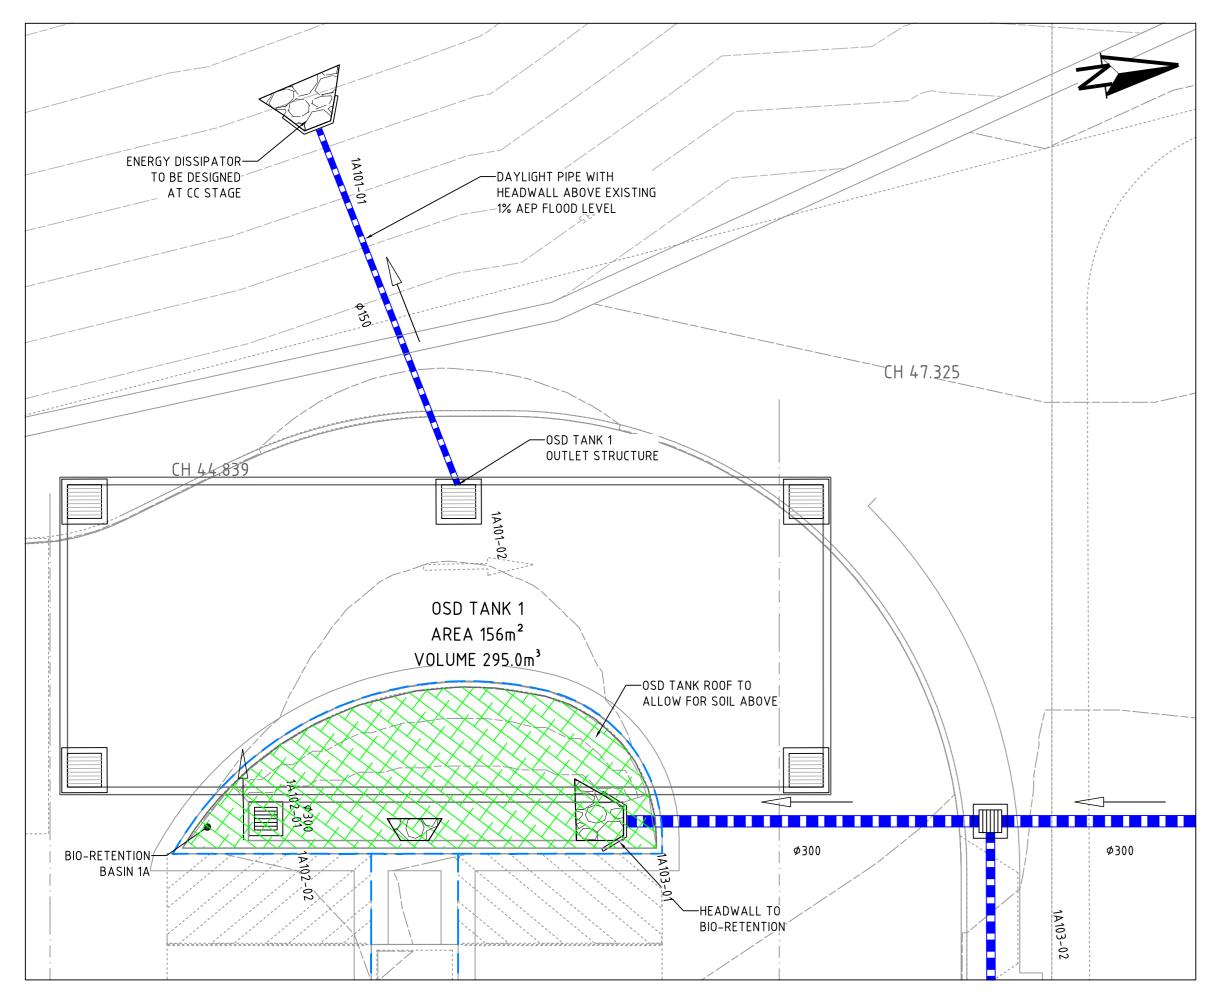
E MINOR AMENDMENTS

MINOR AMENDMENT

D AMENDED FROM CLIENT COMMENTS


B AMENDED DESIGN BASED ON ARCHITECTURE



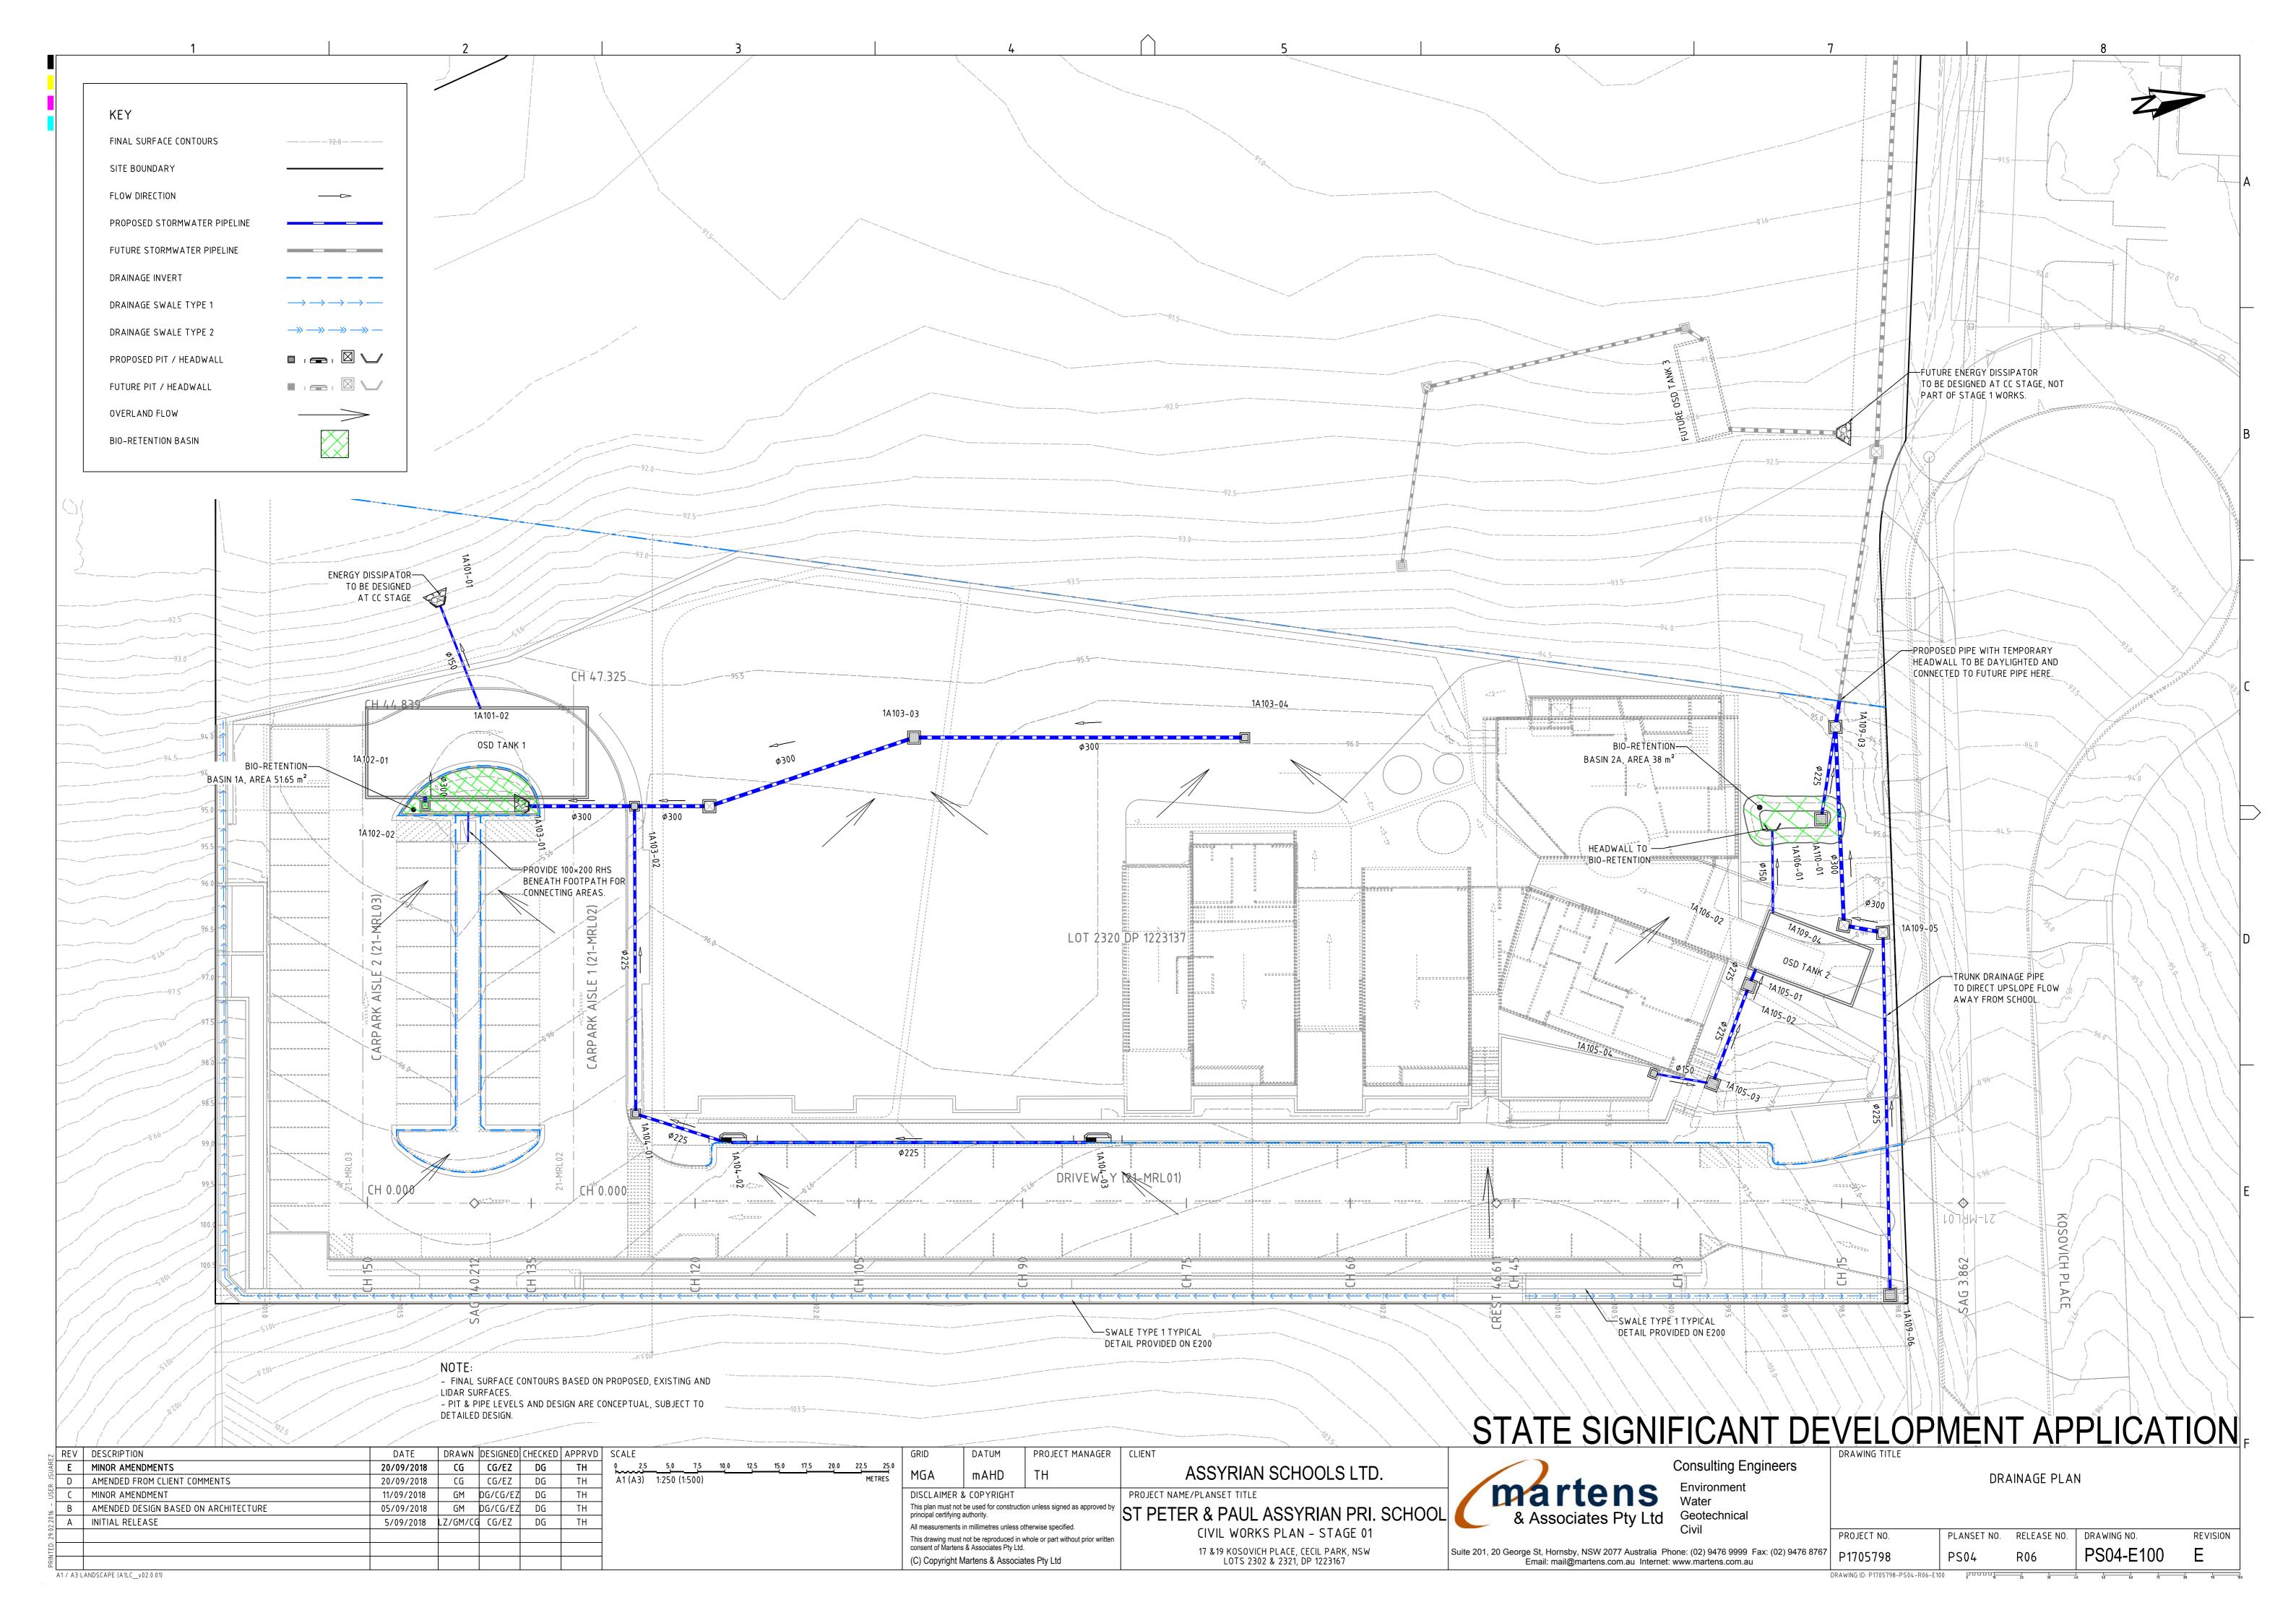

OSD TANK 1 PLAN

SCALE 1:100

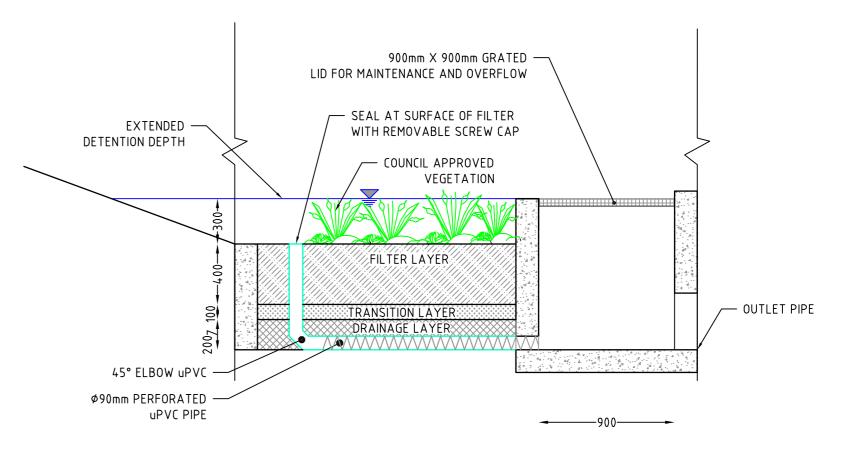

### TYPICAL SECTION: BIORETENTION

SCALE: 1:25

TWL 1% AEP @94.76

4.1m WIDE WEIR
AT RL 94.63

### AT RL 94.63

### AT RL 94.63

ORIFICE-1 #98mm ORIFICE CENTRE LINE @ CL 92.83


### OSD TANK 1 OUTLET STRUCTURE

SCALE: 1:25

2ר90mm RELIEF DRAIN -

WITH GRAVEL SURROUNDED WRAPPED IN GEOTEXTILE FABRIC

NOTES:
- BIO-RETENTION SYSTEM DETAILS TO BE PROVIDED AT CC STAGE AND SHALL BE DESIGNED AS PER FAWB (2009) GUIDELINES.

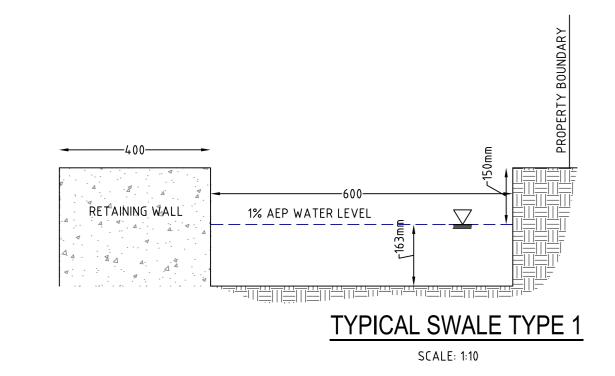

RI	REV DESCRIPTION	DATE	DRAWN DE	SIGNED CHE	CKED APPR'	D SCALE	GRID	DATUM	PROJECT MANAGER	CLIENT	
UAR	E MINOR AMENDMENTS	20/09/2018	CG C	CG/EZ (	OG TH	0 1 2 3 4 5 6 7 8 9 1	Me	, v n u	TU	ASSYRIAN SCHOOLS LTD.	
R. Js	D AMENDED FROM CLIENT COMMENTS	20/09/2018	CG C	CG/EZ (	OG TH	A1 (A3) 1:100 (1:200) METRES	MGA	A mAHD	TH	ASSITIAN SCHOOLS LID.	
USE	C MINOR AMENDMENT	11/09/2018	GM DG	G/CG/EZ (	OG TH	0 0.25 0.50 0.75 1.00 1.25 1.50 1.75 2.00 2.25 2.5	DISCL	.AIMER & COPYRIG	HT	PROJECT NAME/PLANSET TITLE	
<u>'</u>	B AMENDED DESIGN BASED ON ARCHITECTURE	05/09/2018	GM DG	G/CG/EZ (	OG TH	A1 (A3) 1:25 (1:50) METRES		nn must not be used for con al certifying authority.	nstruction unless signed as approved by	ST PETER & PAUL ASSYRIAN PRI. SCHOOI	ı   🌈
2.20%	A INITIAL RELEASE	5/09/2018	LZ/GM/CG (	CG/EZ I	OG TH	0 0.1 0.2 0.3 0.4 0.5 0.6 0.7 0.8 0.9 1.	1 ' '	surements in millimetres u			느 🍆
29.0						A1 (A3) 1:10 (1:20) METRES			ced in whole or part without prior written	CIVIL WORKS PLAN - STAGE 01	
Ë								t of Martens & Associates		17 &19 KOSOVICH PLACE, CECIL PARK, NSW	Suite
PRIN							(C) Cc	opyright Martens & As	ssociates Pty Ltd	LOTS 2302 & 2321, DP 1223167	
A1 /	/ A3 LANDSCAPE (A1LC v02.0.01)	I		I						1	


# STATE SIGNIFICANT DEVELOPMENT APPLICATION FORWARD STATE SIGNIFICANT STATE STATE SIGNIFICANT STATE ST

— Ø 150mm OUTLET

PIPE, IL 92.88



	DRAINAGE	DETAILS (S	HEET 1)	
PROJECT NO.	PLANSET NO.	RELEASE NO.	DRAWING NO.	REVISION
P1705798	PS04	R06	PS04-E200	Е
DRAWING ID: P1705798-PS04-R06-E2	00 00000	20 30 4	0 50 60 70	80 90

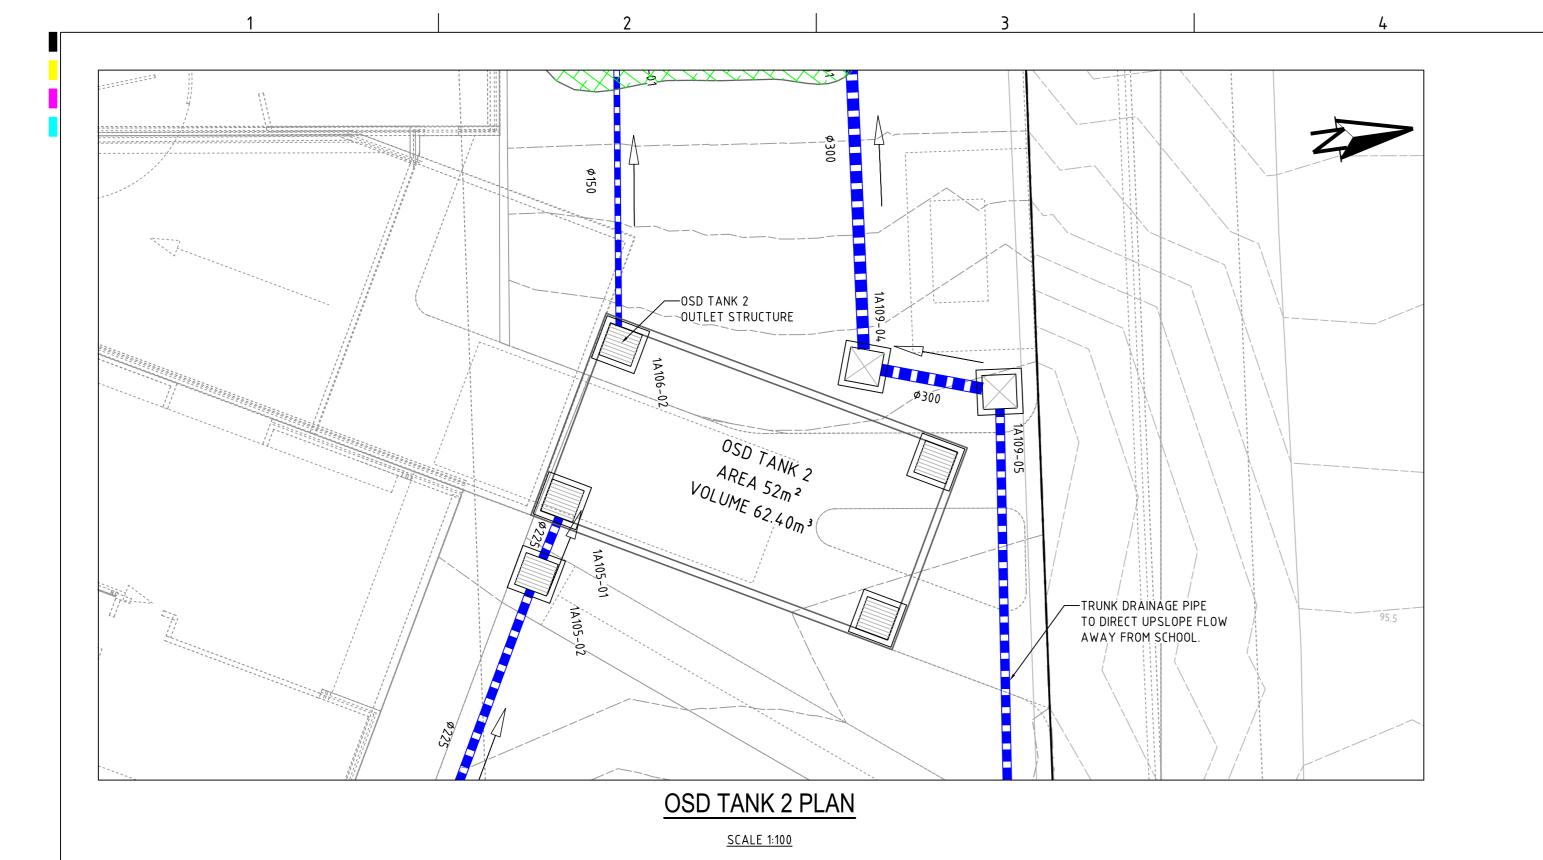

DRAWN DESIGNED CHECKED APPRVD SCALE

TH

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TH

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A1 (A3) 1:100 (1:200)

A1 (A3) 1:25 (1:50)

0 0.25 0.50 0.75 1.00 1.25 1.50 1.75 2.00 2.25 2.50

CG CG/EZ DG

CG CG/EZ DG

GM DG/CG/EZ DG

GM DG/CG/EZ DG

5/09/2018 LZ/GM/CG CG/EZ DG

20/09/2018

20/09/2018

11/09/2018

05/09/2018

/ 900mm GATIC LID AT RL 95.79 ▼ TWL 1% AEP @95.49 ✓ STEP IRON 1.7m WIDE WEIR AT RL 95.34 INLET PIPE -AT IL 94.78 → ORIFICE-1 Ø48mm ORIFICE CENTRE NON-RETURN -LINE @ CL 94.31 FLAP VALVE — ø 150mm OUTLET PIPE, IL 94.29 2ר90mm RELIEF DRAIN — WITH GRAVEL SURROUNDED WRAPPED IN GEOTEXTILE FABRIC

OSD TANK 2 OUTLET STRUCTURE

SCALE: 1:25

NOTES:

- BIO-RETENTION SYSTEM DETAILS TO BE PROVIDED AT CC STAGE AND SHALL BE DESIGNED AS PER FAWB (2009) GUIDELINES.

### STATE SIGNIFICANT DEVELOPMENT APPLICATION

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DRAINAGE DETAILS (SHEET 2) PROJECT NO. PLANSET NO. RELEASE NO. DRAWING NO. REVISION PS04-E201

A1 / A3 LANDSCAPE (A1LC\_v02.0.01)

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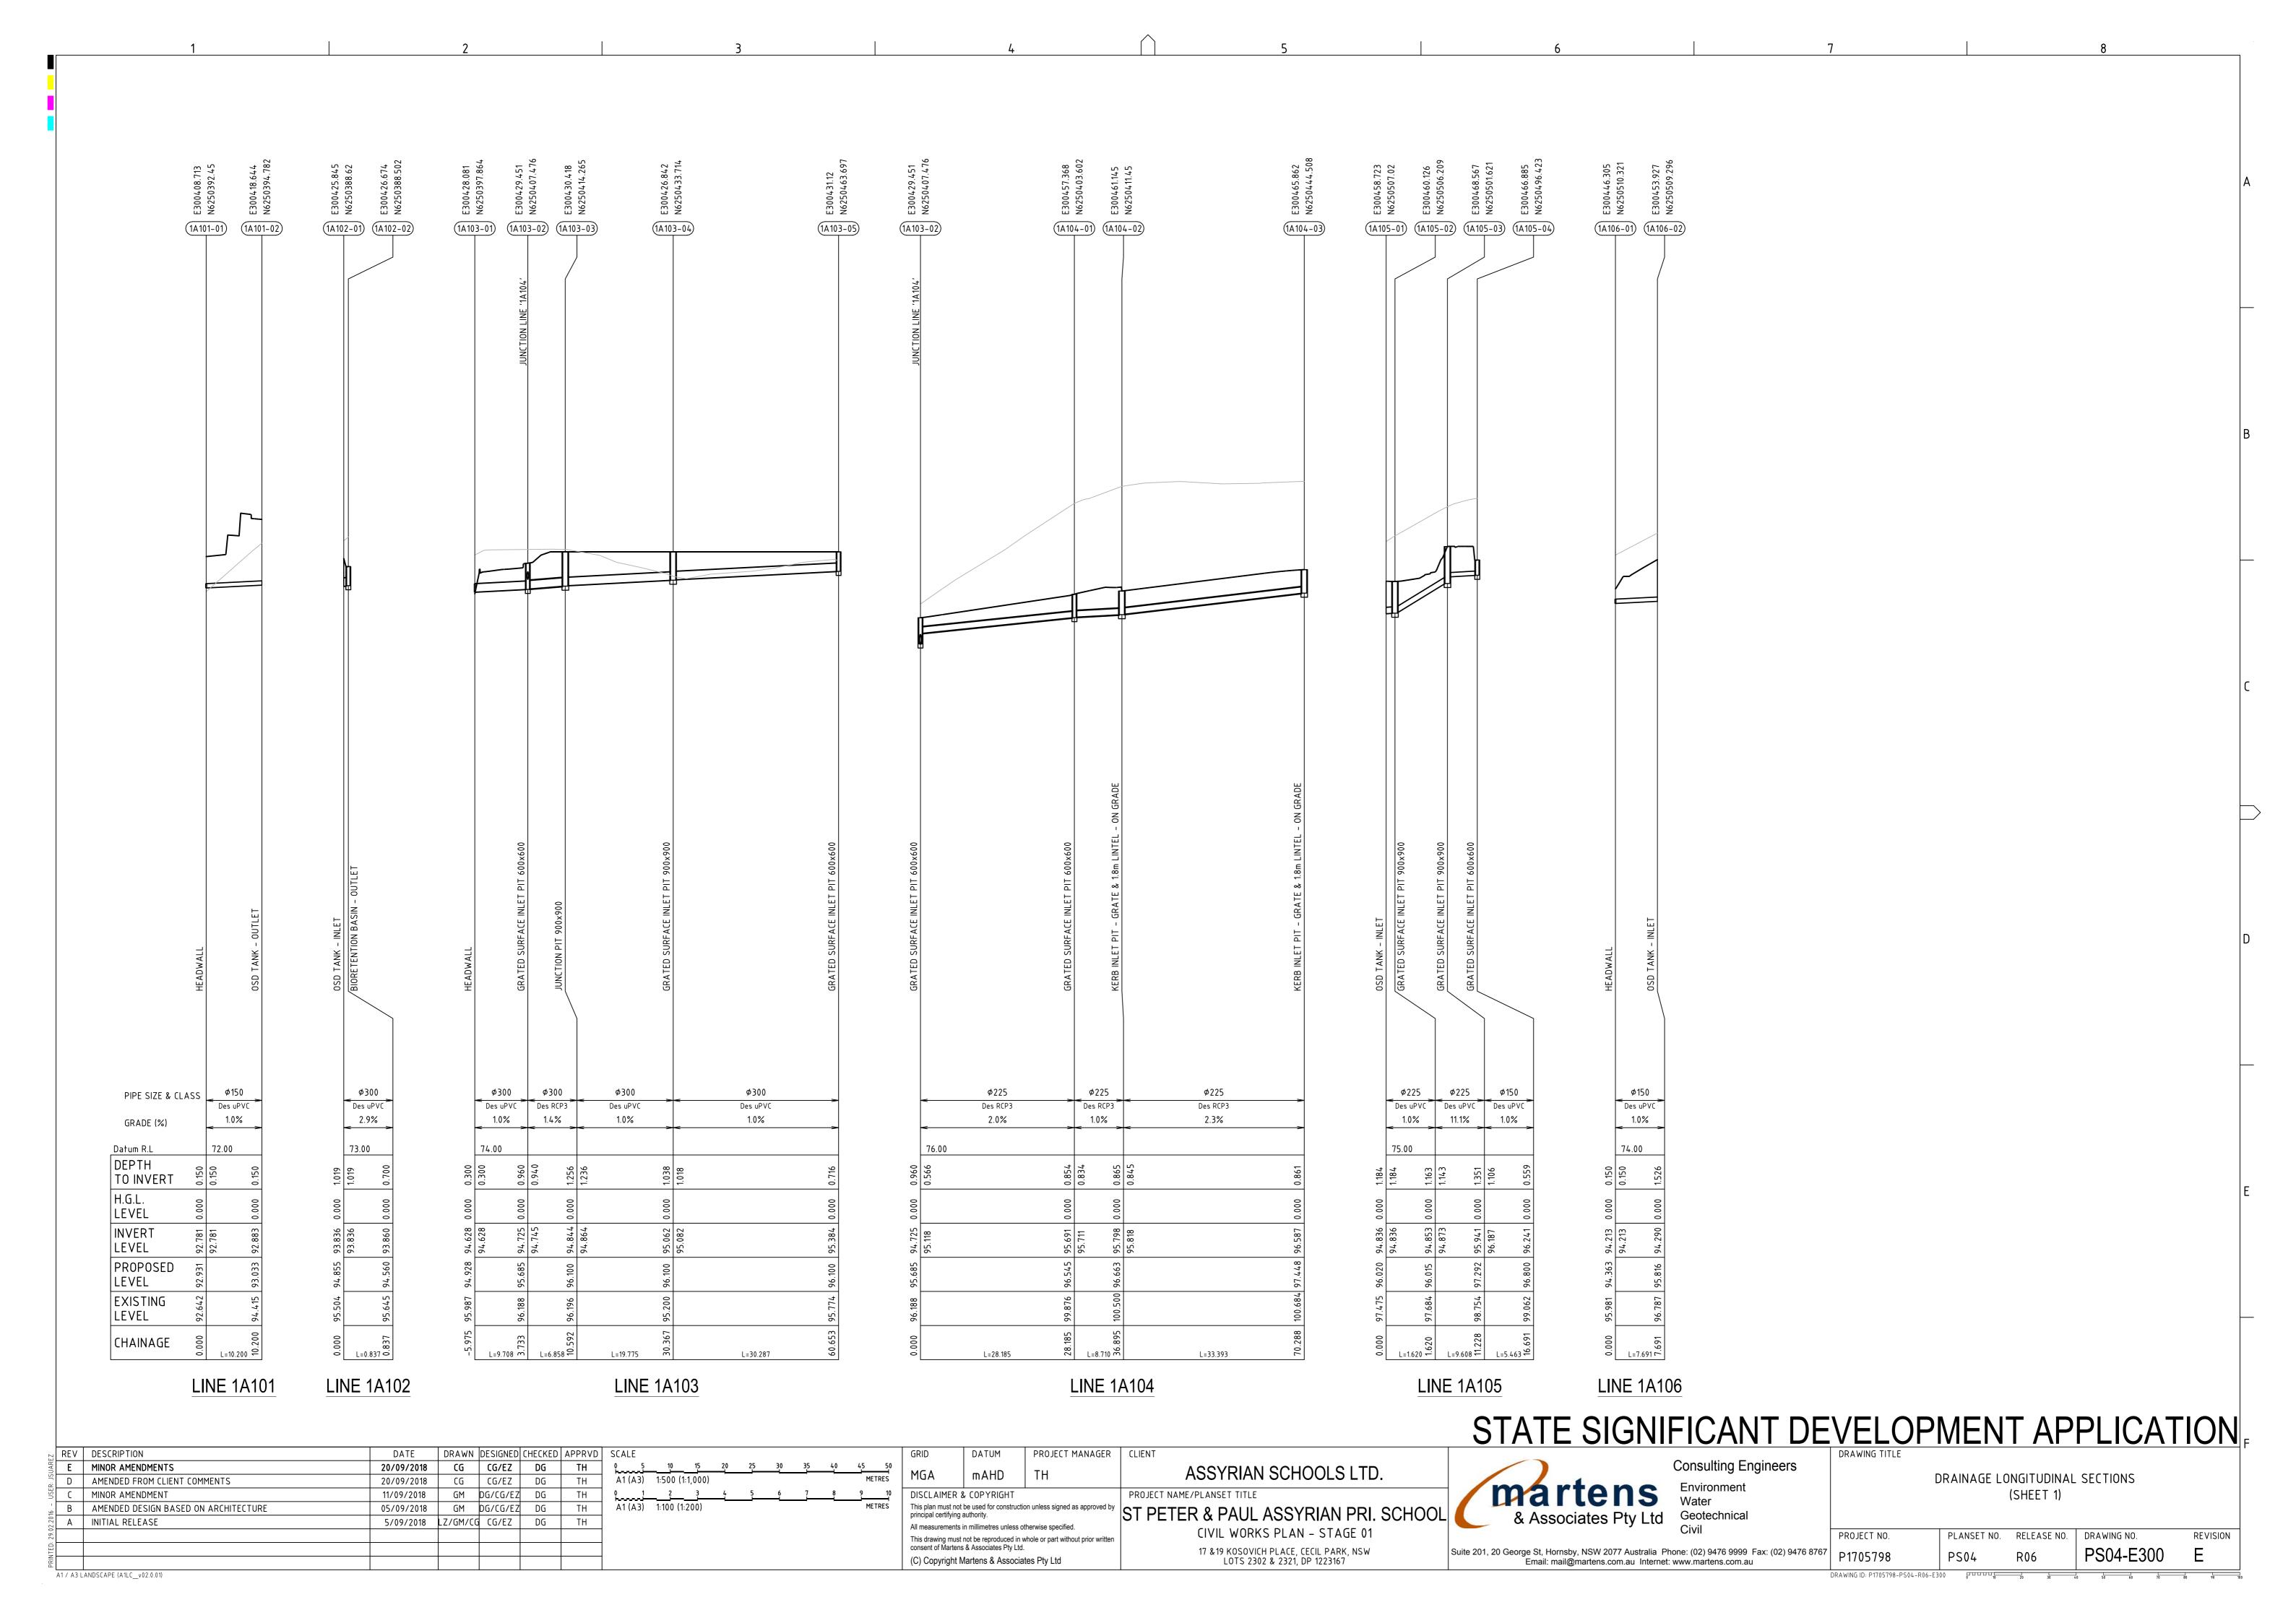
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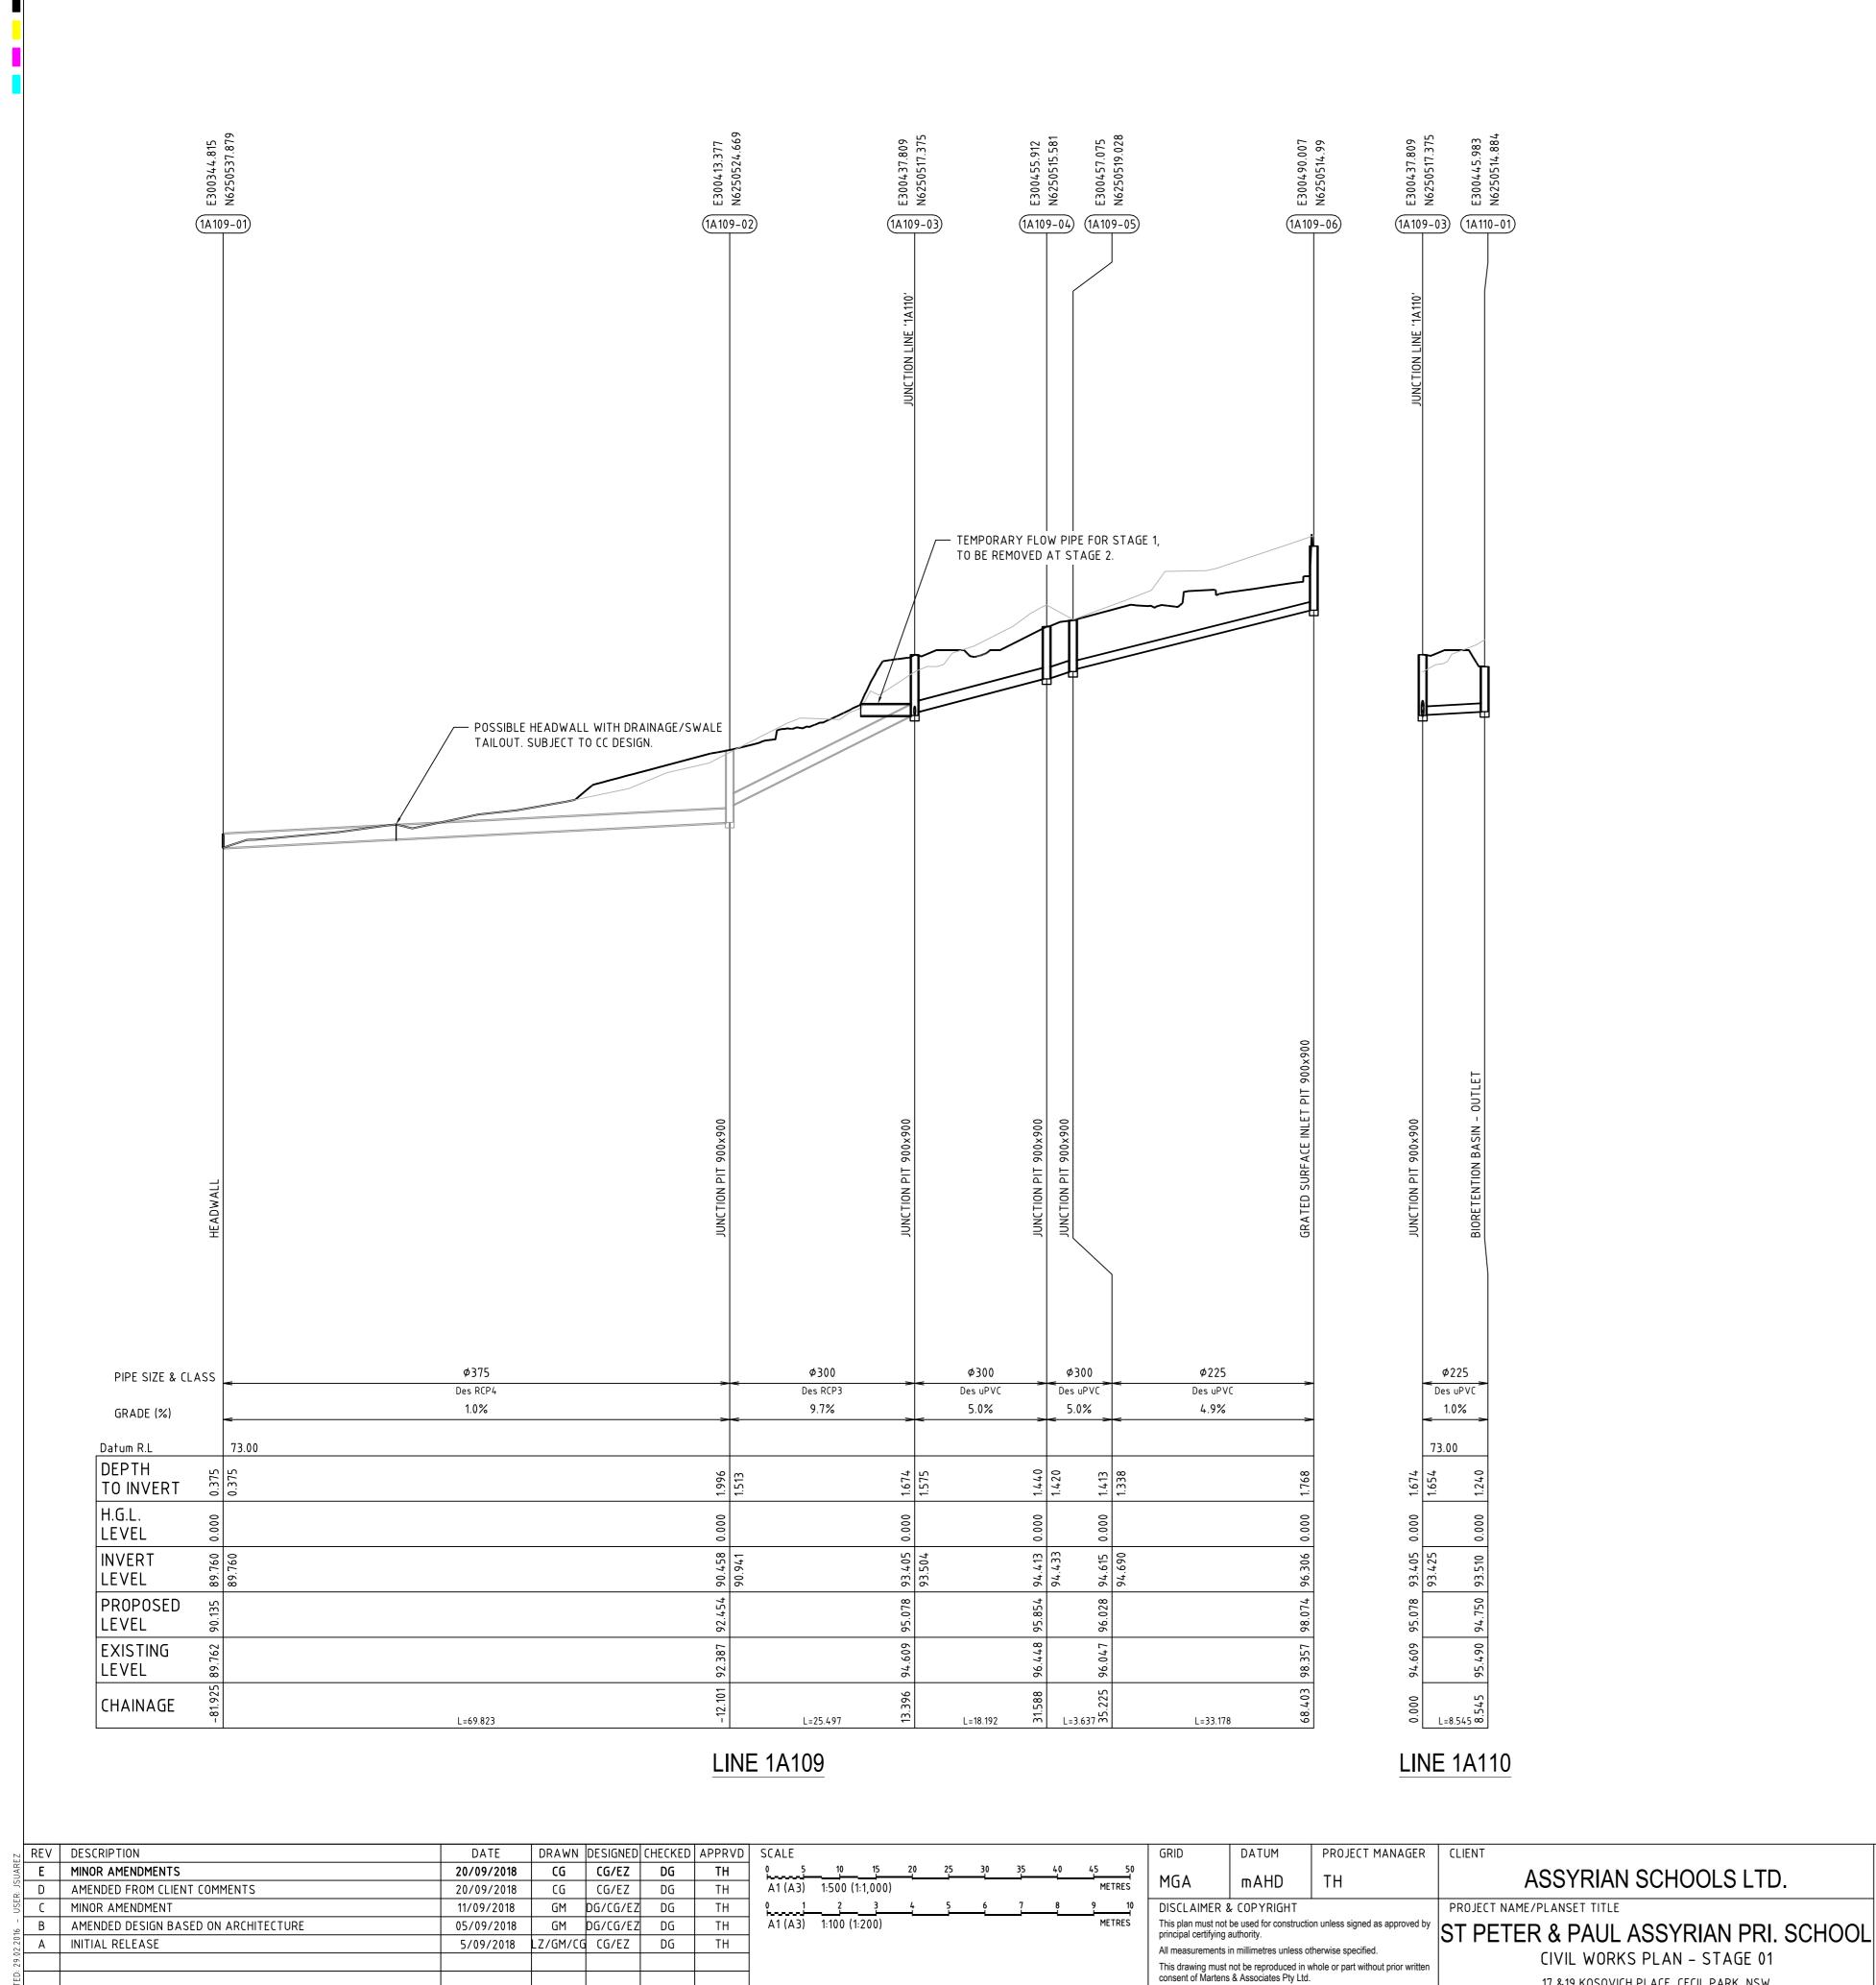
E MINOR AMENDMENTS

MINOR AMENDMENT

AMENDED FROM CLIENT COMMENTS

B AMENDED DESIGN BASED ON ARCHITECTURE





A1 / A3 LANDSCAPE (A1LC\_v02.0.01)

STATE SIGNIFICANT DEVELOPMENT APPLICATION

Associates Pty Ltd Con Wa

17 &19 KOSOVICH PLACE, CECIL PARK, NSW LOTS 2302 & 2321, DP 1223167

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Consulting Engineers

Environment
Water
Geotechnical
Civil

(SHEET 2)

PROJECT NO. PLANSET NO. RELEASE NO. DRAWING NO.
P1705798 PS04 R06 PS04-E301

DRAINAGE LONGITUDINAL SECTIONS

DRAWING ID: P1705798-PS04-R06-E301

REVISION

Suite 201, 20 George St, Hornsby, NSW 2077 Australia Phone: (02) 9476 9999 Fax: (02) 9476 8767
Email: mail@martens.com.au Internet: www.martens.com.au

			PIT	SCHED	ULE							
Pit				INTERNAL		INLET		OUTLET		PIT		
Name	TYPE	EASTING	NORTHING	WD	LEN	DIA	INV LEV	DIA	INV LEV	SETOUT RL	DEPTH	REMARKS
1A101-02	OSD TANK - OUTLET	300418.644	6250394.782	0	0	-	-	150	92.883	93.033	0.15	
1A101-01	HEADWALL	300408.713	6250392.45	0	0	150	92.781	-	-	92.931	0.15	setout level to maximum pipe obvert
1A102-02	BIORETENTION BASIN - OUTLET	300426.674	6250388.502	0.6	0.6	-	-	300	93.86	94.56	0.7	
1A102-01	OSD TANK - INLET	300425.845	6250388.62	0	0	300	93.836	-	-	94.855	1.019	
1A103-05	GRATED SURFACE INLET PIT 600x600	300431.12	6250463.697	0.6	0.6	-	-	300	95.384	96.1	0.716	
1A103-04	GRATED SURFACE INLET PIT 900x900	300426.842	6250433.714	0.9	0.9	300	95.082	300	95.062	96.1	1.038	
1A103-03	JUNCTION PIT 900x900	300430.418	6250414.265	0.9	0.9	300	94.864	300	94.844	96.1	1.256	
1A103-02	GRATED SURFACE INLET PIT 600x600	300429.451	6250407.476	0.6	0.6	300	94.745	300	94.725	95.685	0.96	
1A103-01	HEADWALL	300428.081	6250397.864	0	0	300	94.628	-	-	94.928	0.3	setout level to maximum pipe obvert
1A104-03	KERB INLET PIT - GRATE & 1.8m LINTEL - ON GRADE	300465.862	6250444.508	0.9	0.9		-	225	96.587	97.448	0.861	xy setout to setout string
1A104-02	KERB INLET PIT - GRATE & 1.8m LINTEL - ON GRADE	300461.145	6250411.45	0.9	0.9	225	95.818	225	95.798	96.663	0.865	xy setout to setout string
1A104-01	GRATED SURFACE INLET PIT 600x600	300457.368	6250403.602	0.6	0.6	225	95.711	225	95.691	96.545	0.854	
1A103-02	GRATED SURFACE INLET PIT 600x600	300429.451	6250407.476	0.6	0.6	225	95.118	-	-	95.685	0.96	
1A105-04	GRATED SURFACE INLET PIT 600x600	300466.885	6250496.423	0.6	0.6	-	-	150	96.241	96.391	0.15	setout level to maximum pipe obvert
1A105-03	GRATED SURFACE INLET PIT 900x900	300468.567	6250501.621	0.9	0.9	150	96.187	225	95.941	97.292	1.351	
1A105-02	GRATED SURFACE INLET PIT 900x900	300460.126	6250506.209	0.9	0.9	225	94.873	225	94.853	96.015	1.163	
1A105-01	OSD TANK - INLET	300458.723	6250507.02	0	0	225	94.836	-	-	96.02	1.184	
1A106-02	OSD TANK - OUTLET	300453.927	6250509.296	0	0	-	-	150	94.29	95.816	1.526	
1A106-01	HEADWALL	300446.305	6250510.321	0	0	150	94.213	-	-	94.363	0.15	setout level to maximum pipe obvert
1A109-05	JUNCTION PIT 900x900	300457.075	6250519.028	0.9	0.9	225	94.69	300	94.615	96.028	1.413	
1A109-04	JUNCTION PIT 900x900	300455.912	6250515.581	0.9	0.9	300	94.433	300	94.413	95.854	1.44	
1A109-03	JUNCTION PIT 900x900	300437.809	6250517.375	0.9	0.9	300	93.504	300	93.405	95.078	1.674	
1A109-02	JUNCTION PIT 900x900	300413.377	6250524.669	0.9	0.9	300	90.941	375	90.458	92.454	1.996	
1A109-01	HEADWALL	300344.815	6250537.879	0	0	375	89.76	-	-	90.135	0.375	setout level to maximum pipe obvert
1A110-01	BIORETENTION BASIN - OUTLET	300445.983	6250514.884	0.9	0.9	-	-	225	93.51	94.75	1.24	

PROJECT MANAGER | CLIENT

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CIVIL WORKS PLAN - STAGE 01

17 &19 KOSOVICH PLACE, CECIL PARK, NSW LOTS 2302 & 2321, DP 1223167

PROJECT NAME/PLANSET TITLE

1. XY SETOUT TO PIT CENTRE

DRAWN DESIGNED CHECKED APPRVD SCALE

CG CG/EZ DG

CG CG/EZ DG

GM DG/CG/EZ DG

05/09/2018 GM DG/CG/EZ DG

5/09/2018 LZ/GM/CG CG/EZ DG

20/09/2018


20/09/2018

11/09/2018

2. SETOUT LEVEL TO PIT COVER LEVEL

3. SOME SETOUT XY OR Z LEVELS HAVE SPECIAL SETOUT DATA. SEE INDIVIDUAL MANHOLE REMARKS

STATE SIGNIFICANT DEVELOPMENT APPLICATION

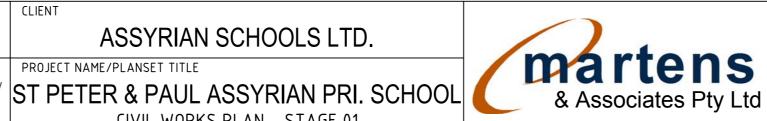

Consulting Engineers

	DRAINA	GE PIT SCHE	DULE	
)	DI ANCET NO	DELEV CE NU	DD V WING NO	

REVISION

PROJECT NO. PLANSET NO. RELEASE NO. Suite 201, 20 George St, Hornsby, NSW 2077 Australia Phone: (02) 9476 9999 Fax: (02) 9476 8767 Email: mail@martens.com.au Internet: www.martens.com.au P1705798 

A1 / A3 LANDSCAPE (A1LC\_v02.0.01)

A INITIAL RELEASE

REV DESCRIPTION

E MINOR AMENDMENTS

MINOR AMENDMENT

AMENDED FROM CLIENT COMMENTS


B AMENDED DESIGN BASED ON ARCHITECTURE

POST-DEVELOPMENT CATCHMENT PLAN

SCALE 1:500

DRAINS RE	SULTS		REQUIREMENT			
STORM EVENT	CRITICAL STORM	PEAK FLOW	PERMISSIBLE SITE DISCHARGE (L/S/HA)	SITE AREA TO OSD (HA)	PERMISSIBLE SITE DISCHARGE (L/S)	REFERENCE
(YEAR ARI)	DURATION (HRS)	RATES (L/S)				
5	1	62	78	0.808	63.02	FAIRFIELD CITY COUNCIL STORMWATER MANAGEMENT POLICY 2017
100	1	63	78	0.808	63.02	FAIRFIELD CITY COUNCIL STORMWATER MANAGEMENT POLICY 2017
NOTE: OSD PROVIDED	FOR DEVELOPED IMPE	ERVIOUS AREA ON	LY AND BASED ON TOTAL FUTURE AREA'S DR	AINING TO OSD.		

	POST DEVELOPMENT CATCHMENT (P1705798DRN02V03)									
Key	DRAINS CAT.	DESCRIPTION	AREA (HA)	% PAVED	Tc PAVED (min)	Tc GRASS (min)				
	1AD01	AREA TO OSD 1	0.657	95	5	12				
	1AD02	AREA TO OSD 2	0.151	70	5	9				
		SITE AREA	0.808	100	= % OF OVERALL AREA					
		TOTAL IMPERVIOUS AREA	0.730	90	= % OF OVERALL AREA					
		TOTAL PERVIOUS AREA	0.078	10	= % OF OVERALL AREA					

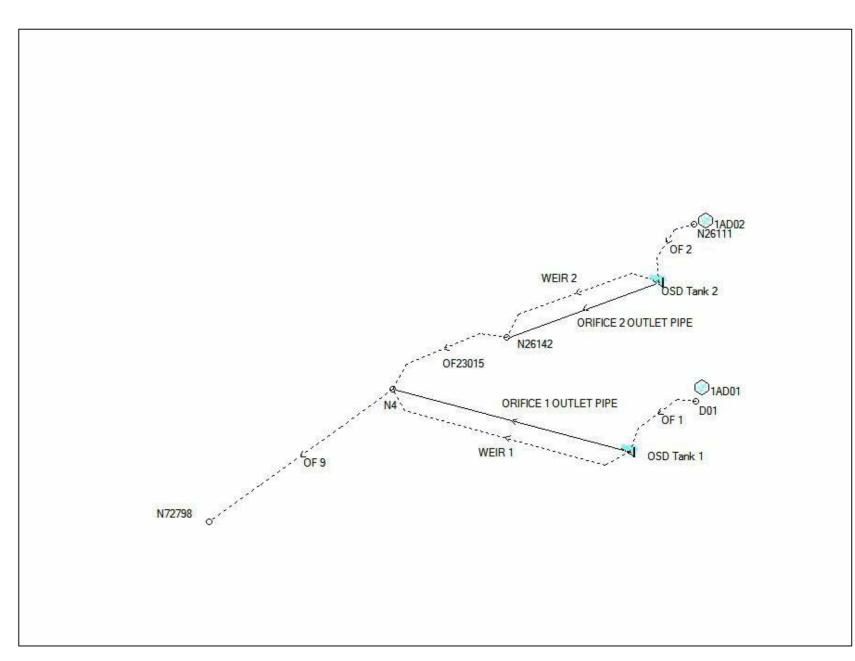

POST-DEVELOPMENT DRAINS MODEL LAYOUT

DRAWN DESIGNED CHECKED APPRVD SCALE PROJECT MANAGER | CLIENT REV DESCRIPTION E MINOR AMENDMENTS CG CG/EZ DG TH 20/09/2018 ASSYRIAN SCHOOLS LTD. mAHD A1 (A3) 1:500 (1:1,000) AMENDED FROM CLIENT COMMENTS CG CG/EZ DG TH 20/09/2018 GM DG/CG/EZ DG PROJECT NAME/PLANSET TITLE MINOR AMENDMENT 11/09/2018 DISCLAIMER & COPYRIGHT This plan must not be used for construction unless signed as approved by principal certifying authority. B AMENDED DESIGN BASED ON ARCHITECTURE 05/09/2018 GM DG/CG/EZ DG ST PETER & PAUL ASSYRIAN PRI. SCHOOL A INITIAL RELEASE 5/09/2018 LZ/GM/CG CG/EZ DG All measurements in millimetres unless otherwise specified. CIVIL WORKS PLAN - STAGE 01 This drawing must not be reproduced in whole or part without prior written consent of Martens & Associates Pty Ltd. 17 &19 KOSOVICH PLACE, CECIL PARK, NSW LOTS 2302 & 2321, DP 1223167 (C) Copyright Martens & Associates Pty Ltd A1 / A3 LANDSCAPE (A1LC\_v02.0.01)

Consulting Engineers martens Suite 201, 20 George St, Hornsby, NSW 2077 Australia Phone: (02) 9476 9999 Fax: (02) 9476 8767 Email: mail@martens.com.au Internet: www.martens.com.au

STATE SIGNIFICANT DEVELOPMENT APPLICATION OSD CATCHMENT PLAN, MODEL AND RESULTS PROJECT NO. PLANSET NO. RELEASE NO. DRAWING NO. REVISION PS04-E600 


### PRE-DEVELOPMENT WATER QUALITY CATCHMENTS PLAN

SCALE 1:1000

	MUSIC CATCHMENTS (P1705798MUS01V02)									
	PRE DEVELOPMENT									
KEY	DESCRIPTION	MUSIC NODE ID	AREA (ha)	IMPERVIOUS %	MUSIC NODE REFERENCE					
	AGRICULTURAL	1B01	2.936	13	FAIRFIELD CITY COUNCIL STORMWATER MANAGEMENT POLICY 2017					
TOTAL SITE										
TOTAL - OVERALI	_			2.936	= 100 % OF OVERALL AREA					
TOTAL - IMPERVIO	DUS			0.381	= 13 % OF OVERALL AREA					
TOTAL - PERVIOU	S			2.555	= 87 % OF OVERALL AREA					
NOTES:	IOTES:									
1. AGRICULTURAL	NODE IS USED TO MODEL	THE PRE-DEVELOPM	ENT CONDITION	I IN ACCORDANCE W	ITH GSLLS NSW MUSIC MODELLING GUIDELINES 2015.					

MUSIC MODELLING RESULTS (P1705798MUS01V02)									
PARAMETER	PRE-DEVELOPMENT	POST-DEVELOPMENT	% CHANGE						
Total Suspended Solids (kg/yr)	948	818	-13.71%						
Total Phosphorus (kg/yr)	3.95	3.45	-12.66%						
Total Nitrogen (kg/yr)	21.1	20.7	-1.90%						

A1 / A3 LANDSCAPE (A1LC\_v02.0.01)

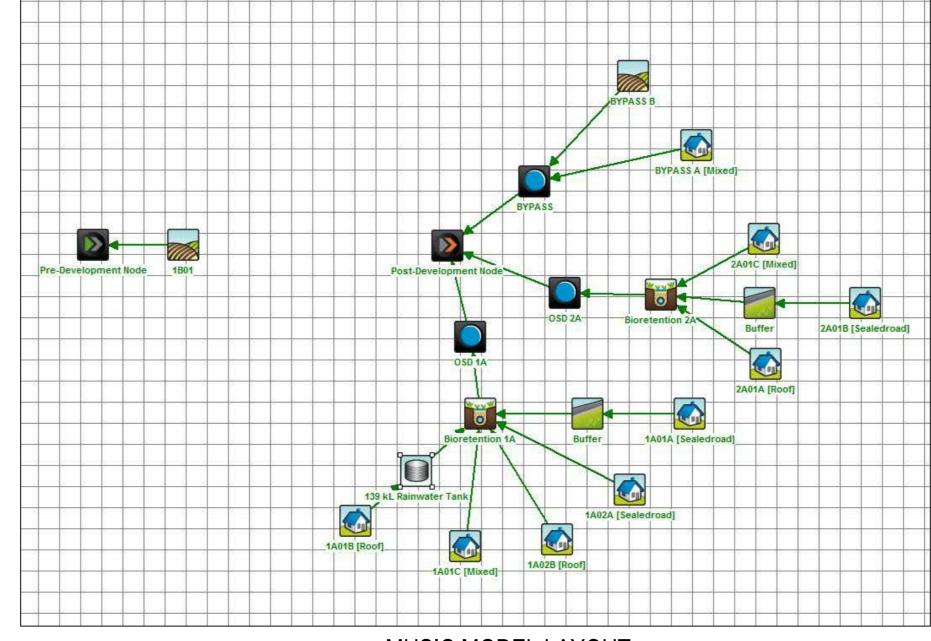

MUSIC MODEL LAYOUT

#### MUSIC CATCHMENTS (P1705798MUS01V02) POST DEVELOPMENT DESCRIPTION MUSIC NODE ID AREA (ha) IMPERVIOUS % MUSIC NODE REFERENCE FAIRFIELD CITY COUNCIL STORMWATER MANAGEMENT POLICY 2017 ROAD TO BIO 1A 0.114 FAIRFIELD CITY COUNCIL STORMWATER MANAGEMENT POLICY 2017 ROAD TO BIO 1A 1A02A 0.177 FAIRFIELD CITY COUNCIL STORMWATER MANAGEMENT POLICY 2017 ROOF TO RWT 1A01B 0.067 ROOF BYPASSING RWT FAIRFIELD CITY COUNCIL STORMWATER MANAGEMENT POLICY 2017 0.043 GROUND TO BIO 1A 1A 01C FAIRFIELD CITY COUNCIL STORMWATER MANAGEMENT POLICY 2017 0.268 ROOF TO BIO 2A 2A01A 0.053 100 FAIRFIELD CITY COUNCIL STORMWATER MANAGEMENT POLICY 2017 ROAD TO BIO 2A 2A01B FAIRFIELD CITY COUNCIL STORMWATER MANAGEMENT POLICY 2017 0.048 GROUND TO BIO 2A FAIRFIELD CITY COUNCIL STORMWATER MANAGEMENT POLICY 2017 2A01C 0.088 GROUND BYPASSING BYPASS A FAIRFIELD CITY COUNCIL STORMWATER MANAGEMENT POLICY 2017 GROUND BYPASSING BYPASS B 2.015 FAIRFIELD CITY COUNCIL STORMWATER MANAGEMENT POLICY 2017 TOTAL SITE TOTAL - OVERALL 2.938 = 100 % OF OVERALL AREA TOTAL - IMPERVIOUS = 30 % OF OVERALL AREA TOTAL - PERVIOUS 2.058 = 70 % OF OVERALL AREA 1. RAINWATER FROM 665M2 ROOF AREAS WILL BE DIRECTED TO A 139 KL RAINWATER TANK FOR REUSE. 2. NO WATER QUALITY TREATMENT OBJECTIVES REQUIRED BY FAIRFIELD CITY COUNCIL. PRE VS POST APPROACH FOR SITE.

POST-DEVELOPMENT WATER QUALITY CATCHMENTS PLAN

# STATE SIGNIFICANT DEVELOPMENT APPLICATION PRAWING TITLE

Consulting Engineers

REV	DESCRIPTION	DATE	DRAWN DESIGNED	CHECK	ED APPRVD	VD SCALE GRID DATUM PROJECT MANAGER CLIENT	
<sub>7</sub> E	MINOR AMENDMENTS	20/09/2018	CG CG/EZ	DG	TH	1 20 30 40 50 60 70 80 90 100 MGA MAHD TH ASSYRIAN SCHOOLS LTI	ח
D	AMENDED FROM CLIENT COMMENTS	20/09/2018	CG CG/EZ	DG	TH	A1 (A3) 1:1,000 (1:2,000) METRES MGA MAHD TH ASSYRIAN SCHOOLS LTI	J.
C C	MINOR AMENDMENT	11/09/2018	GM DG/CG/E	Z DG	TH		
B	AMENDED DESIGN BASED ON ARCHITECTURE	05/09/2018	GM DG/CG/E	Z DG	TH	This plan must not be used for construction unless signed as approved by principal certifying authority.  ST PETER & PAUL ASSYRIAN PRI	
' A	INITIAL RELEASE	5/09/2018	LZ/GM/CG CG/EZ	DG	TH		1. 301 100L
				+		All measurements in minimeters unless otherwise specified.  CIVIL WORKS PLAN - STAGE 0.1	1
<u>.</u>				+		I his drawing must not be reproduced in whole or part without prior written	•
=						consent of Martens & Associates Pty Ltd. 17 & 19 KOSOVICH PLACE, CECIL PARK, NSW	/
Ž						(C) Copyright Martens & Associates Pty Ltd LOTS 2302 & 2321, DP 1223167	

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