SAINTS PETER & PAUL ASSYRIAN PRIMARY SCHOOL PROJECT:

CIVIL WORKS MASTER PLAN PLANSET:

ASSYRIAN SCHOOLS LTD. CLIENT:



LOCALITY PLAN N.T.S.

# NSW DEPARTMENT OF PLANNING AND ENVIRONMENT SSDA 9210 LGA: FAIRFIELD CITY COUNCIL

17 & 19 KOSOVICH PLACE, CECIL PARK, NSW LOTS 2320 & 2321, DP 1223137

REV	DESCRIPTION	DATE	DRAWN	N DESIGNED	CHECKED	APPRVD	SCALE	GRID	DATUM	PROJECT MANAGER	CLIENT			
⊈ E	MINOR AMENDMENT	11/09/2018	GM	DG/CG/EZ	Z DG	TH				   <sub>TU</sub>	ASSYRIAN SCHOOLS LTD			
]S] D	AMENDED ARCHITECT LAYOUTS FROM EMAIL 31/08/2018	05/09/2018	GM	CG/DG/EZ	Z TH					10	AGGINIAN GCHOOLG LID			
<u> </u>	MINOR AMENDMENT	31/08/2018	GM	EZ/CG	CG/DG	TH		DISCLAIMER &			PROJECT NAME/PLANSET TITLE			
B	MINOR AMENDMENT	25/07/2018	GM	CG/EZ	DG	TH		This plan must not b	be used for construction	on unless signed as approved by	ST PETER & PAUL ASSYRIAN PRI. SCHO			
- Δ	INITIAL RELEASE	06/07/2018	GM	CG/EZ							DIFLILIX & FAUL ASSINIAN FINI. SCHO			
1 - ~	HATTINE NEELINGE	00/01/2010	911			+		All measurements in	n millimetres unless of	therwise specified.	CIVIL WORKS MASTER PLAN			
1							·	This drawing must r	not be reproduced in v	whole or part without prior written	CIVIL WURNS MASTER PLAN			
Ë								consent of Martens & Associates Pty Ltd.			17 & 19 KOSOVICH PLACE, CECIL PARK, NSW			
Z Z								(C) Copyright Martens & Associates Pty Ltd						LOTS 2320 & 2321, DP 1223167

STATE SIGNIFICANT DEVELOPMENT APPLICATION

DRAWING LIST

DWG NO REV. TITLE

PS03-A000 E COVER SHEET

PS03-A050 E ENGINEERING OVERVIEW PLAN CONSTRUCTION MANAGEMENT WORKS

PS03-C100 E EARTHWORKS GRADING PLAN

PS03-C500 E EARTHWORKS CUT-FILL PLAN

PS03-E200 D DRAINAGE DETAILS (SHEET 1) PS03-E201 D DRAINAGE DETAILS (SHEET 2)

PS03-E302 D DRAINAGE PIT SCHEDULE

PS03-G400 C CONCEPT PAVEMENT DESIGN

PS03-D100 E ROADWORKS PLAN

PS03-E100 E DRAINAGE PLAN

PS03-B300 E SEDIMENT & EROSION CONTROL PLAN

PS03-B310 E SEDIMENT & EROSION CONTROL DETAILS

PS03-C200 B EARTHWORKS SITE SECTIONS (SHEET 1) PS03-C201 B EARTHWORKS SITE SECTIONS (SHEET 2)

PS03-D200 E DRIVEWAY (21-MRL01) AND CARPARK AISLE (21-MRL02) LONGITUDINAL & TYPICAL SECTIONS

PS03-E300 D DRAINAGE LONGITUDINAL SECTIONS (SHEET 1) PS03-E301 D DRAINAGE LONGITUDINAL SECTIONS (SHEET 2)

PS03-E600 E OSD CATCHMENT PLAN, MODEL AND RESULTS

PS03-H200 A SITE PLAN - WASTEWATER MANAGEMENT

PS03-E700 E WATER QUALITY CATCHMENT PLAN, MODEL AND RESULTS

PS03-K100 SITE PLAN - 1 IN 20 YEAR ARI, 1 IN 100 YEAR ARI AND PMF FLOOD

PS03-D201 E CARPARK AISLE (21-MRL03) AND EMERGENCY VEHICLE ACCESS (21-MRL04) LONGITUDINAL & TYPICAL SECTIONS

GENERAL

EARTHWORKS

ROADWORKS

DRAINAGE WORKS


FINAL CIVIL WORKS


UTILITIES AND SERVICES




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rge St, Hornsby, NSW 2077 Australia Pho Email: mail@martens.com.au Internet: v	( )

		CC	VER SHEET		
7	PROJECT NO.	PLANSET NO.	RELEASE NO.	DRAWING NO.	REVISION
	P1705798  DRAWING ID: P1705798-PS03-R05-A0	PS03	R05	PS03-A000	B0 90

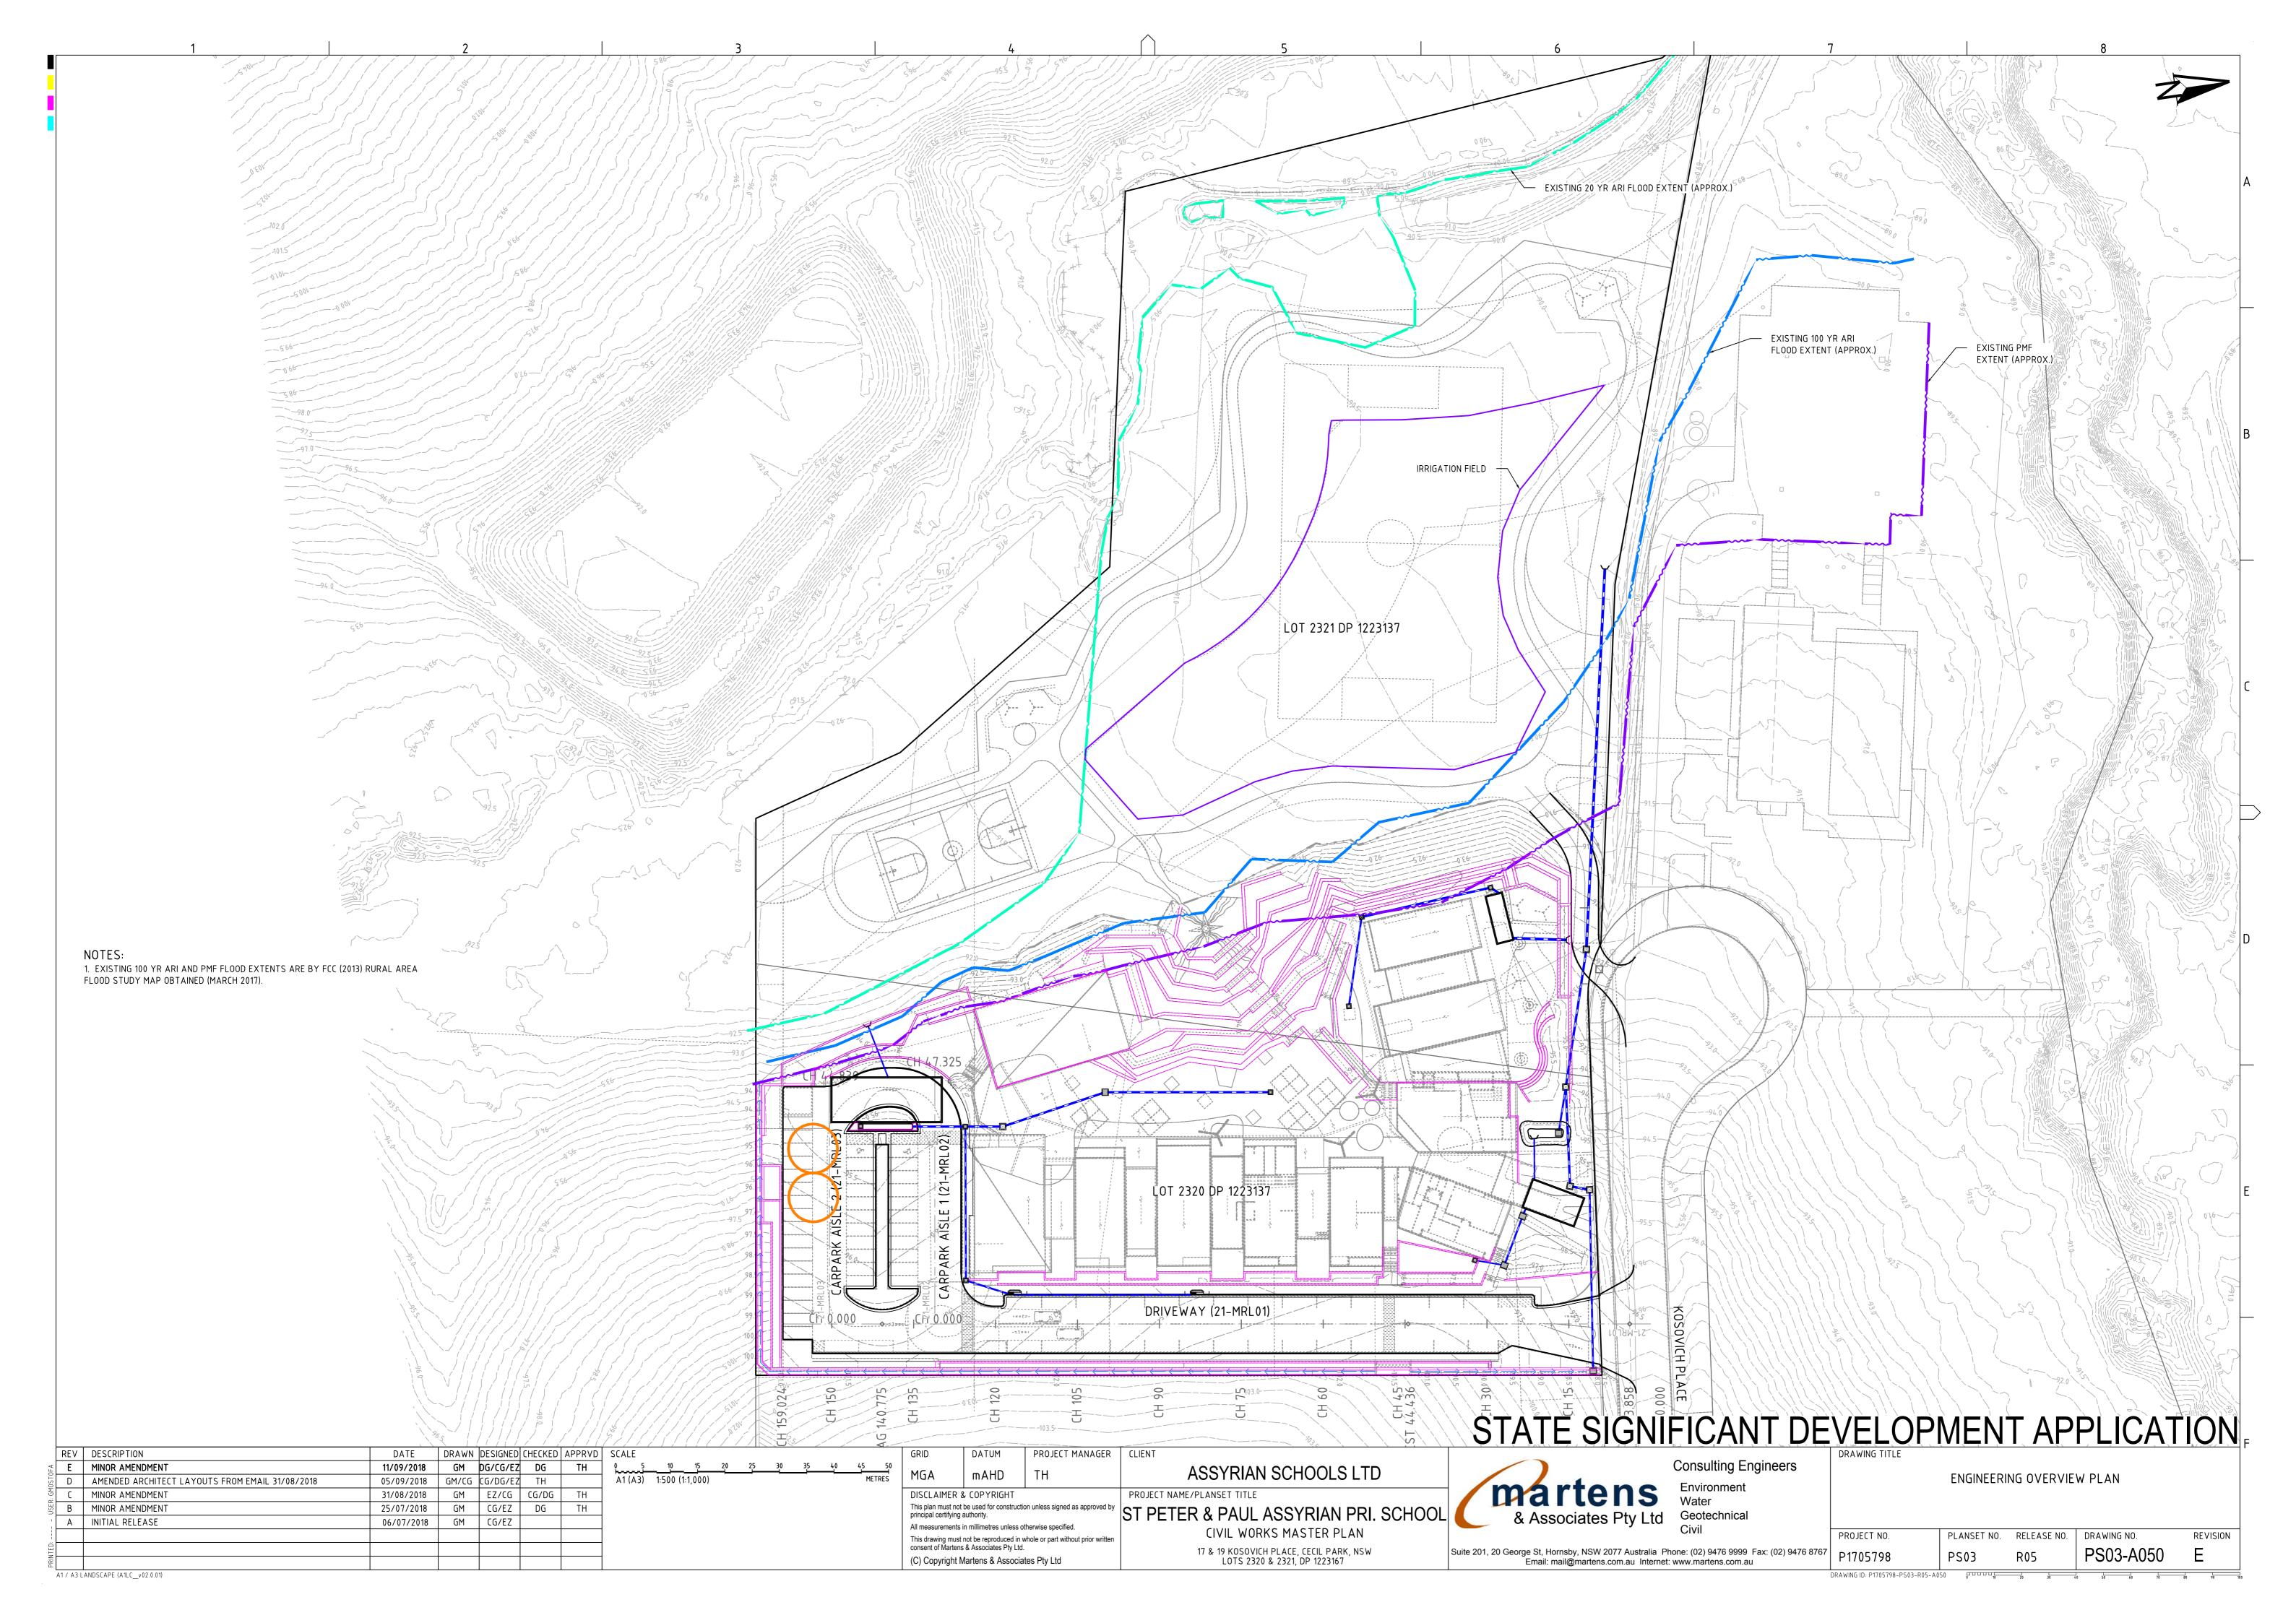

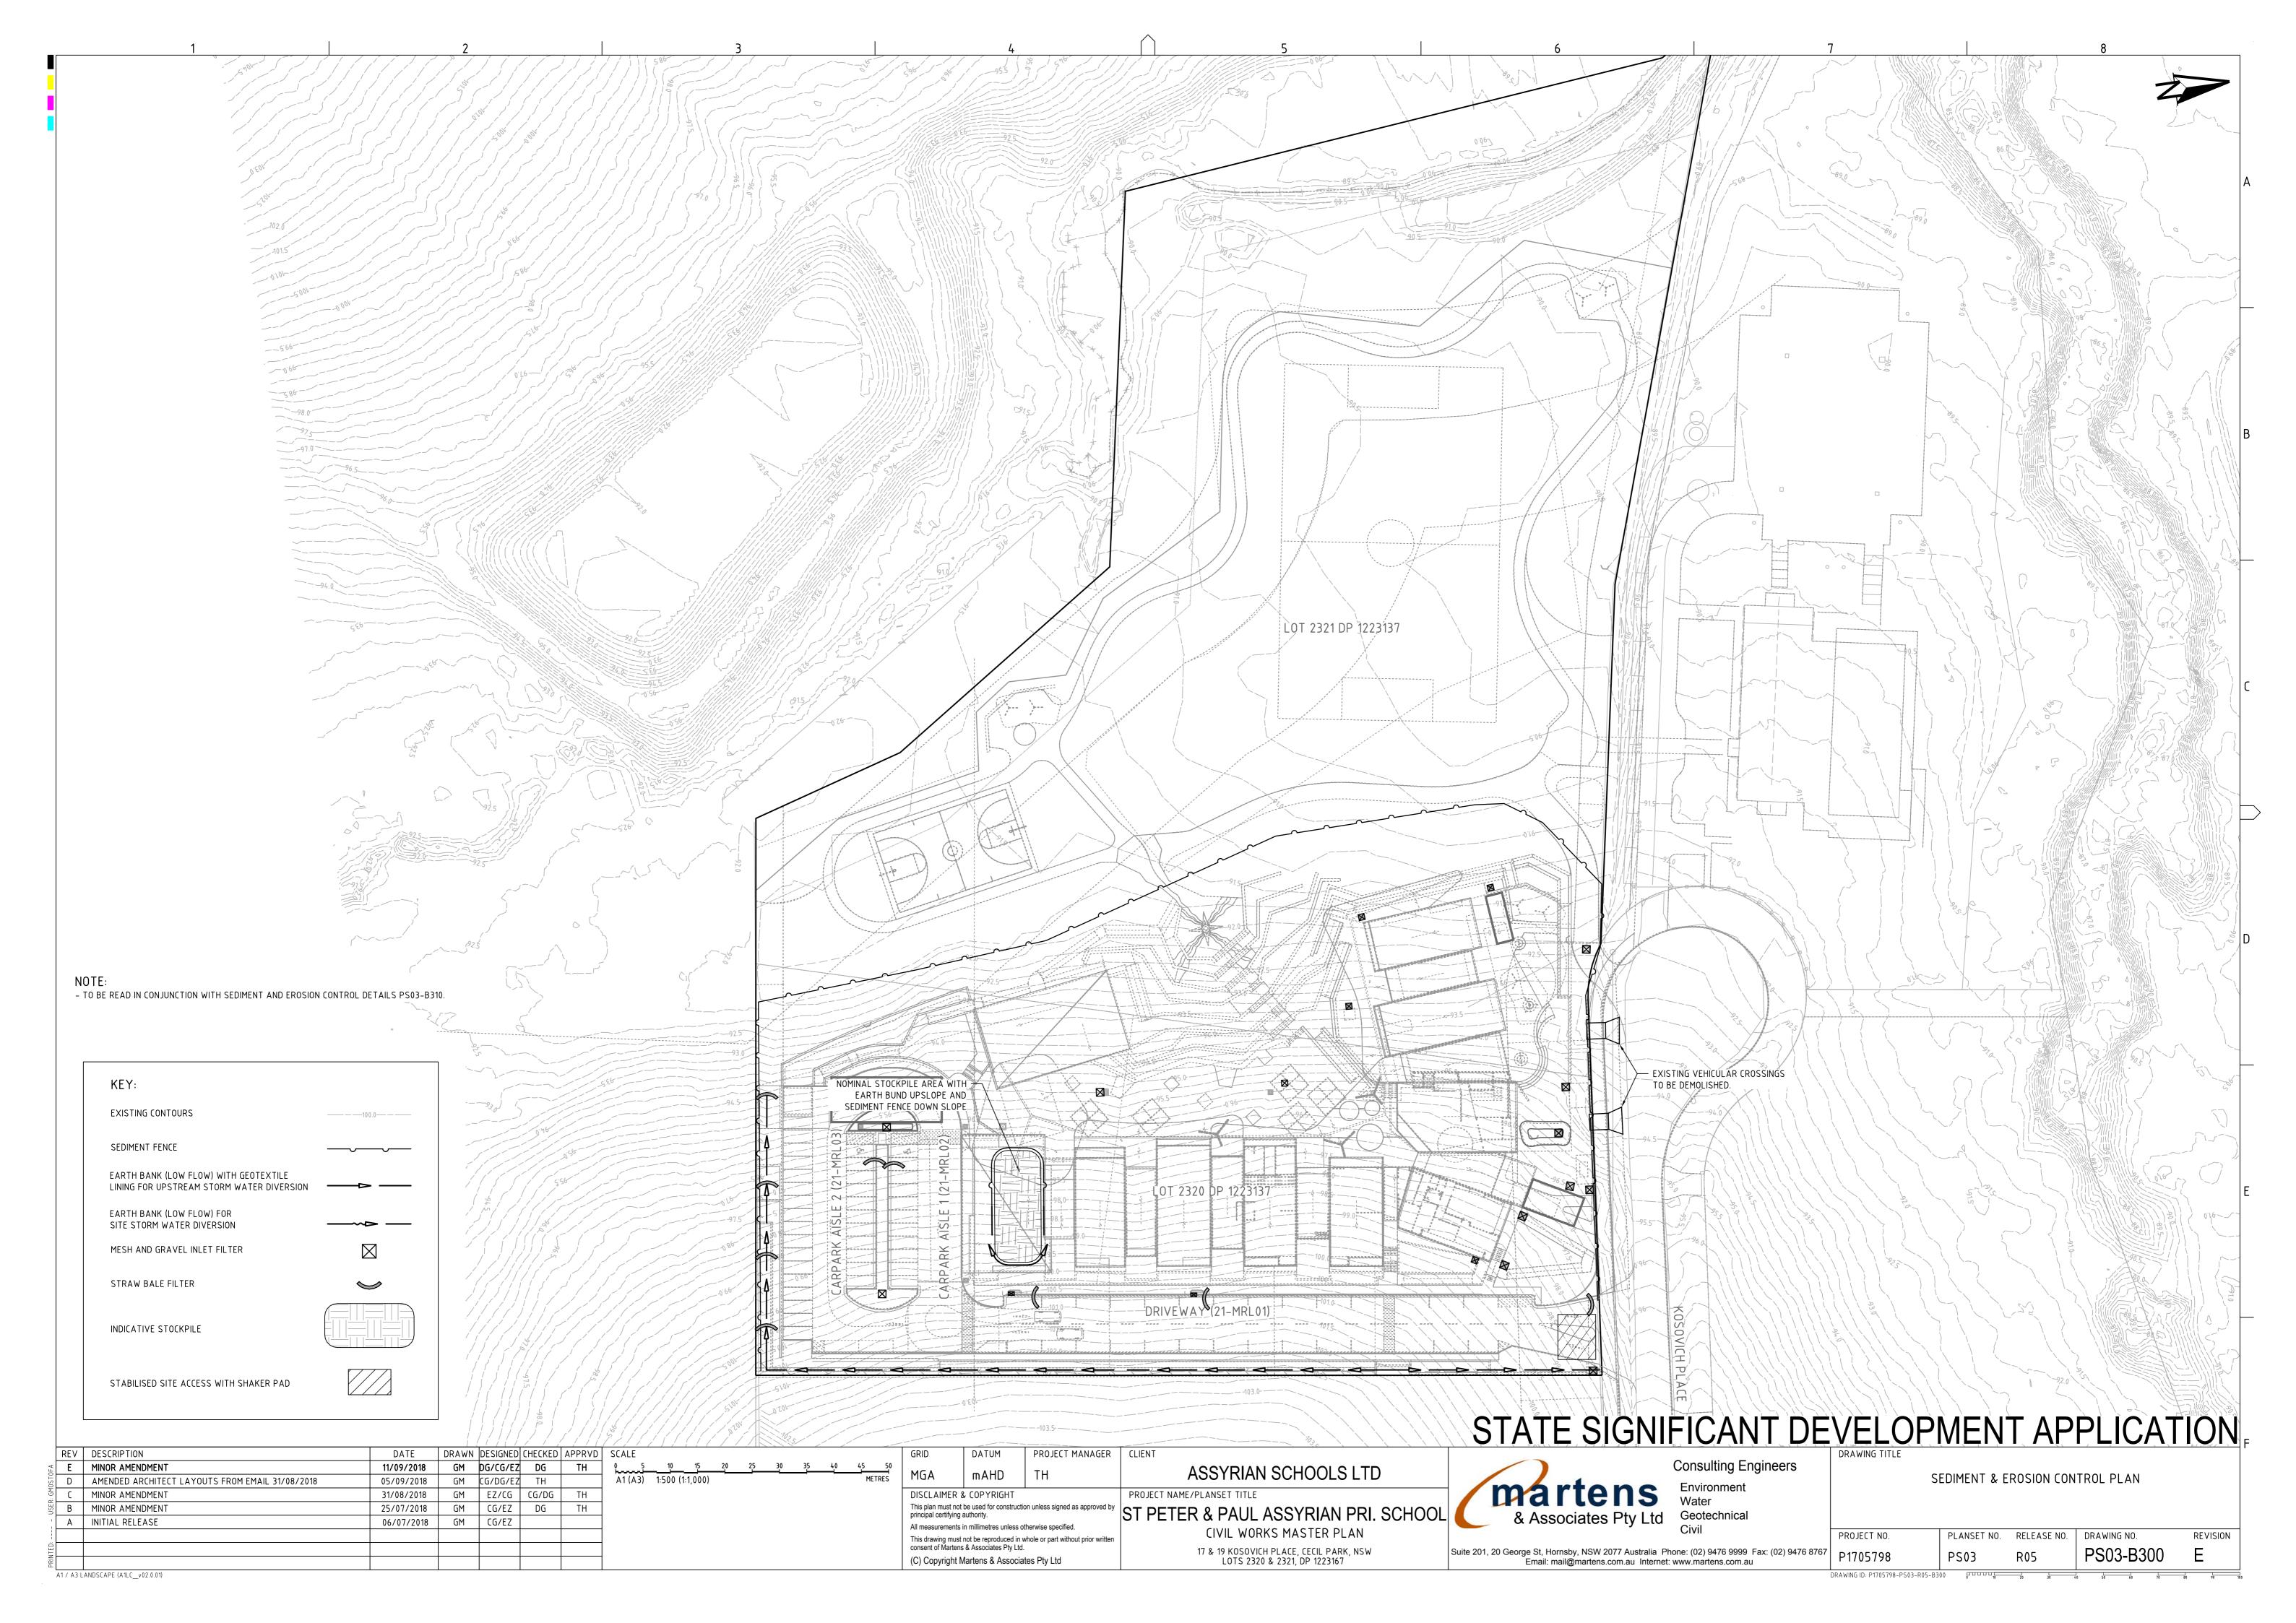

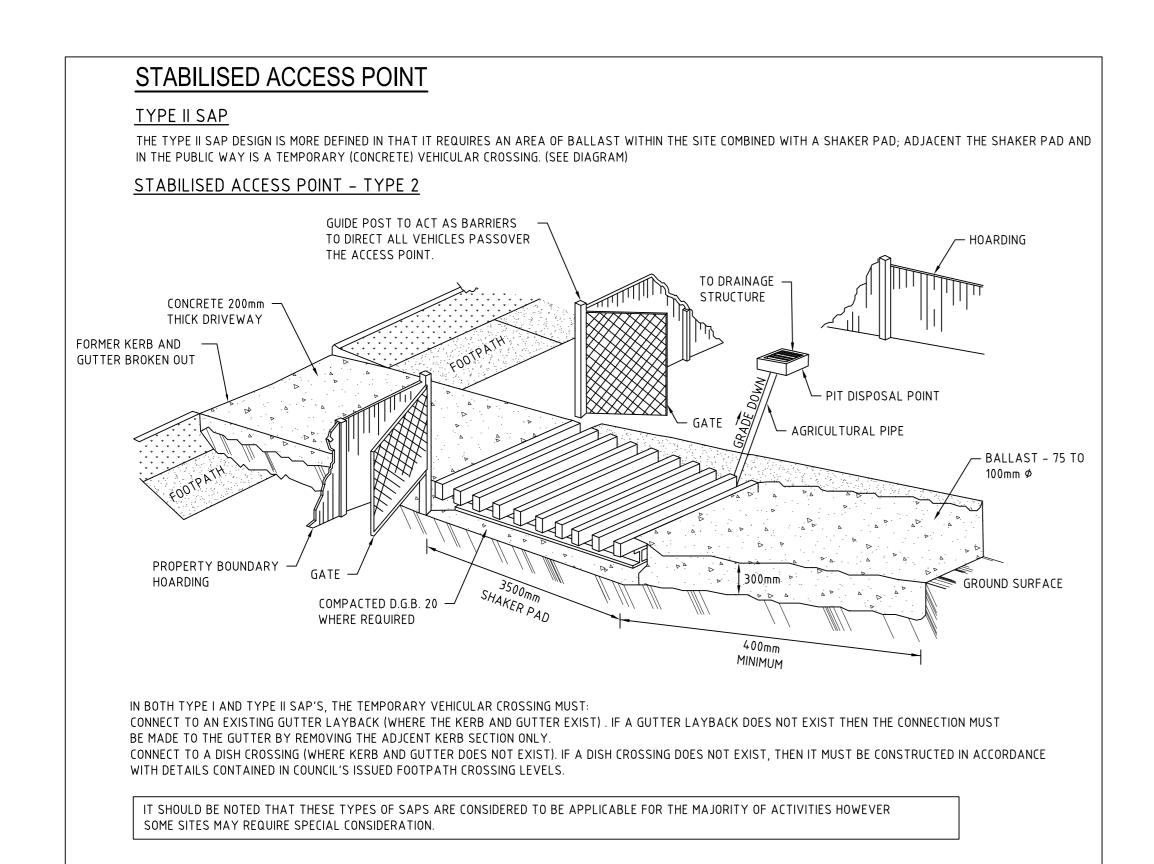

# SHAKER PAD (CATTLE GRID)


A CORRECTLY DESIGNED AND INSTALLED SHAKER PAD WILL ASSIST IN PREVENTING SEDIMENT TRANSFERE FROM A SITE. ANY STABILISED ACCESS POINT (SAP) CAN BE DESIGNED WITH A SHAKER PAD (COMPULSOPRY IN TYPE II SAP'S)


SHAKER PADS CAN BE DESIGNED AND CONSTRUCTED TO ENABLE RE-USE ON FUTURE PROJECTS.


#### THE SHAKER PAD:

- MUST BE DESIGNED AND CERTIFIED BY A PRACTICING STRUCTURAL ENGINEER. THE CERTIFIED DESIGN SHOULD BE SUBMITTED WITH THE RELEVENT
- CAN BE CONSTRUCTED FROM ANY SUITABLE MATERIAL.
- MUST BE LOCATED ON A SUITABLY PREPARED AND COMPACTED SUB-GRADE/BASE MATERIAL
- MUST BE SITUATED SUCH THAT THE RUNGS OF THE SHAKER PAD ARE LEVEL WITH THE ADJOINING NATURAL SURFACE.
- MUST BE A MINIMUM OF 3.5m IN LENGTH.
- MUST BE A MINIMUN OF 3.5m IN WIDTH.
- MUST HAVE CLEAR SPACING BETWEEN RUNGS OF 200 250mm.
- RUNGS MUST HAVE A MAXIMUM WIDTH (BEARING AREA) OF 75mm.
- MUST HAVE A MINIMUM CLEAR DEPTH OF 300mm IE FORM THE ROP OF THE RUNG TO THE FINISHED SUB-GRADE/BASE LEVEL.

THE SHAKER PAD MUST BE PROVIDED WITH SUITABLE BARRIERS AT THE SIDES TO ENSURE THAT ALL TYERS OF VEHICLES LEAVING THE SITE

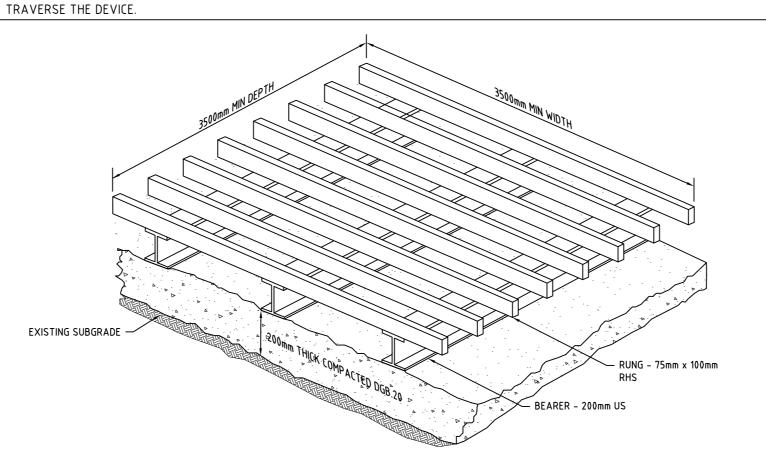

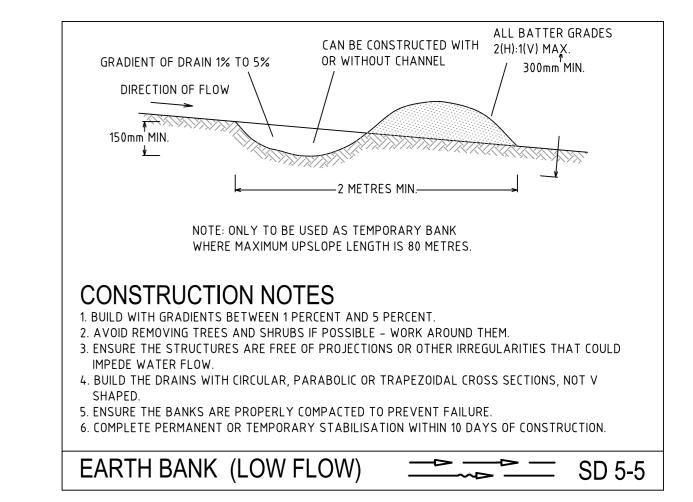

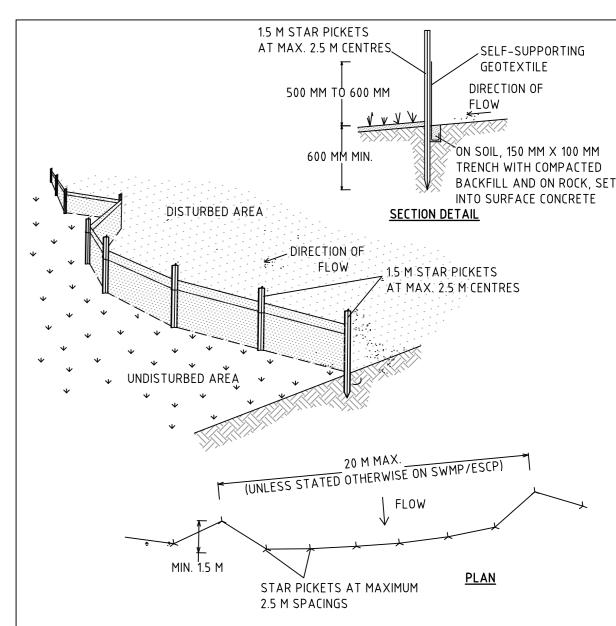

#### **CONSTRUCTION NOTES**

SEDIMENT FENCE

1. CONSTRUCT SEDIMENT FENCES AS CLOSE AS POSSIBLE TO BEING PARALLEL TO THE CONTOURS OF THE SITE, BUT WITH SMALL RETURNS AS SHOWN IN THE DRAWING TO LIMIT THE CATCHMENT AREA OF ANY ONE SECTION.THE CATCHMENT AREA SHOULD BE SMALL ENOUGH TO LIMIT WATER FLOW IF CONCENTRATED AT ONE POINT TO 50 LITRES PER SECOND IN THE DESIGN STORM EVENT, USUALLY THE

2. CUT A 150-MM DEEP TRENCH ALONG THE UPSLOPE LINE OF THE FENCE FOR THE BOTTOM OF THE


FABRIC TO BE ENTRENCHED. 3. DRIVE 1.5 METRE LONG STAR PICKETS INTO GROUND AT 2.5 METRE INTERVALS (MAX) AT THE

DOWNSLOP EDGE OF THE TRENCH. ENSURE ANY STAR PICKETS ARE FITTED WITH SAFETY CAPS. 4. FIX SELF-SUPPORTING GEOTEXTILE TO THE UPSLOPE SIDE OF THE POSTS ENSURING IT GOES TO THE BASE OF THE TRENCH. FIX THE GEOTEXTILE WITH WIRE TIES OR AS RECOMMENDED BY THE MANUFACTURER. ONLY USE GEOTEXTILE SPECIFICALLY PRODUCED FOR SEDIMENT FENCING. THE USE OF SHADE CLOTH FOR THIS PURPOSE IS NOT SATISFACTORY.

5. JOIN SECTIONS OF FABRIC AT A SUPPORT POST WITH A 150-MM OVERLAP.

6. BACKFILL THE TRENCH OVER THE BASE OF THE FABRIC AND COMPACT IT THOROUGHLY OVER THE GEOTEXTILE.

DRAWING ID: P1705798-PS03-R05-B310

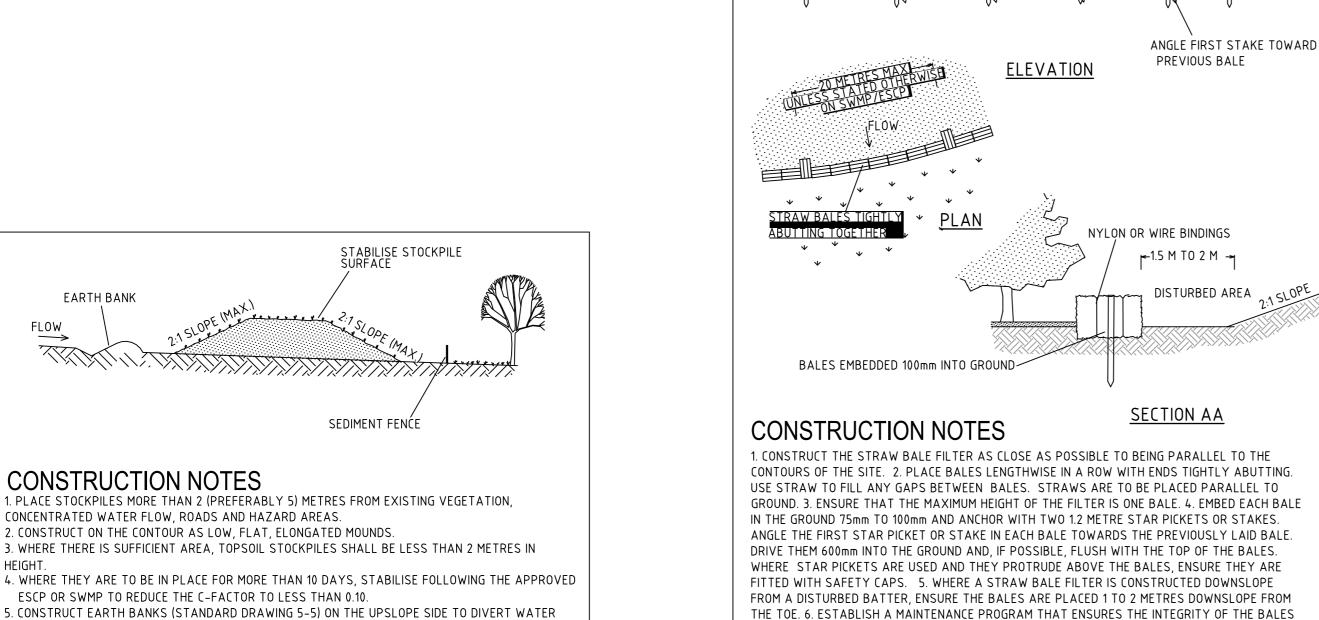


1.2 M STAR PICKET DRIVEN

IS RETAINED - THEY COULD REQUIRE REPLACEMENT EACH TWO TO FOUR MONTHS.

STRAW BALE FILTER

600mm INTO GROUND

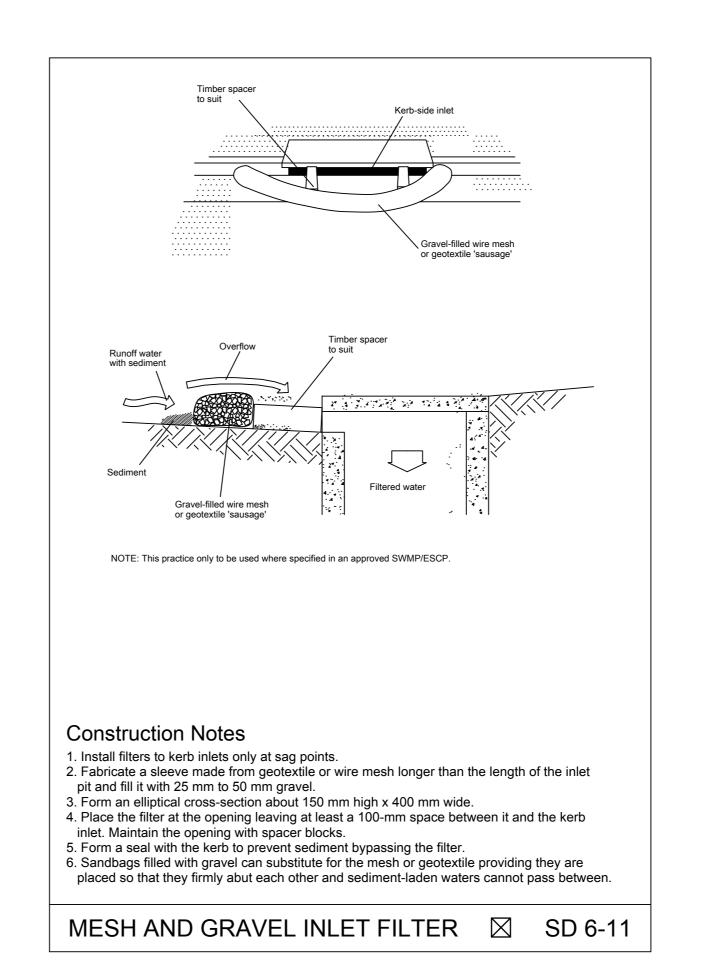

REV	DESCRIPTION	DATE	DRAWN	DESIGNED	CHECKED	APPRVD	SCAL
Ε	MINOR AMENDMENT	11/09/2018	GM	DG/CG/EZ	DG	TH	
D	AMENDED ARCHITECT LAYOUTS FROM EMAIL 31/08/2018	05/09/2018	GM	CG/DG/EZ	TH		
C	MINOR AMENDMENT	31/08/2018	GM	EZ/CG	CG/DG	TH	
В	MINOR AMENDMENT	25/07/2018	GM	CG/EZ	DG	TH	
Α	INITIAL RELEASE	06/07/2018	GM	CG/EZ			
			·				

AROUND STOCKPILES AND SEDIMENT FENCES (STANDARD DRAWING 6-8) 1 TO 2 METRES DOWNSLOPE.

SD 4-1

**CONSTRUCTION NOTES** 

**STOCKPILES** 

PROJECT MANAGER | CLIENT ASSYRIAN SCHOOLS LTD PROJECT NAME/PLANSET TITLE DISCLAIMER & COPYRIGHT This plan must not be used for construction unless signed as approved b principal certifying authority.

SD 6-7

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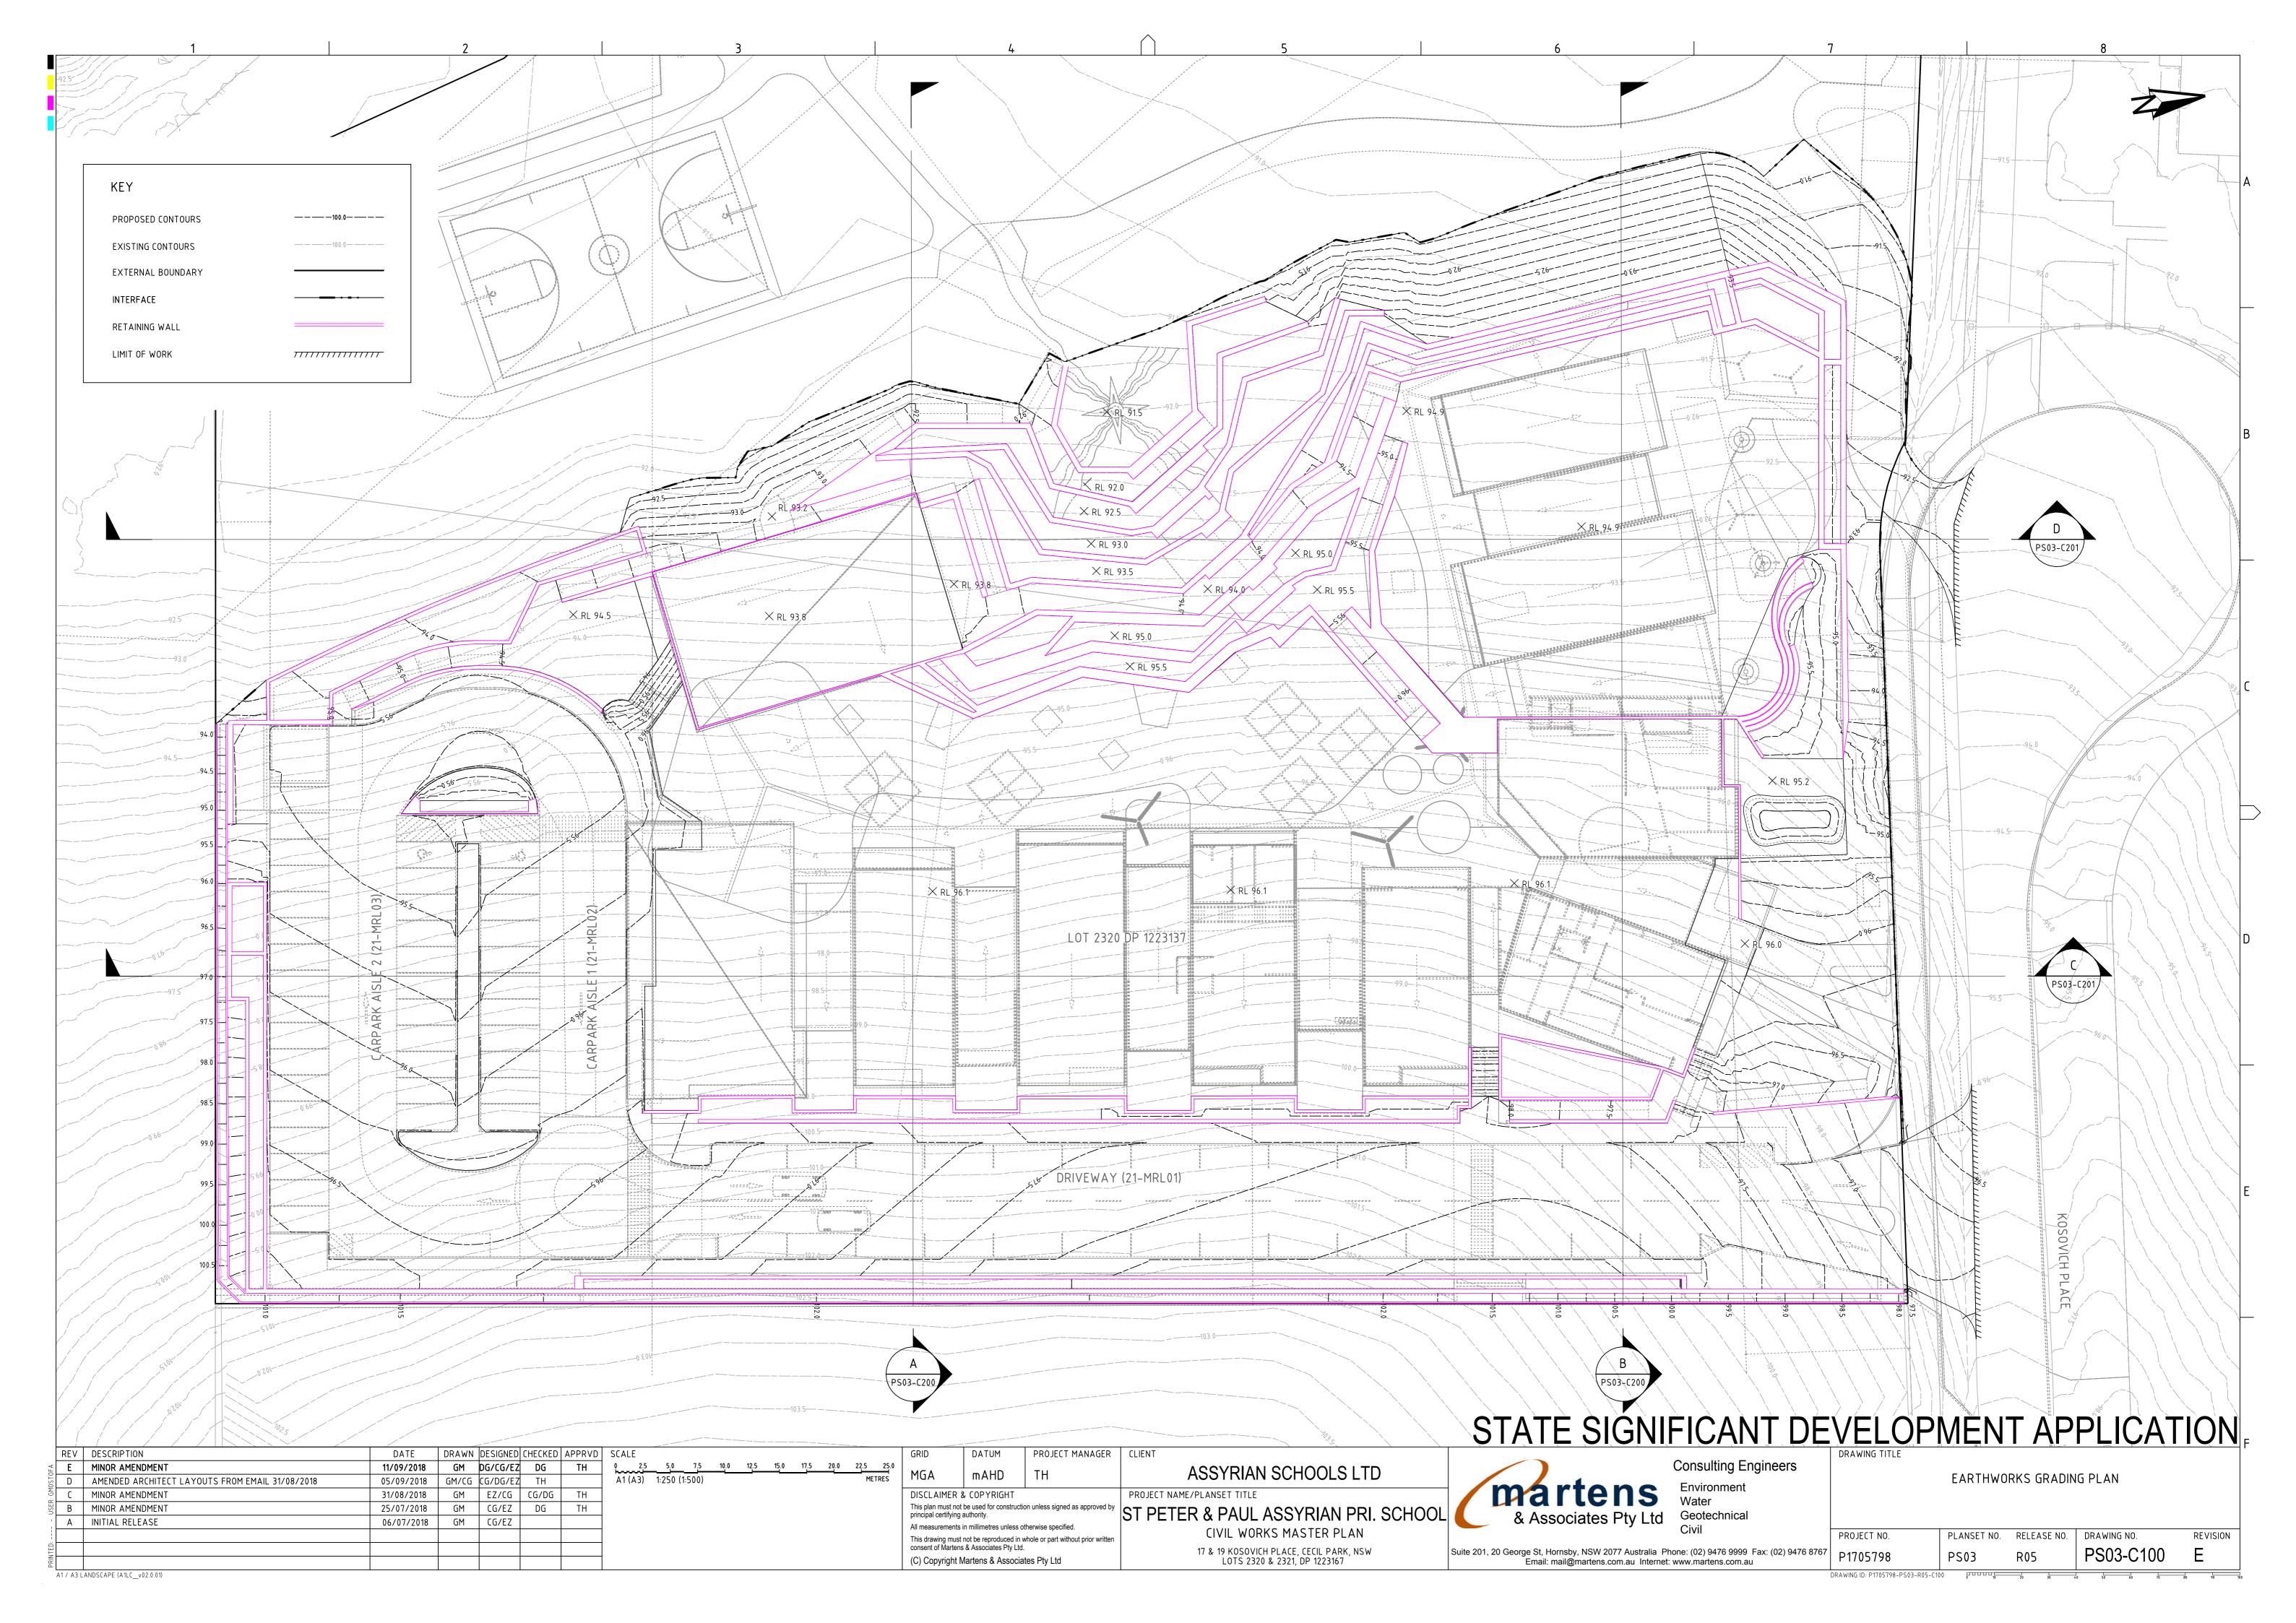
LOTS 2320 & 2321, DP 1223167


martens


Consulting Engineers

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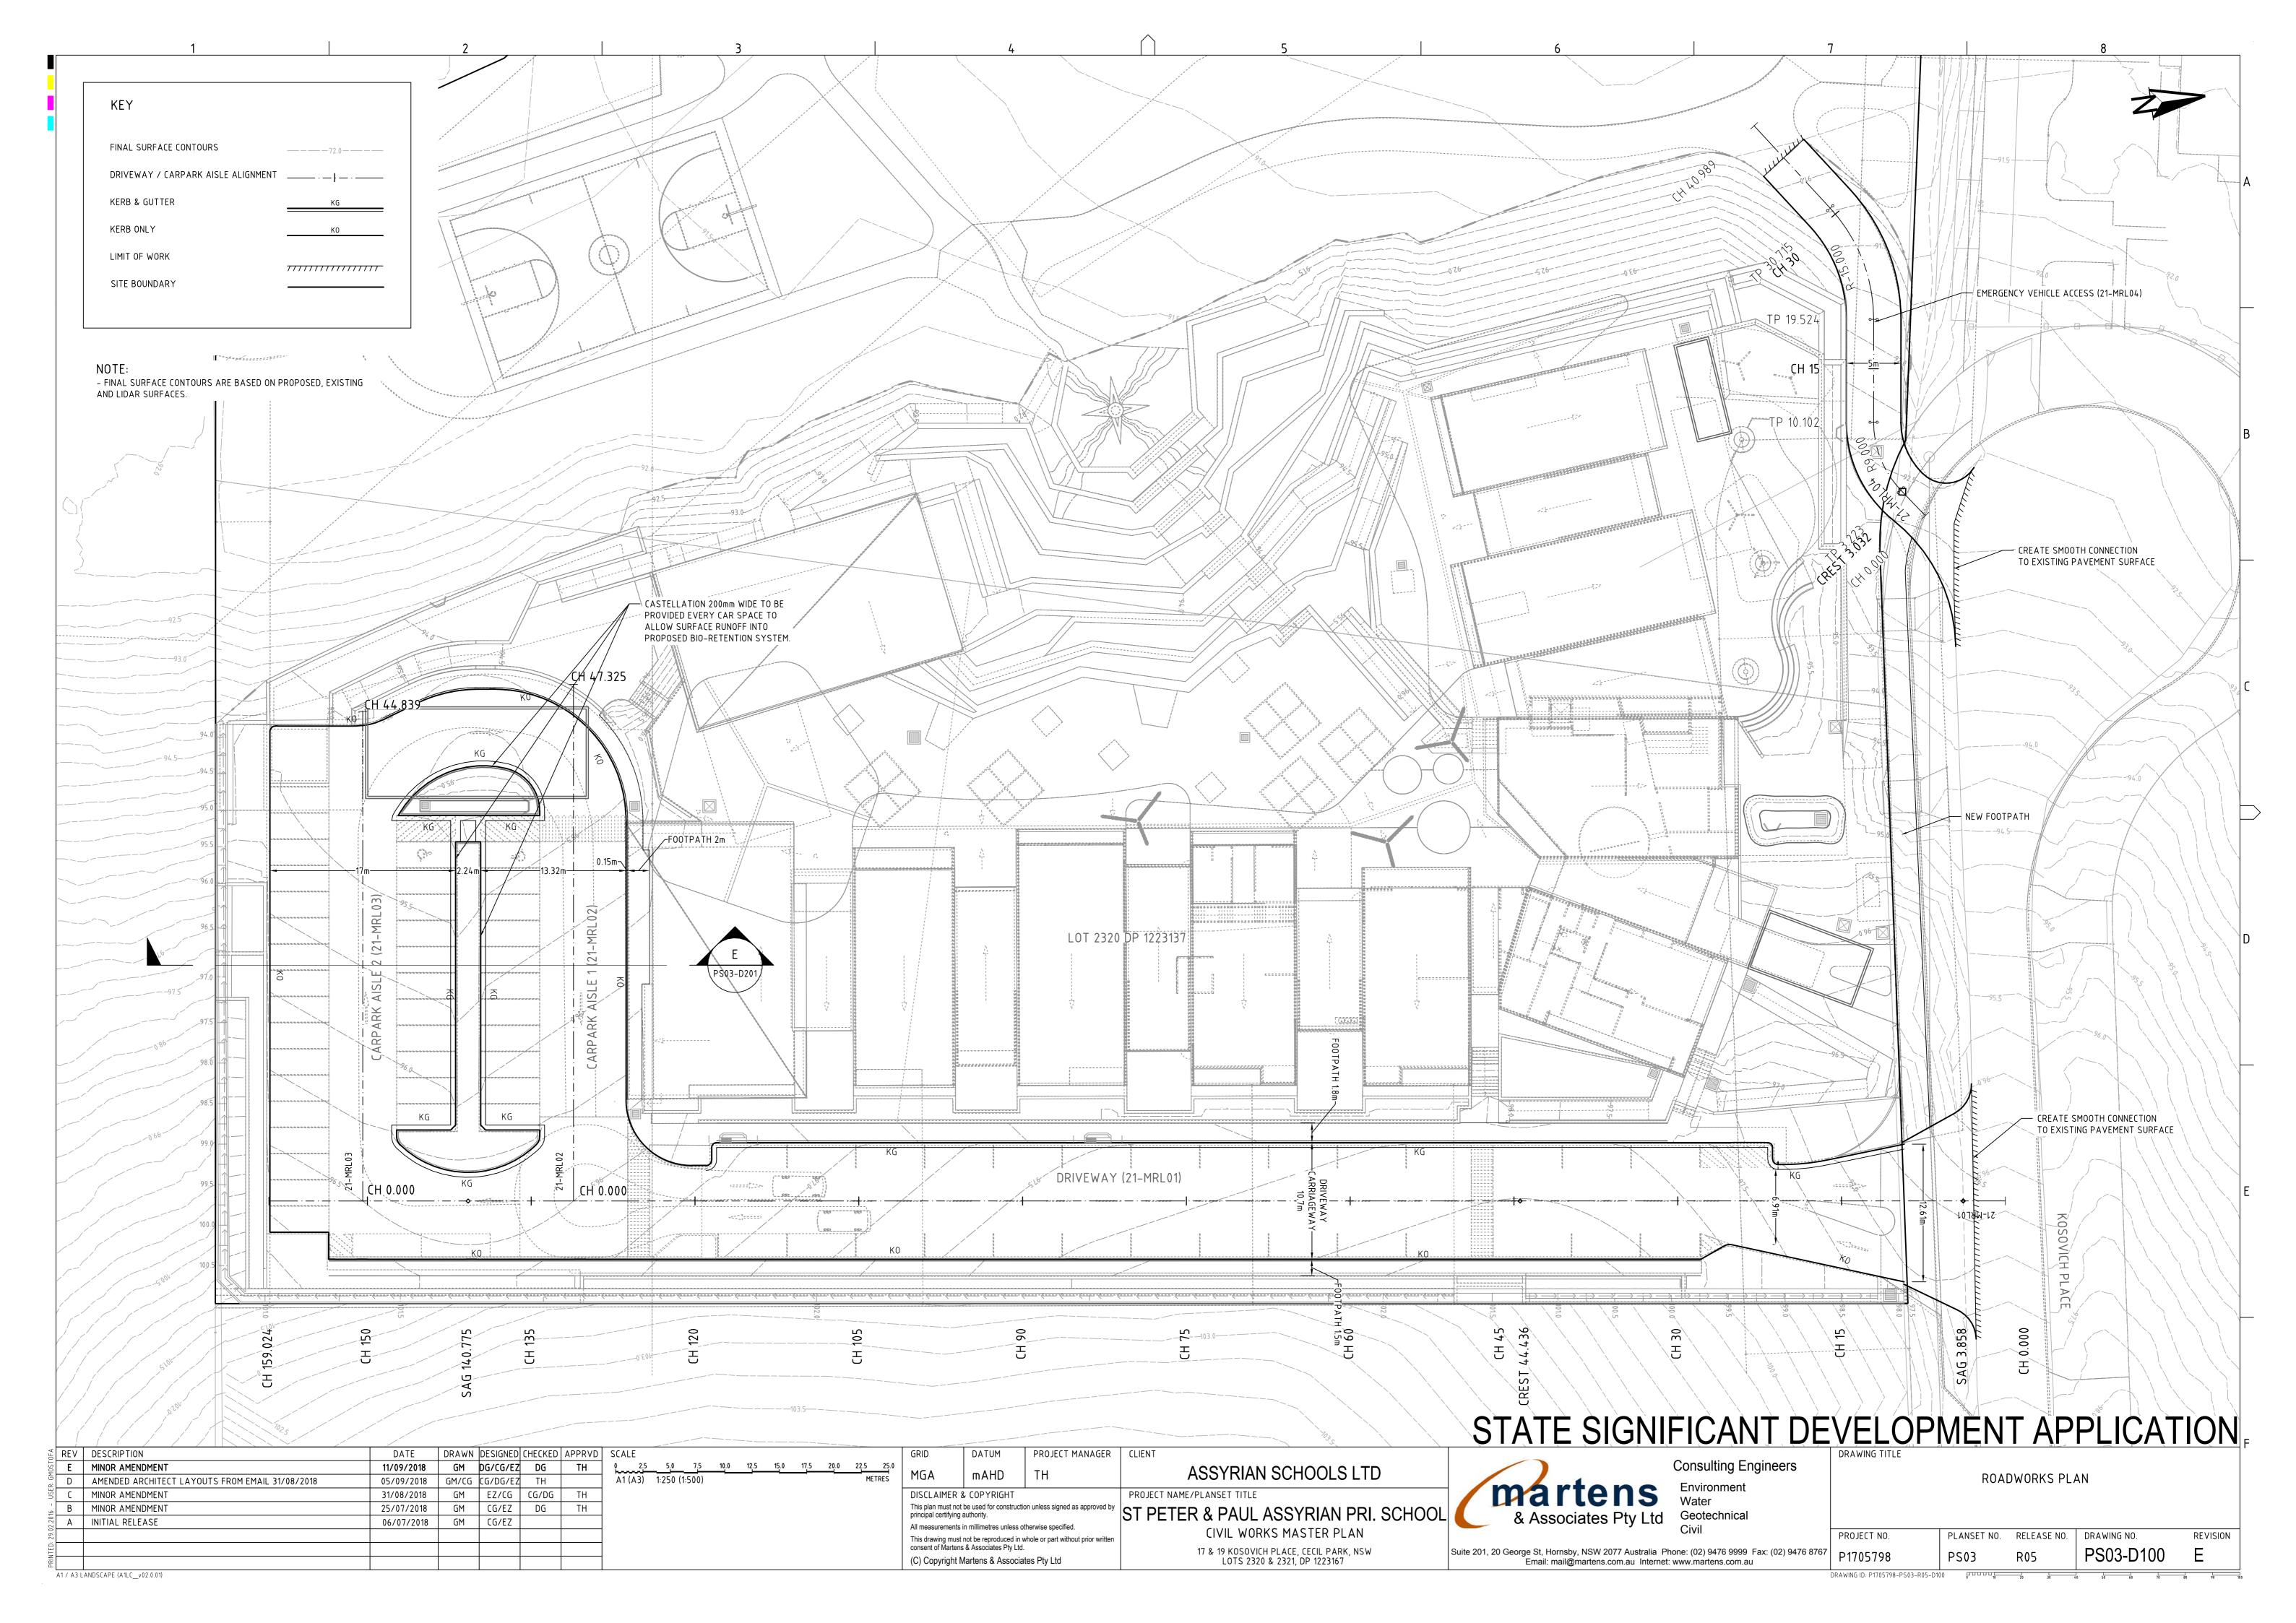
STATE SIGNIFICANT DEVELOPMENT APPLICATION, SEDIMENT & EROSION CONTROL DETAILS PROJECT NO. RELEASE NO. DRAWING NO. REVISION PS03-B31







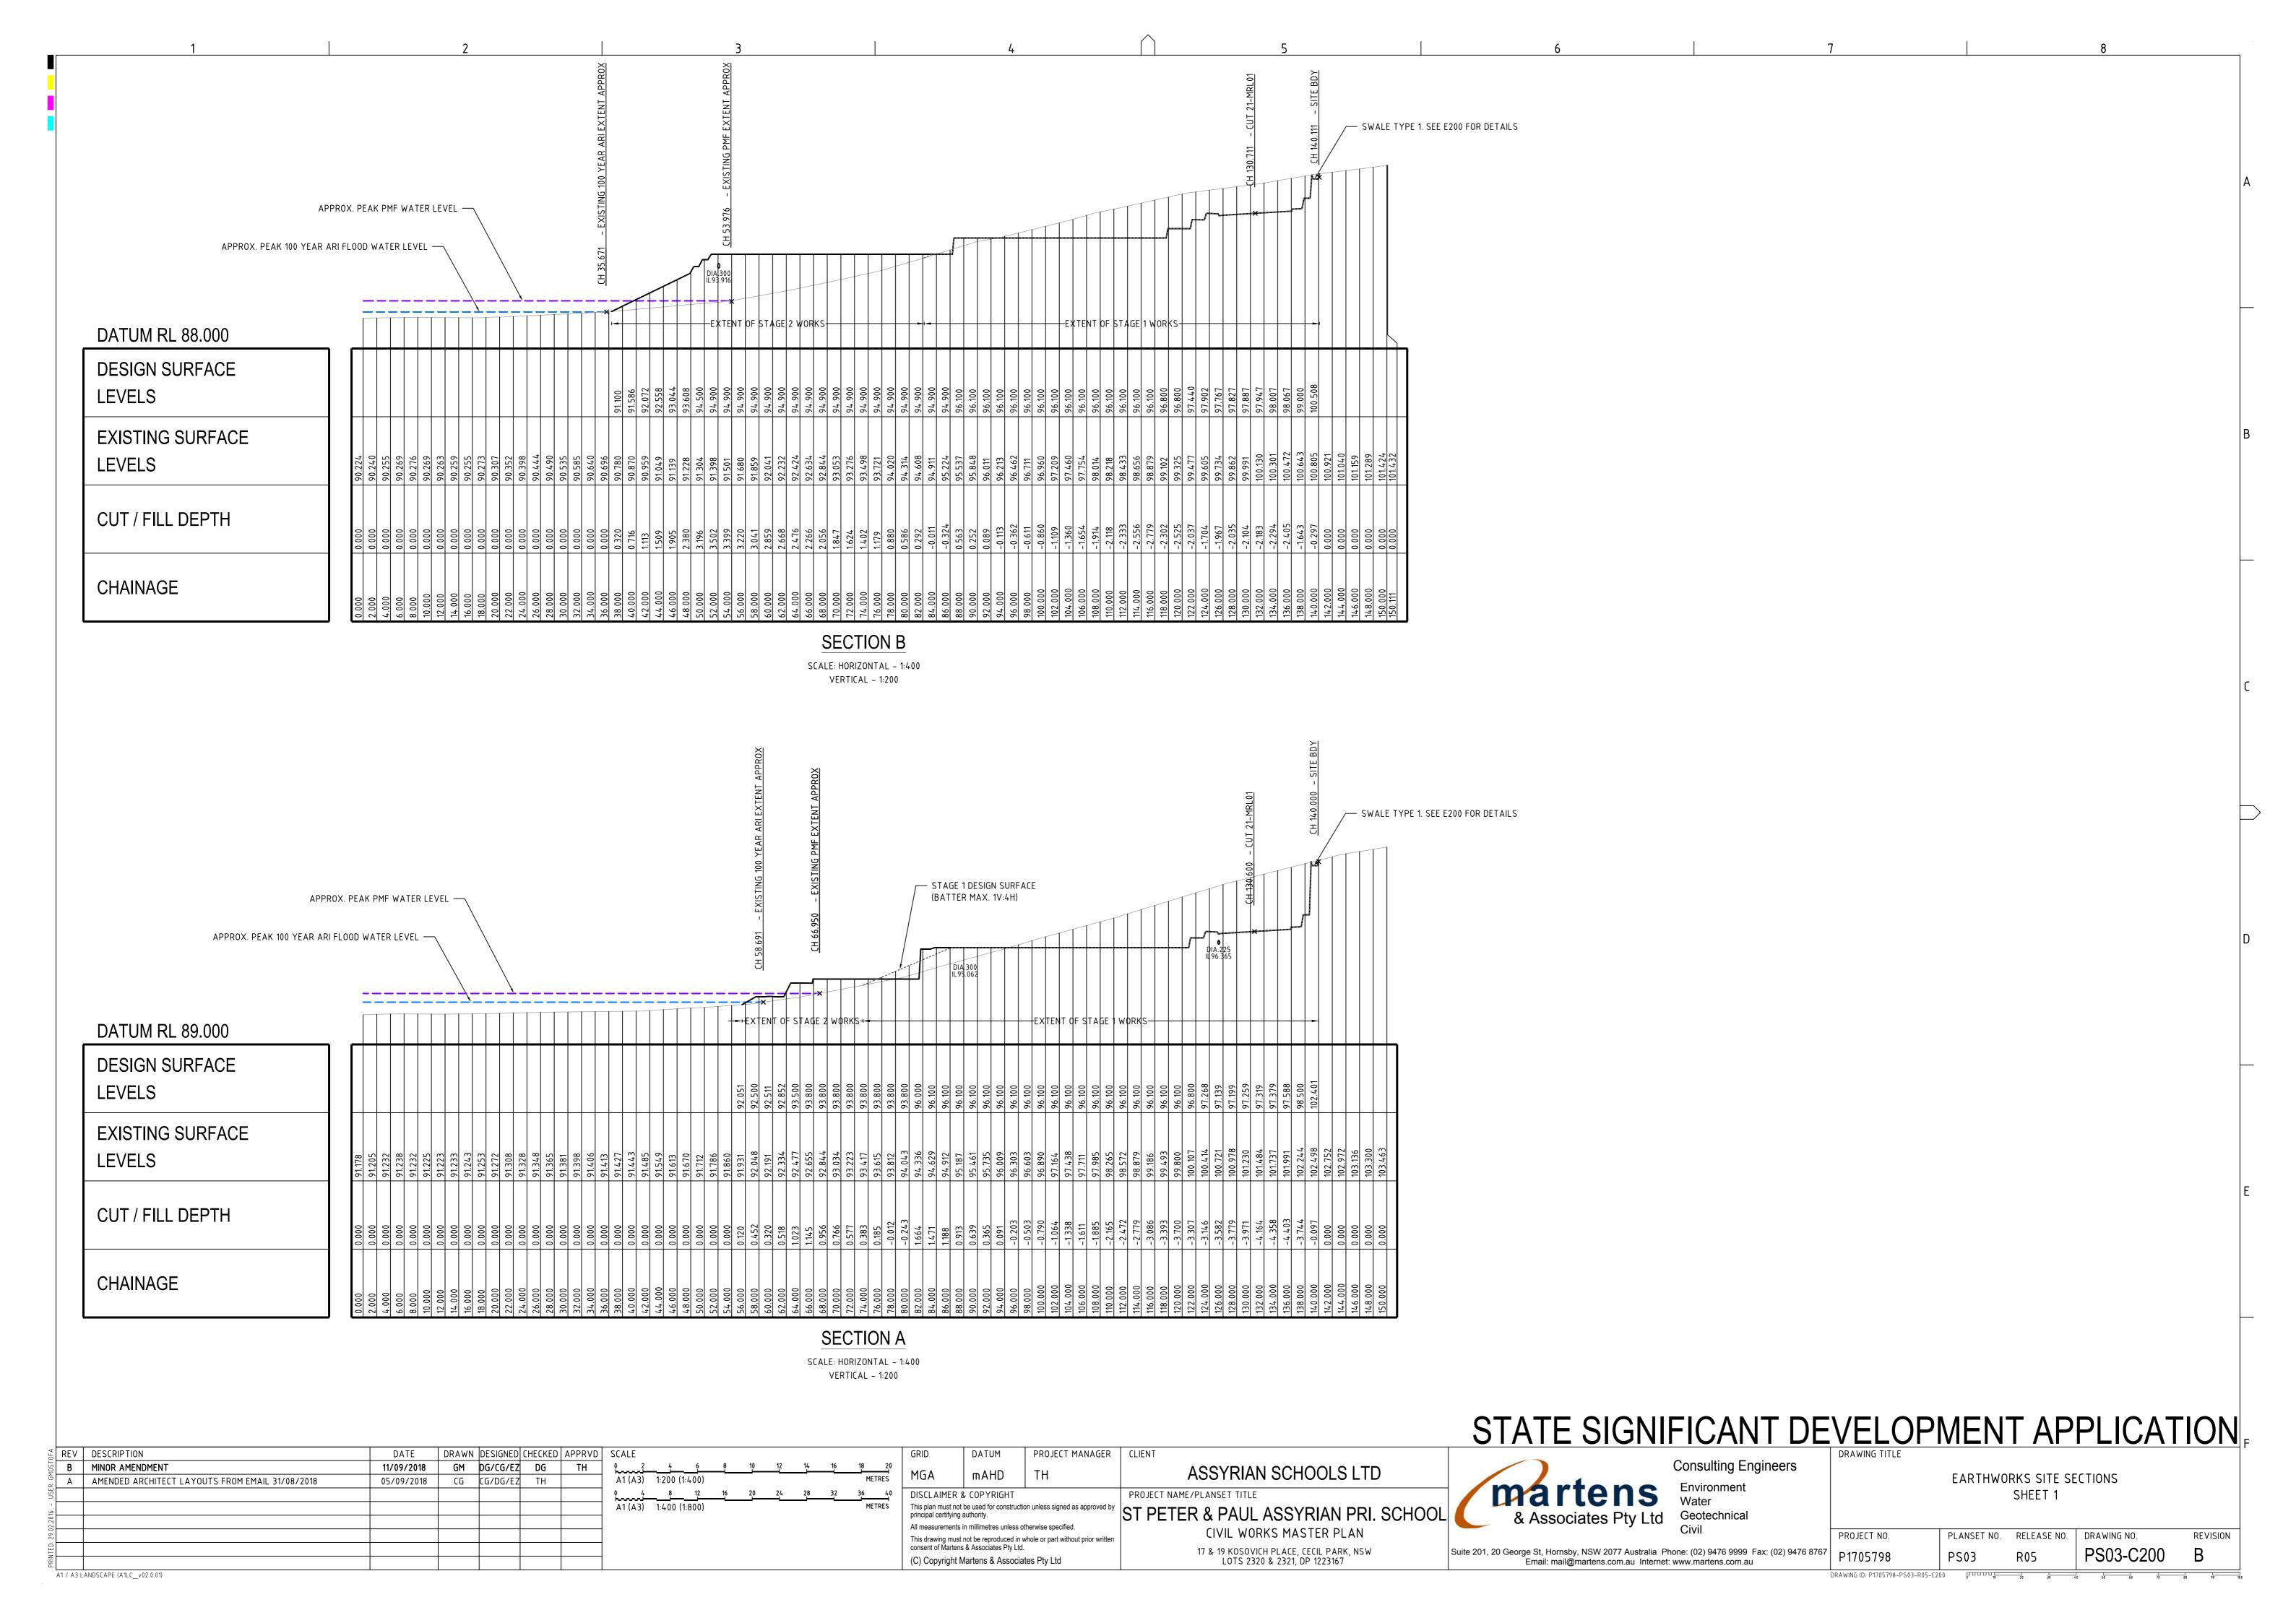


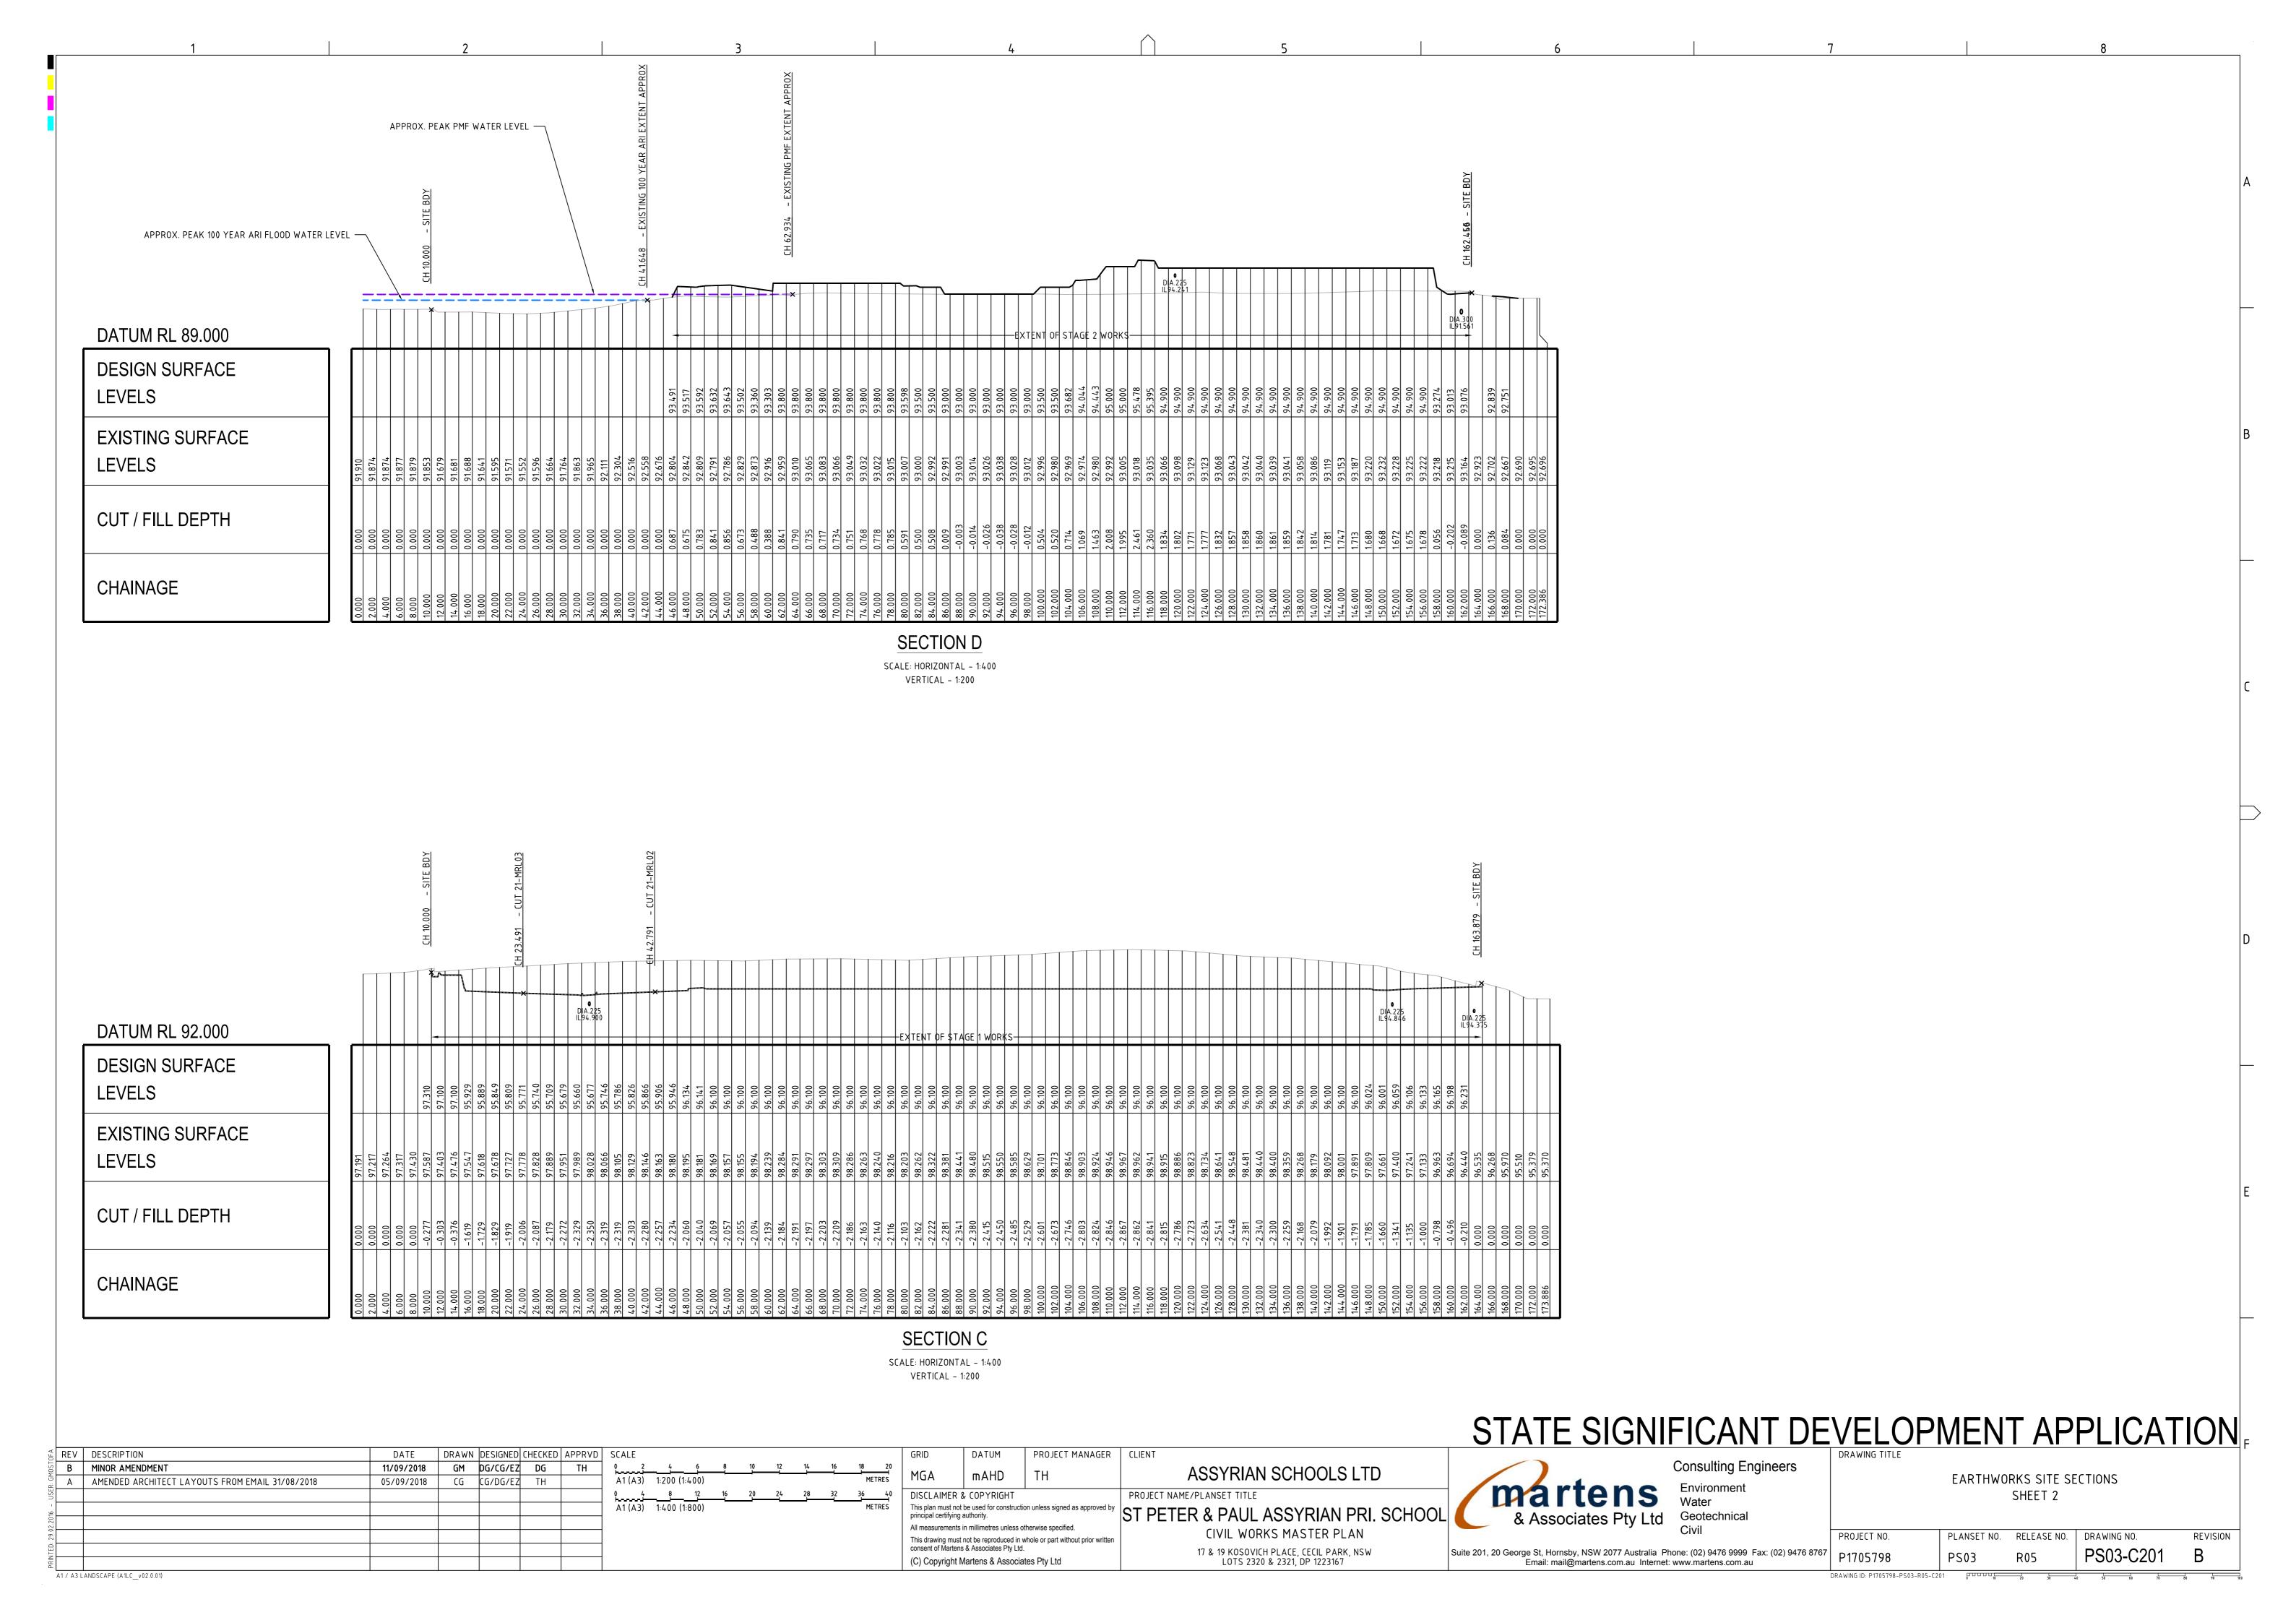





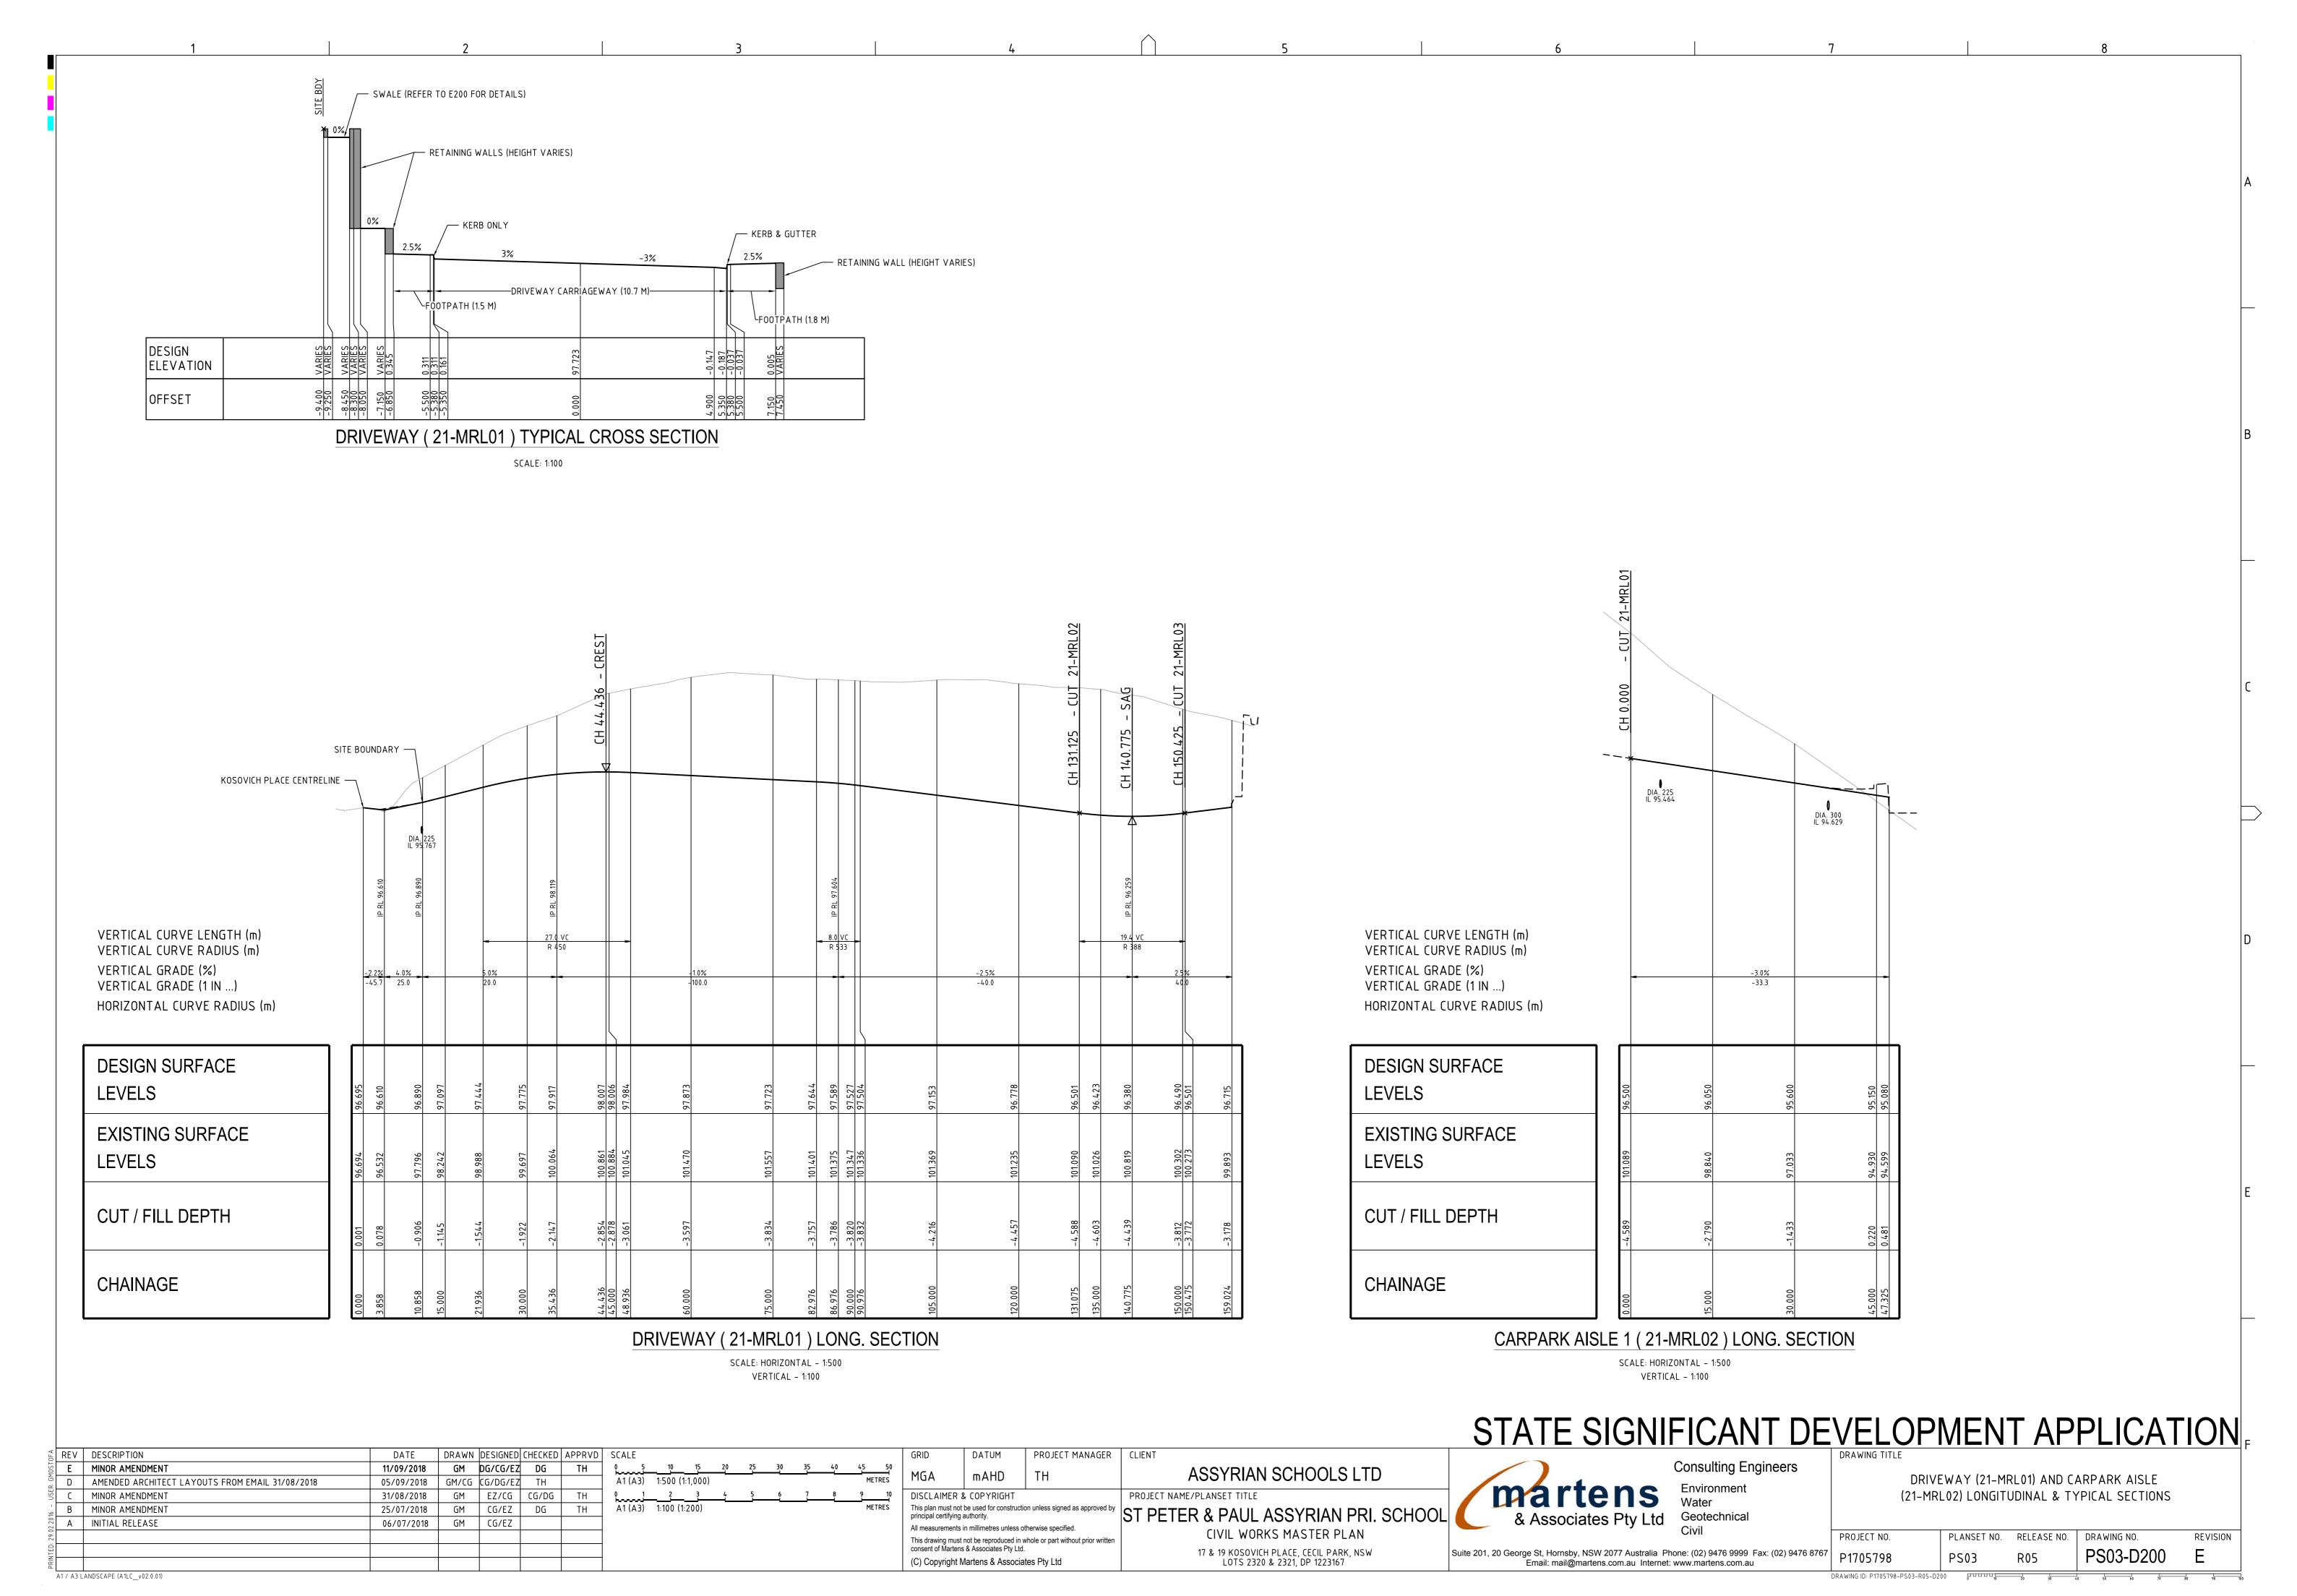

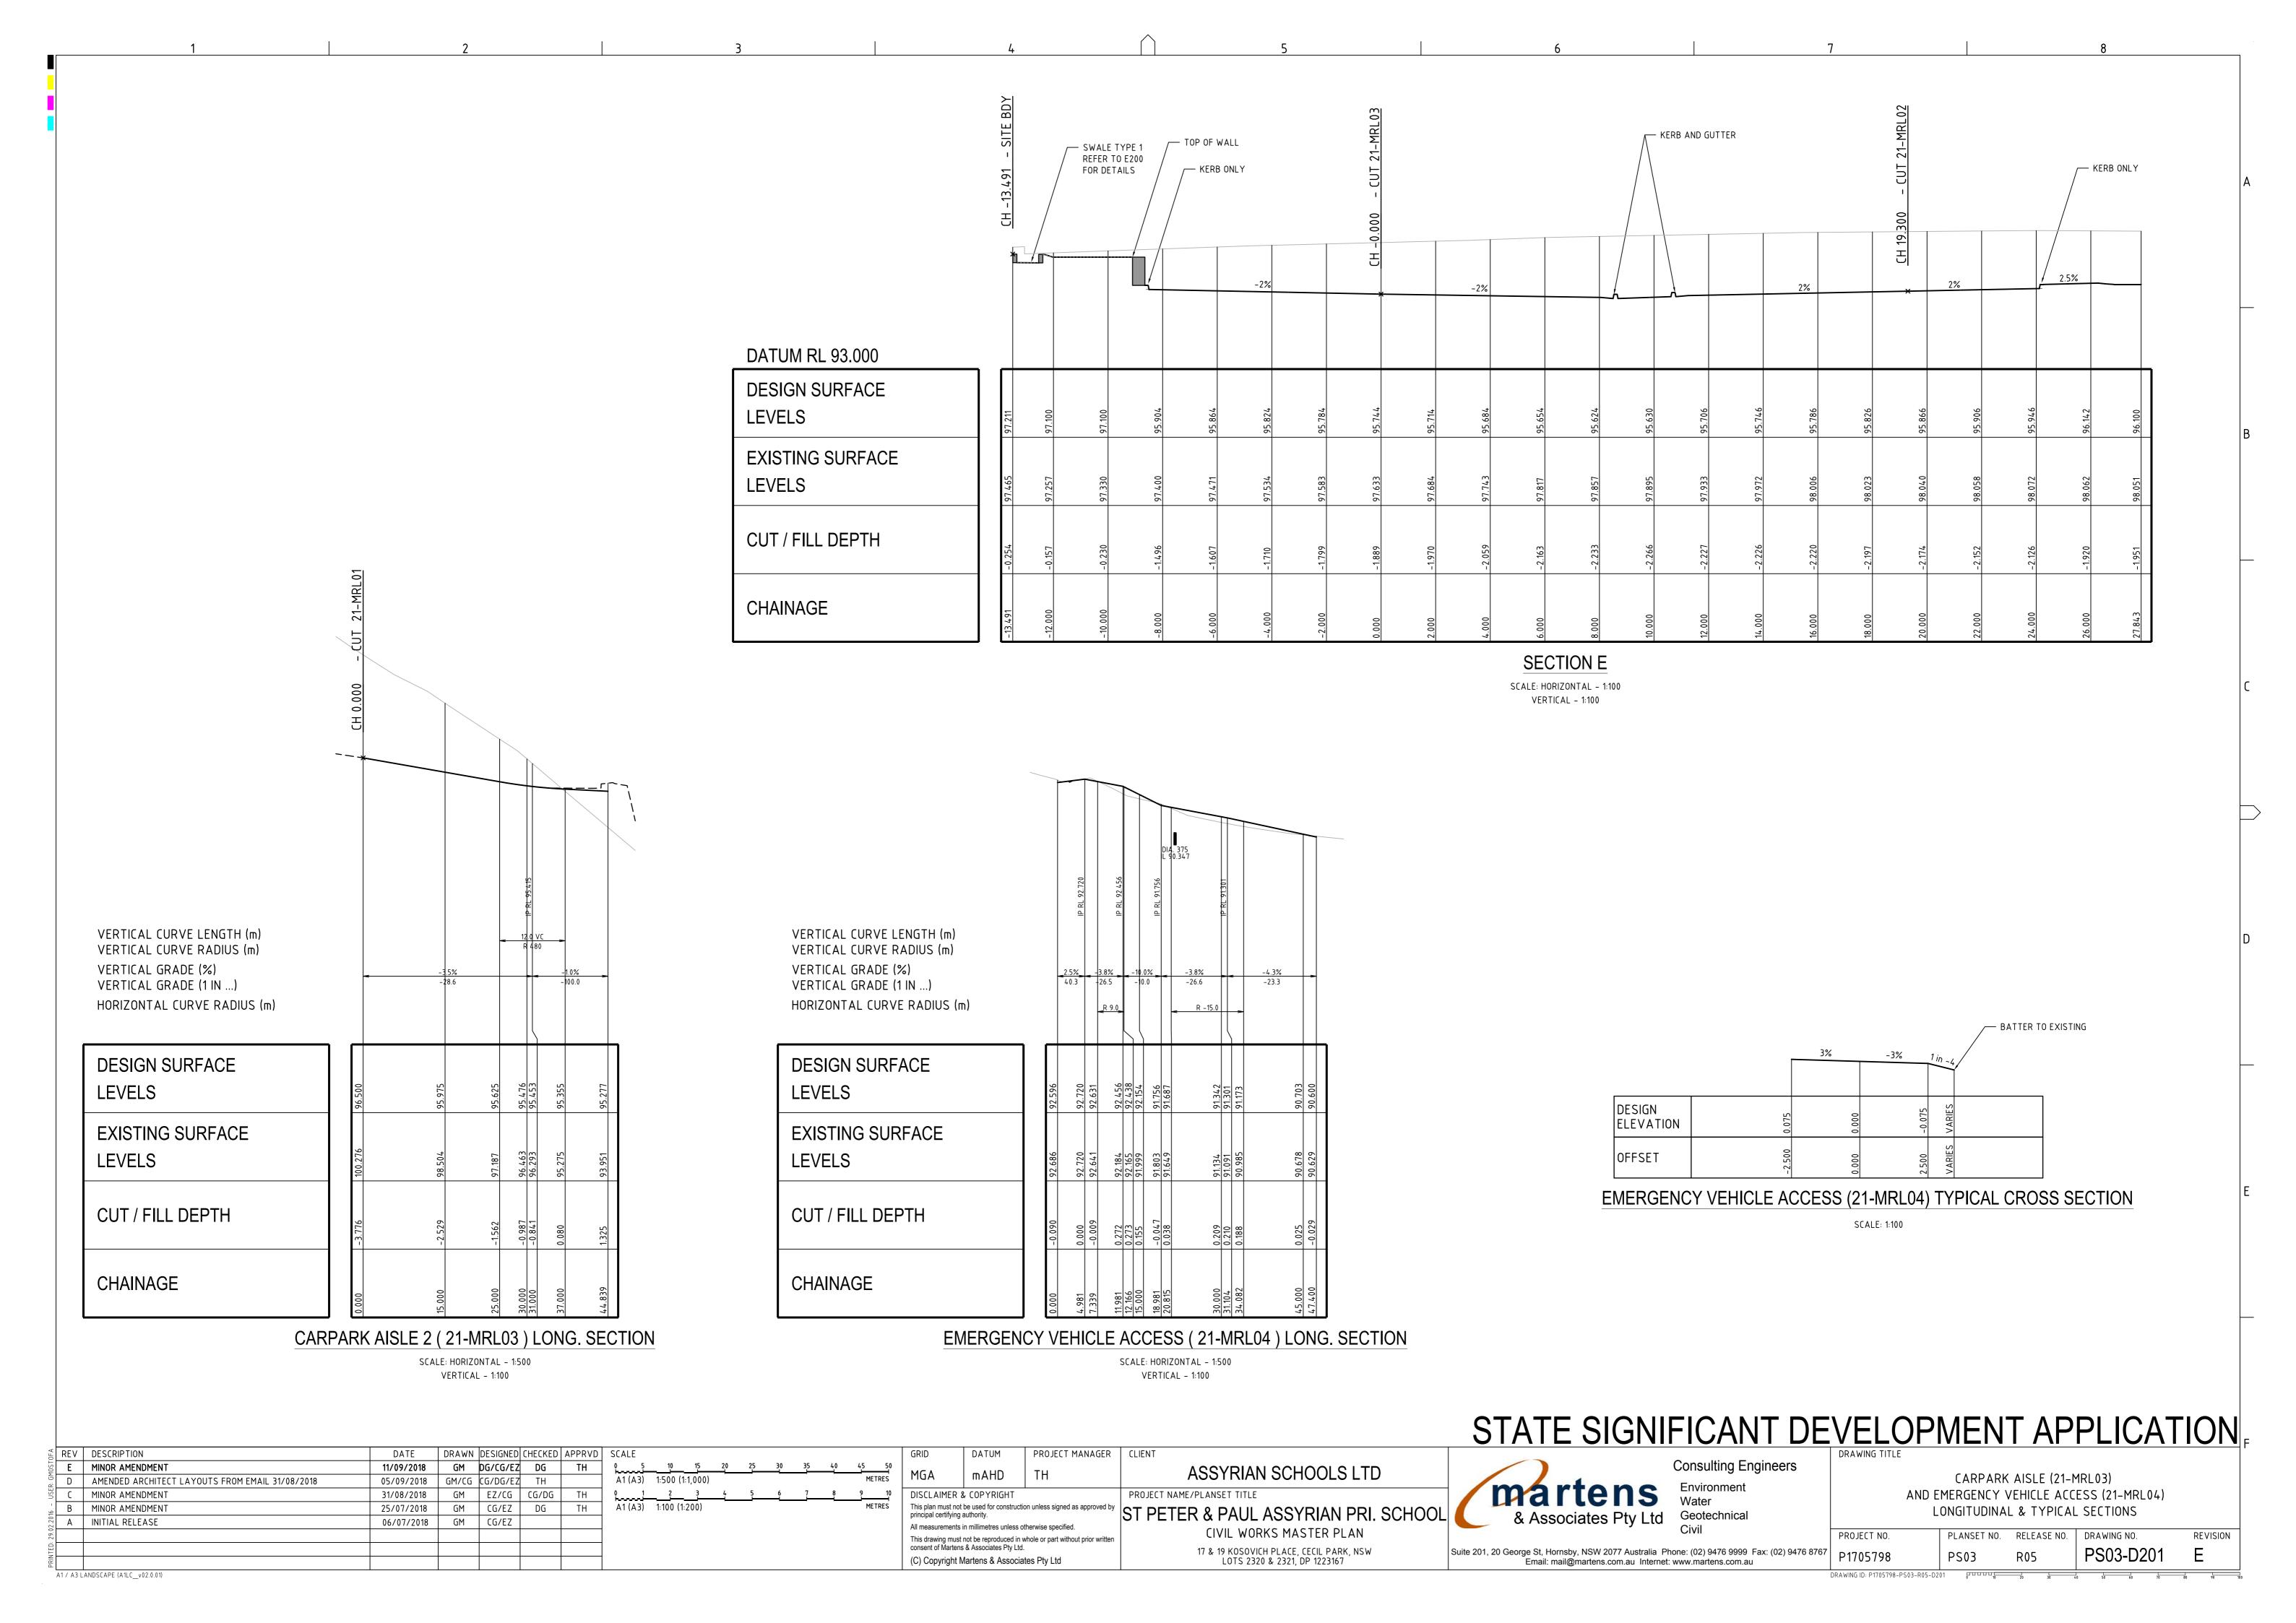

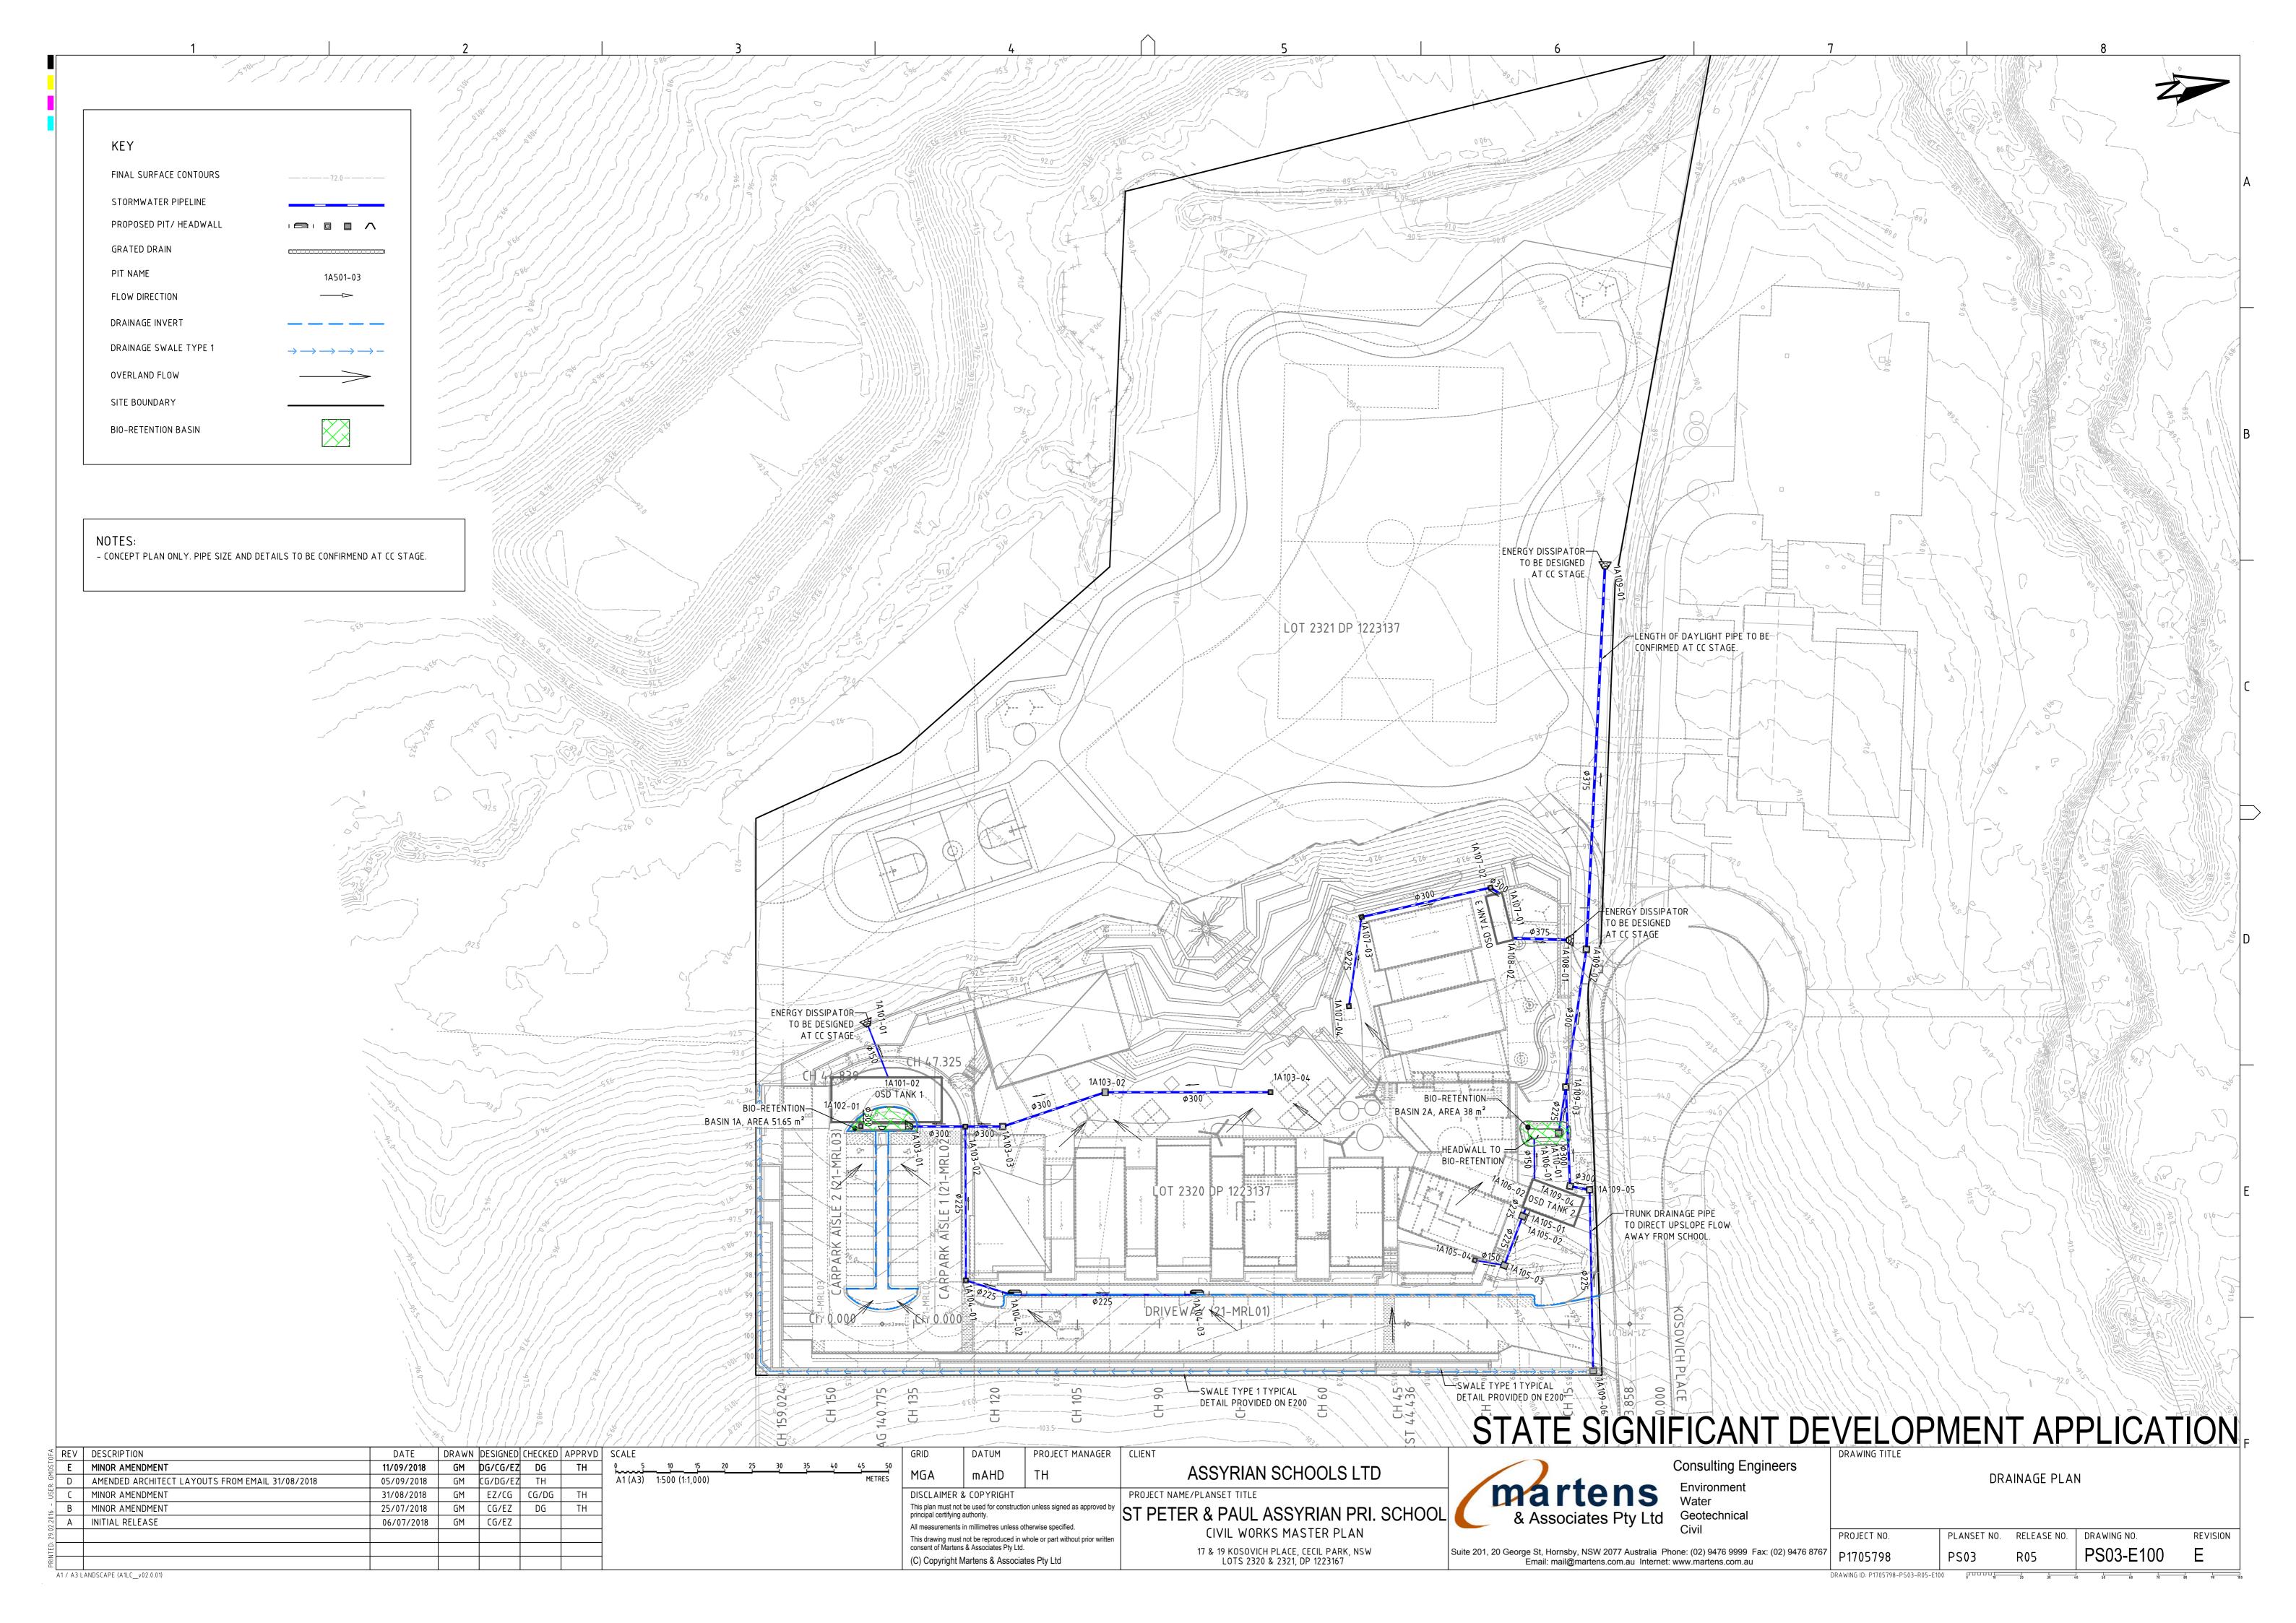


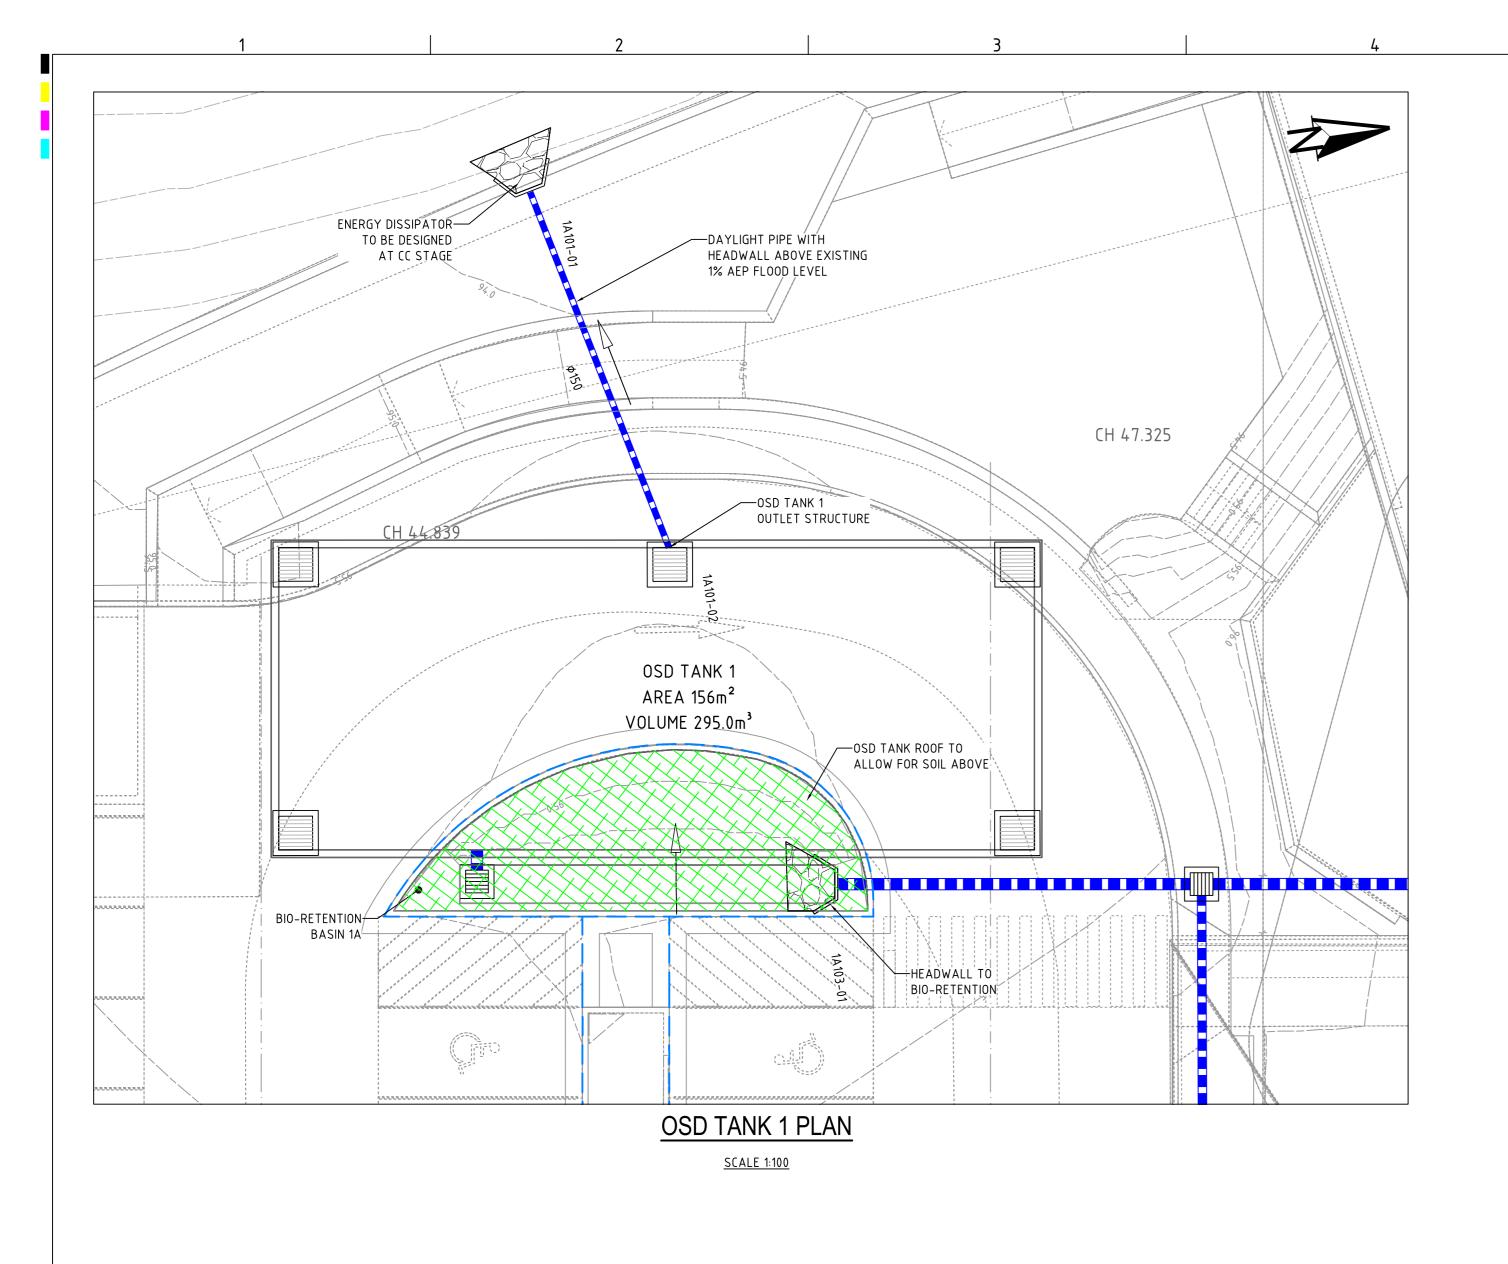

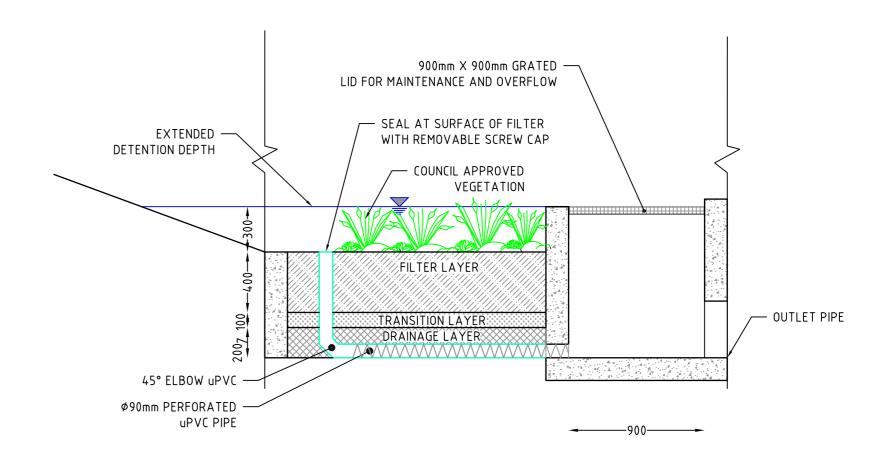


### TYPICAL SECTION: BIORETENTION

SCALE: 1:25

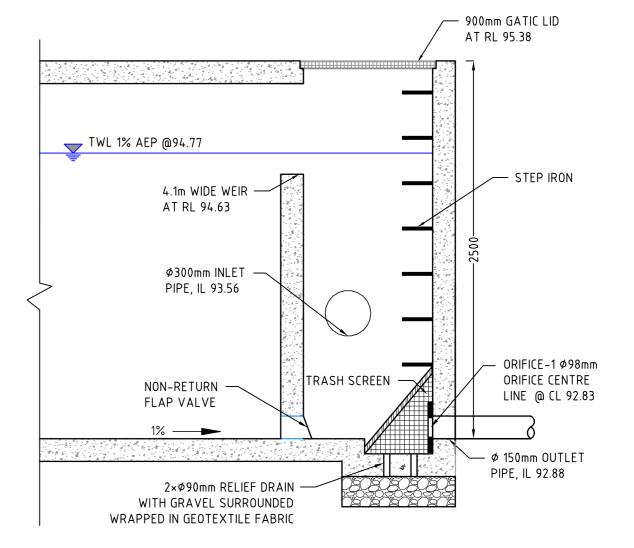

## OSD TANK 1 OUTLET STRUCTURE

- BIO-RETENTION SYSTEM DETAILS TO BE PROVIDED AT CC STAGE AND SHALL BE DESIGNED AS PER FAWB (2009) GUIDELINES.

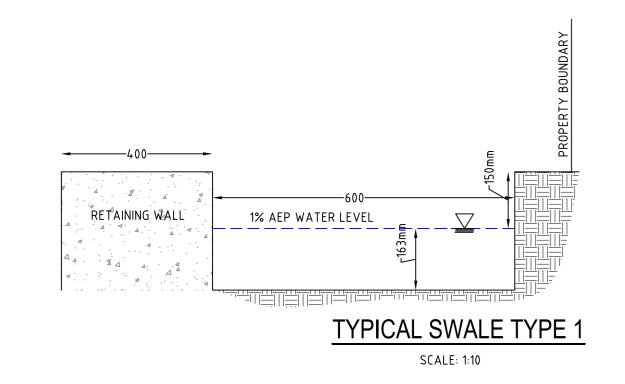


A1 / A3 LANDSCAPE (A1LC\_v02.0.01)


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REV	DESCRIPTION	DATE	DRAWN	DESIGNED	CHECKED	APPRVD	SCALE									GRID	DATUM	PROJECT MA
D	MINOR AMENDMENT	11/09/2018	GM	DG/CG/EZ	DG	TH	0 1 	2	3	4	5	6	7	8	9 10	MGA	mAHD	   TH
С	AMENDED ARCHITECT LAYOUTS FROM EMAIL 31/08/2018	05/09/2018	GM	CG/DG/EZ	. TH		A1 (A3)	1:100 (1:	200)						METRES	MUA	IIIAND	10
В	MINOR AMENDMENT	31/08/2018	GM	EZ/CG	CG/DG	TH	0 0.25	0.50	0.75	1.00	1.25	1.50	1.75	2.00	2.25 2.50	DISCLAIMER	& COPYRIGHT	
Α	MINOR AMENDMENT	25/07/2018	GM	CG/EZ	DG	TH	A1 (A3)	1:25 (1:5	50)						METRES	This plan must not principal certifying		on unless signed as a
							0 0.1	0.2	0.3	0.4	0.5	0.6	0.7	0.8	0.9 1.0	1	•	therwise specified
							A1 (A3)	1:10 (1:2	(0)	,	-		-		METRES			•
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							1									(C) Copyright I	Martens & Associa	ites Pty Ltd
							A1 (A3)	1:10 (1:2	(0)	U.4 ————————————————————————————————————	V:3		<u> </u>	i	_	This drawing must consent of Marten	•	whole

	GRID	DATUM	PROJECT MANAGER	CLIENT
TRES	MGA	mAHD	TH	ASSYRIAN SCHOOLS LTD
2.50	DISCLAIMER 8	& COPYRIGHT		PROJECT NAME/PLANSET TITLE
TRES	This plan must not principal certifying		on unless signed as approved by	ST PETER & PAUL ASSYRIAN PRI. SCHOO
1.0 TRES		in millimetres unless of	•	CIVIL WORKS MASTER PLAN
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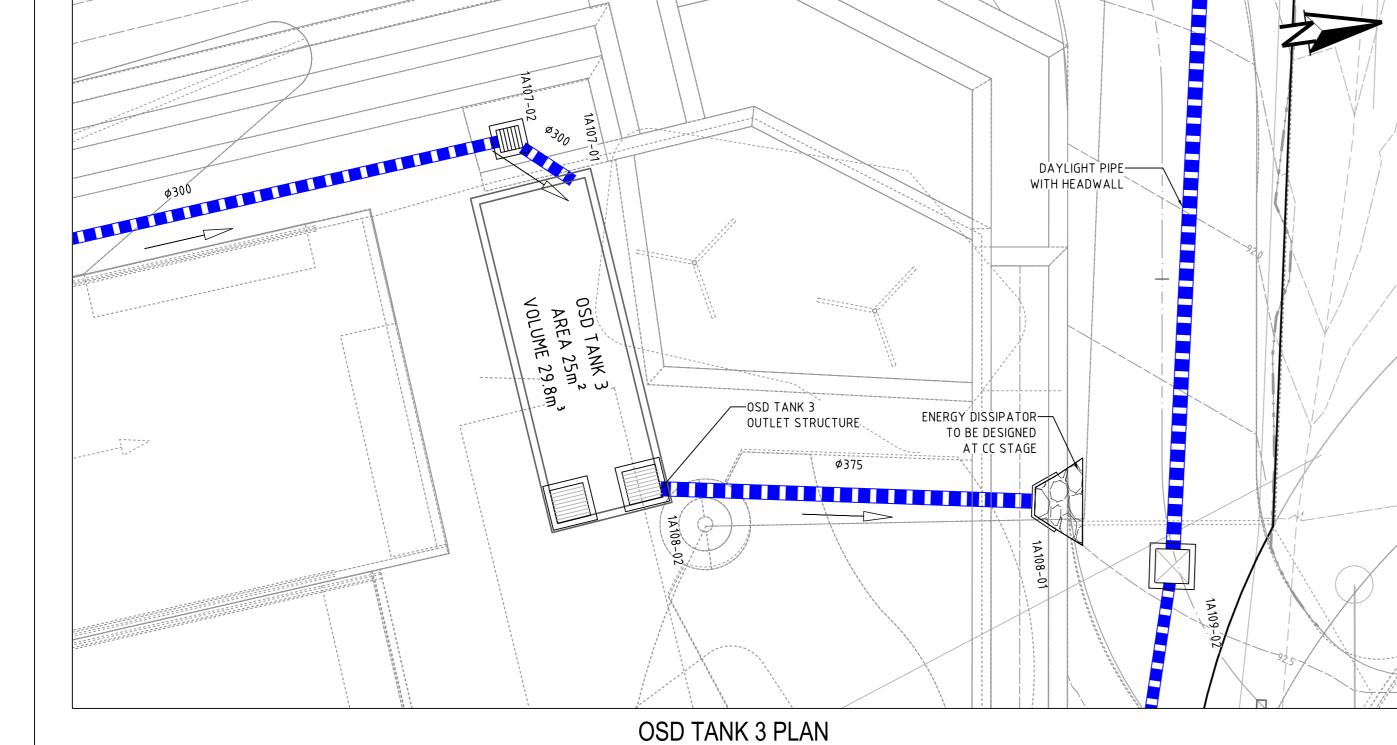
L	martens & Associates Pty Ltd	Consulting Engineers Environment Water Geotechnical	DICAWING TITLE	DRAINAGE	EDETAILS (S	HEET 1)	
		Civil	PROJECT NO.	PLANSET NO.	RELEASE NO.	DRAWING NO.	REVISION
	Suite 201, 20 George St, Hornsby, NSW 2077 Australia P Email: mail@martens.com.au Internet		P1705798	PS03	R05	PS03-E200	D
			DDAWING ID. D1705708 DC03 D05 F2/	^^			



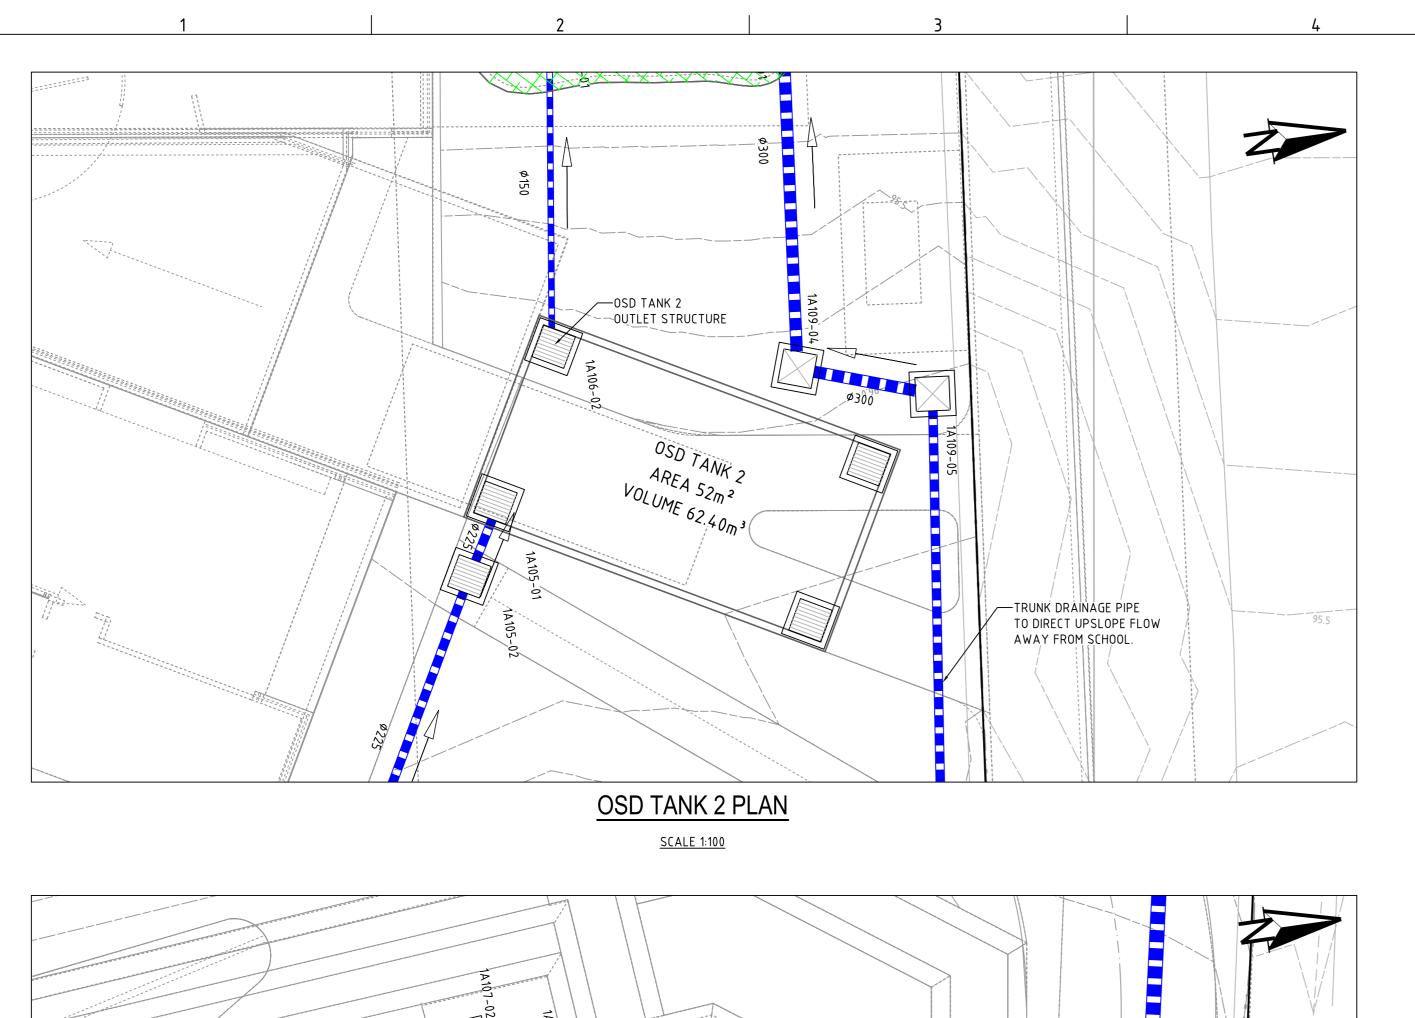


OSD TANK 2 OUTLET STRUCTURE

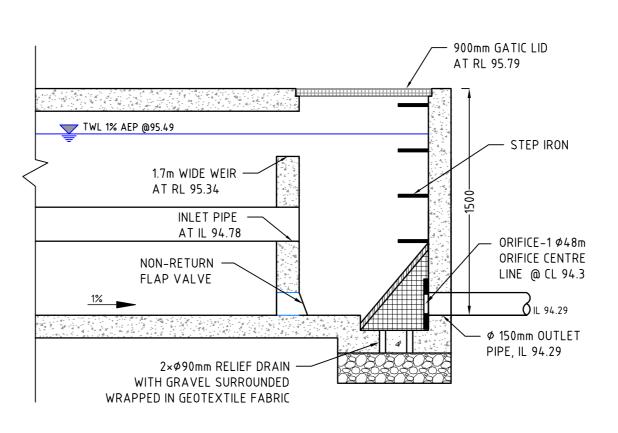SCALE: 1:25



SCALE 1:100

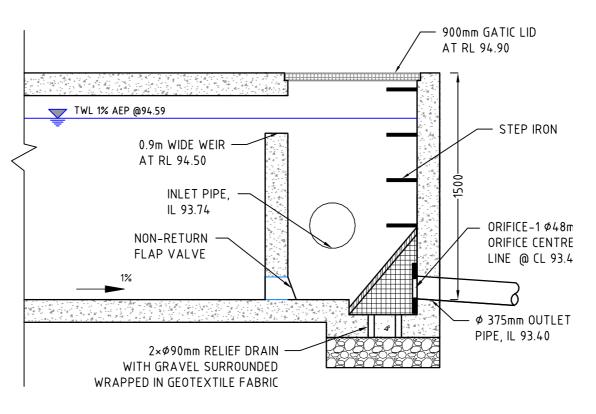

### OSD TANK 3 OUTLET STRUCTURE

SCALE: 1:25

NOTES:

- BIO-RETENTION SYSTEM DETAILS TO BE PROVIDED AT CC STAGE AND SHALL BE


DESIGNED AS PER FAWB (2009) GUIDELINES.


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REV DESCRIPTION	DATE	DRAWN DESIGNED CHECKED	APPRVD SCALE			GRID	DATUM	PROJECT MANAGER	CLIENT					DRAWING	TITLE		
D MINOR AMENDMENT	11/09/2018	GM DG/CG/EZ DG	TH 9 1	2 3 4 5 6 7	8 9 10					A COVERNI COLLOCI O LETE			Consulting Engine	eers			

REV mAHD TH ASSYRIAN SCHOOLS LID METRES A1 (A3) 1:100 (1:200) 05/09/2018 GM CG/DG/EZ TH AMENDED ARCHITECT LAYOUTS FROM EMAIL 31/08/2018 0 0.25 0.50 0.75 1.00 1.25 1.50 1.75 2.00 2.25 2.50 GM EZ/CG CG/DG DISCLAIMER & COPYRIGHT PROJECT NAME/PLANSET TITLE B MINOR AMENDMENT 31/08/2018 A1 (A3) 1:25 (1:50) This plan must not be used for construction unless signed as approved by principal certifying authority. A MINOR AMENDMENT 25/07/2018 GM CG/EZ DG ST PETER & PAUL ASSYRIAN PRI. SCHOOL TH All measurements in millimetres unless otherwise specified. CIVIL WORKS MASTER PLAN This drawing must not be reproduced in whole or part without prior written consent of Martens & Associates Pty Ltd. 17 & 19 KOSOVICH PLACE, CECIL PARK, NSW LOTS 2320 & 2321, DP 1223167 (C) Copyright Martens & Associates Pty Ltd

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DRAWING TITLE				
	DRAINAGE	DETAILS (S	HEET 2)	
	1			
PROJECT NO.	PLANSET NO.	RELEASE NO.	DRAWING NO.	REVISION
P1705798	PS03	R05	PS03-E201	D



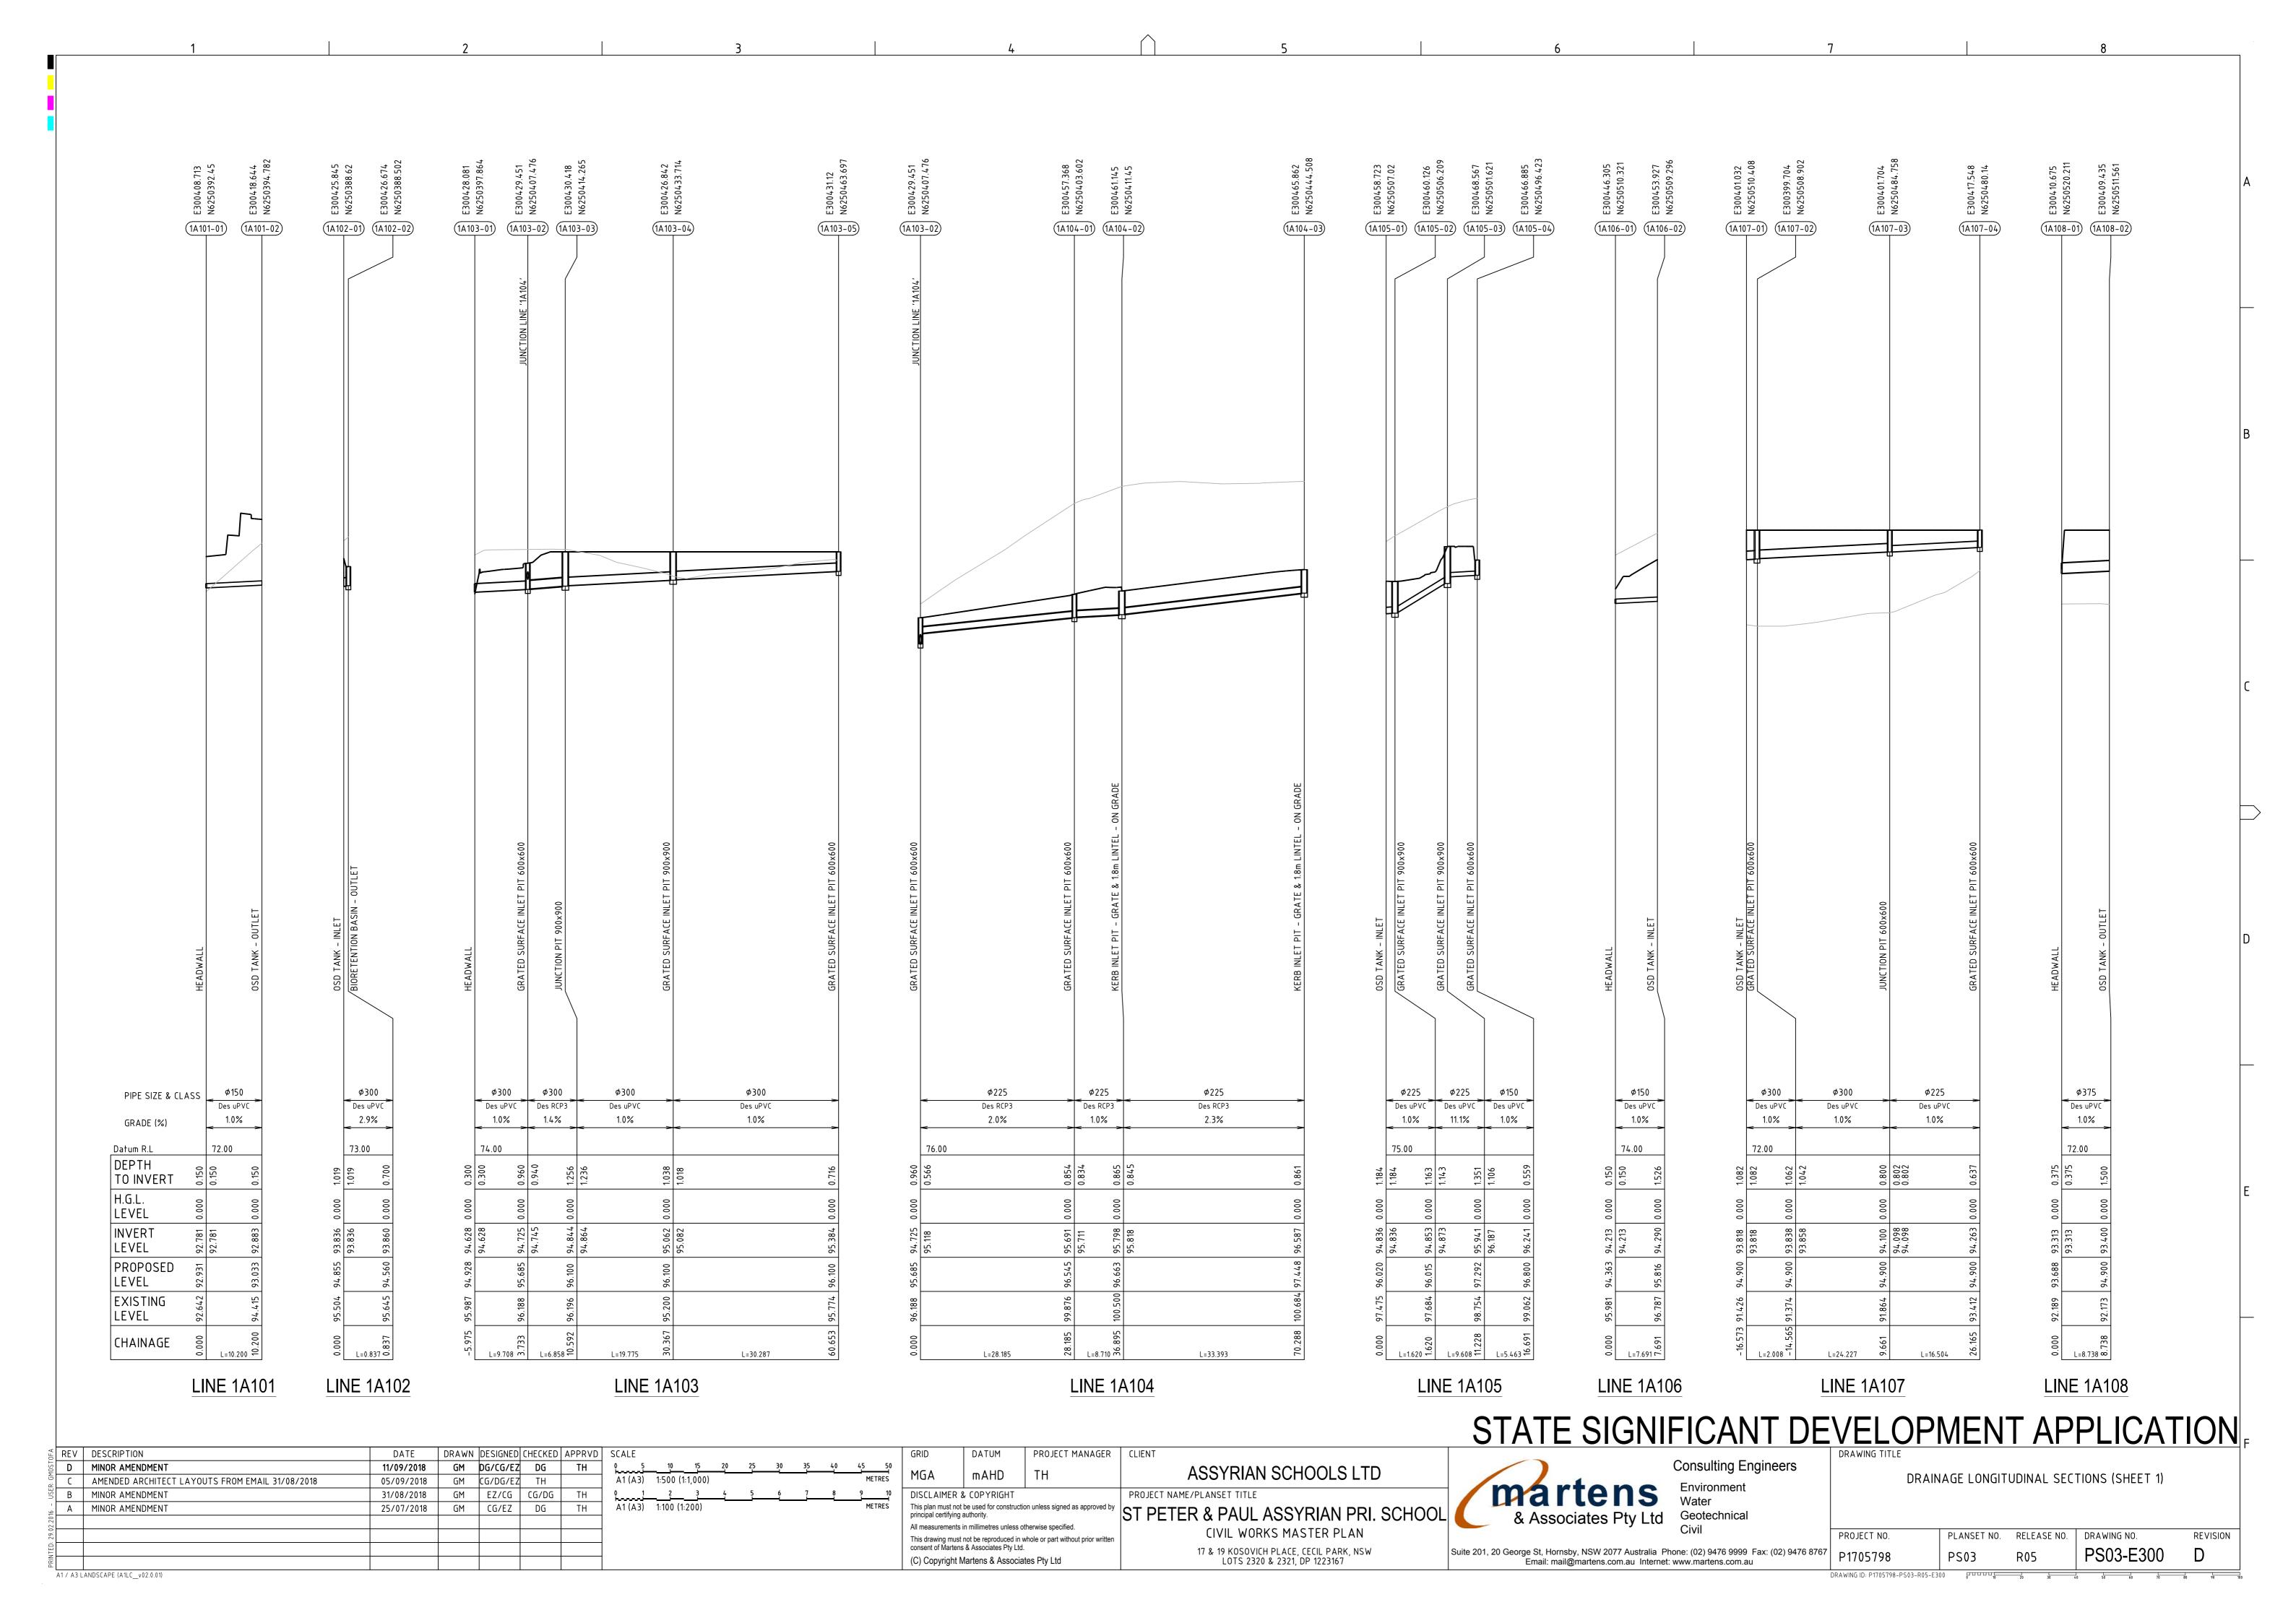

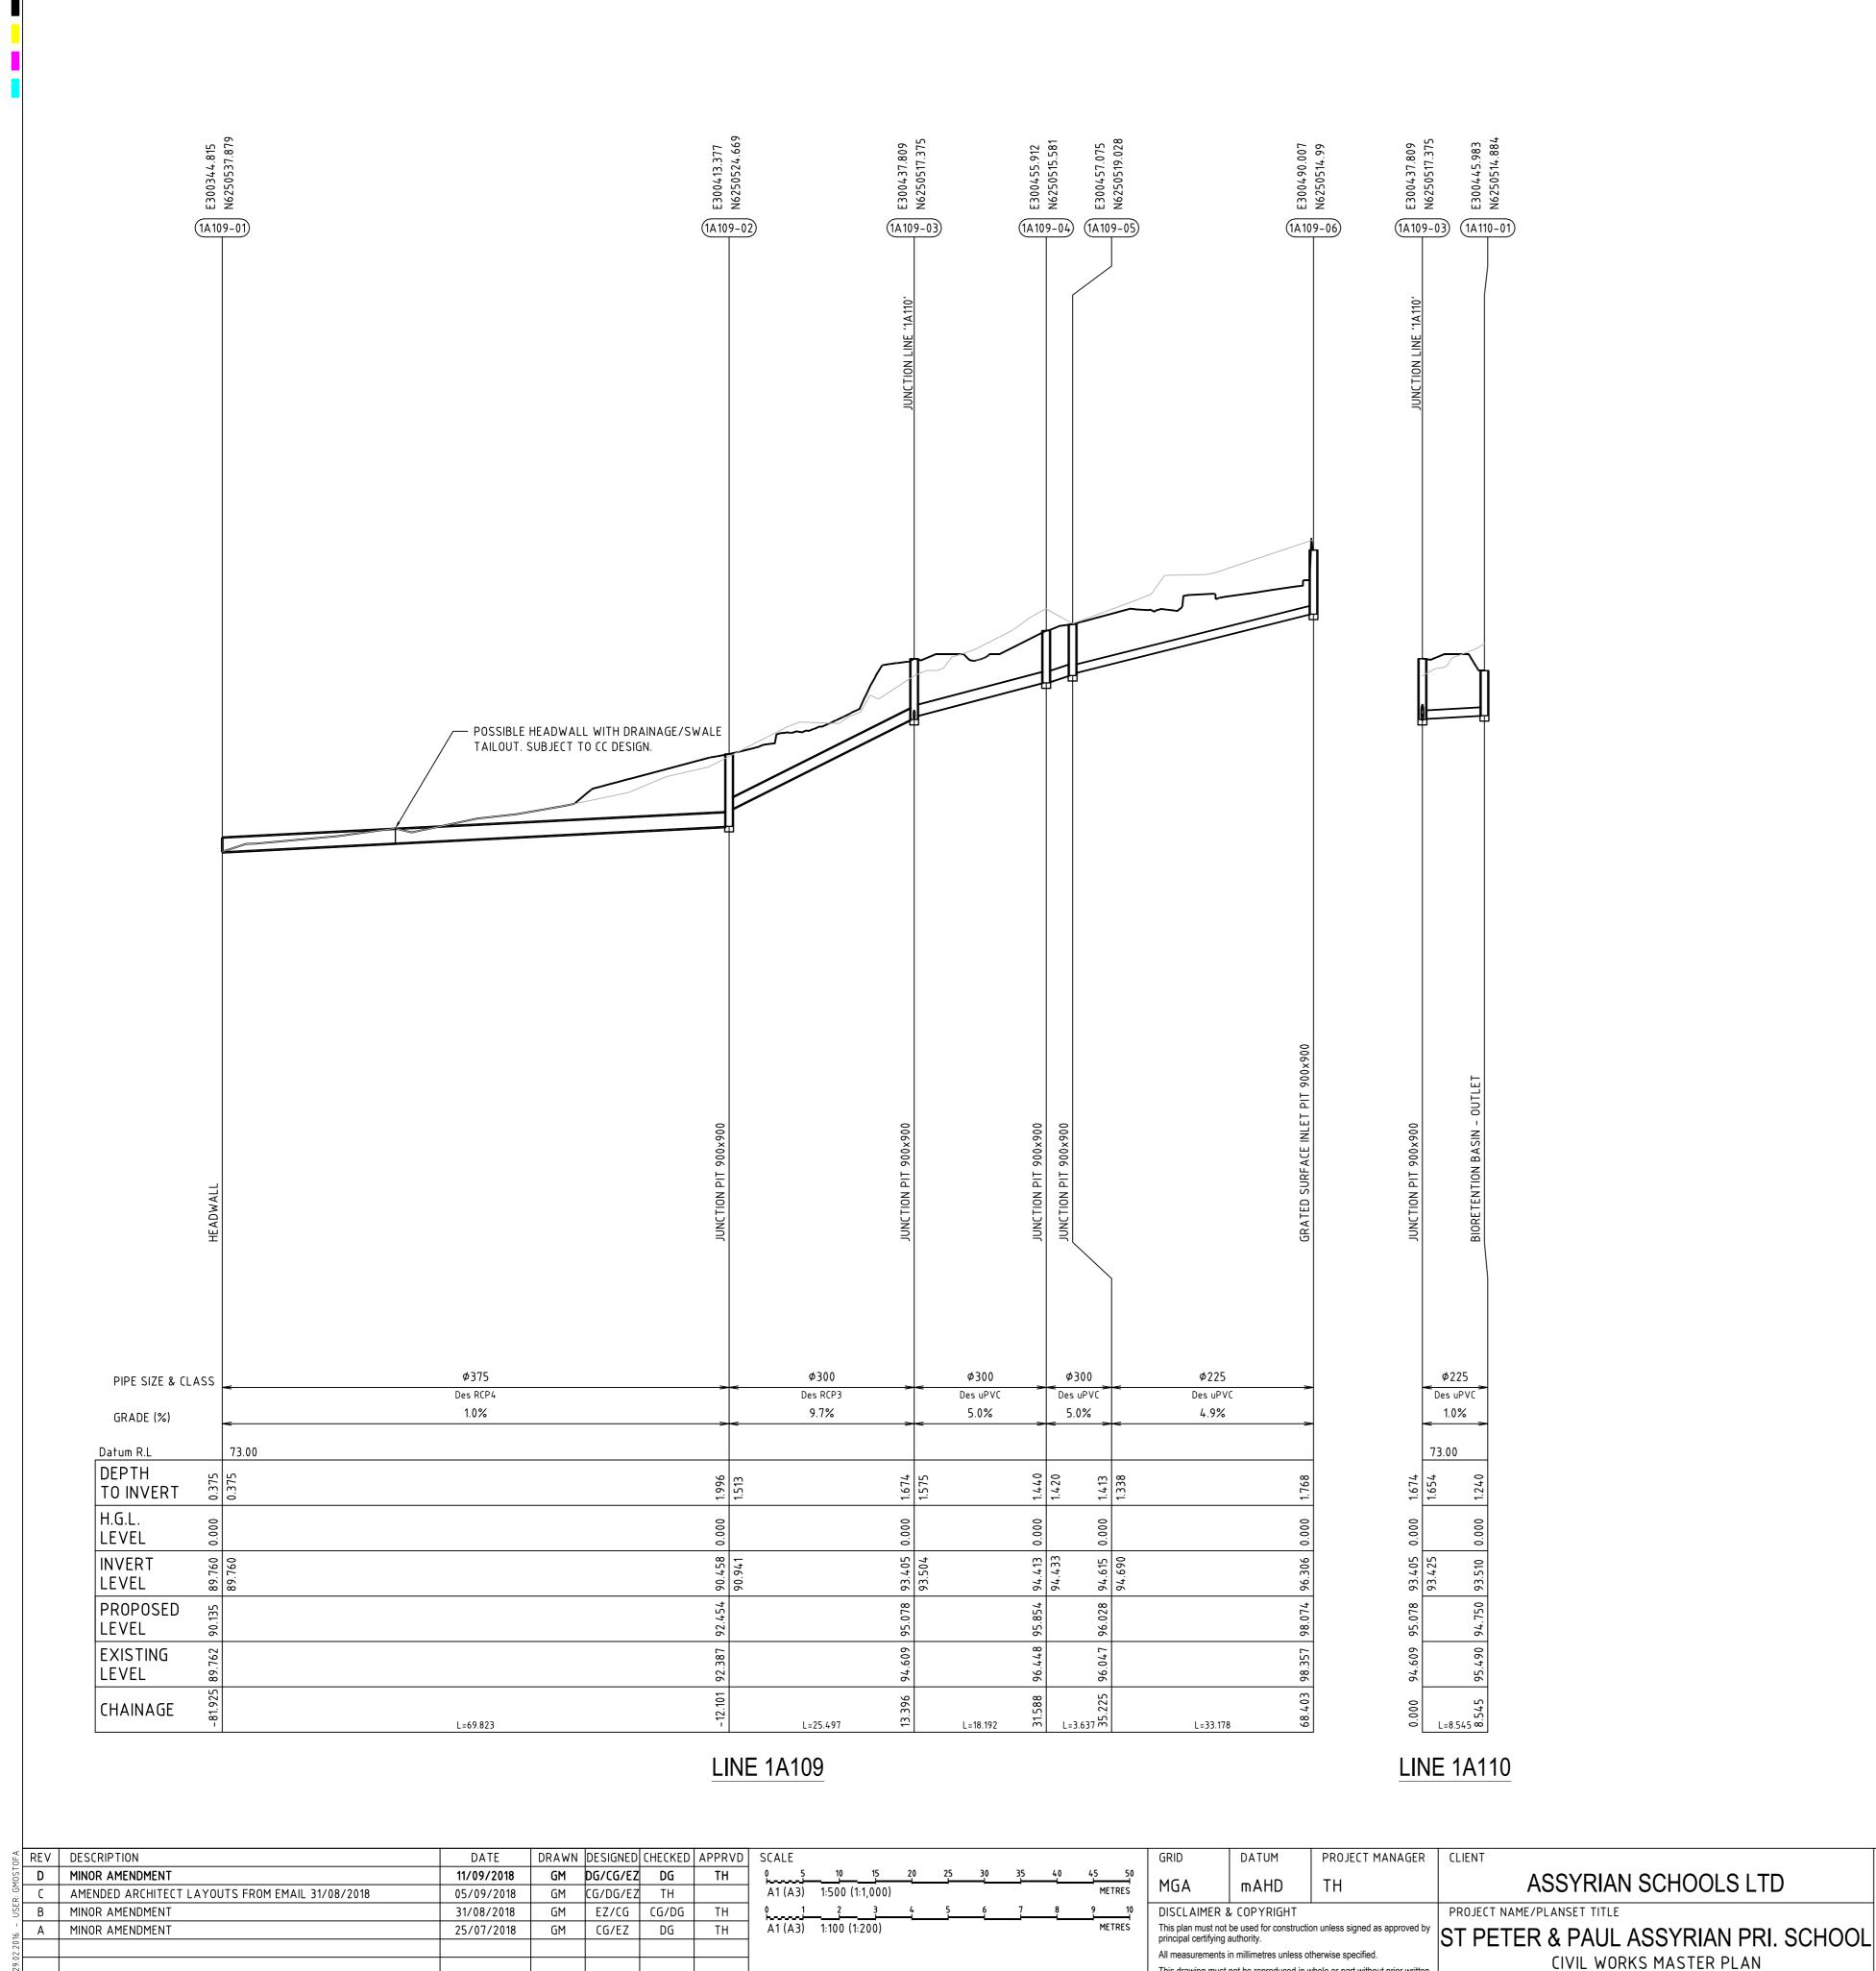A1 / A3 LANDSCAPE (A1LC\_v02.0.01)

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	DRAIN	IAGE LONGITI	UDINAL SEC <sup>-</sup>	FIONS (SHEET 2)	
	PROJECT NO.	PLANSET NO.	RELEASE NO.	DRAWING NO.	REVISION
'67	P1705798	PS03	R05	PS03-E301	D
	DRAWING ID: P1705798-PS03-R05-E3	01 01111	20 30 4	0 50 60 70	80 90 100

			PI	Γ SCHED	ULE							
Pit				INTERNAL		INLET		OUTLET		PIT		
Name	TYPE	EASTING	NORTHING	WD	LEN	DIA	INV LEV	DIA	INV LEV	SETOUT RL	DEPTH	REMARKS
1A101-02	OSD TANK - OUTLET	300418.644	6250394.782	0	0	-	-	150	92.883	93.033	0.15	
1A101-01	HEADWALL	300408.713	6250392.45	0	0	150	92.781	-	-	92.931	0.15	setout level to maximum pipe obvert
1A102-02	BIORETENTION BASIN - OUTLET	300426.674	6250388.502	0.6	0.6	_	-	300	93.86	94.56	0.7	
1A102-01	OSD TANK - INLET	300425.845	6250388.62	0	0	300	93.836	-	-	94.855	1.019	
1A103-05	GRATED SURFACE INLET PIT 600x600	300431.12	6250463.697	0.6	0.6	-	-	300	95.384	96.1	0.716	
1A103-04	GRATED SURFACE INLET PIT 900x900	300426.842	6250433.714	0.9	0.9	300	95.082	300	95.062	96.1	1.038	
1A103-03	JUNCTION PIT 900x900	300430.418	6250414.265	0.9	0.9	300	94.864	300	94.844	96.1	1.256	
1A103-02	GRATED SURFACE INLET PIT 600x600	300429.451	6250407.476	0.6	0.6	300	94.745	300	94.725	95.685	0.96	
1A103-01	HEADWALL	300428.081	6250397.864	0	0	300	94.628	-	-	94.928	0.3	setout level to maximum pipe obvert
1A104-03	KERB INLET PIT - GRATE & 1.8m LINTEL - ON GRADE	300465.862	6250444.508	0.9	0.9	=	=	225	96.587	97.448	0.861	xy setout to setout string
1A104-02	KERB INLET PIT - GRATE & 1.8m LINTEL - ON GRADE	300461.145	6250411.45	0.9	0.9	225	95.818	225	95.798	96.663	0.865	xy setout to setout string
1A104-01	GRATED SURFACE INLET PIT 600x600	300457.368	6250403.602	0.6	0.6	225	95.711	225	95.691	96.545	0.854	
1A103-02	GRATED SURFACE INLET PIT 600x600	300429.451	6250407.476	0.6	0.6	225	95.118	-	-	95.685	0.96	
1A105-04	GRATED SURFACE INLET PIT 600x600	300466.885	6250496.423	0.6	0.6	-	-	150	96.241	96.391	0.15	setout level to maximum pipe obvert
1A105-03	GRATED SURFACE INLET PIT 900x900	300468.567	6250501.621	0.9	0.9	150	96.187	225	95.941	97.292	1.351	
1A105-02	GRATED SURFACE INLET PIT 900x900	300460.126	6250506.209	0.9	0.9	225	94.873	225	94.853	96.015	1.163	
1A105-01	OSD TANK - INLET	300458.723	6250507.02	0	0	225	94.836	-	-	96.02	1.184	
1A106-02	OSD TANK - OUTLET	300453.927	6250509.296	0	0	-	-	150	94.29	95.816	1.526	
1A106-01	HEADWALL	300446.305	6250510.321	0	0	150	94.213	-	-	94.363	0.15	setout level to maximum pipe obvert
1A107-04	GRATED SURFACE INLET PIT 600x600	300417.548	6250480.14	0.6	0.6	_	_	225	94.263	94.9	0.637	
1A107-03	JUNCTION PIT 600x600	300401.704	6250484.758	0.6	0.6	225	94.098	300	94.1	94.9	0.8	
1A107-02	GRATED SURFACE INLET PIT 600x600	300399.704	6250508.902	0.6	0.6	300	93.858	300	93.838	94.9	1.062	
1A107-01	OSD TANK - INLET	300401.032	6250510.408	0	0	300	93.818	-	-	94.9	1.082	
1A108-02	OSD TANK - OUTLET	300409.435	6250511.561	0	0	-	-	375	93.4	94.9	1.5	
1A108-01	HEADWALL	300410.675	6250520.211	0	0	375	93.313	-	-	93.688	0.375	setout level to maximum pipe obvert
1A109-06	GRATED SURFACE INLET PIT 900x900	300490.007	6250514.99	0.9	0.9	_	_	225	96.306	98.074	1.768	
1A109-05	JUNCTION PIT 900x900	300457.075	6250519.028	0.9	0.9	225	94.69	300	94.615	96.028	1.413	
1A109-04	JUNCTION PIT 900x900	300455.912	6250515.581	0.9	0.9	300	94.433	300	94.413	95.854	1.44	
1A109-03	JUNCTION PIT 900x900	300437.809	6250517.375	0.9	0.9	300	93.504	300	93.405	95.078	1.674	
1A109-02	JUNCTION PIT 900x900	300413.377	6250524.669	0.9	0.9	300	90.941	375	90.458	92.454	1.996	
1A109-01	HEADWALL	300344.815	6250537.879	0	0	375	89.76	-	-	90.135	0.375	setout level to maximum pipe obvert
1A110-01	BIORETENTION BASIN - OUTLET	300445.983	6250514.884	0.9	0.9	-	-	225	93.51	94.75	1.24	

PROJECT MANAGER | CLIENT

PROJECT NAME/PLANSET TITLE

mAHD

All measurements in millimetres unless otherwise specified.

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DISCLAIMER & COPYRIGHT

DRAWN DESIGNED CHECKED APPRVD SCALE

A1 (A3) 1:500 (1:1,000)

0 1 2 3 4 5 6 A1 (A3) 1:100 (1:200)

GM DG/CG/EZ DG

GM CG/DG/EZ TH

GM EZ/CG CG/DG

GM CG/EZ DG

11/09/2018

05/09/2018

31/08/2018

25/07/2018

1A109-03

JUNCTION PIT 900x900

STATE SIGNIFICANT DEVELOPMENT APPLICATION

ASSYRIAN SCHOOLS LTD martens ST PETER & PAUL ASSYRIAN PRI. SCHOOL CIVIL WORKS MASTER PLAN 17 & 19 KOSOVICH PLACE, CECIL PARK, NSW LOTS 2320 & 2321, DP 1223167

225 93.425 - - 95.078 1.674

Consulting Engineers

DRAINAGE PIT SCHEDULE PLANSET NO. RELEASE NO. DRAWING NO.

REVISION

PROJECT NO. Suite 201, 20 George St, Hornsby, NSW 2077 Australia Phone: (02) 9476 9999 Fax: (02) 9476 8767 Email: mail@martens.com.au Internet: www.martens.com.au 

A1 / A3 LANDSCAPE (A1LC\_v02.0.01)

REV DESCRIPTION

D MINOR AMENDMENT

B MINOR AMENDMENT

A MINOR AMENDMENT

AMENDED ARCHITECT LAYOUTS FROM EMAIL 31/08/2018

<sup>1.</sup> XY SETOUT TO PIT CENTRE


<sup>2.</sup> SETOUT LEVEL TO PIT COVER LEVEL

<sup>3.</sup> SOME SETOUT XY OR Z LEVELS HAVE SPECIAL SETOUT DATA. SEE INDIVIDUAL MANHOLE REMARKS

POST-DEVELOPMENT CATCHMENTS PLAN

DRAINS RE	SULTS		REQUIREMENT									
STORM EVENT	CRITICAL STORM	PEAK FLOW	PERMISSIBLE SITE DISCHARGE (L/S/HA)	SITE AREA TO OSD (HA)	PERMISSIBLE SITE DISCHARGE (L/S)	REFERENCE						
(YEAR ARI)	DURATION (HRS)	RATES (L/S)										
5	1	72	78	0.937	73.09	FAIRFIELD CITY COUNCIL STORMWATER MANAGEMENT POLICY 2017						
100	1	73	78	0.937	73.09	FAIRFIELD CITY COUNCIL STORMWATER MANAGEMENT POLICY 2017						
NOTE: OSD PROVIDED	IOTE: OSD PROVIDED FOR DEVELOPED IMPERVIOUS AREA ONLY											

	POST DEVELOPMENT CATCHMENT (P1705798DRN03V04)										
Key DRAINS CAT. DESCRIPTION AREA (HA) % PAVED To PAVED (min) To GRASS (min											
1AD01 1AD02		AREA TO OSD 1	0.697	95	5	12					
		AREA TO OSD 2	0.151	71	5	9					
	1AD03	AREA TO OSD 3	0.088	92	5	5					
		SITE AREA	0.937	100	= % OF OVERALL AREA						
		TOTAL IMPERVIOUS AREA	0.848	91	= % OF OVERALL AREA						
		TOTAL PERVIOUS AREA	0.088	9	= % OF OVERALL AREA						

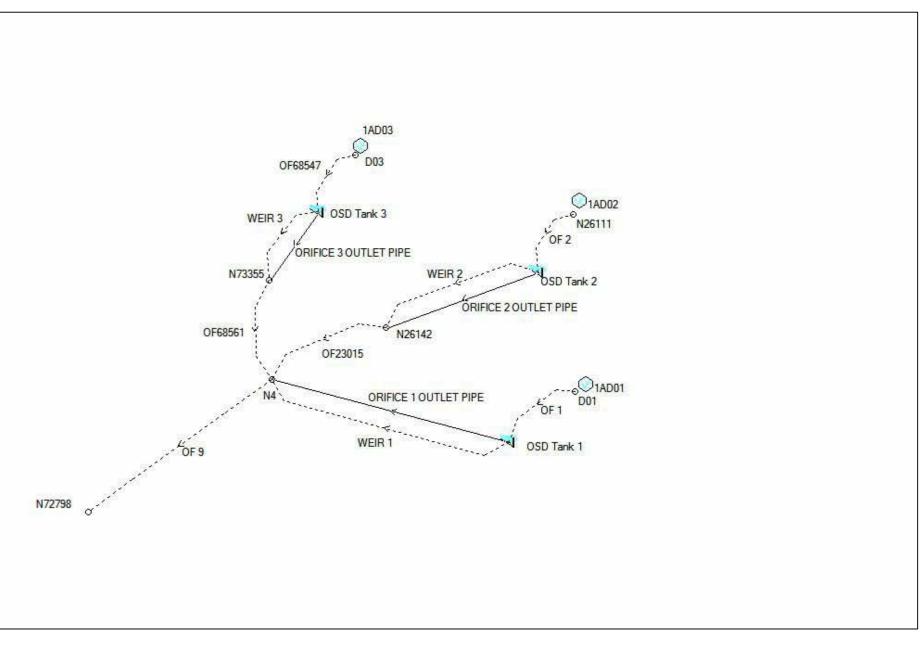

POST-DEVELOPMENT DRAINS MODEL LAYOUT

REV	DESCRIPTION	DATE	DRAW	N DESIGNED	CHECKED	APPRVD	/D SCALE GRID DATUM PROJECT MANAGER CLIENT	
A E	MINOR AMENDMENT	11/09/2018	GM	DG/CG/EZ	DG	TH	1 1 1 1 1 1 1 1 1 1 1 1 1 1 1 1 1 1 1	ı
D D	AMENDED ARCHITECT LAYOUTS FROM EMAIL 31/08/2018	05/09/2018	GM	CG/DG/EZ	TH		A1 (A3) 1:1,000 (1:2,000)  METRES MICH INARD IN	1
E C	MINOR AMENDMENT	31/08/2018	GM	EZ/CG	CG/DG	TH	DISCLAIMER & COPYRIGHT PROJECT NAME/PLANSET TITLE	
B B	MINOR AMENDMENT	25/07/2018	GM	CG/EZ	DG	TH	This plan must not be used for construction unless signed as approved by principal certifying authority.  ST PETER & PAUL ASSYRIAN PRI. SCHOOL	
. A	INITIAL RELEASE	06/07/2018	GM	CG/EZ			All macquirements in millimetres unless atherwise enseitled	
							This drawing must not be reproduced in whole or part without prior written  CIVIL WORKS MASTER PLAN	1
ä						1	concent of Martons & Accepiates Dty Ltd	Suite
PRIN							(C) Copyright Martens & Associates Pty Ltd LOTS 2320 & 2321, DP 1223167	Juile
A1 / A3	B LANDSCAPE (A1LC_v02.0.01)					1		

STATE SIGNIFICANT DEVELOPMENT APPLICATION Consulting Engineers martens

OSD CATCHMENT PLAN, MODEL AND RESULTS PLANSET NO. RELEASE NO. DRAWING NO. REVISION uite 201, 20 George St, Hornsby, NSW 2077 Australia Phone: (02) 9476 9999 Fax: (02) 9476 8767 Email: mail@martens.com.au Internet: www.martens.com.au PS03-E600 


POST-DEVELOPMENT WATER QUALITY CATCHMENTS PLAN

# PRE-DEVELOPMENT WATER QUALITY CATCHMENTS PLAN

SCALE 1:1000

MUSIC CATCHMENTS (P1705798MUS02V02)											
	PRE DEVELOPMENT										
KEY	DESCRIPTION	MUSIC NODE ID	AREA (ha)	IMPERVIOUS %	MUSIC NODE REFERENCE						
	AGRICULTURAL	1B01	2.936	13	FAIRFIELD CITY COUNCIL STORMWATER MANAGEMENT POLICY 2017						
TOTAL SITE											
TOTAL - OVERAL	L			2.936	= 100 % OF OVERALL AREA						
TOTAL - IMPERVI	ous .			0.381 = 13 % OF OVERALL AREA							
TOTAL - PERVIOL	JS			2.555	= 87 % OF OVERALL AREA						
NOTES:				•							
1. AGRICULTURAL	NODE IS USED TO MODEL	THE PRE-DEVELOPM	ENT CONDITION	N IN ACCORDANCE W	/ITH GSLLS NSW MUSIC MODELLING GUIDELINES 2015.						

MUSIC MODELLING RESULTS (P1705798MUS02V02)									
PARAMETER	PRE-DEVELOPMENT	POST-DEVELOPMENT	% CHANGE						
Total Suspended Solids (kg/yr)	965	622	-35.54%						
Total Phosphorus (kg/yr)	4.04	1.77	-56.19%						
Total Nitrogen (kg/yr)	20.9	16	-23.44%						

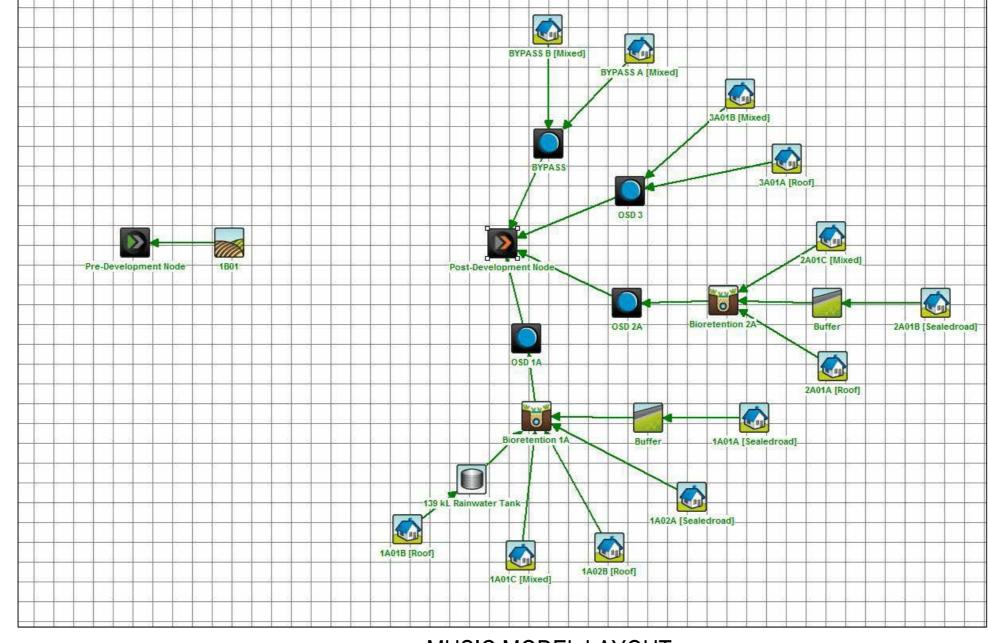

MUSIC	MODEL	LAYOUI

		VIOOIO O/ (		<u> </u>	5798MUS02V02)
			POST	DEVELOPMEN	Т
KEY	DESCRIPTION	MUSIC NODE ID	AREA (ha)	IMPERVIOUS %	MUSIC NODE REFERENCE
	ROAD TO BIO 1A	1A 01A	0.132	76	FAIRFIELD CITY COUNCIL STORMWATER MANAGEMENT POLICY 201
	ROAD TO BIO 1A	1A02A	0.177	92	FAIRFIELD CITY COUNCIL STORMWATER MANAGEMENT POLICY 201
<u> </u>	ROOF TO RWT	1A 01B	0.22	100	FAIRFIELD CITY COUNCIL STORMWATER MANAGEMENT POLICY 201
	ROOF BYPASSING RWT	1A02B	0.108	100	FAIRFIELD CITY COUNCIL STORMWATER MANAGEMENT POLICY 201
	GROUND TO BIO 1C	1A 01C	0.06	100	FAIRFIELD CITY COUNCIL STORMWATER MANAGEMENT POLICY 201
0000	ROOF TO BIO 2A	2A01A	0.049	100	FAIRFIELD CITY COUNCIL STORMWATER MANAGEMENT POLICY 201
	ROAD TO BIO 2A	2A01B	0.048	100	FAIRFIELD CITY COUNCIL STORMWATER MANAGEMENT POLICY 201
	GROUND TO BIO 2A	2A01C	0.082	10	FAIRFIELD CITY COUNCIL STORMWATER MANAGEMENT POLICY 201
	ROOF BYPASSING TREATMENT	3A01A	0.052	100	FAIRFIELD CITY COUNCIL STORMWATER MANAGEMENT POLICY 201
	GROUND TO BIO 3A	3A01B	0.047	100	FAIRFIELD CITY COUNCIL STORMWATER MANAGEMENT POLICY 201
7	GROUND BYPASSING	BYPASS A	0.065	0	FAIRFIELD CITY COUNCIL STORMWATER MANAGEMENT POLICY 201
	GROUND BYPASSING	BYPASS B	1.895	3	FAIRFIELD CITY COUNCIL STORMWATER MANAGEMENT POLICY 201
TOTAL SITE		,	•		
TOTAL - OVERAL	_L			2.936	= 100 % OF OVERALL AREA
TOTAL - IMPERV	IOUS			0.903	= 31 % OF OVERALL AREA
TOTAL - PERVIO	US			2.032	= 69 % OF OVERALL AREA
NOTES:				ı	1
1. RAINWATER FR	ROM 2200M2 ROOF AREAS W	ILL BE DIRECTED TO	) A 139 KI RAI	NWATER TANK FOR	REUSE.

# STATE SIGNIFICANT DEVELOPMENT APPLICATION FRAWING TITLE

	REV	DESCRIPTION	DATE	DRAWN	DESIGNED	CHECKED	APPRVD	SCALE GRID DATUM P	PROJECT M
)FA	Ε	MINOR AMENDMENT	11/09/2018	GM	DG/CG/EZ	DG	TH	0 10 20 30 40 50 60 70 80 90 100 MCA	TU
OST(	D	AMENDED ARCHITECT LAYOUTS FROM EMAIL 31/08/2018	05/09/2018	GM	CG/DG/EZ	TH		A1 (A3) 1:1,000 (1:2,000) METRES MGA MAHD	TH
:: GM	U	MINOR AMENDMENT	31/08/2018	GM	EZ/CG	CG/DG	TH	DISCLAIMER & COPYRIGHT	
USEF	В	MINOR AMENDMENT	25/07/2018	GM	CG/EZ	DG	TH	This plan must not be used for construction ur principal certifying authority.	inless signed as
1	Α	INITIAL RELEASE	06/07/2018	GM	CG/EZ			All measurements in millimetres unless otherv	wise specified
-								This drawing must not be reproduced in whole	
JTED								consent of Martens & Associates Pty Ltd.	
PRI								(C) Copyright Martens & Associates	Pty Ltd

GRID	DATUM	PROJECT MANAGER	CLIENT
MGA	mAHD	TH	ASSYRIAN SCHOOLS LTD
DISCLAIMER & COPYRIGHT			PROJECT NAME/PLANSET TITLE

vise specified. CIVIL WORKS MASTER PLAN or part without prior written 17 & 19 KOSOVICH PLACE, CECIL PARK, NSW LOTS 2320 & 2321, DP 1223167

L	martens & Associates Pty Ltd	Consulting Engineers Environment Water Geotechnical	WATER QUALITY CATCHMENT PLAN, MODEL AND RESULTS					
		Civil	PROJECT NO.	PLANSET NO.	RELEASE NO.	DRAWING NO.	REVISION	
	Suite 201, 20 George St, Hornsby, NSW 2077 Australia Ph Email: mail@martens.com.au Internet:		P1705798	PS03	R05	PS03-E700	Е	

DRAWING ID: P1705798-PS03-R05-E700

