


bekker engineering design buro pty limited

abn 79 159 165 563

po box 591, northbridge, nsw 1560 suite 1/6-7 gurrigal st, Mosman 2088 telephone 02 9960 6944 facsimile 02 9960 6911 email address bekker@spin.net.au

Project No.: 63407 March 15, 2018

STRUCTURAL CONCEPT PROPOSAL

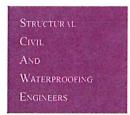

FOR

MAJOR ALTERATIONS AND ADDITIONS STEVENSON LIBRARY UPGRADE

SSD 8922

THE SCOTS COLLEGE

29-53 VICTORIA ROAD BELLEVUE HILL

MARCH 15, 2018

This document has been prepared as part of the submission to Department of Planning for Consent Approval and does not form part of the Approved For Construction documentation



CONTENTS

- 1- Structural concept proposal
- 2- Survey Details
- **3- Proposed works**

1- Structural Concept Proposal



Project No.: 63407

March 10, 2018

STRUCTURAL CONCEPT PROPOSAL STEVENSON LIBRARY SCOTS COLLEGE 29-53 VICTORIA ROAD BELLEVUE HILL

Project Description:

The Scots College are preparing a submission to the Department of Planning for proposed works major alterations and additions to the Stevenson Library.

In support of the submission it is required to provide a Structural Concept Proposal to confirm new shoring requirements and construction work to interface between the new and the existing buildings.

Site Description:

The Scots College School site where the Stevenson Library is located lies to the east of Victoria Rd, the north of Cranbrook Rd and on the western side of Cranbrook Lane. This portion of the school site has a total area of $44,730 \text{ m}^2$.

The site survey confirms the site area and that the site slopes approx. 2.2% from southwest to northeast of the site. The site contains the Middle School Building and Oval. The average ground level of the oval varies between RL54.9 and RL52.2.


Along Victoria Road on the western boundary the site has been excavated into a rocky outcrop with rock exposed at the ground surface.

Existing building:

The existing building is a solid 5 storey concrete framed building with concrete columns, beams and slabs. Each floor level carries the weight of the floor elements with no load bearing walls other than the stair shafts at the northern and southern ends of the building.

All of the Architectural features, which are non-structural are made of masonry.

The building contains a services element situated below ground, under the quadrangle, to the south of the main library building.

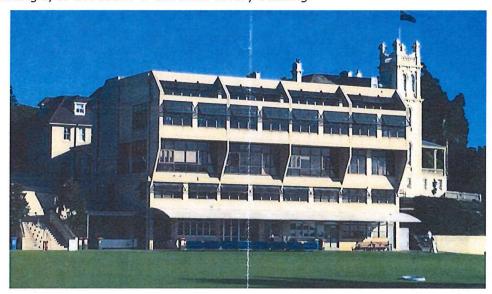

The existing current concrete framed building to be enveloped by the new building design

The School is in the process of obtaining the original drawings submitted to Woollahra Council for construction.

Proposed building:


The proposed building, while radically opposed in appearance to the existing, will enhance the appearance of the Scots College site by enveloping the existing building within the envelope of the new building.



The existing concrete framed building to be encapsulated by the new building design

The proposed building will extend the footprint of the building by around 1,500mm to the north and south and around 4,000mm to the east. The western side will only be extended in the location of new services and lift within the existing shaft. The services section below ground to the south will also be extended.


The additional new building area will add 1,642m² to the existing floor area

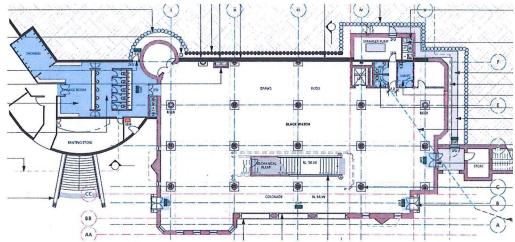

New building plan shows new piles for shoring, demolished plan area and new below ground toilets

As can be seen from the plan the western side of the existing building will require continuous concrete piles to support the ground behind the new services section requirements including lifts, toilets and sprinkler rooms

Atop the existing structure will be added a new concrete framed slab element suitable for the use as attic accommodation within the roof space

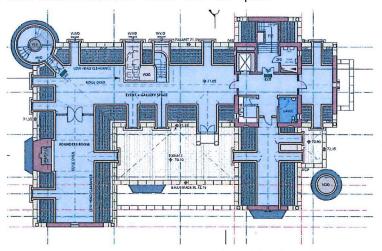


New roof slab with attic accommodation within the roof space

Construction elements

Shoring:

The site shoring for this project will be difficult for terrain and access. For the new Business Studies Centre, the School utilized the experience of a local piling contractor Pile & Bucket to install a shoring wall 10m high without tieback anchors.

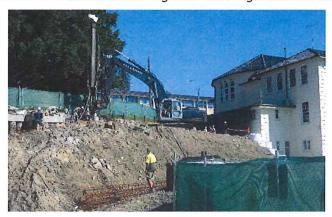

We could utilize a similar contractor to this time provide a Tied Back Contiguous Concrete Pile shoring wall in the locations shown in green on the new building plan above. These new piles will compliment the existing piles shown adjacent.

Demolition:

Naturally all demolition works will be compliant with the requirements of WorkCover and the Australian Standard AS2601 for Demolition Of Structures.

The demolition contract will not be extensive as the majority of the building remains intact with the removal of the facades when being enclosed by the new works outside the perimeter of the existing. At the rear where the loadbearing stair walls are to be demolished and the adjacent subsequently unsupported slab will require careful propping and demolition with small mechanical machines placed on the slabs to remain

Footings

All new load bearing walls or column frames will be supported on concrete footings or pads piled down to the bedrock. The new façade will be supported on footing beams piled to rock. This will replicate and complement the footing system of the existing building.


New Major Building Works

The new building will be similarly concrete framed with load bearing concrete walls and column and slab frames.

To match the support of the existing building the new bay of columns and slabs, facing the oval to the east, will be added with the building supported on piles taken to the rock below

Additionally, new columns and slabs will extend over the full footprint of the building atop the current roof providing access for attic accommodation within the new roof form plus access to rooftop services

The new façade will replicate a traditional Scottish Manor House with the façade built of traditional rendered stone and brickwork

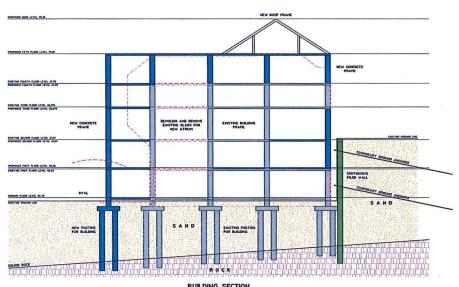


BUILDING SECTION
NEW BUILDING TO ENVELOPE EXISTING

New roof slab with attic accommodation built atop the existing structure with a new facade element to the eastern side facing the oval and a new services section to the west accessed by the installation of a new shoring wall from the existing courtyard level


Yours faithfully

Paul Bekker BE. M IEAust. CP Eng. M ACEA IPENZ BEKKER ENGINEFRING DESIGN BURO PTY LTD

2 - Survey Details

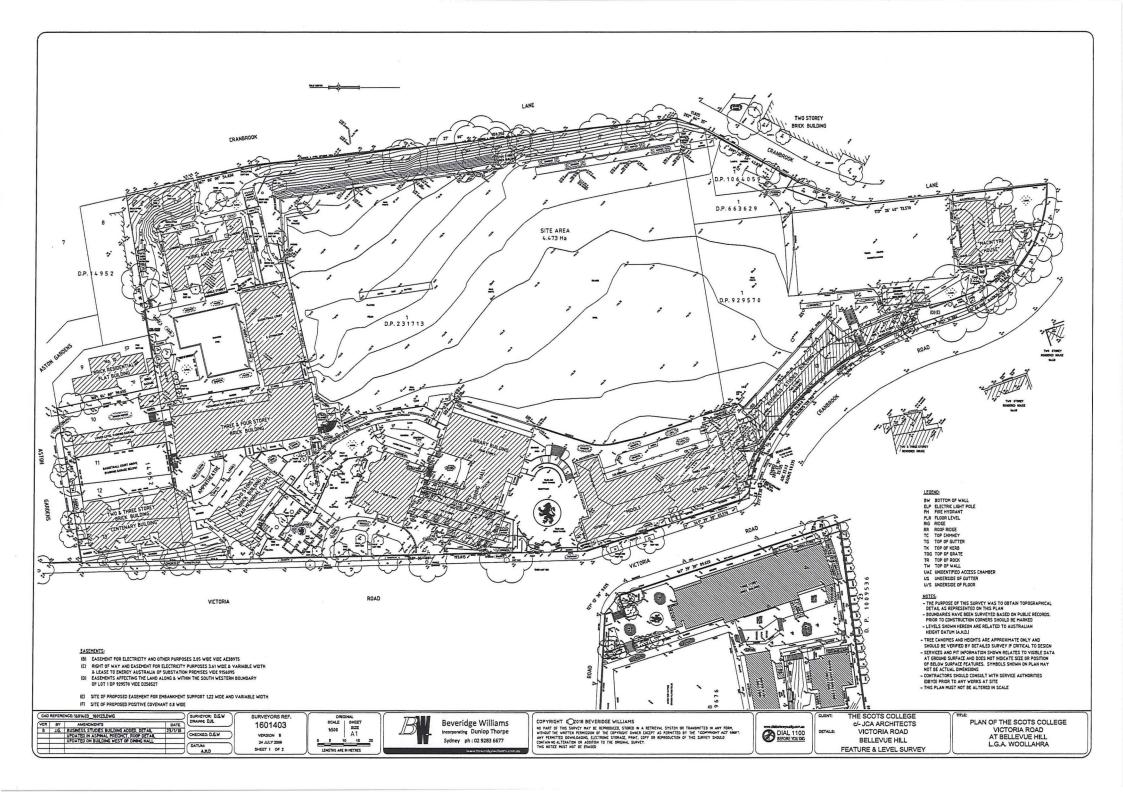

3 - Proposed works

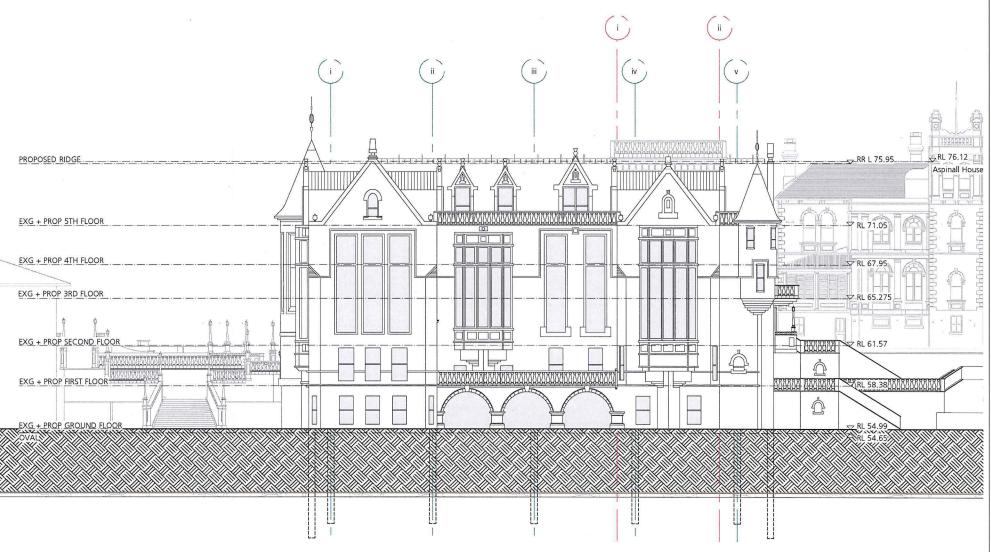

Proposed Eastern Elevation + Context Scale: 1:200

architects

Consult with ALL relevant authorit - (Main sating our holomoush from and high FRIBH to commercine)
- fining disappeaces in the ministration of the Architect.

I make all the special of the virials satisfaction from the Architect before processing.

- All this ways make to read in competition with the concell commons, special commons, special commons, special commons, special commons, special commons are suited by the Architect.

- The ministration which are projected by Copyright.

CONSULTANTS

THOS Quantity Surveyors

hiley Mac Fee Corsulturs



CLIENT STEVEN ADAMS THE SCOTS COLLEGE

PROJECT PROPOSED REFURBISHMENT OF THE STEVENSON LIBRARY ADDRESS

29-53 Victoria Rd Bellevue Hill, NSW

DRAWING TITLE

Proposed Elevation + Contex DRAWN BY JC, CF , JW

1:200 @ A3

REVISION P7

DATE FEBRUARY 2018

DRAWING NUMBER



SSD Proposed Northern Elevation Scale: 1:200



GENERAL NOTES

Congult with ALL relevant author - Construction All Industrial additional in the contracting works - 10 NOT scale. All demonstration in the contracting and in the contraction of site gas to economic the site gas to economic the additional to the contraction and sets of PROTE to construct - 10 status or large set demonstration - 10 status or large sets of set economic to set and the contraction - 10 status or large sets of - 10 status or large sets - 10 status - 10 status or large sets - 1

CONSULTANTS

PSI Stuctural Engineer



STEVEN ADAMS THE SCOTS COLLEGE

PROJECT PROPOSED REFURBISHMENT OF THE STEVENSON LIBRARY ADDRESS

29-53 Victoria Rd Believue Hill, NSW


DRAWING TITLE Proposed Northern Elevation

DRAWN BY JC, CF, JW

SCALE

REVISION P7

DATE FEBRUARY 2018 DRAWING NUMBER

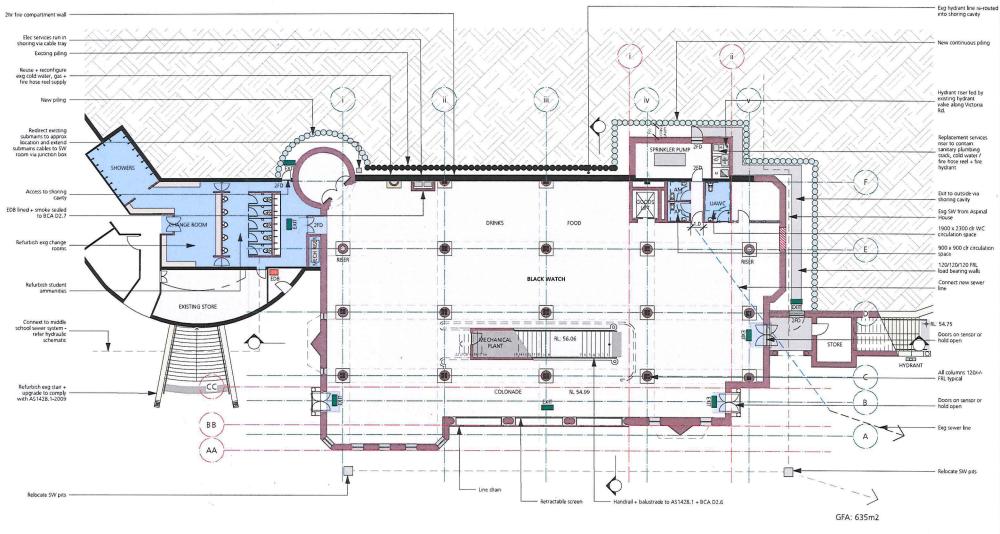

OVAL



LEGEND Exg floor area Entry matt Exg structure Wet area Additional floor area HYD Fire hyrdrant New masonry - 120/120/120 FRL 1FD 1hr fire door set construction of load bearing walls 2FD 2hr fire door set Render / Sandstone capping New concrete

architects Entrapiers on a Wipsethettona GENERAL NOTES

Consult with ALL relocant or Consult with ALL relocant our poor to community works.
 DO NOT code. All dimensions normal + should be curlimate price to commencement.
 Datain setting out information architect PRIOR to community. consest, specification, schedulic site notes + matricinens essed i

CONSULTANTS

Stry Mic Fre Cortofort





STEVEN ADAMS THE SCOTS COLLEGE

PROJECT PROPOSED REFURBISHMENT OF THE STEVENSON LIBRARY ADDRESS

29-53 Victoria Rd Bollevue Hill, NSW


DRAWING TITLE PROPOSED GROUND FLOOR PLAN

DRAWN BY JC, CF , JW SCALE

1:200 @ A3 ISSUE

PRELIMINARY REVISION

DATE FEBRUARY 2018 DRAWING NUMBER

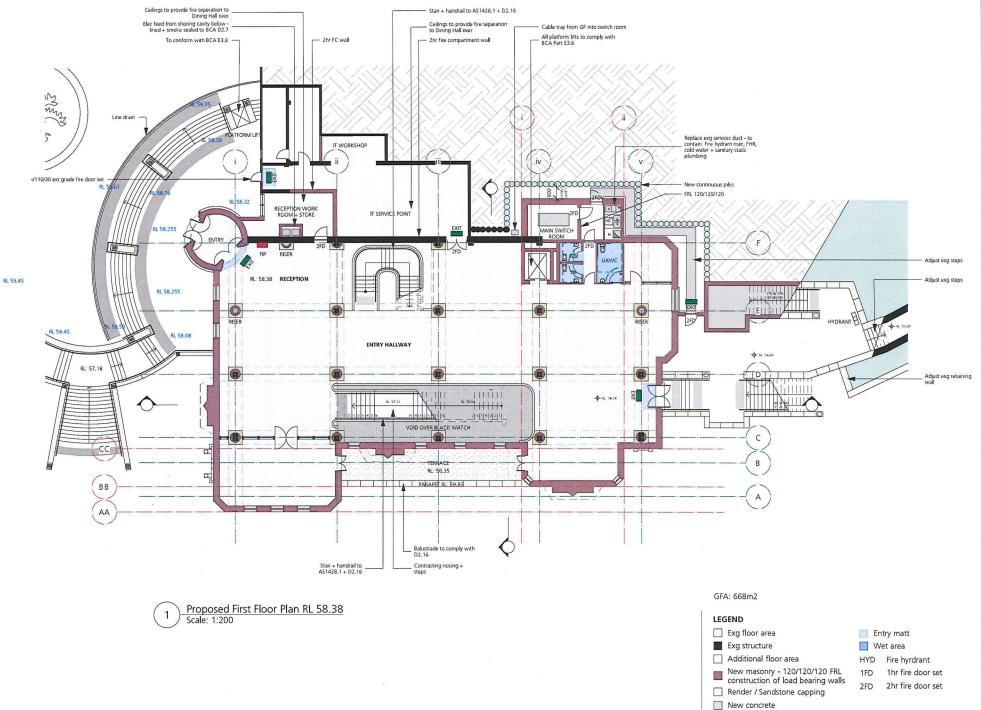

architects Entraphentiana Winachtencoma Winachtencoma GENERAL NOTES - Consult with ALL relevant aut

 Promotive with Act of the prior to commencing works
 OO NOT scale. All dimensions are extremal + should be continued on safe prior to commencement. Bring discrepancies to the immedial attention of the Archarct If uncure of any aspect of the work sock instruction from the Architect

belier proceeding

All discongresses be read in conjunction with the council consent, specification, schedules,

see notes • instructions exceed by the Architect • This material / work is protected by Copyright

CONSULTANTS

Holy Mac Fee Consultant





CLIENT STEVEN ADAMS THE SCOTS COLLEGE

PROJECT
PROPOSED REFURBISHMENT OF
THE STEVENSON LIBRARY
ADDRESS

29-53 Victoria Rd Bellevue Hill, NSW

DRAWING TITLE

PROPOSED FIRST FLOOR PLAN DRAWN BY JC, CF , JW


SCALE 1:200 @ A3

ISSUE


REVISION

DATE MARCH 2018

DRAWING NUMBER

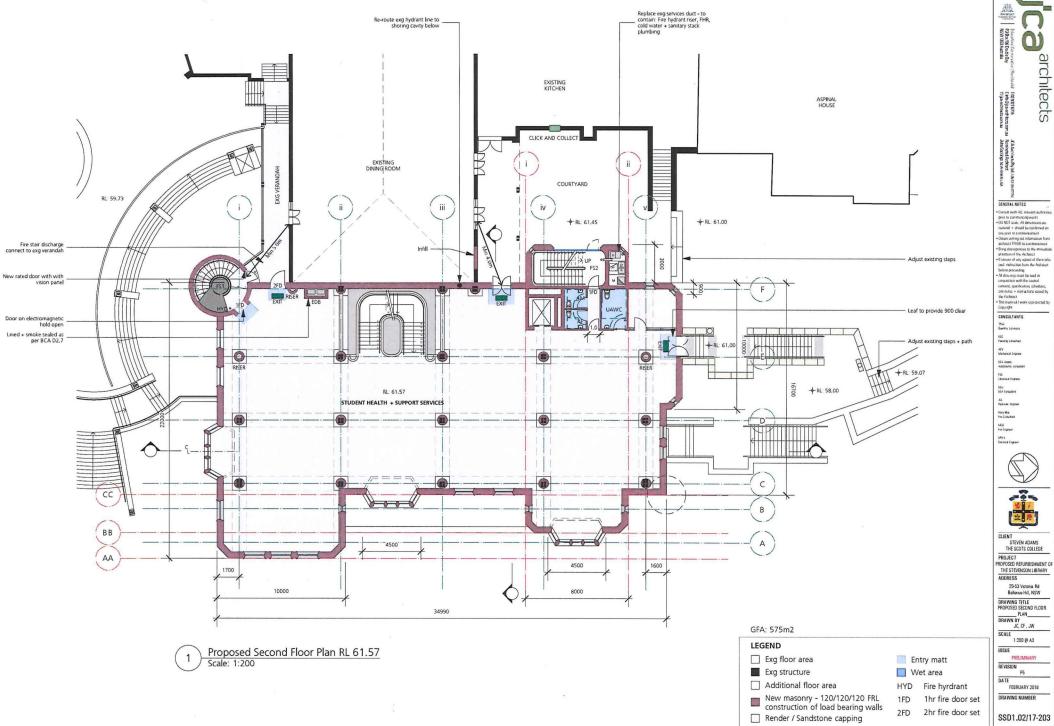

architects

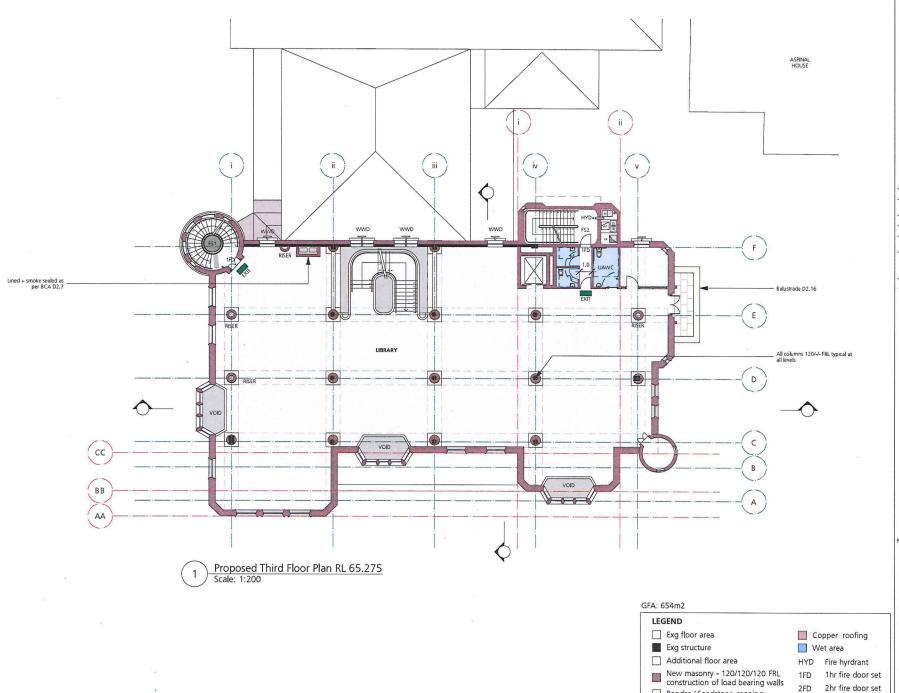



GENERAL NOTES

- Corout with ALL relevant authorise prior to currenerary works
- 50 NOT scale. All dimensionaire examinal + stoud be confirmed on still prior to corremonance.

- Oktain partition of statement of the prior to corremonance.

- Oktain partition of the statement of the prior to corresponding the statement of the

orthast PRIOR to commonreal Being disseagements to the minedial attention of the Architect Il means of any appet of the vicit-rial structures from the Architect below proceeding. "All dissinguisment to not on comparison with the council content, specification prohesion, and the facilities the facilities." It is not not to the Facilities? This manual works at protected by Copyright.

CONSULTANTS

kiny Mic In Constant





CLIENT
STEVEN ADAMS
THE SCOTS COLLEGE

PROJECT PROPOSED REFURBISHMENT OF THE STEVENSON LIBRARY ADDRESS

29-53 Victoria Rd Bellevue Hill, NSW

DRAWING TITLE PROPOSED THIRD FLOOR

DRAWN BY JC, CF, JW

1:200 @ A3


ISSUE

REVISION P5 DATE


FEBRUARY 2018 DRAWING NUMBER

SSD1.02/17-204

Render / Sandstone capping

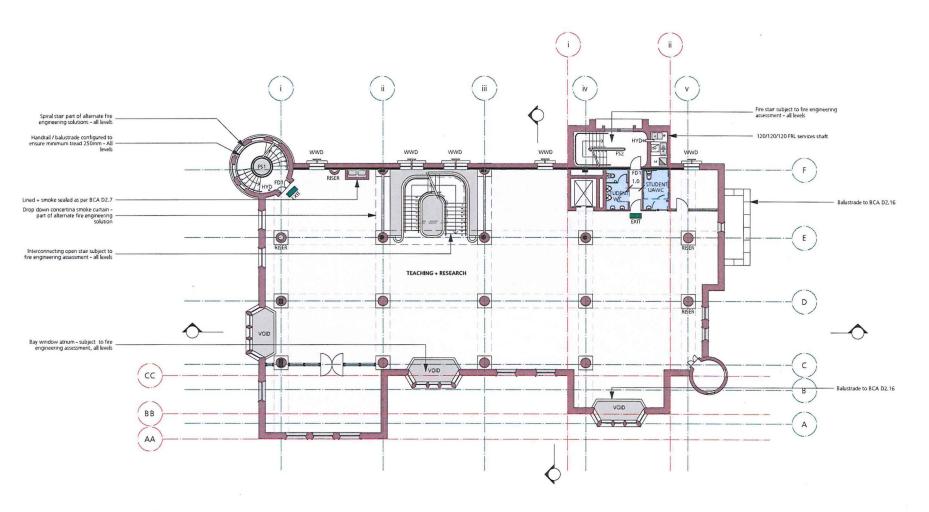

Proposed Fourth Floor Plan RL 67.95 Scale: 1:200

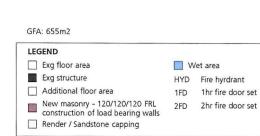

architects EAActivetsPylid /JNS118

Nonivated Architect
John Cockings NEW 4580 ES A44

GENERAL NOTES

GENERAL MOTES

Instant with All, induced subtracts
pare to commercing world

of to NOT scale. He demonstrates
remained a student of the parent of the Actioned as the student of the Actioned as the Act

CONSULTANTS

Hitey Mac Hea Consultant





STEVEN ADAMS THE SCOTS COLLEGE PROJECT

PROPOSED REFURBISHMENT OF THE STEVENSON LIBRARY ADDRESS

29-53 Victoria Rd Bellevue Hill, NSW

DRAWING TITLE


PROPOSED FOURTH FLOOR PLAN

DRAWN BY JC, CF, JW SCALE

1.200 @ A3 ISSUE

PRELIMINARY REVISION

DATE FEBRUARY 2018 DRAWING NUMBER

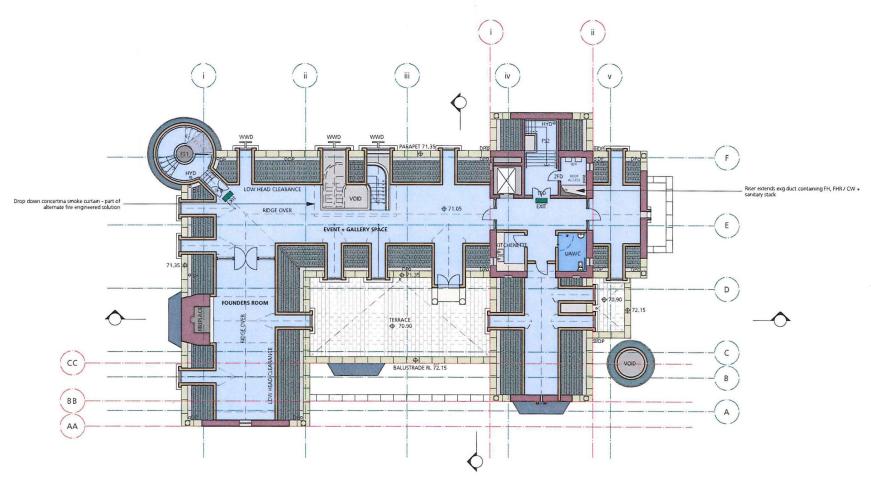

Proposed Fifth Floor Plan RL 71.05 Scale: 1:200





New masonry - 120/120/120 FRL construction of load bearing walls

Render / Sandstone capping

Welsh slate roof Roof leadwork

HYD Fire hyrdrant 1hr fire door set 1FD 2FD 2hr fire door set

GENERAL NOTES

CHAPSEAL MOTES

Checally with All, inhousing authorises para to contributing world.

For the CHAPSEAL CHAPSEAL

CONSULTANTS

havy the Fee Considers





STEVEN ADAMS THE SCOTS COLLEGE

PROJECT PROPOSED REFURBISHMENT OF THE STEVENSON LIBRARY ADDRESS

29-53 Victoria Rd Bollevue Hill, NSW

DRAWING TITLE PROPOSED FIFTH FLOOR PLAN


DRAWN BY JC, CF , JW

SCALE 1:200 @ A3

PRELIMINARY

REVISION P5

FEBRUARY 2018 DRAWING NUMBER

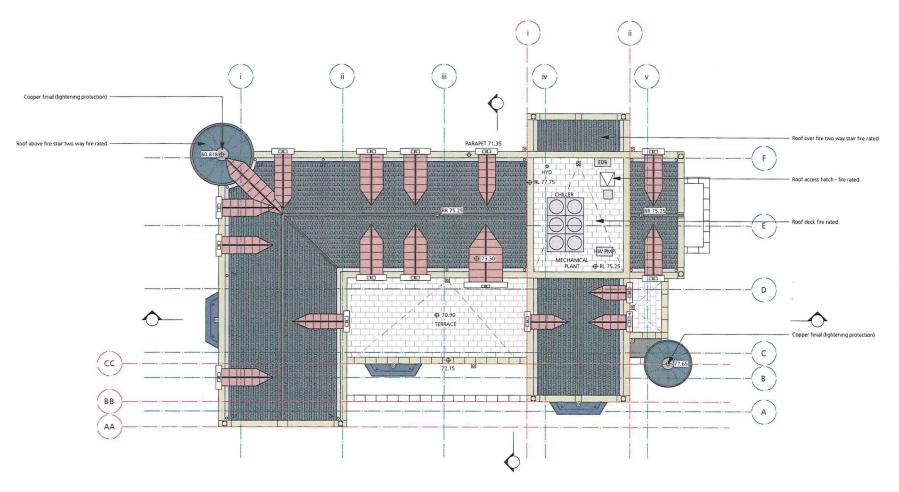

Proposed Roof Plan RL 75.25 Scale: 1:200



Welsh slate

Roof leadwork

Standing seam copper

☐ Sandstone capping □ Pavers

HYD Fire hyrdrant

CONTRAL ANOTE

CONTRAL WITH ALL Insteads authorises para to contracting white
FOR 10 Mill stake, Africa

FOR 10 Mill

CONSULTANTS

ADV Michael Engree BEA AGES Agestably Contained





STEVEN ADAMS THE SCOTS COLLEGE PROJECT

PROPOSED REFURBISHMENT OF THE STEVENSON LIBRARY ADDRESS

29-63 Victoria Rd Bellevue Hill, NSW

DRAWING TITLE

PROPOSED ROOF PLAN DRAWN BY JC, CF , JW

SCALE 1:200 @ A3

ISSUE

PRELIMINARY REVISION P5

DATE FEBRUARY 2018

DRAWING NUMBER SSD1.02/17-207