



Our Reference: NW160037  
Your Reference:

Unit 10, Level 1  
1 Maitland Place  
NORWEST NSW 2153

21 December 2021

PO Box 7760  
BAULKHAM HILLS NSW 1755

Ethos Urban  
173 Sussex Street  
SYDNEY QLD 2000

T 02 9634 6311  
F 02 9438 5398

Attention: Claire Burdett

ENGINEERS  
MANAGERS  
INFRASTRUCTURE  
PLANNERS  
DEVELOPMENT  
CONSULTANTS

Dear Claire

**Re: Costco Wholesale – Oakdale NSW  
Stage 2B Development Application Submission**

We write in reference to the proposed Stage 2B extension of the existing Costco warehouse at Ottelia Road, Oakdale.

The proposed building extension is slightly longer than that originally proposed in the Development Application for the current building under SSD 8209 MOD 2.

The bulk earthworks and retaining walls were constructed during the original Stage 1 works. The trunk stormwater pipes and water quality devices were also installed during the Stage 1 works in readiness for the stage 2B works.

The proposed site grading and stormwater drainage for the Stage 2B extension is as shown on the original civil Stage 1 development application drawings. Given that the detention and water quality basin was constructed off-site as part the overall subdivision stormwater treatment, the increase in building area does not materially change the stormwater outcomes from the original design.

The original Stage 1 Civil Development Application drawings and stormwater report is attached for reference.

Please contact the undersigned if you have any questions.

Yours faithfully,

**ACOR Consultants Pty Ltd**

A handwritten signature in blue ink, appearing to read 'Steven Wong'.

Steven Wong


Principal Civil Engineer BE(Hons), MEngSc, MIEAust, CPEng NER RPEQ

**Attachments:**

NW160037 – DAC1.01 – General Arrangement Plan  
NW160037 – DAC1.11 – Stormwater Catchment Plan  
NW160037 – DAC2.01 – Siteworks Plan – 1 of 6  
NW160037 – DAC2.02 – Siteworks Plan – 2 of 6  
NW160037 – DAC2.03 – Siteworks Plan – 3 of 6  
NW160037 – DAC2.04 – Siteworks Plan – 4 of 6  
NW160037 – DAC2.05 – Siteworks Plan – 5 of 6  
NW160037 – DAC2.06 – Siteworks Plan – 6 of 6  
NW160037 – DAC3.01 – Sitework Sections Sheet 1 of 2  
NW160037 – DAC3.02 – Sitework Sections Sheet 2 of 2  
NW160037 – DAC4.01 – Construction Staging Plan  
NW160037 – DAC6.01 – Bulk Earthworks Cut / Fill Plan  
NW160037 – DAC6.11 – Vehicle Turning Paths Plan  
NW160037 – DAC8.01 – Soil and Erosion Control Concept Plan, Notes and Details

Stormwater Management Plan



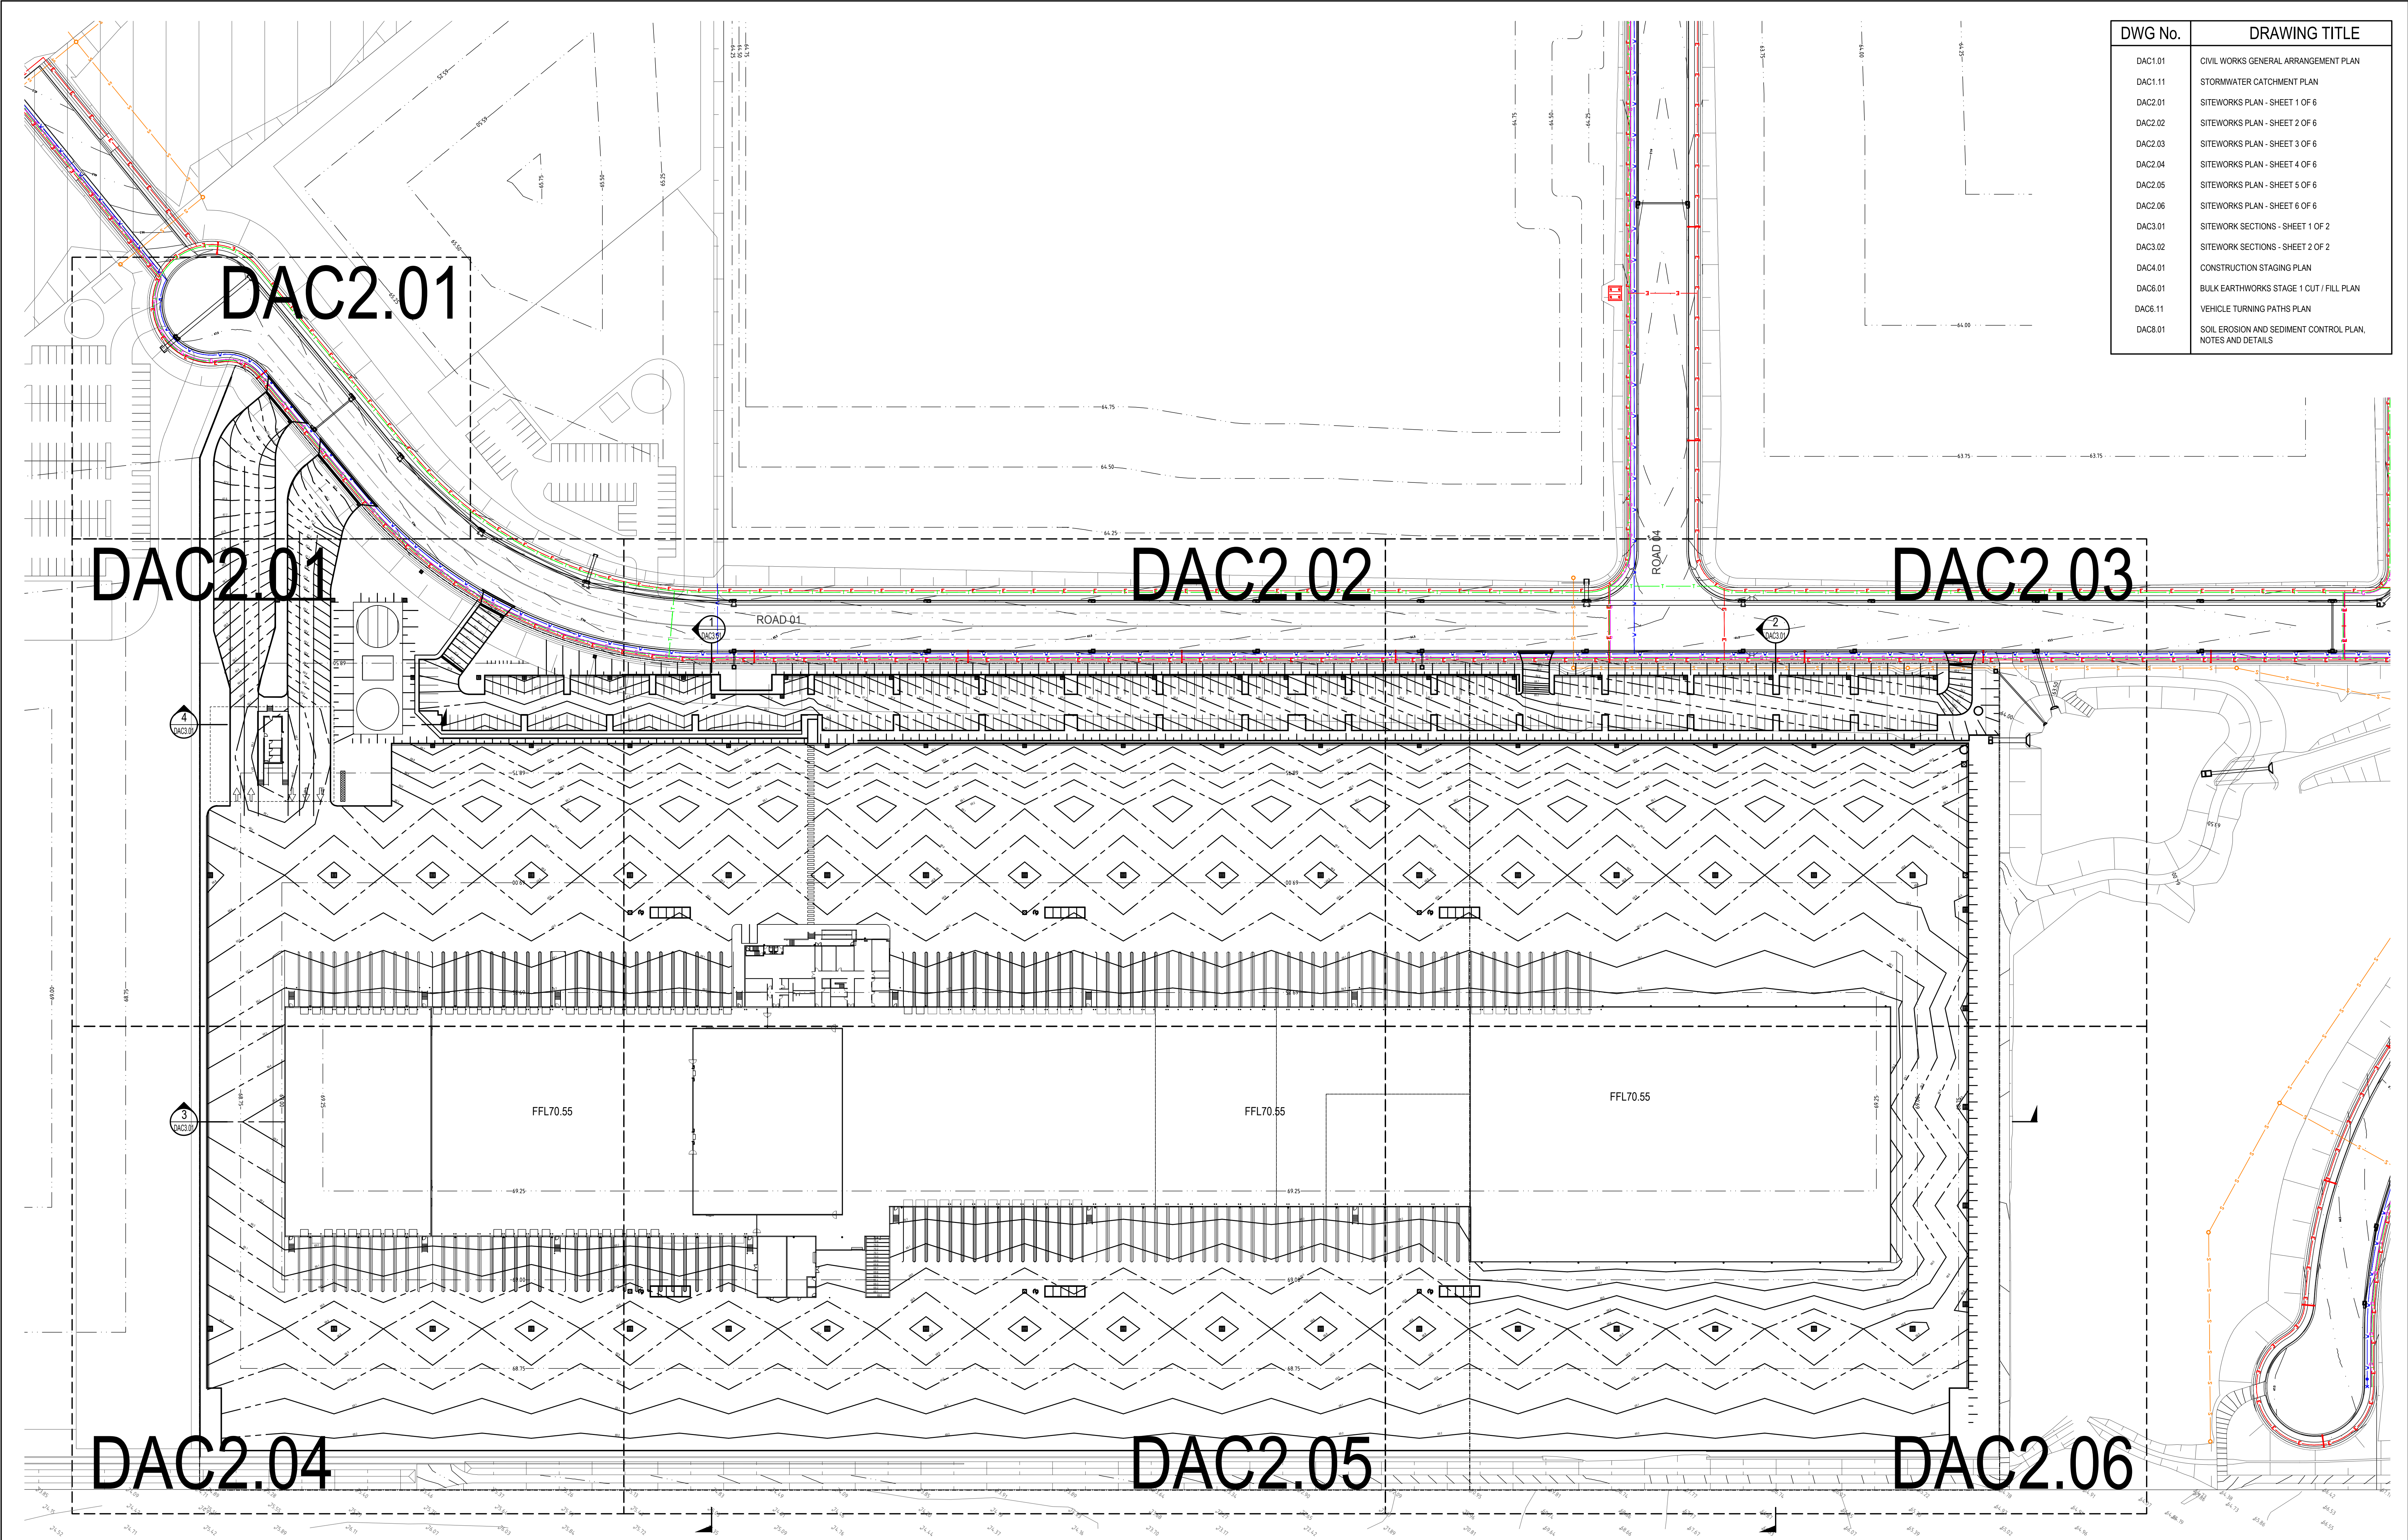


DWG No.	DRAWING TITLE
DAC1.01	CIVIL WORKS GENERAL ARRANGEMENT PLAN
DAC1.11	STORMWATER CATCHMENT PLAN
DAC2.01	SITEWORKS PLAN - SHEET 1 OF 6
DAC2.02	SITEWORKS PLAN - SHEET 2 OF 6
DAC2.03	SITEWORKS PLAN - SHEET 3 OF 6
DAC2.04	SITEWORKS PLAN - SHEET 4 OF 6
DAC2.05	SITEWORKS PLAN - SHEET 5 OF 6
DAC2.06	SITEWORKS PLAN - SHEET 6 OF 6
DAC3.01	SITEWORK SECTIONS - SHEET 1 OF 2
DAC3.02	SITEWORK SECTIONS - SHEET 2 OF 2
DAC4.01	CONSTRUCTION STAGING PLAN
DAC6.01	BULK EARTHWORKS STAGE 1 CUT / FILL PLAN
DAC6.11	VEHICLE TURNING PATHS PLAN
DAC8.01	SOIL EROSION AND SEDIMENT CONTROL PLAN, NOTES AND DETAILS

© COPYRIGHT of this design and plan is the property of ACOR Consultants Pty Ltd, ACN 079 306 245 ABN 40 079 306 245, all rights reserved. It must not be used, modified, reproduced or copied wholly or in part without written permission from ACOR Consultants Pty Ltd.

This drawing has been assigned an electronic code that signifies the drawing has been checked and approved by

A	ISSUED FOR DA	14.06.17	RAS	SRW	North
P3	ISSUED FOR REVIEW	08.03.17	RAS	SRW	
P2	ISSUED FOR REVIEW	21.02.17	RAS	SRW	
P1	ISSUED FOR REVIEW	17.10.16	RAS	SRW	
Issue	Description	Date	Drawn	Approved	20m

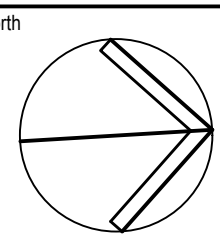

SCALE 1:750



**ACOR Consultants Pty Ltd**  
Unit 10, Level 1, No.1 Maitland Place  
Baulkham Hills NSW 2153  
T +61 2 9634 6311

Project  
**COSTCO OAKDALE DEPOT**  
ESTATE ROAD 1  
OAKDALE SOUTH ESTATE, NSW

Drawing Title CIVIL WORKS GENERAL ARRANGEMENT PLAN					
Drawn	Date	Scale	B1	Q.A. Check	Date
RAS	APRIL 2016	AS SHOWN			
Designed	Project No.	Dwg No.	Issue		
SRW	NW160037	DAC1.01	A		

NOT FOR CONSTRUCTION









INSET A


CIVIL LEGEND PROPOSED	
	PAVEMENT TYPE 1 LOADING AREA
	PAVEMENT TYPE 2 CARPARK
	PAVEMENT TYPE 3 ENTRY
	PAVEMENT TYPE 4 FOOTPATH
	LANDSCAPE AREAS REFER LANDSCAPE ARCHITECTS DRAWINGS FOR DETAILS
	SUBGRADE LEVEL FOR FUTURE WORKS
	VEHICULAR CROSSING REFER DRAWING C7.02 FOR DETAILS
	BUILDING REFER STRUCTURAL DRAWINGS DETAILS
	KERB
	BLOCK RETAINING WALL
	SAWCUT
	PRAM RAMP
	FINISHED SURFACE LEVEL
	FINISHED SURFACE CONTOUR
	FINISHED FLOOR LEVEL
	FINISHED SURFACE GRADE
	STORMWATER PIT
	STORMWATER DRAINAGE LINE WITH
	INVERT LEVEL UPSTREAM
	PIPE SIZE AND CLASS
	PIPE GRADE
	PIPE LENGTH
	INVERT LEVEL DOWNSTREAM
	EMERGENCY SITE OVERLAND FLOW ROUTE

CIVIL LEGEND EXISTING

	BOUNDARY
	KERB
	SURFACE LEVEL CONTOUR
	SURFACE LEVEL
	STORMWATER PIT
	SEWER PIPE
	STORMWATER PIPE

NOTES

- N1. PROPOSED PROPRIETARY GROSS POLLUTANT TRAP.
- N2. RETAINING WALL CONSTRUCTED AS PART OF SUBDIVISION WORKS.
- N3. RETAINING WALL TO BE CONSTRUCTED AS PART OF SUBJECT DA.
- N4. SEWER MAIN CONSTRUCTED AS PART OF SUBDIVISION WORKS.
- N5. ACOUSTIC WALL, SWALE AND LANDSCAPING CONSTRUCTED AS PART OF SUBDIVISION WORKS.
- N6. 75 KL EFFECTIVE VOLUME UNDERGROUND RAINWATER RE-USE TANK.

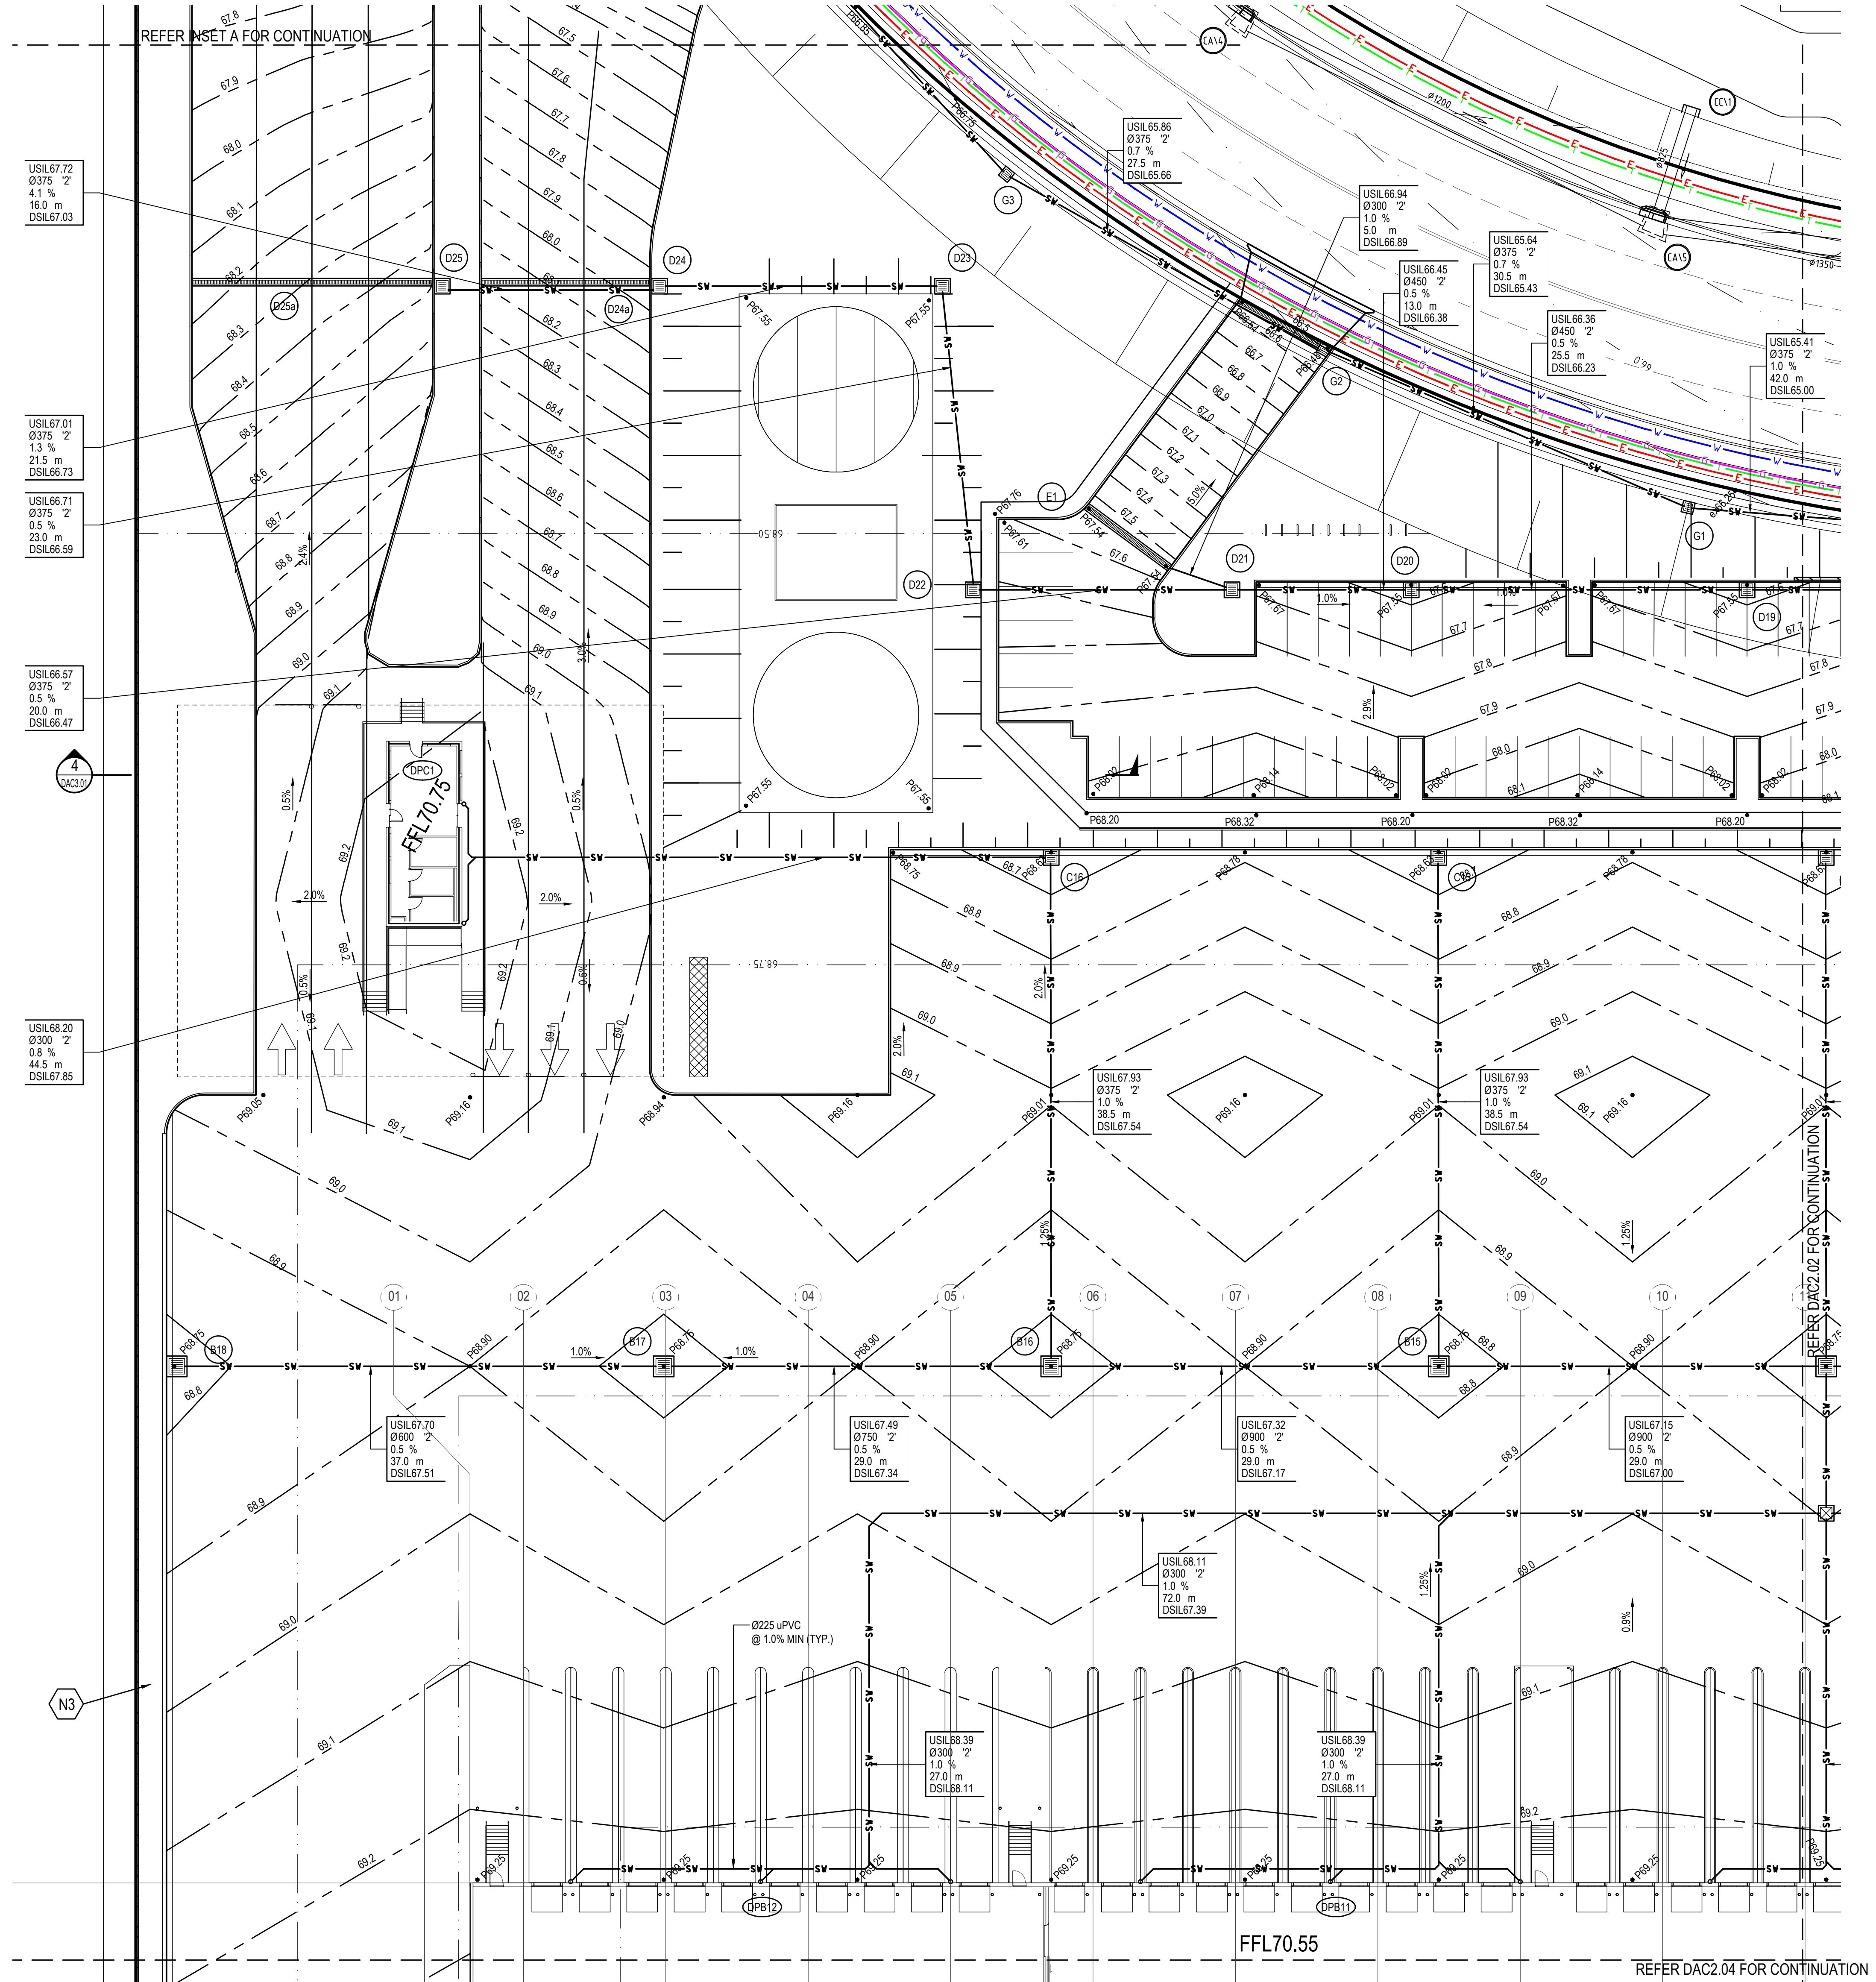


REFER DAC2.04 FOR CONTINUATION

NOT FOR CONSTRUCTION

© COPYRIGHT OF THE DESIGN AND PLAN TO THE PROPERTY OF ACOR CONSULTANTS PTY LTD, ACN 079 306 246 ABN 40 079 306 246, all rights reserved. It must not be used, modified, reproduced or copied wholly or in part without written permission from ACOR Consultants Pty Ltd.

This drawing has been assigned an electronic code that signifies the drawing has been checked and approved by

Issue	Description	Date	Drawn	Approved
A	ISSUED FOR DA	14.06.17	RAS	SRW
P3	ISSUED FOR REVIEW	08.03.17	RAS	SRW
P2	ISSUED FOR REVIEW	21.02.17	RAS	SRW
P1	ISSUED FOR REVIEW	17.10.16	RAS	SRW

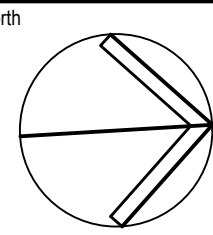

SCALE 1:250



ACOR Consultants Pty Ltd  
Unit 10, Level 1, No.1 Maitland Place  
Baulkham Hills NSW 2153  
T +61 2 9634 6311

Project  
COSTCO OAKDALE DEPOT  
ESTATE ROAD 1  
OAKDALE SOUTH ESTATE, NSW

Drawing Title		Date		Scale		B1		Q.A. Check		Date	
CIVIL WORKS PLAN		APRIL 2016		AS SHOWN							
SHEET 1 OF 6											
Drawn	RAS	Date	APRIL 2016	Scale	AS SHOWN	B1		Q.A. Check		Date	
Designed	SRW	Project No.	NW160037	Dwg. No.	DAC2.01			Issue			



## NOTES

- N1. PROPOSED PROPRIETARY GROSS POLLUTANT TRAP.
- N2. RETAINING WALL TO BE CONSTRUCTED AS PART OF SUBDIVISION WORKS.
- N3. RETAINING WALL TO BE CONSTRUCTED AS PART OF SUBJECT DA.
- N4. SEWER MAIN CONSTRUCTED AS PART OF SUBDIVISION WORKS.

## NOTES


- N5. ACOUSTIC WALL, SWALE AND LANDSCAPING CONSTRUCTED AS PART OF SUBDIVISION WORKS.
- N6. 75 KL EFFECTIVE VOLUME UNDERGROUND RAINWATER RE-USE TANK.

ROAD 01

© COPYRIGHT of this design and plan is the property of ACOR Consultants Pty Ltd. ACN 079 306 246 ABN 40 079 306 246, all rights reserved. It must not be used, modified, reproduced or copied wholly or in part without written permission from ACOR Consultants Pty Ltd.

This drawing has been assigned an electronic code that signifies the drawing has been checked and approved by

Issue	Description	Date	Drawn	Approved	Scale
A	ISSUED FOR DA	14.06.17	RAS	SRW	North
P3	ISSUED FOR REVIEW	08.03.17	RAS	SRW	
P2	ISSUED FOR REVIEW	21.02.17	RAS	SRW	
P1	ISSUED FOR REVIEW	17.10.16	RAS	SRW	

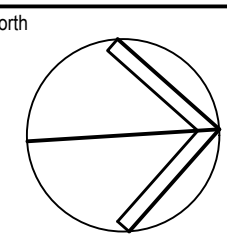

**COSTCO**  
WHOLESALE

**GROUP SA**

SCALE 1:250

**ACOR**  
CONSULTANTS


**ACOR Consultants Pty Ltd**  
Unit 10, Level 1, No.1 Maitland Place  
Baulkham Hills NSW 2153  
T +61 2 9634 6311

Project  
**COSTCO OAKDALE DEPOT**  
ESTATE ROAD 1  
OAKDALE SOUTH ESTATE, NSW

Drawing Title  
**CIVIL WORKS PLAN**  
SITWORKS PLAN  
SHEET 2 OF 6

Drawn	Date	Scale	B1	G.A. Check	Date
RAS	APRIL 2016	AS SHOWN			
Designed	Project No.	Dwg. No.	Issue		
SRW	NW160037	DAC2.02	A		



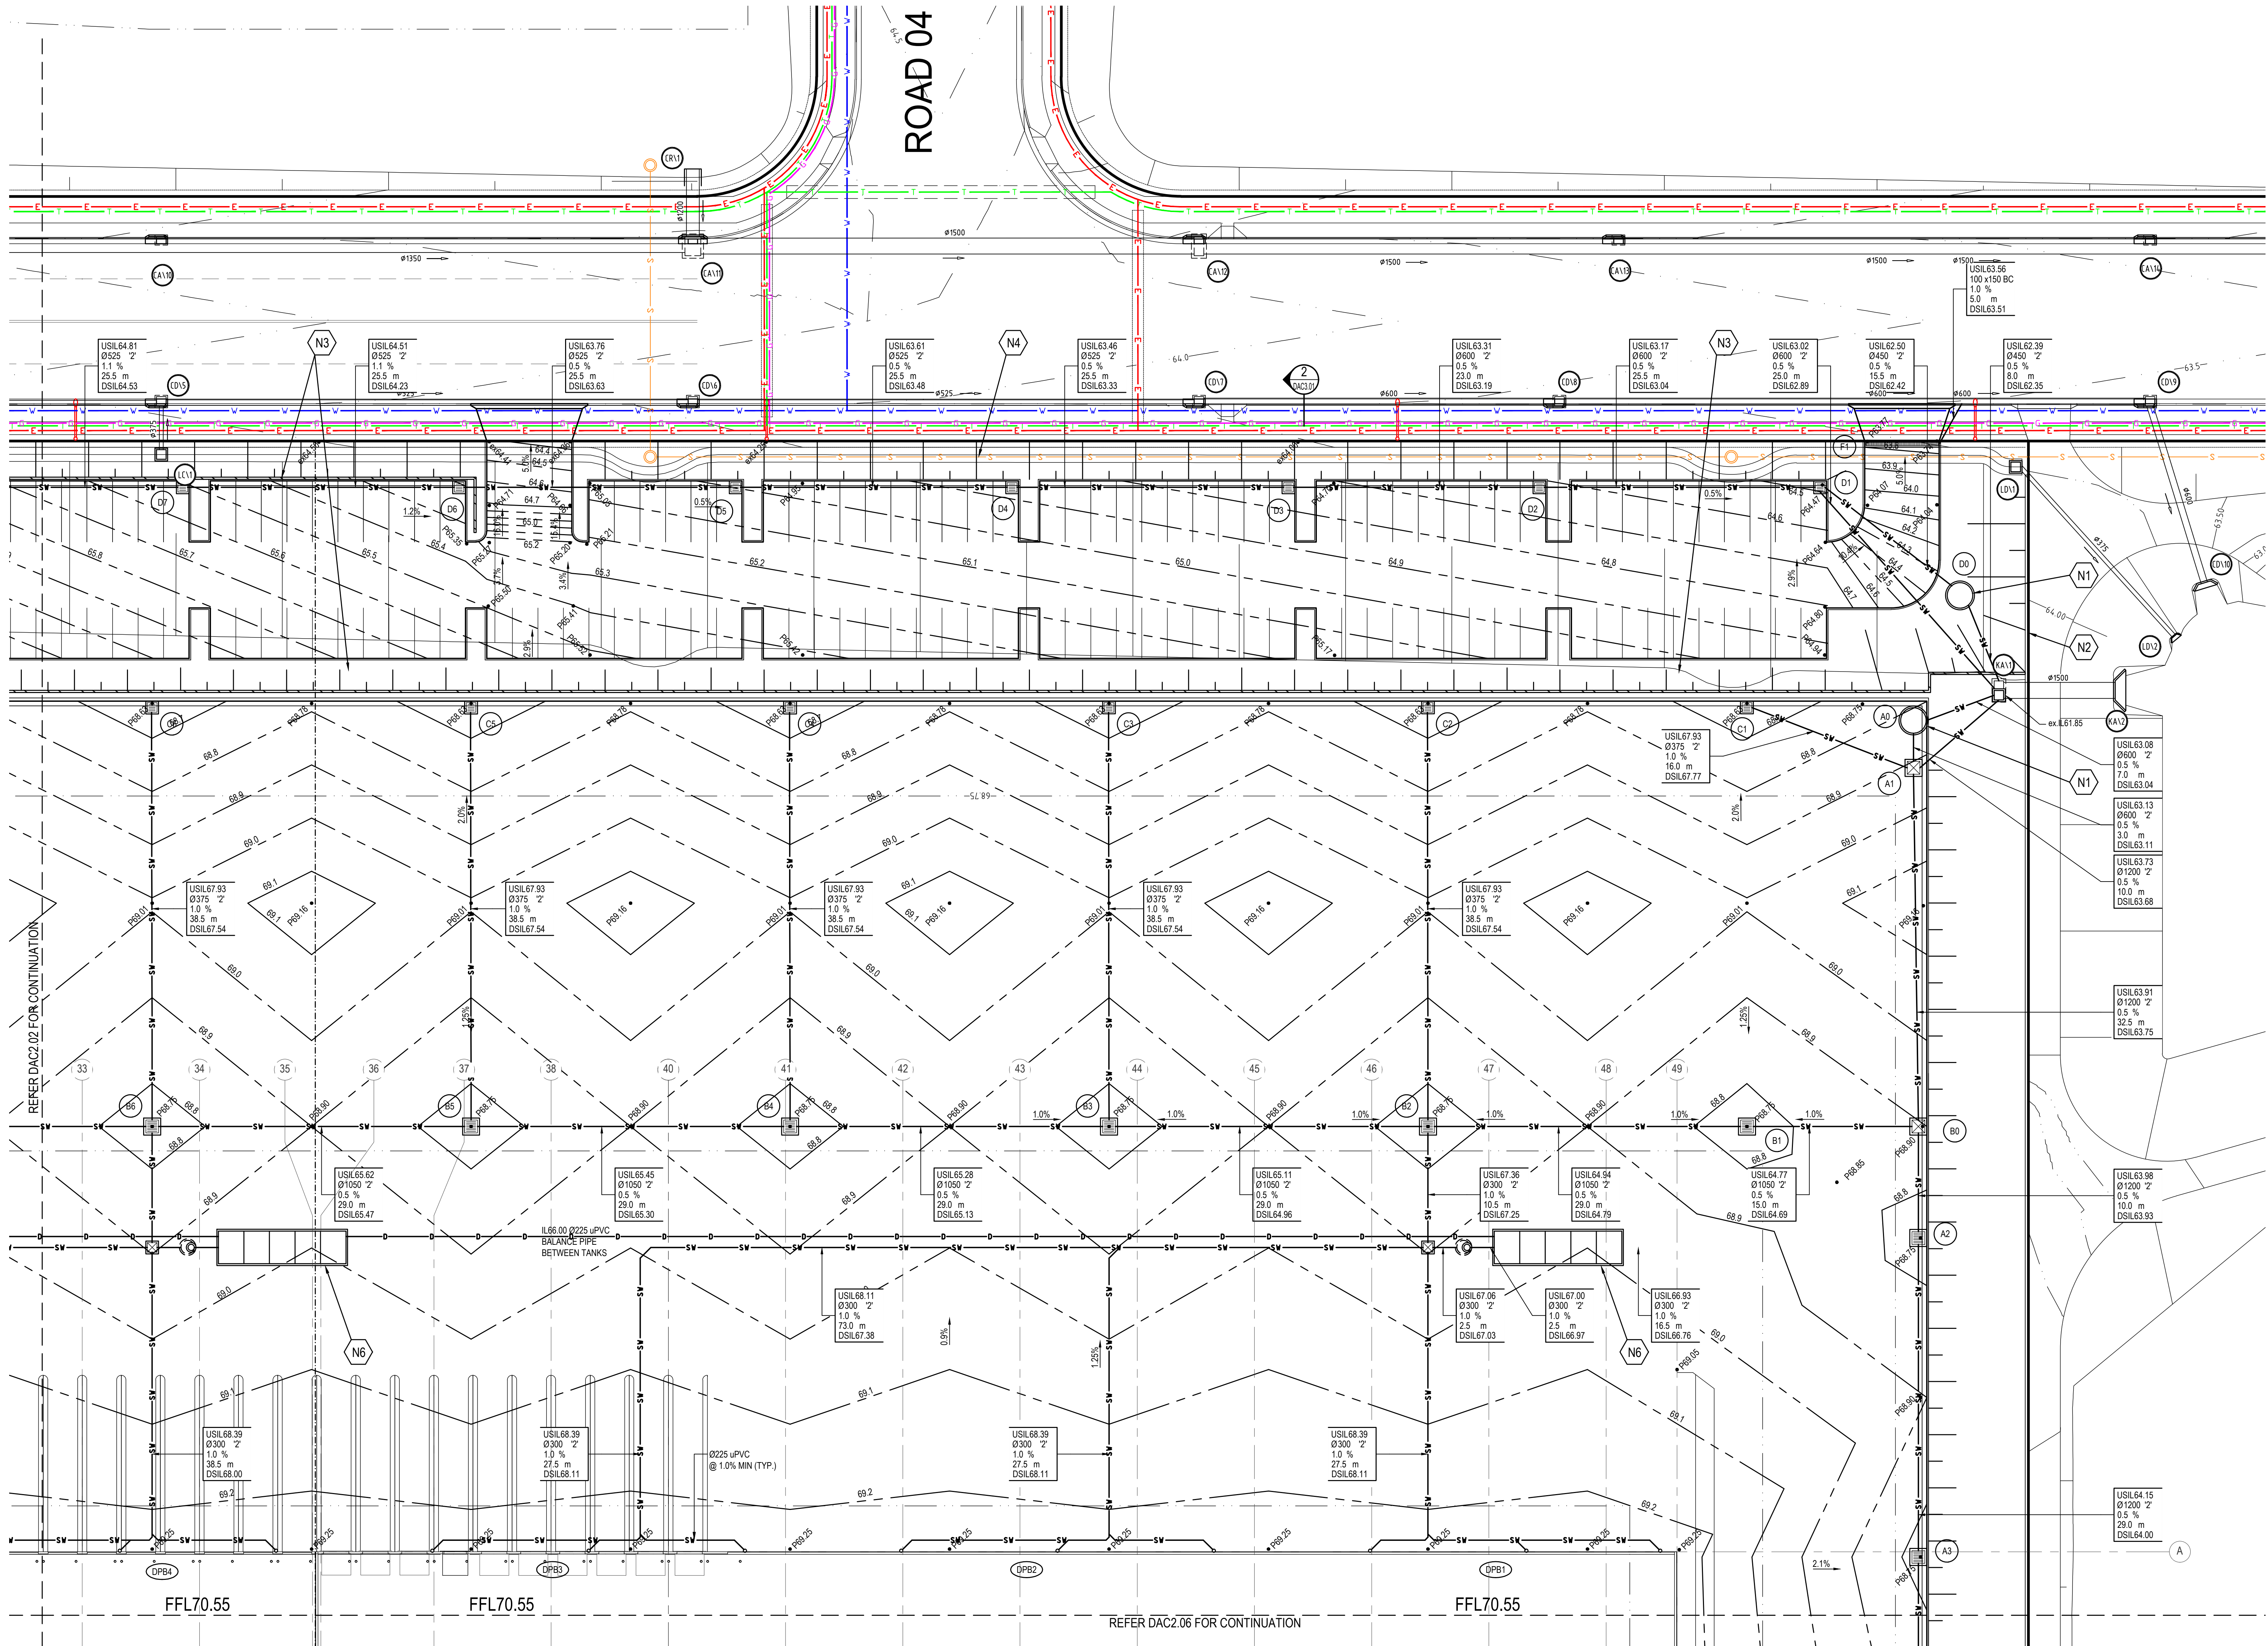


- NOTES**
- N1. PROPOSED PROPRIETARY GROSS POLLUTANT TRAP.
  - N2. RETAINING WALL CONSTRUCTED AS PART OF SUBDIVISION WORKS.
  - N3. RETAINING WALL TO BE CONSTRUCTED AS PART OF SUBJECT DA.
  - N4. SEWER MAIN CONSTRUCTED AS PART OF SUBDIVISION WORKS.
  - N5. ACOUSTIC WALL, SWALE AND LANDSCAPING CONSTRUCTED AS PART OF SUBDIVISION WORKS.
  - N6. 75 KL EFFECTIVE VOLUME UNDERGROUND RAINWATER RE-USE TANK.

REFER DAC2.02 FOR CONTINUATION

REFER DAC2.06 FOR CONTINUATION

© COPYRIGHT of this design and plan is the property of ACOR Consultants Pty Ltd, ACN 079 306 246 ABN 40 079 306 246, all rights reserved. It must not be used, modified, reproduced or copied wholly or in part without written permission from ACOR Consultants Pty Ltd.

This drawing has been assigned an electronic code that signifies the drawing has been checked and approved by			
B	RE-ISSUED FOR DA	30.10.17	RAS SRW
A	ISSUED FOR DA	14.06.17	RAS SRW
P3	ISSUED FOR REVIEW	08.03.17	RAS SRW
P2	ISSUED FOR REVIEW	21.02.17	RAS SRW
Issue	Description	Date	Drawn Approved
Now at full size			

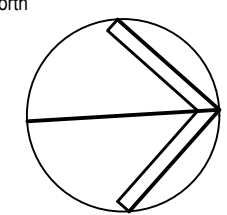

SCALE 1:250



**ACOR Consultants Pty Ltd**  
Unit 10, Level 1, No.1 Maitland Place  
Baulkham Hills NSW 2153  
T +61 2 9634 6311


Project  
**COSTCO OAKDALE DEPOT**  
ESTATE ROAD 1  
OAKDALE SOUTH ESTATE, NSW

Drawing Title <b>CIVIL WORKS PLAN</b> SITeworks PLAN SHEET 3 OF 6			
Drawn RAS	Date APRIL 2016	Scale AS SHOWN	Q.A. Check Date
Designed SRW	Project No. NW160037	Dwg No. DAC2.03	Issue B

NOT FOR CONSTRUCTION




N1.	PROPOSED PROPRIETARY GROSS POLLUTANT TRAP.
N2.	RETAINING WALL CONSTRUCTED AS PART OF SUBDIVISION WORKS.
N3.	RETAINING WALL TO BE CONSTRUCTED AS PART OF SUBJECT DA.
N4.	SEWER MAIN CONSTRUCTED AS PART OF SUBDIVISION WORKS.
N5.	ACOUSTIC WALL, SWALE AND LANDSCAPING CONSTRUCTED AS PART OF SUBDIVISION WORKS.
N6.	75 KL EFFECTIVE VOLUME UNDERGROUND RAINWATER RE-USE TANK.

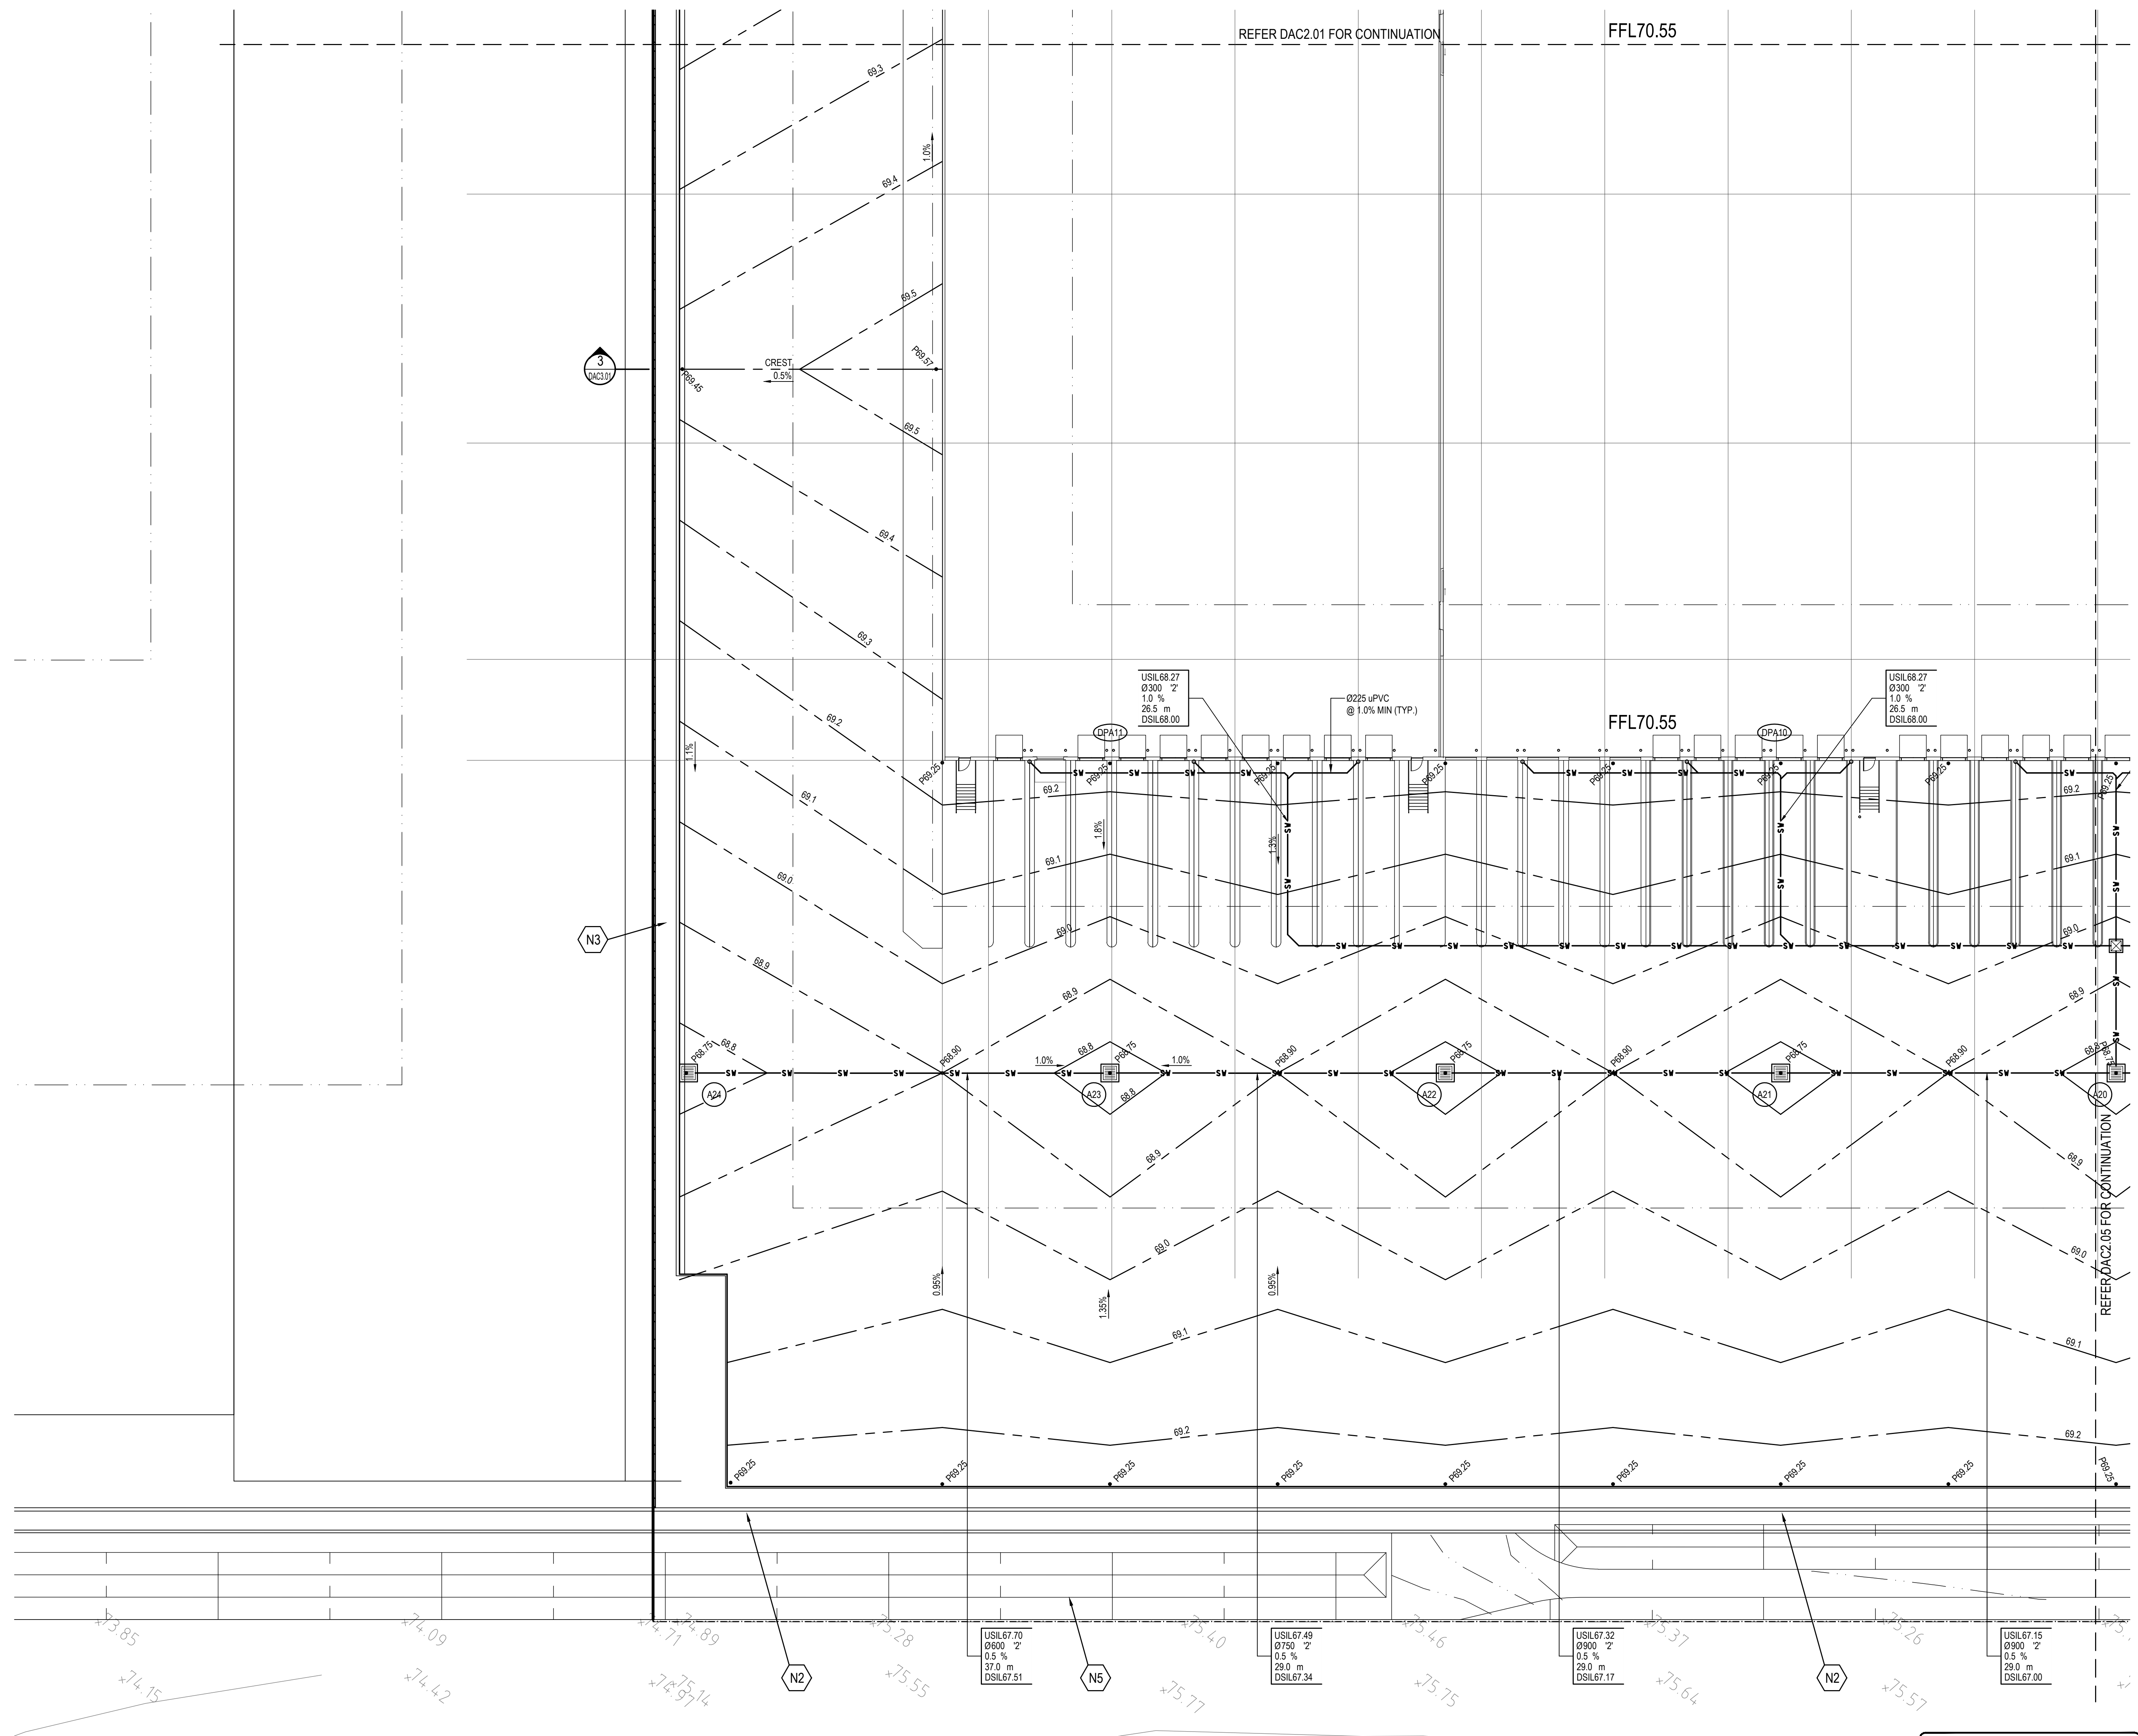


NOT FOR CONSTRUCTION

This drawing has been assigned an electronic code that signifies the drawing has been checked and approved by

A	ISSUED FOR DA	14.06.17	RAS	SRW
P3	ISSUED FOR REVIEW	08.03.17	RAS	SRW
P2	ISSUED FOR REVIEW	21.02.17	RAS	SRW
P1	ISSUED FOR REVIEW	17.10.16	RAS	SRW
Issue	Description	Date	Drawn	Approved

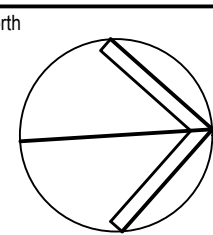

**GROUPSA**

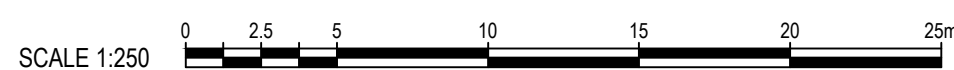

**ACOR Consultants Pty Ltd**  
Unit 10, Level 1, No.1 Maitland Place  
Baulkham Hills NSW 2153  
T +61 2 9634 6311


STRUCTURE PLANNERS | DEVELOPMENT CONSULTANTS

Project

COSTCO OAKDALE DEPOT  
ESTATE ROAD 1  
OAKDALE SOUTH ESTATE, NSW

Drawing Title			
CIVIL WORKS SITEWORKS PLAN SHEET 4 OF 6			
Drawn	Date	Scale	B1
RAS	APRIL 2016	AS SHOWN	
Designed		Q.A. Check	
SRW		Date	
Project No.		Dwg. No.	Issue
NW160037		DAC2.04	A




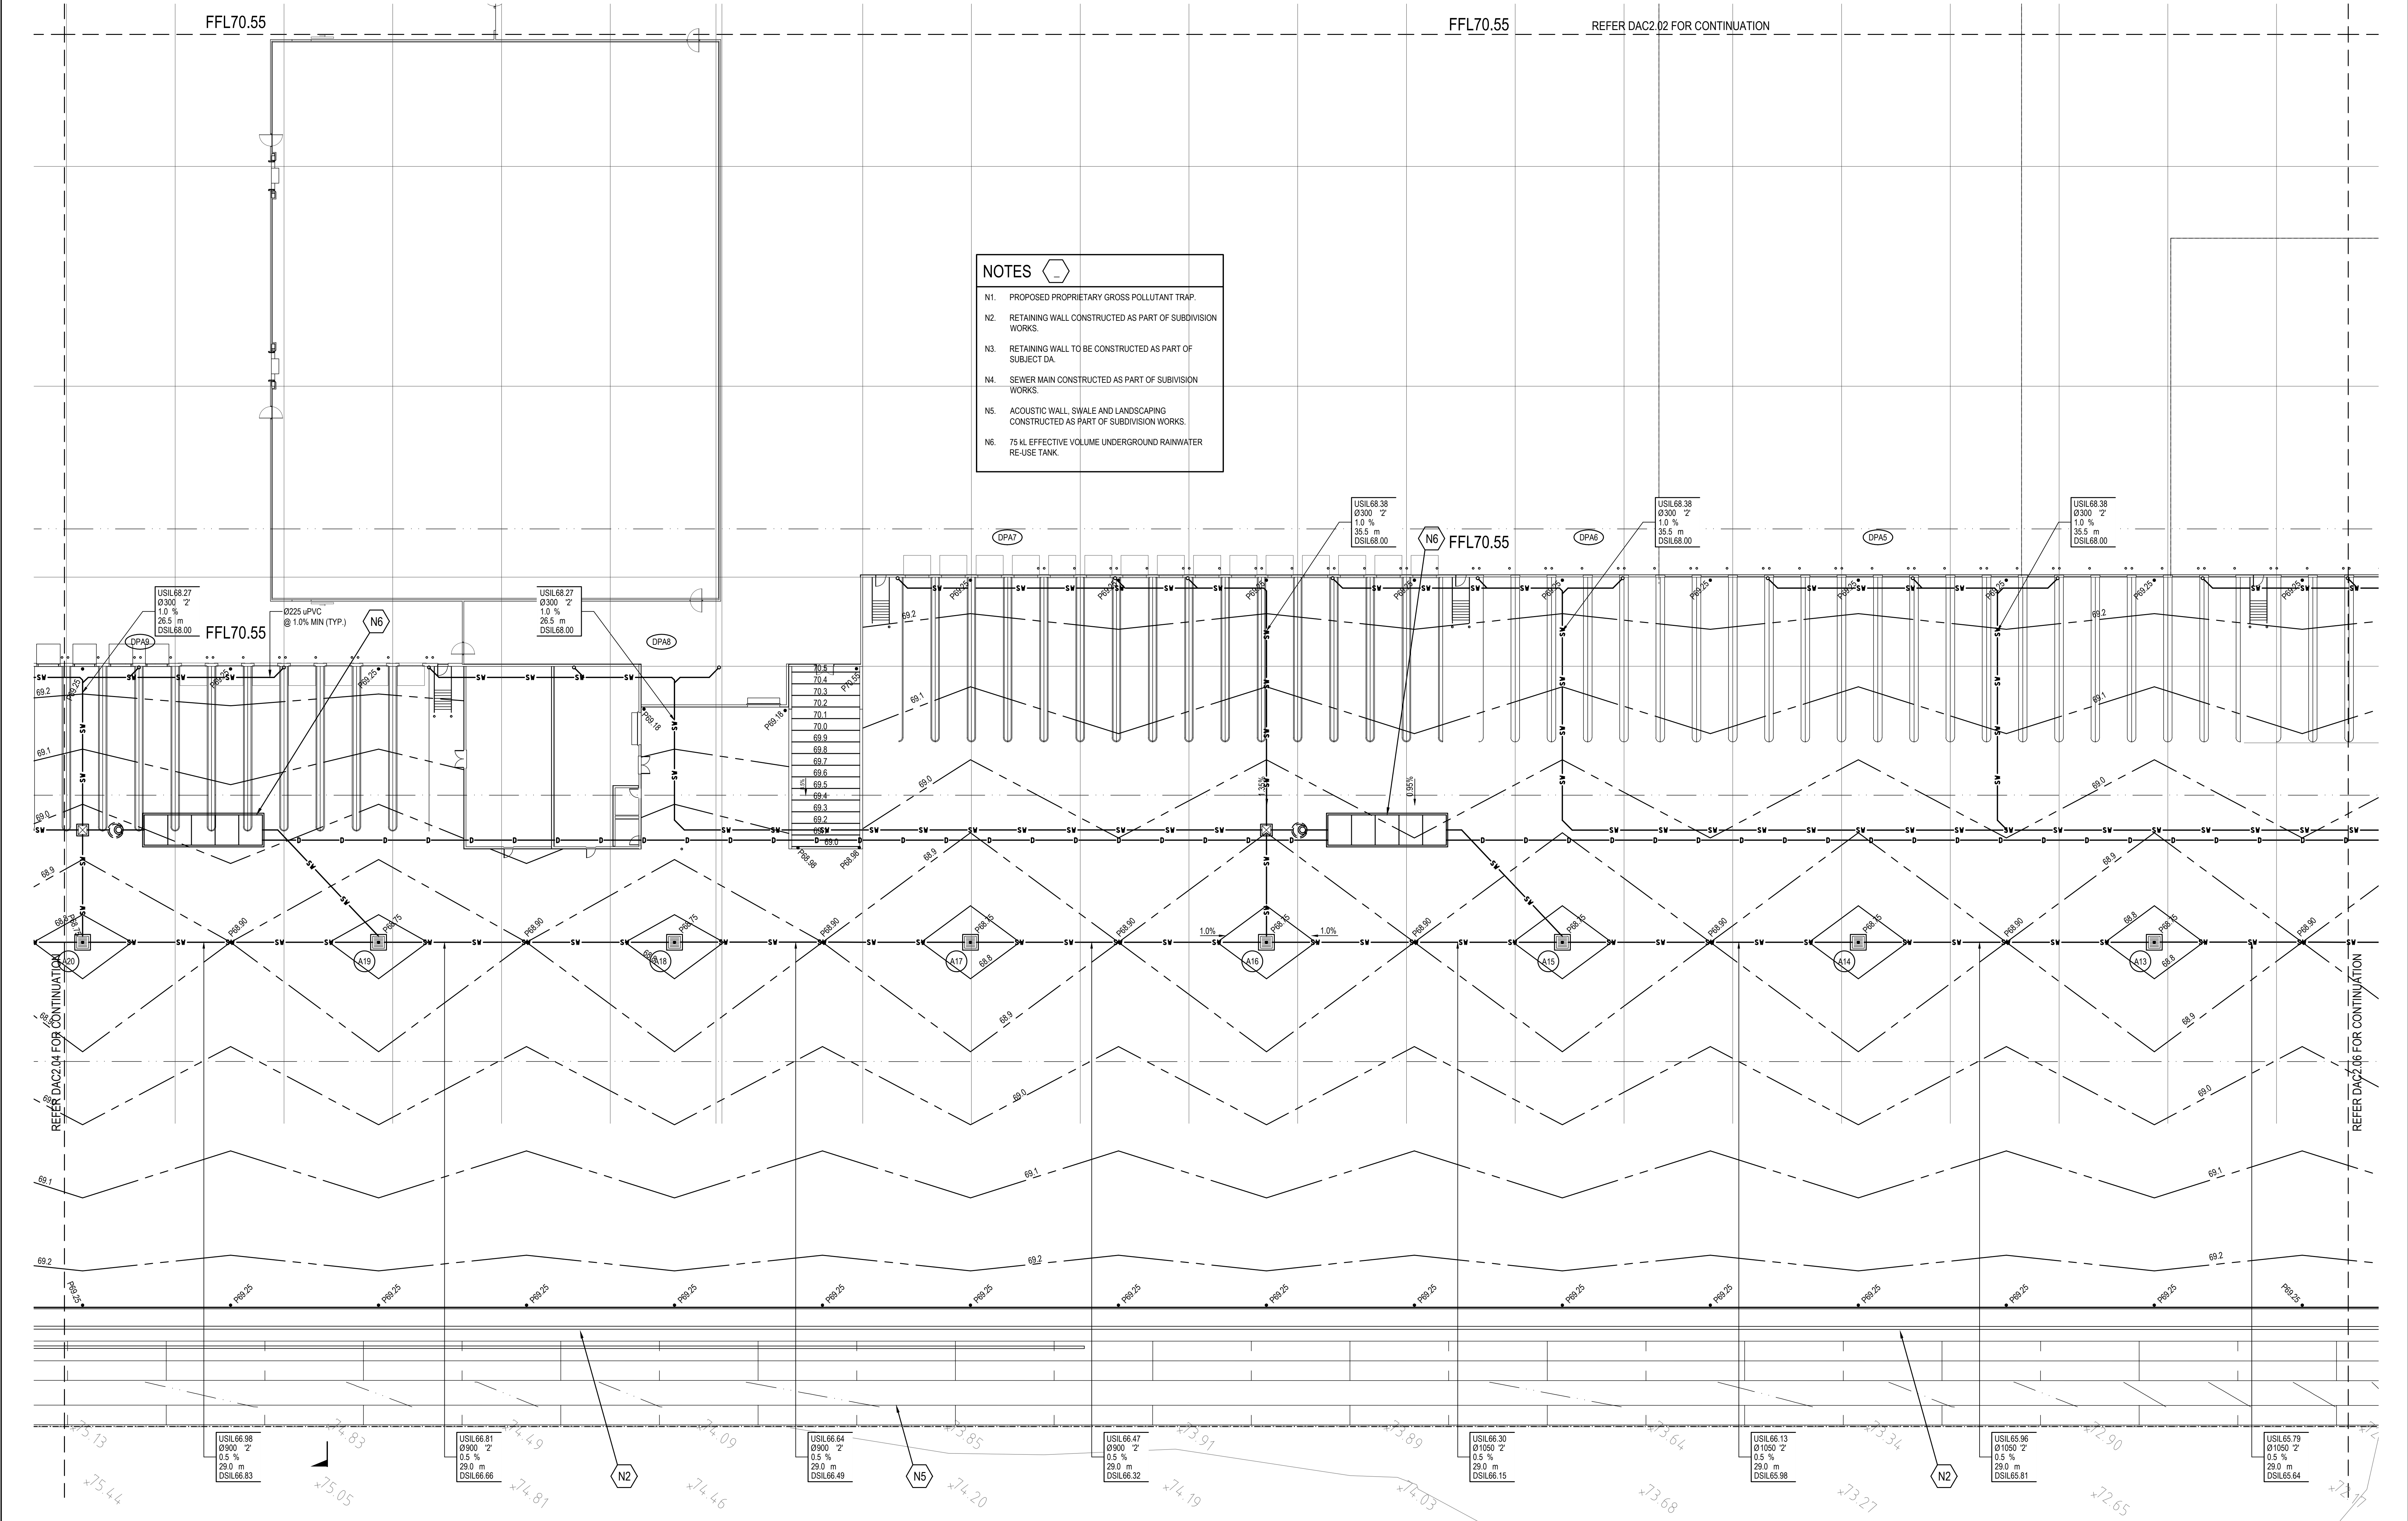

© COPYRIGHT of this design and plan is the property of ACOR Consultants Pty Ltd, ACN 079 306 245 ABN 40 079 306 245, all rights reserved. It must not be used, modified, reproduced or copied wholly or in part without written permission from ACOR Consultants Pty Ltd.

This drawing has been assigned an electronic code that signifies the drawing has been checked and approved by

A	ISSUED FOR DA	14.06.17	RAS	SRW
P3	ISSUED FOR REVIEW	08.03.17	RAS	SRW
P2	ISSUED FOR REVIEW	21.02.17	RAS	SRW
P1	ISSUED FOR REVIEW	17.10.16	RAS	SRW
Issue	Description	Date	Drawn	Approved
	Not at full scale			

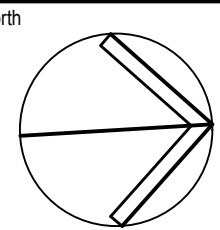

Client



Architect



SCALE 1:250



**ACOR Consultants Pty Ltd**  
Unit 10, Level 1, No.1 Maitland Place  
Baulkham Hills NSW 2153  
T +61 2 9634 6311

Project


**COSTCO OAKDALE DEPOT**  
ESTATE ROAD 1  
OAKDALE SOUTH ESTATE, NSW

Drawing Title  
**CIVIL WORKS  
SITEWORKS PLAN  
SHEET 5 OF 6**


Drawn	Date	Scale	B1	Q.A. Check	Date
RAS	APRIL 2016	AS SHOWN			
Designed	Project No.	Dwg. No.	Issue		
SRW	NW160037	DAC2.05	A		

NOT FOR CONSTRUCTION



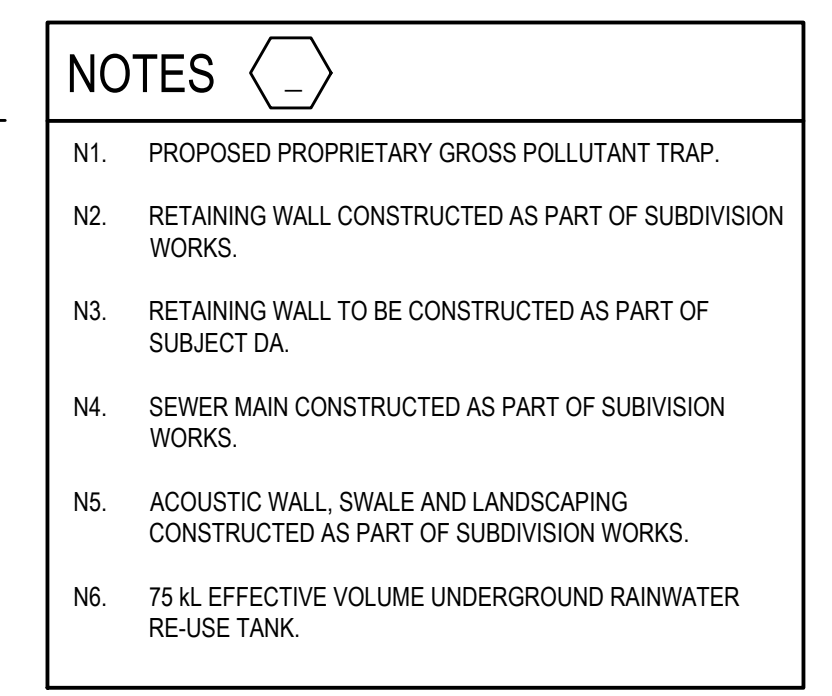


## NOTES



- N1. PROPOSED PROPRIETARY GROSS POLLUTANT TRAP.
- N2. RETAINING WALL CONSTRUCTED AS PART OF SUBDIVISION WORKS.
- N3. RETAINING WALL TO BE CONSTRUCTED AS PART OF SUBJECT DA.
- N4. SEWER MAIN CONSTRUCTED AS PART OF SUBDIVISION WORKS.
- N5. ACOUSTIC WALL, SWALE AND LANDSCAPING CONSTRUCTED AS PART OF SUBDIVISION WORKS.
- N6. 75 KL EFFECTIVE VOLUME UNDERGROUND RAINWATER RE-USE TANK.

NOT FOR CONSTRUCTION



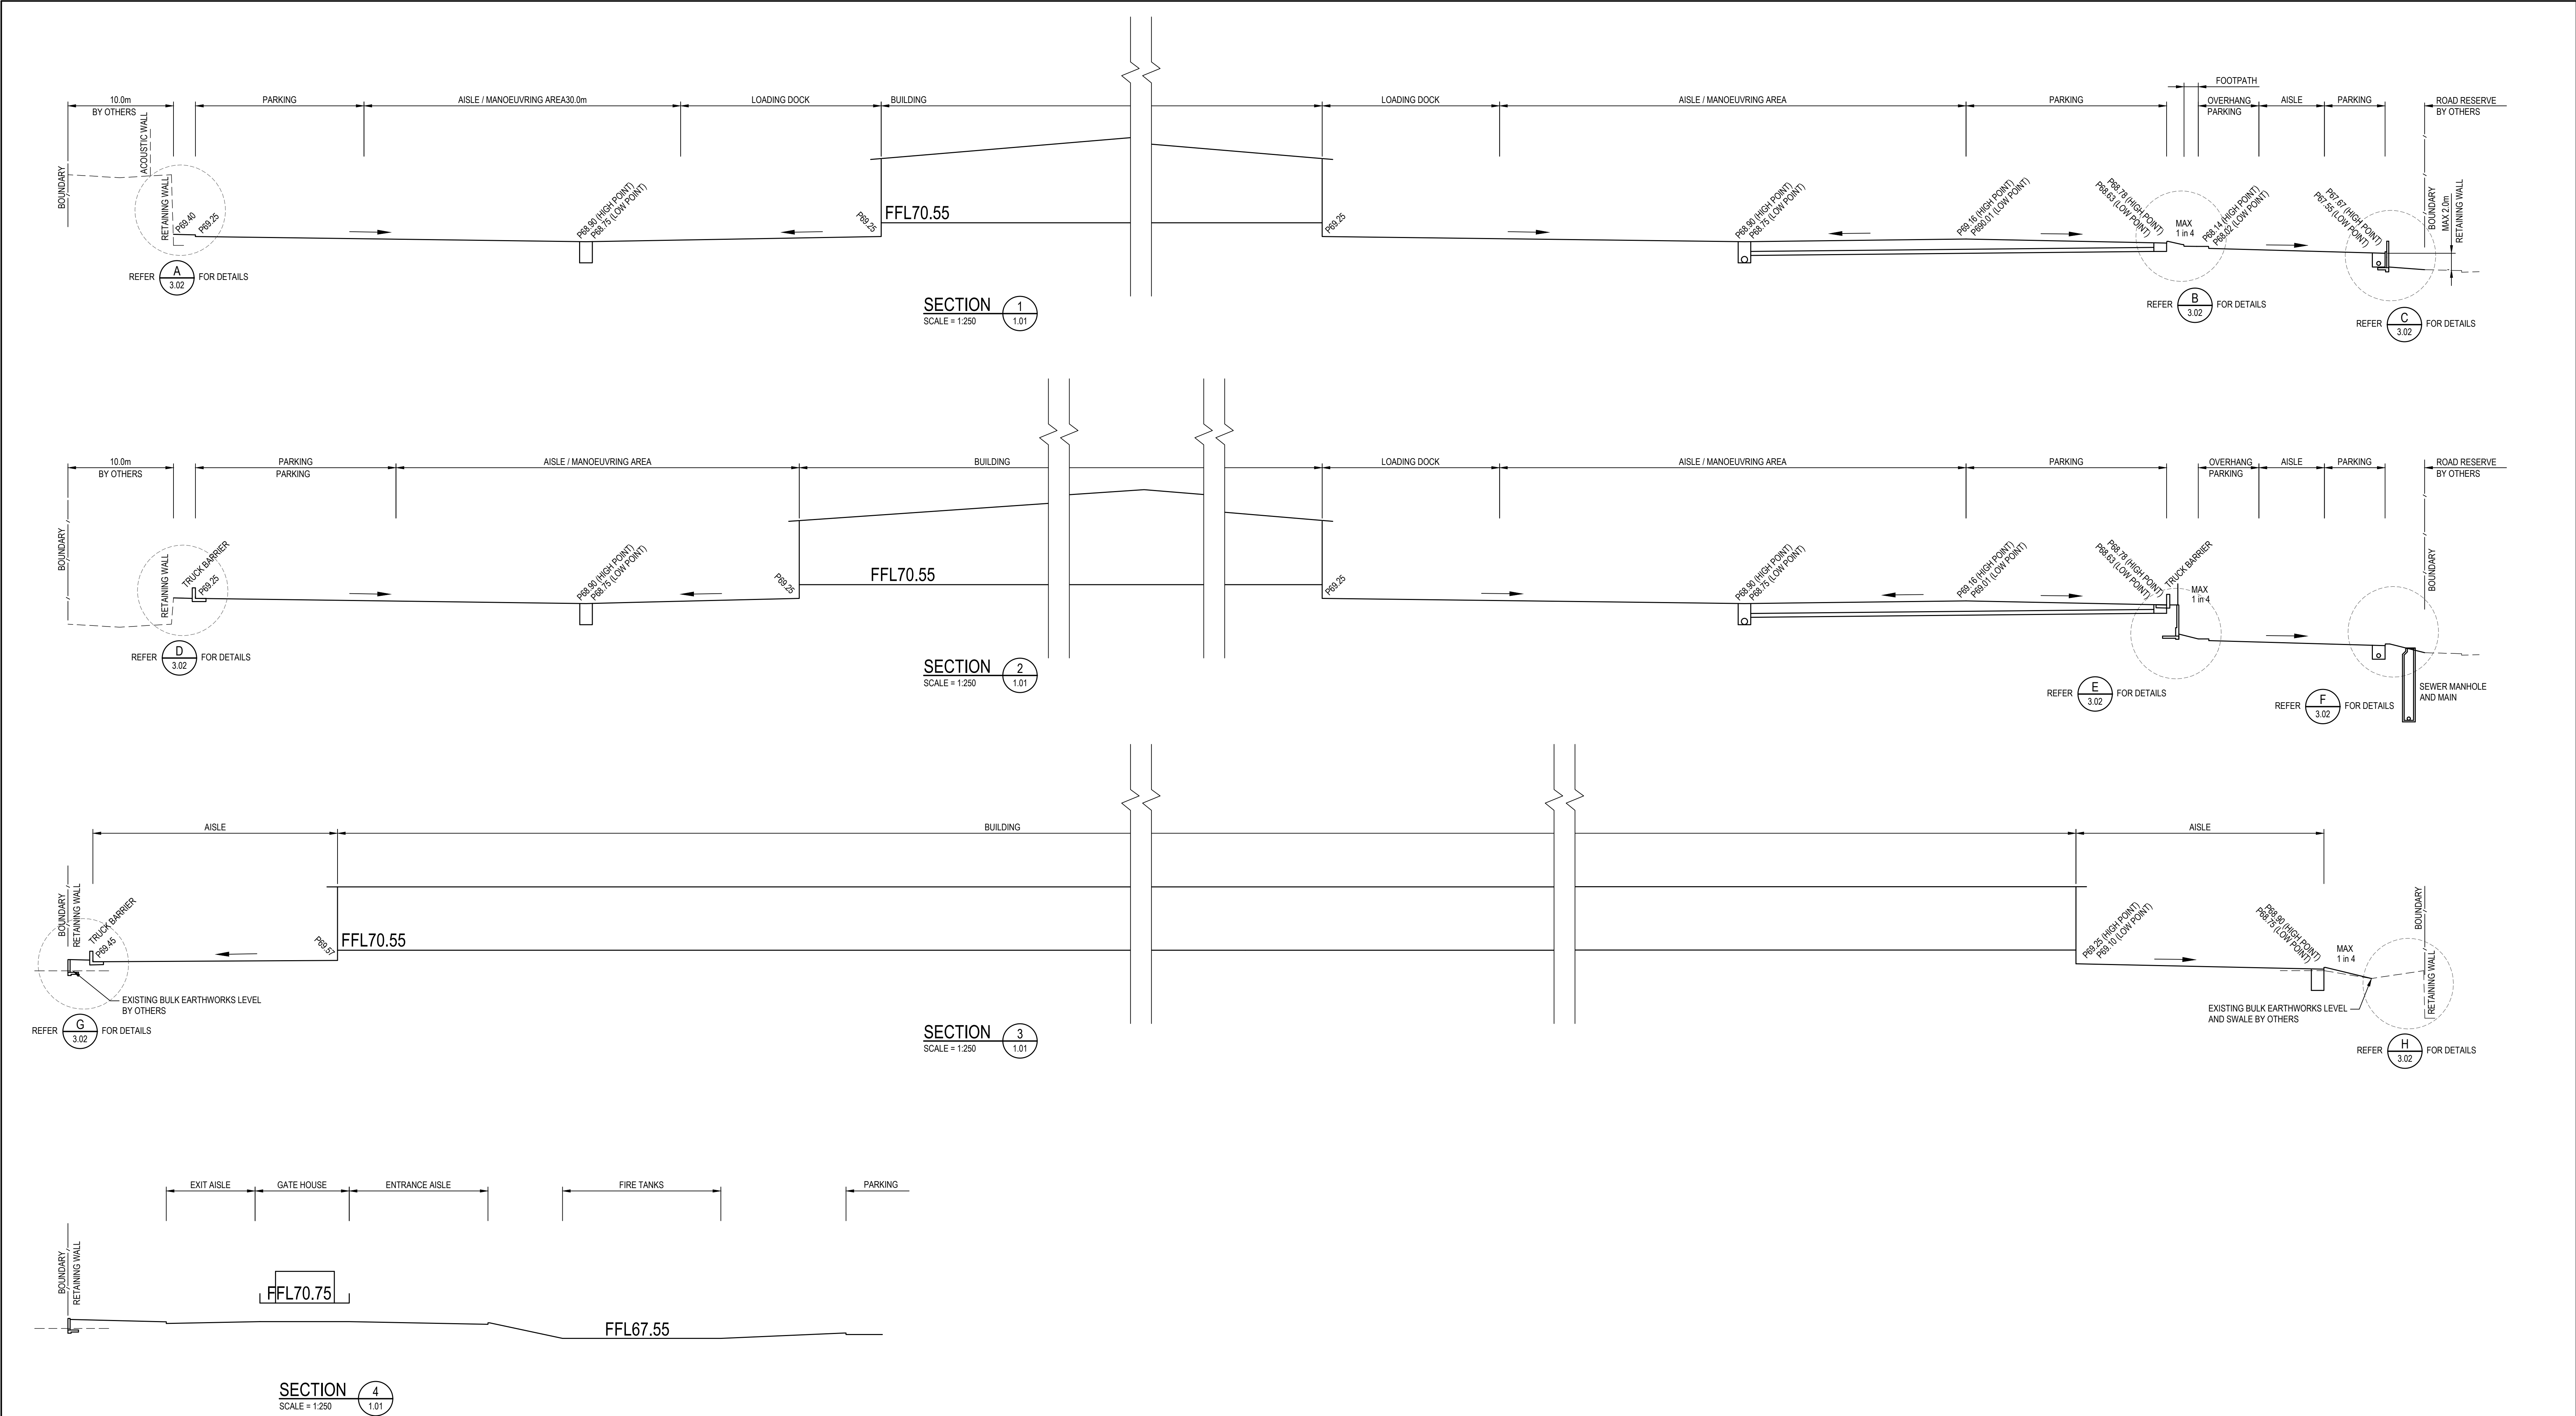

© COPYRIGHT of this design and plan is the property of ACOR Consultants Pty Ltd, ACN 079 306 245 ABN 40 079 306 245, all rights reserved. It must not be used, modified, reproduced or copied wholly or in part without written permission from ACOR Consultants Pty Ltd.

This drawing has been assigned an electronic code that signifies the drawing has been checked and approved by					
A	ISSUED FOR DA	14.06.17	RAS	SRW	North
P3	ISSUED FOR REVIEW	08.03.17	RAS	SRW	
P2	ISSUED FOR REVIEW	21.02.17	RAS	SRW	
P1	ISSUED FOR REVIEW	17.10.16	RAS	SRW	
Issue	Description	Date	Drawn	Approved	
Now at full size					

Client



Architect



**ACOR Consultants Pty Ltd**  
Unit 10, Level 1, No.1 Maitland Place  
Baulkham Hills NSW 2153  
T +61 2 9634 6311

Project


**COSTCO OAKDALE DEPOT**  
ESTATE ROAD 1  
OAKDALE SOUTH ESTATE, NSW

Drawing Title  
SITEWORKS SECTIONS  
SHEET 1 OF 2

Drawn	Date	Scale	BT	G.A. Check	Date
RAS	JULY 2016	AS SHOWN			
Designed	Project No.	Dwg. No.	Issue		
SRW	NW160037	DAC3.01	A		


NOT FOR CONSTRUCTION



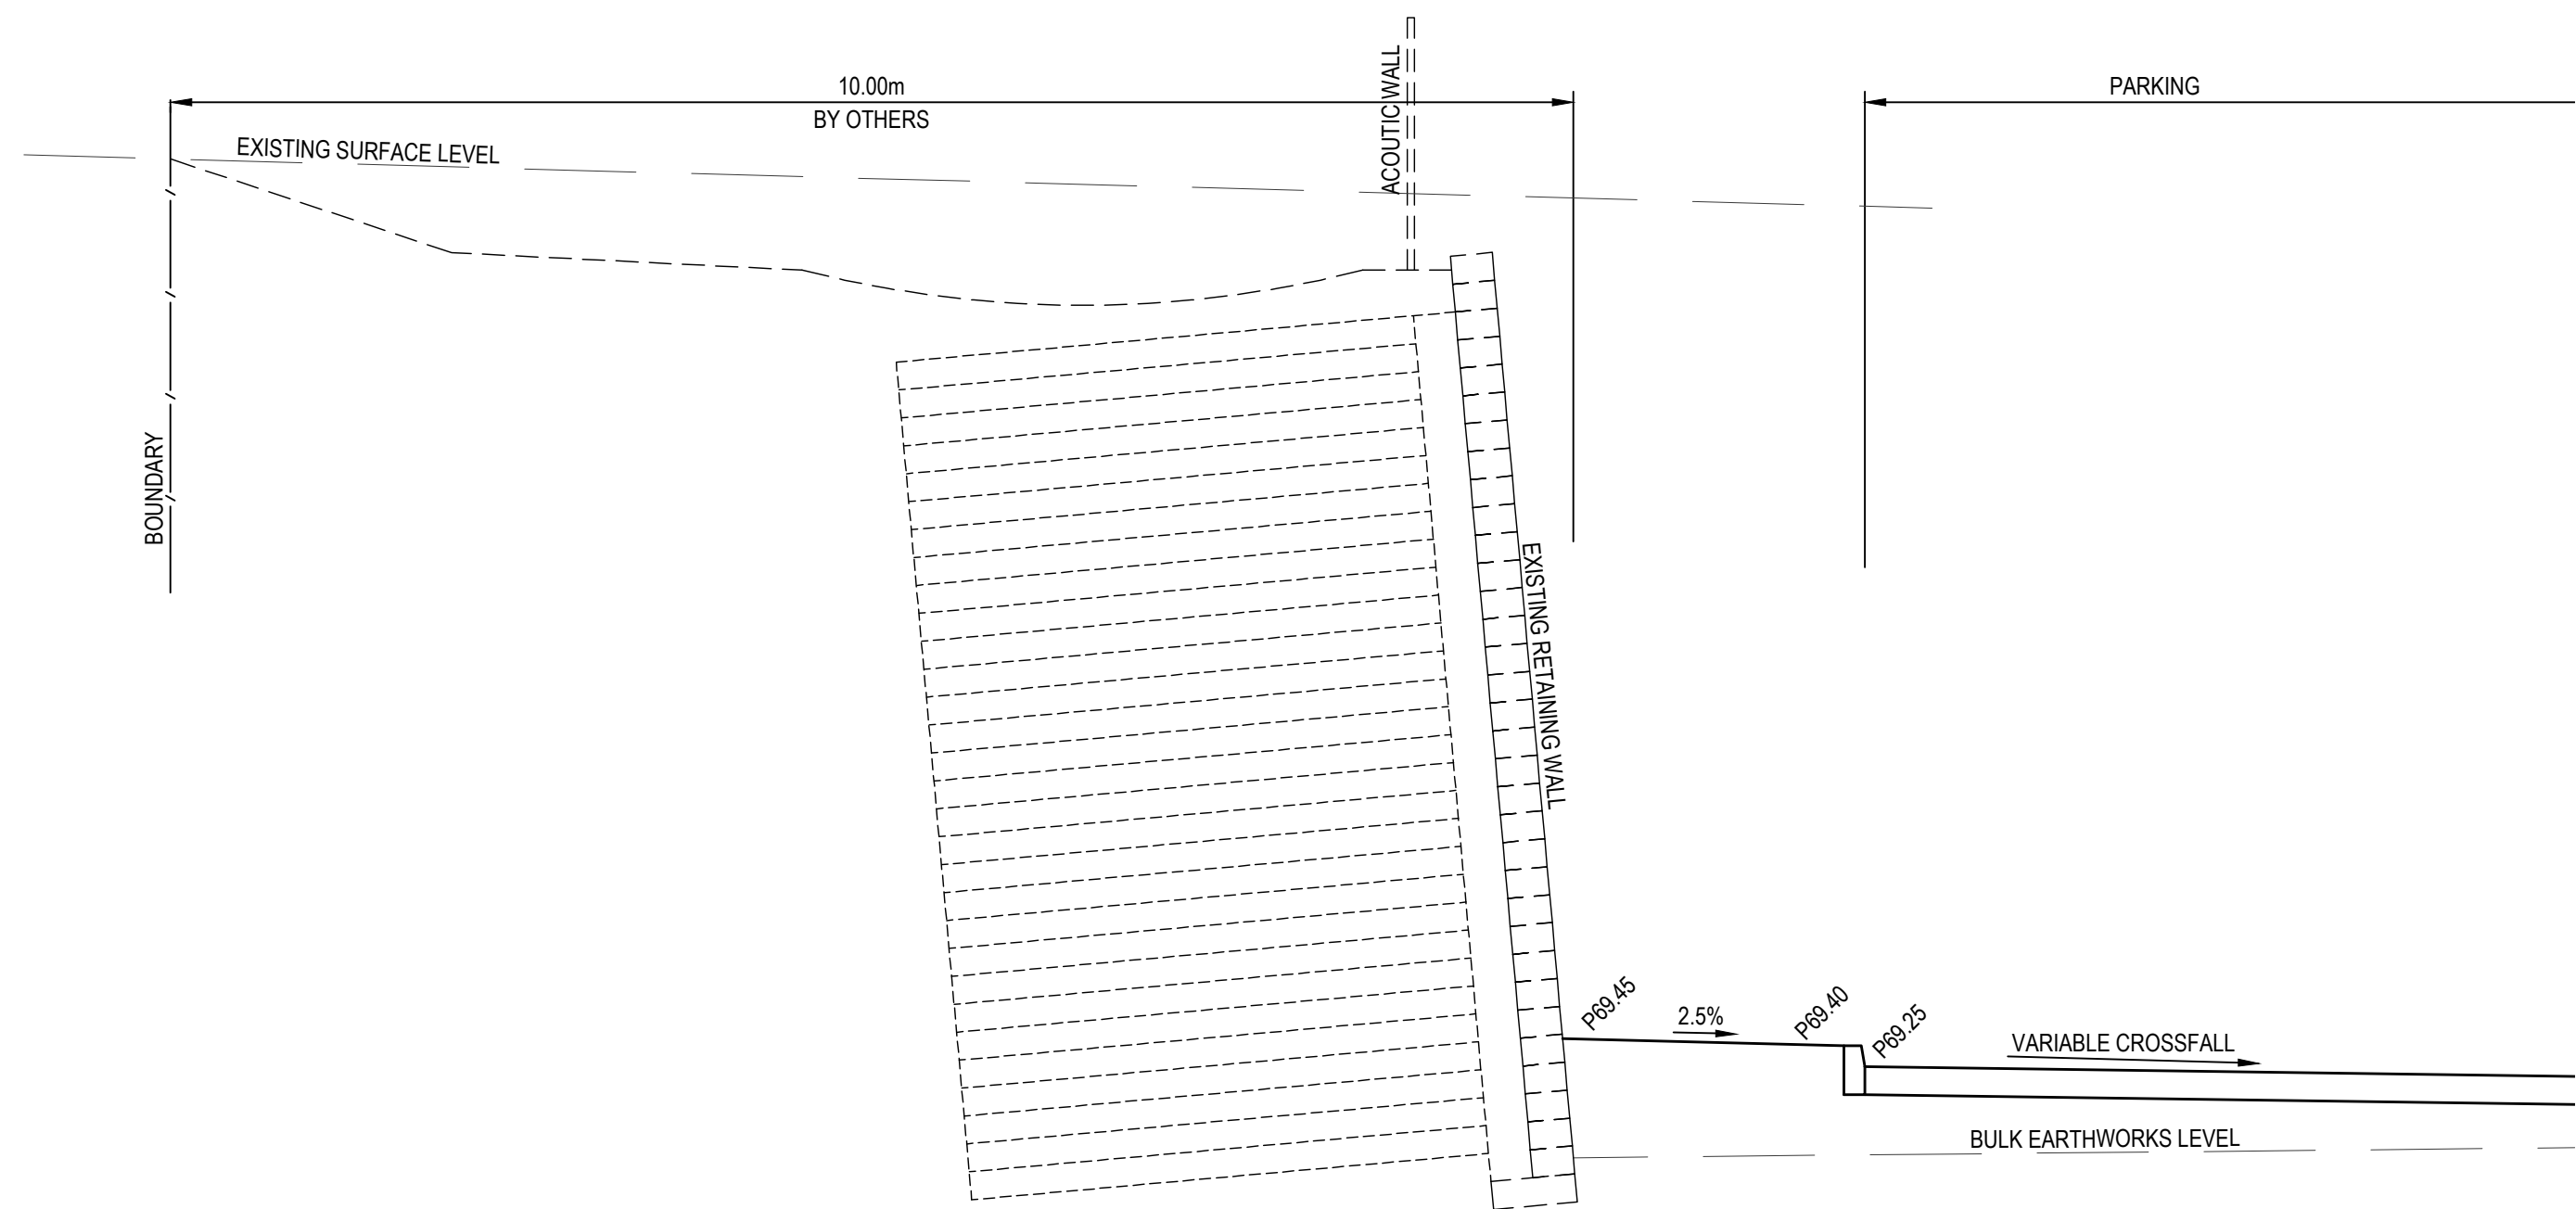


TYPICAL EASTERN BOUNDARY RETAINING WALL - CUT

DETAIL A  
SCALE = 1:50

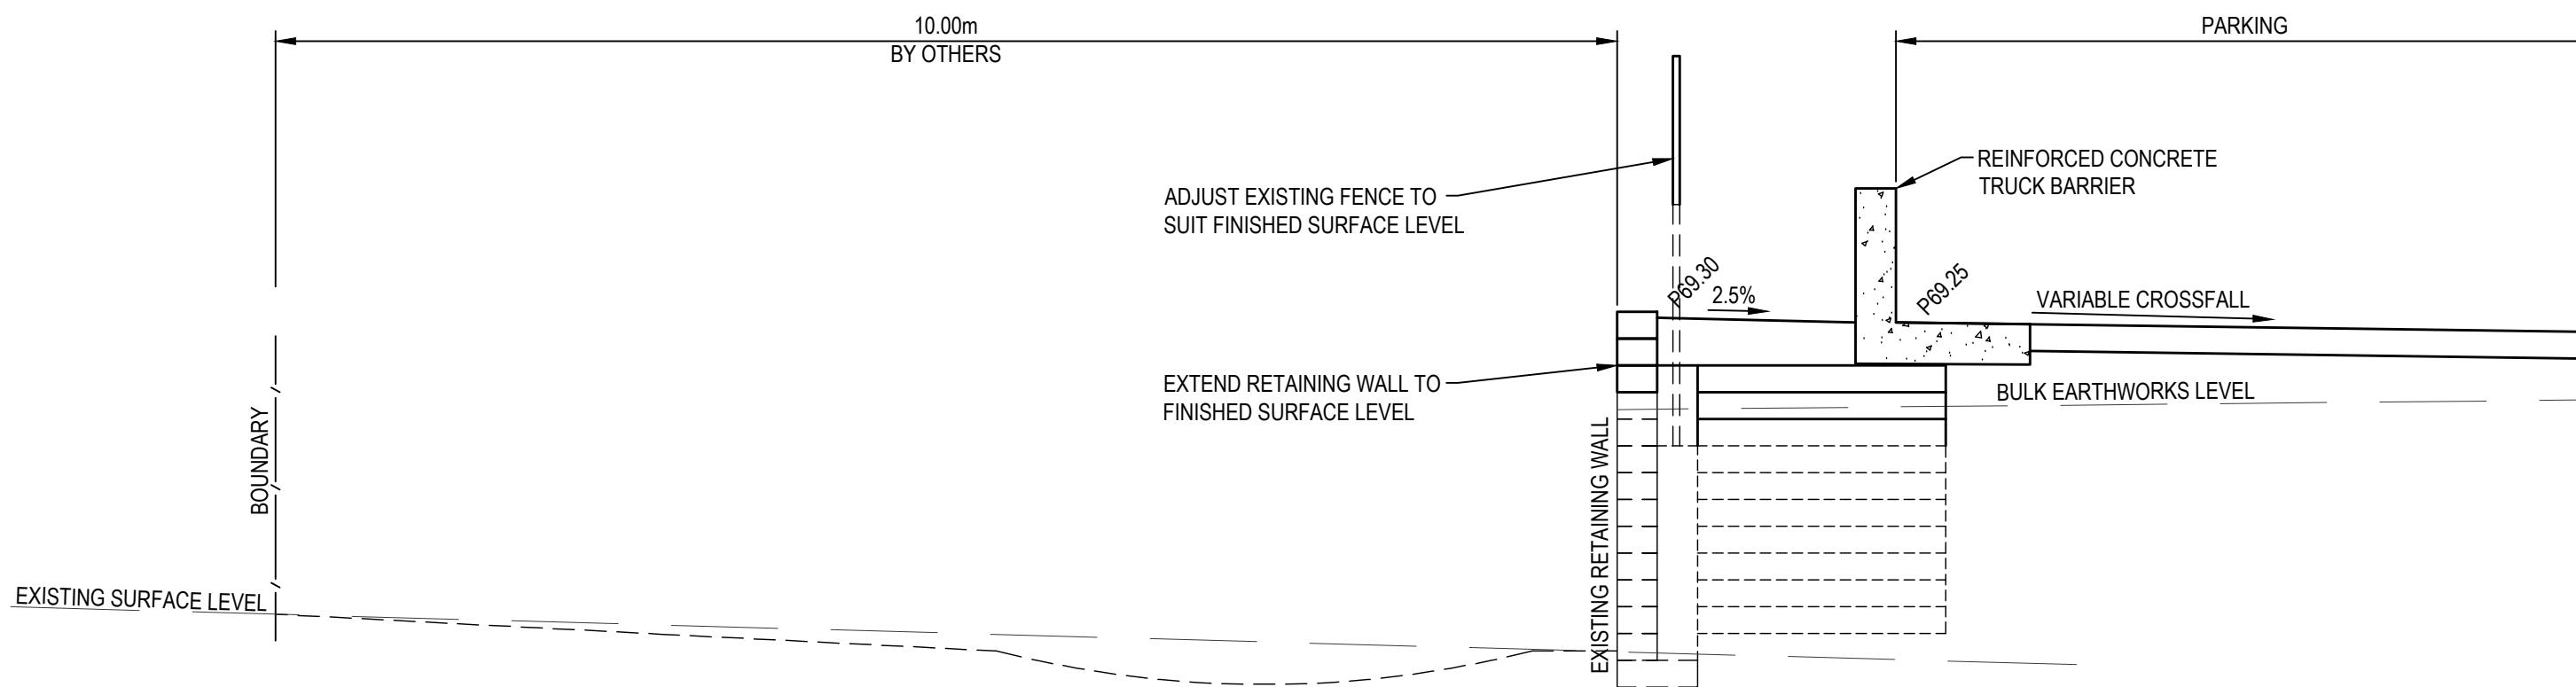


TYPICAL EASTERN BOUNDARY RETAINING WALL - FILL

DETAIL D  
SCALE = 1:50

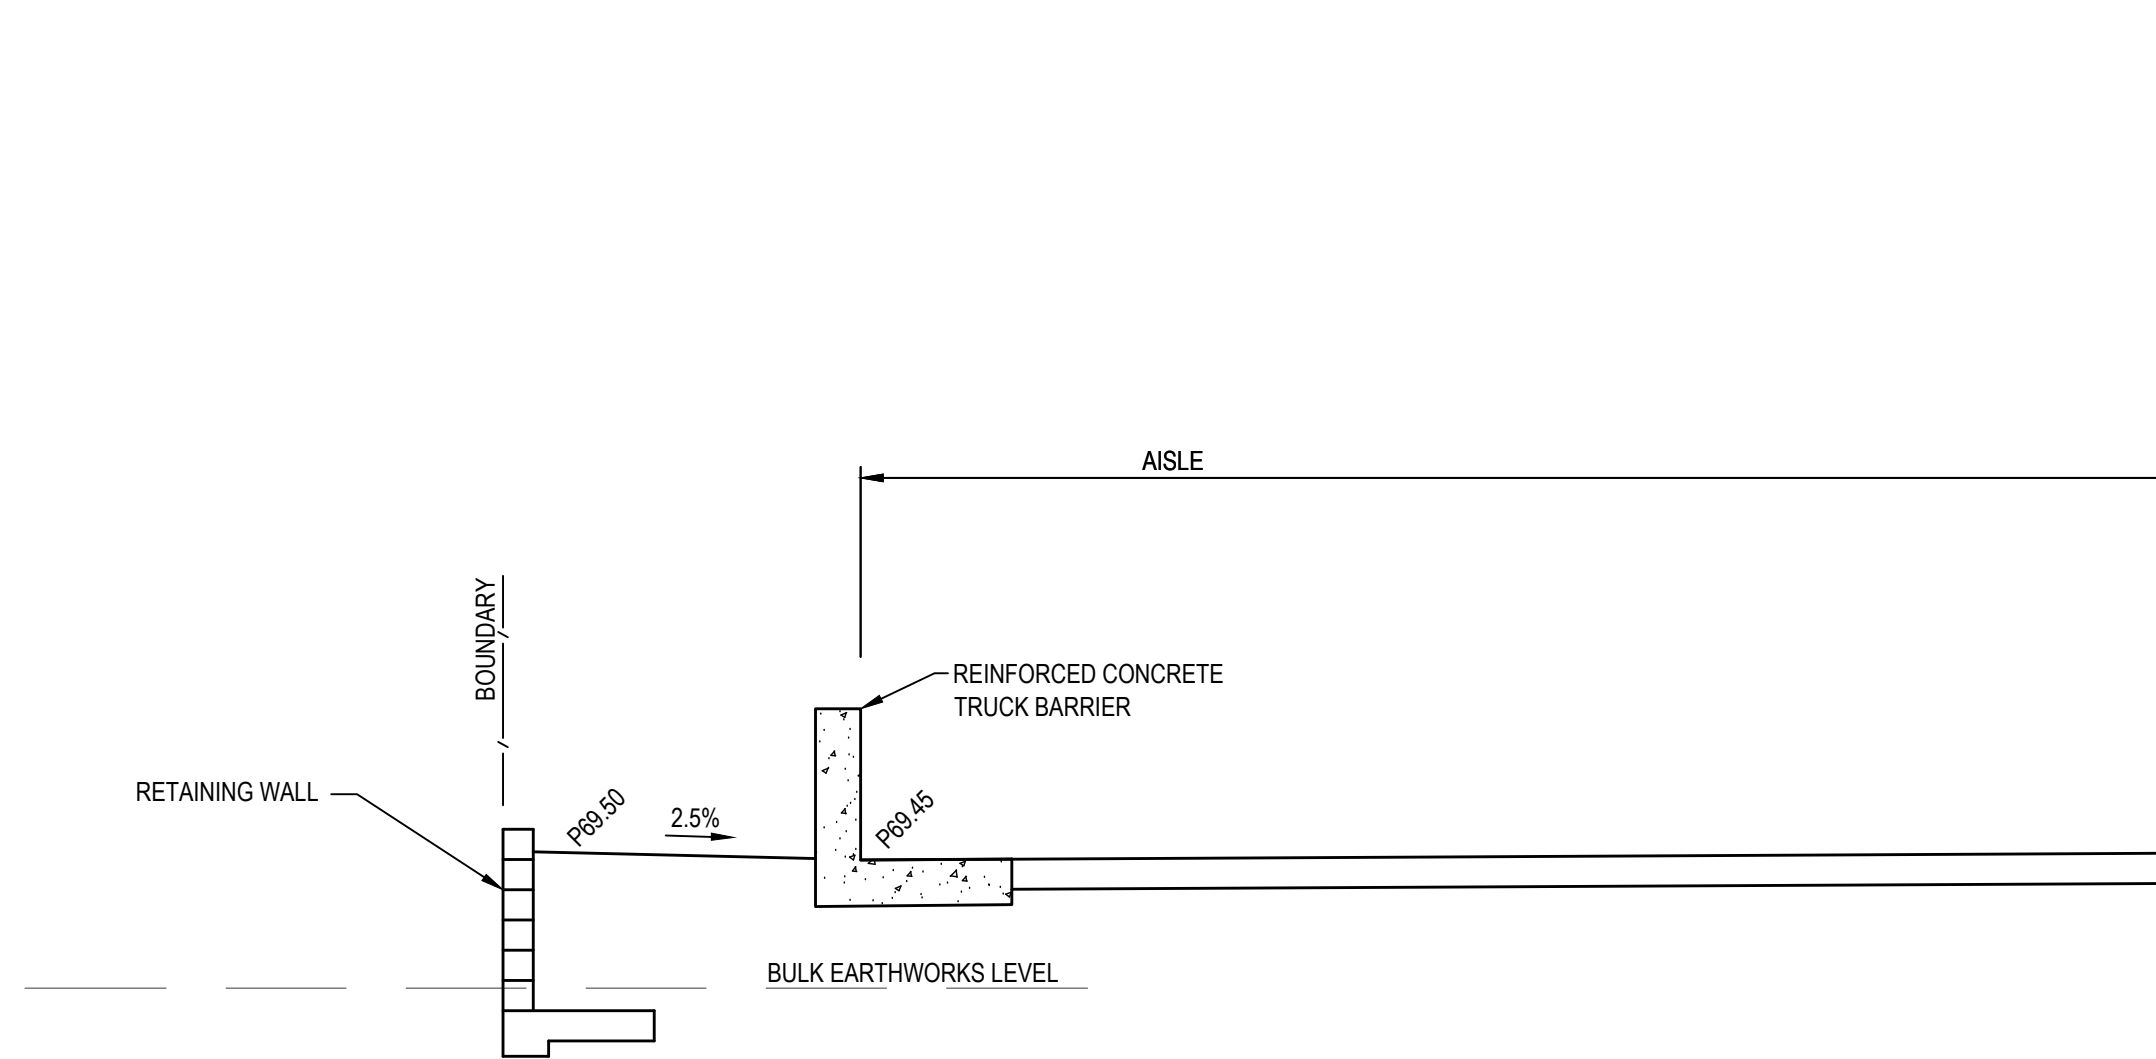


TYPICAL SOUTHERN BOUNDARY RETAINING WALL - FILL

DETAIL G  
SCALE = 1:50

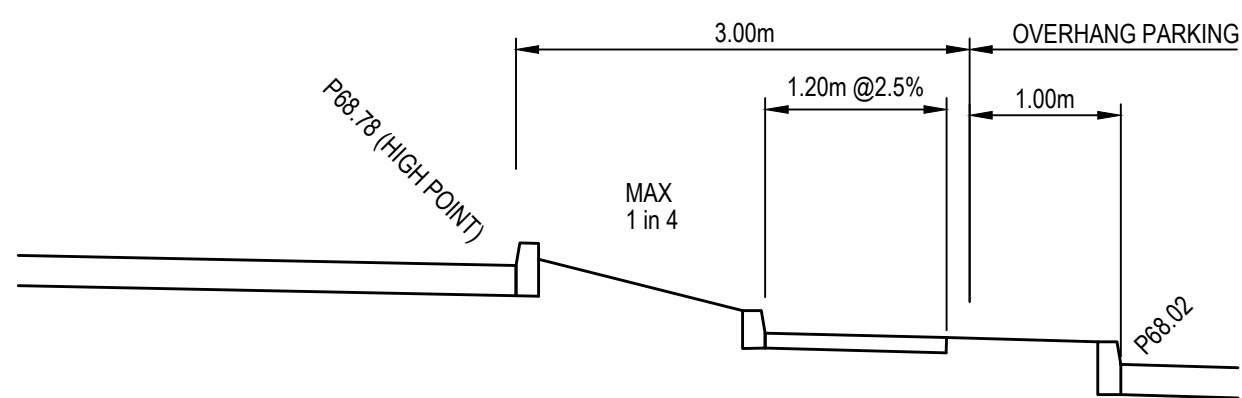


BETWEEN CARPARKS - SOUTH END

DETAIL B  
SCALE = 1:50

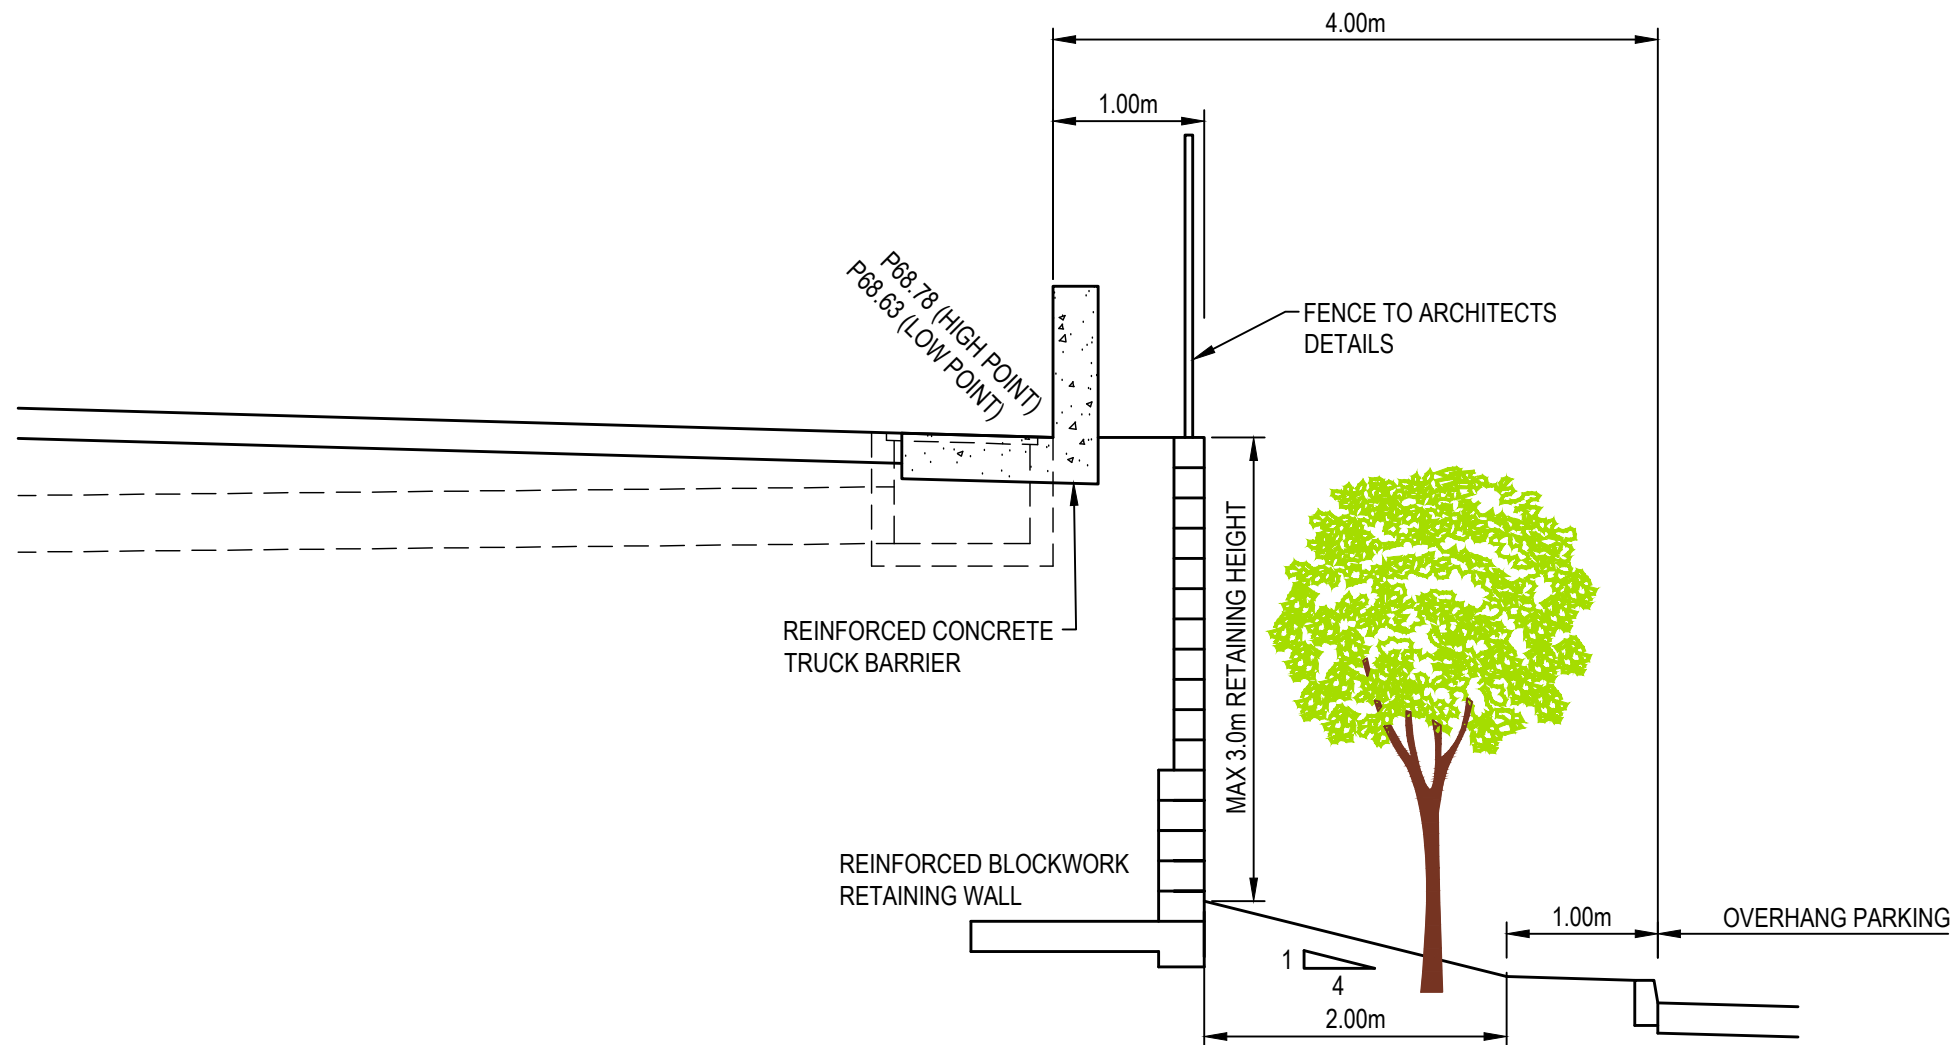


BETWEEN CARPARKS - NORTH END

DETAIL E  
SCALE = 1:50

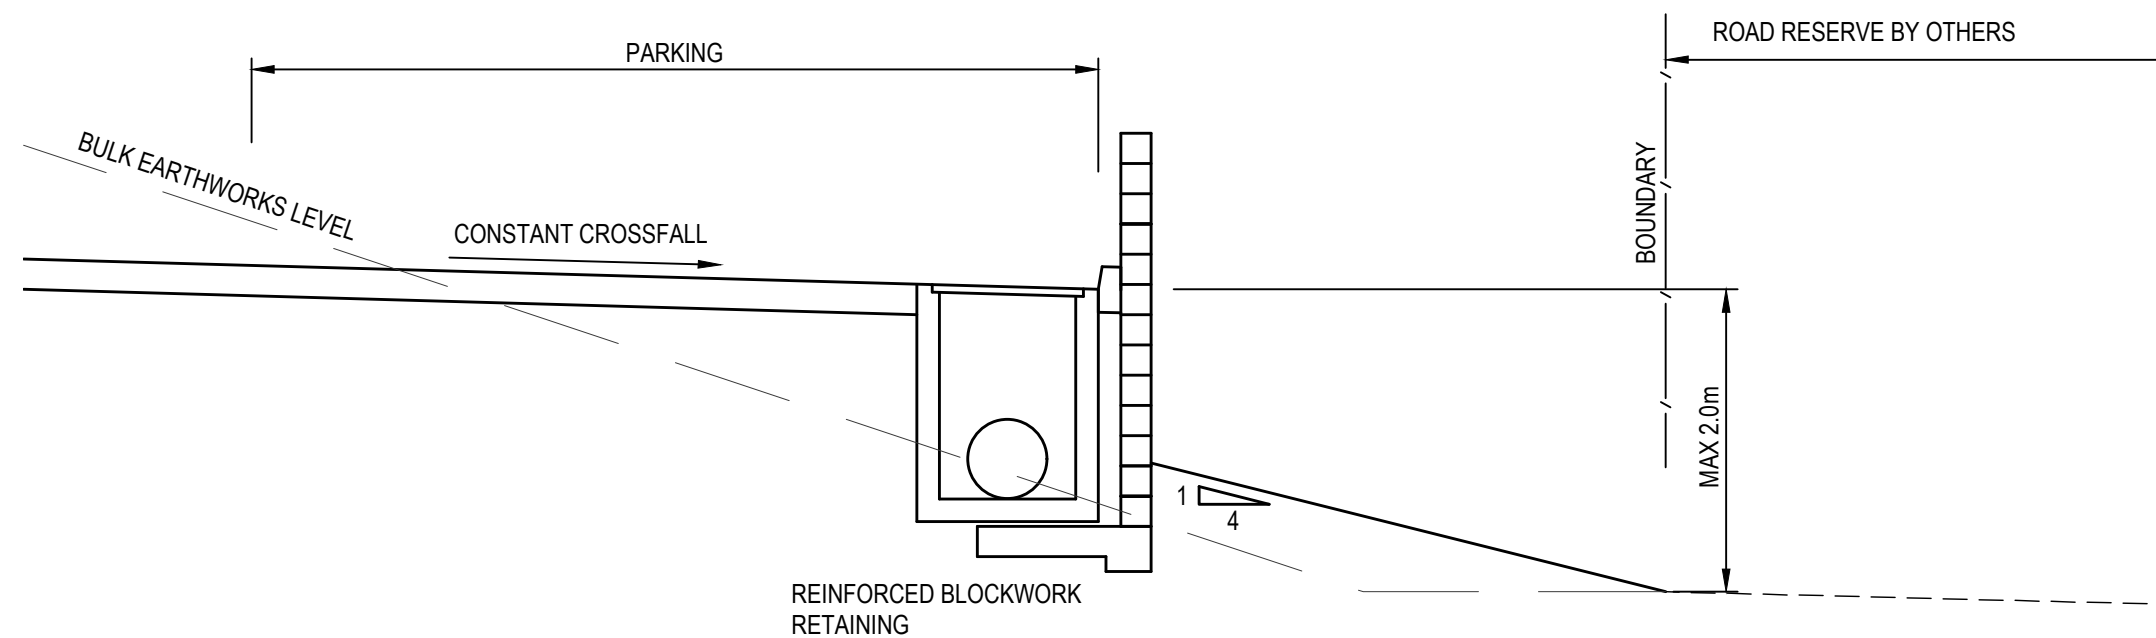


TYPICAL WESTERN BOUNDARY RETAINING WALL

DETAIL C  
SCALE = 1:50

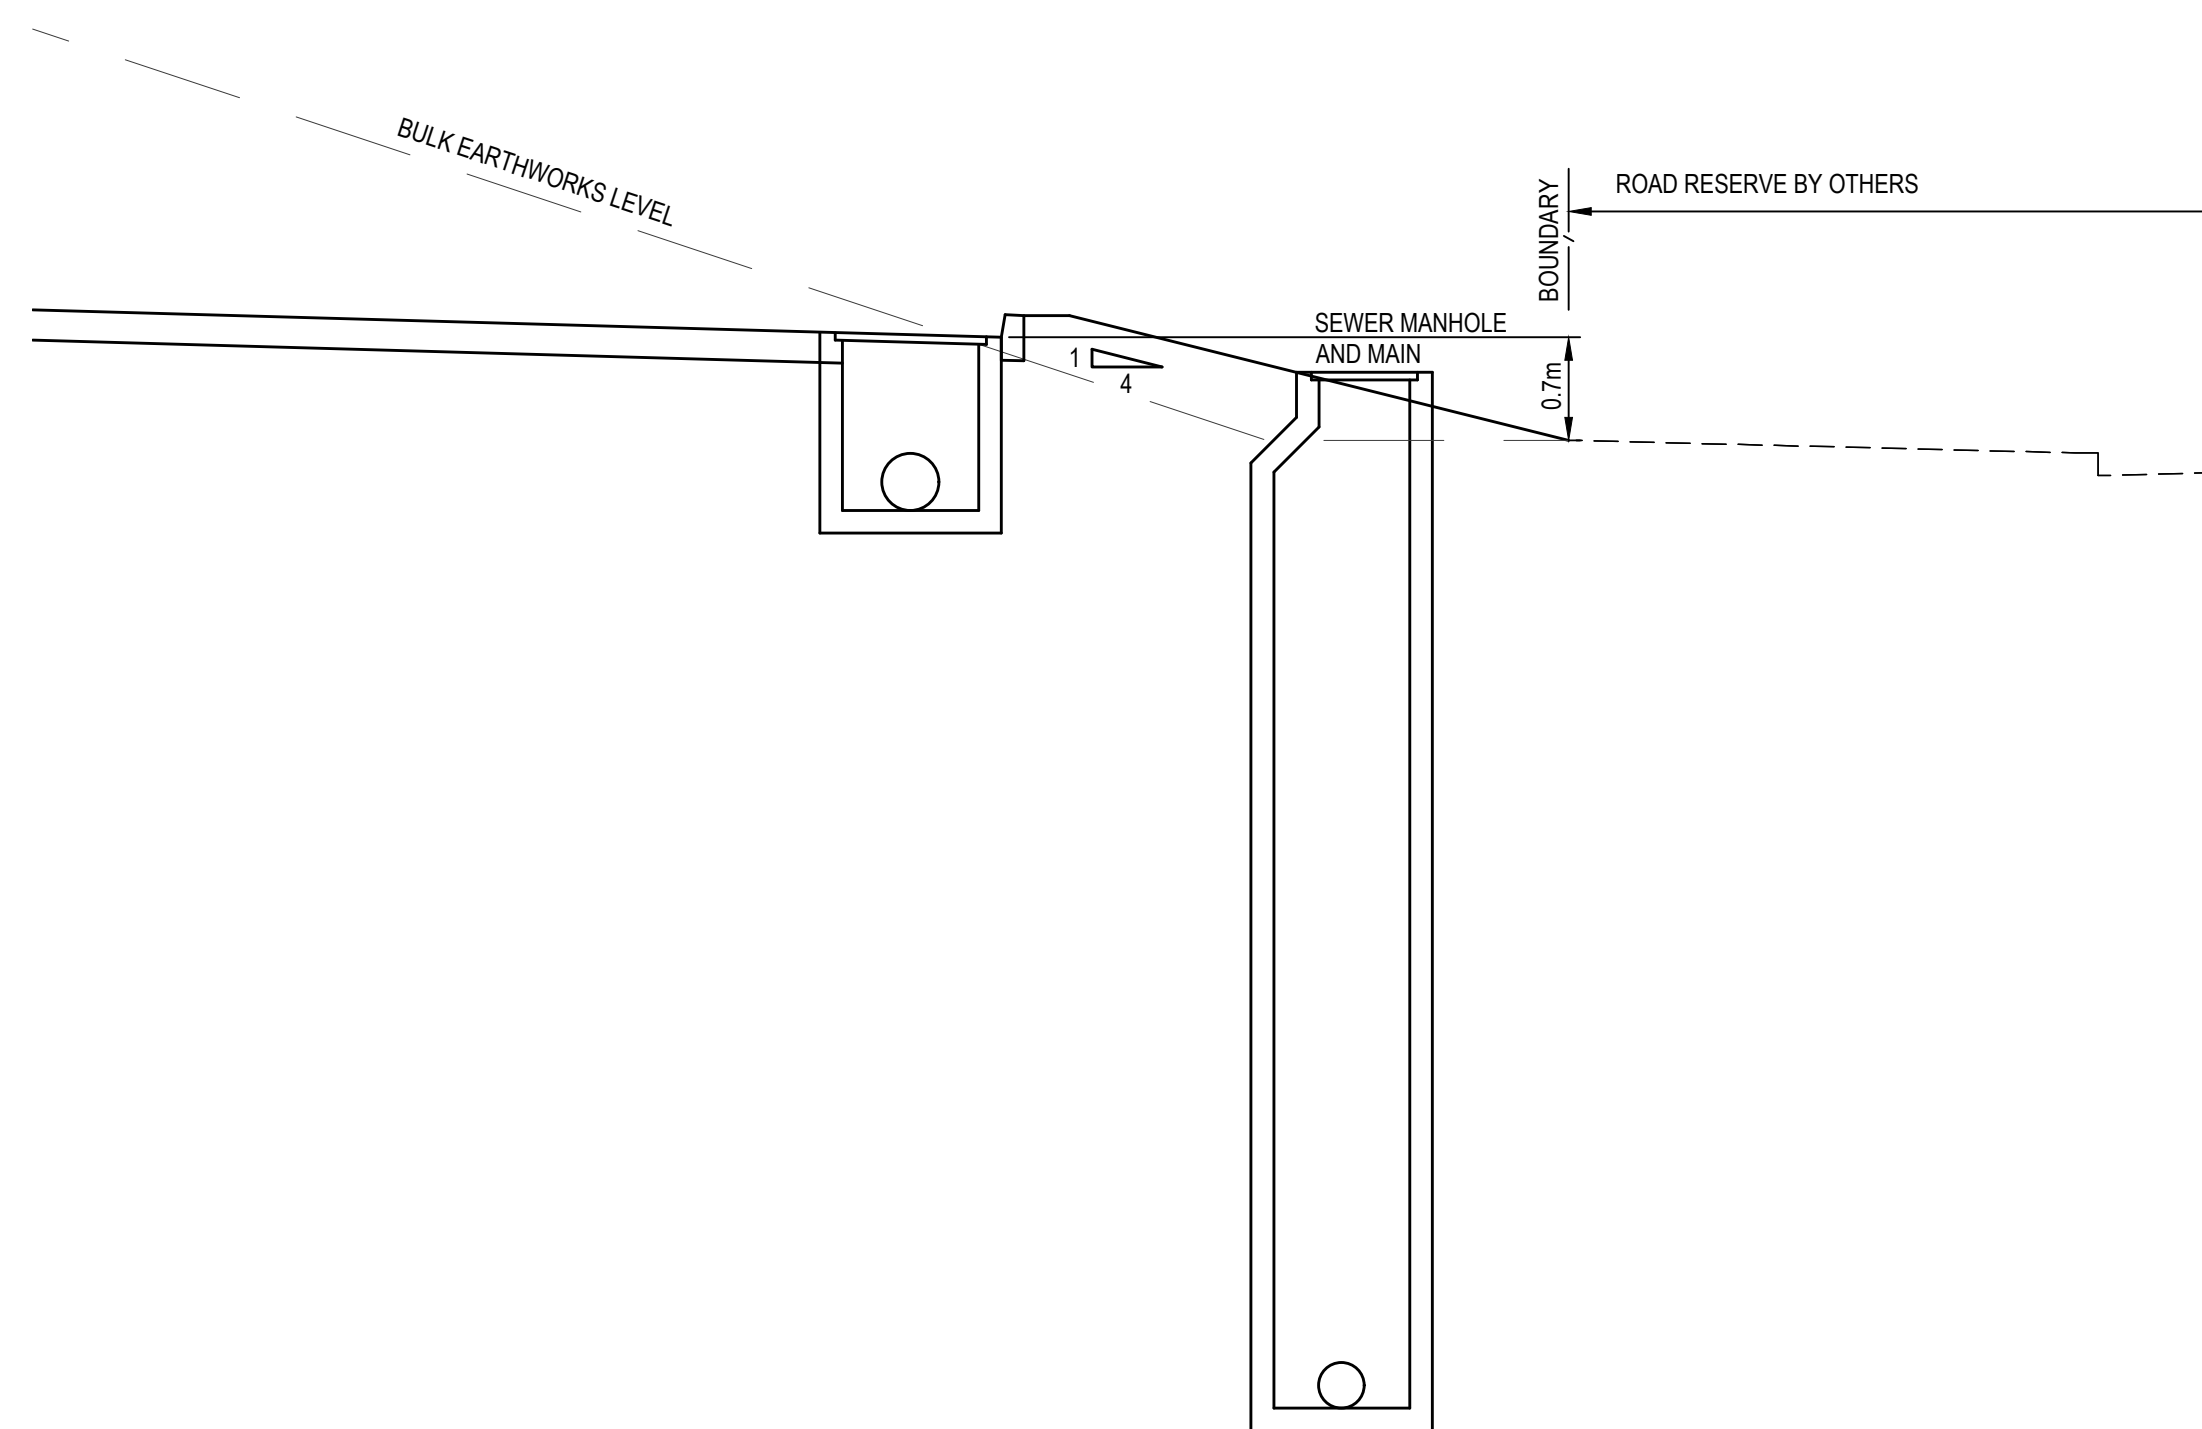

TYPICAL WESTERN BOUNDARY NO RETAINING WALL

DETAIL F  
SCALE = 1:50

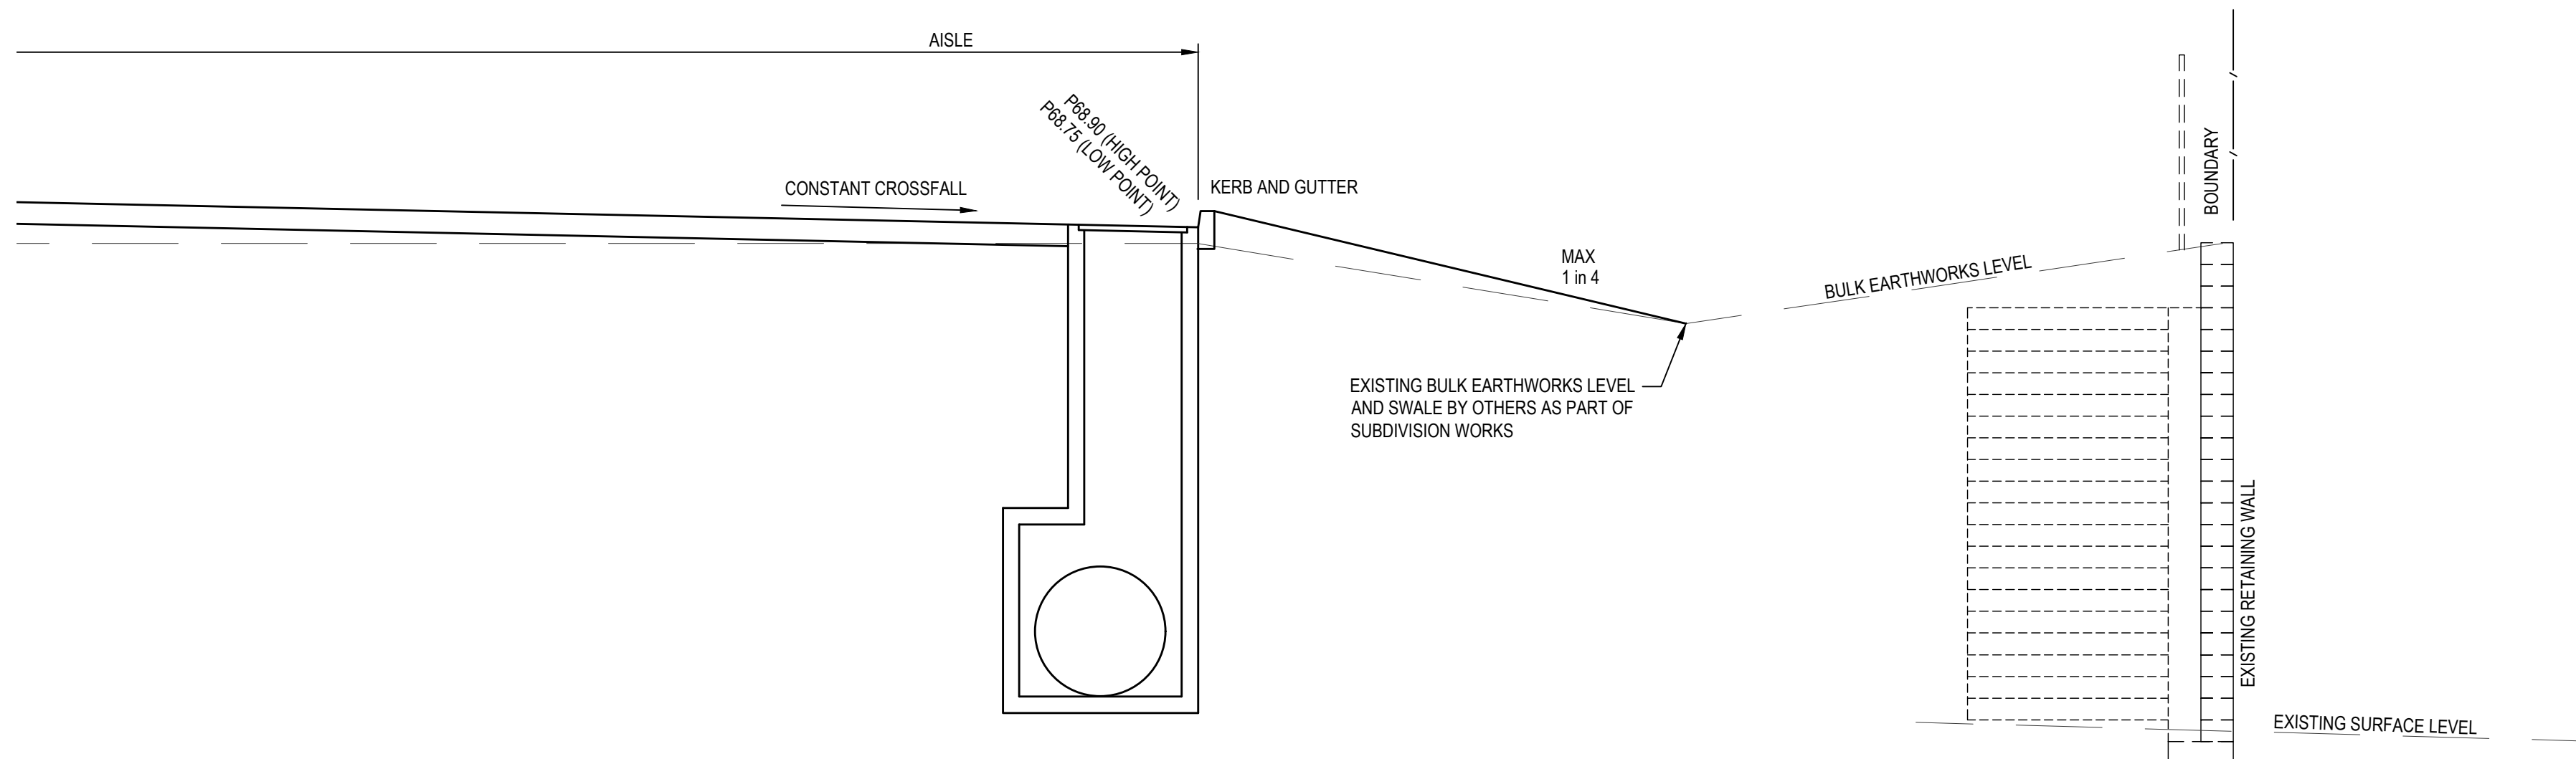

TYPICAL NORTHERN BOUNDARY RETAINING WALL - FILL

DETAIL H  
SCALE = 1:50

© COPYRIGHT of this design and plan is the property of ACOR Consultants Pty Ltd, ACN 079 306 245. All rights reserved. It must not be used, modified, reproduced or copied wholly or in part without written permission from ACOR Consultants Pty Ltd.

This drawing has been assigned an electronic code that signifies the drawing has been checked and approved by:				
A	ISSUED FOR DA	14.06.17	RAS	SRW
P3	ISSUED FOR REVIEW	08.03.17	RAS	SRW
P2	ISSUED FOR REVIEW	21.02.17	RAS	SRW
P1	ISSUED FOR REVIEW	17.10.16	RAS	SRW
Issue	Description	Date	Drawn	Approved
Now at full size				

Client



Architect



**ACOR Consultants Pty Ltd**  
Unit 10, Level 1, No.1 Maitland Place  
Baulkham Hills NSW 2153  
T +61 2 9634 6311

Project


**COSTCO OAKDALE DEPOT**  
ESTATE ROAD 1  
OAKDALE SOUTH ESTATE, NSW

Drawing Title  
SITEWORKS SECTIONS  
SHEET 2 OF 2

Drawn	Date	Scale	B1	Q.A. Check	Date
RAS	JULY 2016	AS SHOWN			
Designed	Project No.	Dwg. No.	Issue		
SRW	NW160037	DAC3.02	A		

NOT FOR CONSTRUCTION




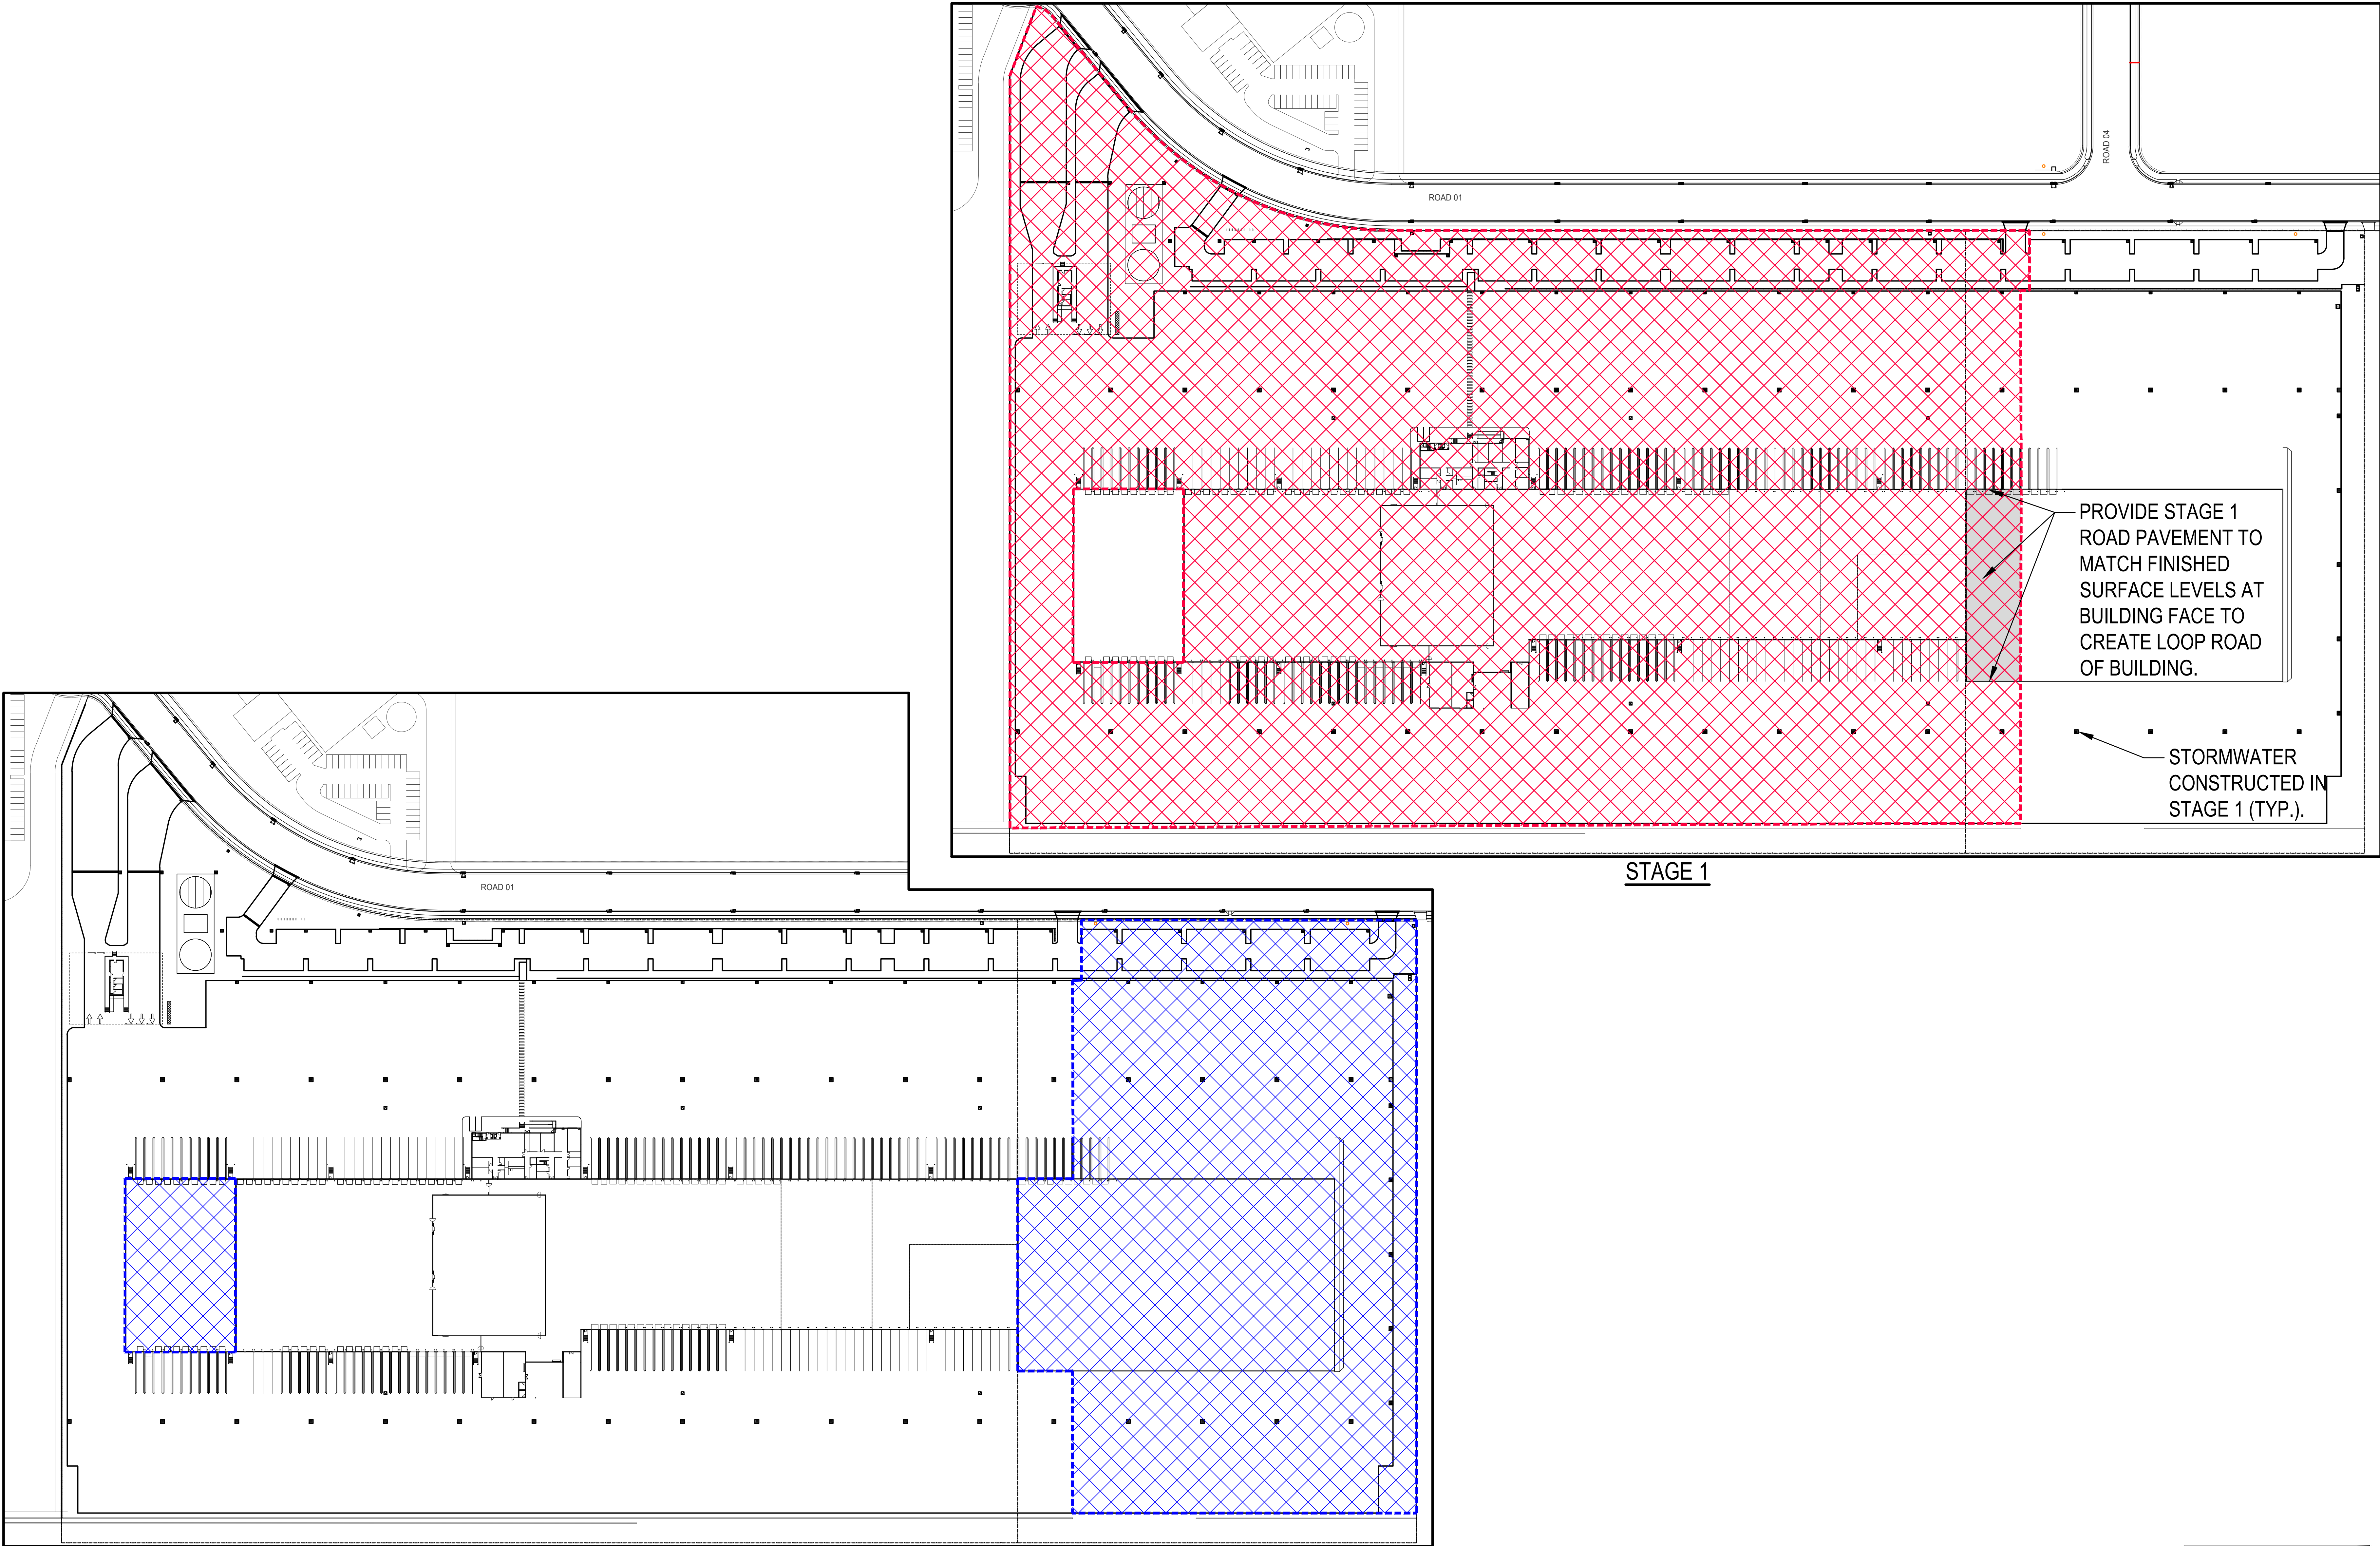

©COPYRIGHT of this design and plan is the property of ACOR Consultants Pty Ltd, ACN 079 306 245 ABN 40 079 306 245, all rights reserved. It must not be used, modified, reproduced or copied wholly or in part without written permission from ACOR Consultants Pty Ltd.

This drawing has been assigned an electronic code that signifies the drawing has been checked and approved by

A		ISSUED FOR DA		14.06.17	RAS	SRW
P1		ISSUED FOR REVIEW		08.03.17	RAS	SRW
Issue		Description		Date	Drawn	Approved
New or full size		None		200m		

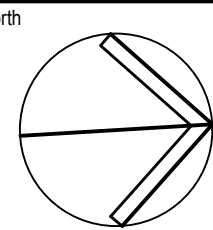

STAGE 2



SCALE 1:1000 0 10 20 40 60 80 100m



**ACOR Consultants Pty Ltd**  
Unit 10, Level 1, No.1 Maitland Place  
Baulkham Hills NSW 2153  
T +61 2 9634 6311



Project  
**COSTCO OAKDALE DEPOT**  
**ESTATE ROAD 1**  
**OAKDALE SOUTH ESTATE, NSW**


Drawing Title  
**CIVIL WORKS**  
**CONSTRUCTION STAGING PLAN**










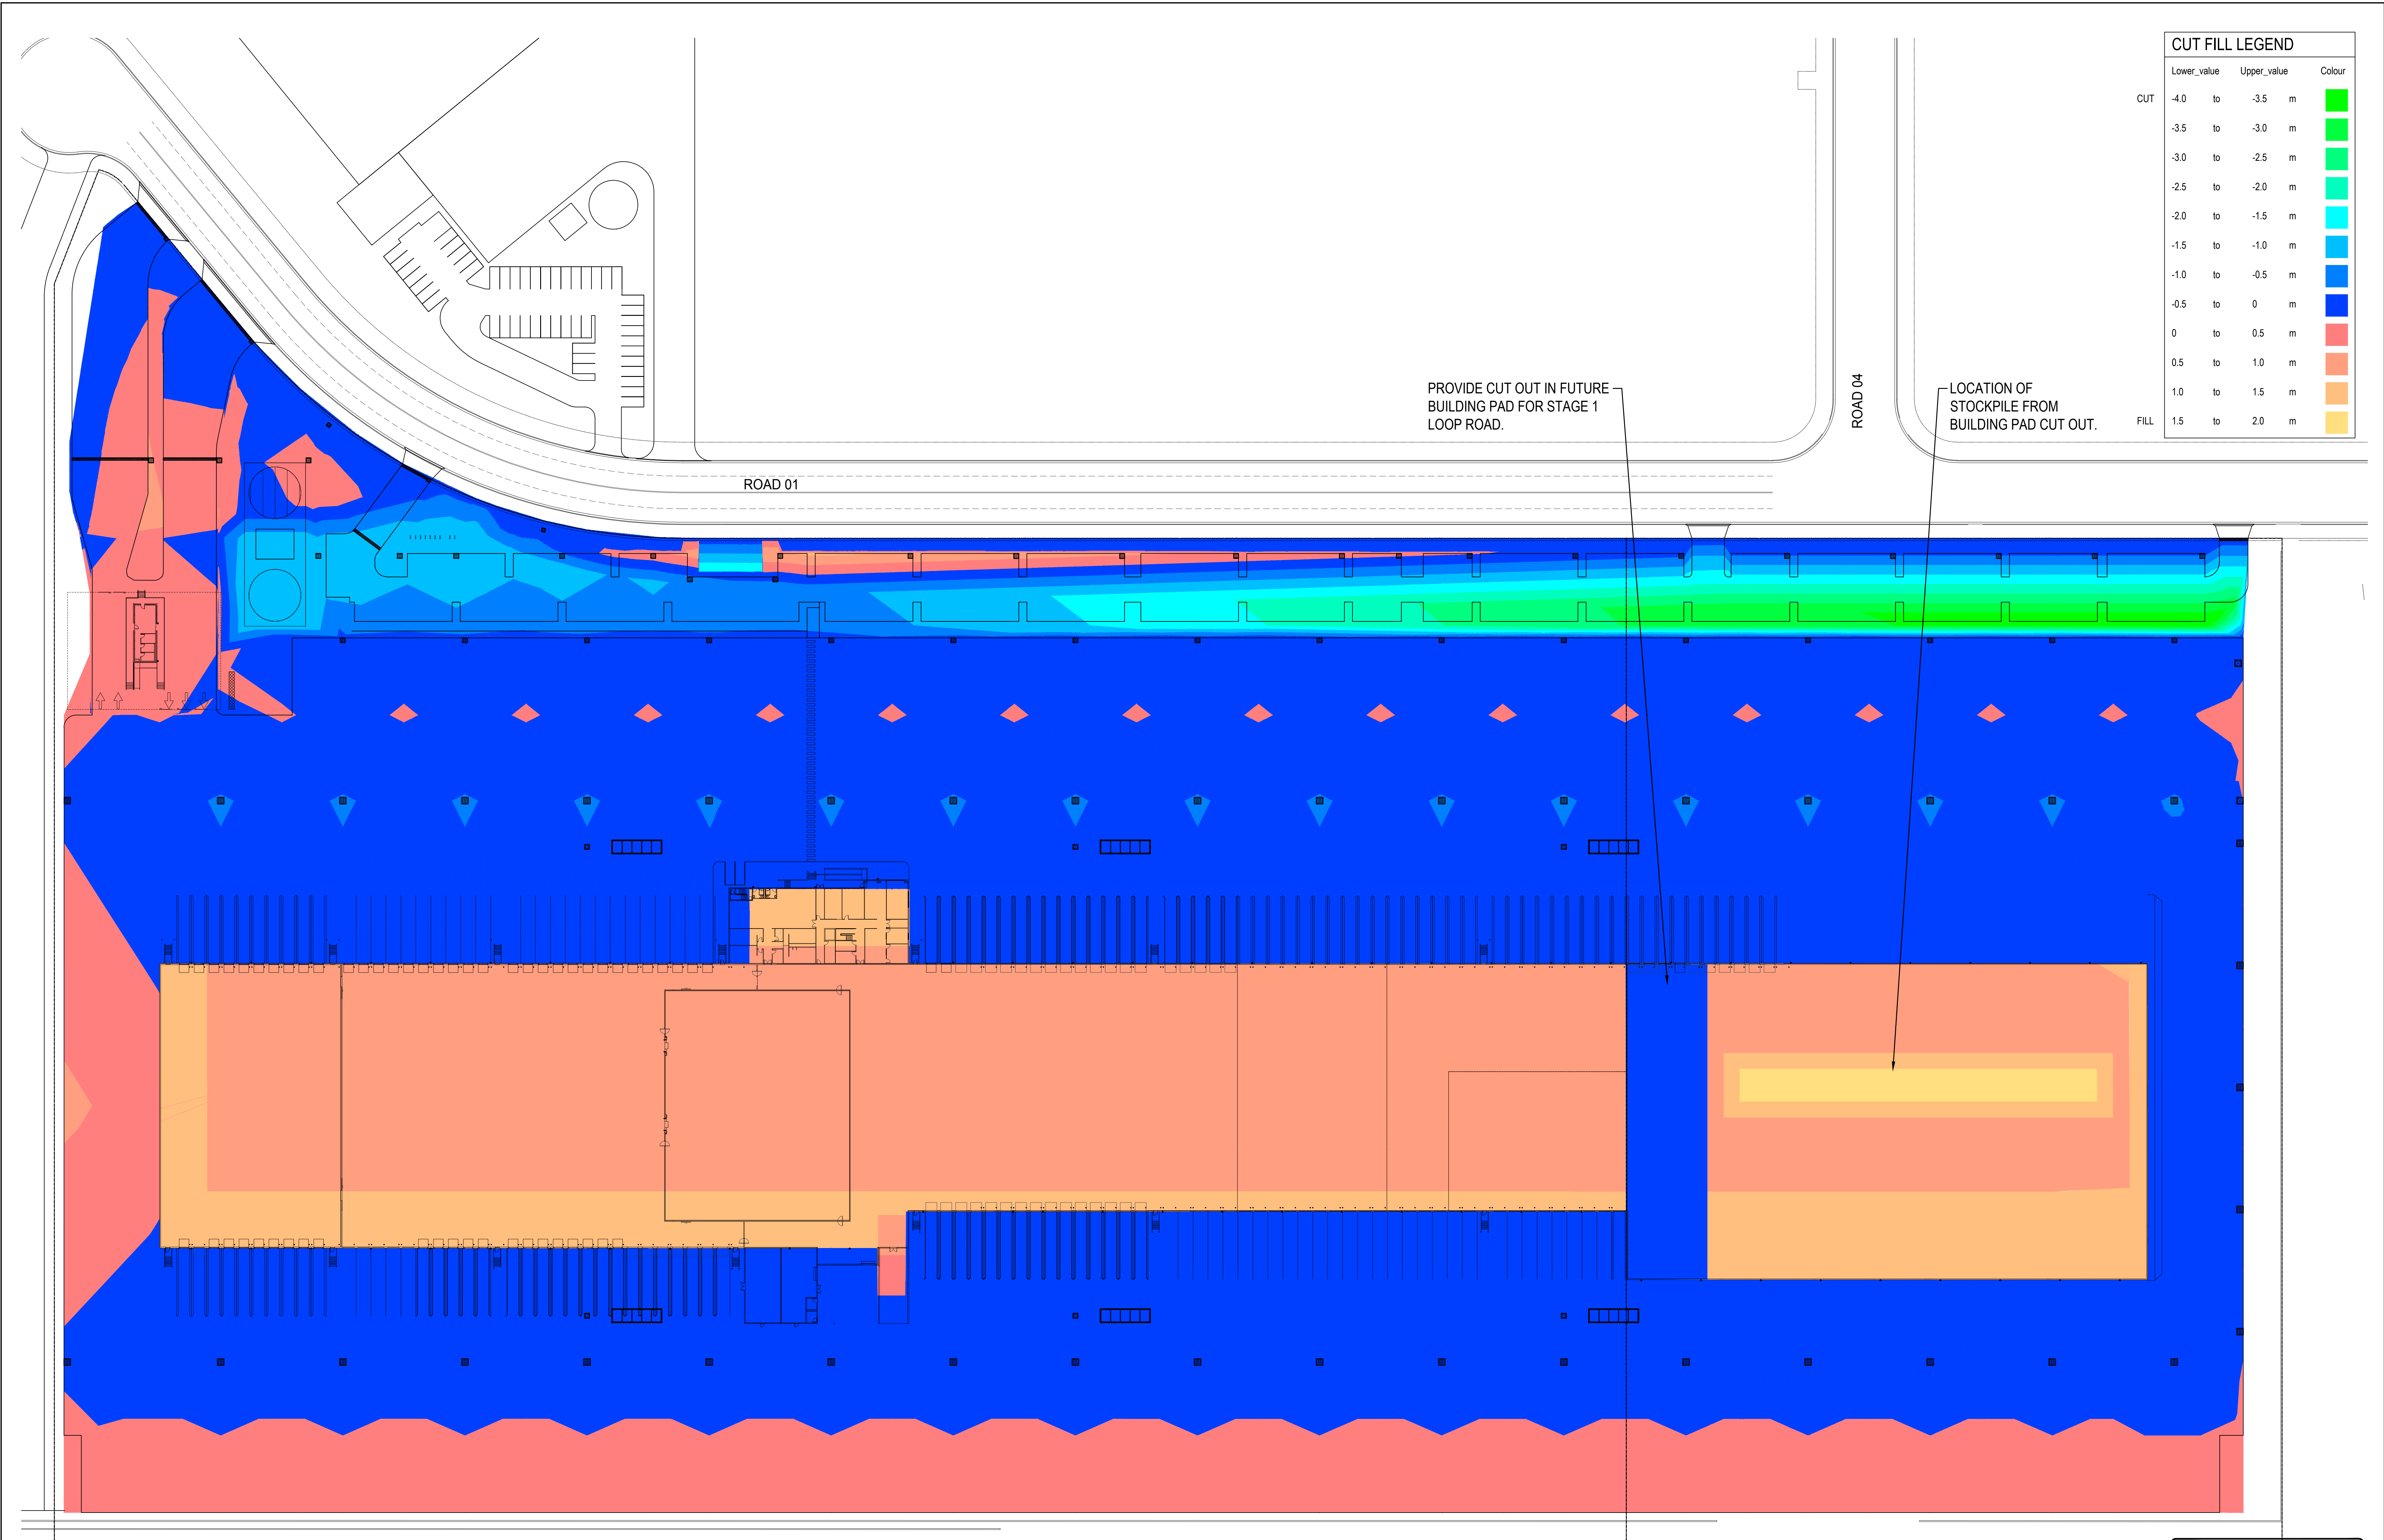

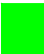
Drawn	Date	Scale	B1	Q.A. Check	Date
RAS	APRIL 2016	AS SHOWN			
Designed	Project No.	Dwg. No.	Issue		
SRW	NW160037	DAC4.01	A		

NOT FOR CONSTRUCTION

P:\NW160037\Drawings\Civil\Staging\NW160037\_DAC4.01.dwg  
Jan 14 2017 11:38am






CUT FILL LEGEND					
	Lower_value		Upper_value		Colour
CUT	-4.0	to	-3.5	m	
	-3.5	to	-3.0	m	
	-3.0	to	-2.5	m	
	-2.5	to	-2.0	m	
	-2.0	to	-1.5	m	
	-1.5	to	-1.0	m	
	-1.0	to	-0.5	m	
	-0.5	to	0	m	
FILL	0	to	0.5	m	
	0.5	to	1.0	m	
	1.0	to	1.5	m	
	1.5	to	2.0	m	

©COPYRIGHT of this design and plan is the property of ACOR Consultants Pty Ltd, ACN 079 306 245 ABN 40 079 306 245, all rights reserved. It must not be used, modified, reproduced or copied wholly or in part without written permission from ACOR Consultants Pty Ltd.

This drawing has been assigned an electronic code that signifies the drawing has been checked and approved by

A	ISSUED FOR DA	14.06.17	RAS	SRW
P1	ISSUED FOR REVIEW	08.03.17	RAS	SRW
Issue	Description	Date	Drawn	Approved
100m				

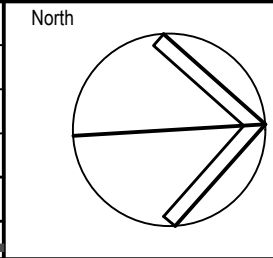

Client



Architect



SCALE 1:600



**ACOR Consultants Pty Ltd**  
Unit 10, Level 1, No.1 Maitland Place  
Baulkham Hills NSW 2153  
T +61 2 9634 6311

Project

**COSTCO OAKDALE DEPOT**  
ESTATE ROAD 1  
OAKDALE SOUTH ESTATE, NSW






Drawing Title  
**CIVIL WORKS**  
**BULK EARTHWORKS STAGE 1 CUT / FILL PLAN**

Drawn	Date	Scale	B1	G.A. Check	Date
RAS	APRIL 2016	AS SHOWN			
Designed	Project No.	Dwg. No.	Issue		
SRW	NW160037	DAC6.01	A		


NOT FOR CONSTRUCTION

\\NW160037\Drawings\ACOR\Drawings\NW160037\_DWG01.dwg  
Jan 14 2017 - 11:58am



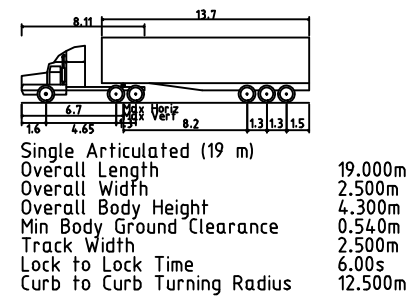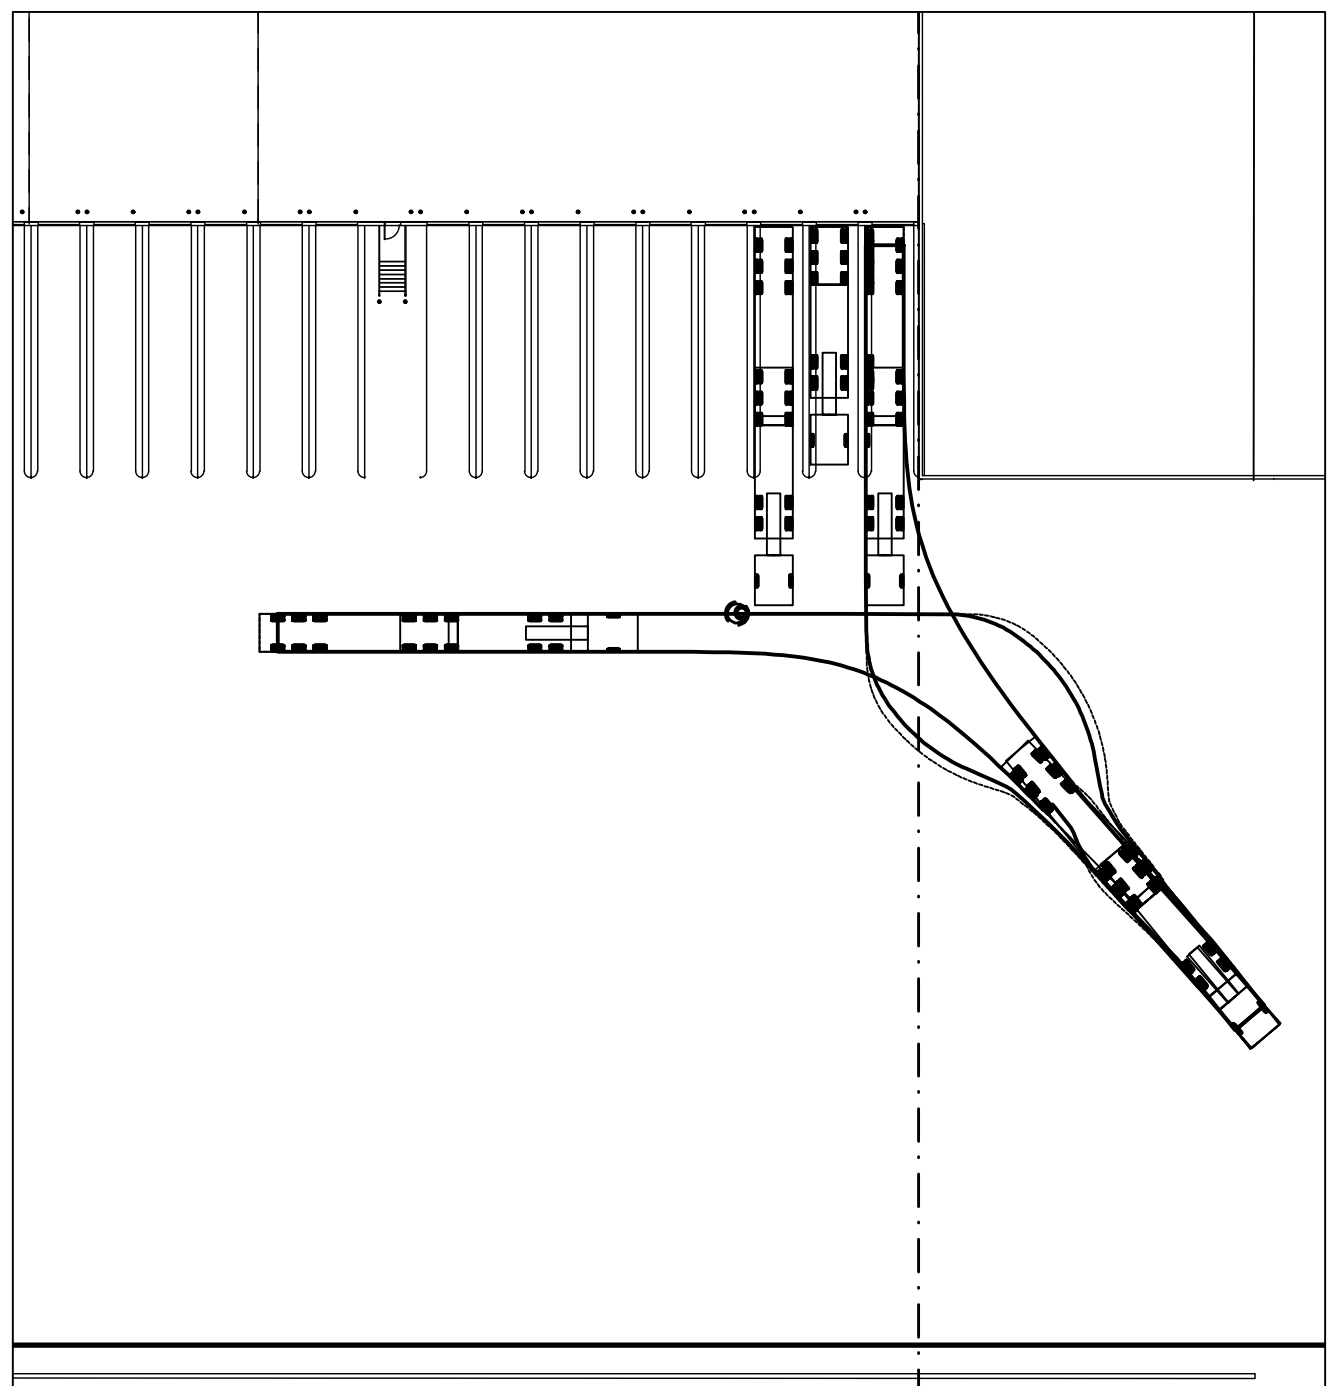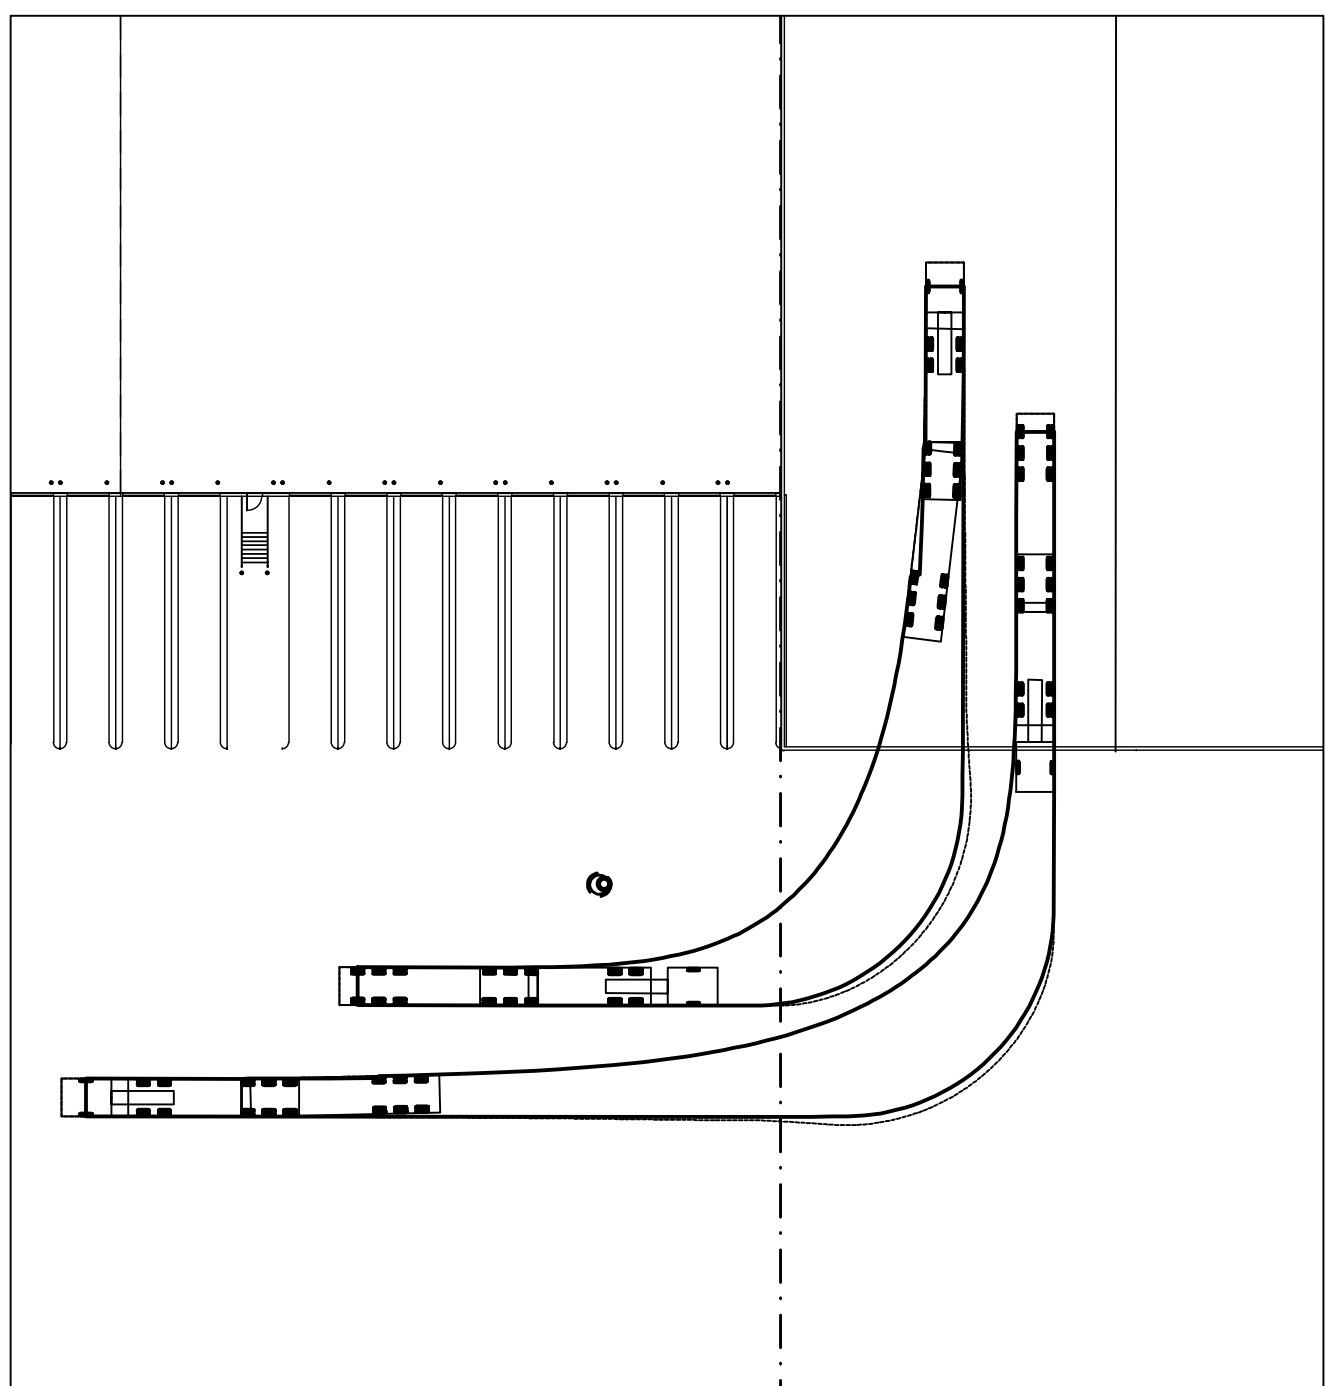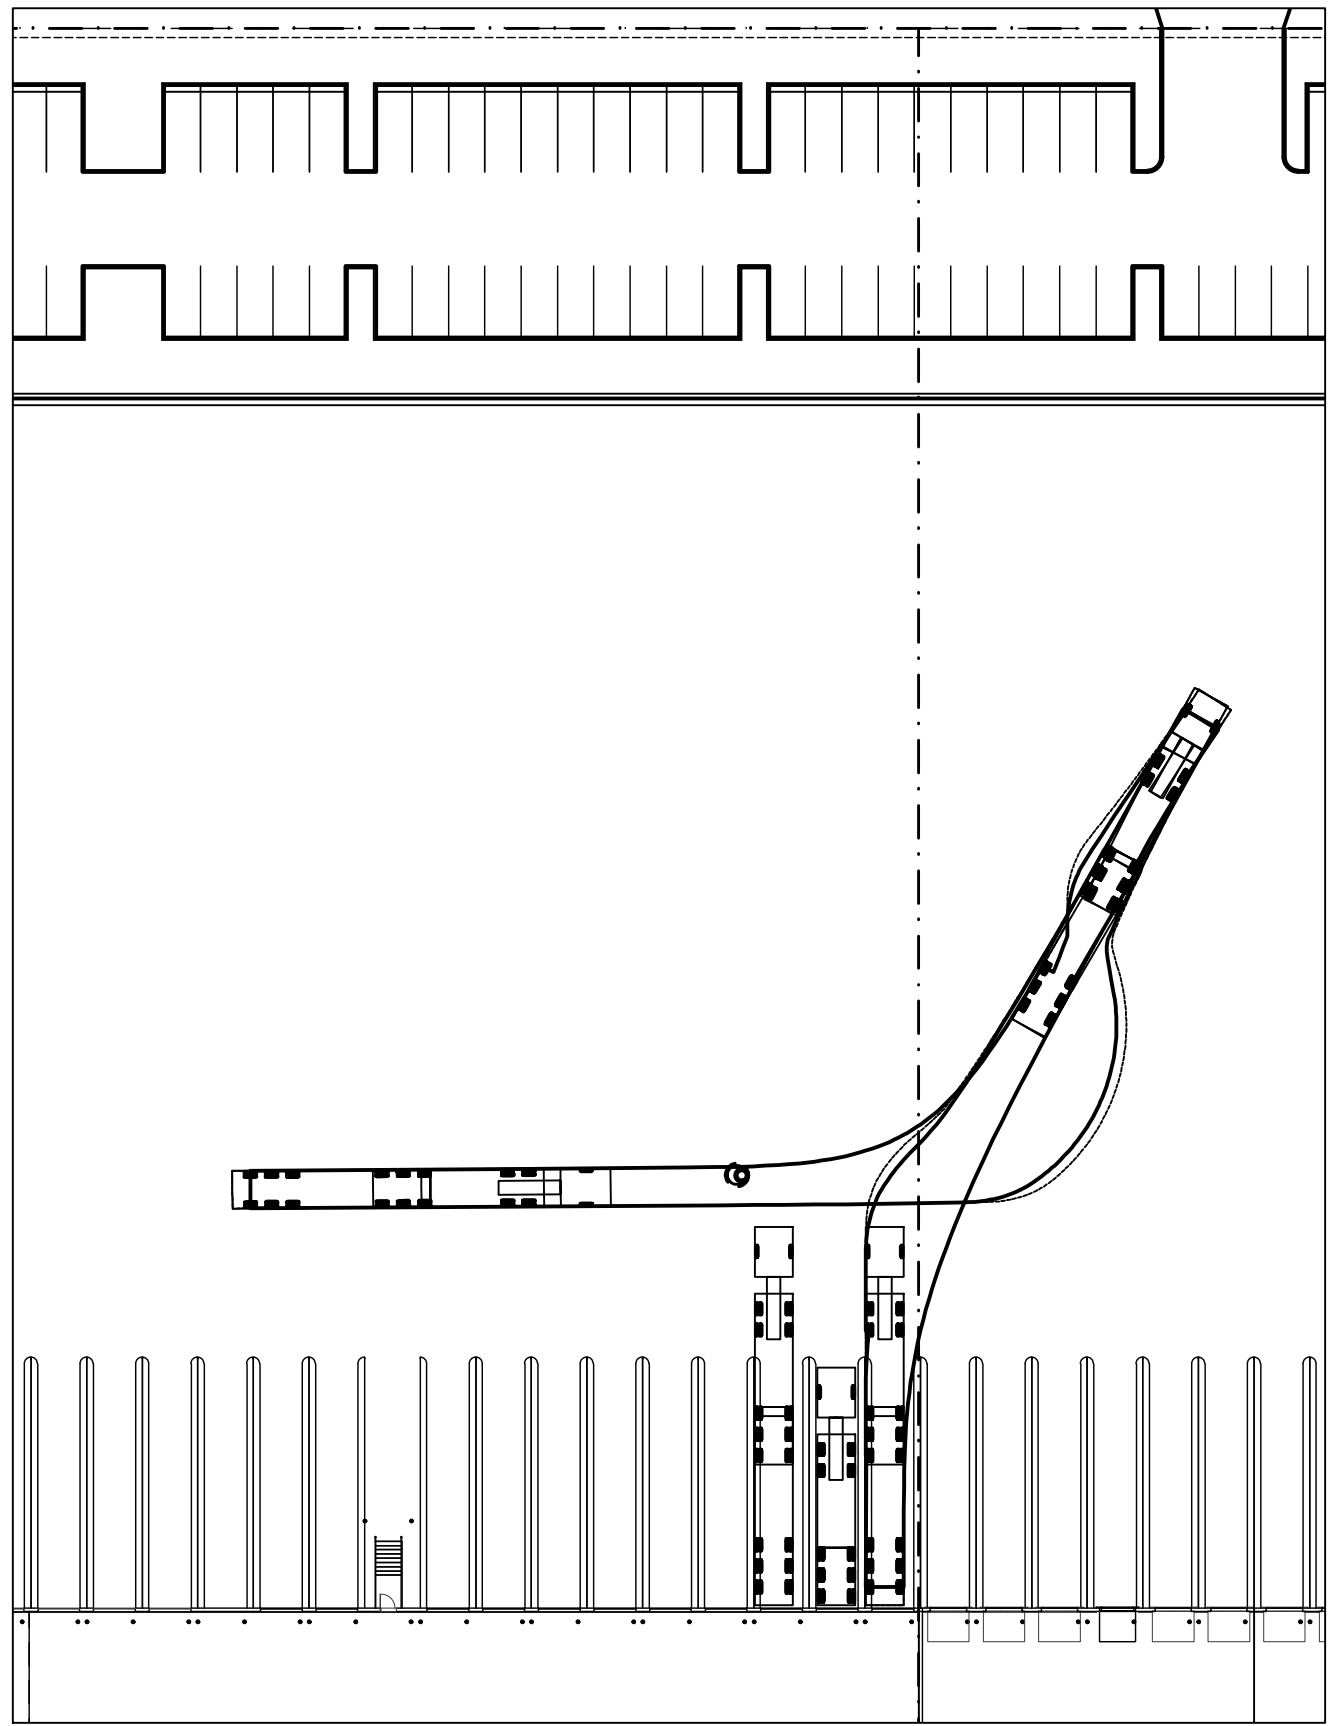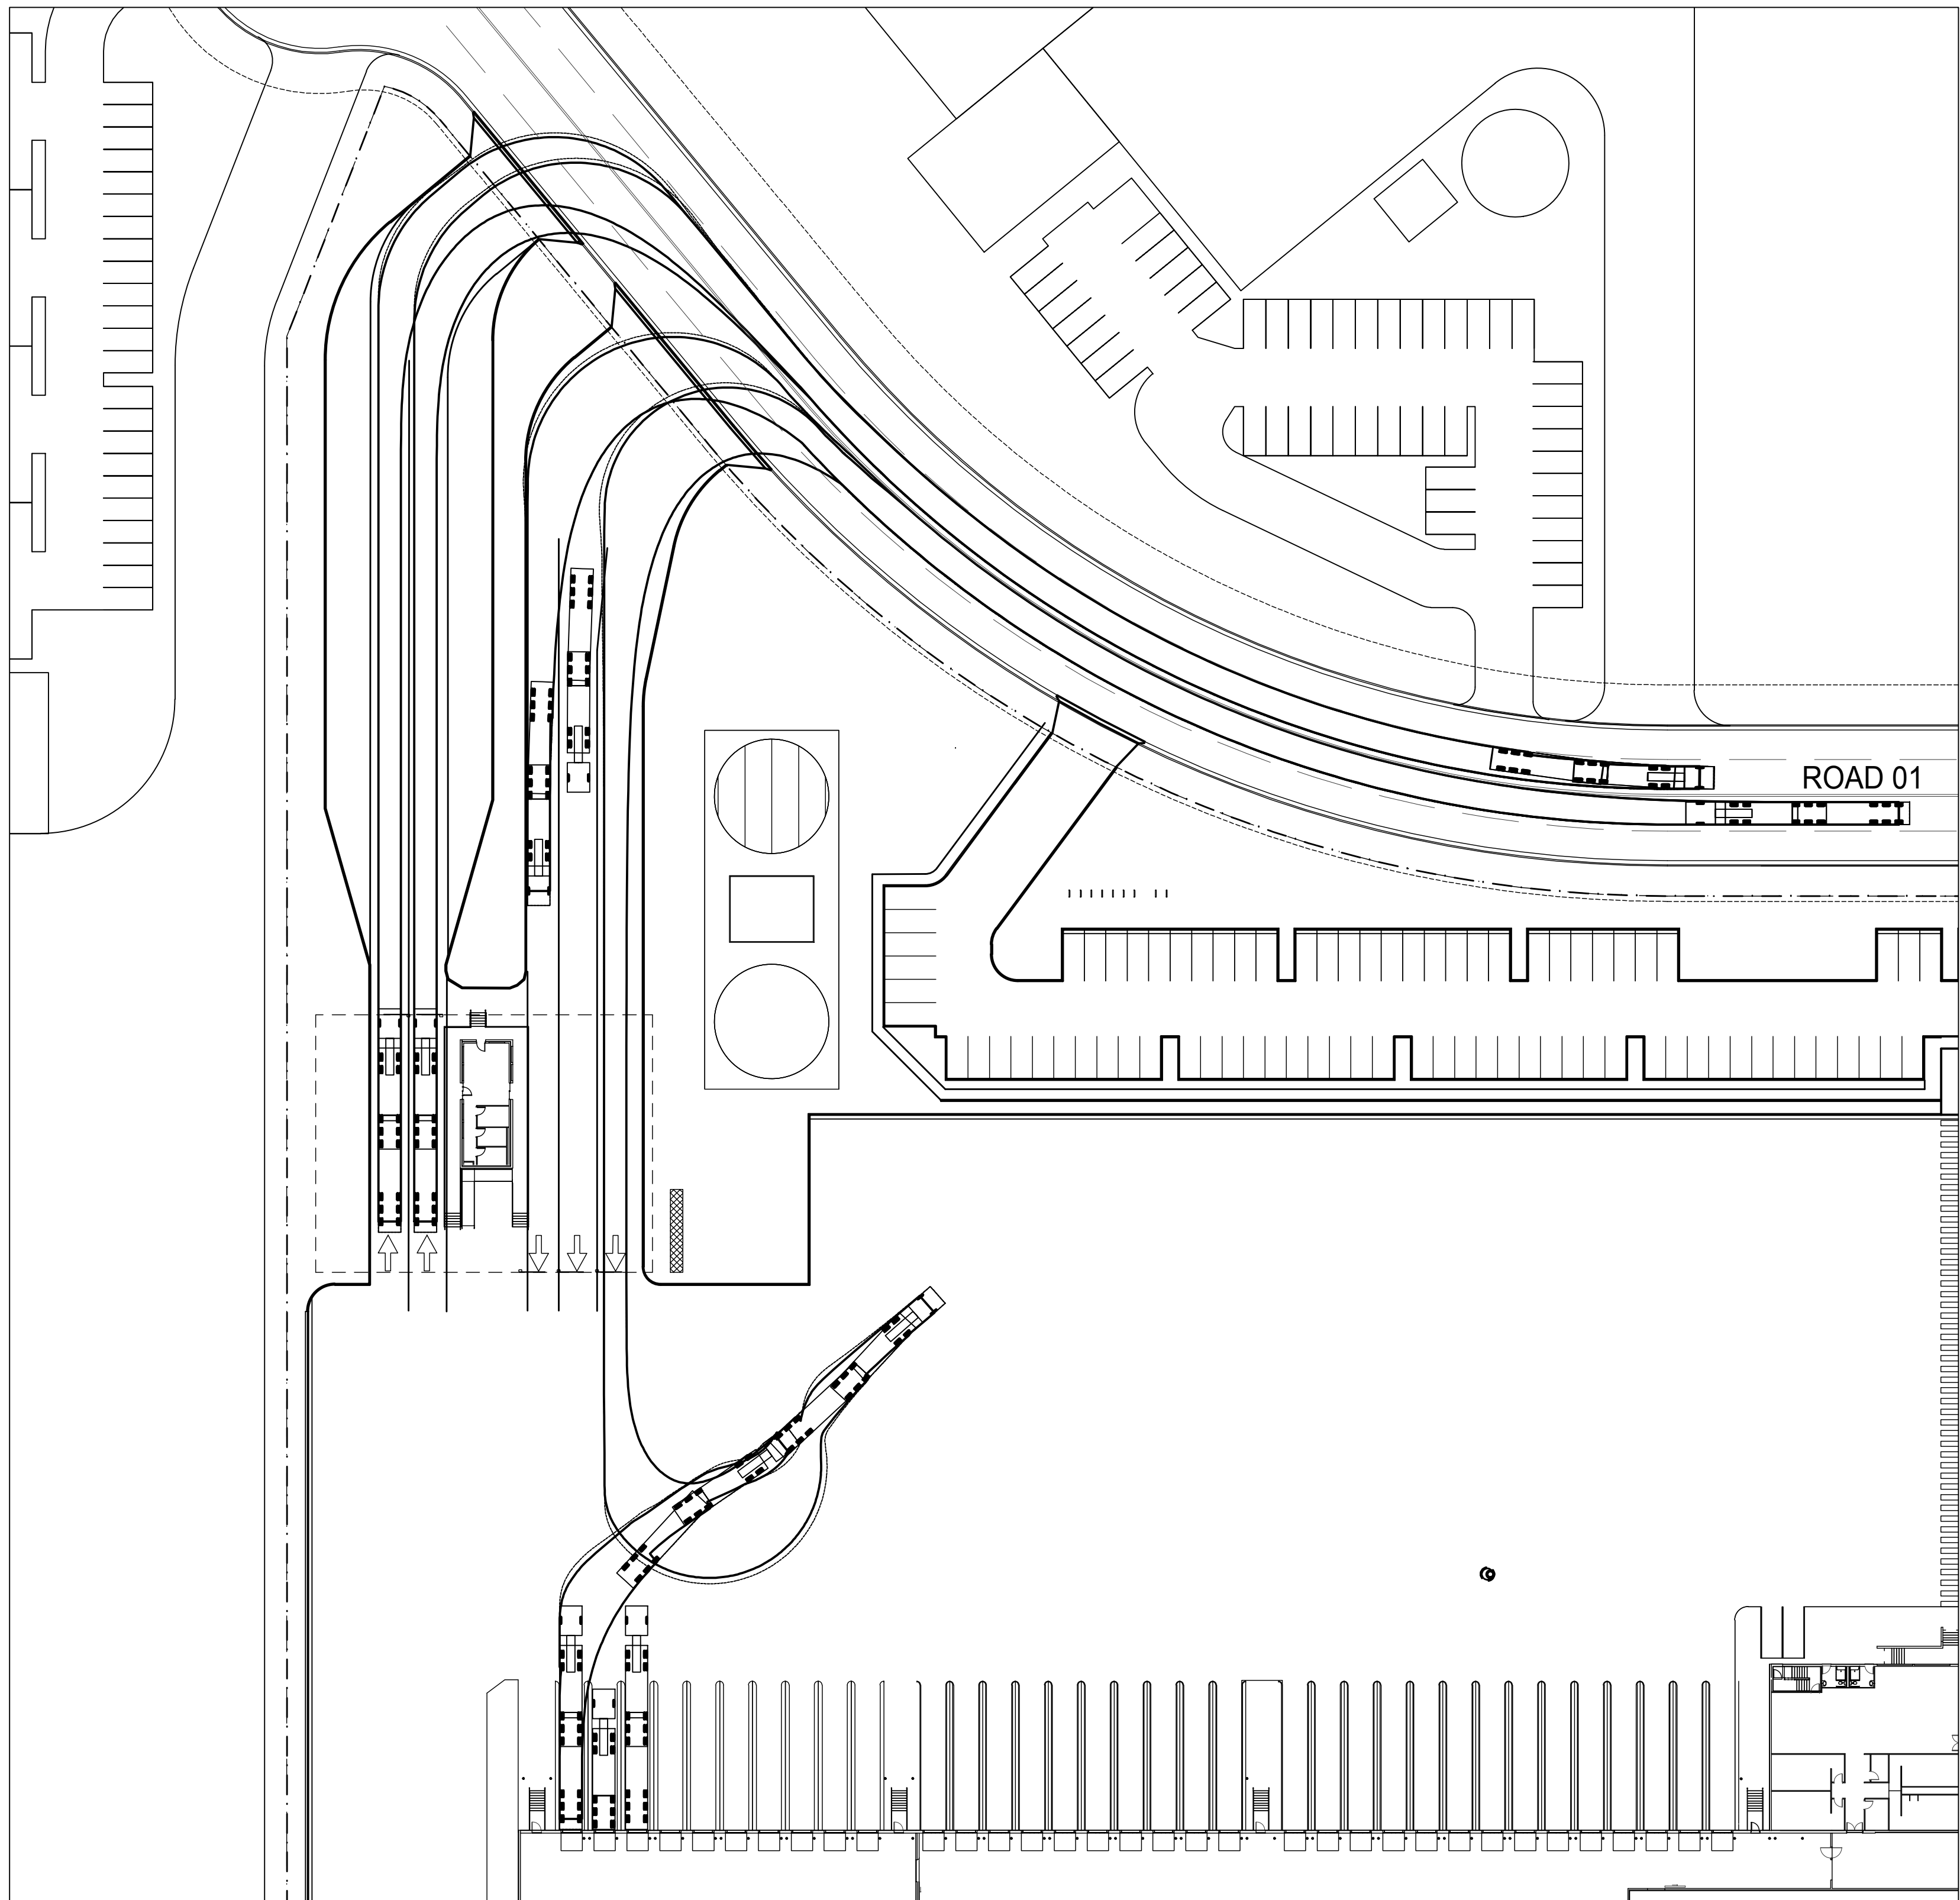

This drawing has been assigned an electronic code that signifies the drawing has been checked and approved by:			
A	ISSUED FOR DA	14.06.17	RAS SRW
P5	ISSUED FOR REVIEW	08.03.17	RAS SRW
P4	ISSUED FOR REVIEW	21.02.17	RAS SRW
P3	ISSUED FOR REVIEW	14.10.16	RAS SRW
Issue	Description	Date	Drawn Approved

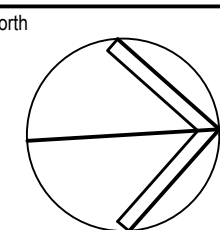

**GROUPSA**

SCALE 1:500



AcOR  
CONSULTANTS

**ACOR Consultants Pty Ltd**  
Unit 10, Level 1, No.1 Maitland Place  
Baulkham Hills NSW 2153  
T +61 2 9634 6311

STRUCTURE PLANNERS | DEVELOPMENT CONSULTANTS

Project  
COSTCO OAKDALE DEPOT  
ESTATE ROAD 1  
OAKDALE SOUTH ESTATE, NSW

Drawing Title
CIVIL WORKS
VEHICLE TURNING PATH PLAN

Drawn <b>RAS</b>	Date <b>APRIL 2016</b>	Scale <b>AS SHOWN</b>	Q.A. Check  Date	
Designed <b>SRW</b>	Project No. <b>NW160037</b>		Dwg. No. <b>DAC6.11</b>	Issue <b>A</b>

NOT FOR CONSTRUCTION

Jun 14, 2017 - 11:57 am P:\NW\NW\65037 Drawings\City Drawings\NW\65037\_0408\_11.dwg



LEGEND

GEOTEXTILE FILTER FABRIC DROP INLET SEDIMENT TRAP.

SANDBAG SEDIMENT TRAP AT KERB ON GRADE PIT

SANDBAG SEDIMENT TRAP AT KERB SAG PIT

SEDIMENT CONTROL FENCE

SITE ACCESS PAD

NOTES

1. THIS DRAWING IS FOR GUIDANCE PURPOSES ONLY - THE SOIL & EROSION CONTROLS SHOWN ARE INDICATIVE AND REMAIN SUBJECT TO CONSTRUCTION METHODOLOGY - THE CONTRACTOR SHALL AT ALL TIMES REMAIN RESPONSIBLE FOR COMPLIANCE WITH ALL LAWS AND REGULATIONS PERTAINING TO SAFETY AND PROTECTION OF THE ENVIRONMENT.

2. ALL SOIL & EROSION CONTROLS TO BE INSTALLED AND MAINTAINED IN ACCORDANCE WITH COUNCIL GUIDELINES AND CONDITIONS AND THE CURRENT NSW DEPT OF CONSERVATION & LAND MANAGEMENT "URBAN EROSION AND SEDIMENT CONTROL" HANDBOOK.

3. CONTRACTOR TO ENSURE THAT SEDIMENT IS NOT ALLOWED TO ENTER ADJACENT LOTS OR DOWNSTREAM STORMWATER SYSTEMS. ANY DAMAGE WHATSOEVER CAUSED THROUGH BREACH OF THIS CONDITION BY THE CONTRACTOR SHALL BE RECTIFIED SOLELY AT THE CONTRACTOR'S COST.

4. ANY FINE, FEE, LEVY OR THE LIKELY IMPOSED BY THE REGULATORY AUTHORITY AS A CONSEQUENCE OF THE CONTRACTOR'S ACTS OR OMISSIONS SHALL BE PAID BY THE CONTRACTOR EITHER DIRECTLY OR INDIRECTLY VIA CREDIT VARIATION TO THE CONTRACT SUM.

SOIL AND EROSION CONTROL CONCEPT NOTES

GENERAL INSTRUCTIONS

1. ALL WATER AND SOIL MANAGEMENT WORKS TO BE IN ACCORDANCE WITH COUNCIL REQUIREMENTS, STANDARDS AND NOTES ON THIS SHEET

2. TEMPORARY CONSTRUCTION ENTRY/EXIT LOCATION TO BE DETERMINED BY BUILDER PRIOR TO COMMENCEMENT OF CONSTRUCTION

3. THESE PLANS ARE TO BE READ IN CONJUNCTION WITH THE ENGINEERING PLANS AND ANY OTHER PLANS WRITTEN INSTRUCTIONS THAT MAY BE ISSUED AND RELATING TO DEVELOPMENT AT THE SUBJECT SITE

4. ENSURE THAT ALL SOIL AND WATER MANAGEMENT WORKS ARE AS A MINIMUM UNDERTAKEN AS GUIDED BY THESE DRAWINGS AND CONSTRUCTED FOLLOWING THE GUIDELINES STATED IN "MANAGING URBAN STORMWATER: SOILS AND CONSTRUCTION (2004)"

5. THE CONTRACTORS STAFF AND SUBCONTRACTORS TO BE INFORMED BY CONTRACTOR OF THEIR RESPONSIBILITIES IN MINIMISING THE POTENTIAL FOR SOIL EROSION AND POLLUTION TO DOWNSLOPE LANDS AND WATERWAYS AND PROTECTION OF THE ENVIRONMENT.

EROSION CONTROL CONDITIONS

6. STOCKPILES SHALL BE STABILISED DURING CONSTRUCTION WITH A TEMPORARY GRASS COVER

7. STOCKPILES STABILISED WITH TEMPORARY GRASS COVER SHALL BE MAINTAINED AND WATERED REGULARLY AT LEAST WEEKLY UNTIL AN EFFECTIVE COVER HAS PROPERLY ESTABLISHED AND PLANTS ARE GROWING VIGOROUSLY. FURTHER APPLICATION OF SEED MIGHT BE NECESSARY IN AREAS OF INADEQUATE VEGETATION ESTABLISHMENT.

8. WHERE PRACTICAL FOOT AND VEHICULAR TRAFFIC WILL BE KEPT AWAY FROM STABILISED AREAS.

9. ALL EARTHWORKS INCLUDING SPILLWAYS AND THEIR OUTLETS SHALL BE CONSTRUCTED TO BE STABLE IN AT LEAST THE DESIGN STORM EVENT AS SPECIFIED IN MANAGING URBAN STORMWATER SOILS AND CONSTRUCTION (2004)

10. DURING WINDY CONDITIONS, LARGE UNPROTECTED AREAS WILL BE KEPT MOIST (NOT WET) BY SPRINKLING WITH WATER TO KEEP DUST UNDER CONTROL. IN THE EVENT WATER IS NOT AVAILABLE IN SUFFICIENT QUANTITIES, SOIL BINDERS AND/OR DUST RETARDANTS WILL BE USED TO RESIST DUST REMOVAL BY WIND.

POLLUTION CONTROL CONDITIONS

11. STOCKPILES ARE NOT TO BE LOCATED WITHIN 5 METRES OF HAZARD AREAS INCLUDING AREAS OF FLOWS SUCH AS WATERWAYS AND PROPOSED PAVED AREAS. SPECIAL SEDIMENT CONTROL MEASURES SHALL BE TAKEN AT STOCKPILES TO MINIMISE POSSIBLE POLLUTION TO DOWNSLOPE WATERS EG. THROUGH INSTALLATION OF SEDIMENT FENCING. FOR DETAILS OF STOCKPILE TREATMENT REFER SD4-1 OF MANAGING URBAN STORMWATER SOILS AND CONSTRUCTION (2004). EXACT LOCATION OF STOCKPILES TO BE CONFIRMED ON SITE BY SUPERINTENDENT.

12. SEDIMENT REMOVAL FROM ANY TRAPPING DEVICE WILL BE DISPOSED IN LOCATIONS WHERE FURTHER EROSION AND CONSEQUENT POLLUTION TO DOWNSLOPE LANDS AND WATERWAYS WILL NOT OCCUR.

13. TEMPORARY SOIL AND WATER MANAGEMENT STRUCTURES WILL BE REMOVED ONLY AFTER LANDS THEY ARE PROTECTING ARE STABILISED. WASTE MANAGEMENT CONDITION.

14. ACCEPTABLE RECEPTORS WILL BE PROVIDED FOR CONCRETE AND MORTAR SLURRIES, PAINTS AND WASHINGS, LIGHT WEIGHT WASTE MATERIALS AND LITTER WHERE PRACTICAL. RECEPTORS WILL BE EMPTIED AT LEAST WEEKLY. DISPOSAL OF WASTE SHALL BE IN A MANNER APPROVED BY THE SUPERINTENDENT.


OTHER MATTERS

15. ANY EXISTING TREES WHICH FORM PART OF THE FINAL LANDSCAPING WILL BE PROTECTED FROM CONSTRUCTION ACTIVITIES BY:

A. PROTECTING THEM WITH BARRIER FENCING OR SIMILAR MATERIALS INSTALLED OUTSIDE THE DRIP LINE

B. ENSURING NOTHING IS NAILED TO THEM

C. PROHIBITING PAVING, GRADING, SEDIMENT WASH OR PLACING OF STOCKPILES WITHIN DRILINE.

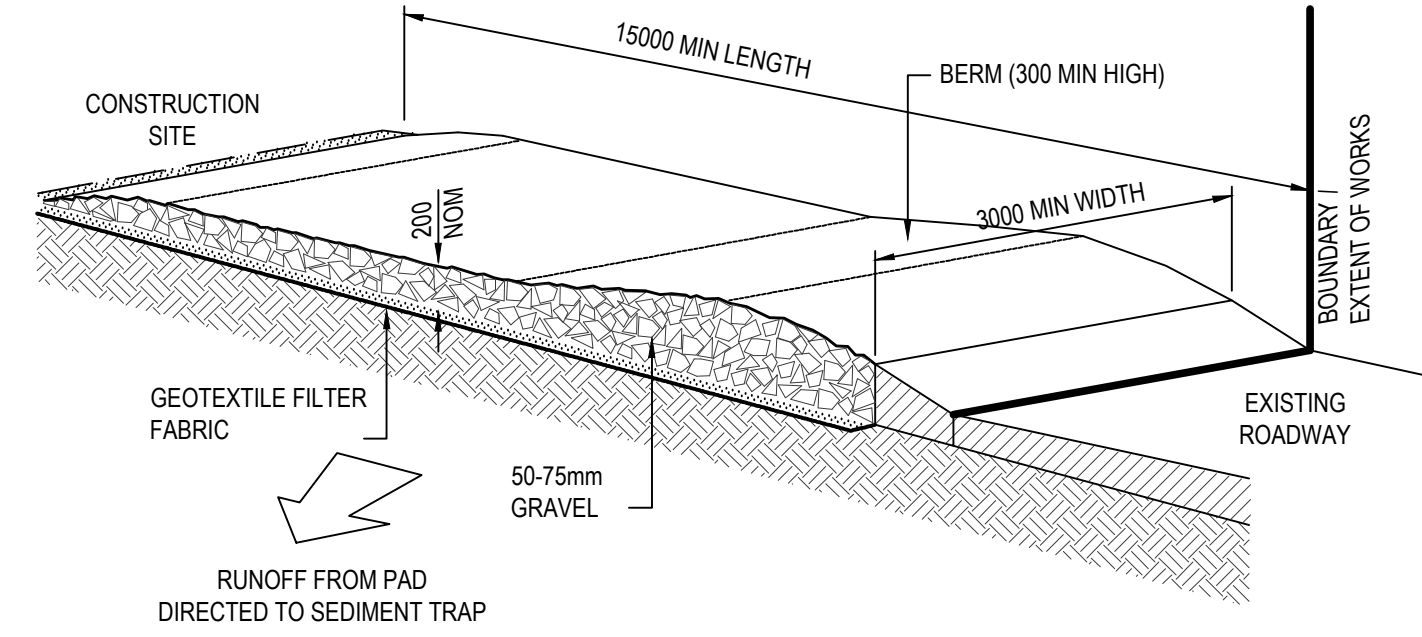


TEMPORARY SITE ENTRANCE  
NOT TO SCALE


- MAINTENANCE
- THE TEMPORARY ACCESS SHALL BE MAINTAINED IN A CONDITION THAT PREVENTS TRACKING OR FLOWING OF SEDIMENT ONTO PUBLIC RIGHTS OF WAY.

• THIS MAY REQUIRE PERIODIC TOP DRESSING WITH ADDITIONAL GRAVEL AS CONDITIONS DEMAND AND REPAIR AND/OR CLEANOUT OF ANY MEASURES USED TO TRAP SEDIMENT.


• ALL SEDIMENT SPILLED, DROPPED, WASHED OR TRACKED ONTO PUBLIC RIGHTS OF WAY MUST BE REMOVED IMMEDIATELY.

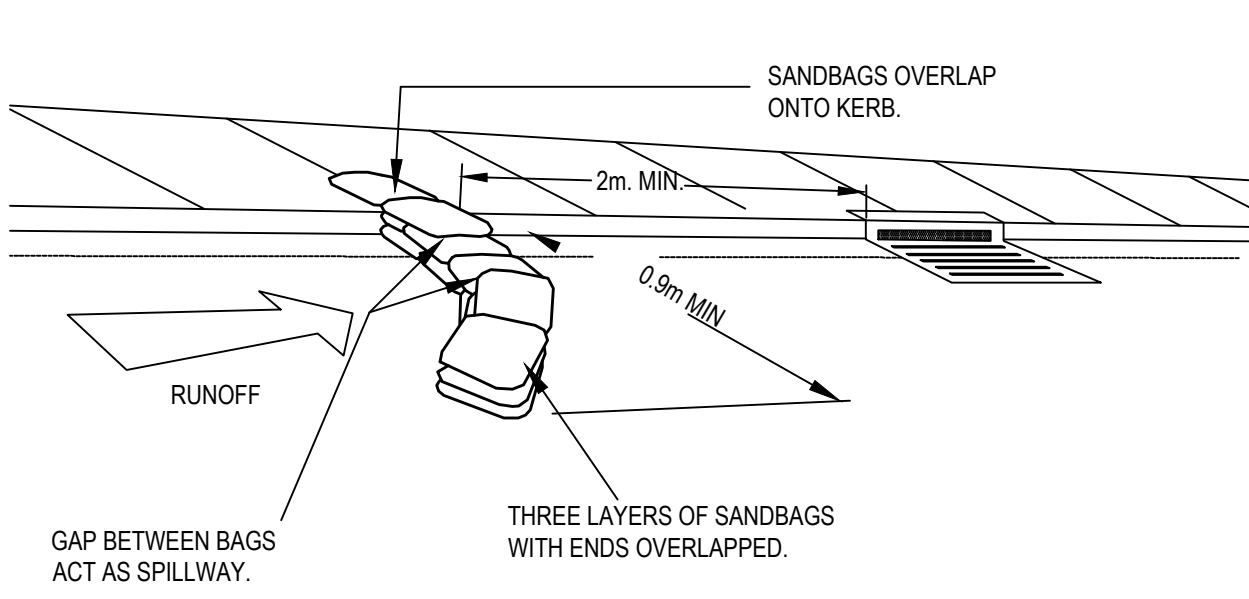


SANDBAG SEDIMENT TRAP - AT KERB ON GRADE PIT  
NTS

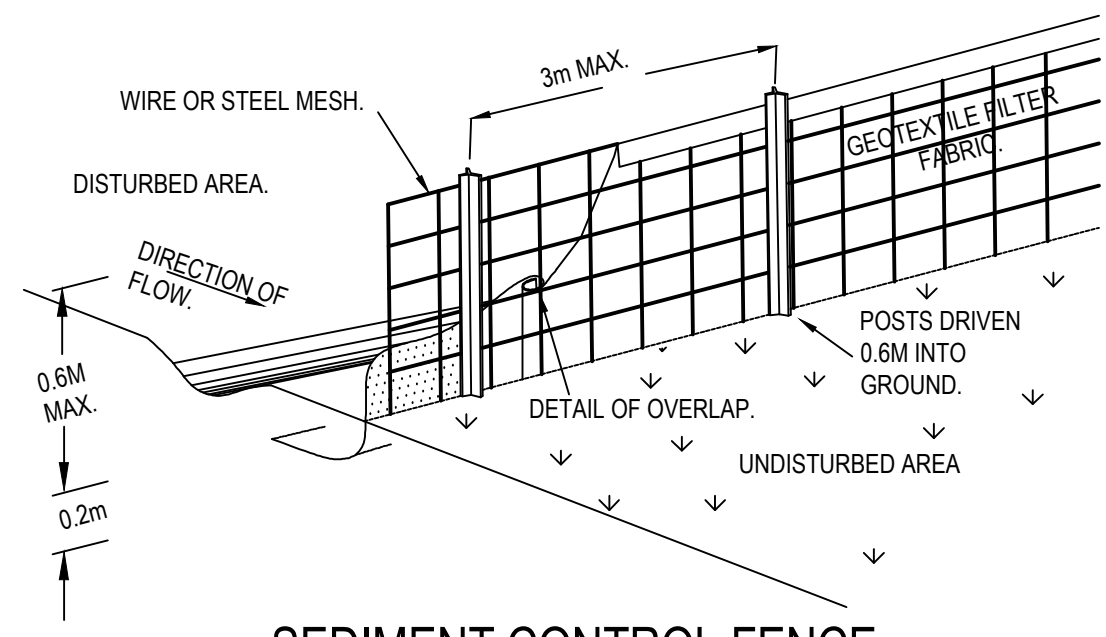

SEDIMENT CONTROL FENCE  
NTS

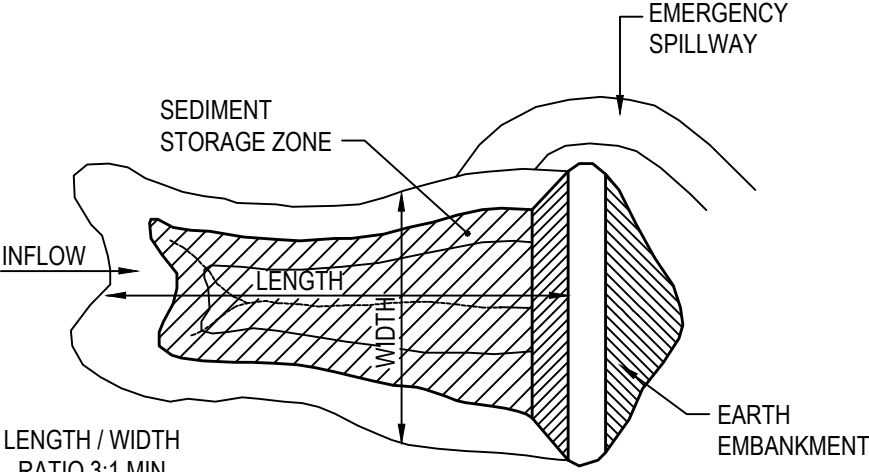

SEDIMENT BASIN (TYPICAL) PLAN - TYPE D AND F SOILS  
NOT TO SCALE

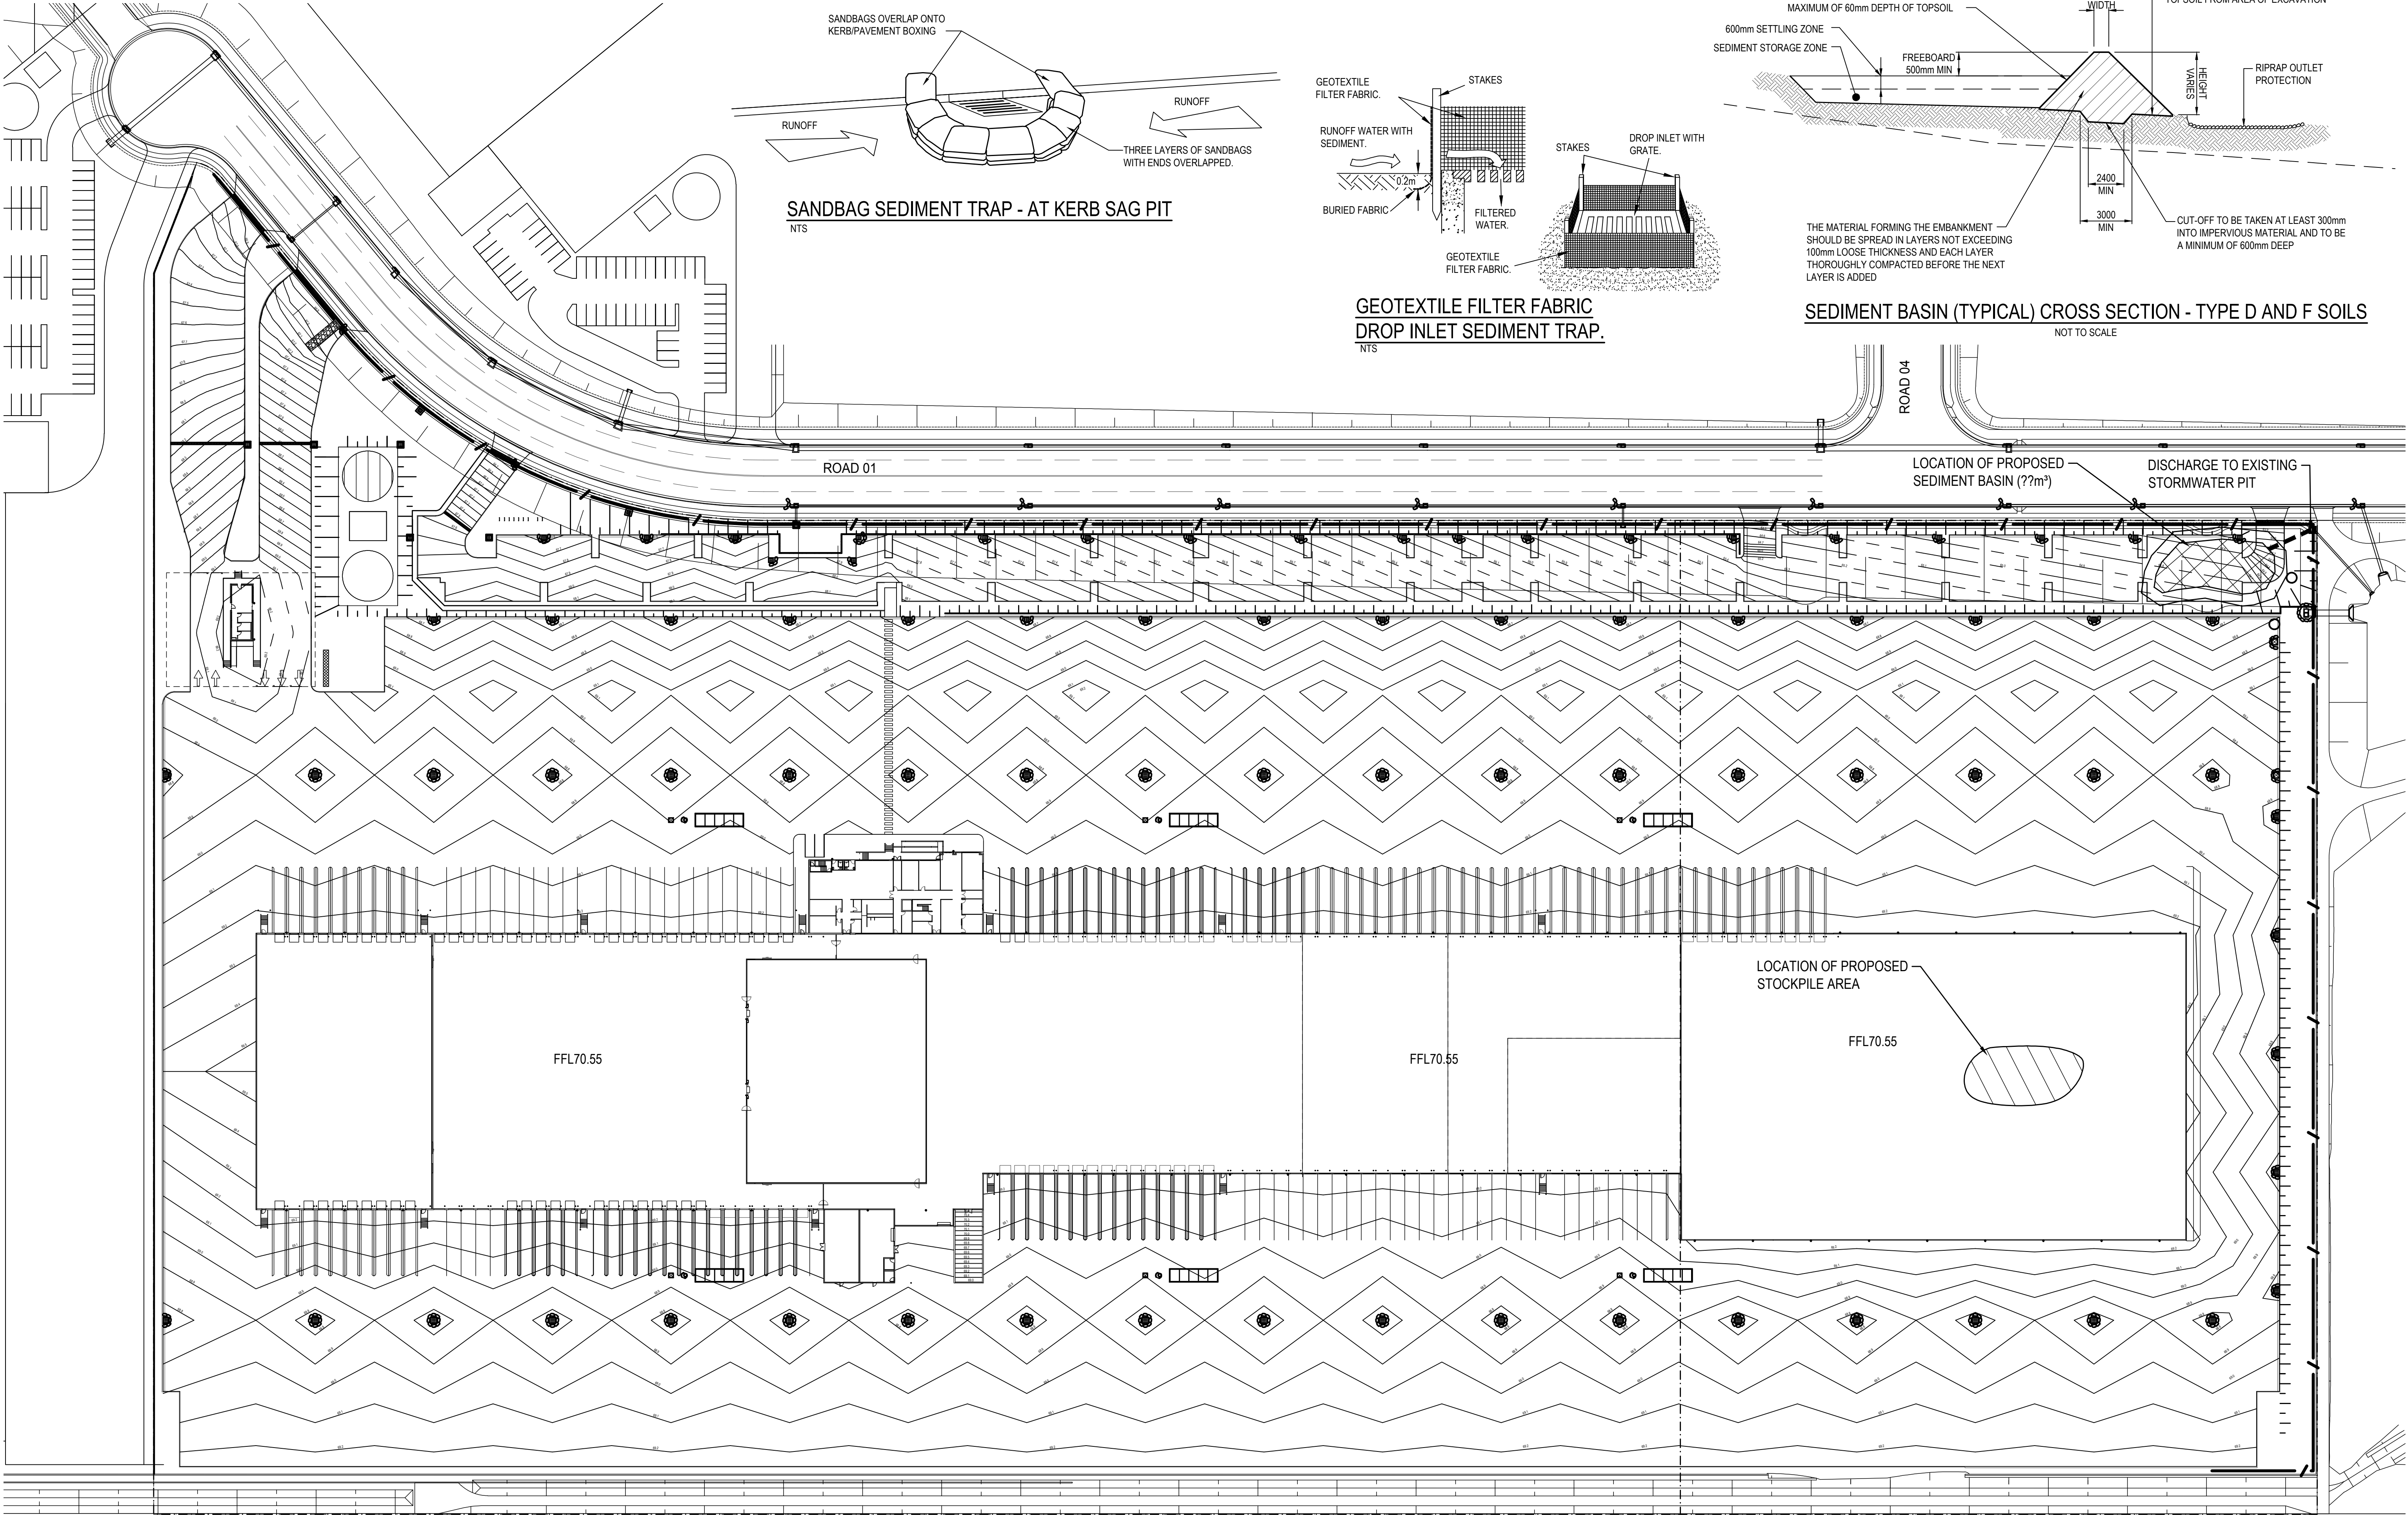


SEDIMENT BASIN (TYPICAL) CROSS SECTION - TYPE D AND F SOILS  
NOT TO SCALE

©COPYRIGHT of this design and plan is the property of ACOR Consultants Pty Ltd, ACN 079 306 246 ABN 40 079 306 246, all rights reserved. It must not be used, modified, reproduced or copied without written permission from ACOR Consultants Pty Ltd.

This drawing has been assigned an electronic code that signifies the drawing has been checked and approved by:

A	ISSUED FOR DA	14.06.17	RAS	SRW	North
P3	ISSUED FOR REVIEW	08.03.17	RAS	SRW	
P2	ISSUED FOR REVIEW	21.02.17	RAS	SRW	
P1	ISSUED FOR REVIEW	17.10.16	RAS	SRW	
Issue	Description	Date	Drawn	Approved	Scale
	New 2D Full size				200m

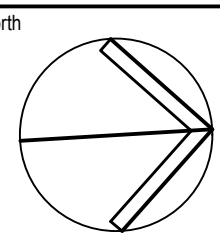

SCALE 1:750



ACOR Consultants Pty Ltd  
Unit 10, Level 1, No.1 Maitland Place  
Baulkham Hills NSW 2153  
T +61 2 9634 6311

Project

COSTCO OAKDALE DEPOT  
ESTATE ROAD 1  
OAKDALE SOUTH ESTATE, NSW

Drawing Title  
SOIL AND EROSION CONTROL CONCEPT  
PLAN, NOTES AND DETAILS

Drawn	Date	Scale	B1	G.A. Check	Date
RAS	JULY 2016	-	AS SHOWN		
Designed	Project No.	Dwg No.	Issue		
SRW	NW160037	DAC8.01	A		

NOT FOR CONSTRUCTION