

TIME: 14/10/2020 8:10:03 AM PLOTTED & CHECKED BY: Author

DEMOLITION PLAN LEGEND



EXISTING WALL TO BE RETAINED EXISTING WALL TO BE DEMOLISHED EXISTING ITEM TO BE DEMOLISHED

GENERAL DEMOLITION NOTES

- DEMOLISH EXISTING WALLS, FLOORS, STAIRS, WINDOWS, DOORS AND JOINERY AS SHOWN IN RED DOTTED ON DRAWINGS PROVIDE TEMPORARY SUPPORT AS REQUIRED TO ENSURE
- STABILITY OF THE EXISTING STRUCTURE REMOVE TREES AS SHOWN IN RED DOTTED ON DRAWINGS
- THE CONTRACTOR SHALL INSPECT AND DETERMINE THE EXTENT OF WORKS REQUIRED PRIOR TO COMMENCEMENT OF DEMOLITION.
- CONTRACTOR IS RESPONSIBLE FOR ENSURING THE SEQUENCE OF WORKS IS IN ACCORDANCE WITH STRUCTURAL ENGINEER'S DRAWINGS AND DOES NOT COMPROMISE THE BRACING OF THE EXISTING STRUCTURE
- MAINTAIN EXISTING SERVICES, WHERE REQUIRED. REFER TO ELECTRICAL AND HYDRAULIC ENGINEER'S DRAWINGS AND SPECIFICATIONS
- CONSULT STRUCTURAL ENGINEER AND ON SITE REQUIREMENTS PRIOR TO COMMENCEMENT OF DEMOLITION WORKS
- . REFER TO SPECIFICATION FOR REQUIREMENTS OF DEMOLITION WORKS
- . REMOVE ALL EXISTING LETTERBOXES FROM FRONT OF TERRACES
- 10. REMOVE ALL EXISTING AERIALS AND ASSOCIATED WIRING FROM TERRACE FACADES AND ROOFS
- 1. REFER TO SERVICES DRAWINGS FOR DISCONNECTION AND REMOVAL OF SERVICES

12. TREE PROTECTION ZONE TO BE INSTALLED PRIOR TO DEMOLITION - REFER TO ARBORIST REPORT PREPARED BY ARBORSAFE 'PRE DEVELOPMENT TREE SURVEY DARLINGTON LANE, UNIVERSITY OF SYDNEY' (DATED JULY 9TH, 2014)

TERRACES INTERNAL EXISTING CONDITIONS CLASSIFICATION KEY

REFER TO SCHEDULE 9605 TERRACES INTERNAL EXISTING CONDITION CLASSIFICATION **B** REFER TO SCHEDULE 9605 TERRACES INTERNAL EXISTING CONDITION CLASSIFICATION

C REFER TO SCHEDULE 9605 TERRACES INTERNAL EXISTING CONDITION CLASSIFICATION

DEMOLITION PLAN KEY

- 1 CUT OPENING IN EXISTING WALL AND MAKE GOOD SURROUNDING WALLS
- REMOVE PORTION OF EXISTING WALL TO INSTALL A NEW DOOR AND FRAME. REFER TO PLANS AND DOOR SCHEDULES FOR SIZE AND LOCATION
- REMOVE PORTION OF EXISTING WALL TO INSTALL A NEW WINDOW AND FRAME. REFER TO PLANS AND WINDOW SCHEDULES FOR SIZE AND LOCATION
- REMOVE EXISTING STAIR, RAILING AND SUPPORTS
- REMOVE EXISTING EXTERNAL STEPS, RAMP, RAILING AND 6 SUPPORTS
- REMOVE ROOFING SYSTEM, DECK AND SUPPORTS
- REMOVE EXISTING DOOR, FRAME AND HARDWARE
- REHANG EXISTING DOOR, FRAME AND HARDWARE TO OPEN IN OPPOSITE DIRECTION
- 10 REMOVE EXISTING WINDOW, FRAME, SILL AND ALL ASSOCIATED COMPONENTS
- REMOVE EXISTING ALUMINIUM WINDOW, FRAME, SILL AND ALL ASSOCIATED COMPONENTS AND REPLACE WITH TIMBER FRAMED WINDOW
- REMOVE EXISTING BATHROOM, LAUNDRY, CUT AND CAP OFF ALL EXISTING SERVICES, PLUMBING FIXTURES AND AND ALL ASSOCIATED COMPONENTS. PATCH FLOOR FOR NEW FINISHES
- REMOVE EXISTING KITCHEN, CUT AND CAP OFF ALL EXISTING SERVICES, PLUMBING FIXTURES AND AND ALL ASSOCIATED COMPONENTS WHERE NEW BEDROOMS ARE PROPOSED. REFER TO A2000 SET DRAWINGS FOR LOCATION
- ¹⁵ REMOVE MANTLE AND STORE FOR RE-INSTATE

Key

A

REMOVE MANTLE AND FIREPLACE AND STORE FOR RE-INSTATE REMOVE EXISTING FENCE AND ALL ASSOCIATED COMPONENTS REMOVE AND REPLACE EXISTING ROOF SHEET, GUTTER AND DOWNPIPE

DARLINGTON ROAD

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DARLINGTON LANE

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12 DOORS ExRL 40.110 ExRL 39.700 NO. 132 DARLINGTON ROAD 11

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Description DRAFT DA SUBMISSION DRAFT DA SUBMISSION DRAFT DA SUBMISSION SSDA ISSUE REVISED SSDA ISSUE

Revision No. Date

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05/09/16


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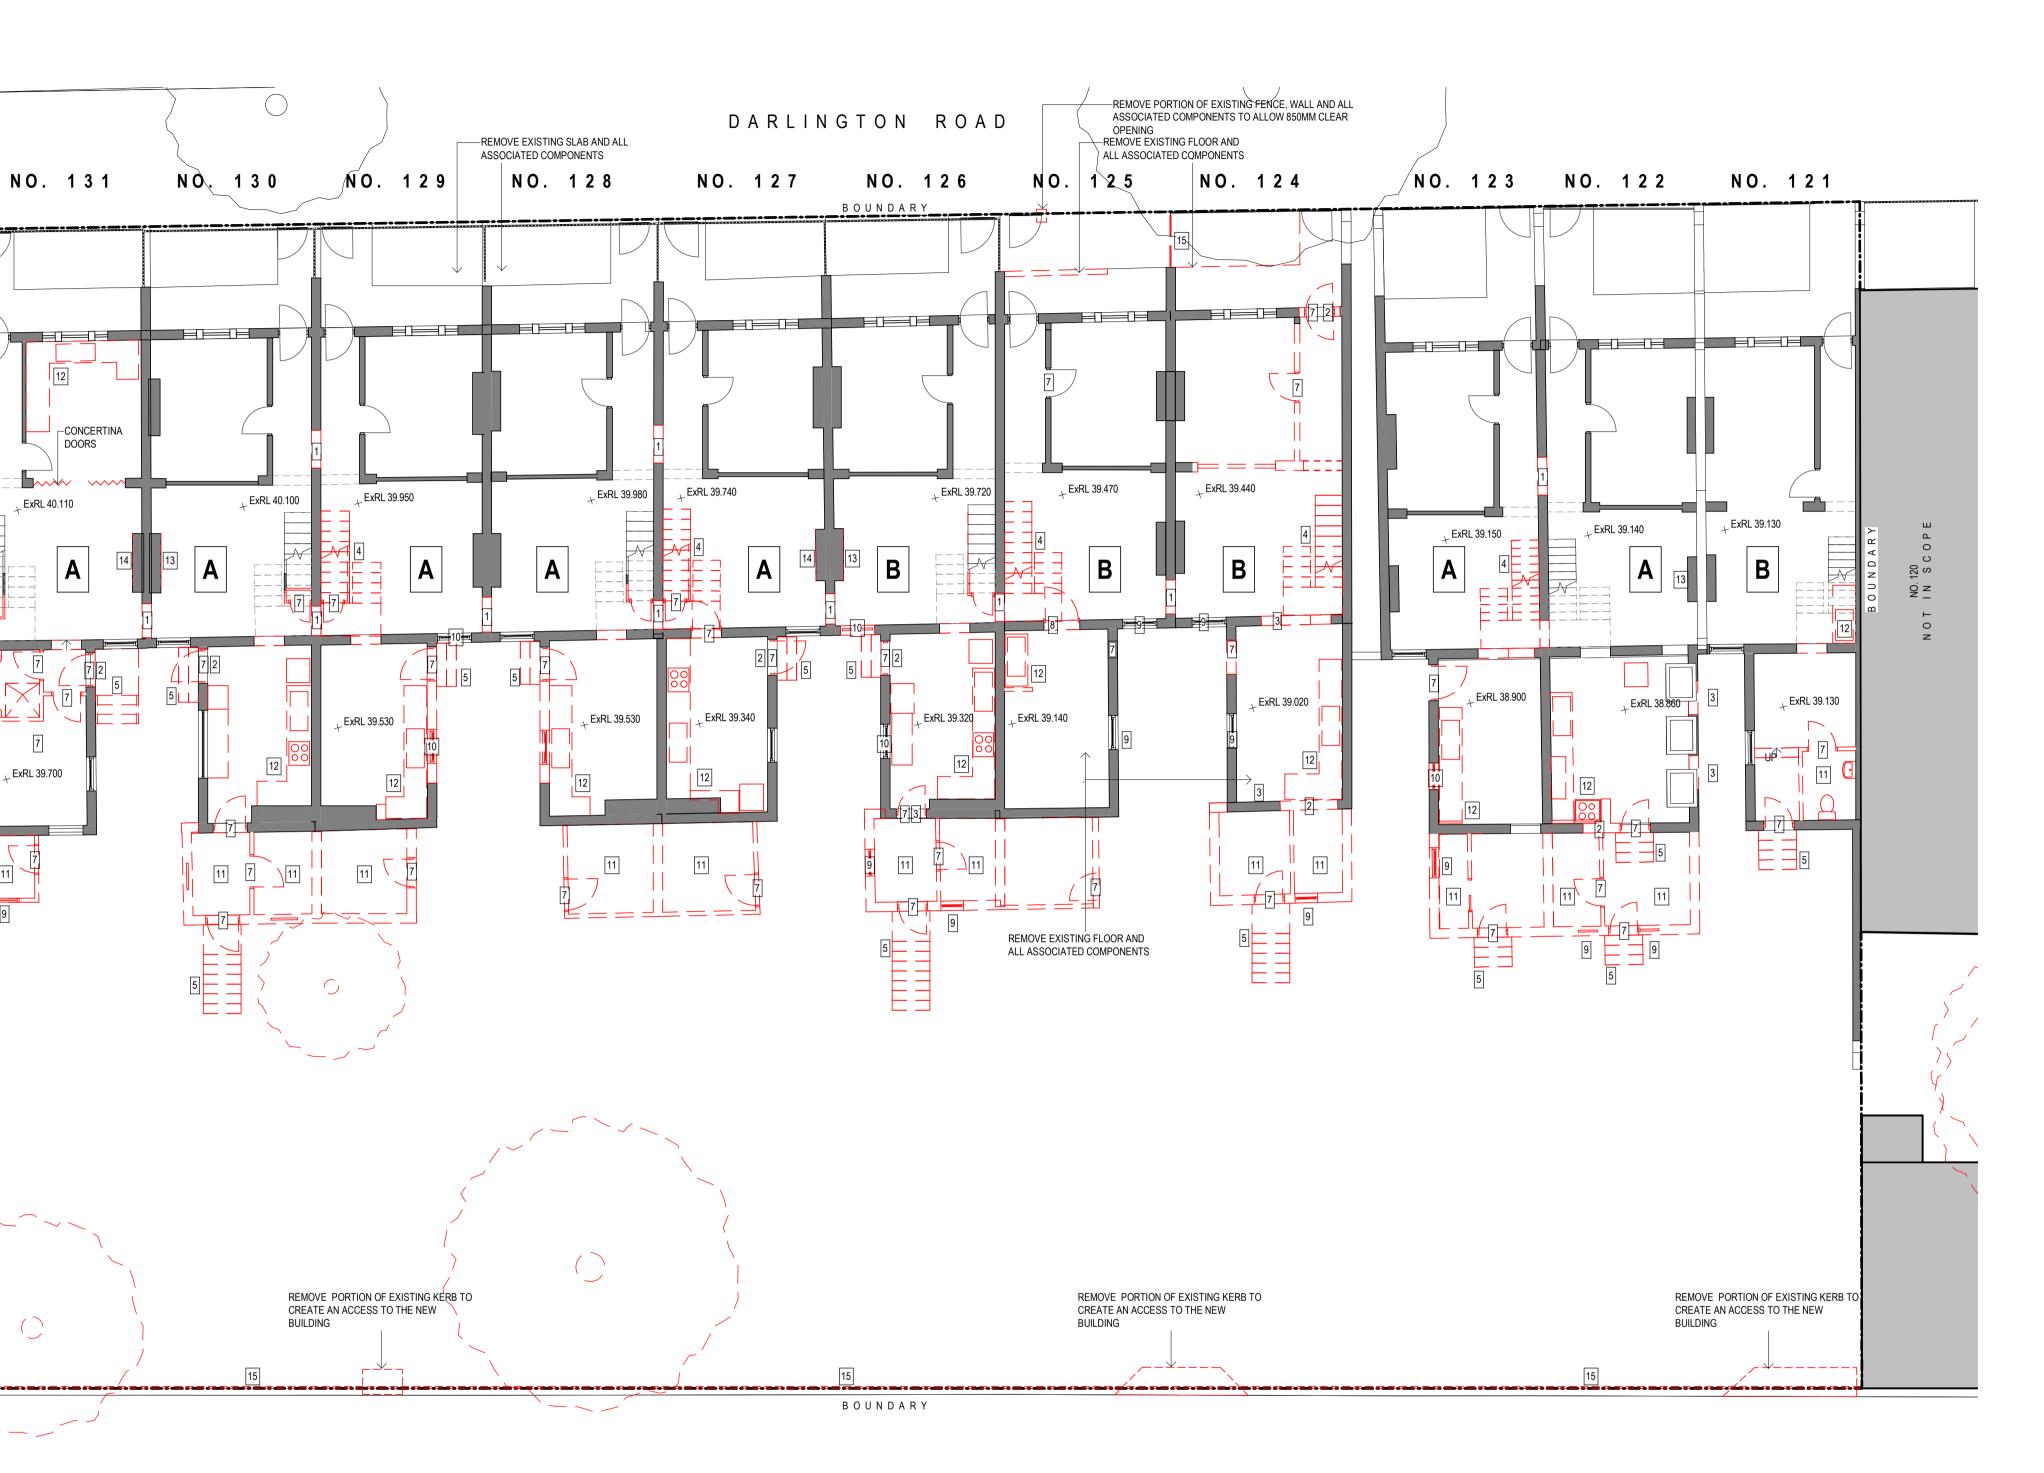
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25/11/16

13/10/20

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DARLINGTON LANE



DARLINGTON ROAD TERRACES MIXED USE BUILDING ADDITIONS AND ALTERATIONS TO THE DARLINGTON ROAD TERRACES AND PUBLIC DOMAIN Darlington Road DARLINGTON

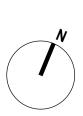


Drawing Title	Scale	Drawing No.	Issue
PART DEMOLITION PLAN - TERRACE NO.131-121 - L1	1 : 100 @A1	DA1101	5
Drawing Status NOT FOR CONSTRUCTION	0 1.000 2.000) 4.000	8.000 m

DEMOLITION PLAN LEGEND		
EXISTING WALL TO BE RETAINED EXISTING WALL TO BE DEMOLISHED EXISTING ITEM TO BE DEMOLISHED		
GENERAL DEMOLITION NOTES	_	
1. DEMOLISH EXISTING WALLS, FLOORS, STAIRS, WINDOWS, DOORS AND JOINERY AS SHOWN IN RED DOTTED ON DRAWINGS		
2. PROVIDE TEMPORARY SUPPORT AS REQUIRED TO ENSURE STABILITY OF THE EXISTING STRUCTURE		
 REMOVE TREES AS SHOWN IN RED DOTTED ON DRAWINGS THE CONTRACTOR SHALL INSPECT AND DETERMINE THE EXTENT OF WORKS REQUIRED PRIOR TO COMMENCEMENT OF DEMOLITION. 		NO. 131
5. CONTRACTOR IS RESPONSIBLE FOR ENSURING THE SEQUENCE OF WORKS IS IN ACCORDANCE WITH STRUCTURAL ENGINEER'S DRAWINGS AND DOES NOT COMPROMISE THE BRACING OF THE EXISTING STRUCTURE		
 MAINTAIN EXISTING SERVICES, WHERE REQUIRED. REFER TO ELECTRICAL AND HYDRAULIC ENGINEER'S DRAWINGS AND SPECIFICATIONS 		
 CONSULT STRUCTURAL ENGINEER AND ON SITE REQUIREMENTS PRIOR TO COMMENCEMENT OF DEMOLITION WORKS REFER TO SPECIFICATION FOR REQUIREMENTS OF DEMOLITION WORKS 		
9. REMOVE ALL EXISTING LETTERBOXES FROM FRONT OF TERRACES		
10. REMOVE ALL EXISTING AERIALS AND ASSOCIATED WIRING FROM TERRACE FACADES AND ROOFS		ExRL 43.440
11. REFER TO SERVICES DRAWINGS FOR DISCONNECTION AND REMOVAL OF SERVICES		
12. TREE PROTECTION ZONE TO BE INSTALLED PRIOR TO DEMOLITION - REFER TO ARBORIST REPORT PREPARED BY ARBORSAFE 'PRE DEVELOPMENT TREE SURVEY_DARLINGTON LANE, UNIVERSITY OF SYDNEY' (DATED JULY 9TH, 2014)		
TERRACES INTERNAL EXISTING CONDITIONS CLASSIFICATION KEY	-	
A REFER TO SCHEDULE 9605 TERRACES INTERNAL EXISTING CONDITION CLASSIFICATION		ExRL 42.530
B REFER TO SCHEDULE 9605 TERRACES INTERNAL EXISTING CONDITION CLASSIFICATION		
C REFER TO SCHEDULE 9605 TERRACES INTERNAL EXISTING CONDITION CLASSIFICATION	NO. 132	
1 CUT OPENING IN EXISTING WALL AND MAKE GOOD SURROUNDING WALLS		
2 REMOVE PORTION OF EXISTING WALL TO INSTALL A NEW DOOR AND FRAME. REFER TO PLANS AND DOOR SCHEDULES FOR SIZE AND LOCATION		
3 REMOVE PORTION OF EXISTING WALL TO INSTALL A NEW WINDOW AND FRAME. REFER TO PLANS AND WINDOW SCHEDULES FOR SIZE AND LOCATION		
 REMOVE EXISTING STAIR, RAILING AND SUPPORTS DEMOVE EXISTING EXTERNAL OFFICE DAMP. DAMING AND 		
6 SUPPORTS		
 REMOVE ROOFING SYSTEM, DECK AND SUPPORTS REMOVE EXISTING DOOR, FRAME AND HARDWARE 		
9 REHANG EXISTING DOOR, FRAME AND HARDWARE TO OPEN IN OPPOSITE DIRECTION		
10 REMOVE EXISTING WINDOW, FRAME, SILL AND ALL ASSOCIATED COMPONENTS		
REMOVE EXISTING ALUMINIUM WINDOW, FRAME, SILL AND ALL ASSOCIATED COMPONENTS AND REPLACE WITH TIMBER FRAMED WINDOW		
12 REMOVE EXISTING BATHROOM, LAUNDRY, CUT AND CAP OFF ALL EXISTING SERVICES, PLUMBING FIXTURES AND AND ALL ASSOCIATED COMPONENTS. PATCH FLOOR FOR NEW FINISHES REMOVE EXISTING KITCHEN, CUT AND CAP OFF ALL EXISTING		
SERVICES, PLUMBING FIXTURES AND AND ALL ASSOCIATED COMPONENTS WHERE NEW BEDROOMS ARE PROPOSED. REFER TO		
14 15 REMOVE MANTLE AND STORE FOR RE-INSTATE		
16 REMOVE MANTLE AND FIREPLACE AND STORE FOR RE-INSTATE		
REMOVE EXISTING FENCE AND ALL ASSOCIATED COMPONENTS REMOVE AND REPLACE EXISTING ROOF SHEET, GUTTER AND DOWNPIPE		
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Do not scale drawings. Use figured dimensions only. Check & verify levels and dimensions on site prior to the commencement of any work, the preparation of shop drawings or the fabrication of Allen Jack + Cottier Architects: Michael Heenan 5264, Peter Ireland 6661


DARLINGTON LANE

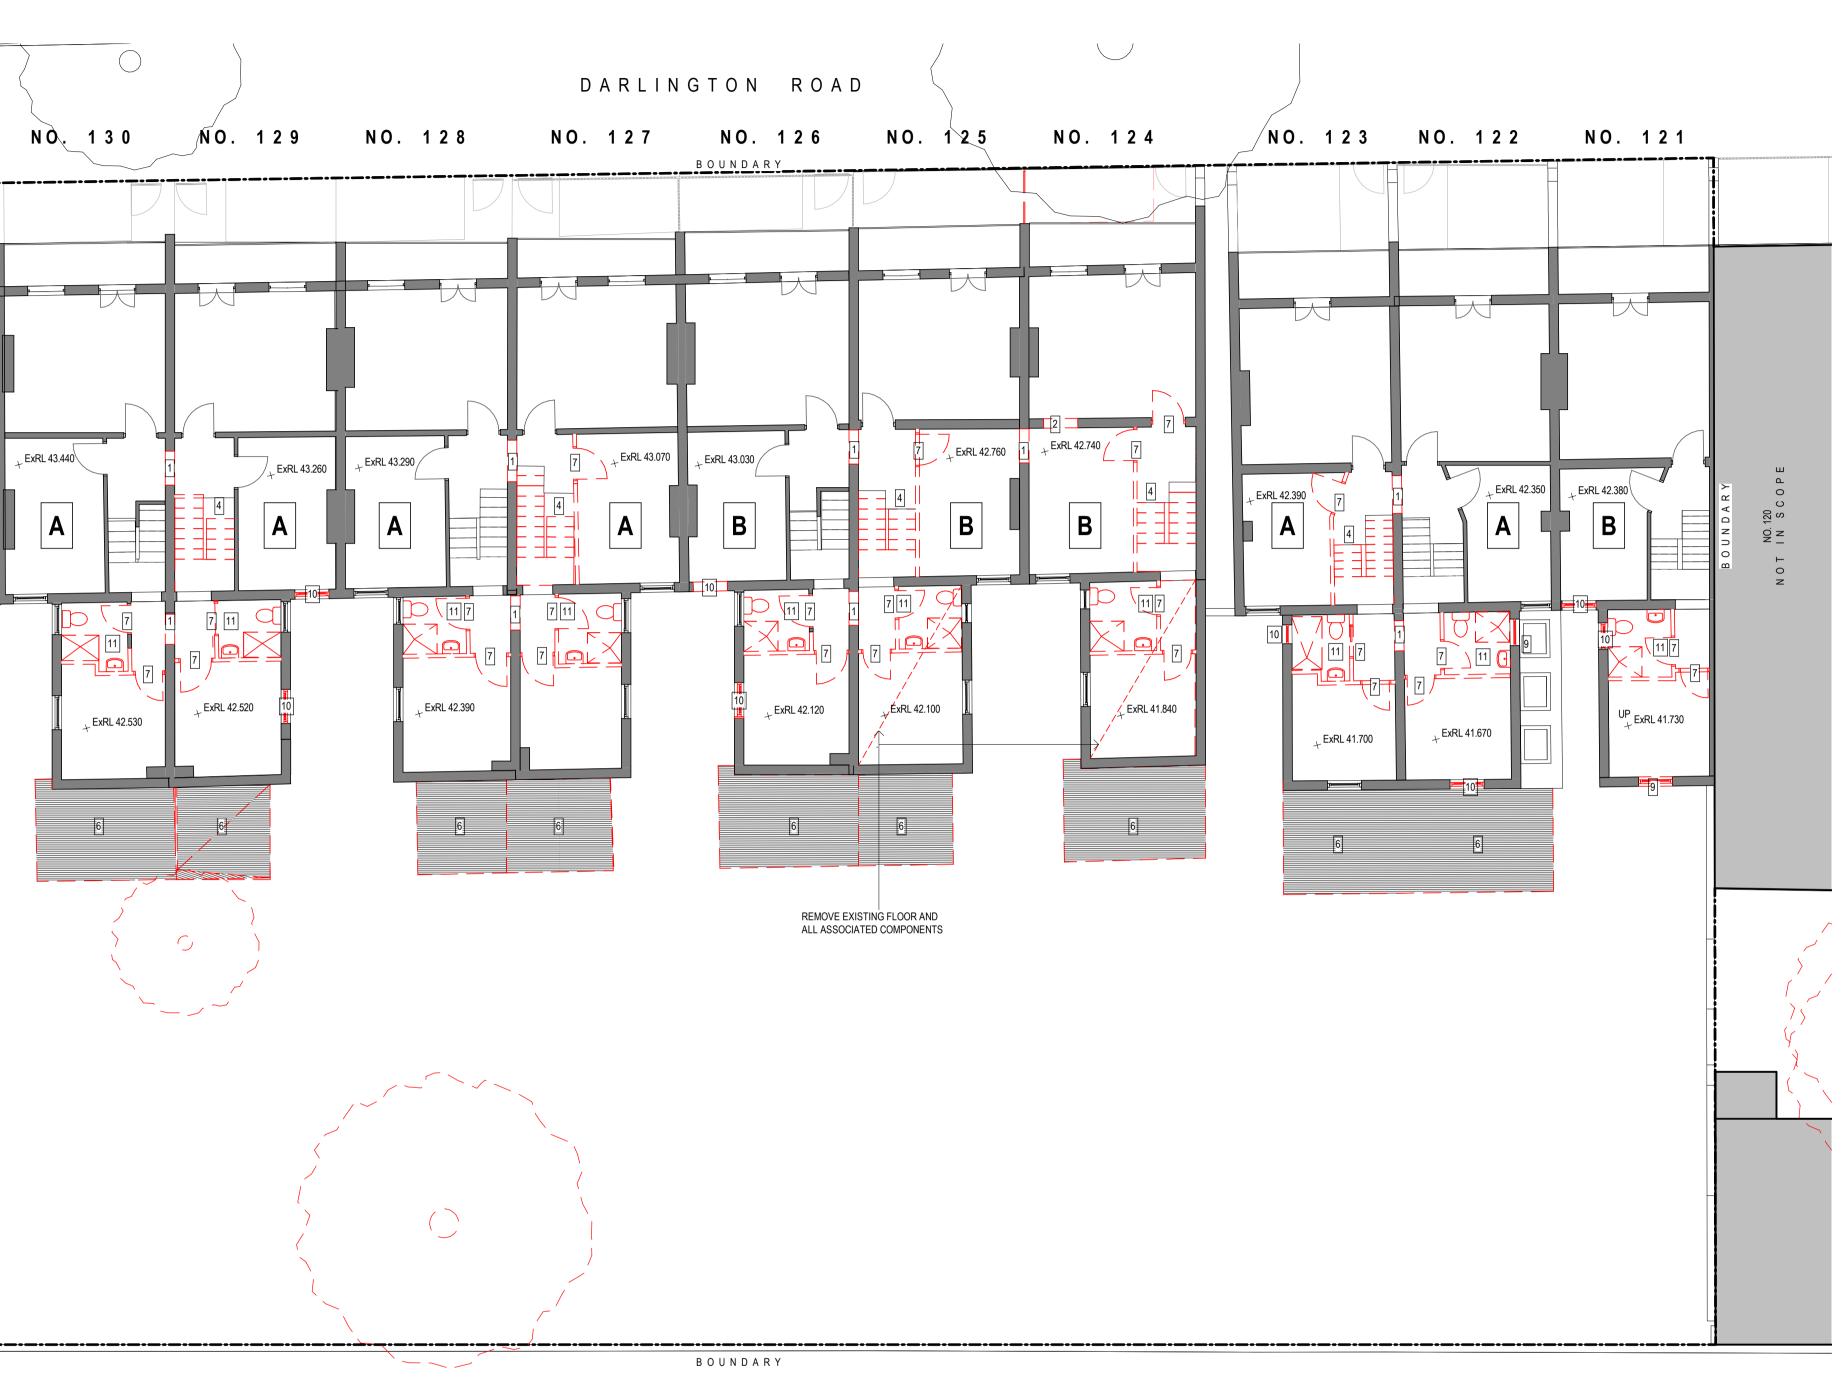

DARLINGTON LANE



ALTERATIONS TO THE DARLINGTON ROAD TERRACES AND PUBLIC DOMAIN

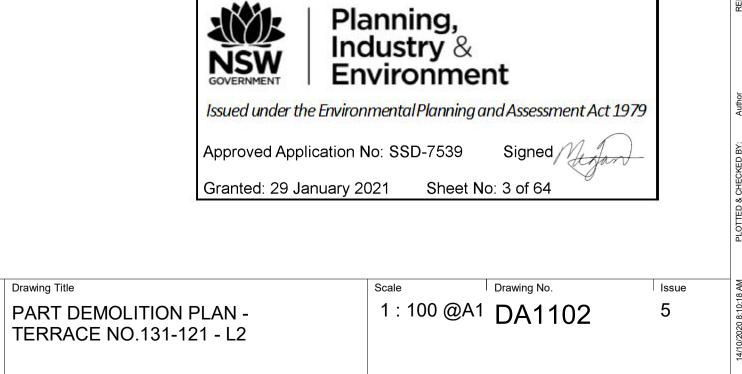

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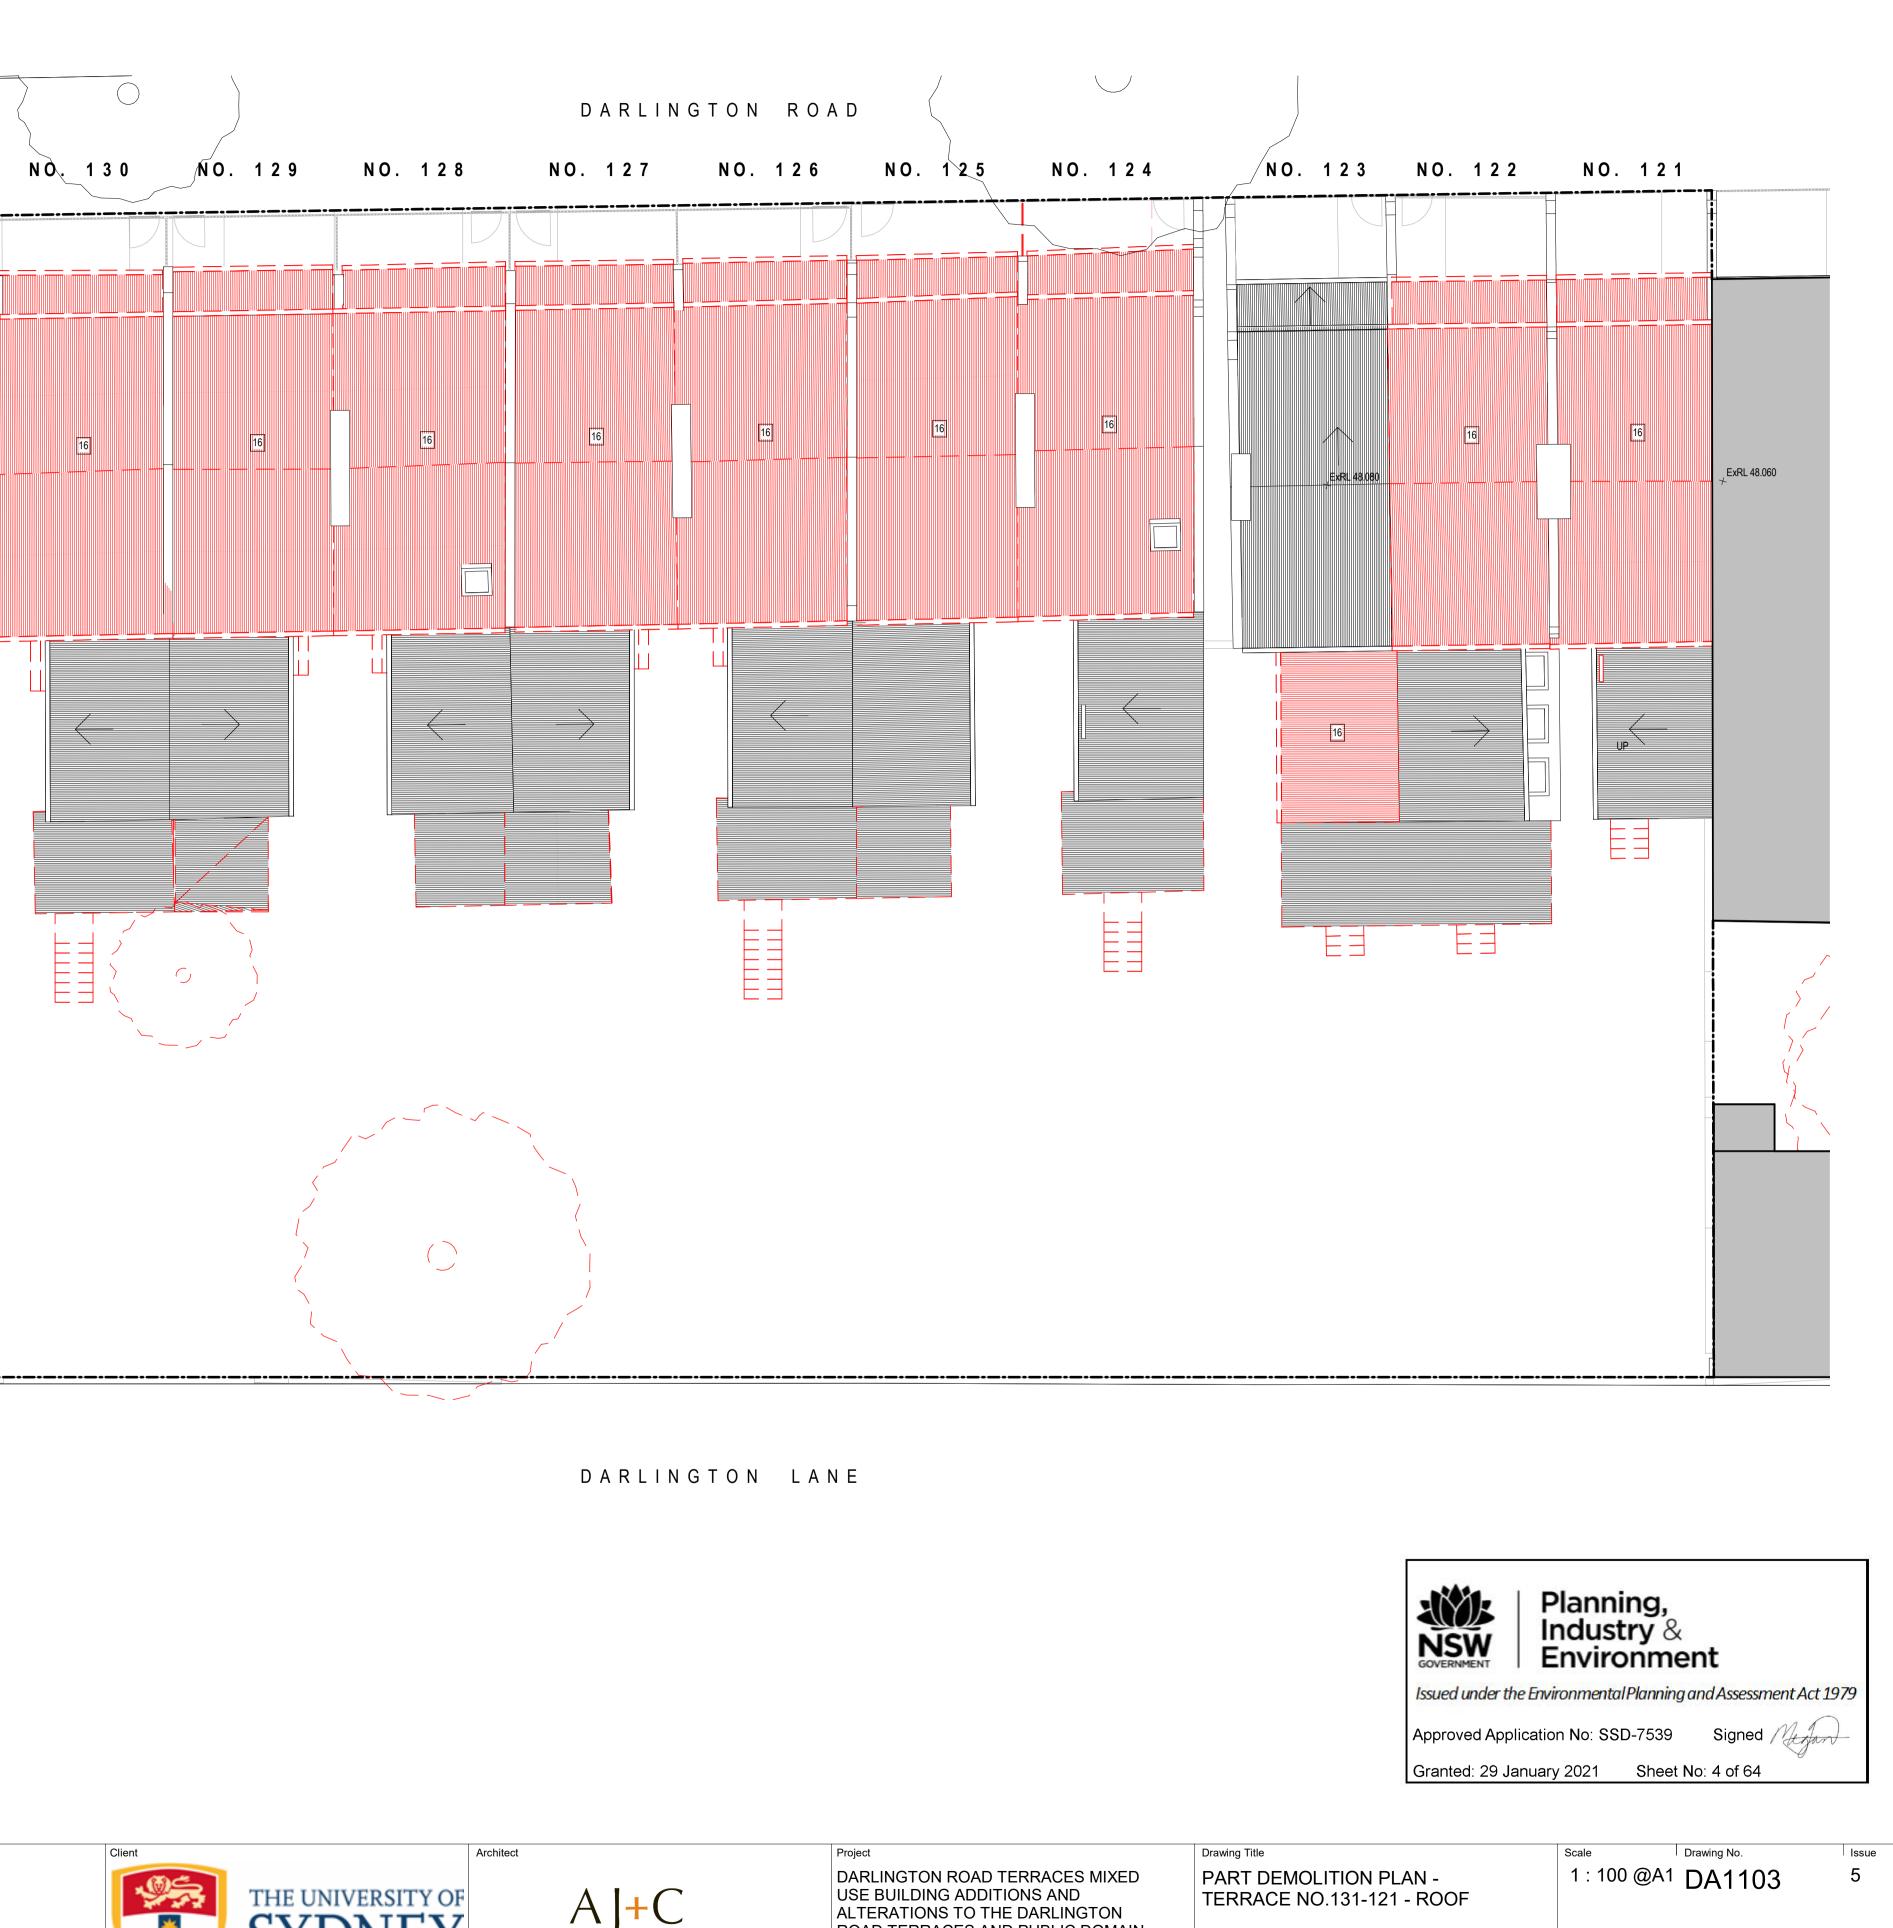
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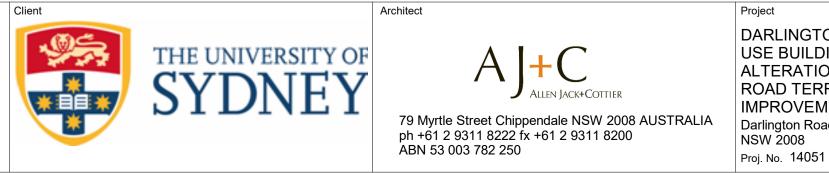
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DEMOLITION PLAN LEGEND	_			
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GENERAL DEMOLITION NOTES				
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 STABILITY OF THE EXISTING STRUCTURE REMOVE TREES AS SHOWN IN RED DOTTED ON DRAWINGS 				NO. 131
4. THE CONTRACTOR SHALL INSPECT AND DETERMINE THE EXTENT OF WORKS REQUIRED PRIOR TO COMMENCEMENT OF				
DEMOLITION. 5. CONTRACTOR IS RESPONSIBLE FOR ENSURING THE SEQUENCE OF WORKS IS IN ACCORDANCE WITH STRUCTURAL ENGINEER'S DRAWINGS AND DOES NOT COMPROMISE THE BRACING OF THE EXISTING STRUCTURE				
 MAINTAIN EXISTING SERVICES, WHERE REQUIRED. REFER TO ELECTRICAL AND HYDRAULIC ENGINEER'S DRAWINGS AND SPECIFICATIONS 				
7. CONSULT STRUCTURAL ENGINEER AND ON SITE REQUIREMENTS PRIOR TO COMMENCEMENT OF DEMOLITION WORKS				
8. REFER TO SPECIFICATION FOR REQUIREMENTS OF DEMOLITION WORKS				
9. REMOVE ALL EXISTING LETTERBOXES FROM FRONT OF TERRACES				ExRL 49.460
10. REMOVE ALL EXISTING AERIALS AND ASSOCIATED WIRING FROM TERRACE FACADES AND ROOFS				
11. REFER TO SERVICES DRAWINGS FOR DISCONNECTION AND REMOVAL OF SERVICES		NO. 132		
12. TREE PROTECTION ZONE TO BE INSTALLED PRIOR TO		DARLINGTON ROAD		
DEMOLITION - REFER TO ARBORIST REPORT PREPARED BY ARBORSAFE 'PRE DEVELOPMENT TREE SURVEY_DARLINGTON LANE, UNIVERSITY OF SYDNEY' (DATED JULY 9TH, 2014)				
TERRACES INTERNAL EXISTING CONDITIONS CLASSIFICATION KEY				
A REFER TO SCHEDULE 9605 TERRACES INTERNAL EXISTING CONDITION CLASSIFICATION				
B REFER TO SCHEDULE 9605 TERRACES INTERNAL EXISTING CONDITION CLASSIFICATION				
C REFER TO SCHEDULE 9605 TERRACES INTERNAL EXISTING CONDITION CLASSIFICATION				
DEMOLITION PLAN KEY				
1 CUT OPENING IN EXISTING WALL AND MAKE GOOD SURROUNDING WALLS				
2 REMOVE PORTION OF EXISTING WALL TO INSTALL A NEW DOOR AND				
FRAME. REFER TO PLANS AND DOOR SCHEDULES FOR SIZE AND LOCATION REMOVE PORTION OF EXISTING WALL TO INSTALL A NEW WINDOW AND FRAME. REFER TO PLANS AND WINDOW SCHEDULES FOR SIZE				
AND LOCATION 4 REMOVE EXISTING STAIR, RAILING AND SUPPORTS				
5 REMOVE EXISTING EXTERNAL STEPS, RAMP, RAILING AND 6 SUPPORTS				
7 REMOVE ROOFING SYSTEM, DECK AND SUPPORTS				
8 REMOVE EXISTING DOOR, FRAME AND HARDWARE				
9 REHANG EXISTING DOOR, FRAME AND HARDWARE TO OPEN IN OPPOSITE DIRECTION				
10 REMOVE EXISTING WINDOW, FRAME, SILL AND ALL ASSOCIATED COMPONENTS				
11 REMOVE EXISTING ALUMINIUM WINDOW, FRAME, SILL AND ALL ASSOCIATED COMPONENTS AND REPLACE WITH TIMBER FRAMED				
WINDOW 12 REMOVE EXISTING BATHROOM, LAUNDRY, CUT AND CAP OFF ALL EXISTING SERVICES BUILDING EXTURES AND AND ALL				
EXISTING SERVICES, PLUMBING FIXTURES AND AND ALL ASSOCIATED COMPONENTS. PATCH FLOOR FOR NEW FINISHES				
REMOVE EXISTING KITCHEN, CUT AND CAP OFF ALL EXISTING SERVICES, PLUMBING FIXTURES AND AND ALL ASSOCIATED COMPONENTS WHERE NEW BEDROOMS ARE PROPOSED. REFER TO				
14 A2000 SET DRAWINGS FOR LOCATION				
15 REMOVE MANTLE AND STORE FOR RE-INSTATE 16 REMOVE MANTLE AND FIREPLACE AND STORE FOR RE-INSTATE				
REMOVE EXISTING FENCE AND ALL ASSOCIATED COMPONENTS				
REMOVE AND REPLACE EXISTING ROOF SHEET, GUTTER AND DOWNPIPE				
Кеу	Revisions No. Date	Description DRAFT DA SUBMISSION	Ver App'd NZ VB	
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DARLINGTON LANE





ALTERATIONS TO THE DARLINGTON ROAD TERRACES AND PUBLIC DOMAIN IMPROVEMENTS Darlington Road DARLINGTON NSW 2008


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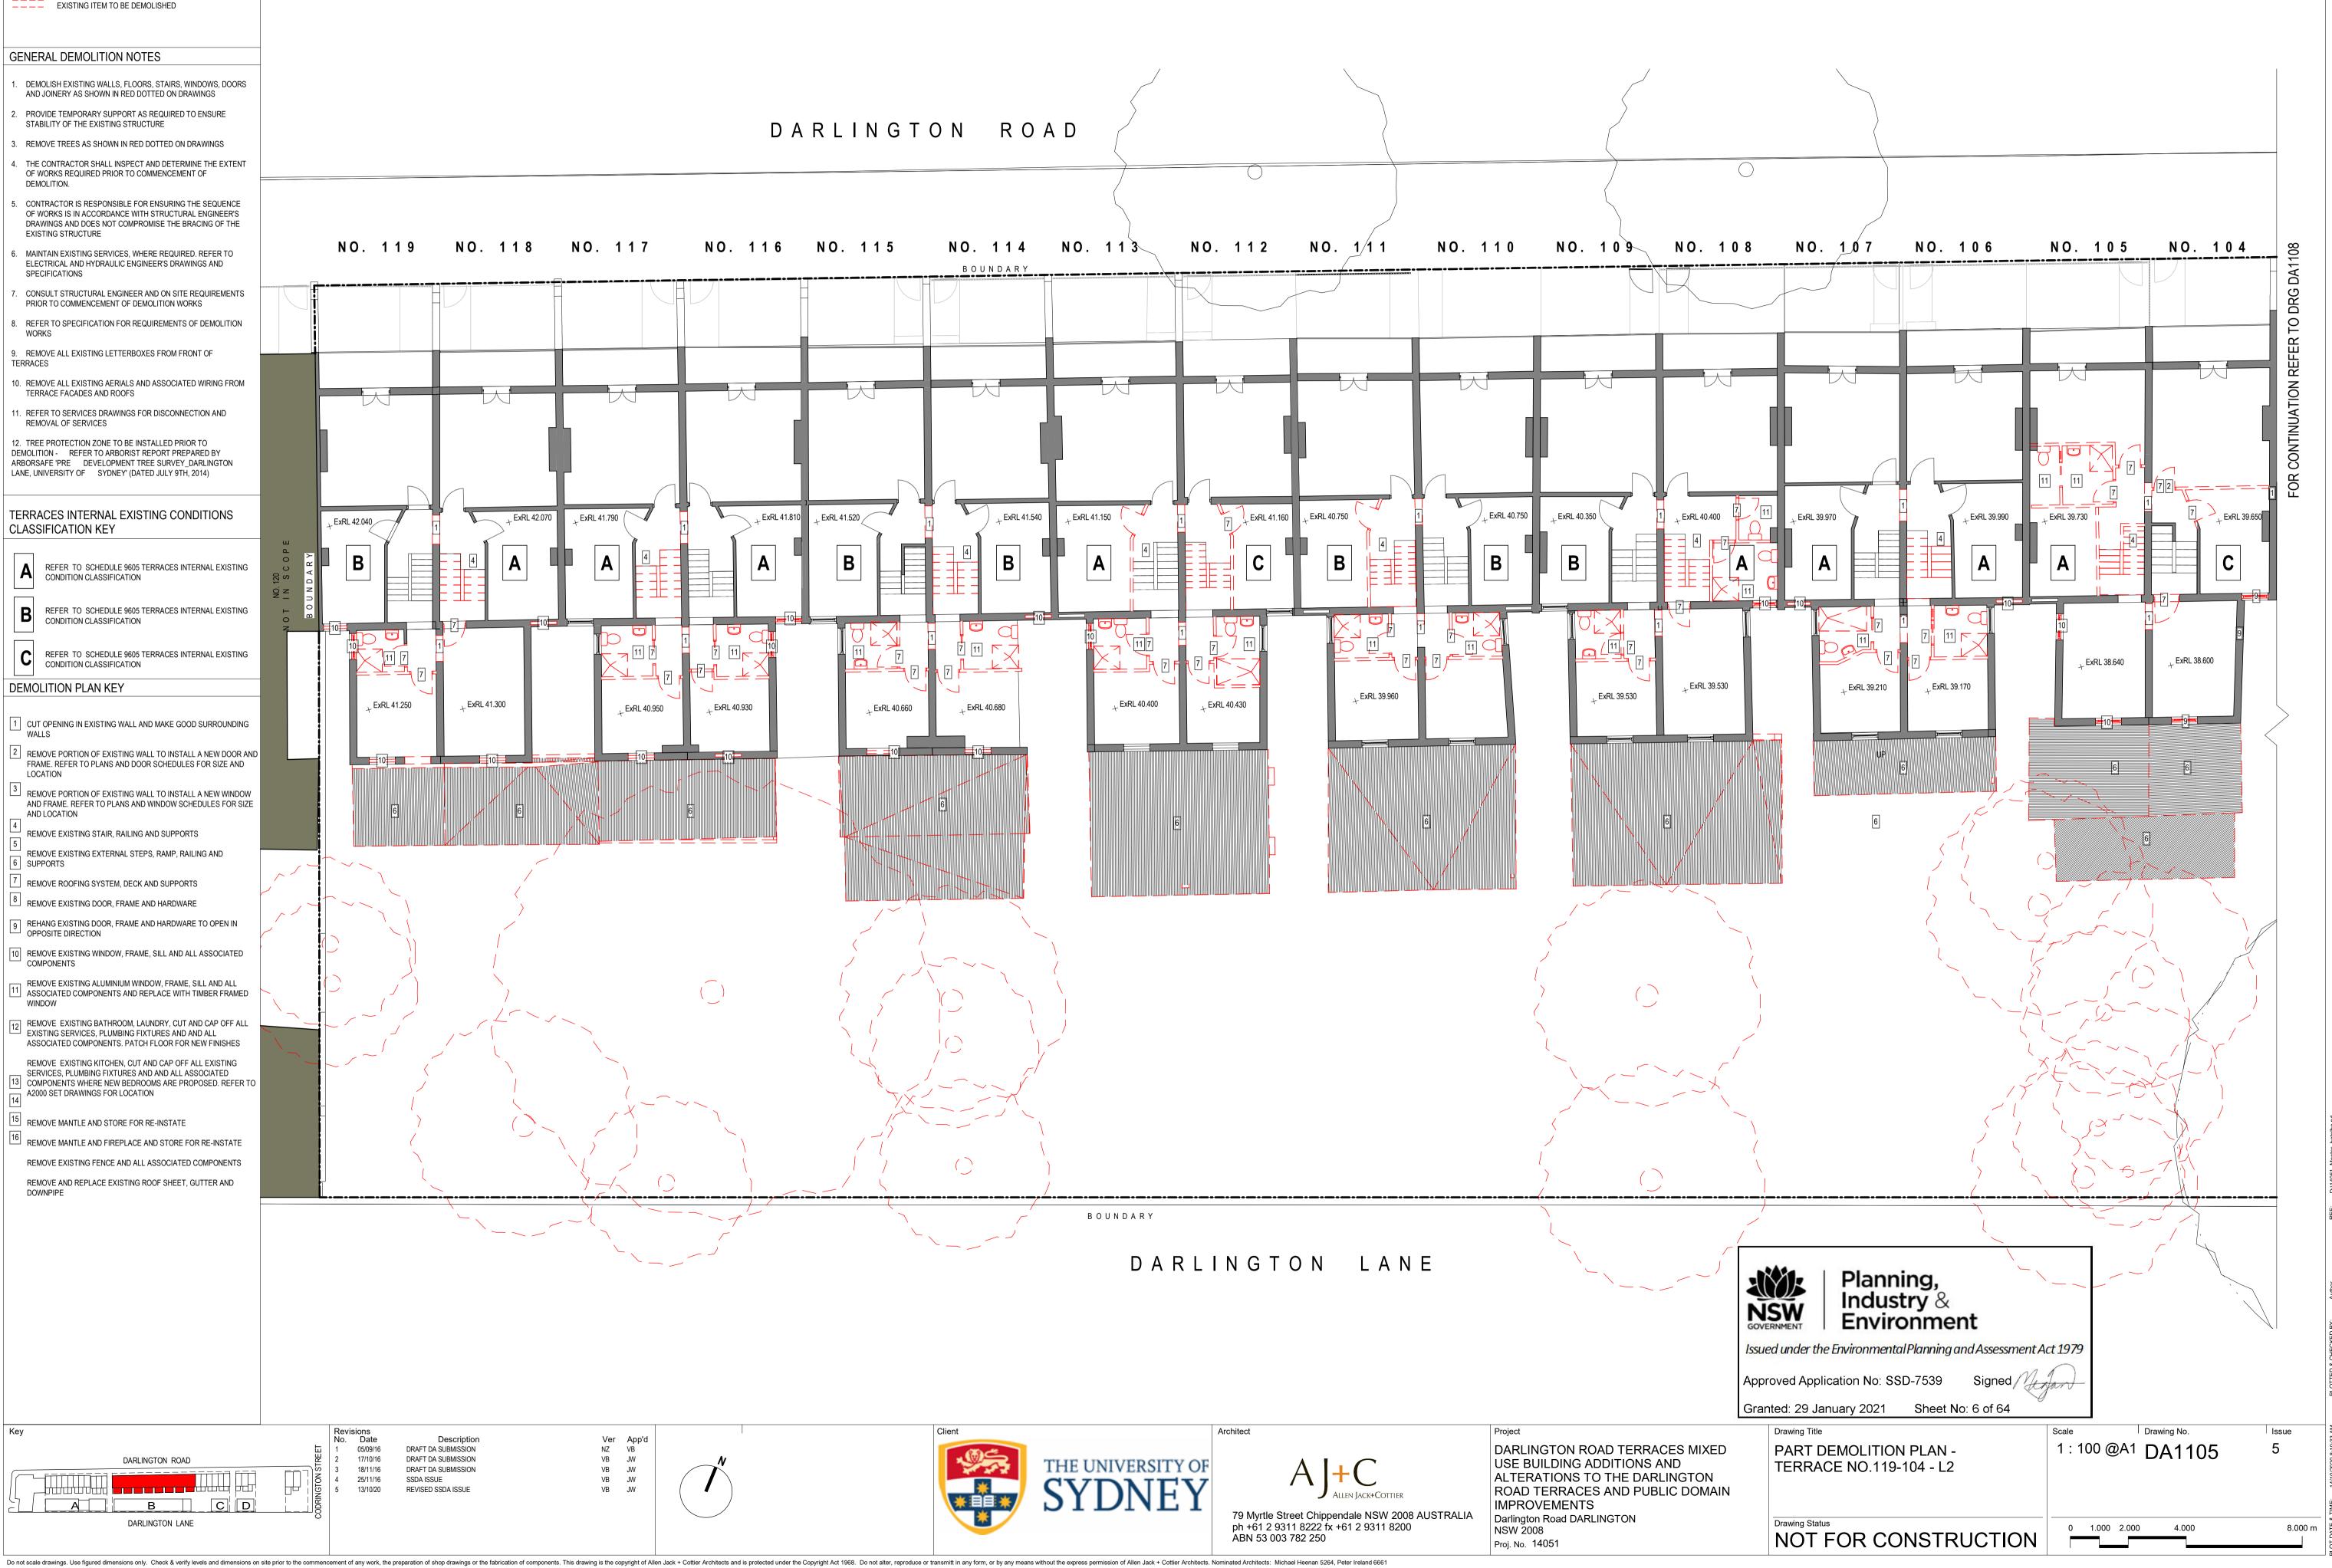
DEMOLITION PLAN LEGEND		
EXISTING WALL TO BE RETAINED EXISTING WALL TO BE DEMOLISHED EXISTING ITEM TO BE DEMOLISHED		
GENERAL DEMOLITION NOTES		
 DEMOLISH EXISTING WALLS, FLOORS, STAIRS, WINDOWS, DOORS AND JOINERY AS SHOWN IN RED DOTTED ON DRAWINGS PROVIDE TEMPORARY SUPPORT AS REQUIRED TO ENSURE STABILITY OF THE EXISTING STRUCTURE REMOVE TREES AS SHOWN IN RED DOTTED ON DRAWINGS 		DAF
 THE CONTRACTOR SHALL INSPECT AND DETERMINE THE EXTENT OF WORKS REQUIRED PRIOR TO COMMENCEMENT OF DEMOLITION. 		
5. CONTRACTOR IS RESPONSIBLE FOR ENSURING THE SEQUENCE OF WORKS IS IN ACCORDANCE WITH STRUCTURAL ENGINEER'S DRAWINGS AND DOES NOT COMPROMISE THE BRACING OF THE EXISTING STRUCTURE		. 118 NO. 117 NO. 116
6. MAINTAIN EXISTING SERVICES, WHERE REQUIRED. REFER TO ELECTRICAL AND HYDRAULIC ENGINEER'S DRAWINGS AND SPECIFICATIONS		
 CONSULT STRUCTURAL ENGINEER AND ON SITE REQUIREMENTS PRIOR TO COMMENCEMENT OF DEMOLITION WORKS REFER TO SPECIFICATION FOR REQUIREMENTS OF DEMOLITION WORKS 		
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DEMOLITION - REFER TO ARBORIST REPORT PREPARED BY ARBORSAFE 'PRE DEVELOPMENT TREE SURVEY_DARLINGTON LANE, UNIVERSITY OF SYDNEY' (DATED JULY 9TH, 2014)		
TERRACES INTERNAL EXISTING CONDITIONS CLASSIFICATION KEY	$ = = = \begin{bmatrix} 1 \\ 1 \\ 2 \end{bmatrix} = \begin{bmatrix} 1 \\ 2 \end{bmatrix} \begin{bmatrix}$	ExRL 38.510ExRL 38.510EXRL 38.490
A REFER TO SCHEDULE 9605 TERRACES INTERNAL EXISTING CONDITION CLASSIFICATION		
B REFER TO SCHEDULE 9605 TERRACES INTERNAL EXISTING CONDITION CLASSIFICATION		
C REFER TO SCHEDULE 9605 TERRACES INTERNAL EXISTING CONDITION CLASSIFICATION	+ ExRL 38.510 + ExRL	12 38.470 ExRL 38.230
1 CUT OPENING IN EXISTING WALL AND MAKE GOOD SURROUNDING WALLS		
2 REMOVE PORTION OF EXISTING WALL TO INSTALL A NEW DOOR AND FRAME. REFER TO PLANS AND DOOR SCHEDULES FOR SIZE AND LOCATION		
3 REMOVE PORTION OF EXISTING WALL TO INSTALL A NEW WINDOW AND FRAME. REFER TO PLANS AND WINDOW SCHEDULES FOR SIZE	11	
AND LOCATION 4 REMOVE EXISTING STAIR, RAILING AND SUPPORTS 5		
REMOVE EXISTING EXTERNAL STEPS, RAMP, RAILING AND SUPPORTS		
 REMOVE ROOFING SYSTEM, DECK AND SUPPORTS REMOVE EXISTING DOOR, FRAME AND HARDWARE 	5	$\langle \rangle$
9 REHANG EXISTING DOOR, FRAME AND HARDWARE TO OPEN IN OPPOSITE DIRECTION		REMOVE EXISTING WINDOW INSTAL A NEW DOOR AND FF REFER TO PLANS AND DOOF
10 REMOVE EXISTING WINDOW, FRAME, SILL AND ALL ASSOCIATED COMPONENTS REMOVE EXISTING ALUMINIUM WINDOW, FRAME, SILL AND ALL	X X	SCHEDULS FOR SIZE AND LO
ASSOCIATED COMPONENTS AND REPLACE WITH TIMBER FRAMED WINDOW		
12 REMOVE EXISTING BATHROOM, LAUNDRY, CUT AND CAP OFF ALL EXISTING SERVICES, PLUMBING FIXTURES AND AND ALL ASSOCIATED COMPONENTS. PATCH FLOOR FOR NEW FINISHES		
REMOVE EXISTING KITCHEN, CUT AND CAP OFF ALL EXISTING SERVICES, PLUMBING FIXTURES AND AND ALL ASSOCIATED COMPONENTS WHERE NEW BEDROOMS ARE PROPOSED. REFER TO A2000 SET DRAWINGS FOR LOCATION		
15 REMOVE MANTLE AND STORE FOR RE-INSTATE		
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REMOVE AND REPLACE EXISTING ROOF SHEET, GUTTER AND DOWNPIPE		
Кеу	Revisions	
DARLINGTON ROAD	No. Date Description	Ver App'd NZ VB VB JW
	Image: 1 05/09/16 DRAFT DA SUBMISSION Image: 2 17/10/16 DRAFT DA SUBMISSION Image: 3 18/11/16 DRAFT DA SUBMISSION Image: 4 25/11/16 SSDA ISSUE Image: 5 13/10/20 REVISED SSDA ISSUE	VB JW VB JW VB JW

DARLINGTON LANE






DEMOLITION PLAN LEGEND				
EXISTING WALL TO BE RETAINED EXISTING WALL TO BE DEMOLISHED EXISTING ITEM TO BE DEMOLISHED				
GENERAL DEMOLITION NOTES	_			
1. DEMOLISH EXISTING WALLS, FLOORS, STAIRS, WINDOWS, DOORS AND JOINERY AS SHOWN IN RED DOTTED ON DRAWINGS				
2. PROVIDE TEMPORARY SUPPORT AS REQUIRED TO ENSURE STABILITY OF THE EXISTING STRUCTURE			D	ARLI
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 MAINTAIN EXISTING SERVICES, WHERE REQUIRED. REFER TO ELECTRICAL AND HYDRAULIC ENGINEER'S DRAWINGS AND SPECIFICATIONS 	NU. 119	NO. 118	NO. 117 NO. 116	N O .
 CONSULT STRUCTURAL ENGINEER AND ON SITE REQUIREMENTS PRIOR TO COMMENCEMENT OF DEMOLITION WORKS REFER TO SPECIFICATION FOR REQUIREMENTS OF DEMOLITION WORKS 				
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TERRACES INTERNAL EXISTING CONDITIONS CLASSIFICATION KEY	+ ExRL 42.040	1 + ExRL 42.070	+ ExRL 41.790	110 + ExRL 41.520
A REFER TO SCHEDULE 9605 TERRACES INTERNAL EXISTING CONDITION CLASSIFICATION	B A R Y R Y R Y R Y R Y R Y R Y R Y R Y R	A 4		В
B REFER TO SCHEDULE 9605 TERRACES INTERNAL EXISTING CONDITION CLASSIFICATION				
C REFER TO SCHEDULE 9605 TERRACES INTERNAL EXISTING CONDITION CLASSIFICATION		T T		
DEMOLITION PLAN KEY	ExRL 41.250	L = ExRL 41.300	ExRL 40.950 + ExRL 40.930	
1 CUT OPENING IN EXISTING WALL AND MAKE GOOD SURROUNDING WALLS				
2 REMOVE PORTION OF EXISTING WALL TO INSTALL A NEW DOOR AND FRAME. REFER TO PLANS AND DOOR SCHEDULES FOR SIZE AND LOCATION				
3 REMOVE PORTION OF EXISTING WALL TO INSTALL A NEW WINDOW AND FRAME. REFER TO PLANS AND WINDOW SCHEDULES FOR SIZE	6			
AND LOCATION 4 REMOVE EXISTING STAIR, RAILING AND SUPPORTS 5				
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13COMPONENTS WHERE NEW BEDROOMS ARE PROPOSED. REFER TO14A2000 SET DRAWINGS FOR LOCATION				
15 REMOVE MANTLE AND STORE FOR RE-INSTATE 16 REMOVE MANTLE AND FIREPLACE AND STORE FOR RE-INSTATE	\sim			
REMOVE MANTLE AND FIREPLACE AND STORE FOR RE-INSTATE REMOVE EXISTING FENCE AND ALL ASSOCIATED COMPONENTS				,
REMOVE AND REPLACE EXISTING ROOF SHEET, GUTTER AND DOWNPIPE				/
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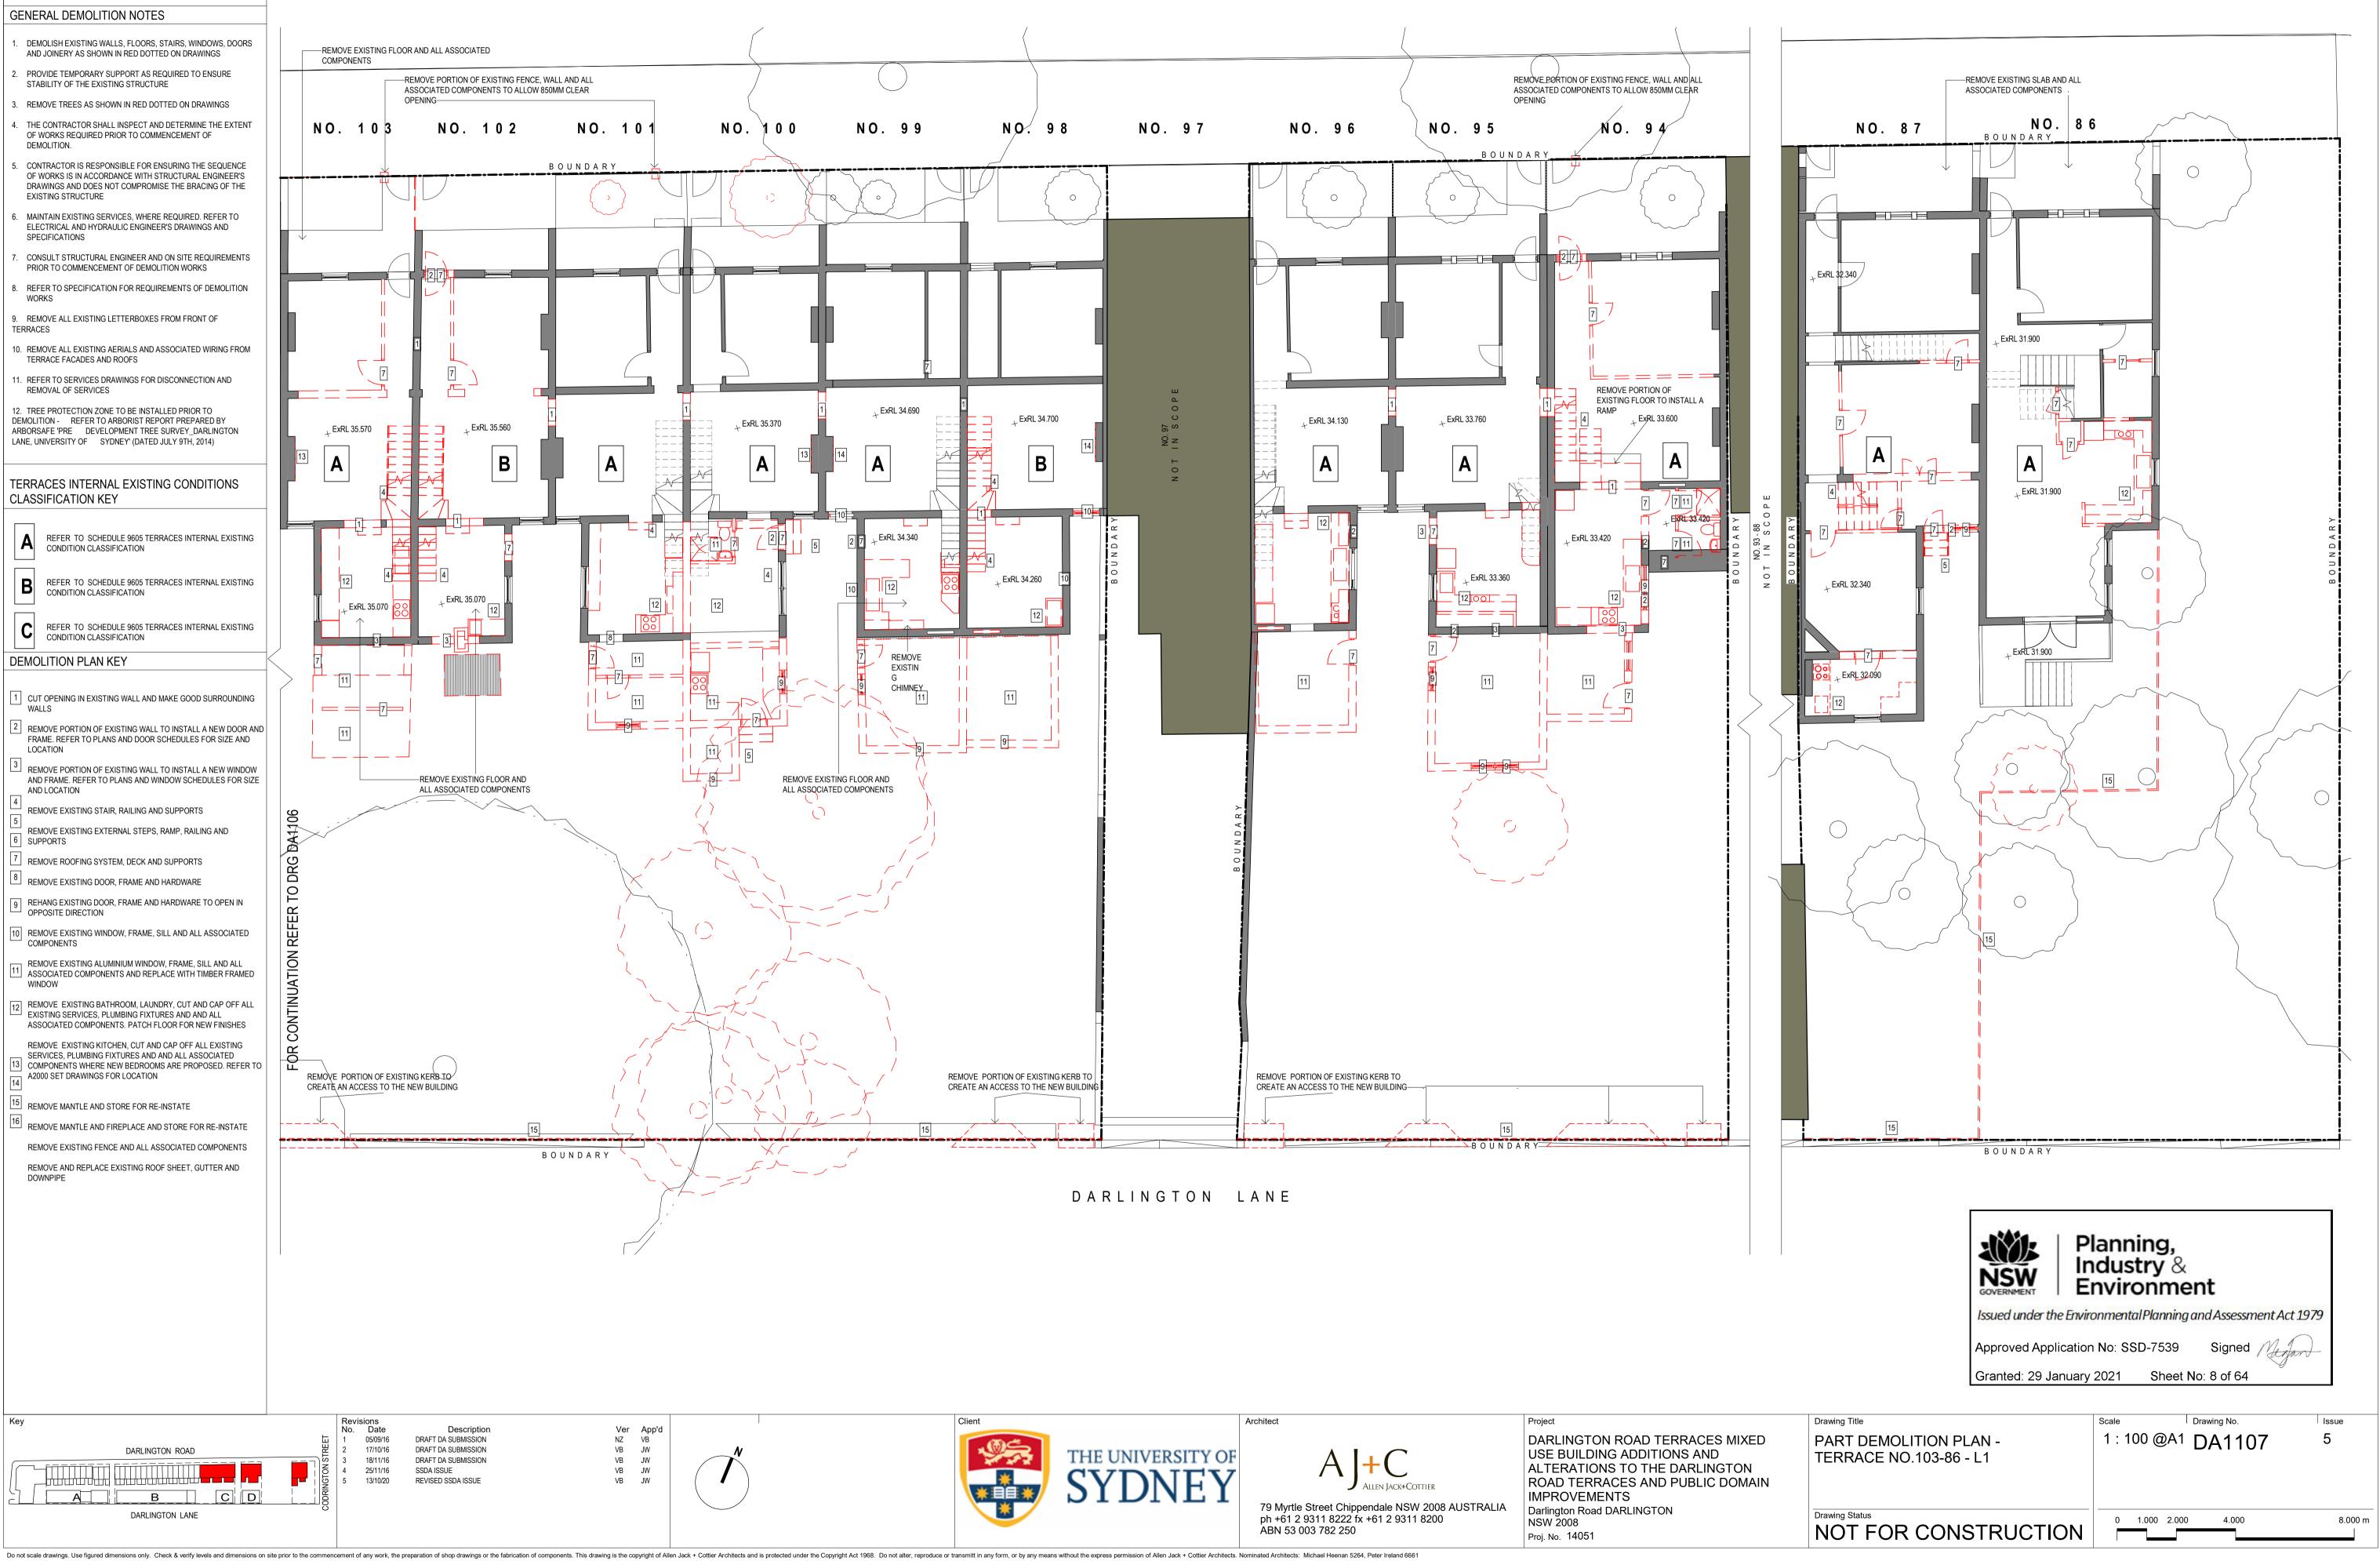


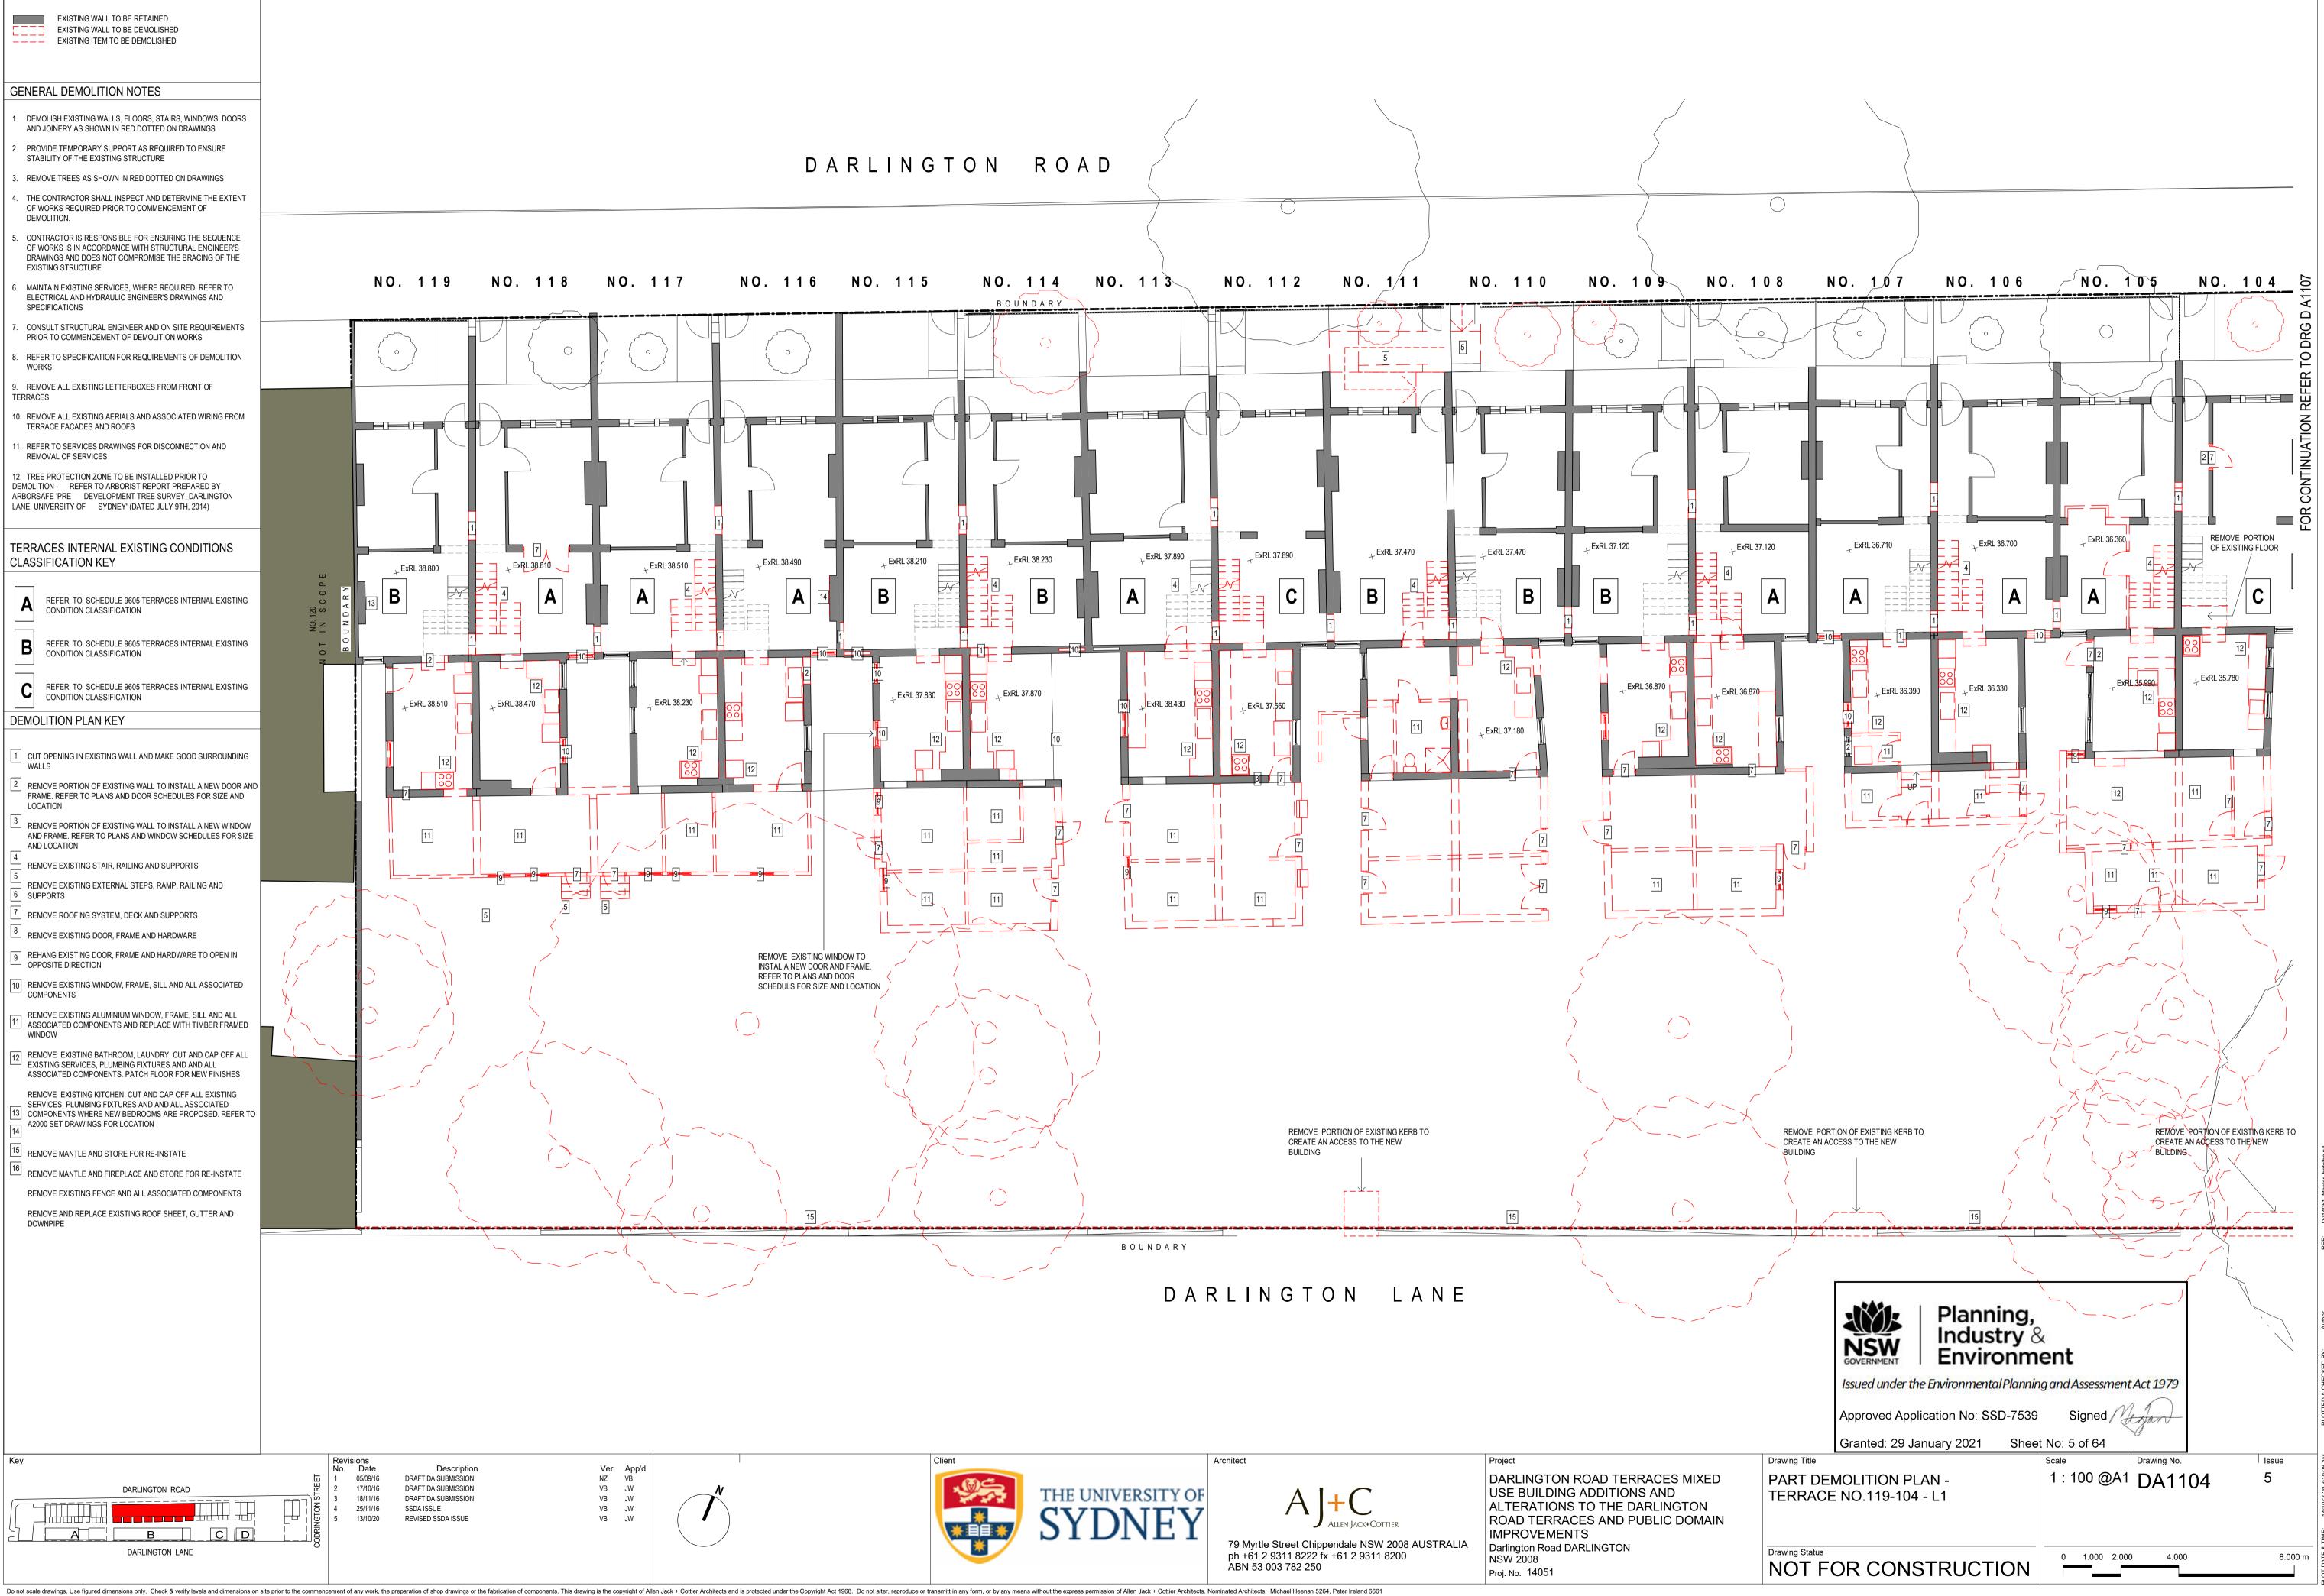
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12. TREE PROTECTION ZONE TO BE INSTALLED PRIOR TO DEMOLITION - REFER TO ARBORIST REPORT PREPARED BY	
ARBORSAFE 'PRE DEVELOPMENT TREE SURVEY_DARLINGTON LANE, UNIVERSITY OF SYDNEY' (DATED JULY 9TH, 2014)	
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B REFER TO SCHEDULE 9605 TERRACES INTERNAL EXISTING CONDITION CLASSIFICATION	
C REFER TO SCHEDULE 9605 TERRACES INTERNAL EXISTING CONDITION CLASSIFICATION	
1 CUT OPENING IN EXISTING WALL AND MAKE GOOD SURROUNDING WALLS	
2 REMOVE PORTION OF EXISTING WALL TO INSTALL A NEW DOOR AND FRAME. REFER TO PLANS AND DOOR SCHEDULES FOR SIZE AND	
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AND FRAME. REFER TO PLANS AND WINDOW SCHEDULES FOR SIZE AND LOCATION 4 REMOVE EXISTING STAIR, RAILING AND SUPPORTS	
5 REMOVE EXISTING EXTERNAL STEPS, RAMP, RAILING AND 6 SUPPORTS	
7 REMOVE ROOFING SYSTEM, DECK AND SUPPORTS	
8 REMOVE EXISTING DOOR, FRAME AND HARDWARE 9 REHANG EXISTING DOOR, FRAME AND HARDWARE TO OPEN IN	
 OPPOSITE DIRECTION 10 REMOVE EXISTING WINDOW, FRAME, SILL AND ALL ASSOCIATED 	
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14 A2000 SET DRAWINGS FOR LOCATION 15 REMOVE MANTLE AND STORE FOR RE-INSTATE	
¹⁶ REMOVE MANTLE AND FIREPLACE AND STORE FOR RE-INSTATE	
REMOVE EXISTING FENCE AND ALL ASSOCIATED COMPONENTS REMOVE AND REPLACE EXISTING ROOF SHEET, GUTTER AND	
DOWNPIPE	
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DEMOLITION PLAN LEGEND		
EXISTING WALL TO BE RETAINED EXISTING WALL TO BE DEMOLISHED EXISTING ITEM TO BE DEMOLISHED		
GENERAL DEMOLITION NOTES		
1. DEMOLISH EXISTING WALLS, FLOORS, STAIRS, WINDOWS, DOORS AND JOINERY AS SHOWN IN RED DOTTED ON DRAWINGS	REMOVE EXISTING FLOOR AND ALL ASSOCIATED	
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PRIOR TO COMMENCEMENT OF DEMOLITION WORKS 8. REFER TO SPECIFICATION FOR REQUIREMENTS OF DEMOLITION WORKS		
9. REMOVE ALL EXISTING LETTERBOXES FROM FRONT OF TERRACES		
10. REMOVE ALL EXISTING AERIALS AND ASSOCIATED WIRING FROM TERRACE FACADES AND ROOFS		
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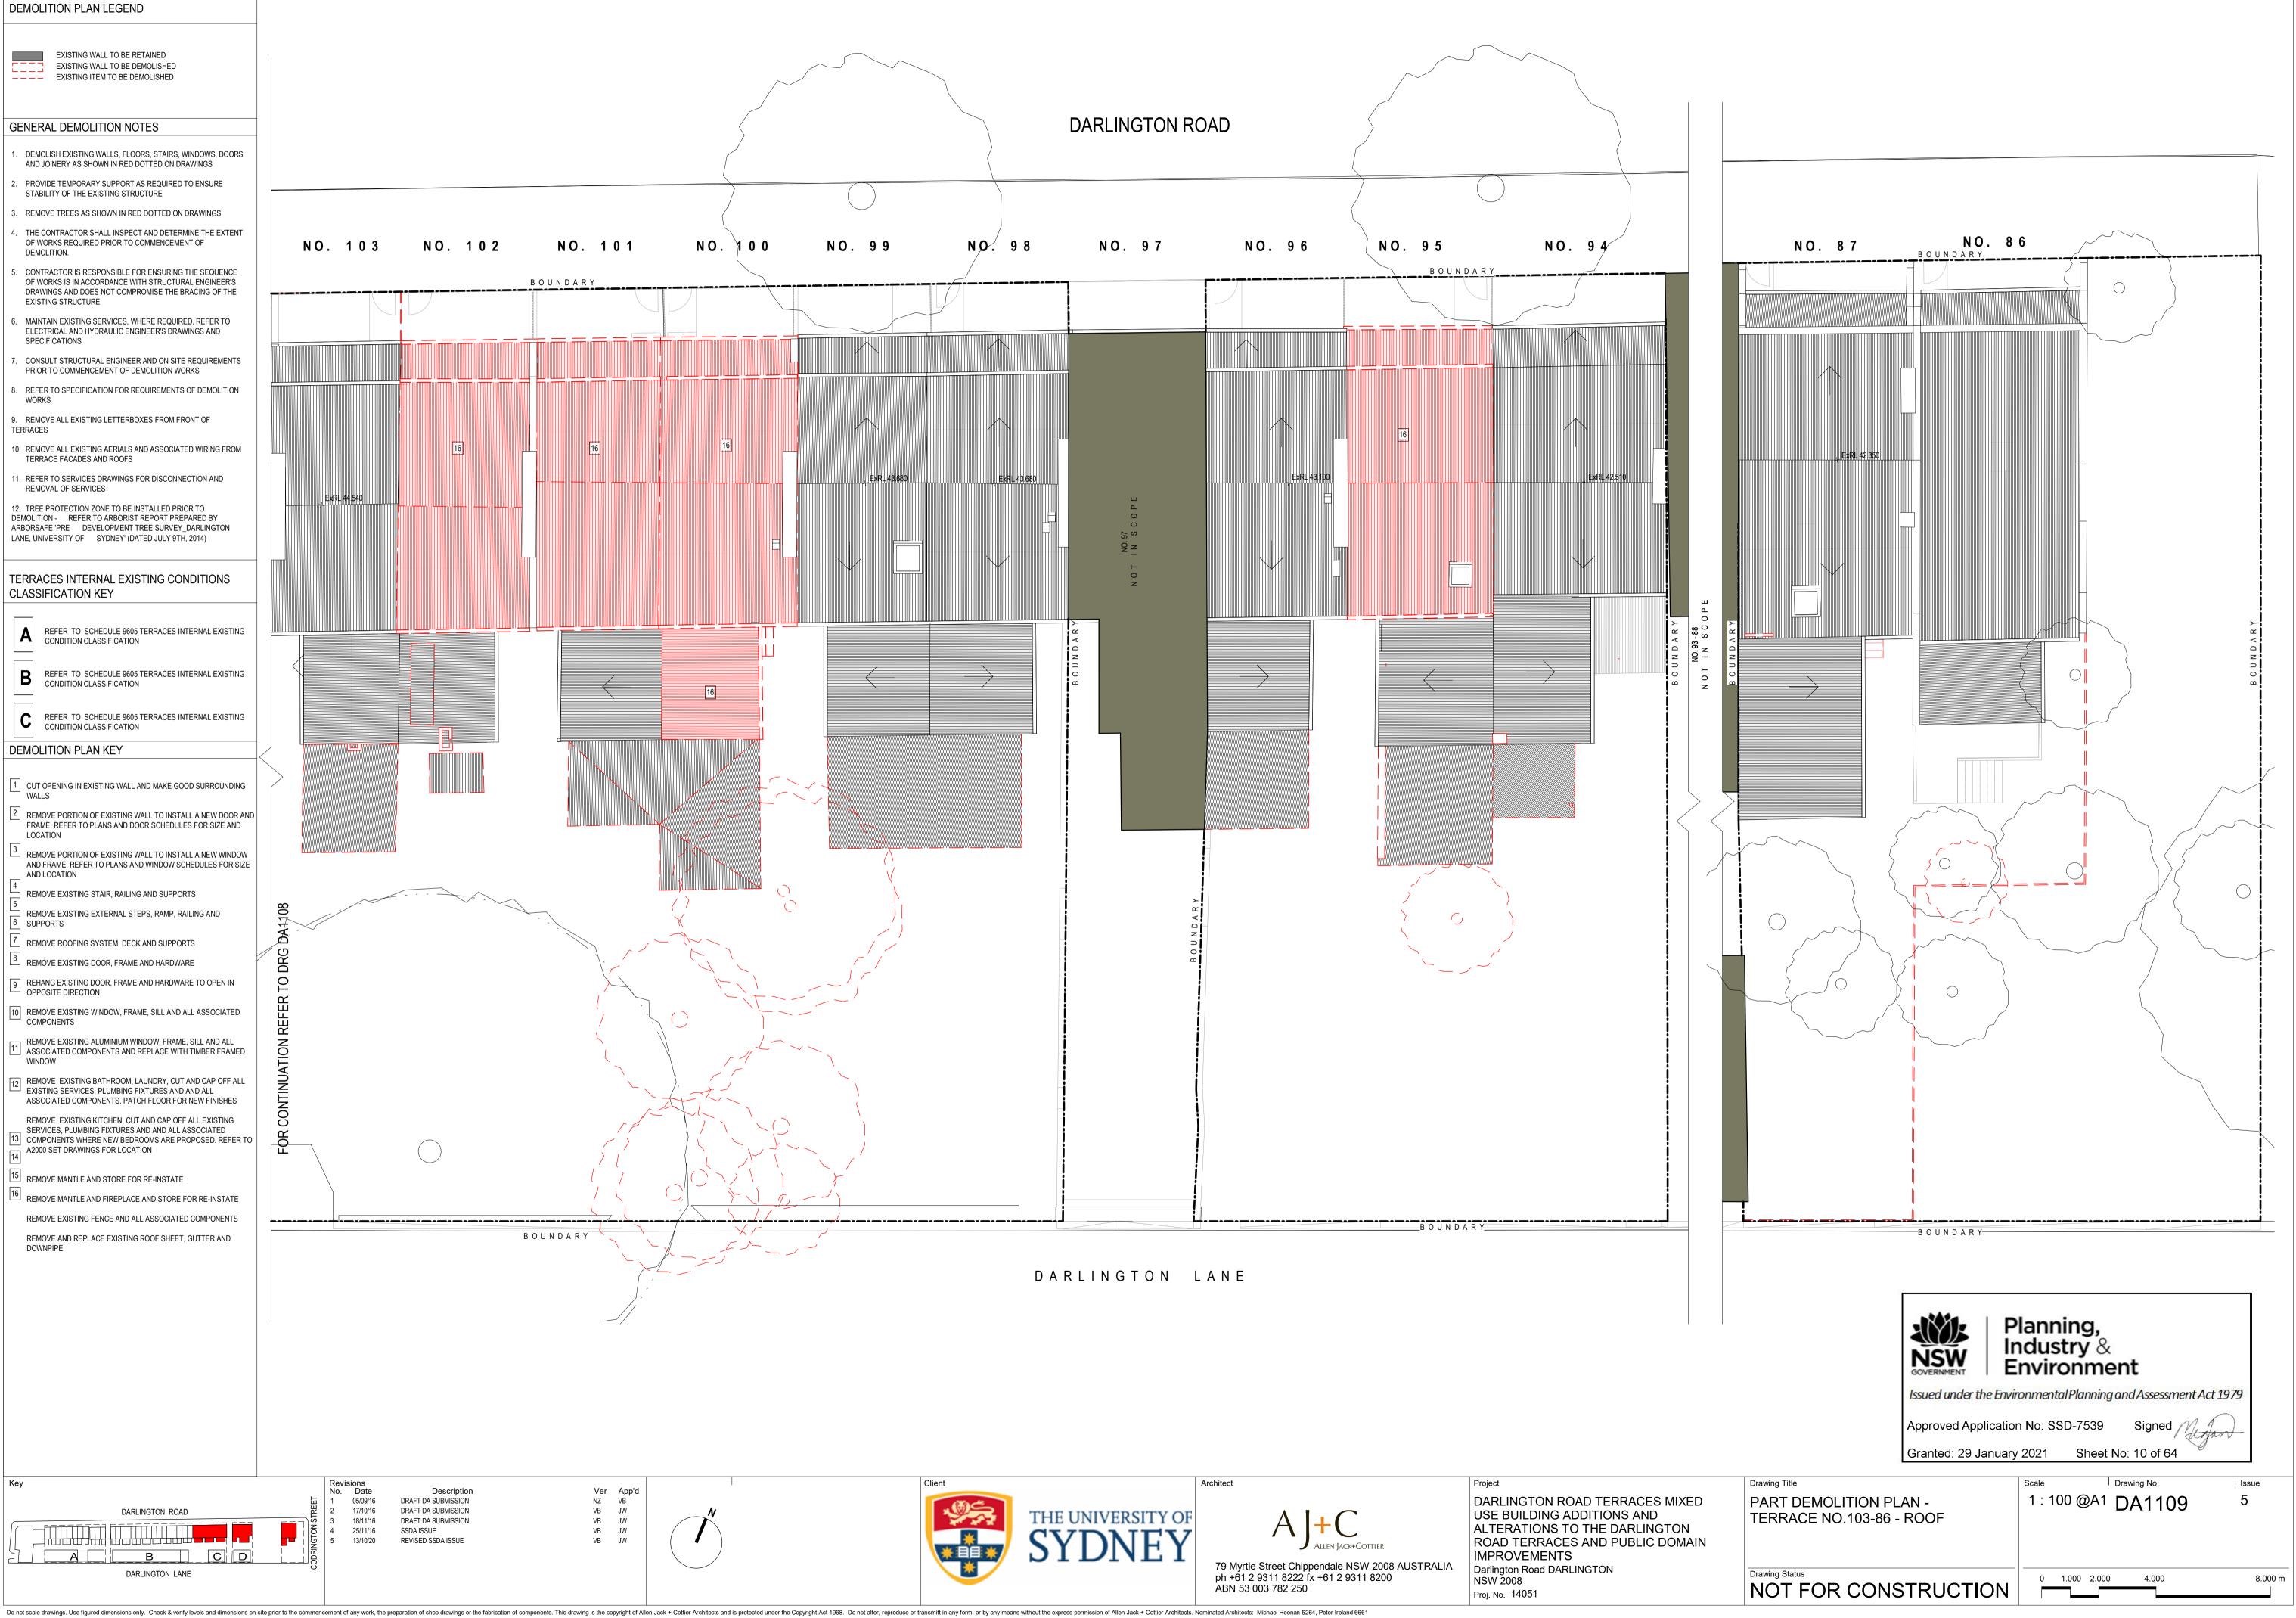



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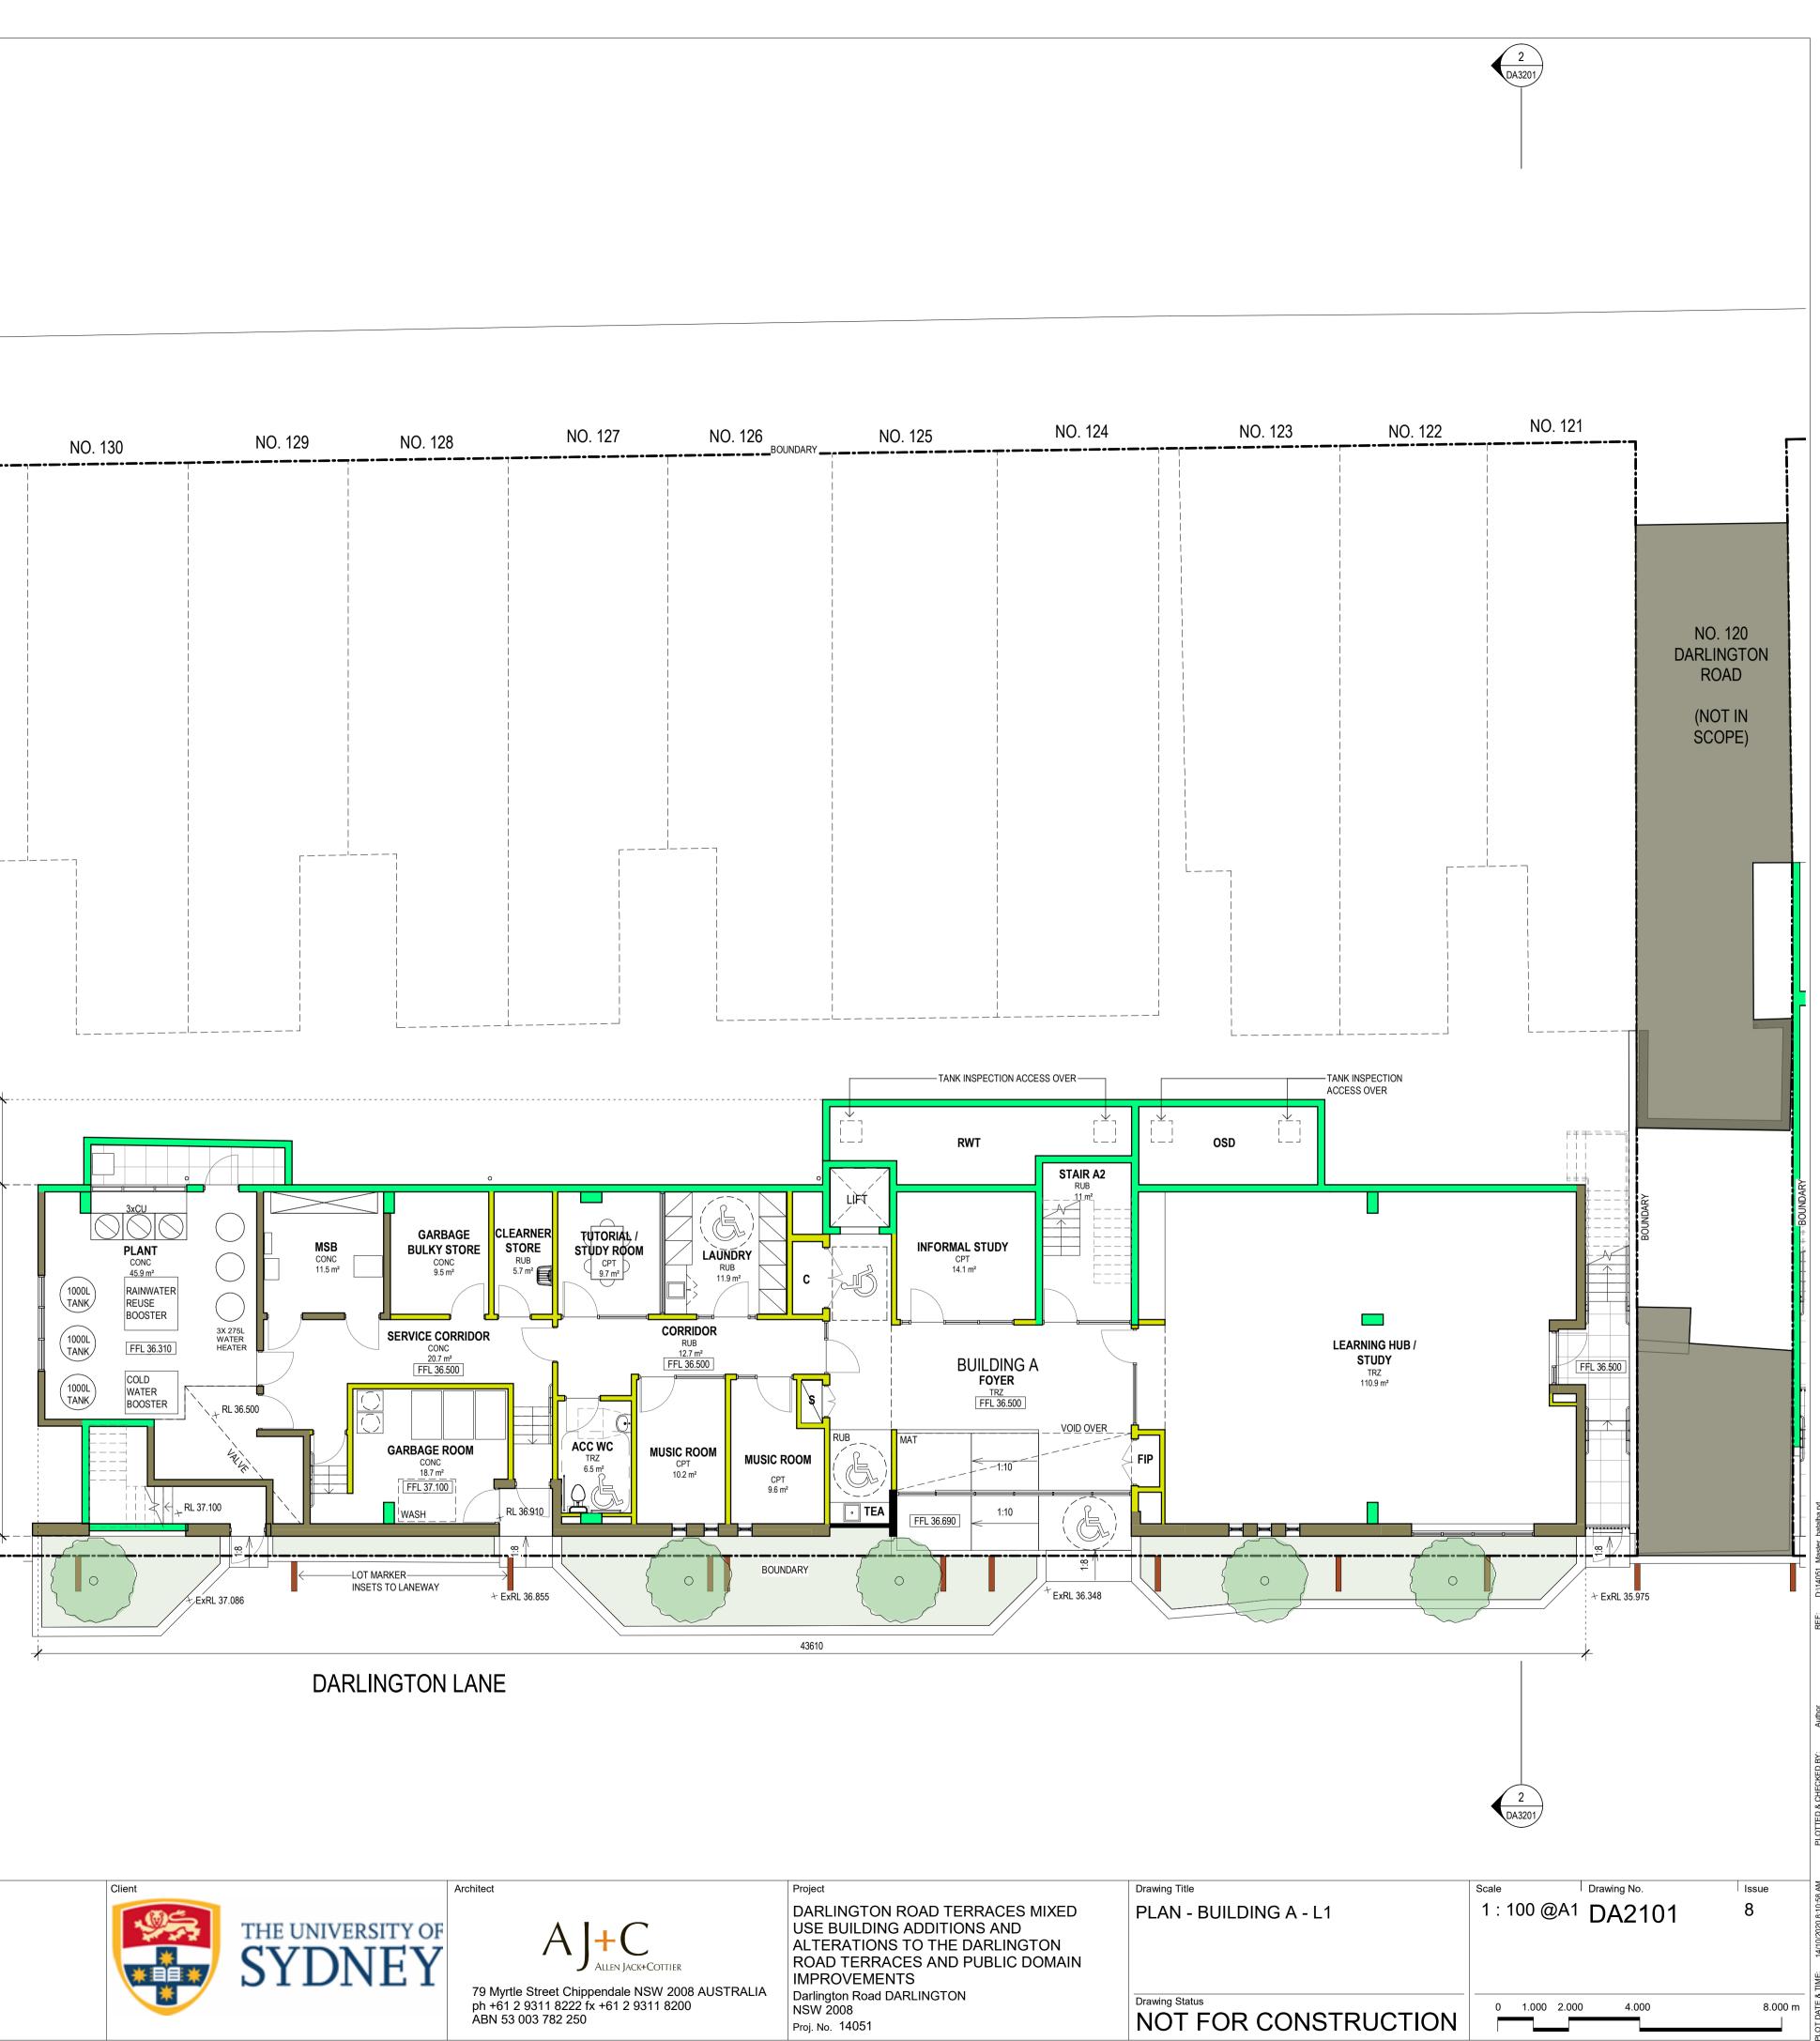



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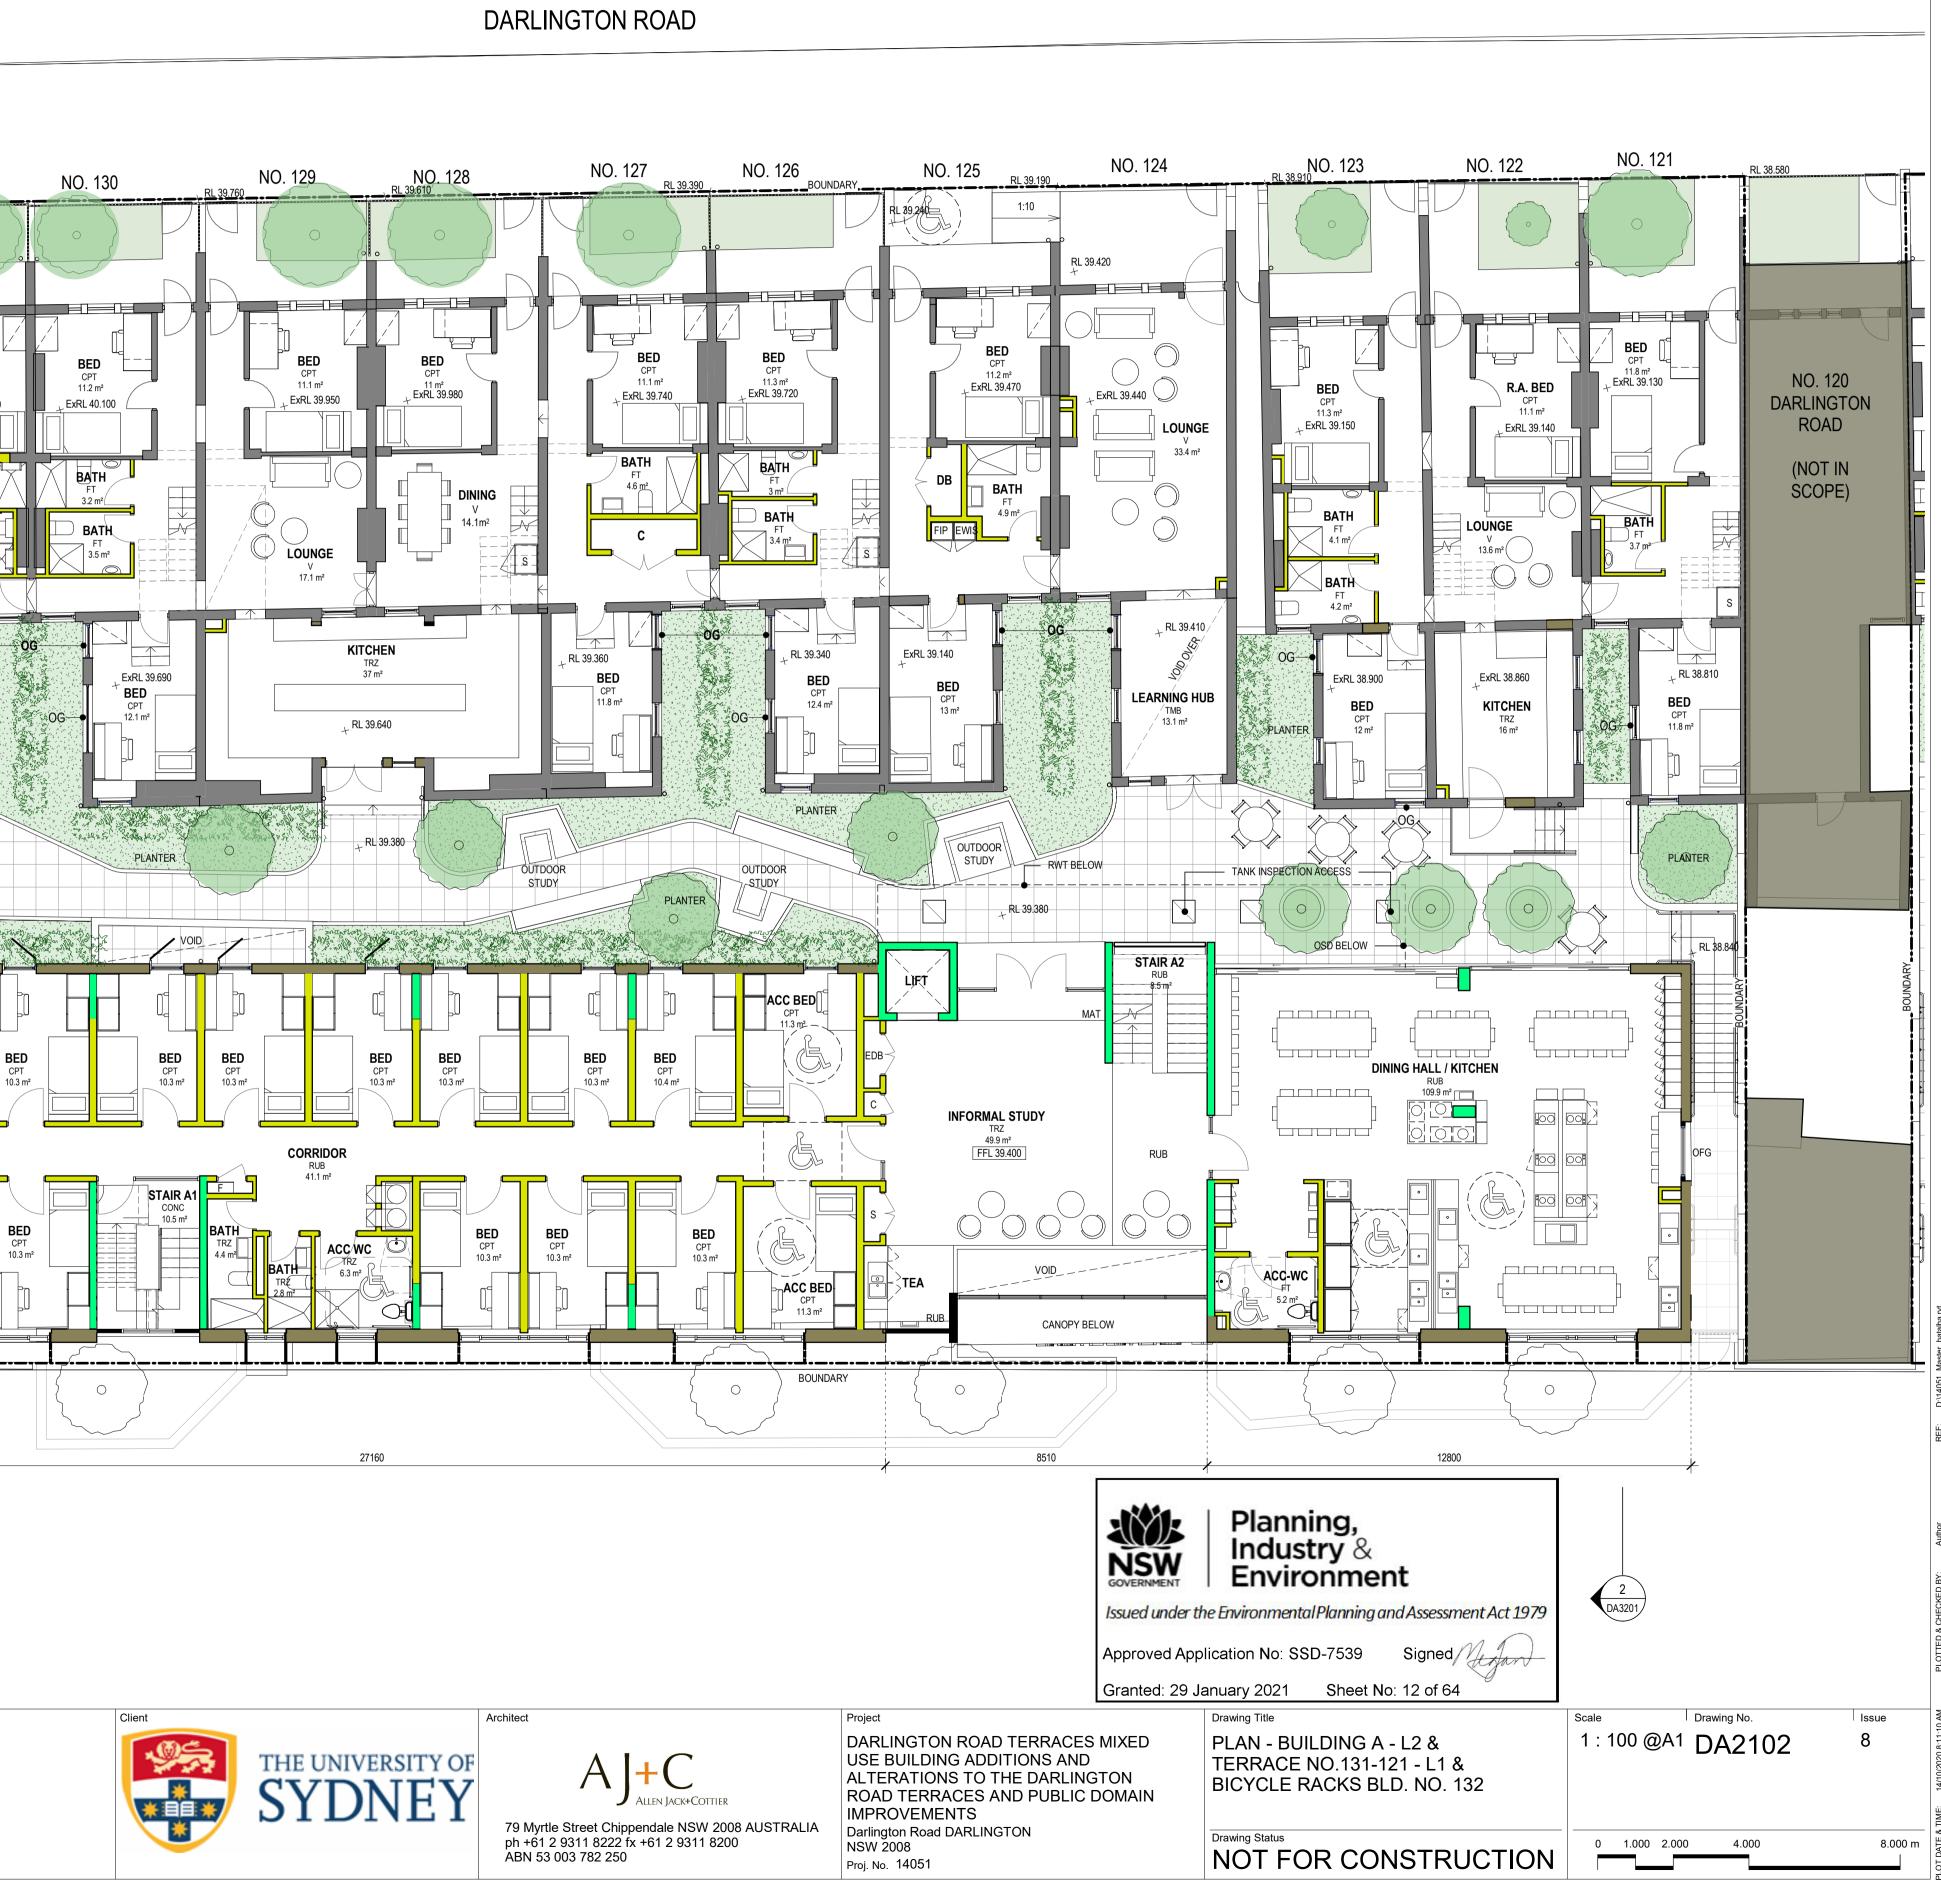


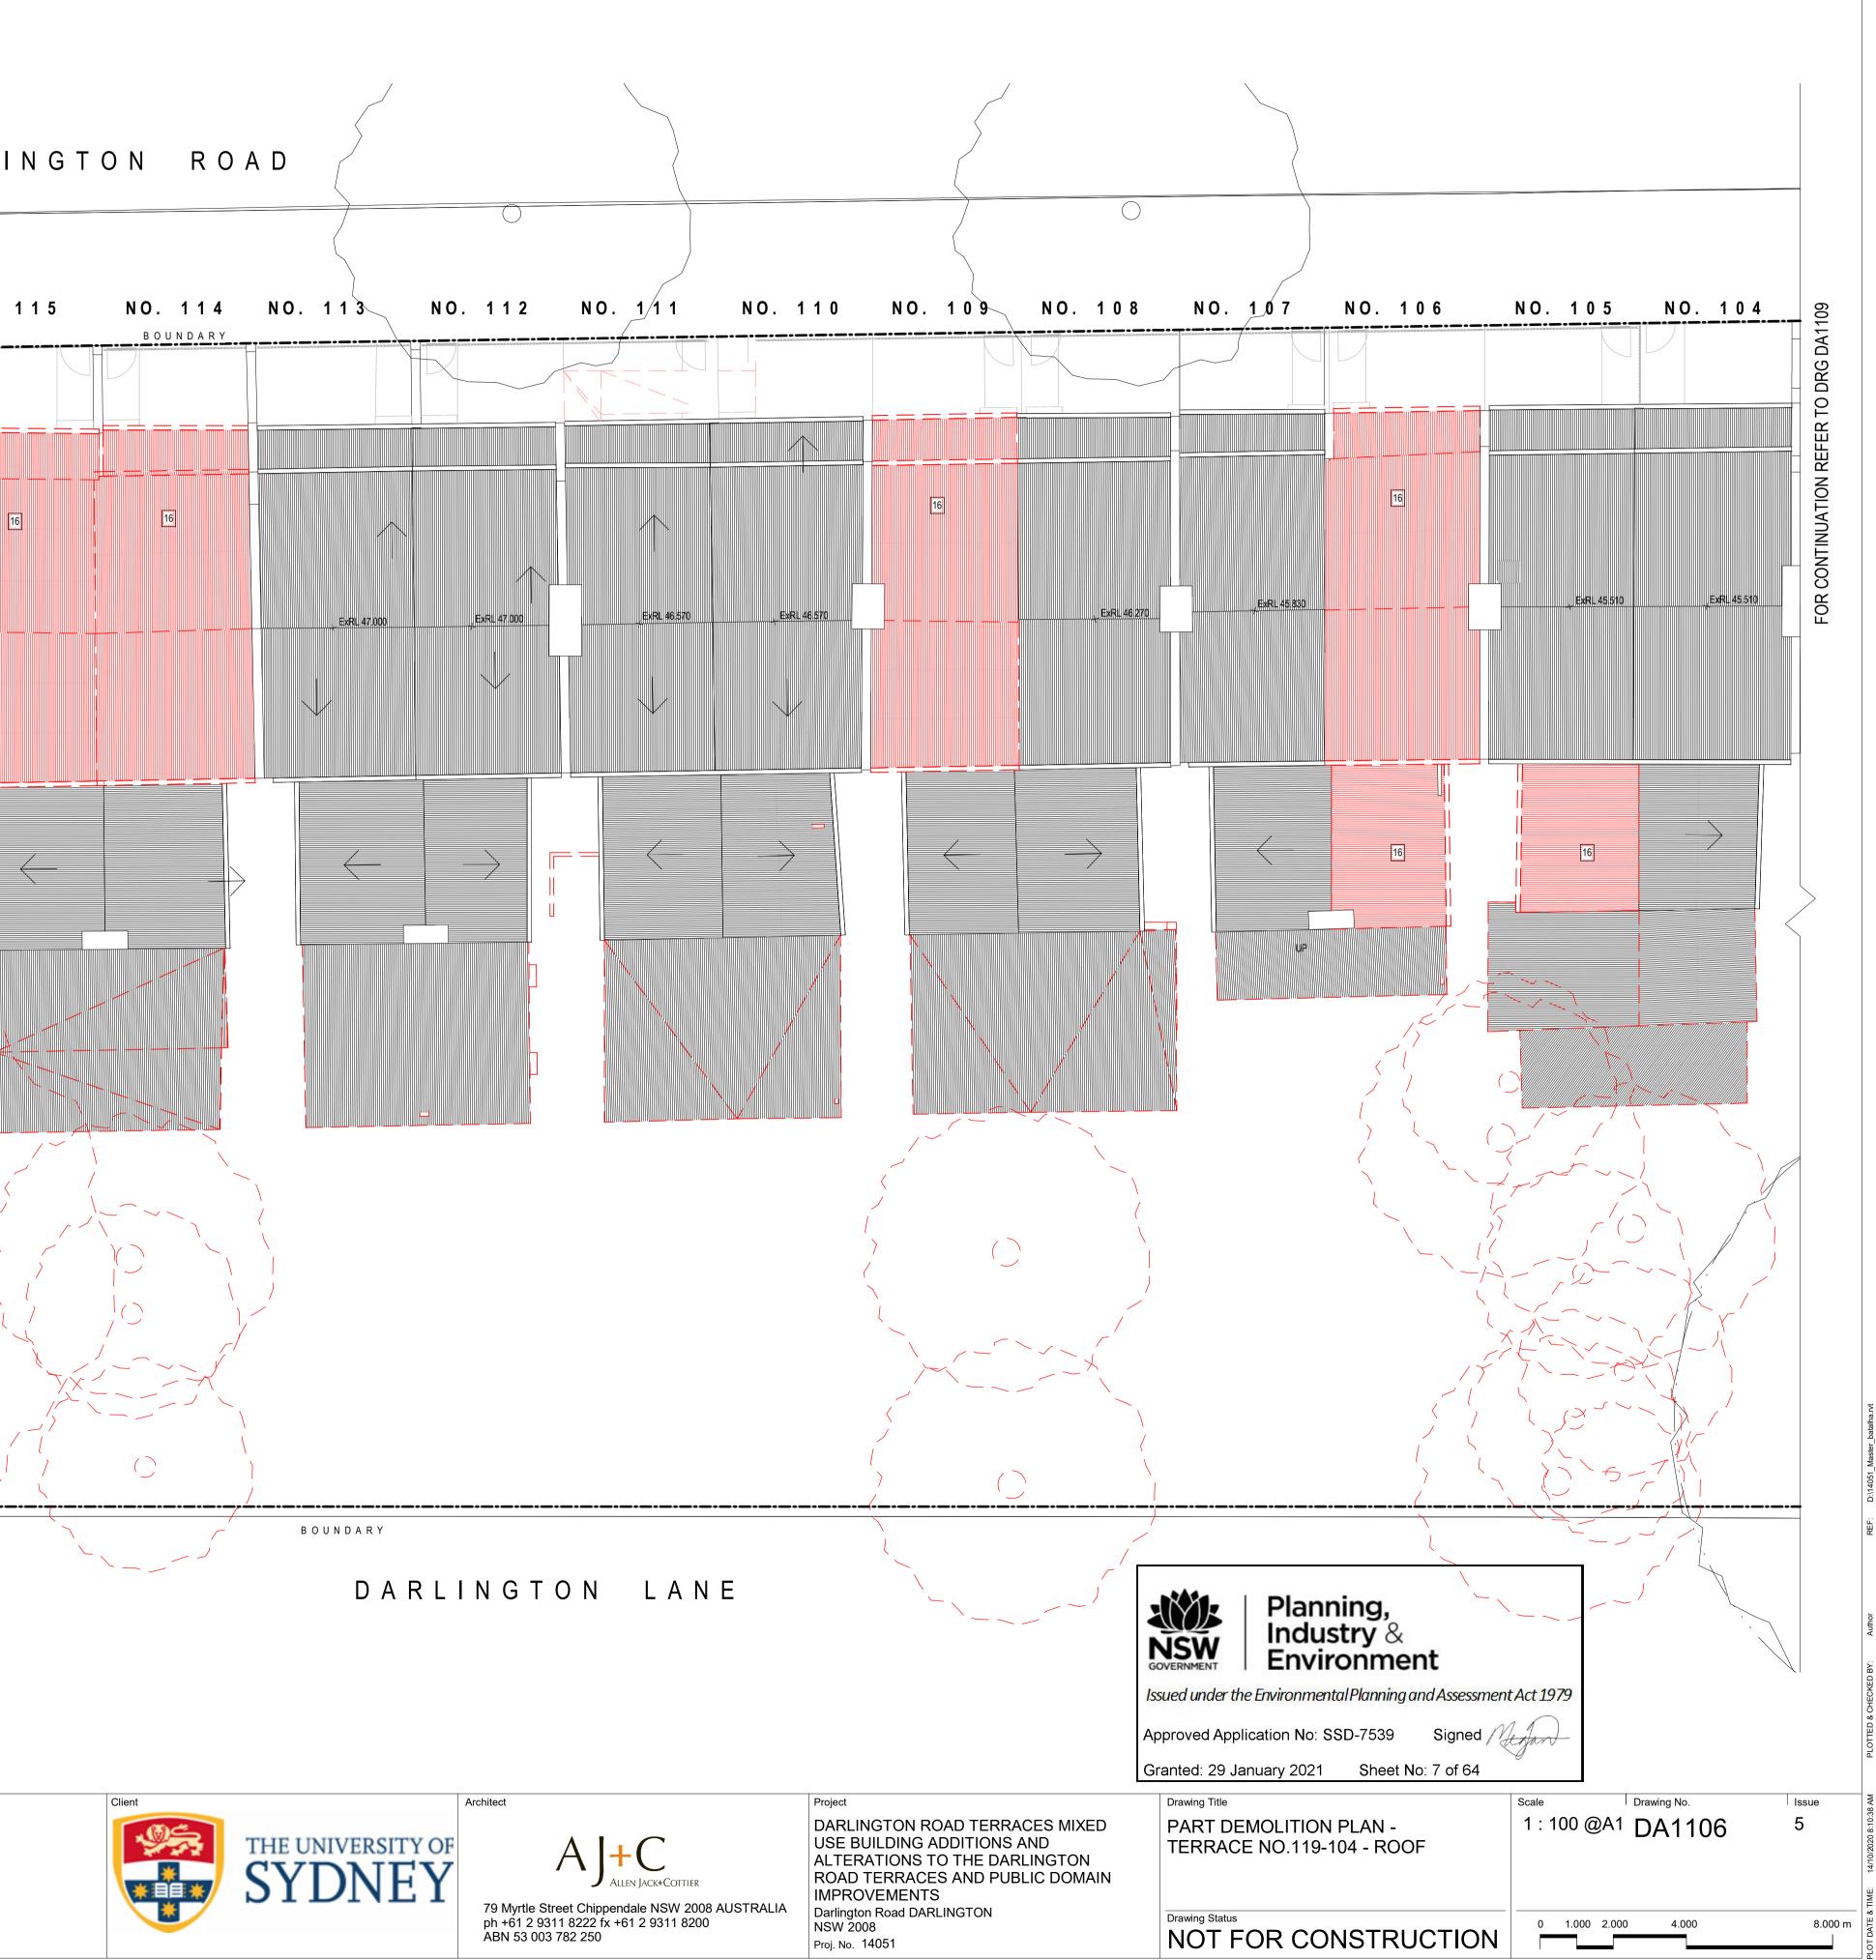

NO. 131 RL 40.150 BED CPT 11.1 m² ExRL 40.110 EXISTING STORE BATH -BATH ExRL 39.700 BED CPT 13.2 m² **BIKE MAINTENANCE** OG _ ExRL 38.550 NOT IN SCOPE - - - - -10 ACC BED CPT 12 11 WAITING BAY ----NEW BICYCLE RACKS (90) ACC BED_ GARBAGE GARBAGE 11.3 m² MATERIALS KEY EXISTING FABRIC TO BE RETAINED PROPOSED - CONCRETE (1) (DA3201) PROPOSED - GLAZING PROPOSED - LIGHTWEIGHT WALL PROPOSED - MASONRY Revisions Ver App'd NZ VB No. Date Description DRAFT DA SUBMISSION 05/09/16 ISSUE FOR CONSULTANTS COORDINATION DARLINGTON ROAD 05/10/16 NZ VB VB JW VB JW VB JW 17/10/16 DRAFT DA SUBMISSION 18/11/16 DRAFT DA SUBMISSION 25/11/16 SSDA ISSUE VB JW VB JW 21/03/18 SSDA ISSUE C D R 14/10/19 REVISED SSDA ISSUE 13/10/20 REVISED SSDA ISSUE VB JW DARLINGTON LANE

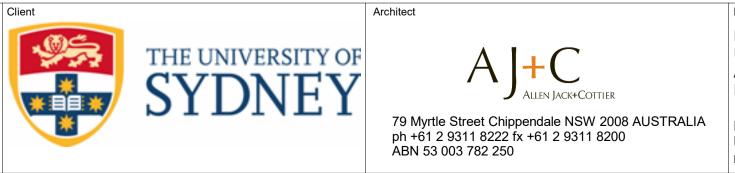
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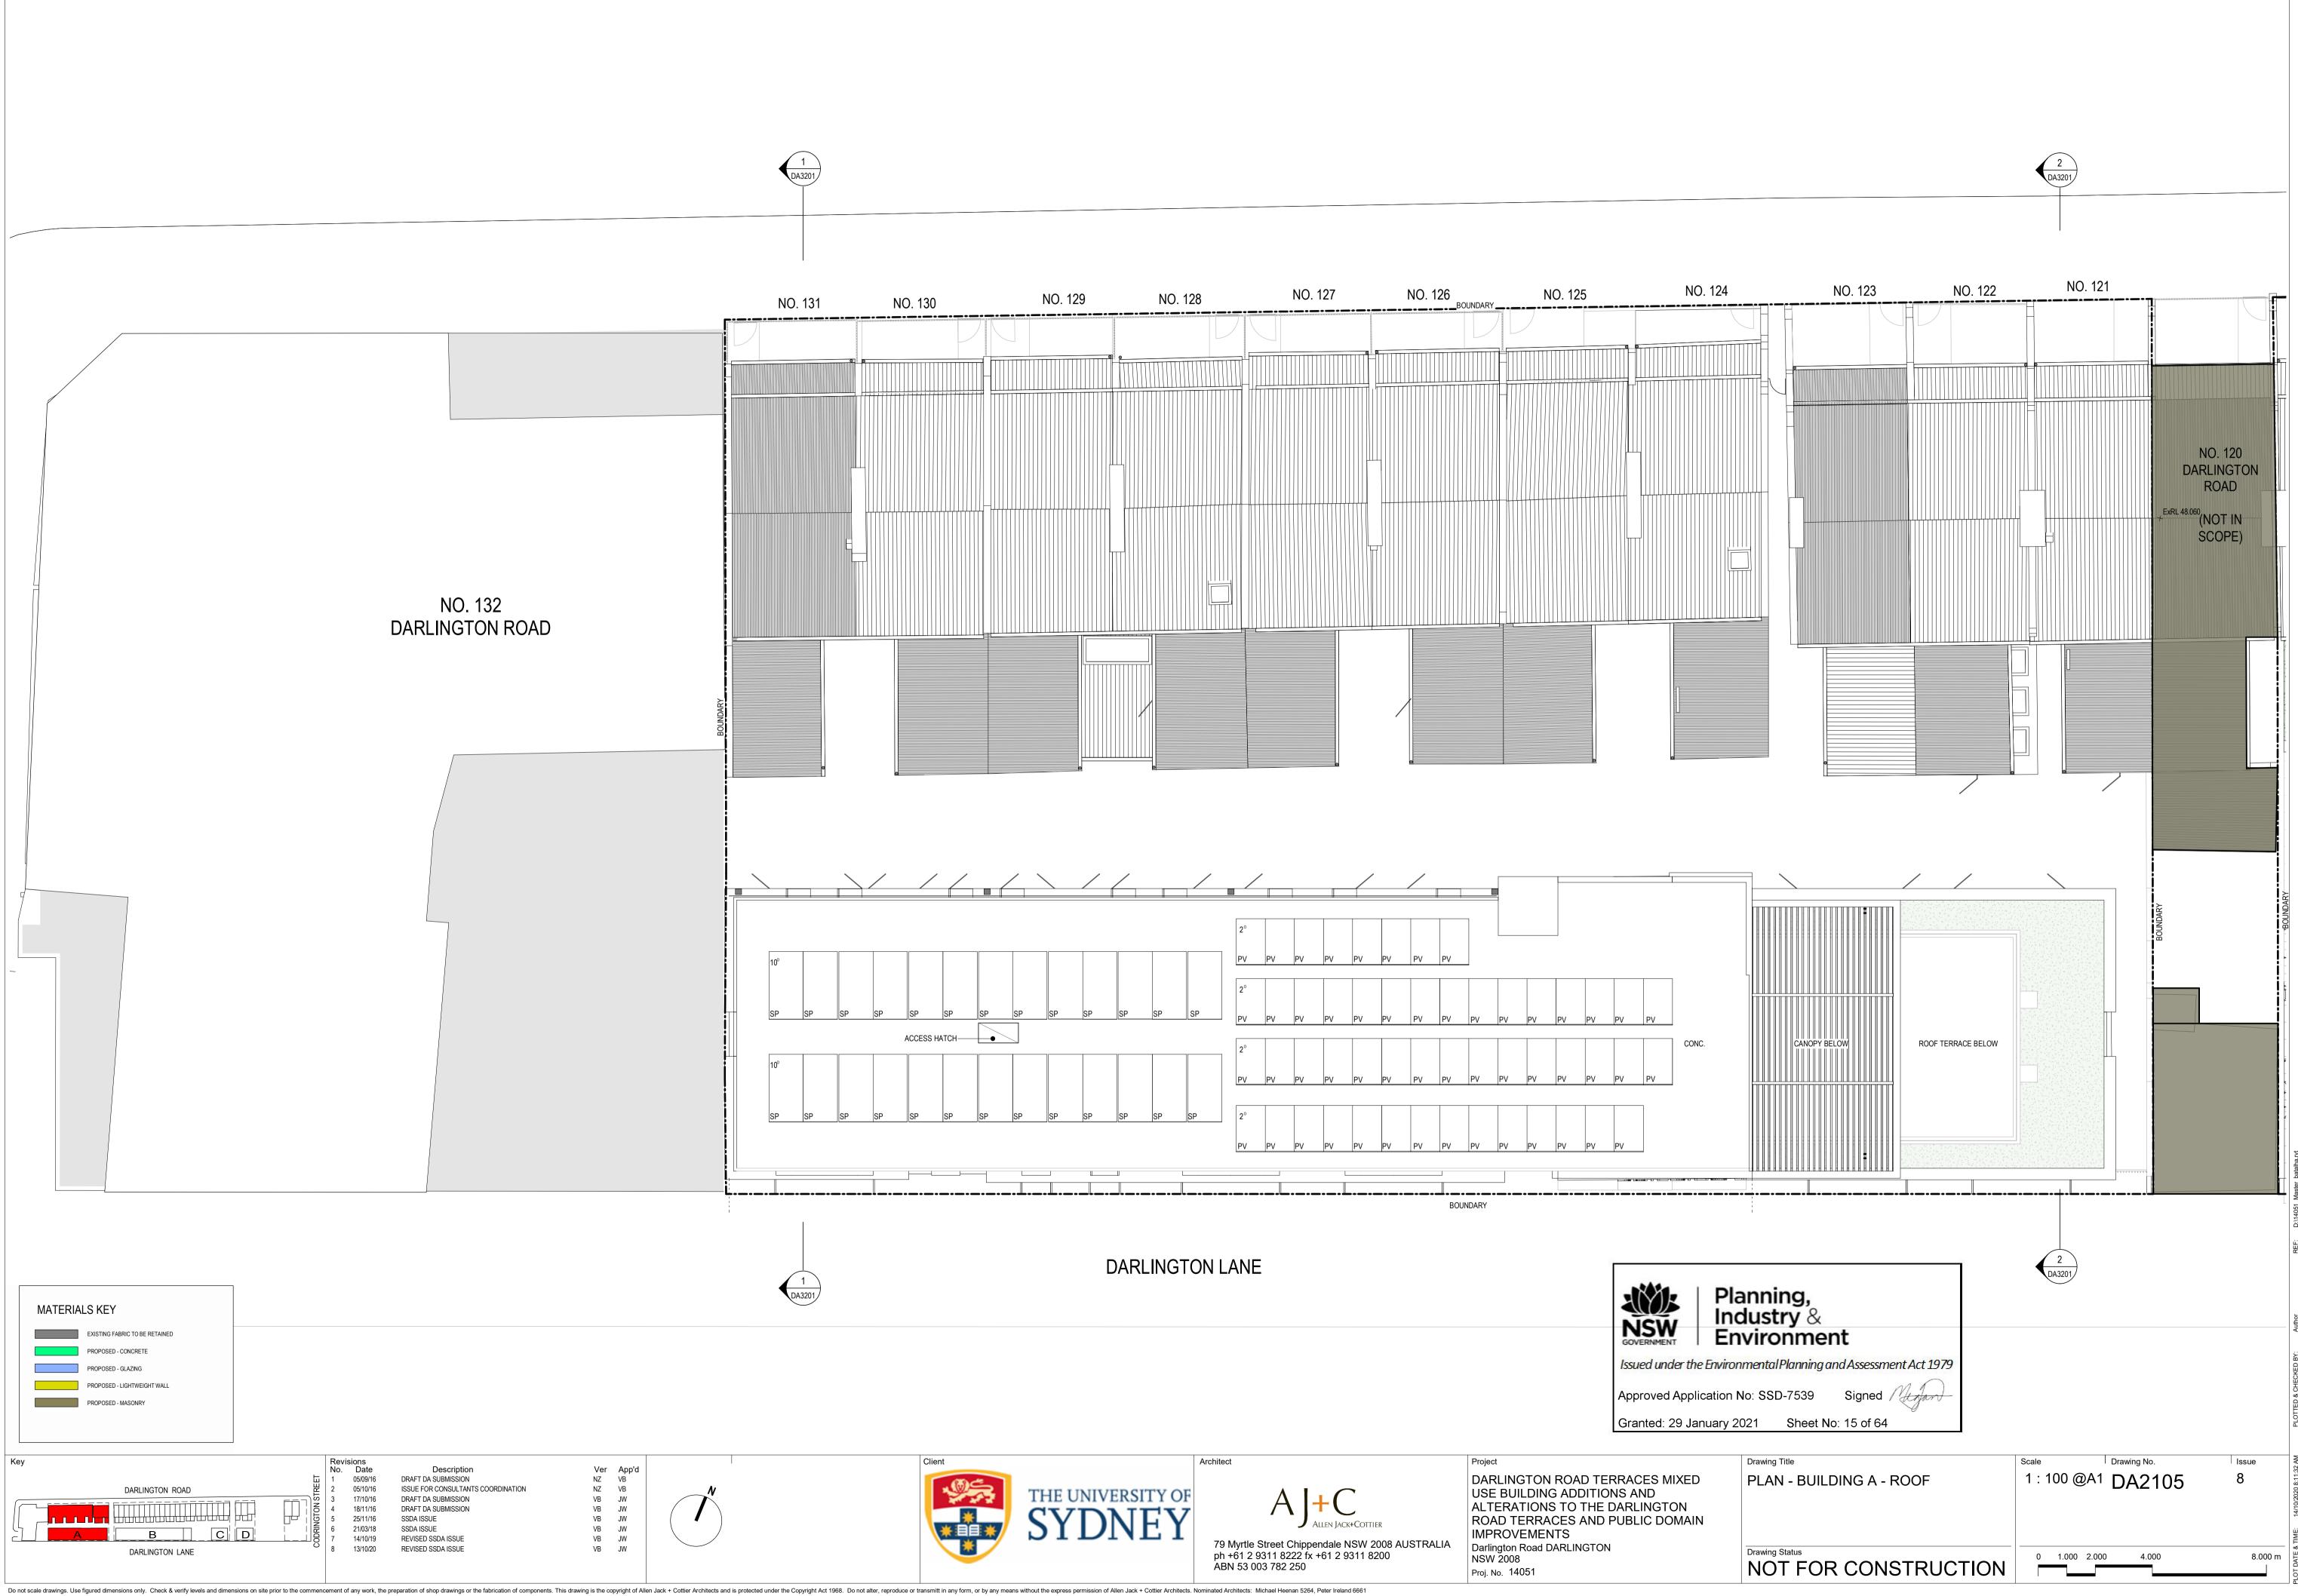
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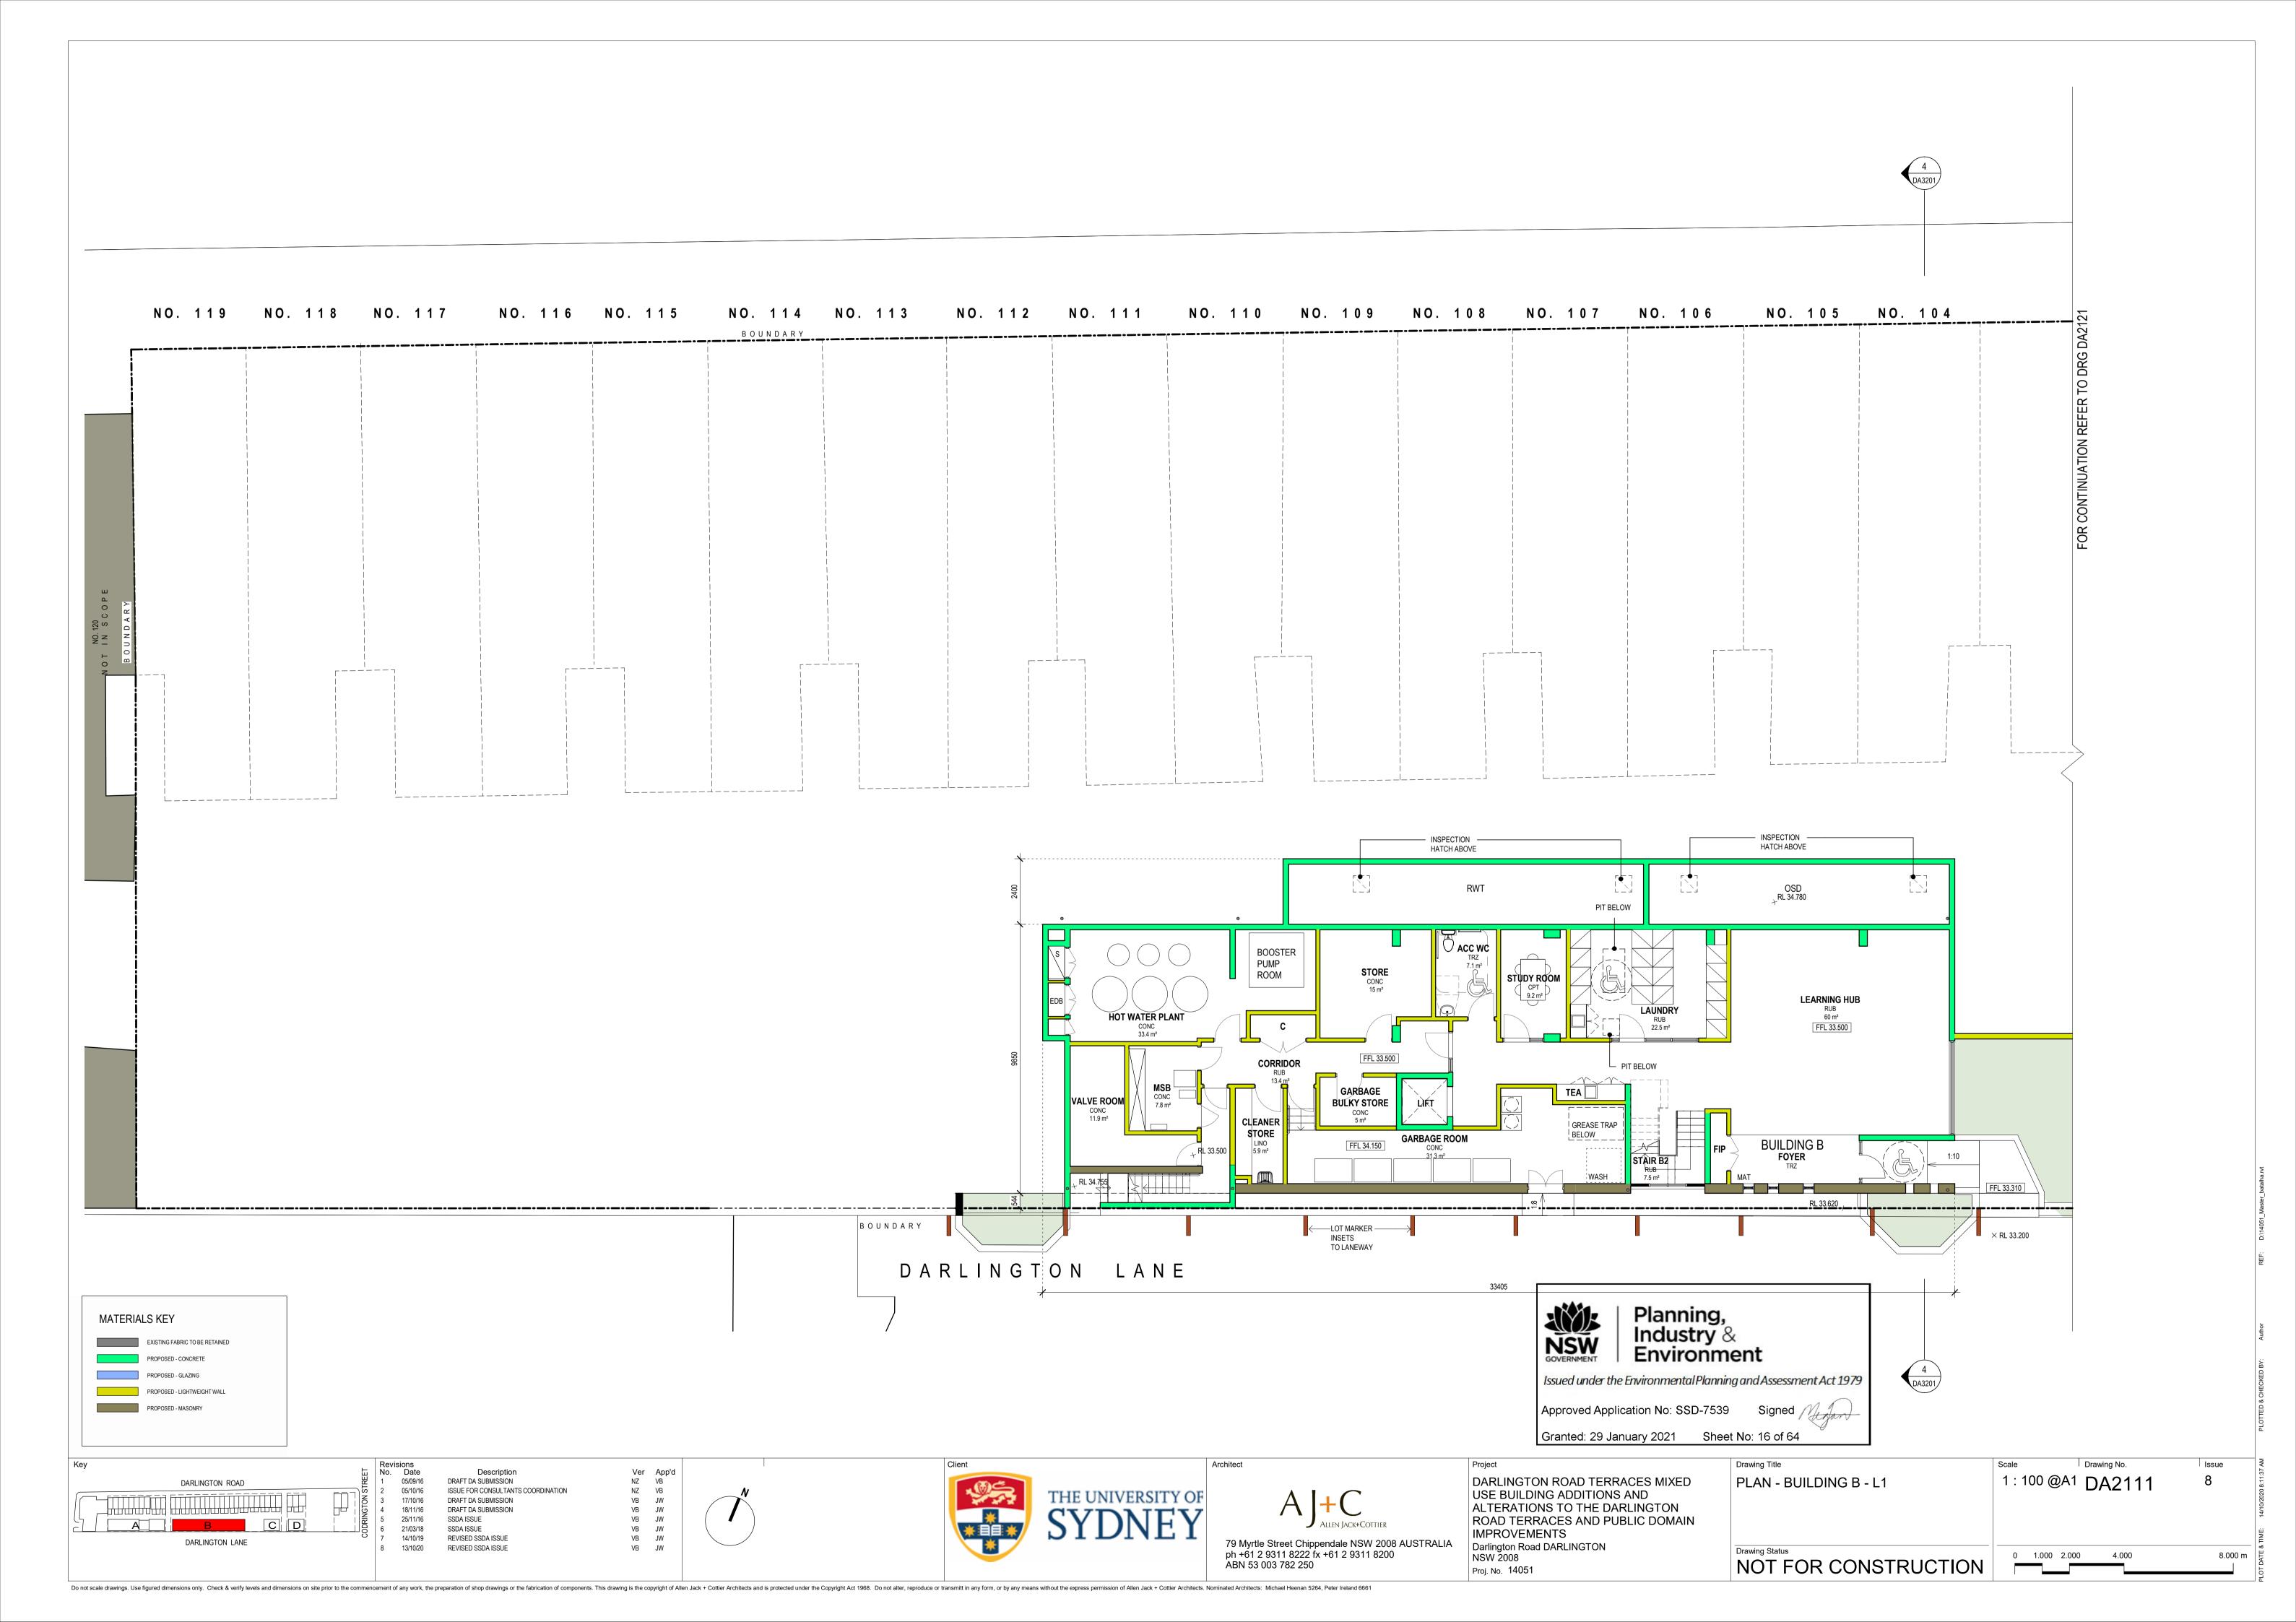

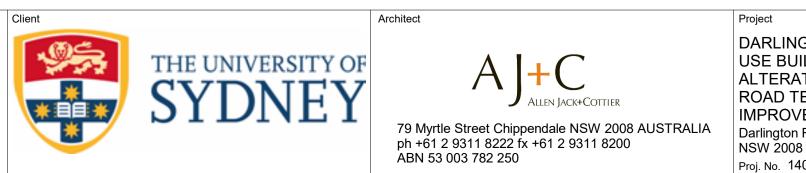
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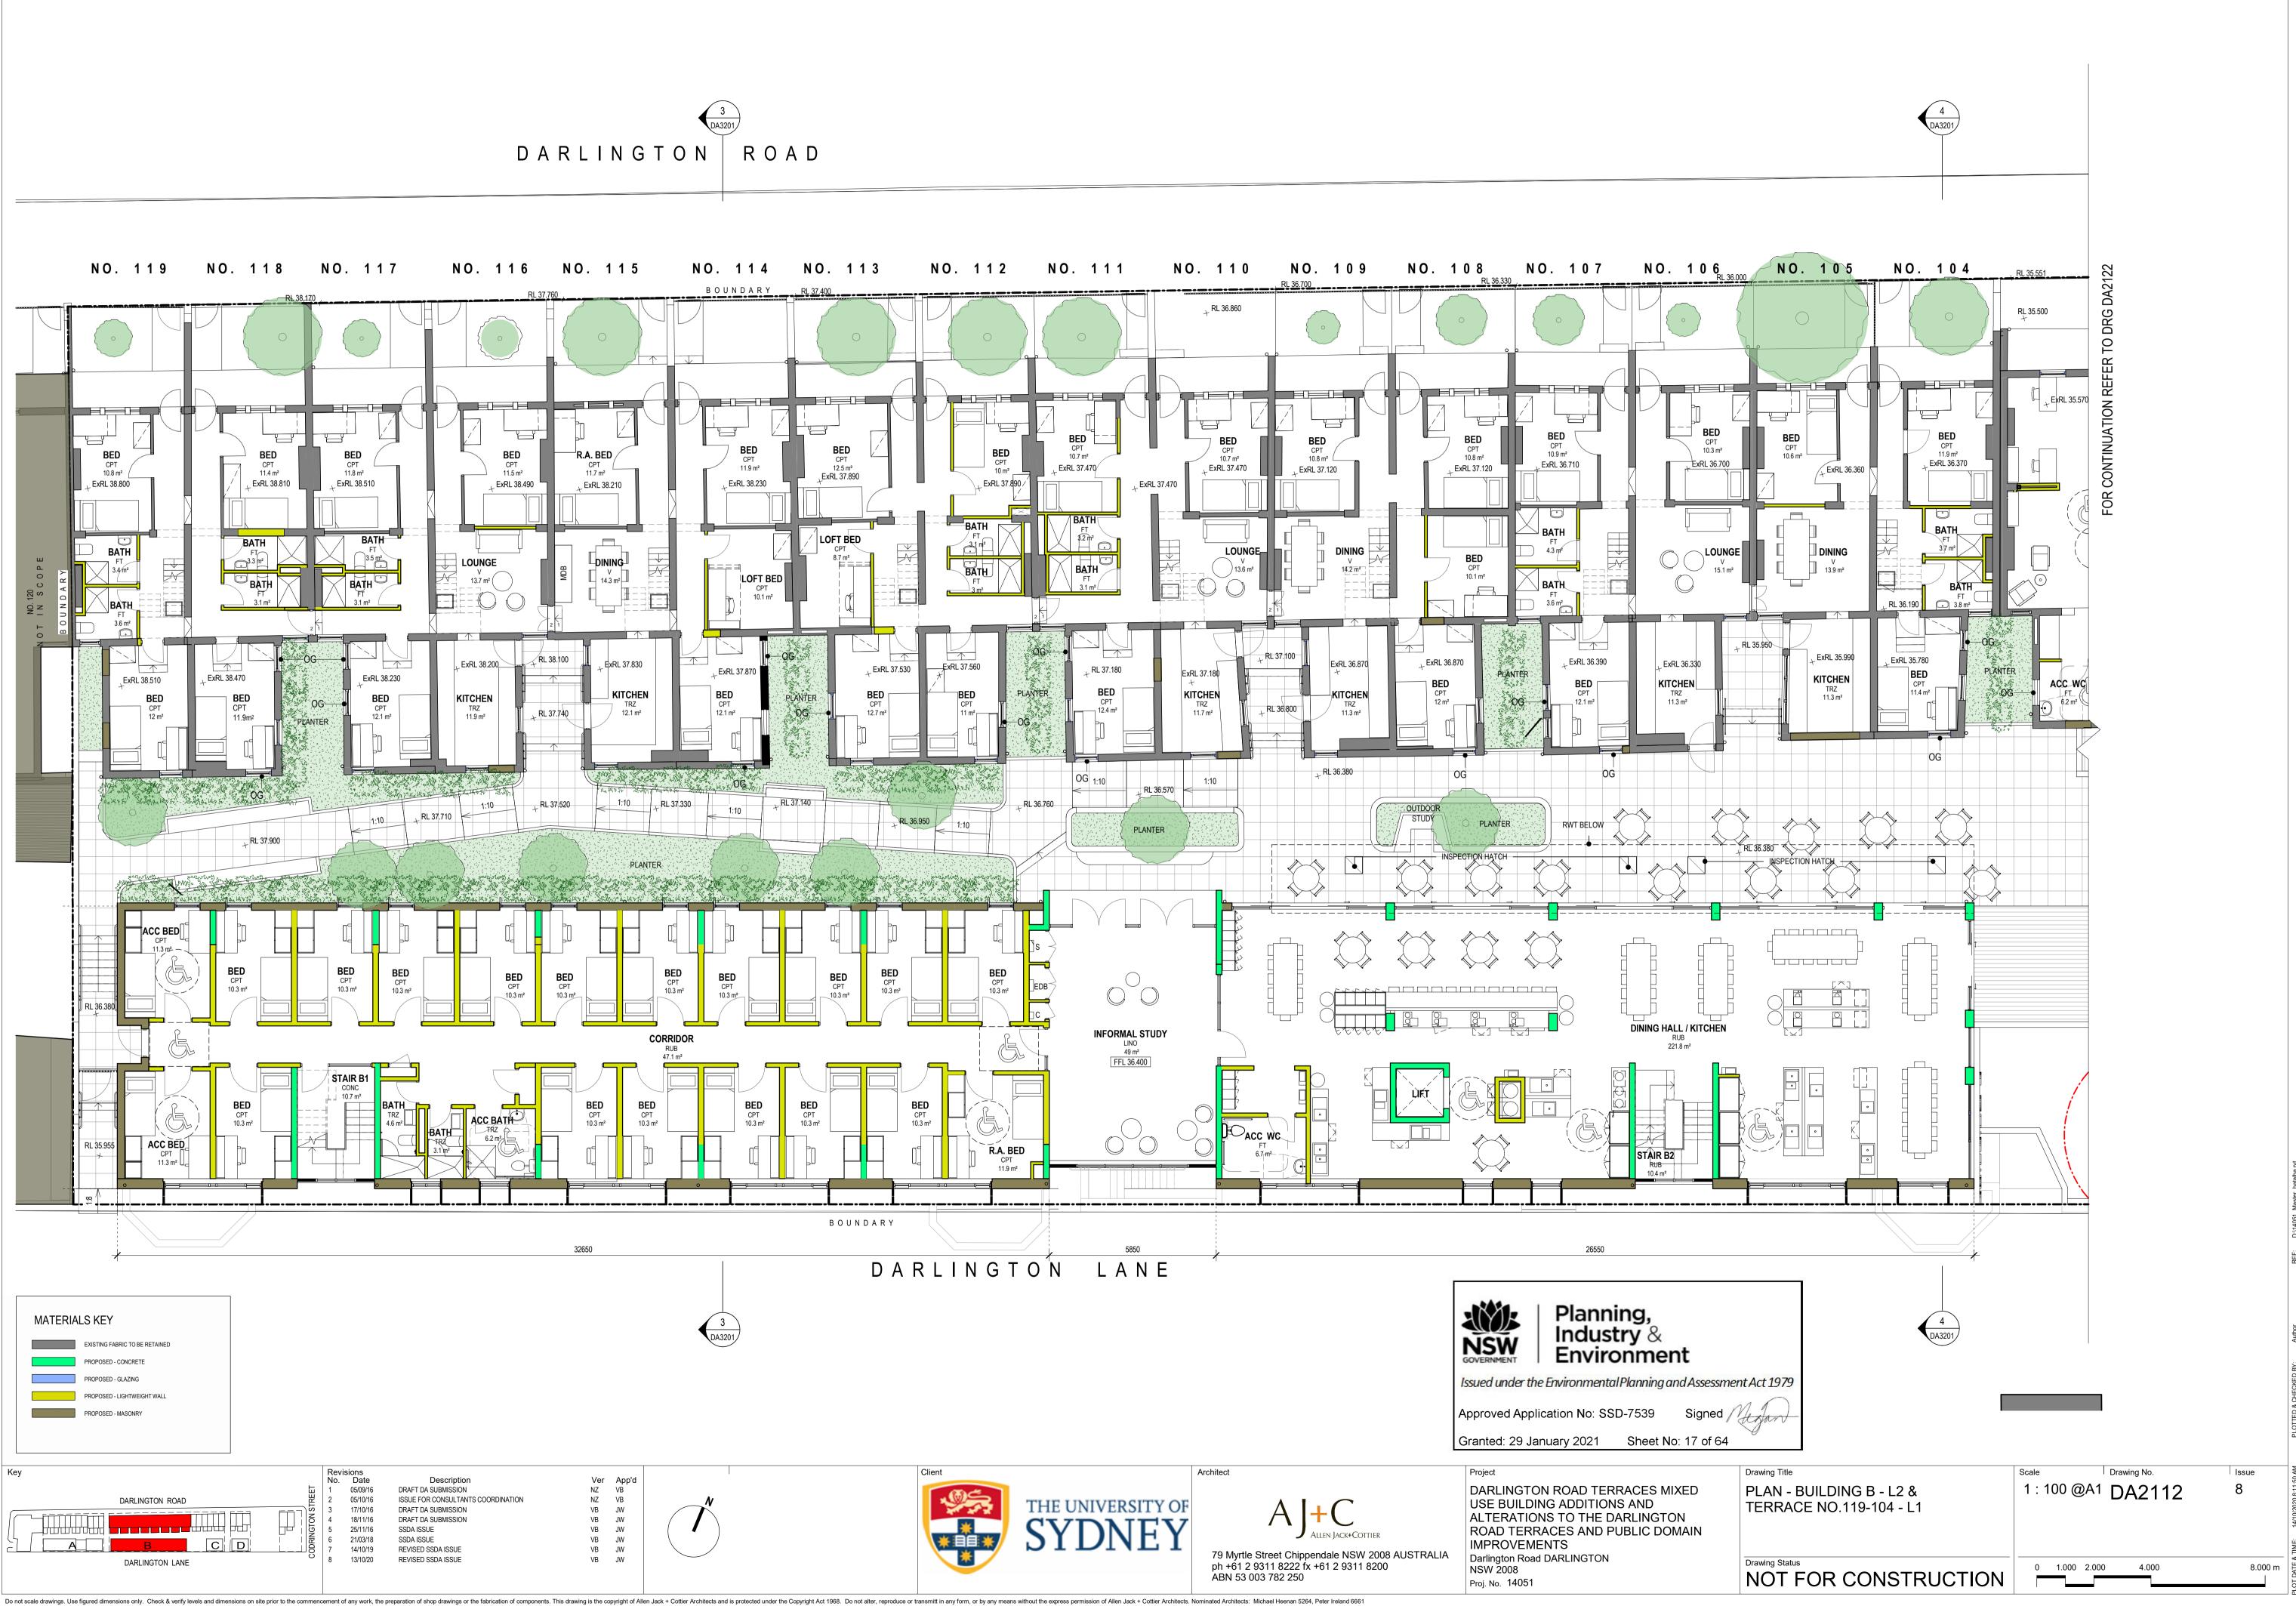


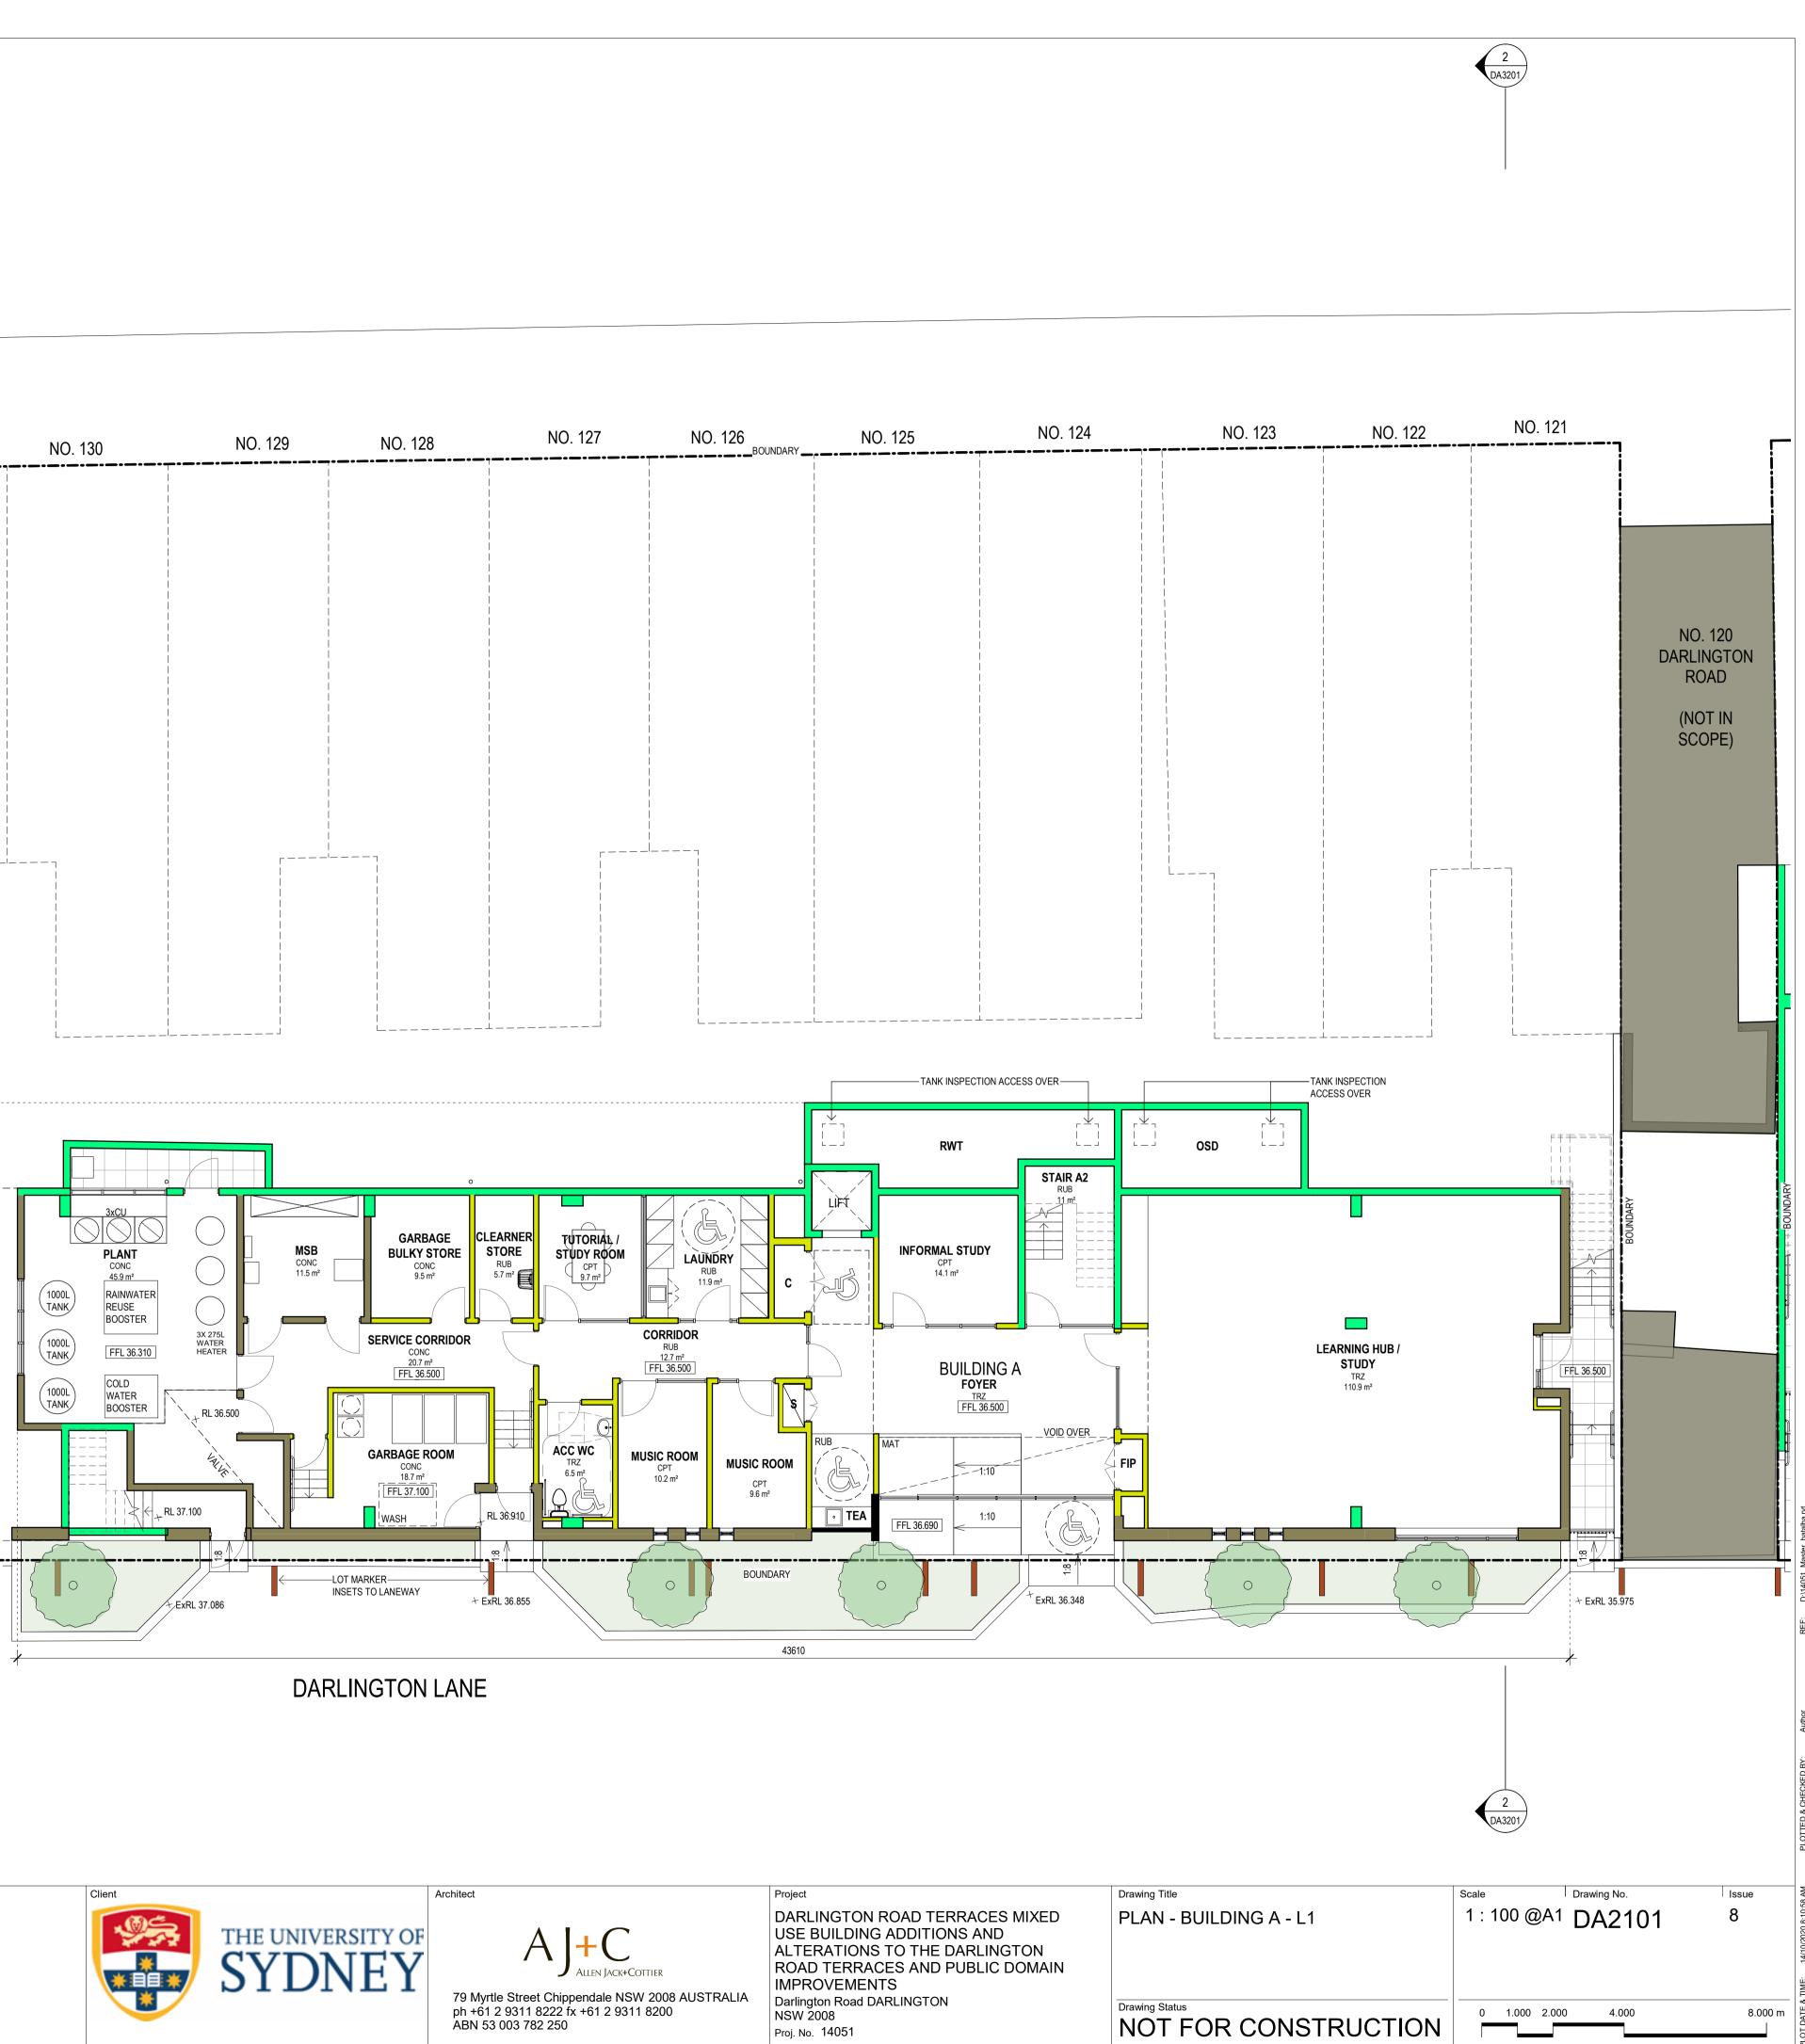







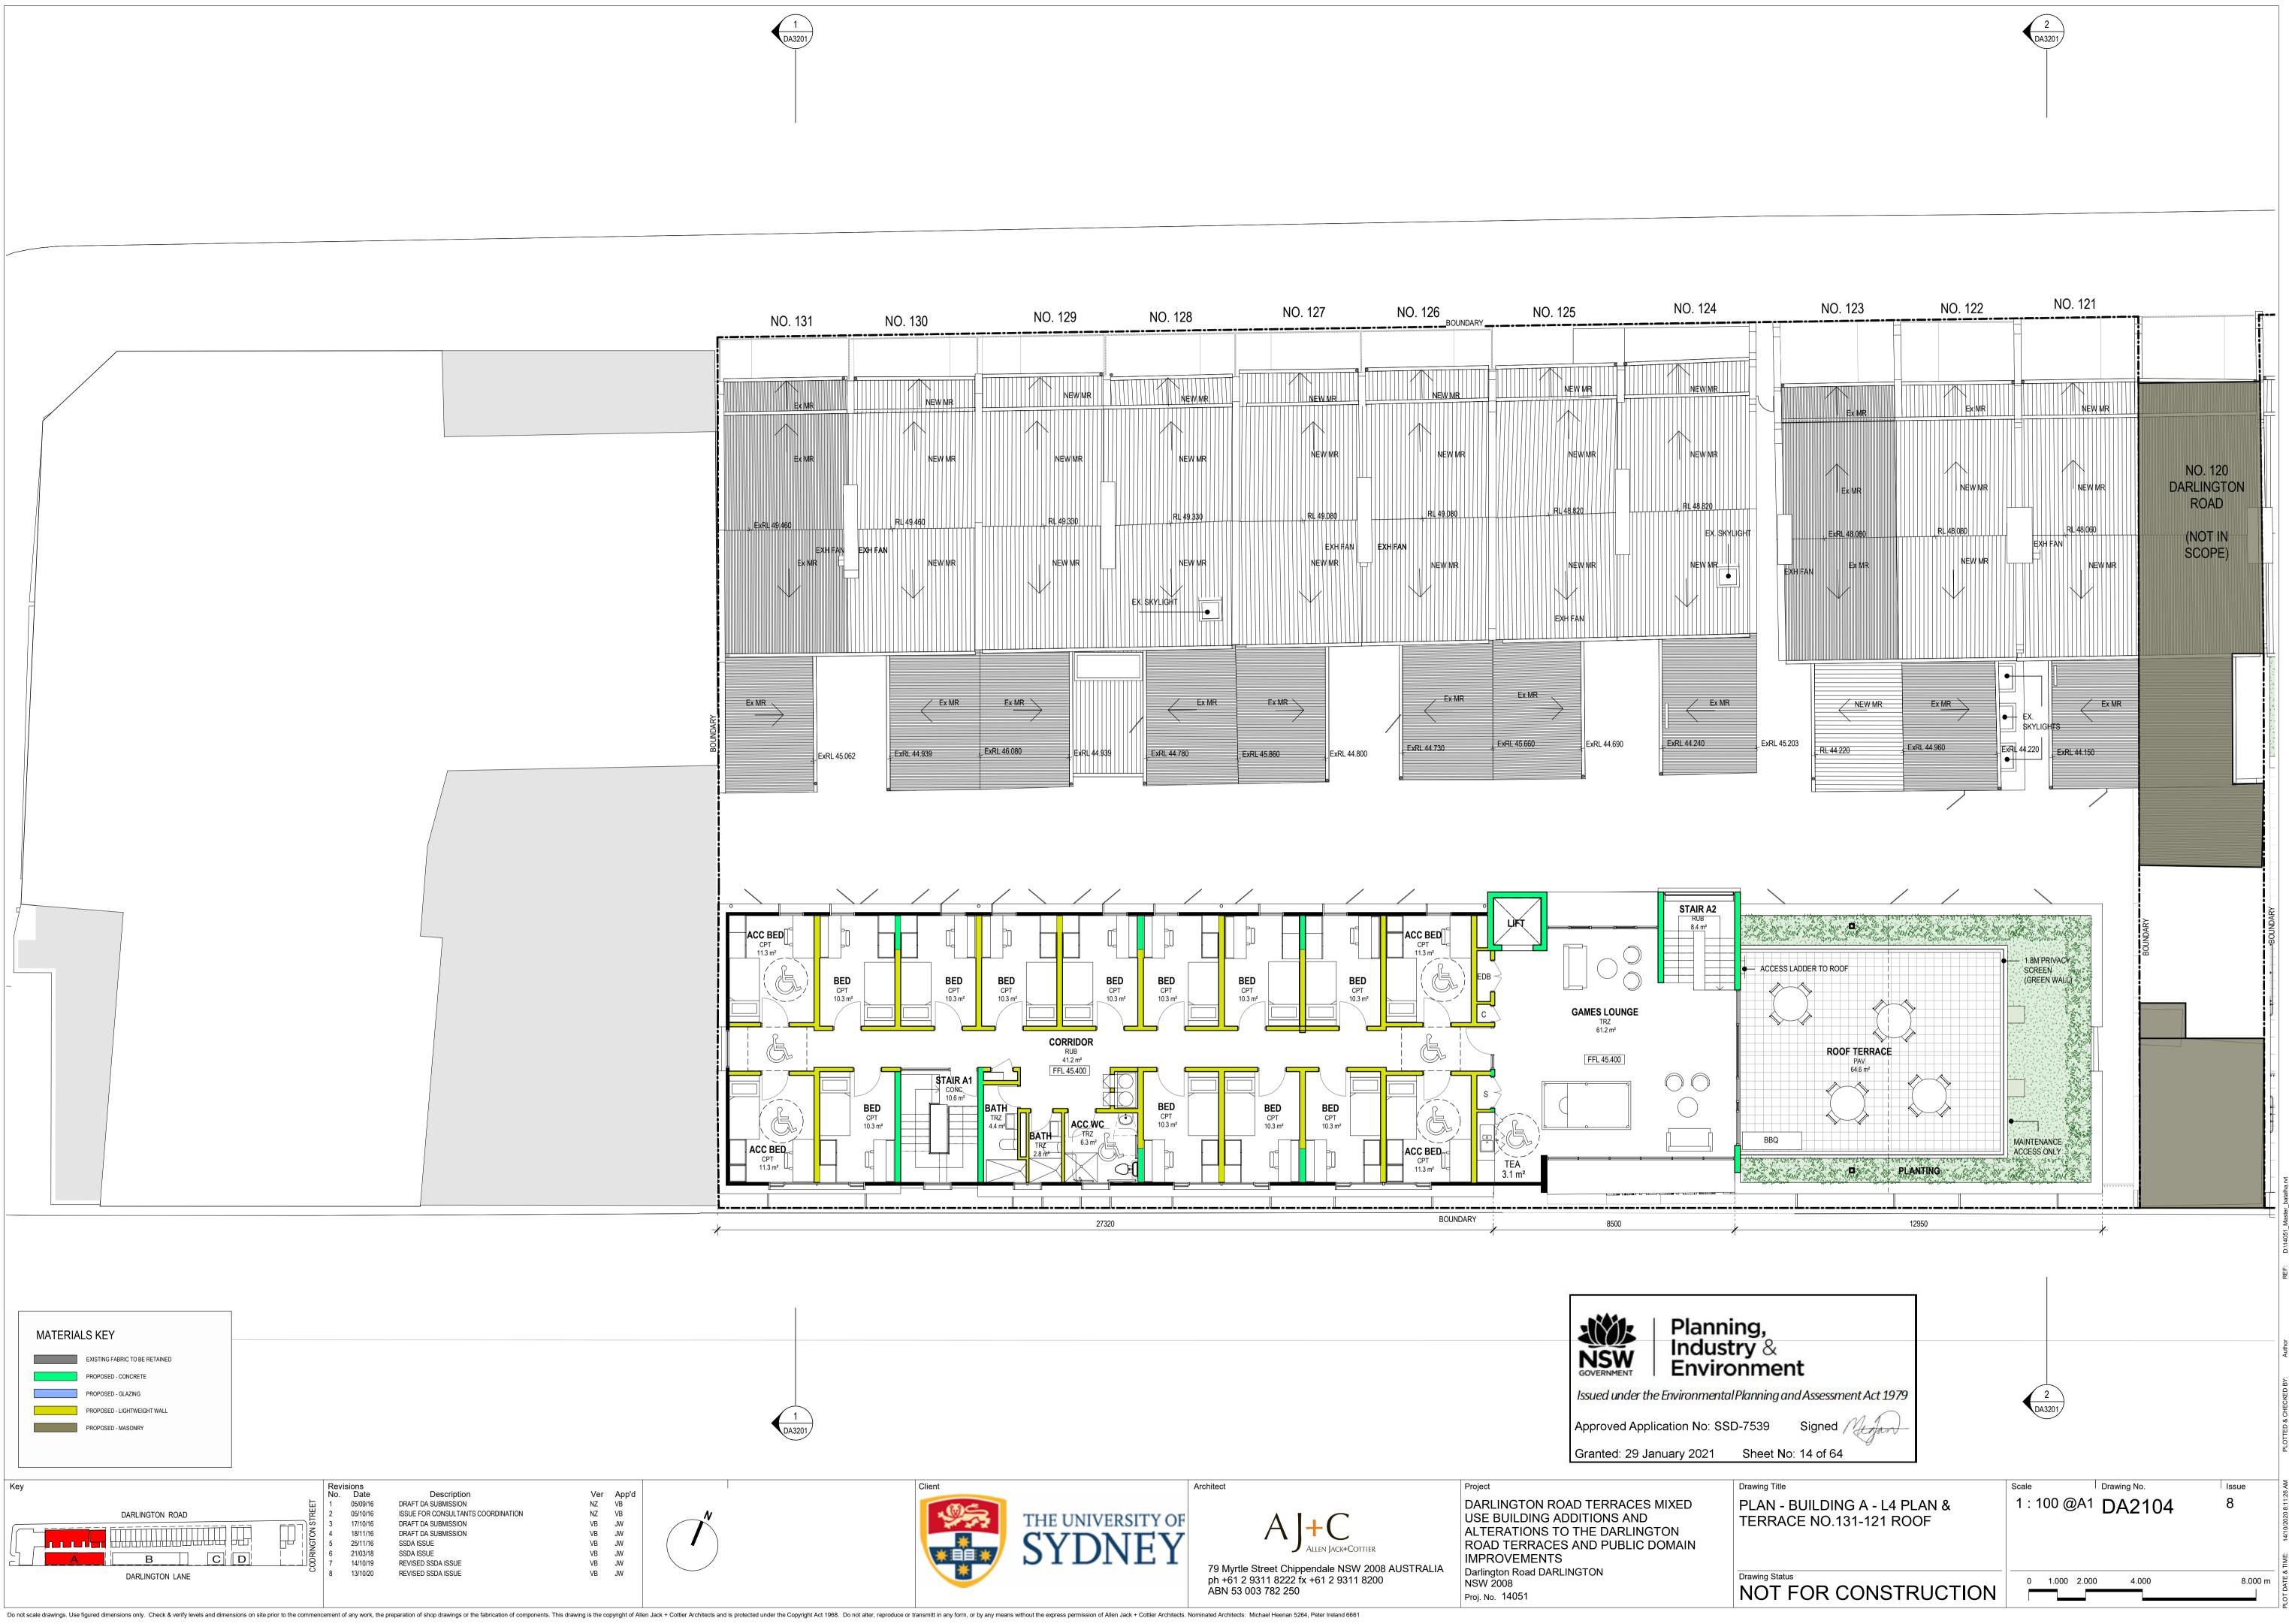






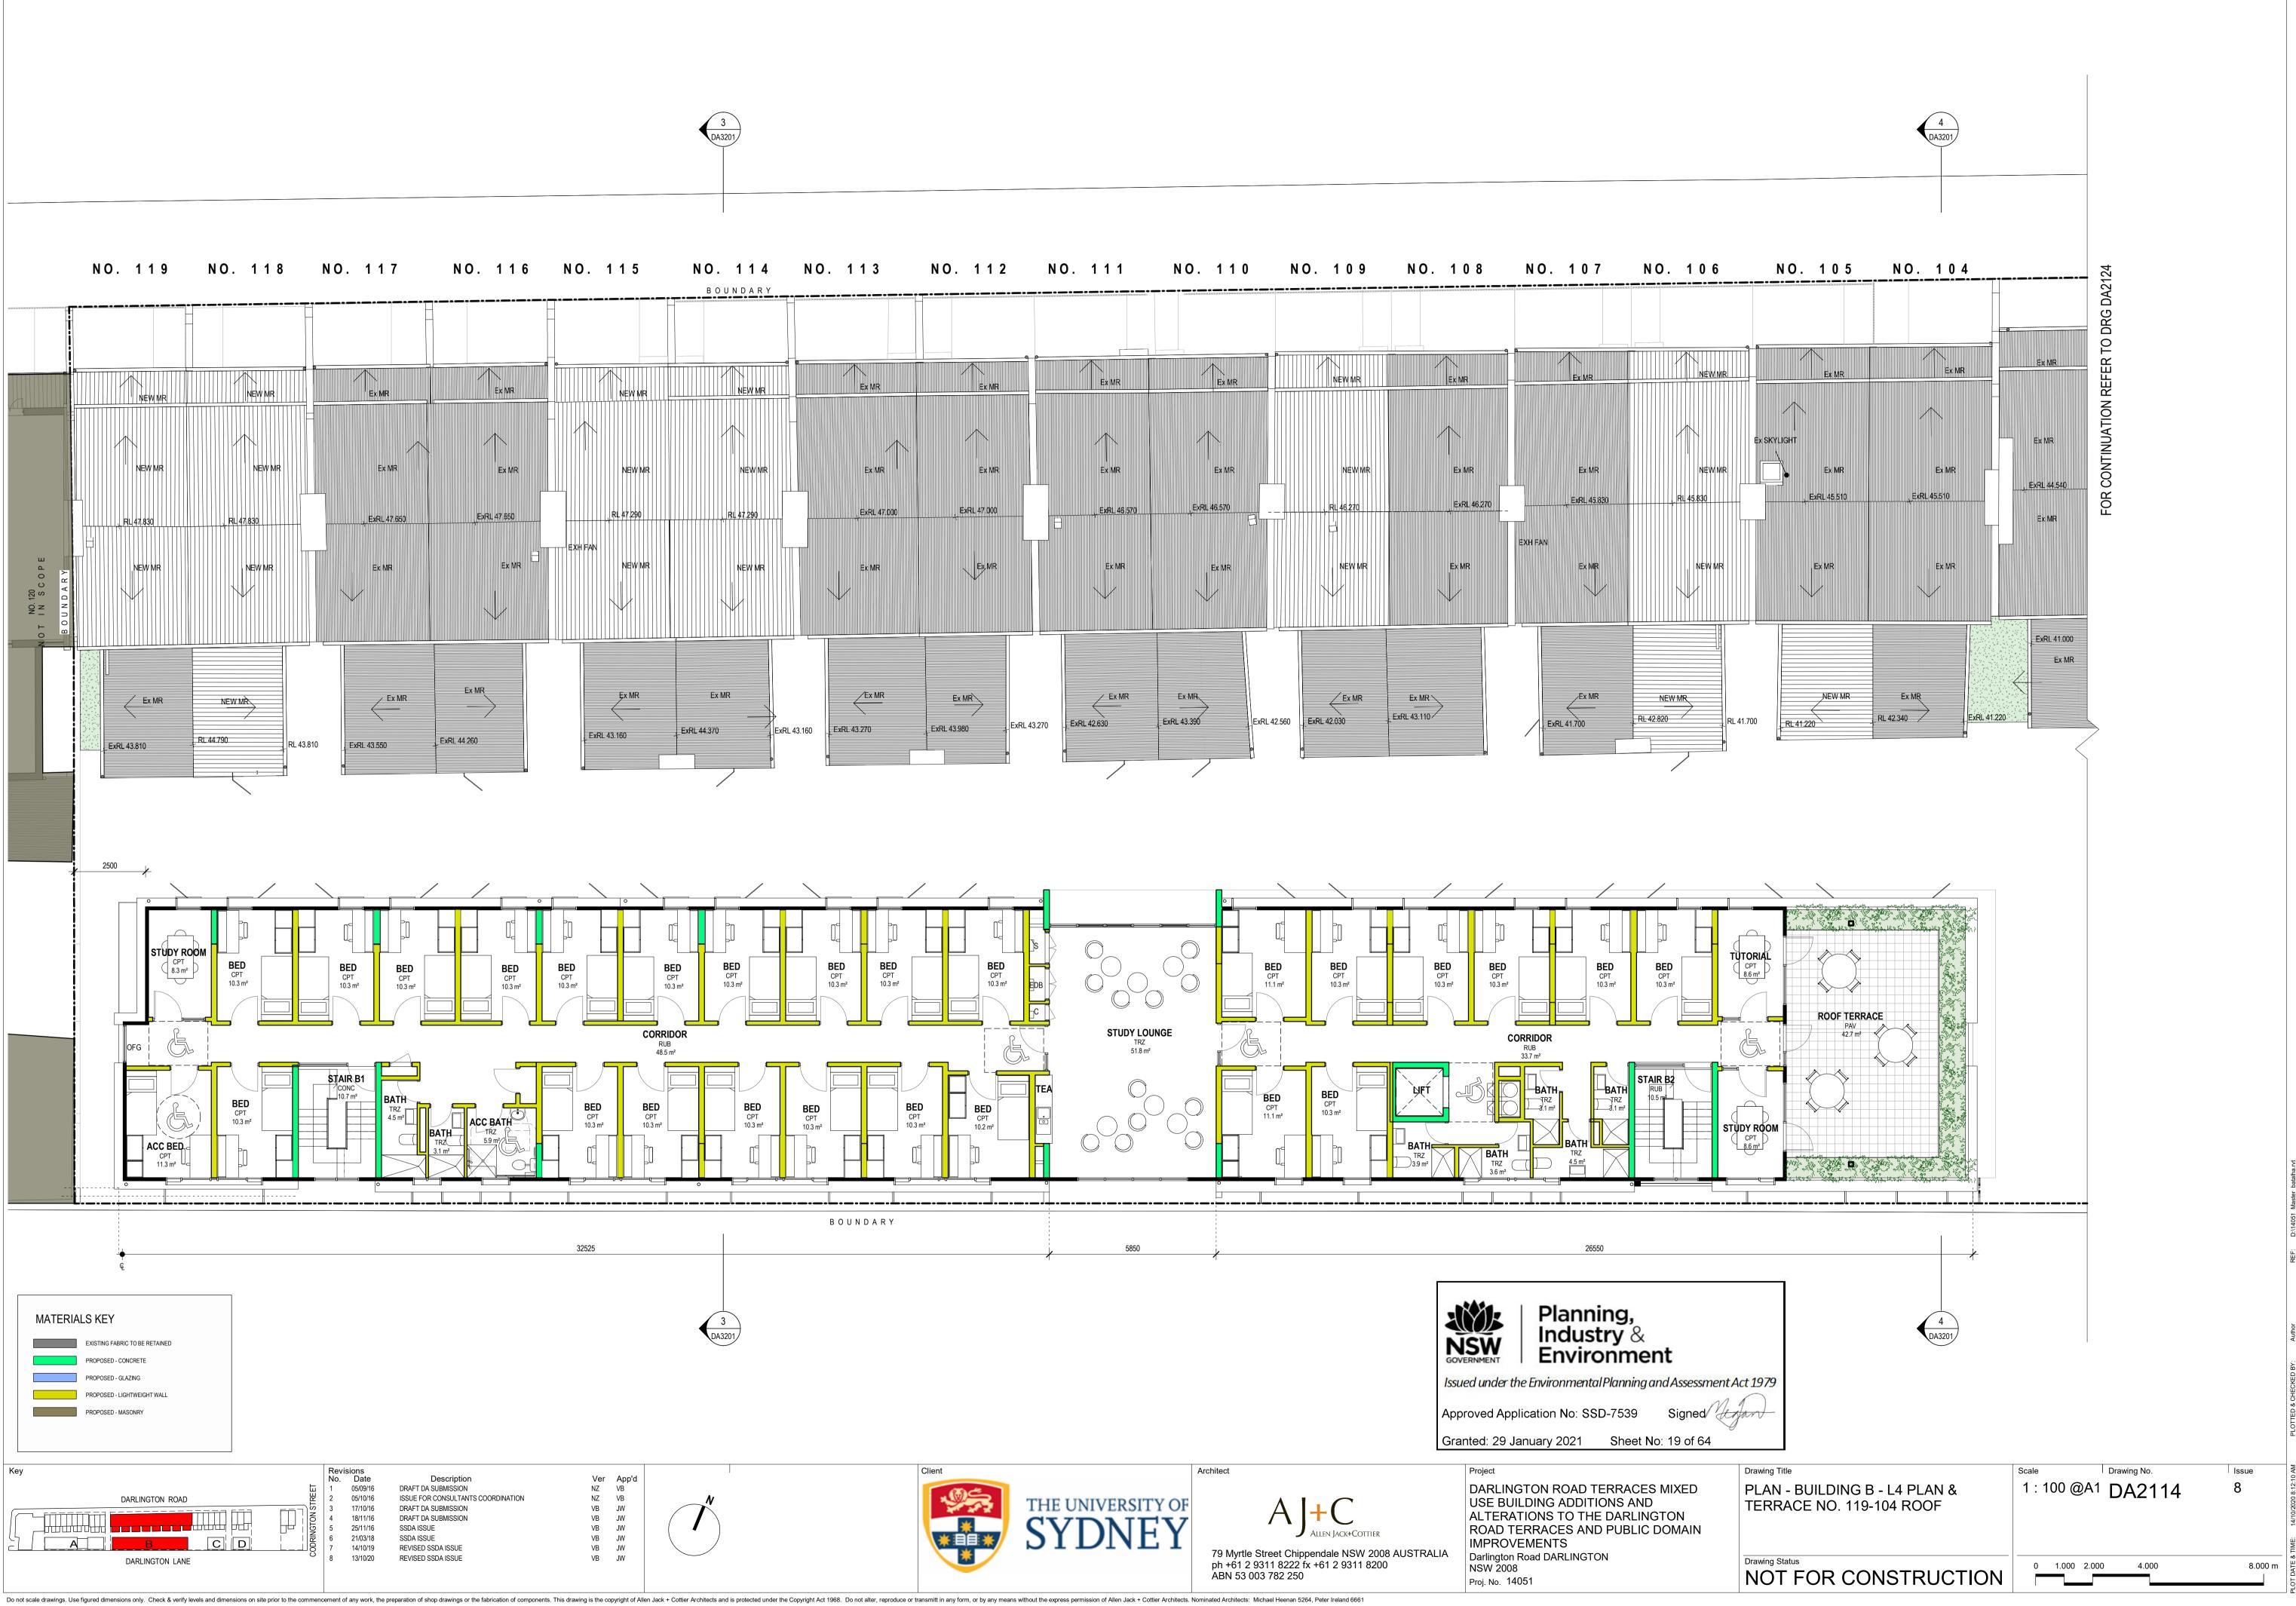


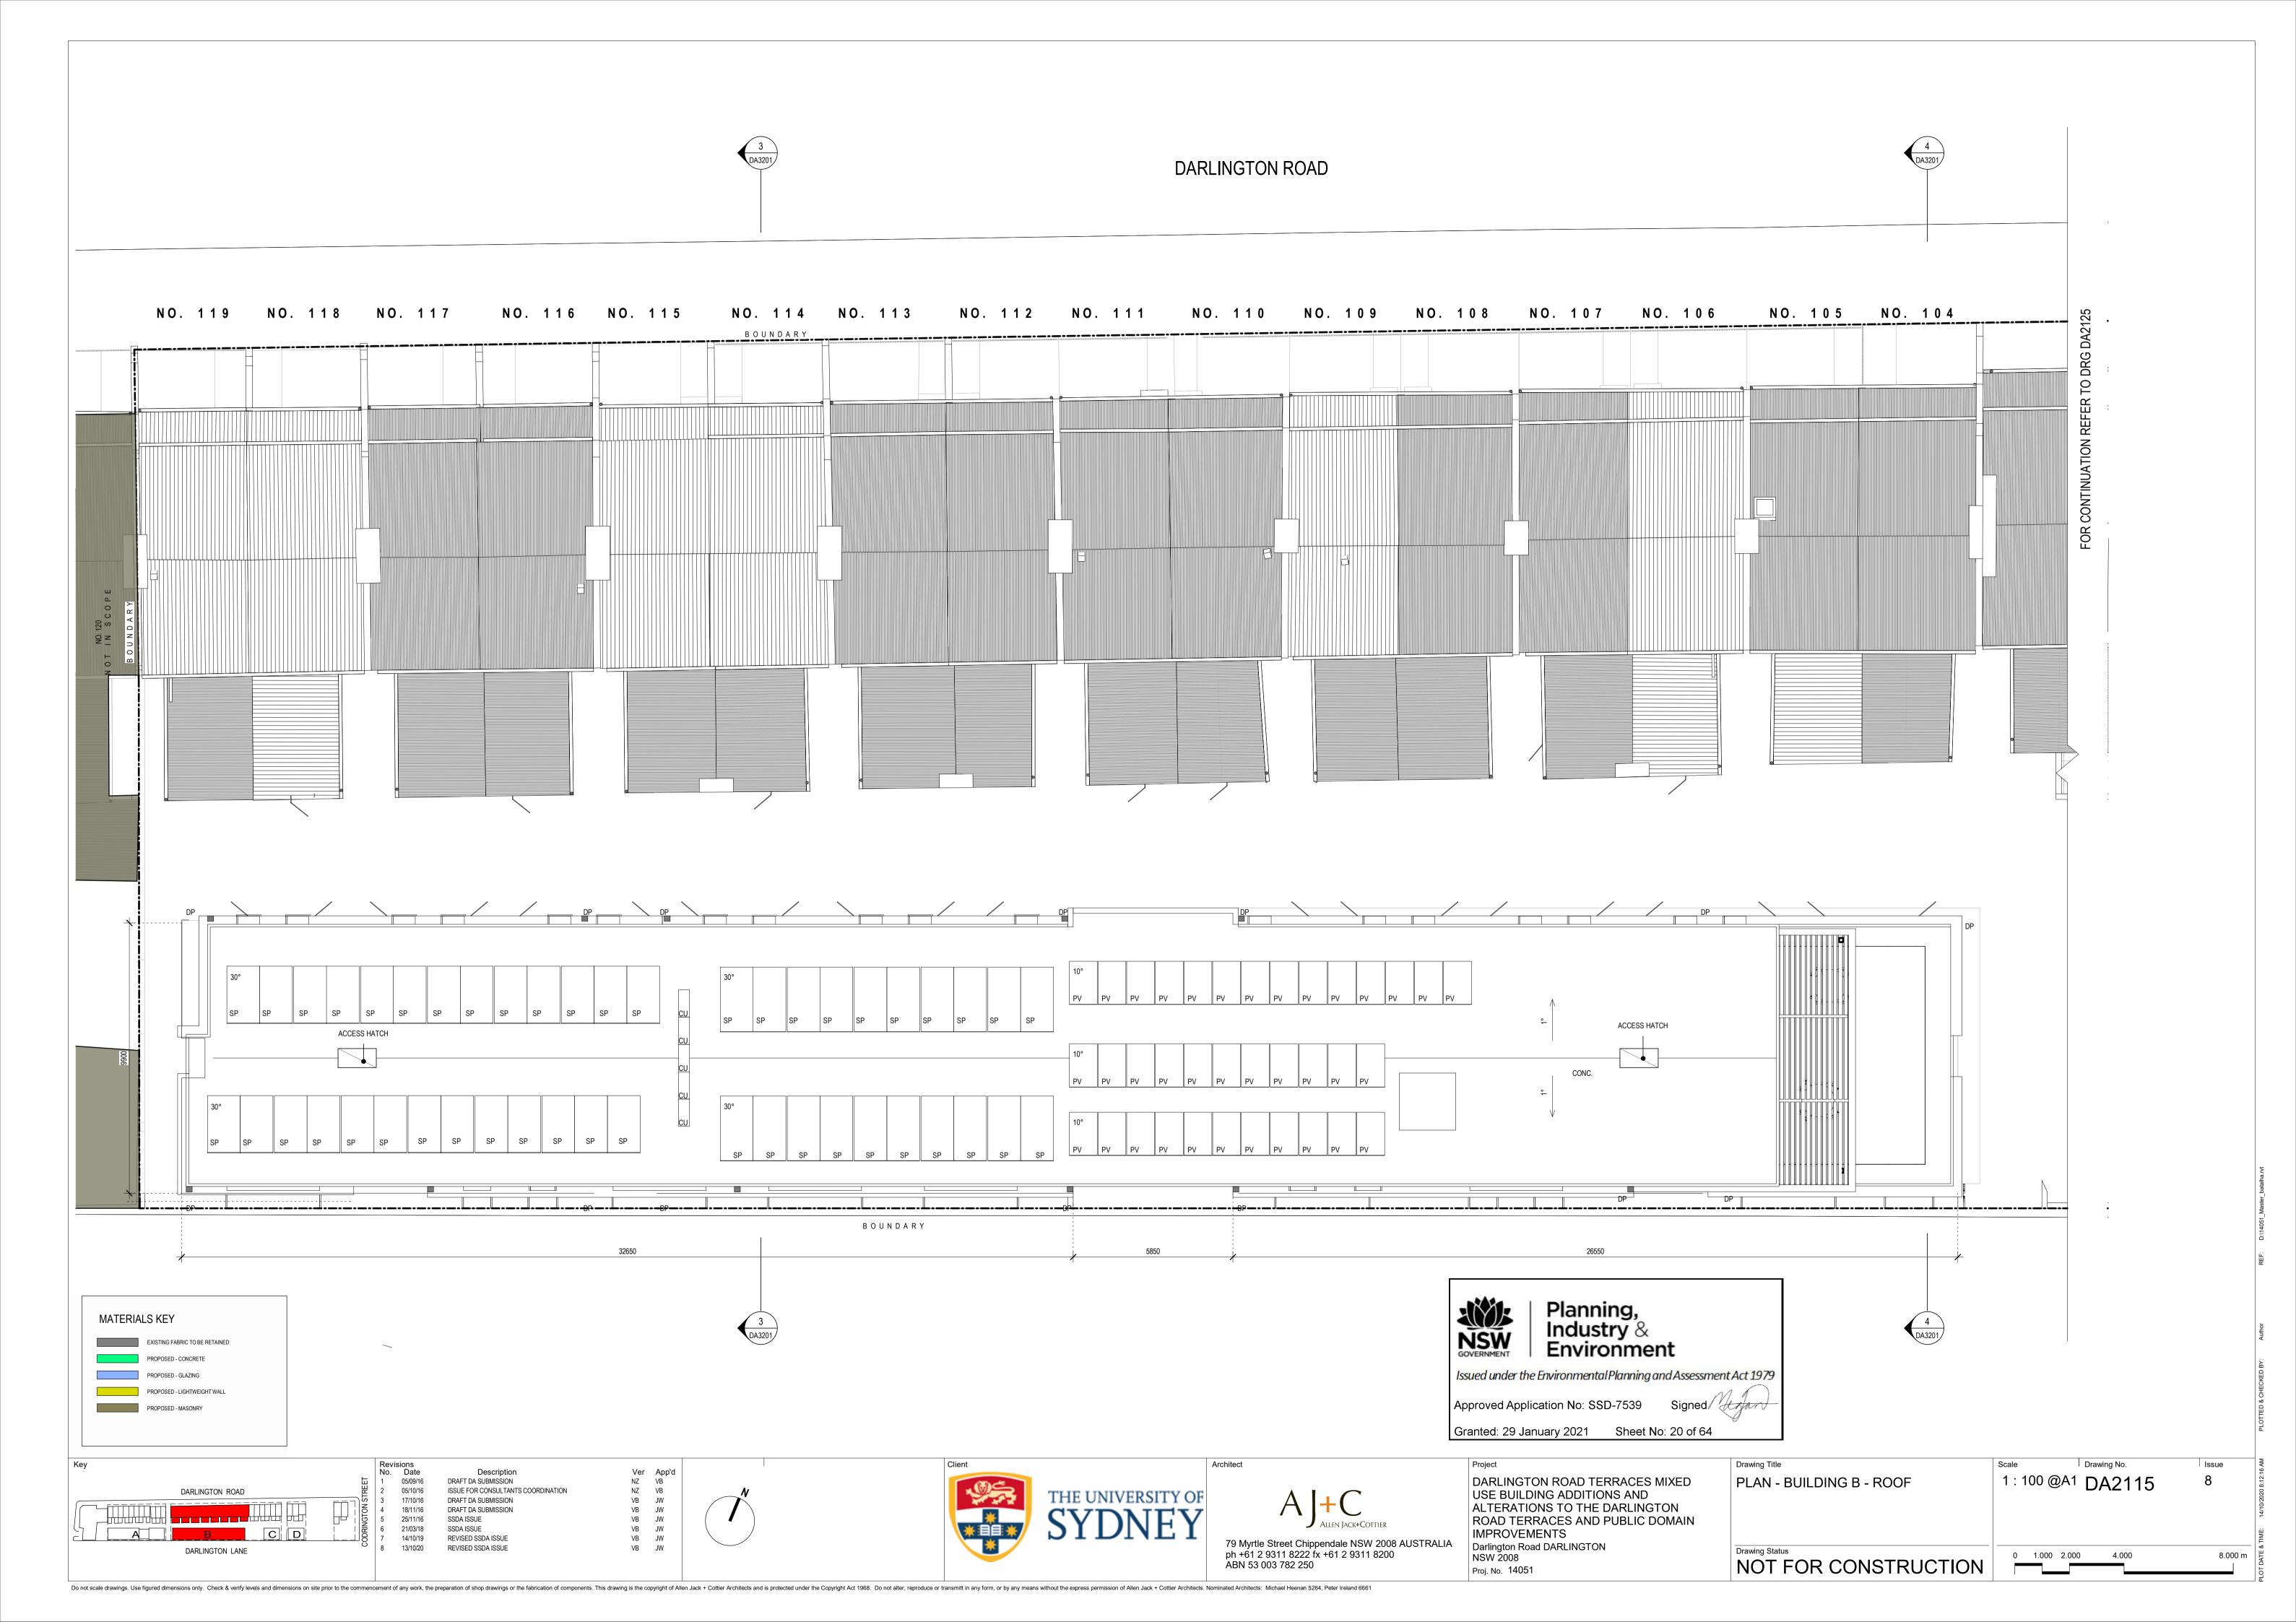

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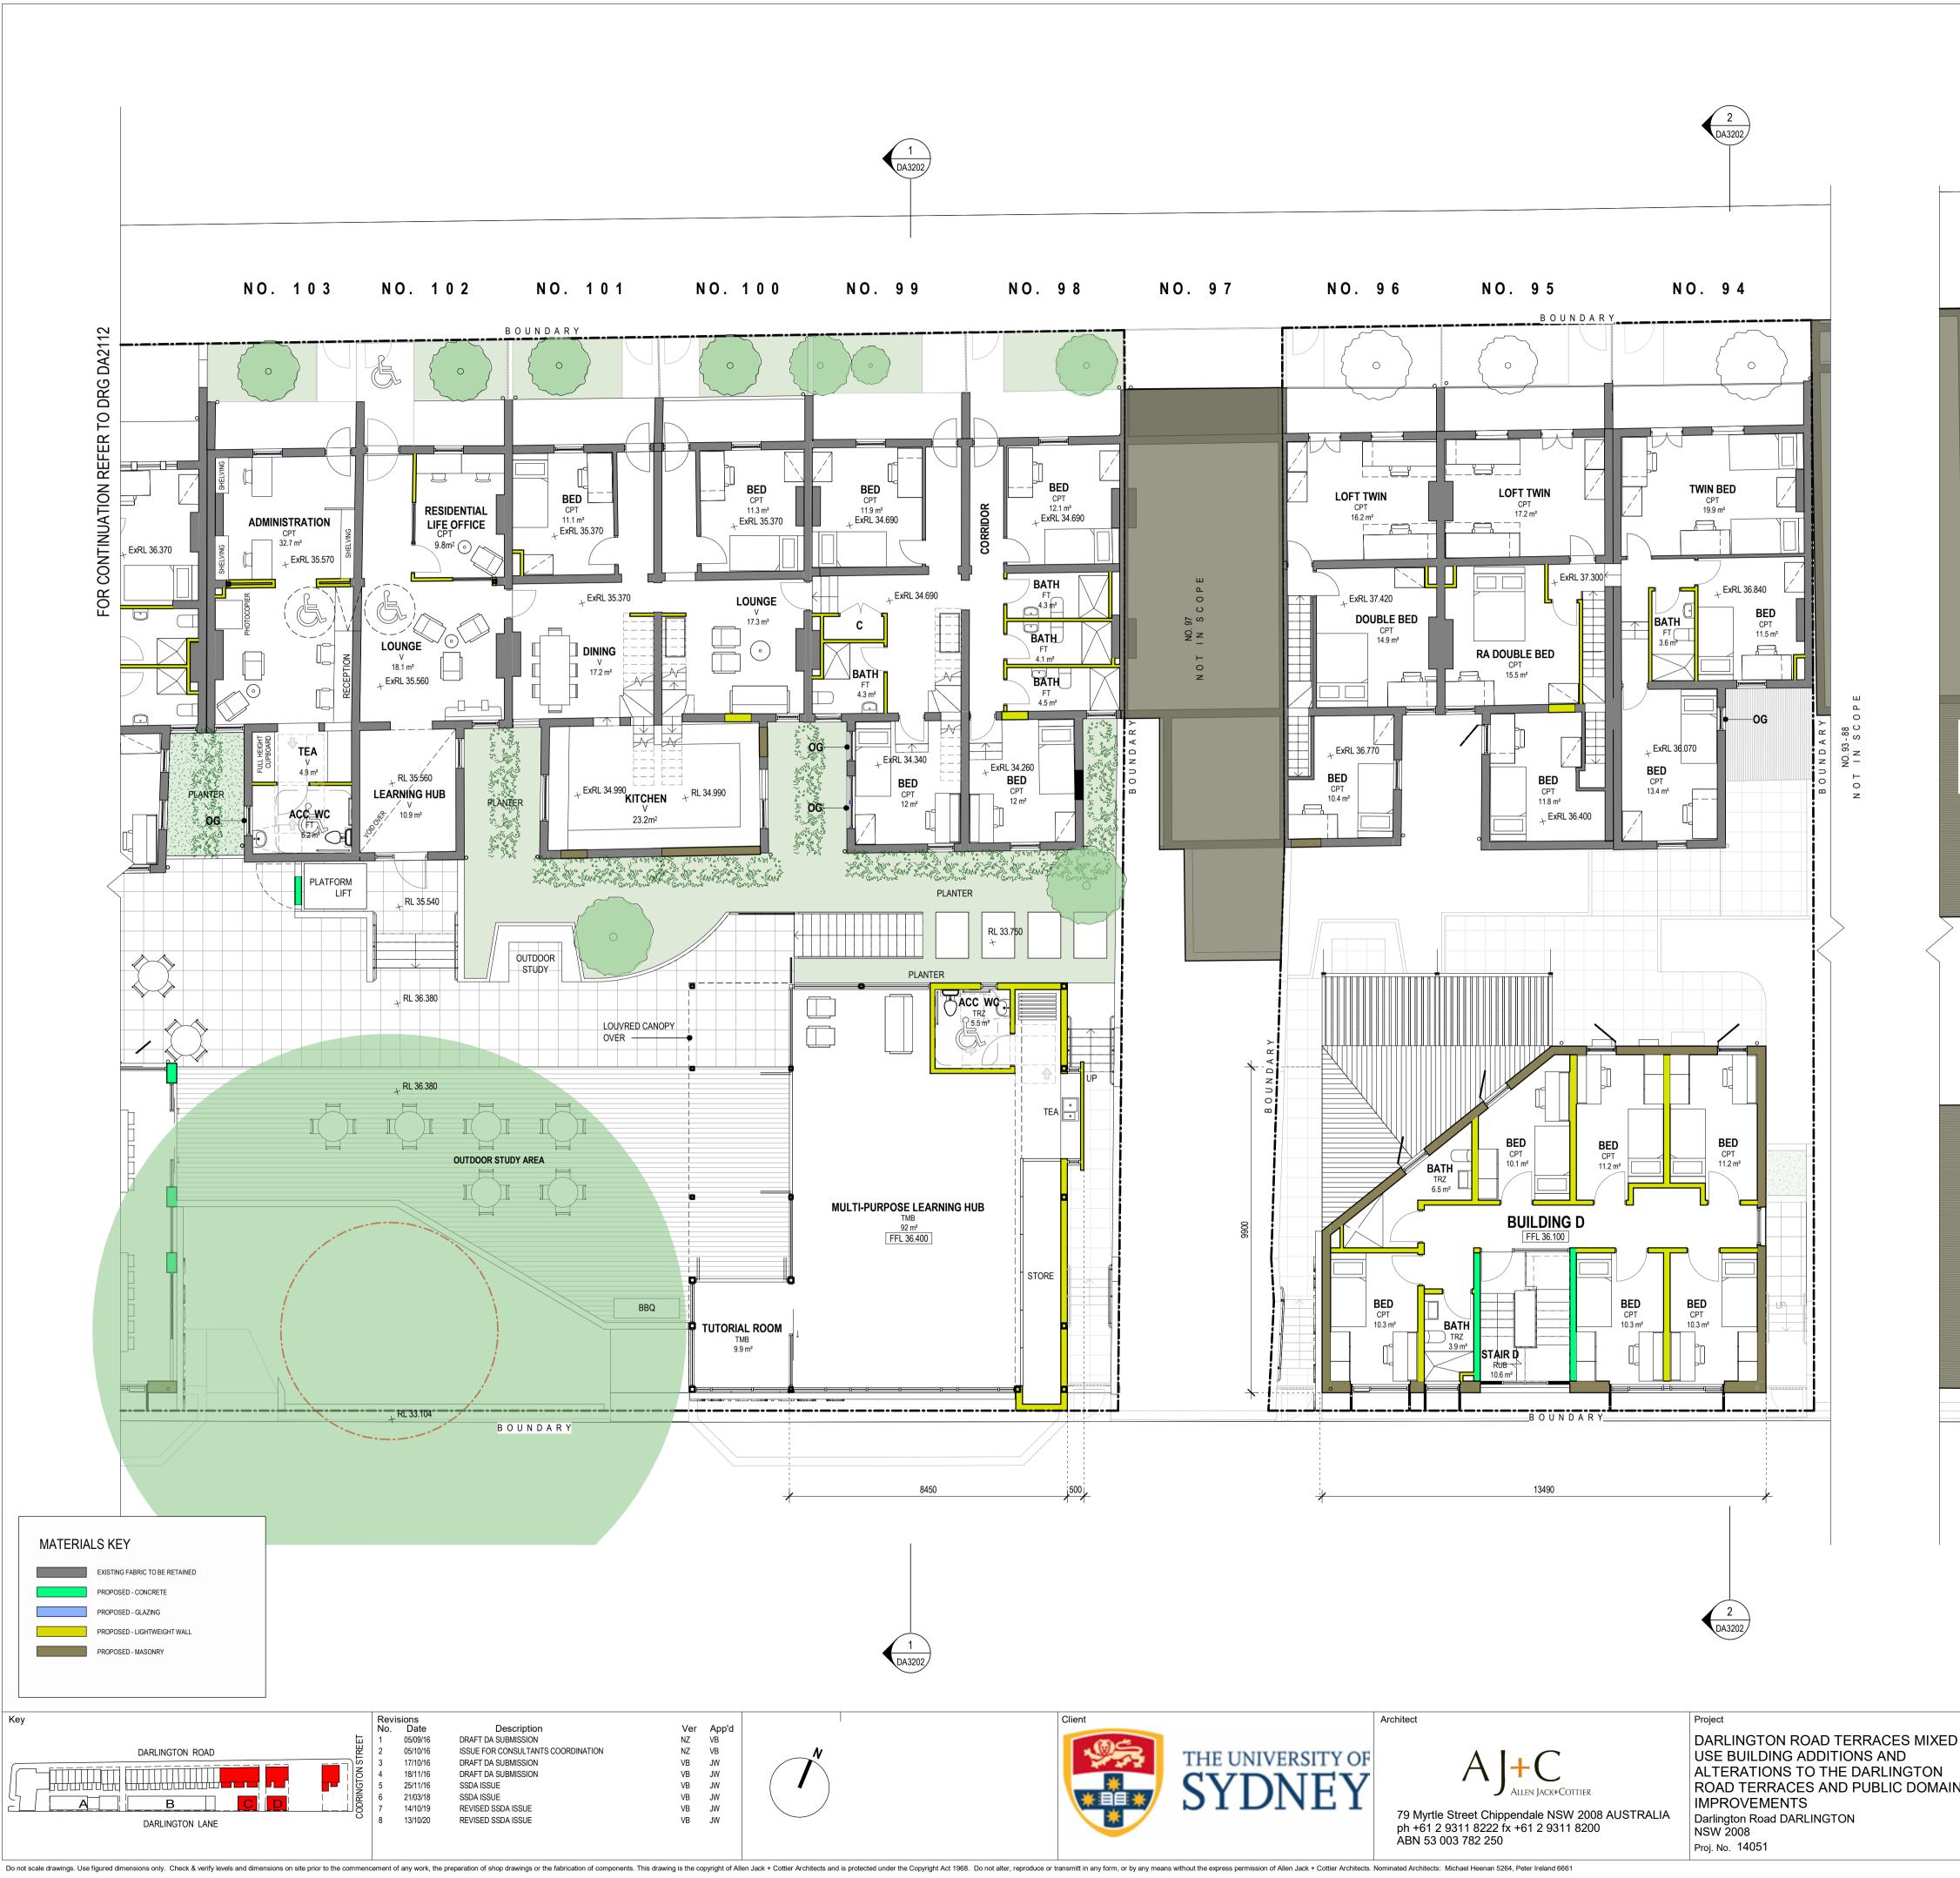
Client THE UNIVERSITY OF SYDNEY

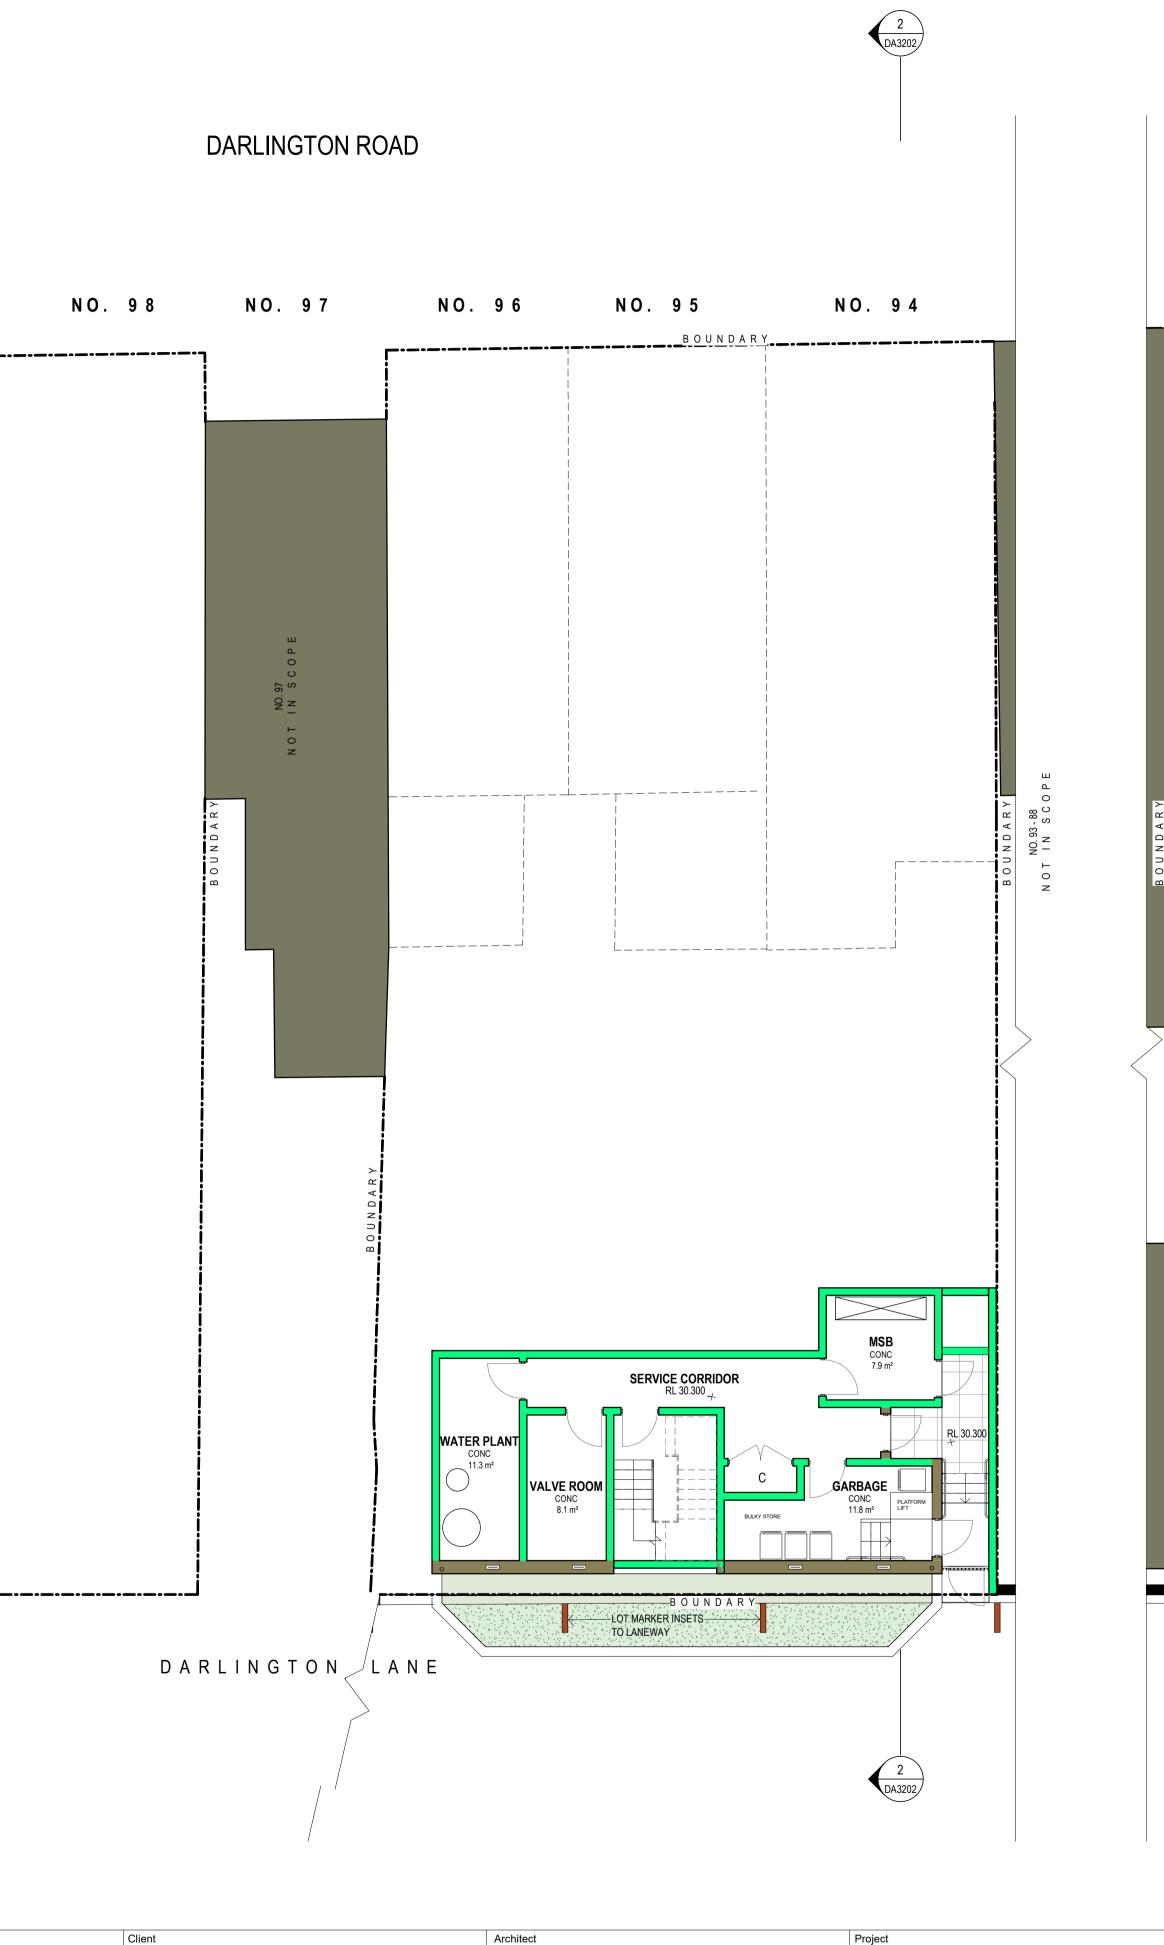


Project DARLINGTON ROAD TERRACES MIXED USE BUILDING ADDITIONS AND ALTERATIONS TO THE DARLINGTON ROAD TERRACES AND PUBLIC DOMAIN IMPROVEMENTS Darlington Road DARLINGTON NSW 2008 Proj. No. 14051

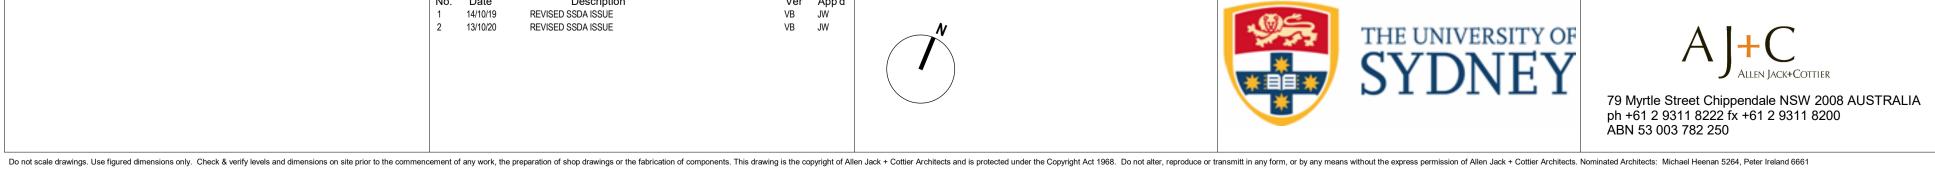







ALTERATIONS TO THE DARLINGTON ROAD TERRACES AND PUBLIC DOMAIN

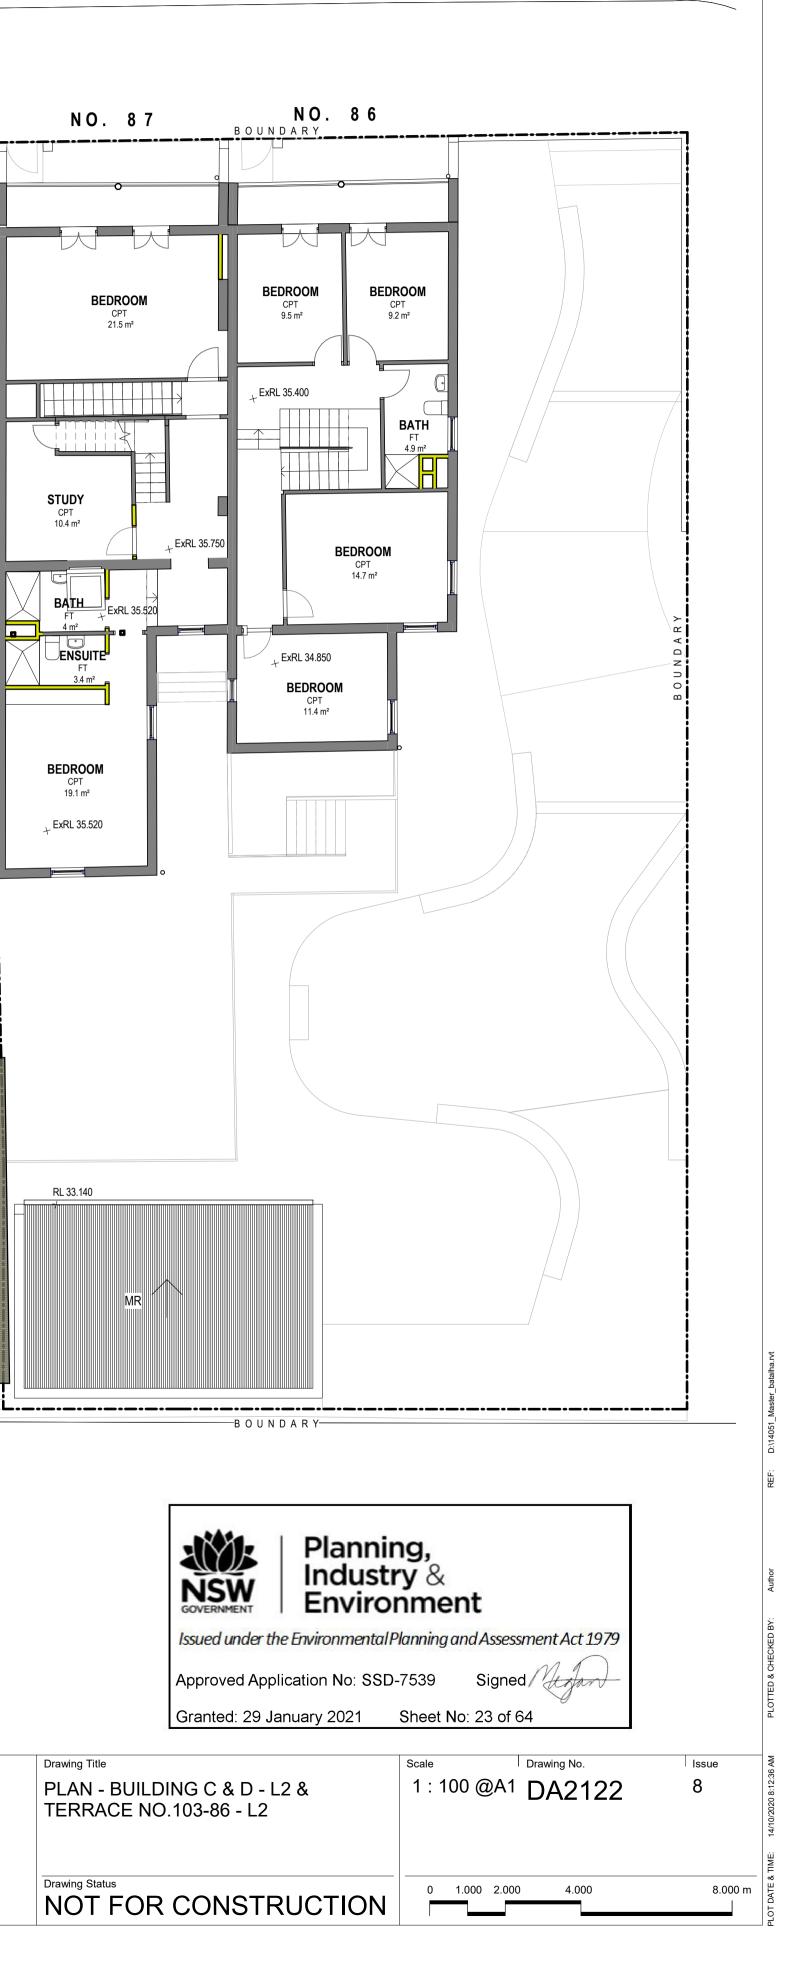



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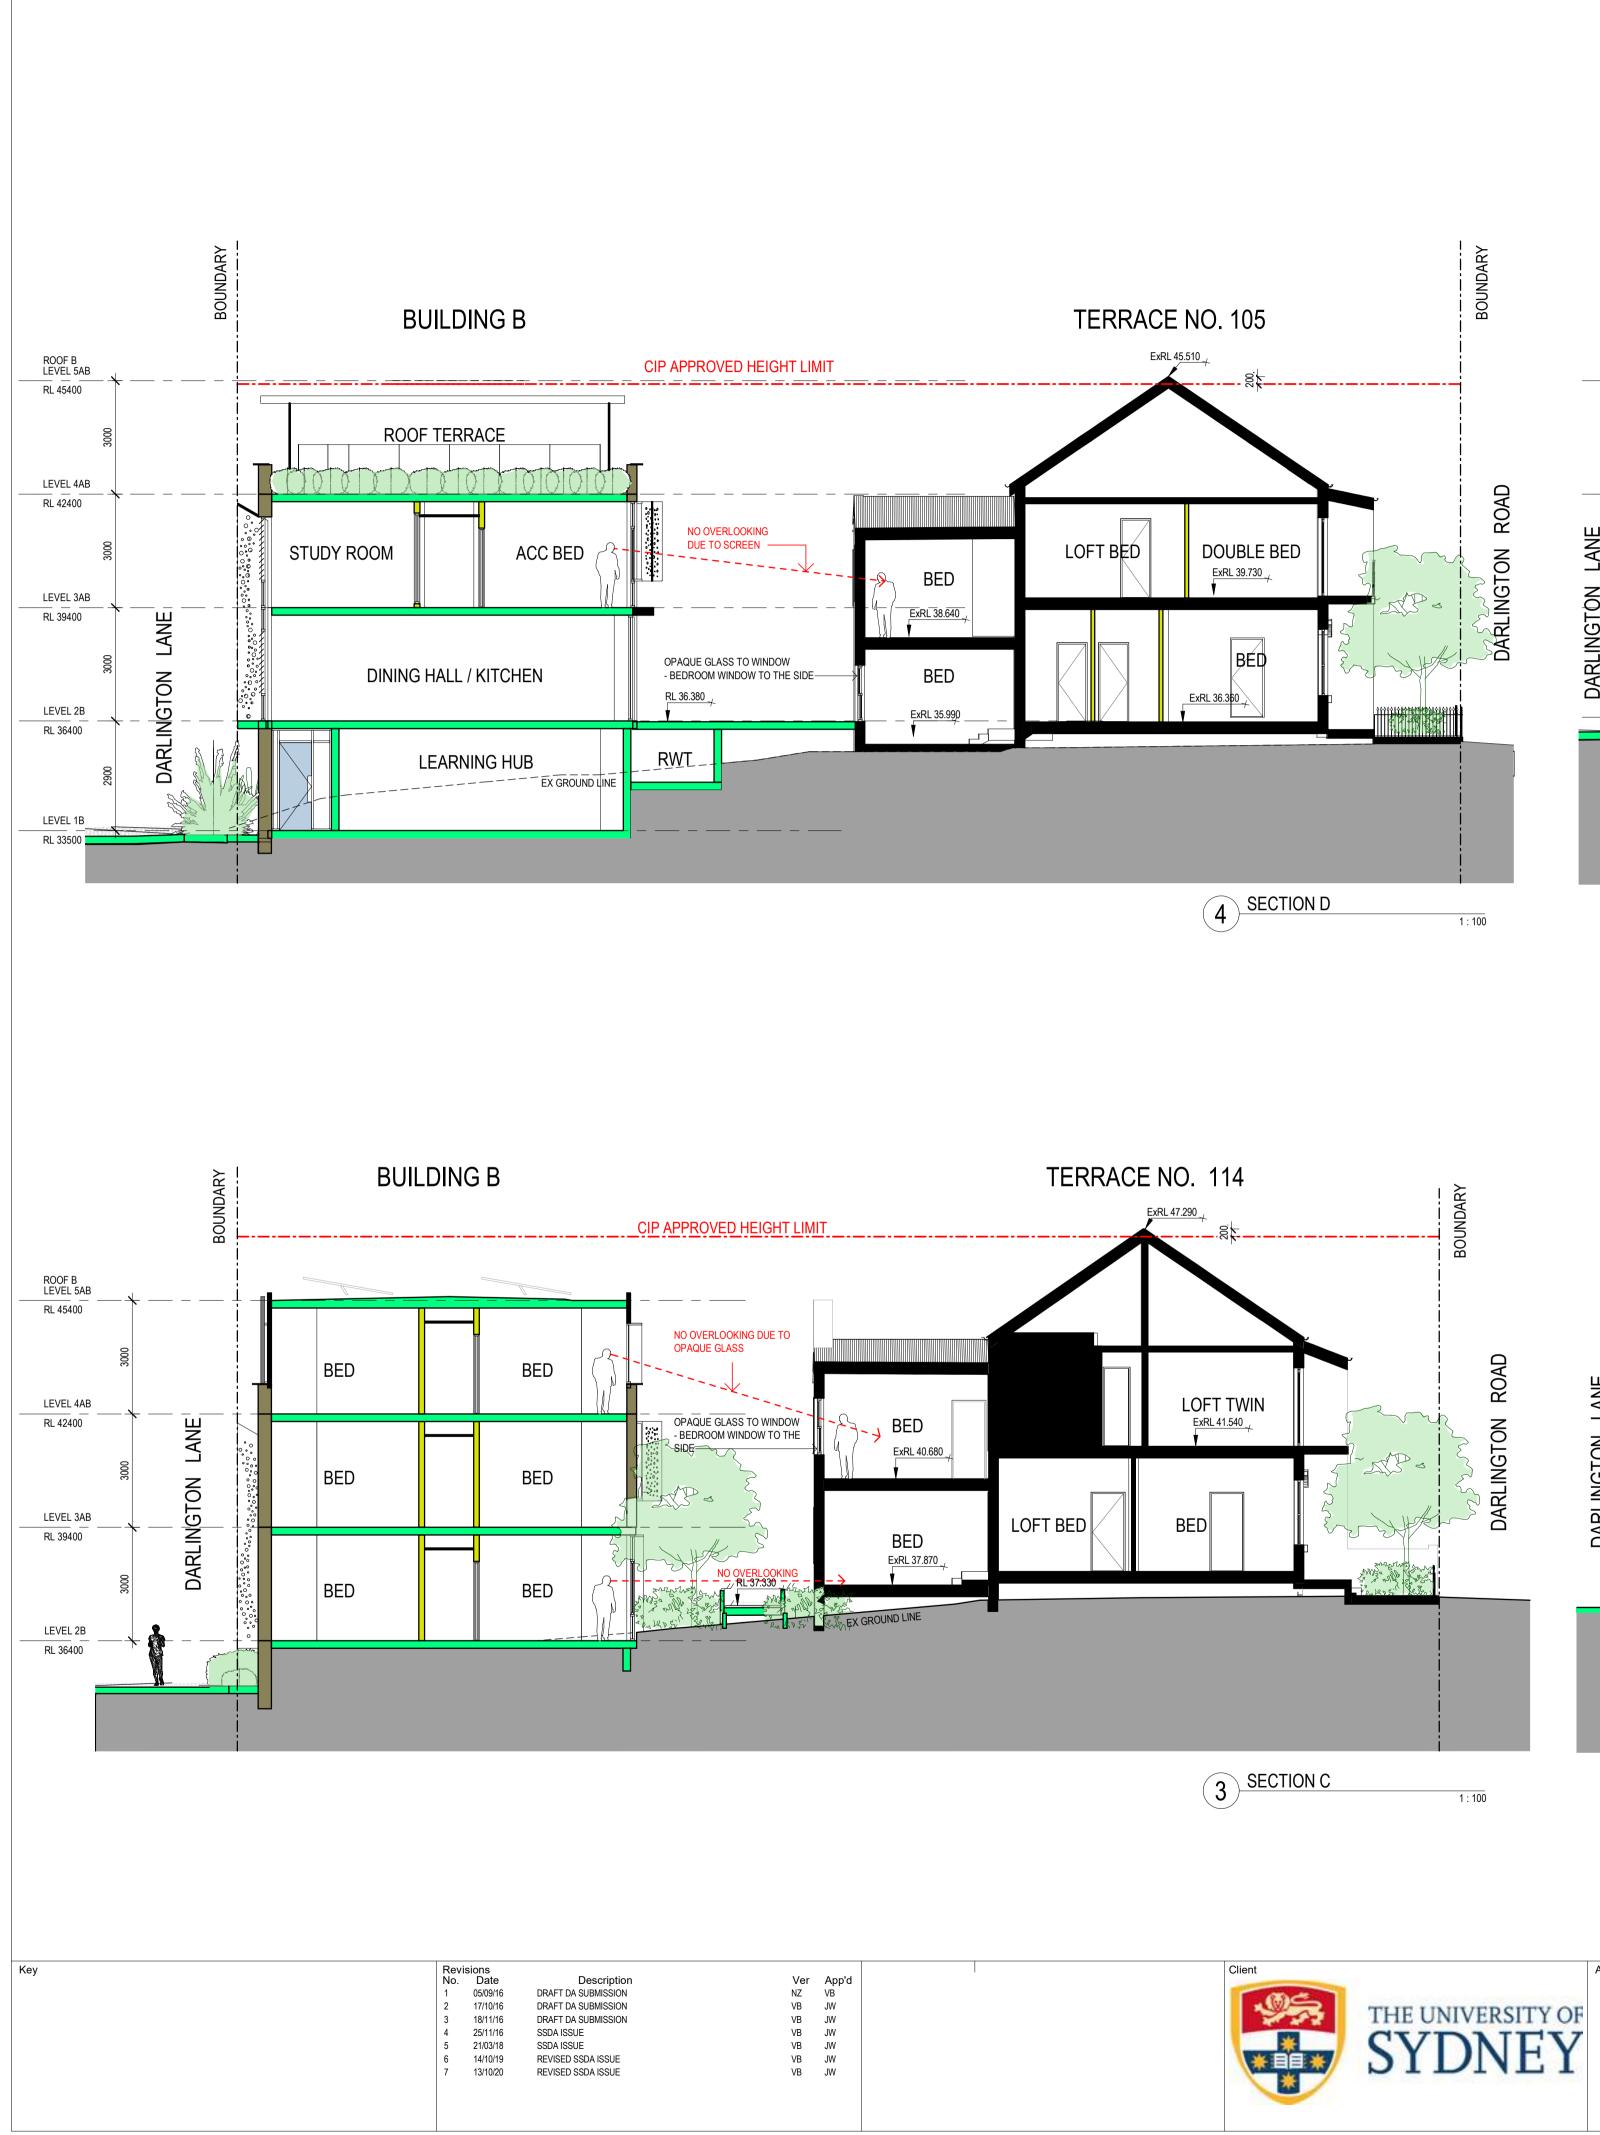


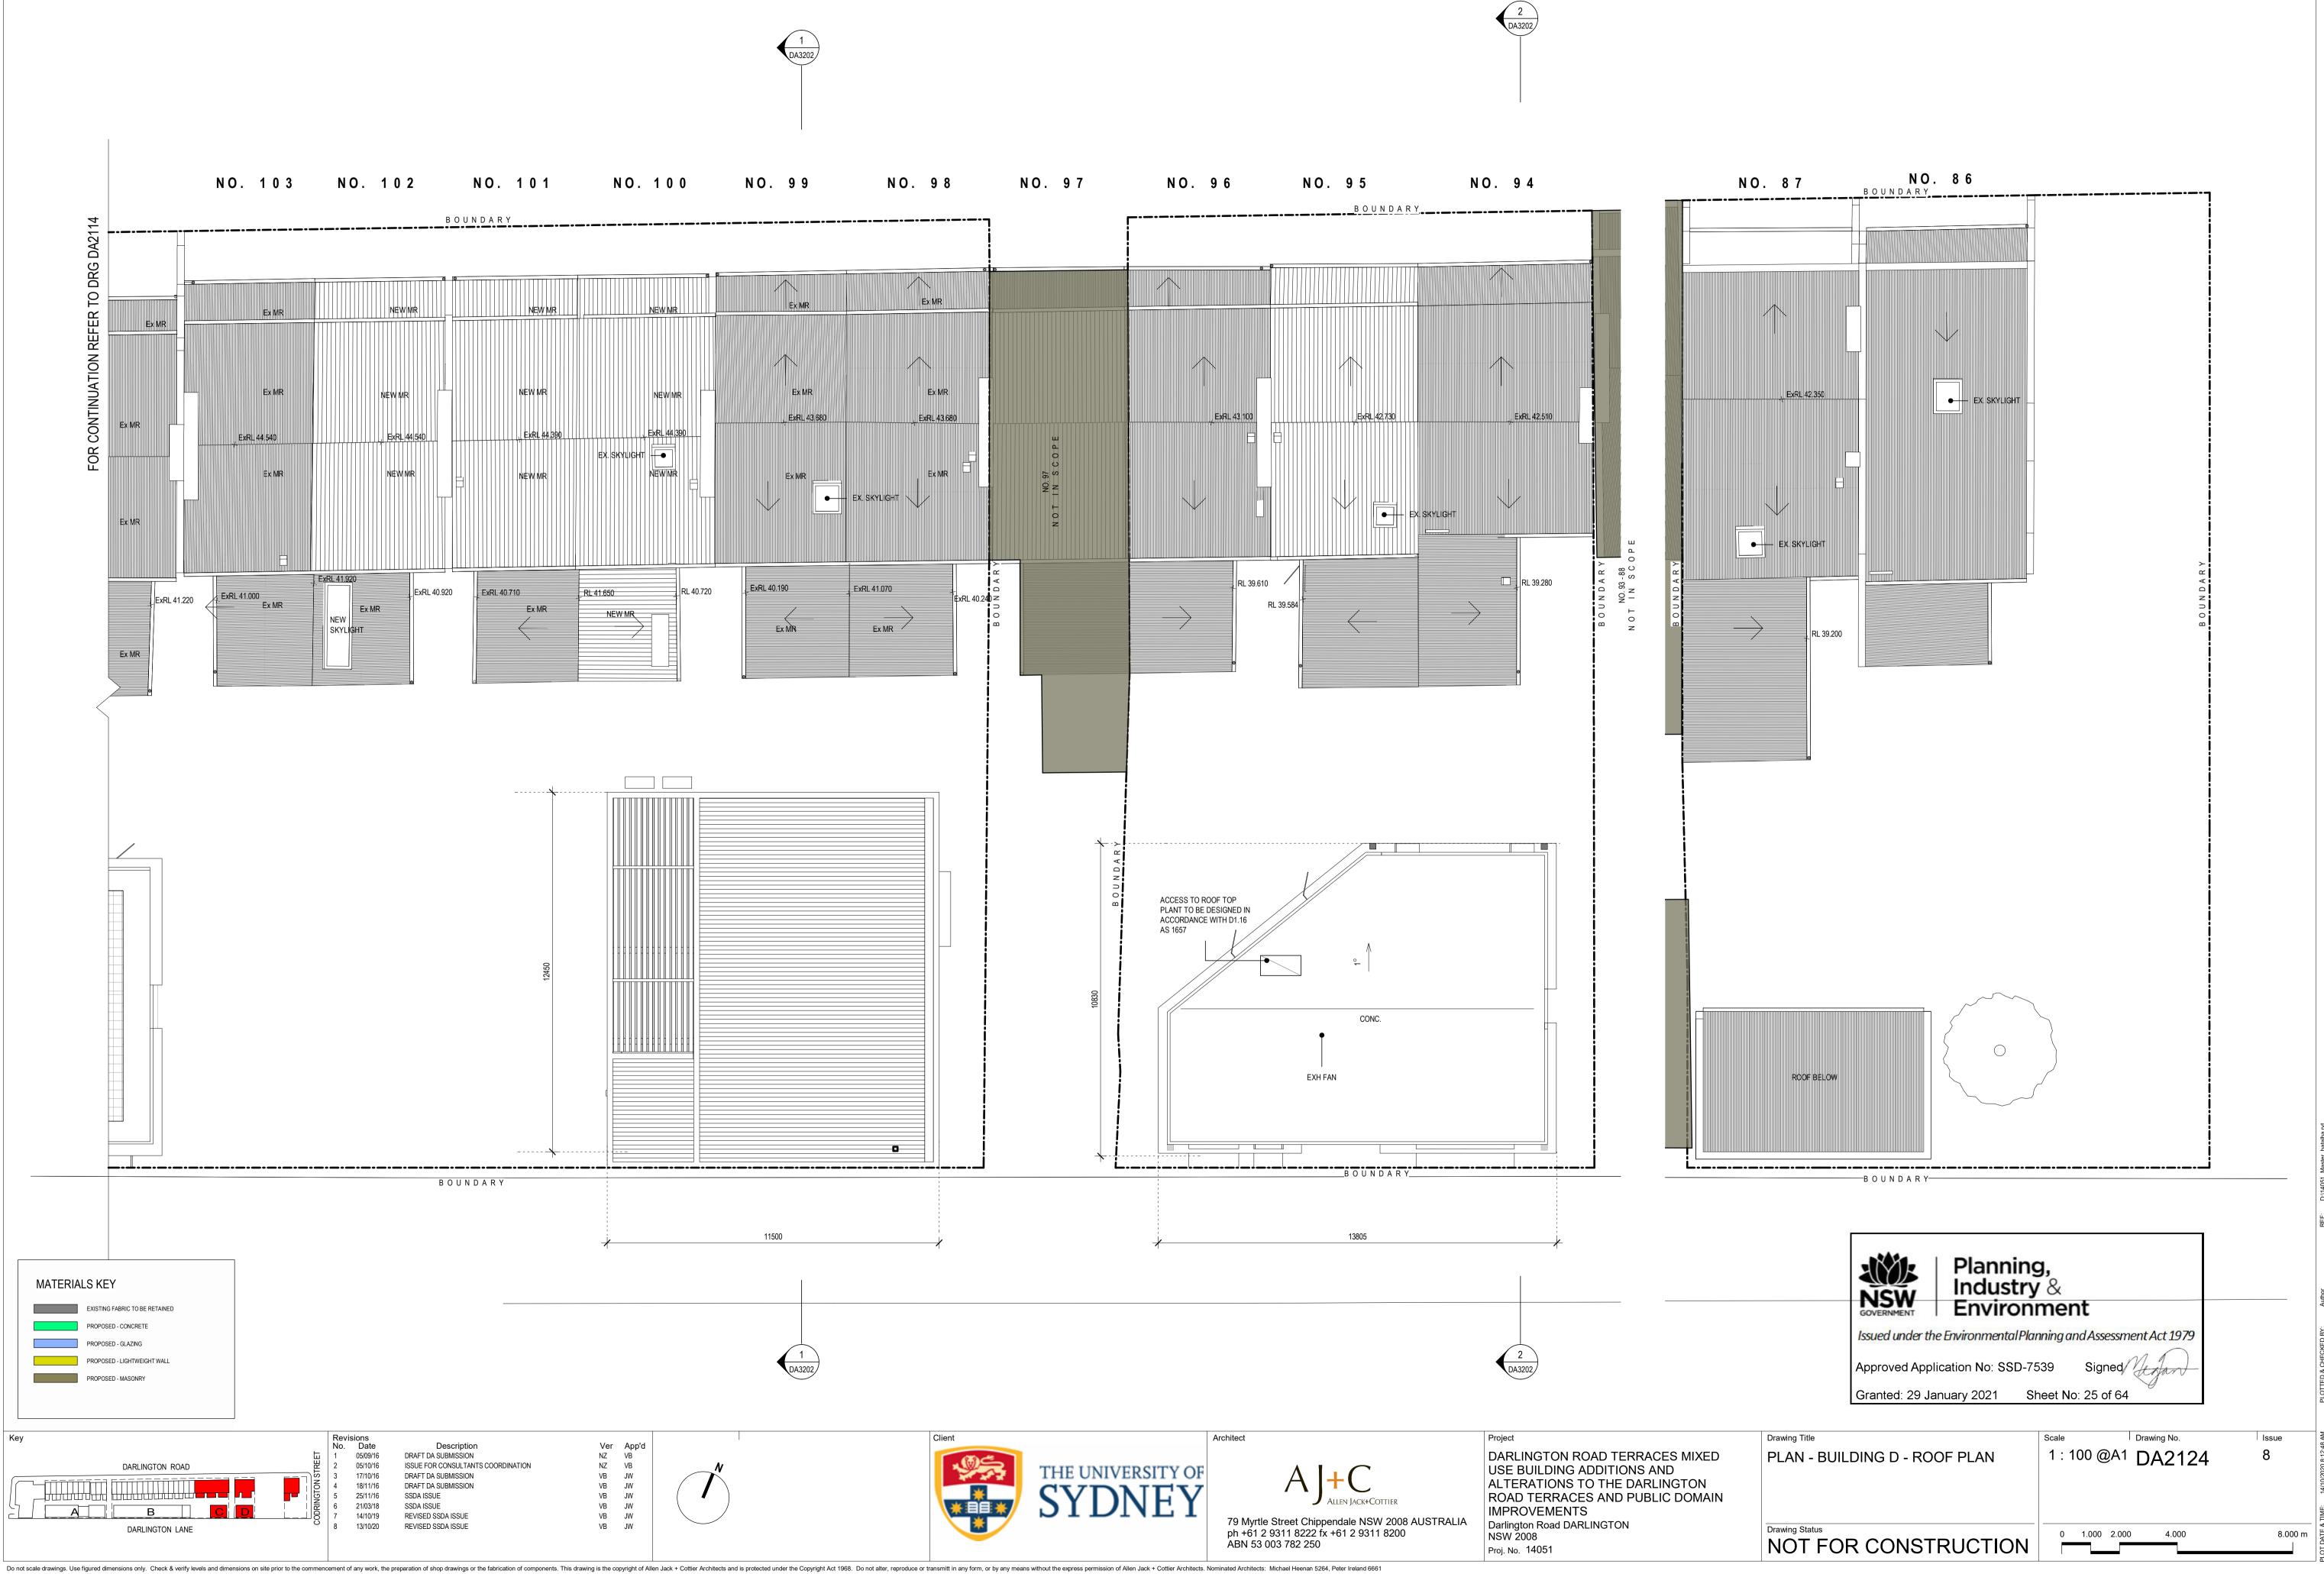


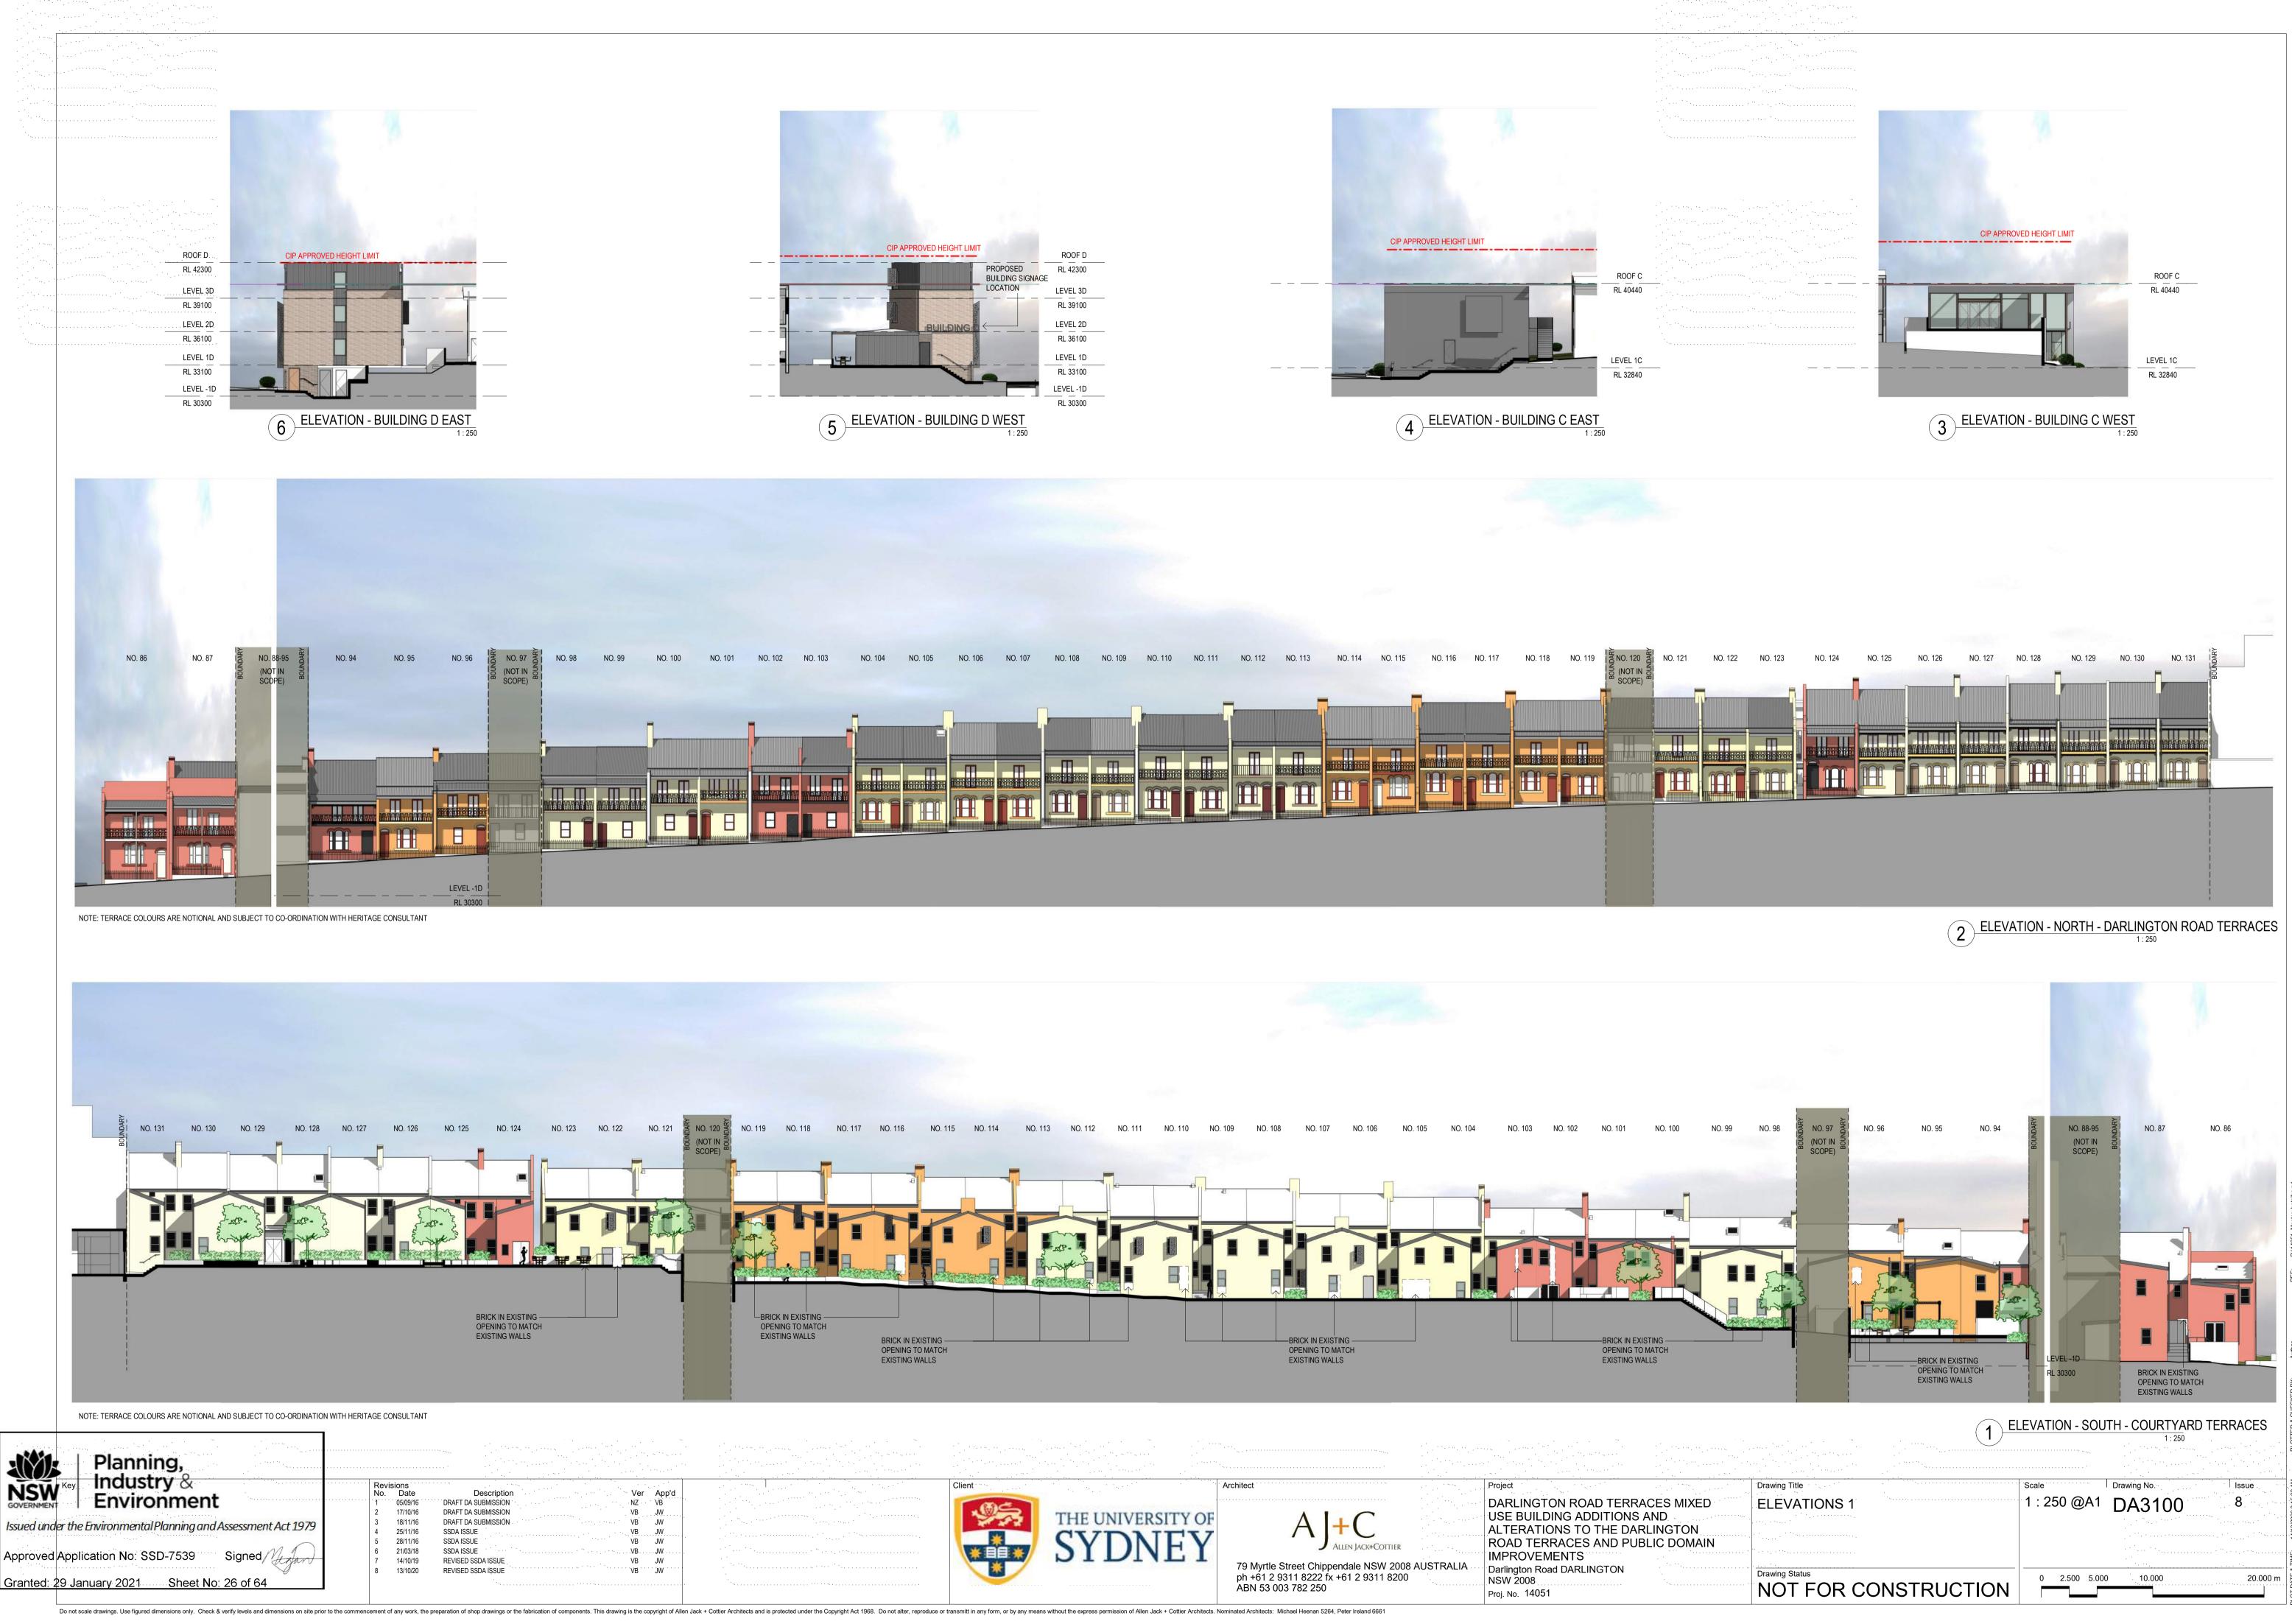








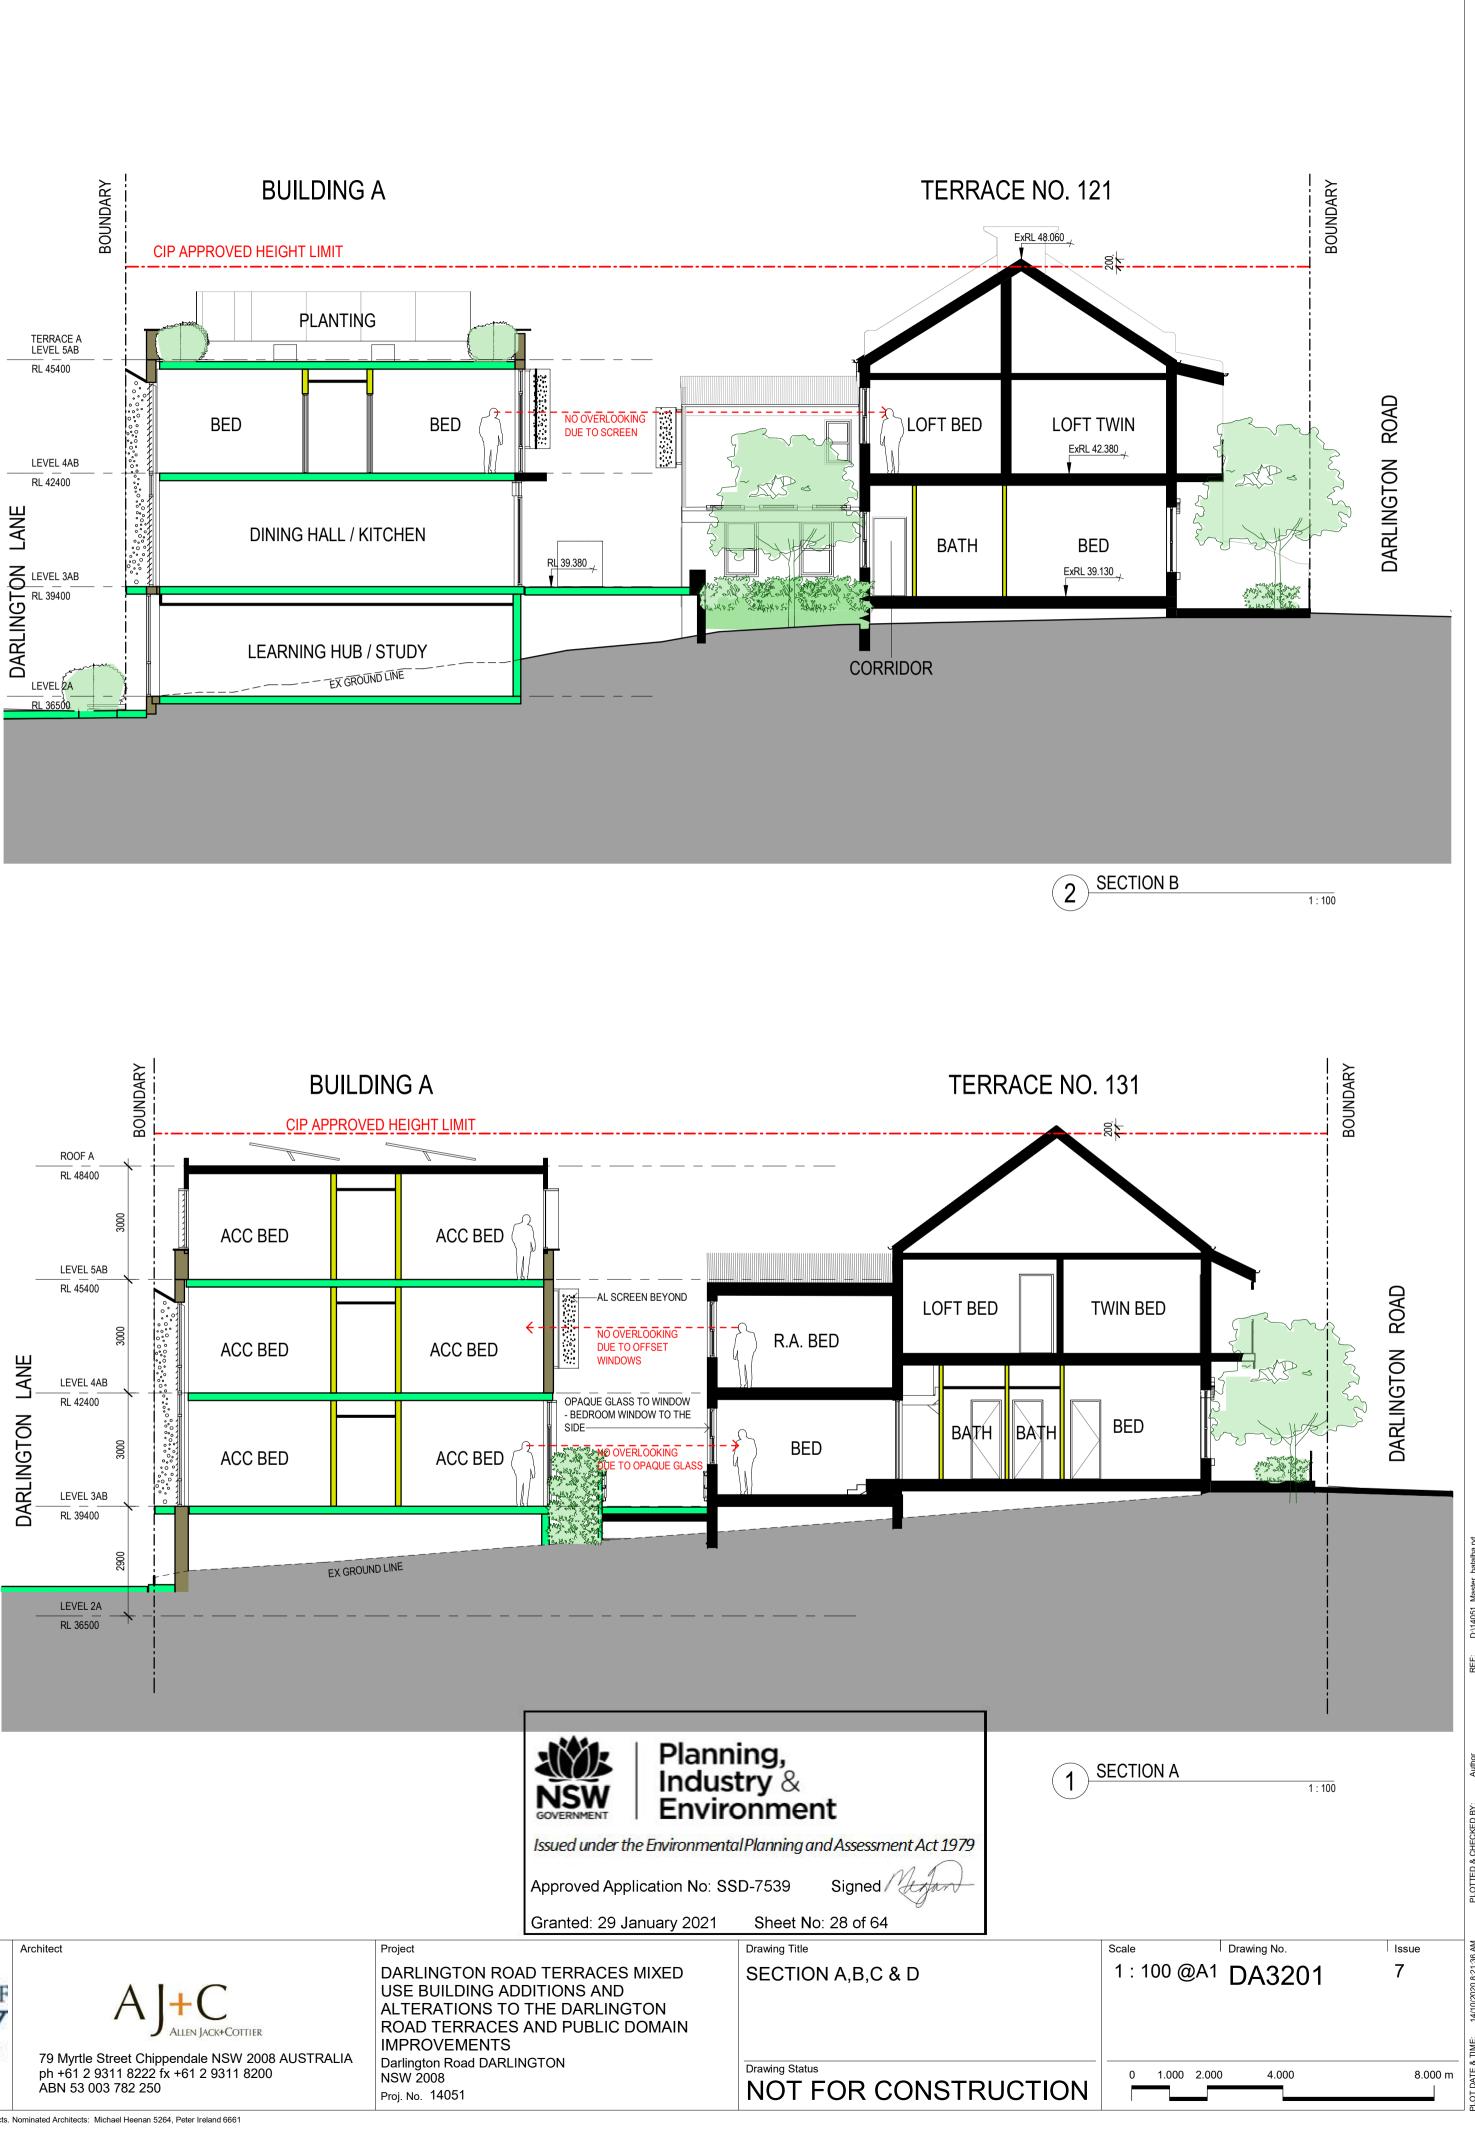

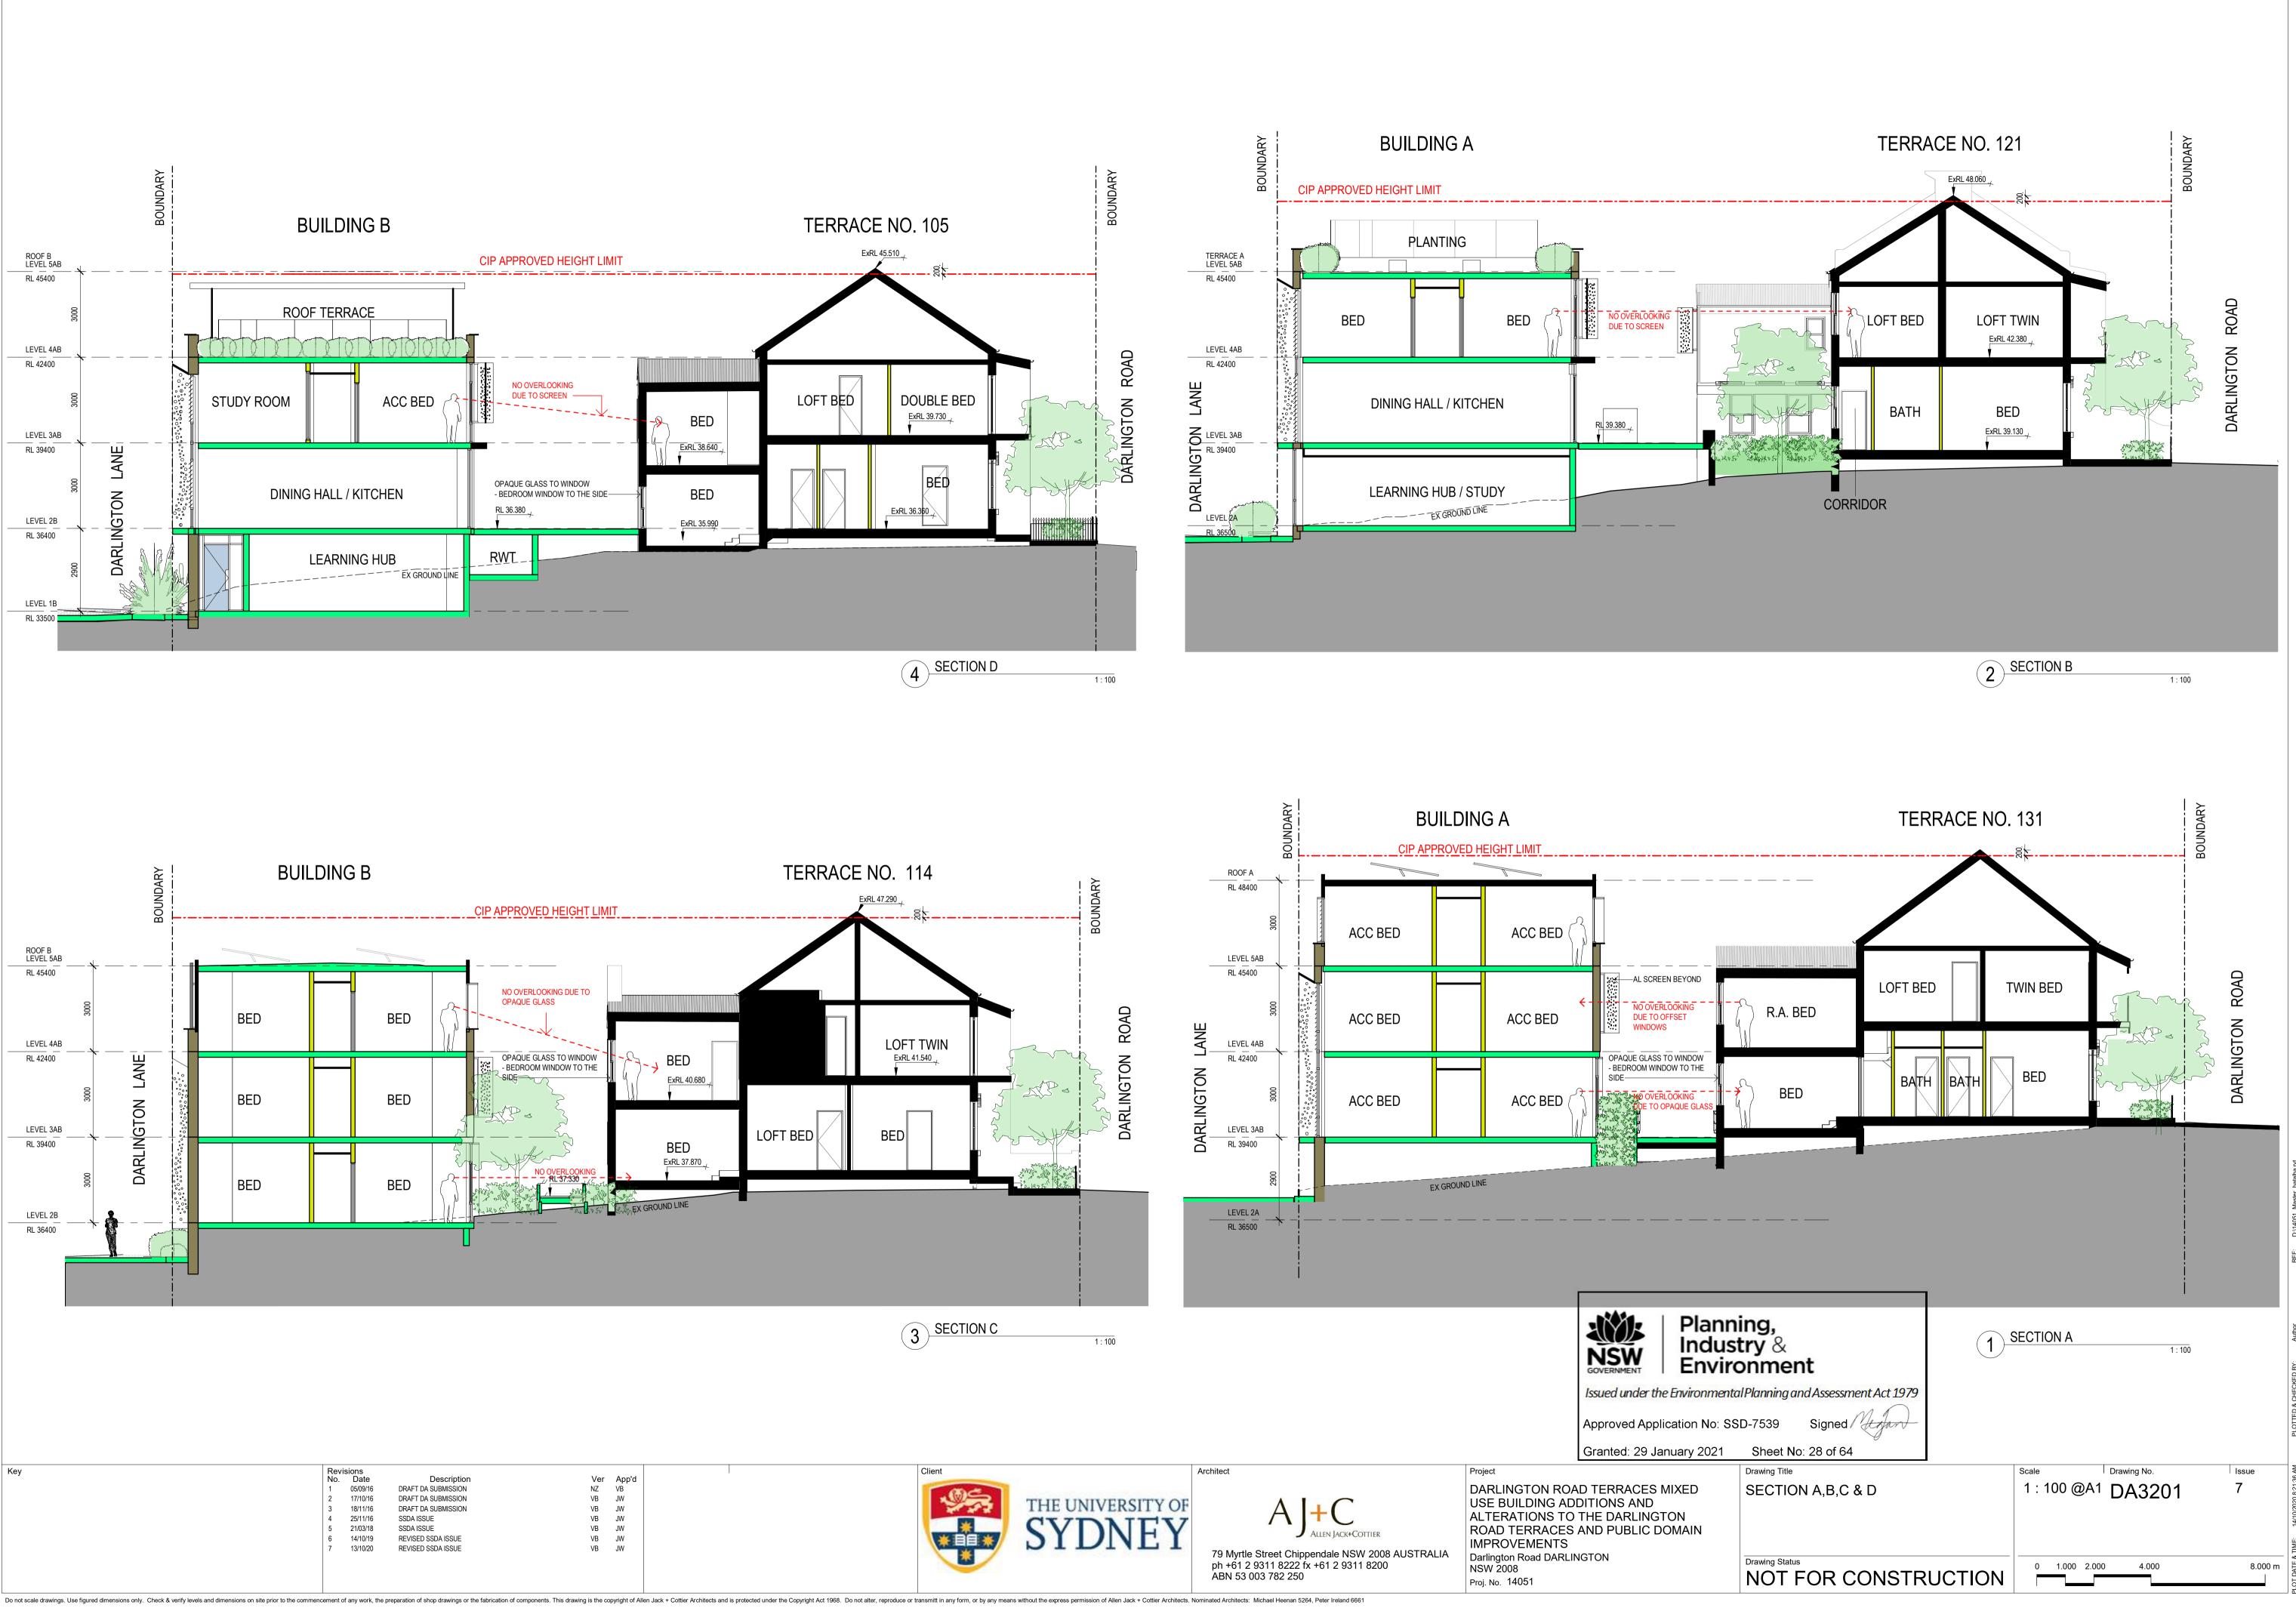







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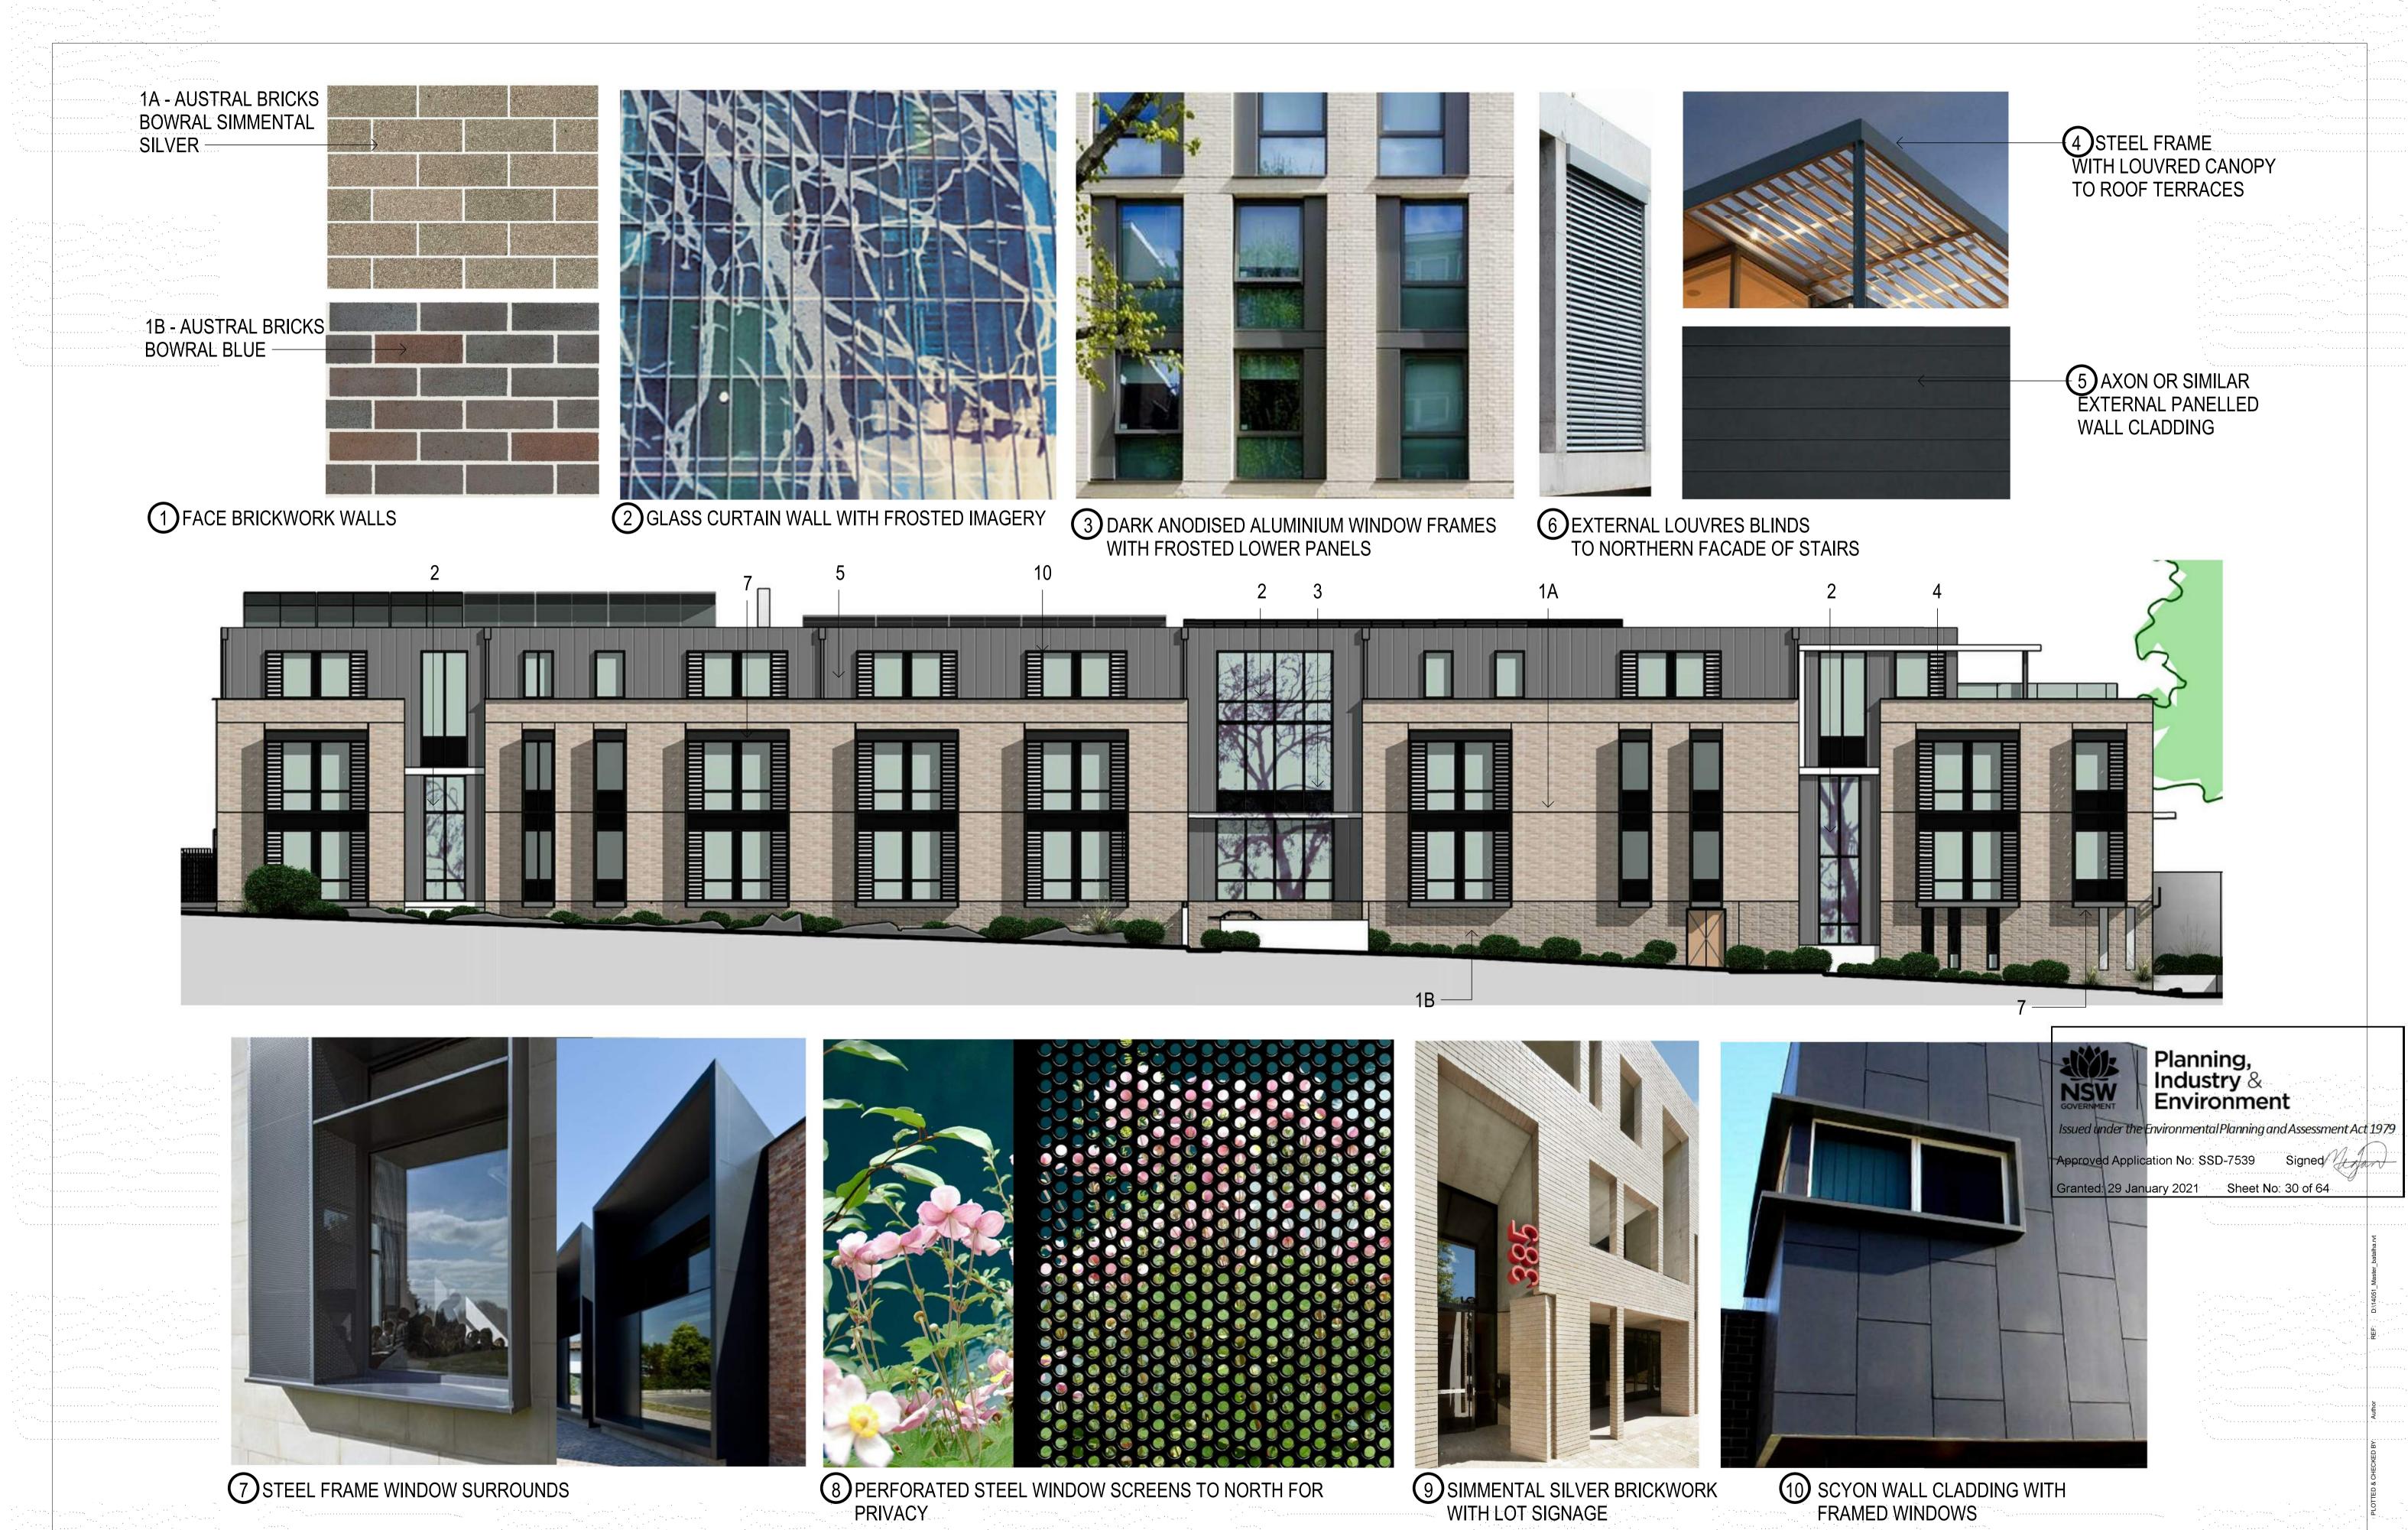
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0.	Date	Description
	05/09/16	DRAFT DA SUBMISSION
	17/10/16	DRAFT DA SUBMISSION
	18/11/16	DRAFT DA SUBMISSION
	25/11/16	SSDA ISSUE
	21/03/18	SSDA ISSUE
	14/10/19	REVISED SSDA ISSUE
	13/10/20	REVISED SSDA ISSUE

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7 STEEL FRAME WINDOW SURROUNDS


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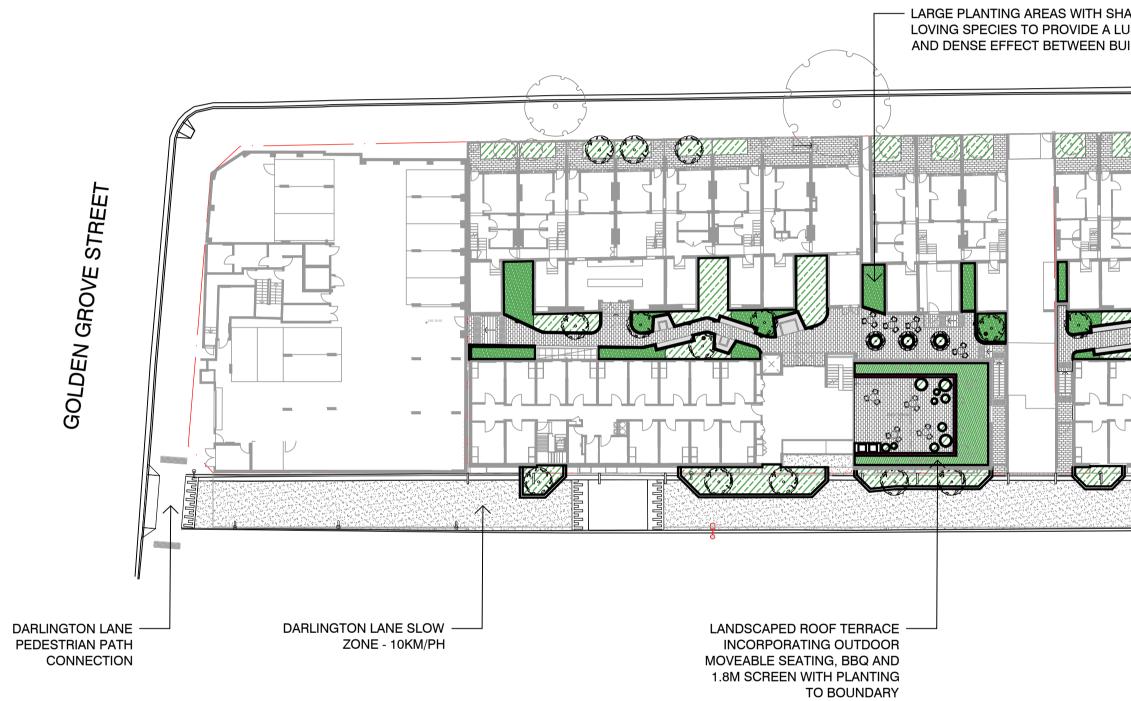


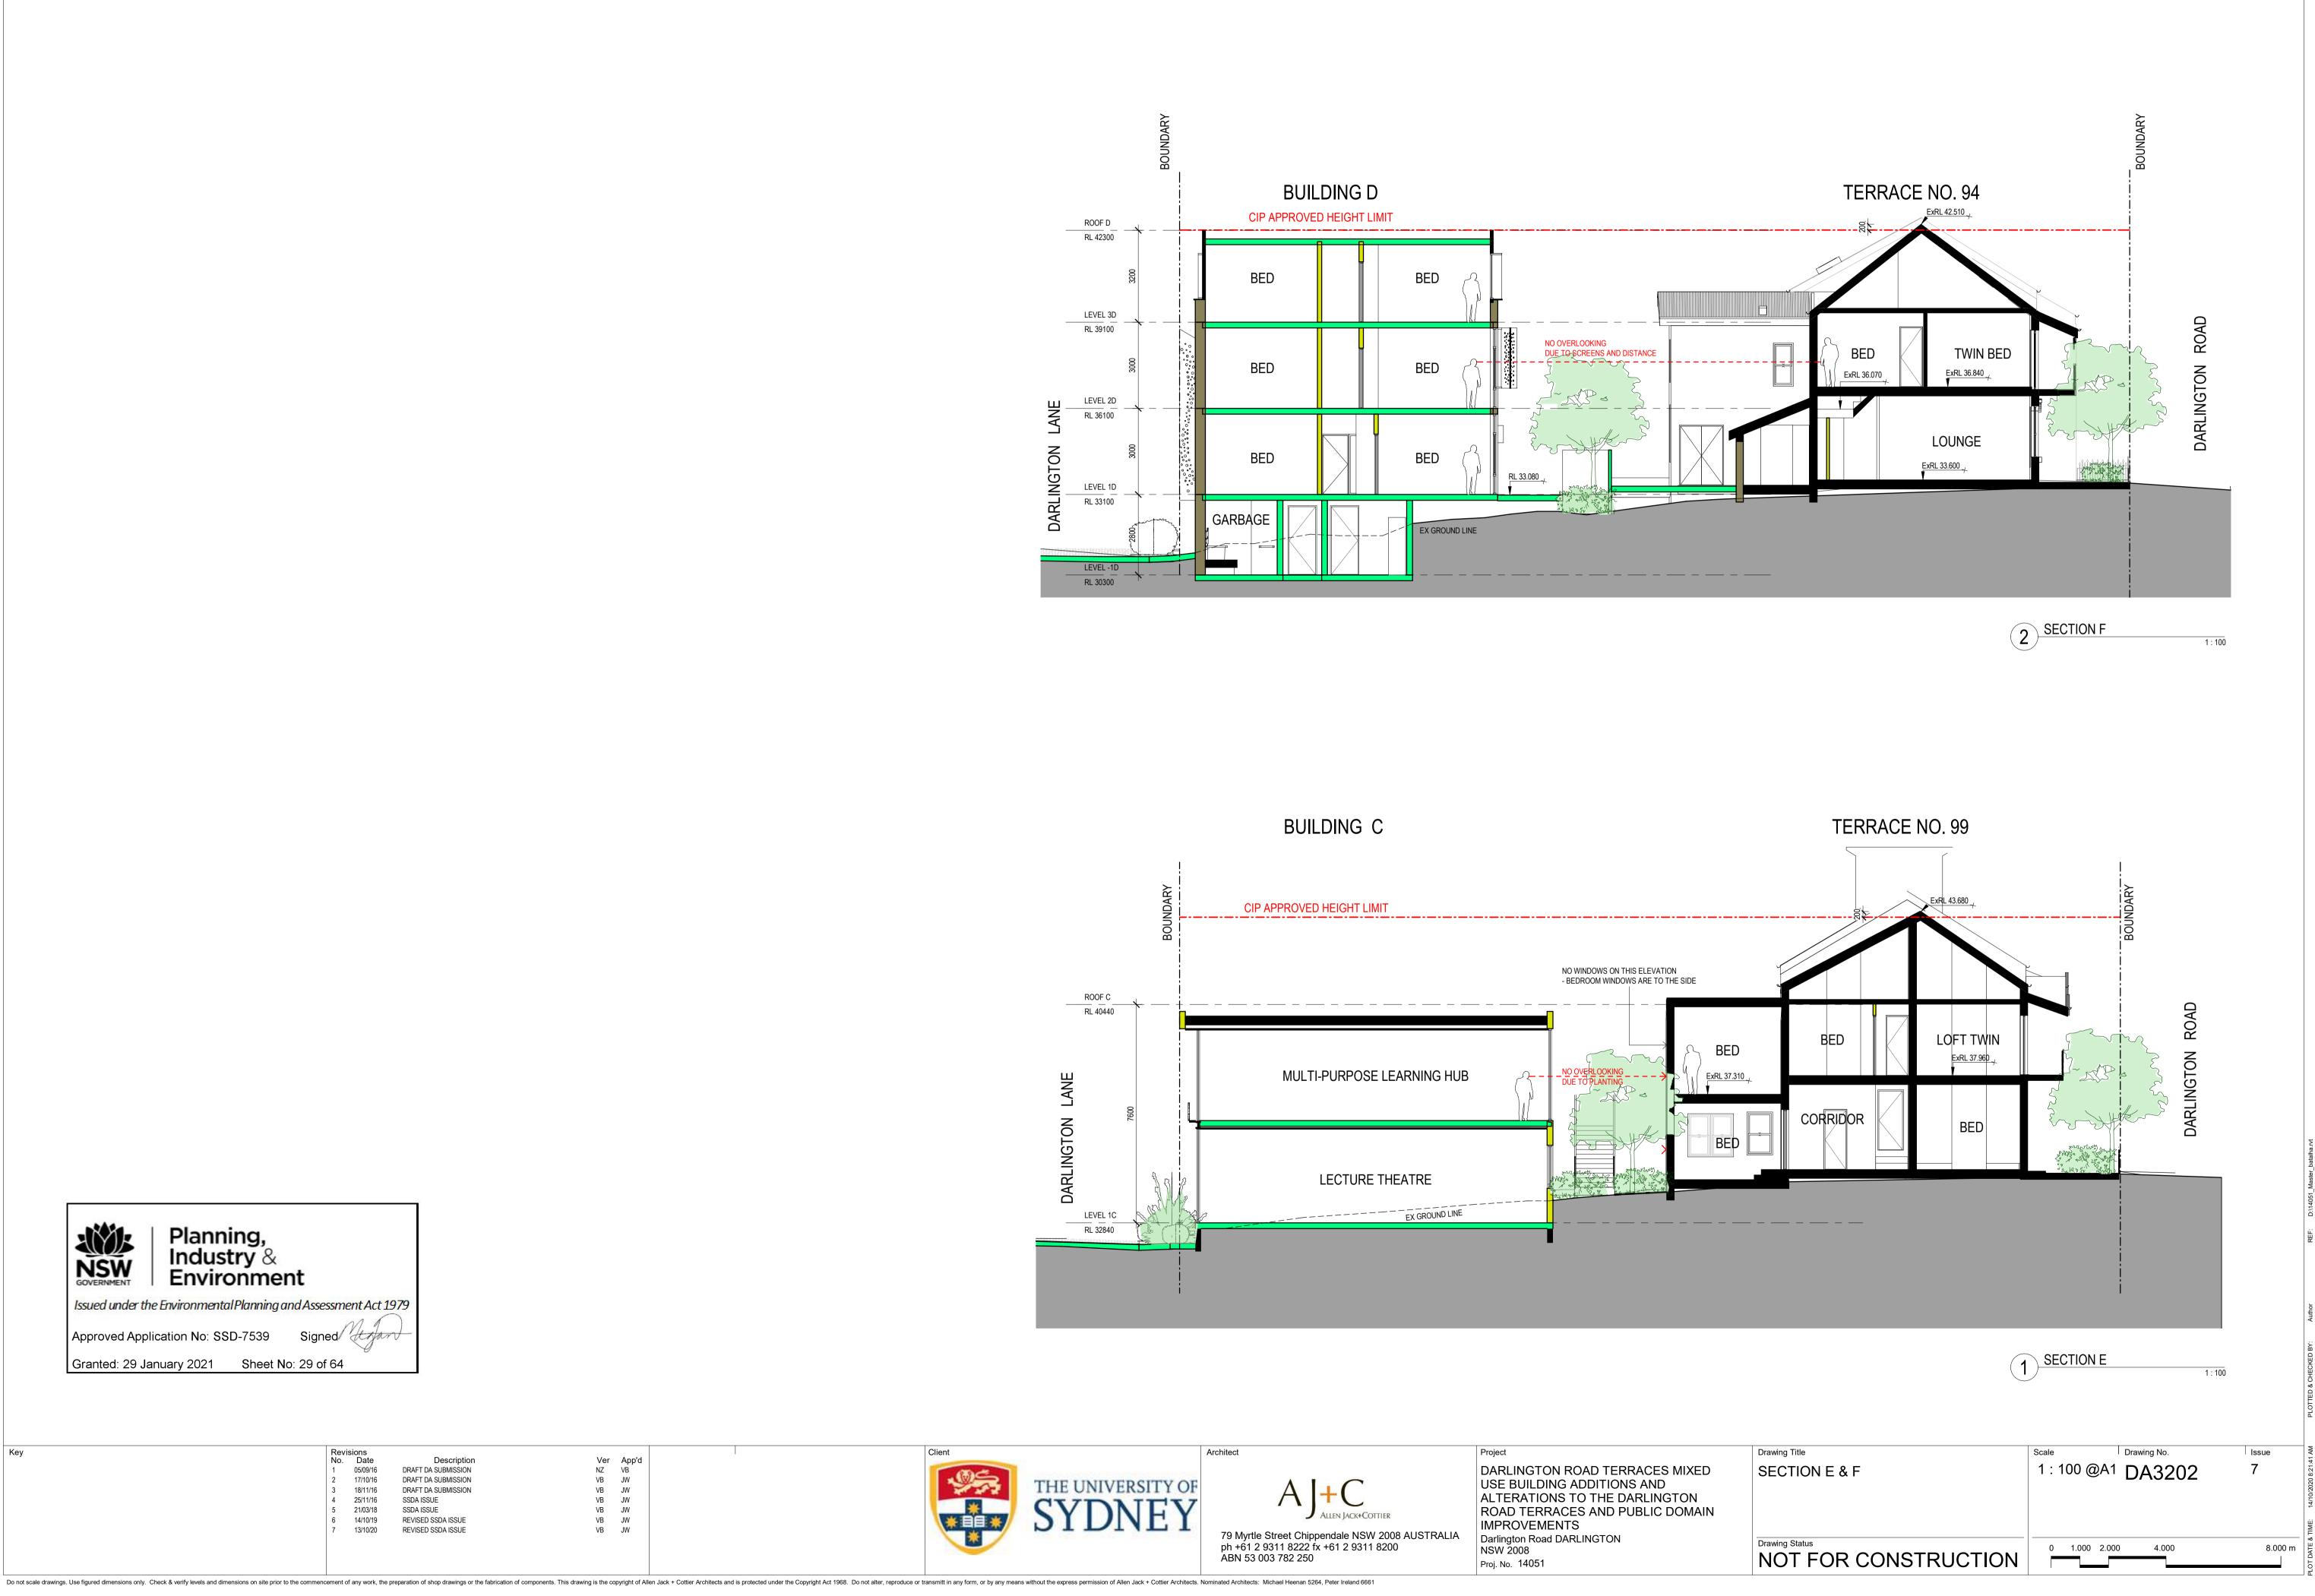

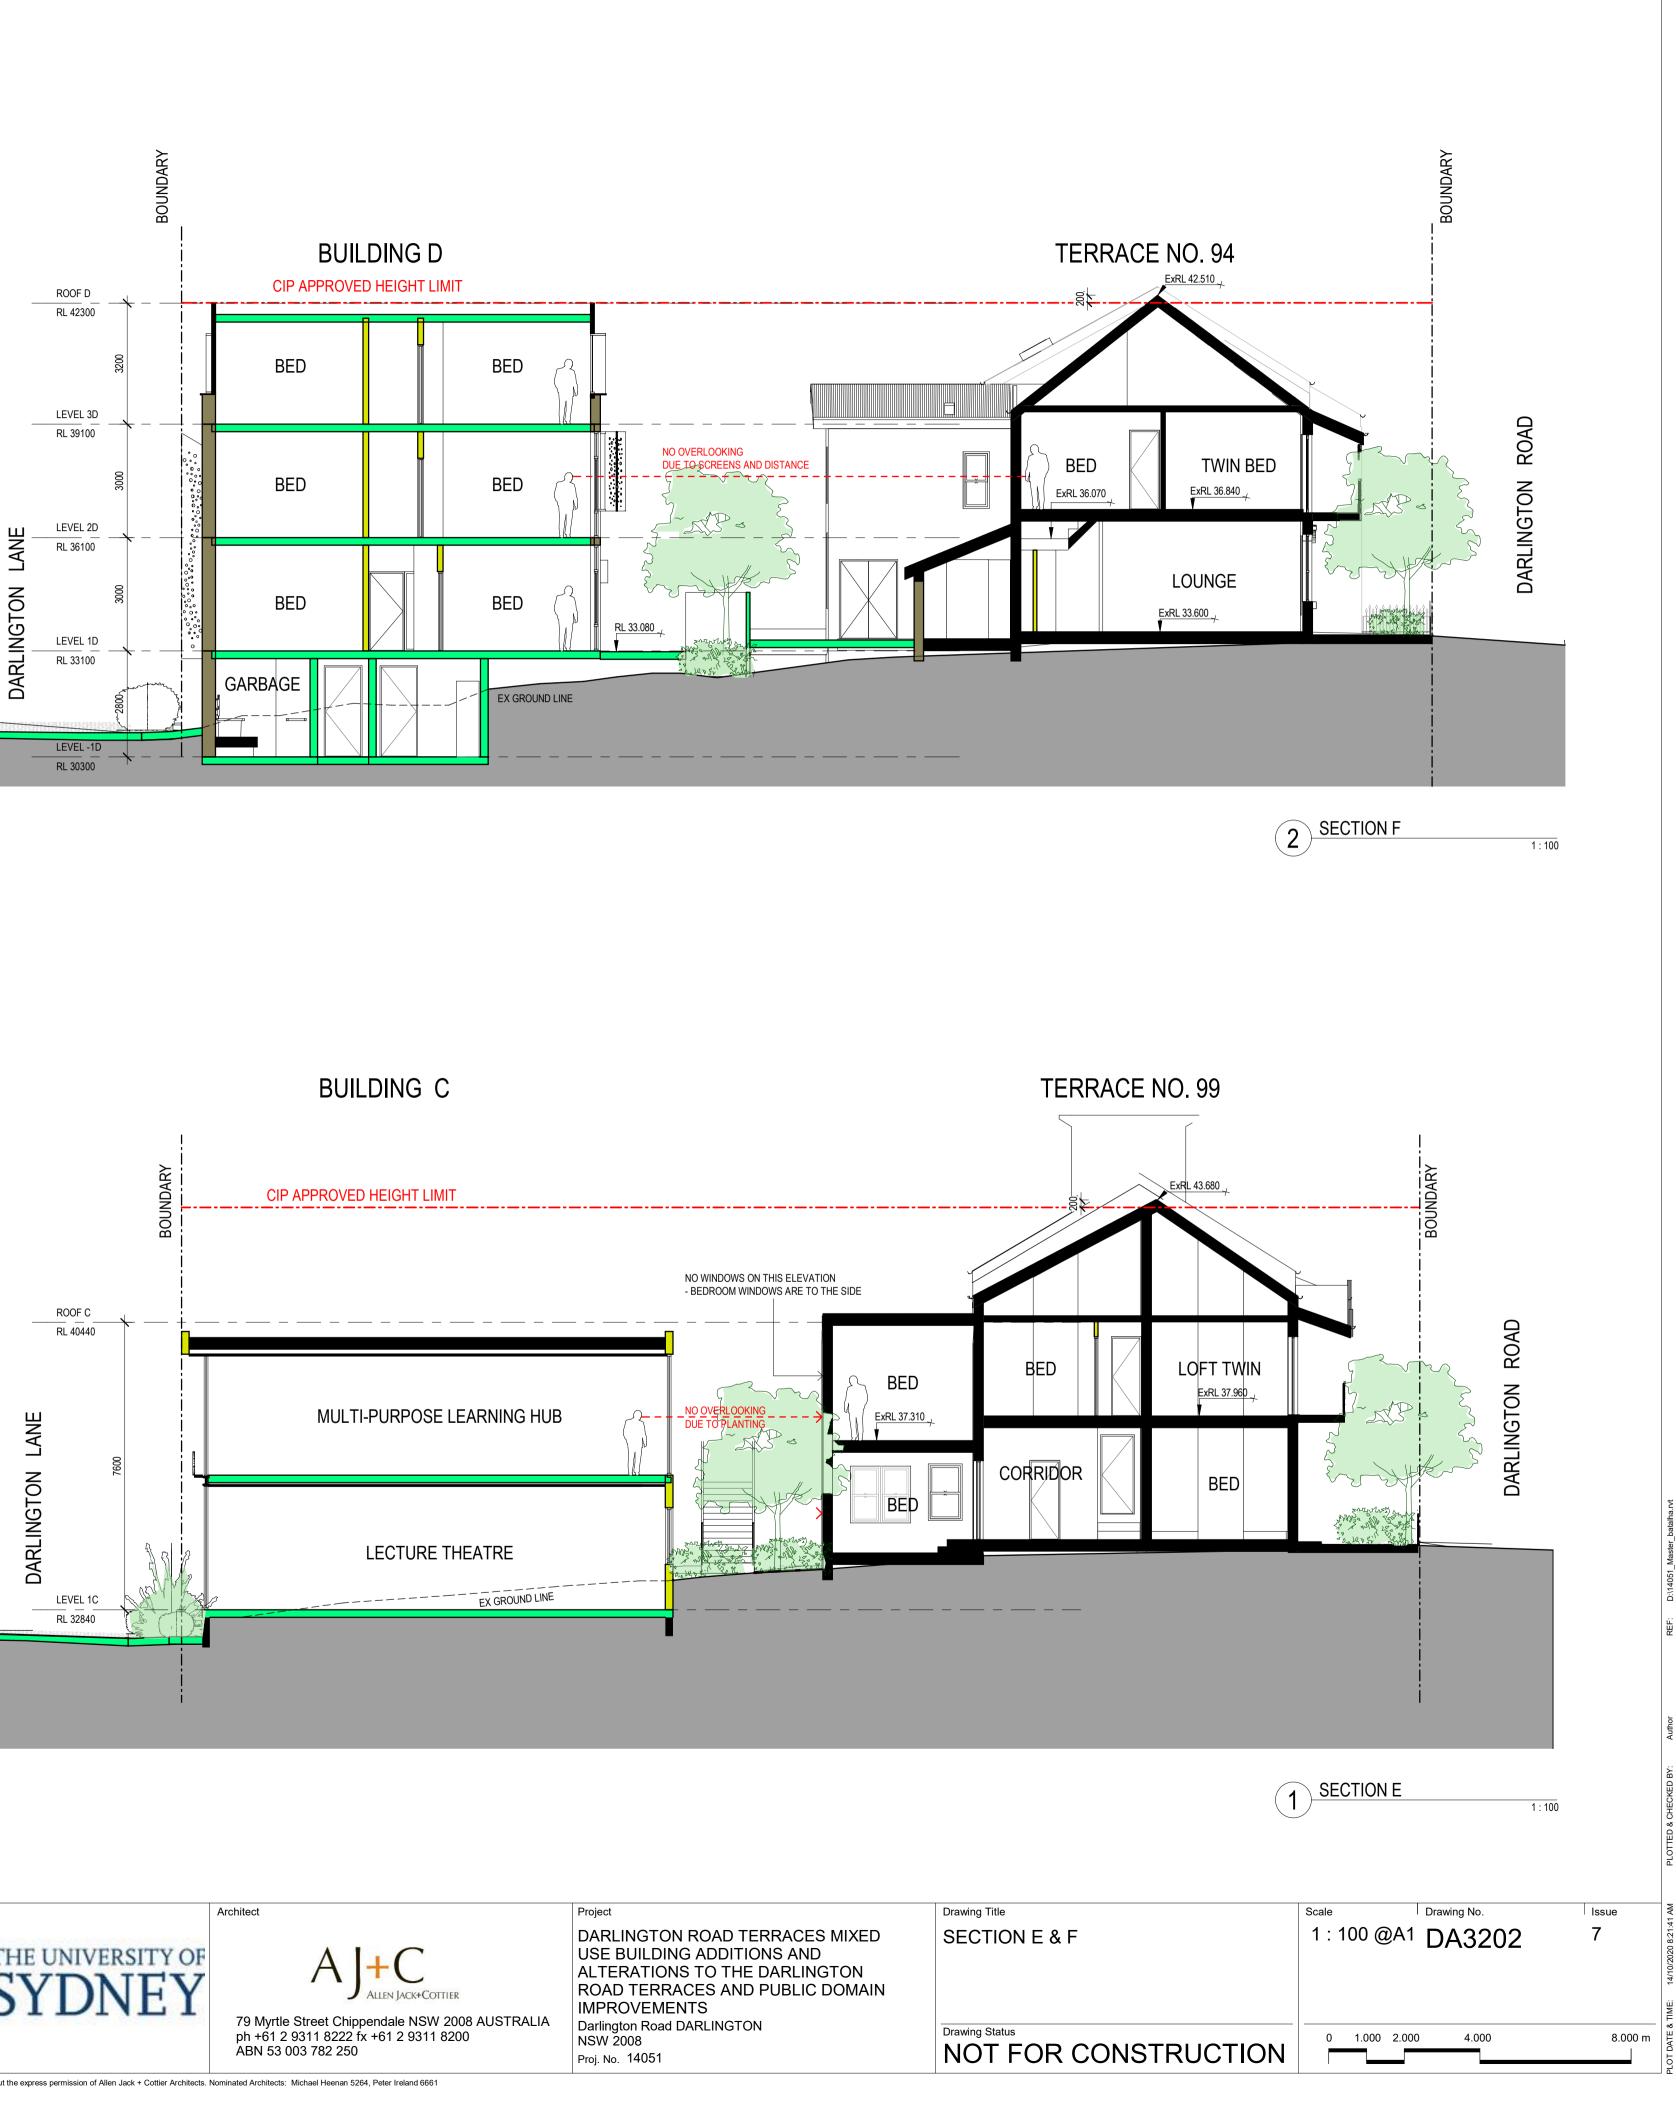

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NOTES	KEY PLAN	ISSUE DATE AMENDMENT	DRN	APRVD	
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© OCULUS 2018 All rights reserved		05 22.05.20 ISSUE FOR DA	SM	KS	p 02.9557.5533 australia@oculus.info
DIAL BEFORE SERVICES SHOWN ON THIS DRAWING ARE APPROXIMATELY ONLY. THE EXACT LOCATION IS					SYDNEY MELBOURNE WASHINGTON
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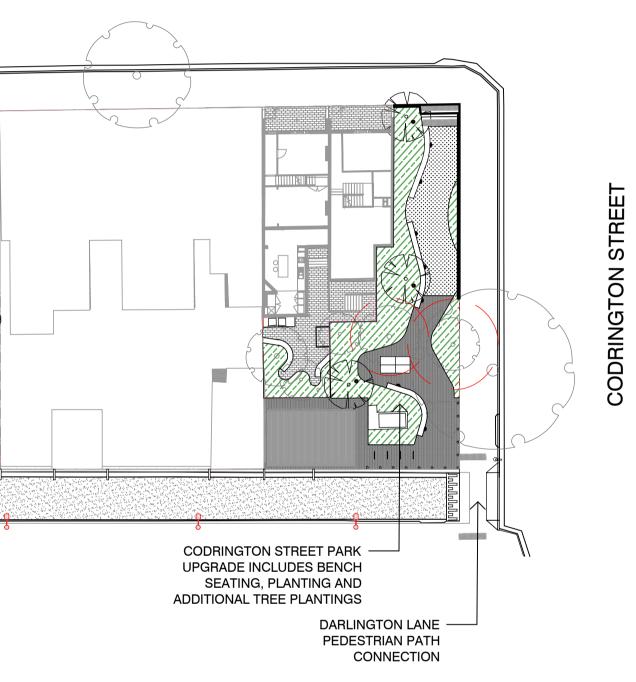
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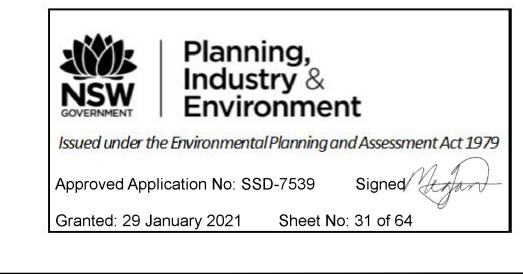
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PLANTED ROA WITH SHADE TOLEI	RANT PLANT	LANDSCAPED ROOF TERRACE INCORPORATING OUTDOOR MOVEABLE SEATING AND 1.8M SCREEN WITH PLANTING TO BOUNDARY EXISTING LARGE EUCALYPTUS SALIGNA RETAINED WITH UNDERPLANTING TO PROTECT THE STRUCTURAL ROOT ZONE	

PROJECT
DARLINGTON ROAD TERRACES
Darlington Road, Darlington NSW 2008
CLIENT

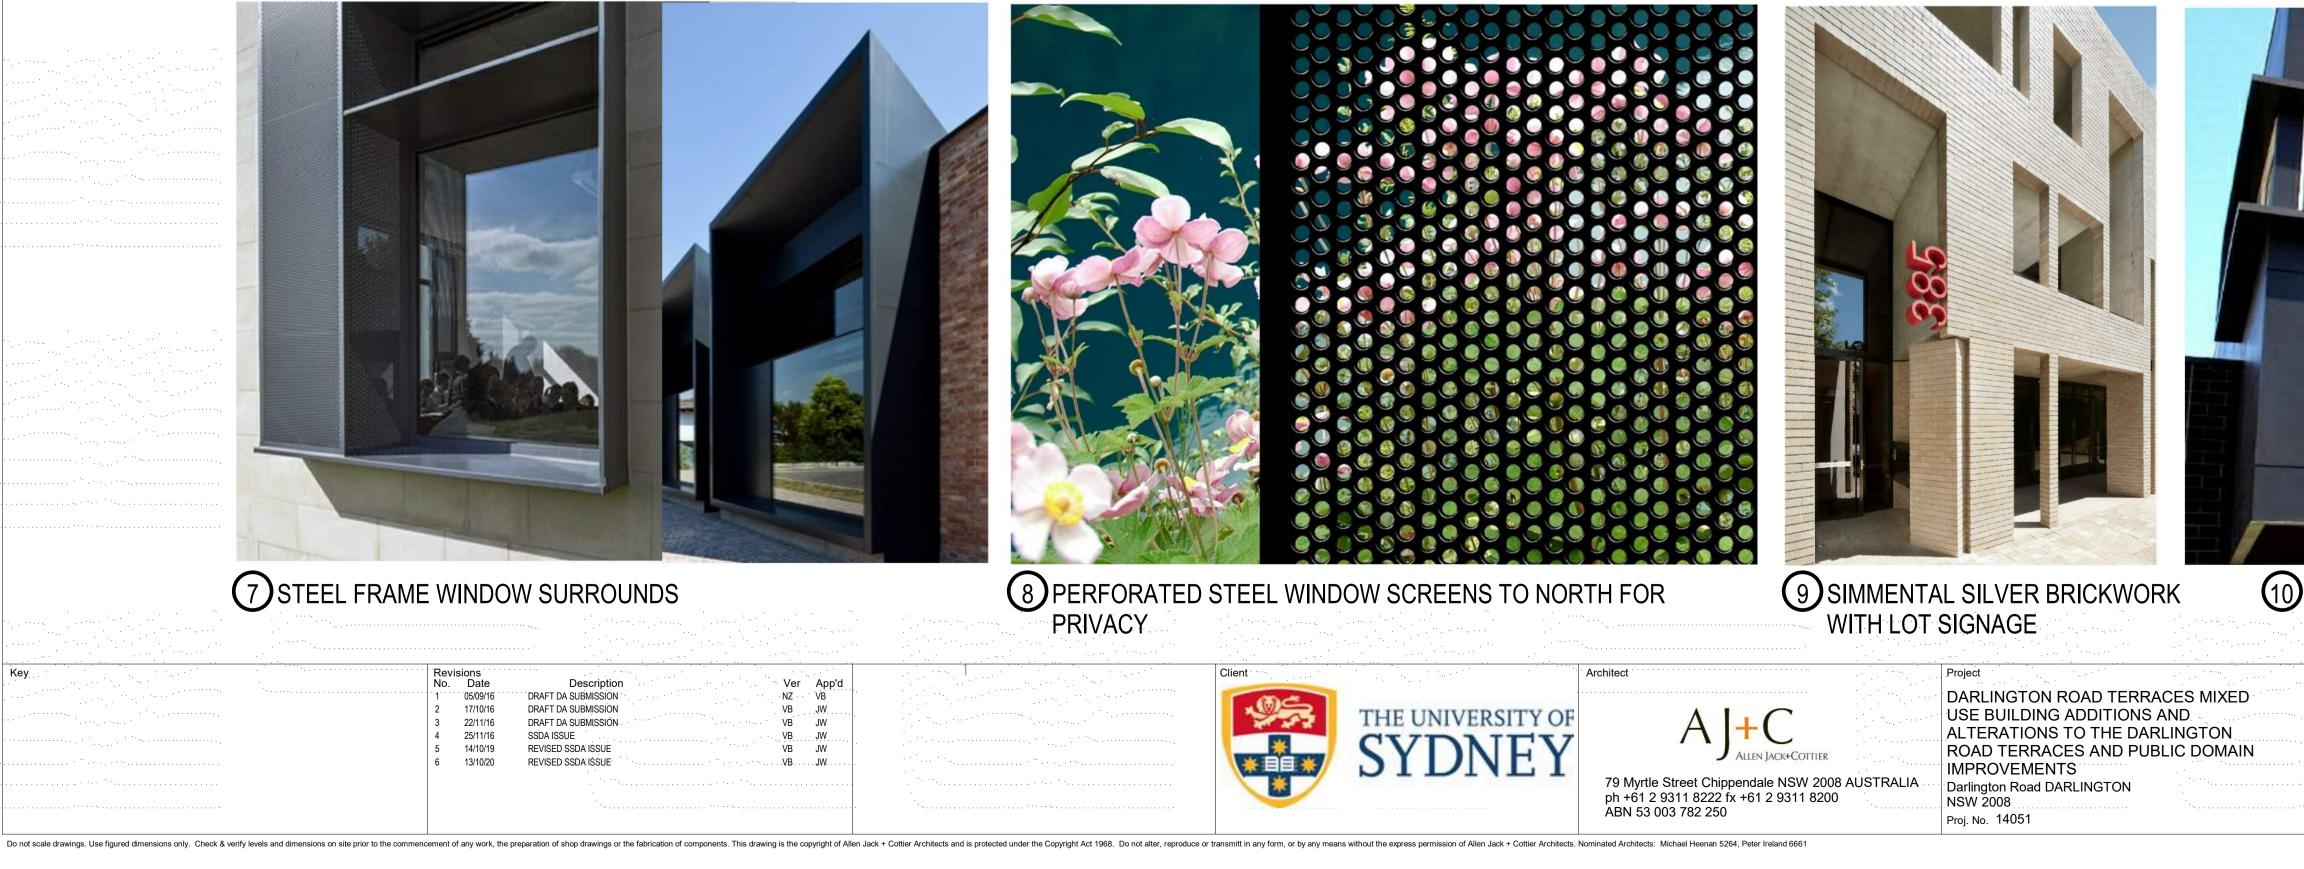THE UNIVERSITY OF SYDNEY Camperdown NSW 2006

ARCHITECT ALLEN JACK AND COTTIER 79 Myrtle Street Chippendale NSW 2008







STATUS		DRAWING	
DEVELOPMENT APPLICATION		SITE PLAN	
DRAWING SCALE	NORTH POINT	PROJECT №	SHEET SIZE
SCALE 1:350 @ A1 0.5 0 0.5 1 2.5m		S14-028 	ISSUE

L005

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ISSUE	DATE	AMENDMENT	DRN	APRVD
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ARCHITECT

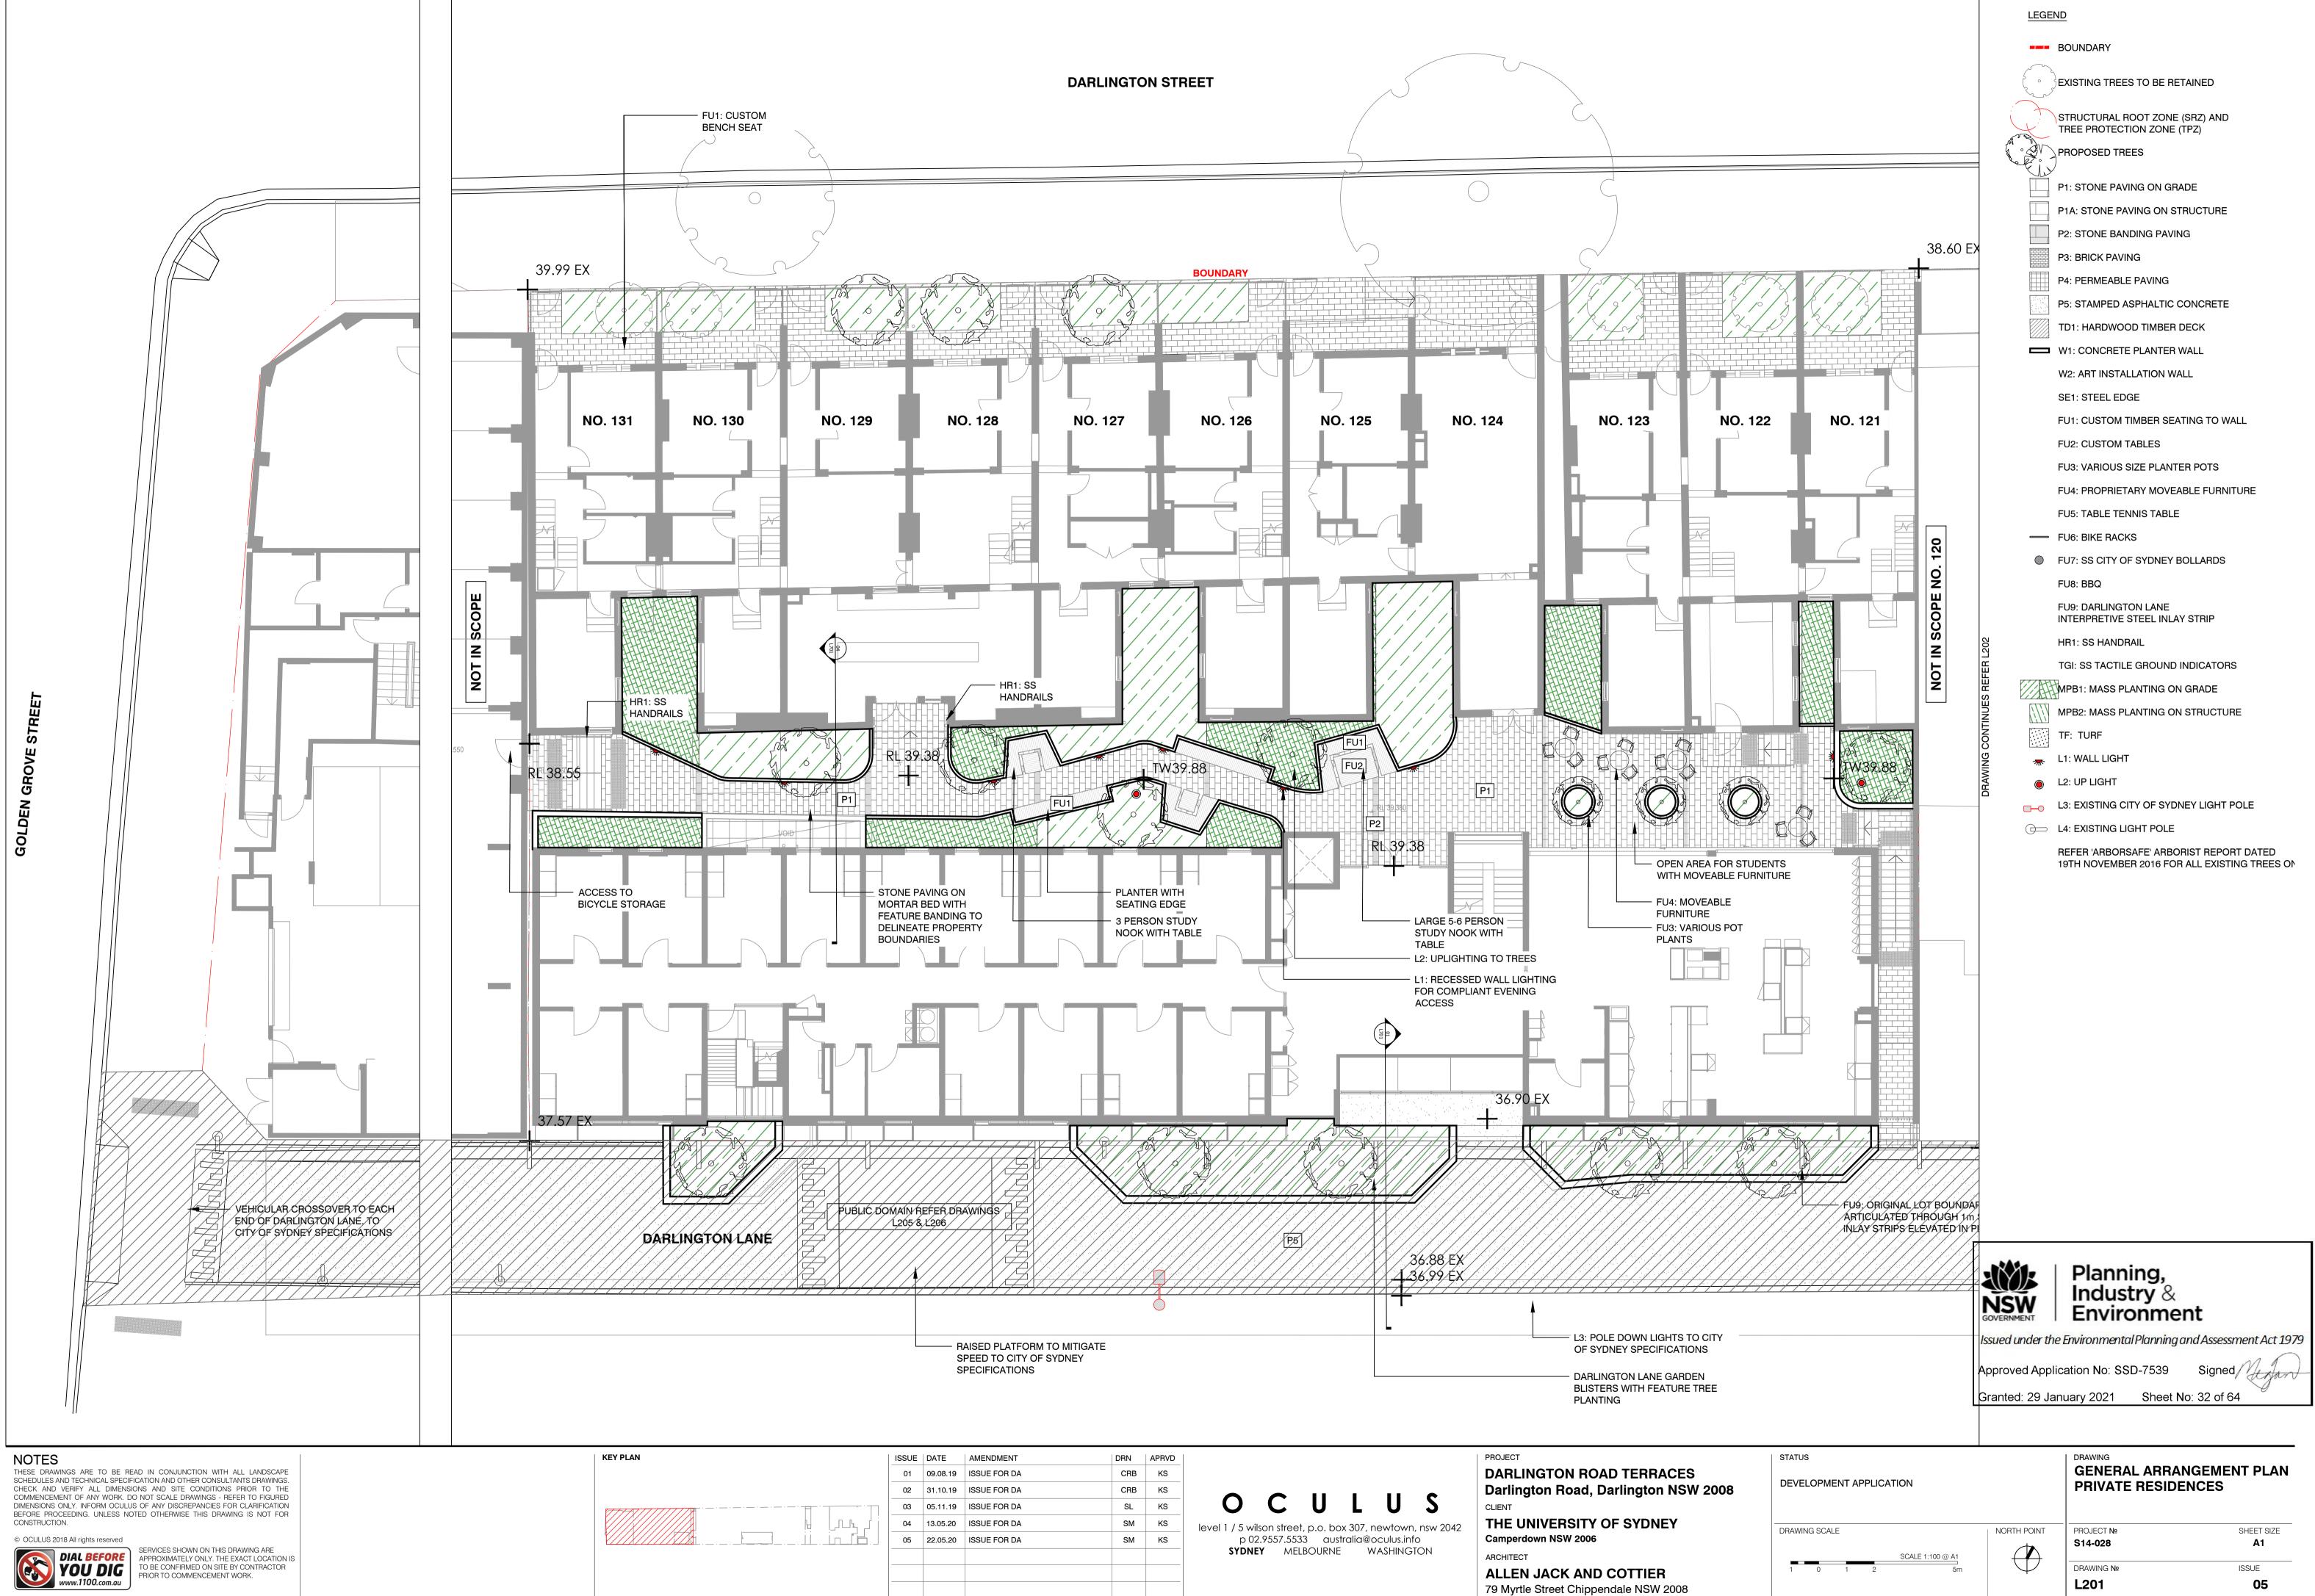ALLEN JACK AND COTTIER 79 Myrtle Street Chippendale NSW 2008

LEGEND

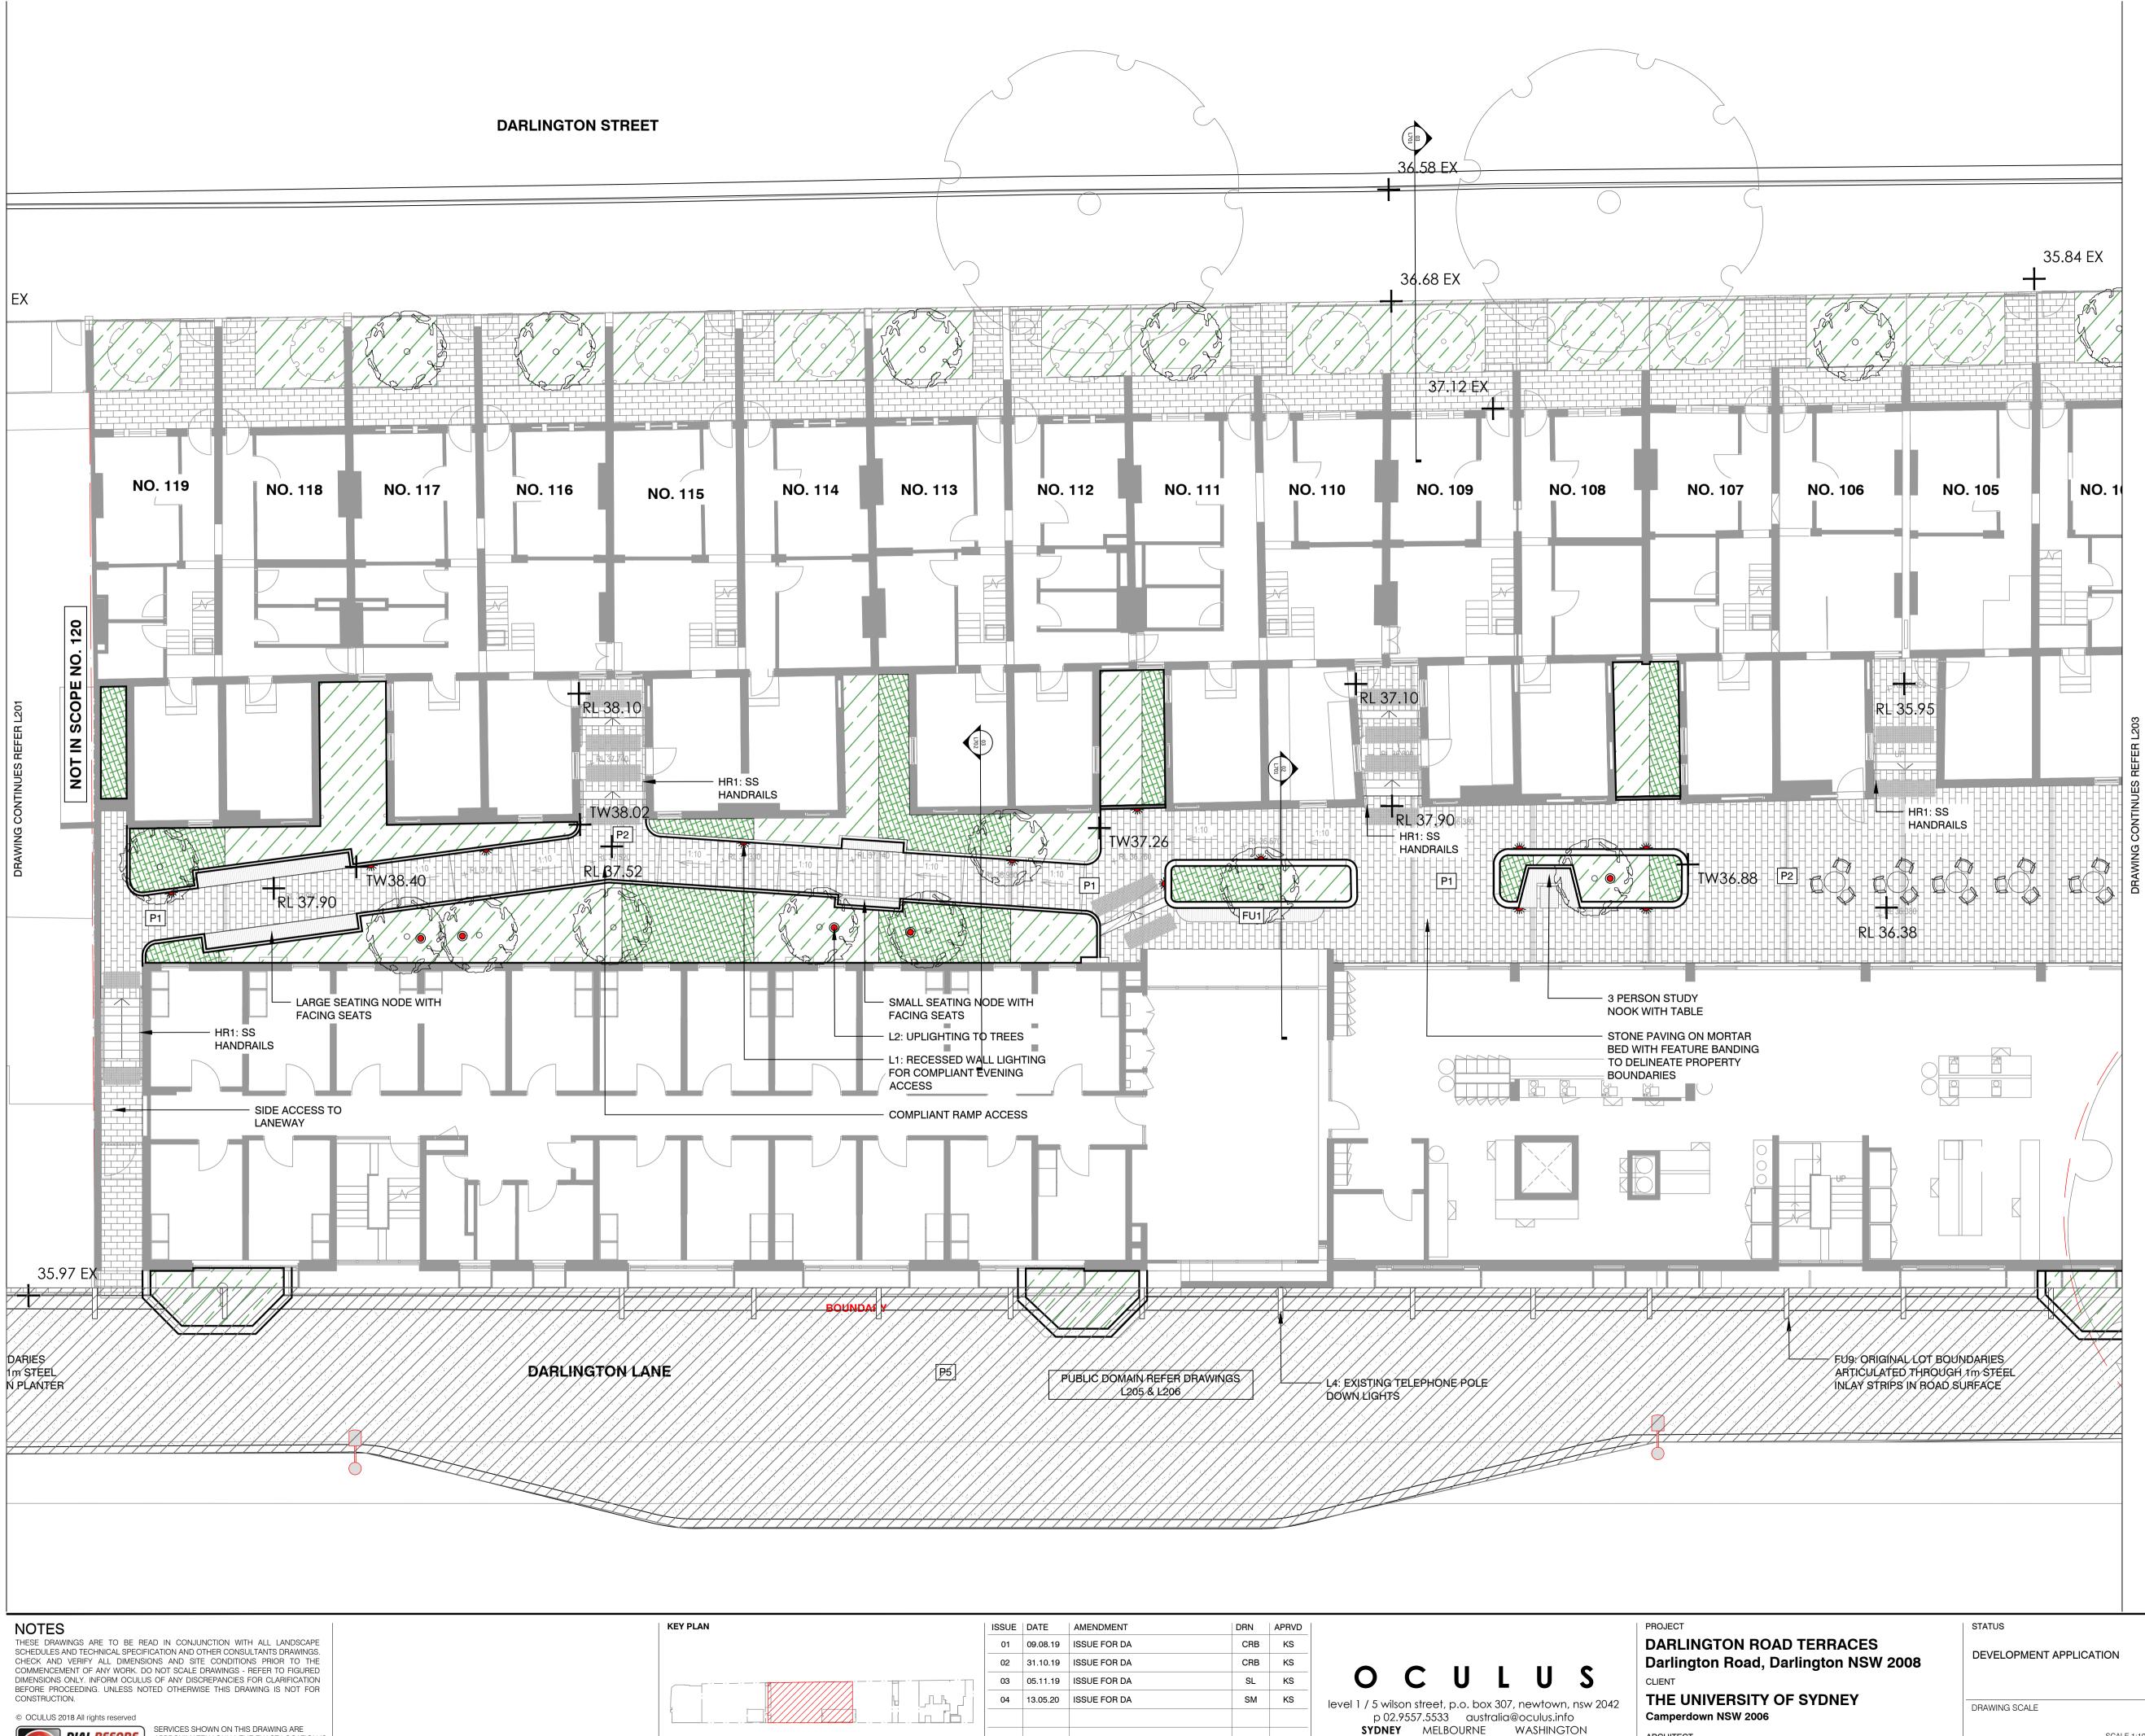BOUNDARY

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Lans Constant	SEXISTING TREES TO BE RETAINED
T.	STRUCTURAL ROOT ZONE (SRZ) AND TREE PROTECTION ZONE (TPZ)
	PROPOSED TREES
	P1: STONE PAVING ON GRADE
	P1A: STONE PAVING ON STRUCTURE
	P2: STONE BANDING PAVING
	P3: BRICK PAVING
	P4: PERMEABLE PAVING
	P5: STAMPED ASPHALTIC CONCRETE
	TD1: HARDWOOD TIMBER DECK
	W1: CONCRETE PLANTER WALL
	W2: ART INSTALLATION WALL
	SE1: STEEL EDGE
	FU1: CUSTOM TIMBER SEATING TO WALL
	FU2: CUSTOM TABLES
	FU3: VARIOUS SIZE PLANTER POTS
	FU4: PROPRIETARY MOVEABLE FURNITURE
	FU5: TABLE TENNIS TABLE
	FU6: BIKE RACKS
\bigcirc	FU7: SS CITY OF SYDNEY BOLLARDS
	FU8: BBQ
	FU9: DARLINGTON LANE INTERPRETIVE STEEL INLAY STRIP
	HR1: SS HANDRAIL
	TGI: SS TACTILE GROUND INDICATORS
	MPB1: MASS PLANTING ON GRADE
<i>[[]]</i>	MPB2: MASS PLANTING ON STRUCTURE
	TF: TURF
ѫ	L1: WALL LIGHT
۲	L2: UP LIGHT
	L3: EXISTING CITY OF SYDNEY LIGHT POLE
	L4: EXISTING LIGHT POLE

REFER 'ARBORSAFE' ARBORIST REPORT DATED 19TH NOVEMBER 2016 FOR ALL EXISTING TREES ON



Granted: 29 January 2021 Sheet No: 33 of 64

DRAWING GENERAL ARRANGEMENT PLAN PRIVATE RESIDENCES

				SCALE 1:100 @ A1
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S14-028 DRAWING № L202


PROJECT №

NORTH POINT

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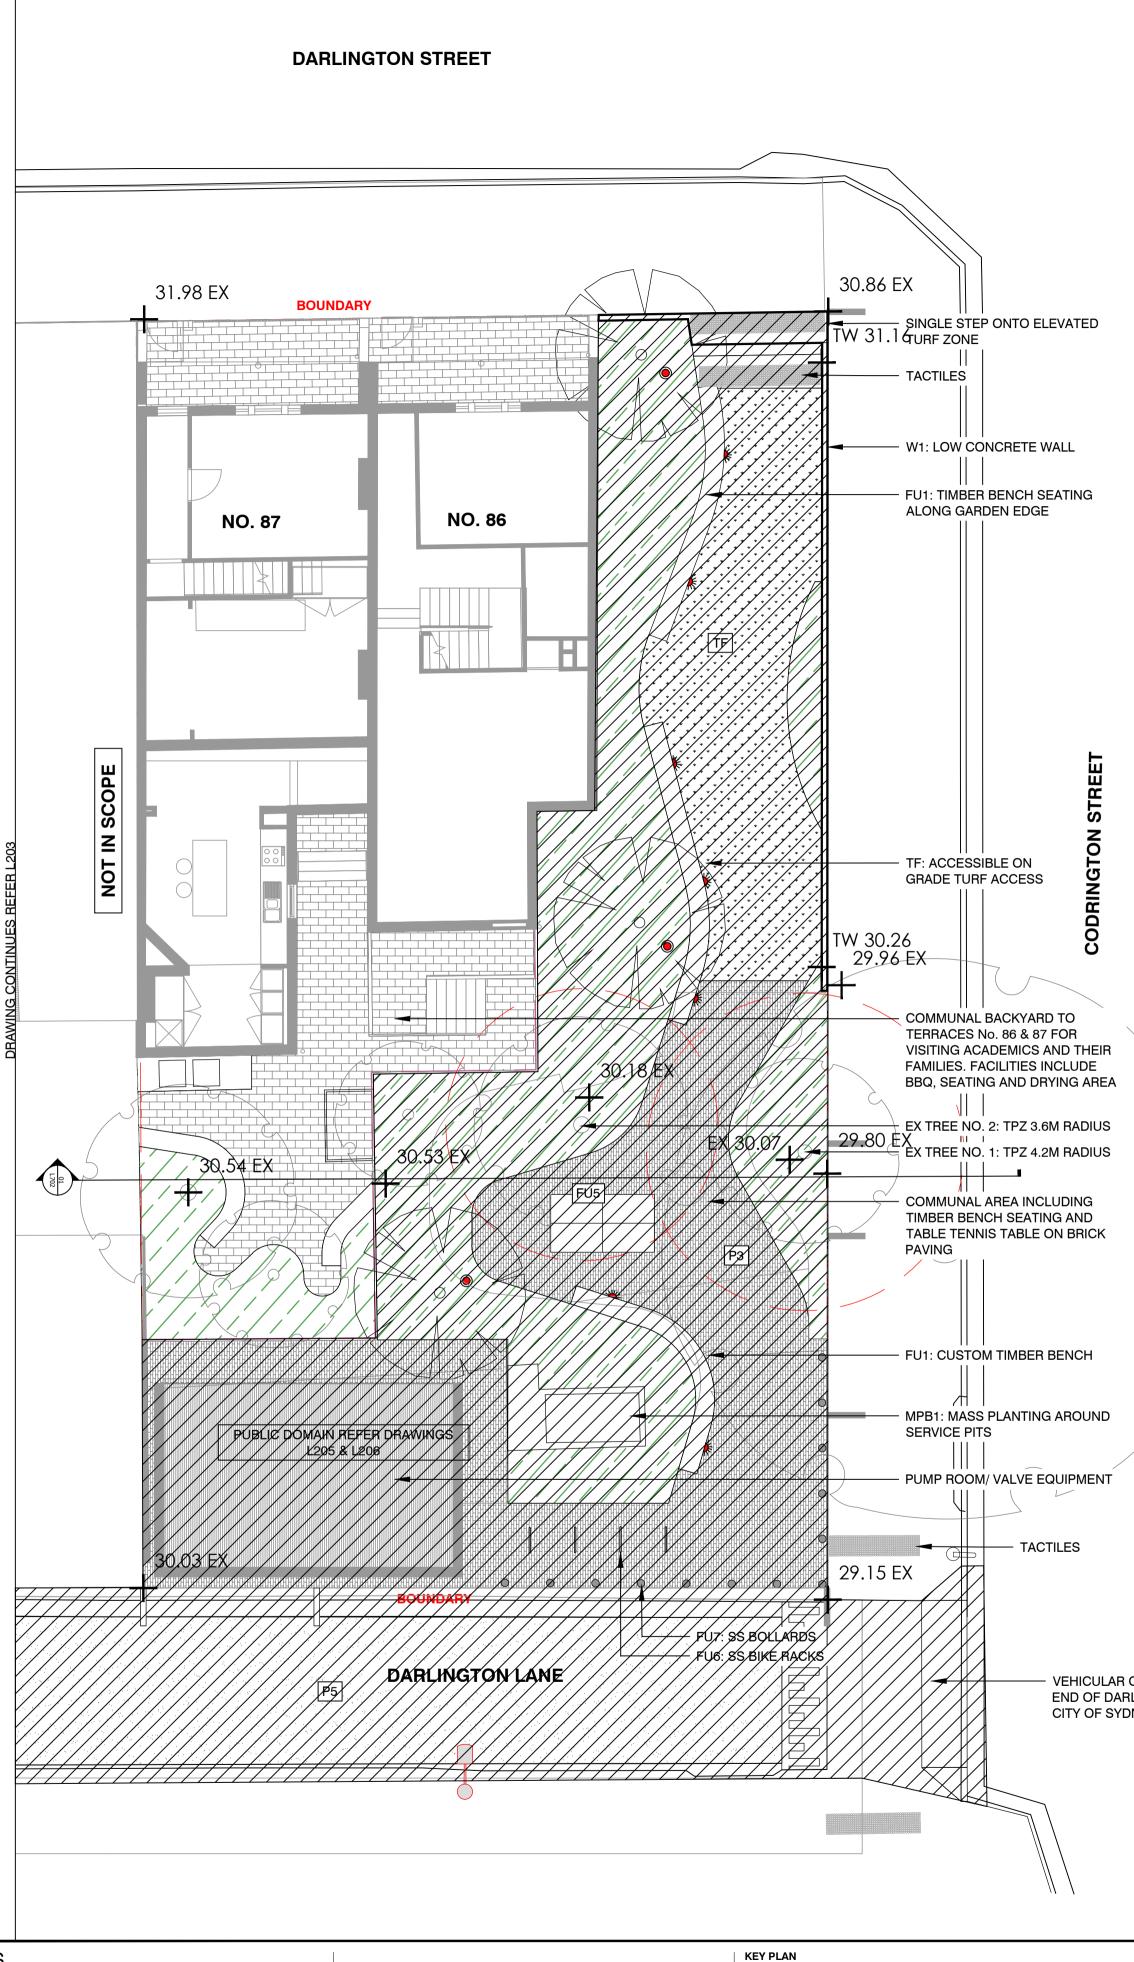
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ISSUE 04



CONSTRUCTION.

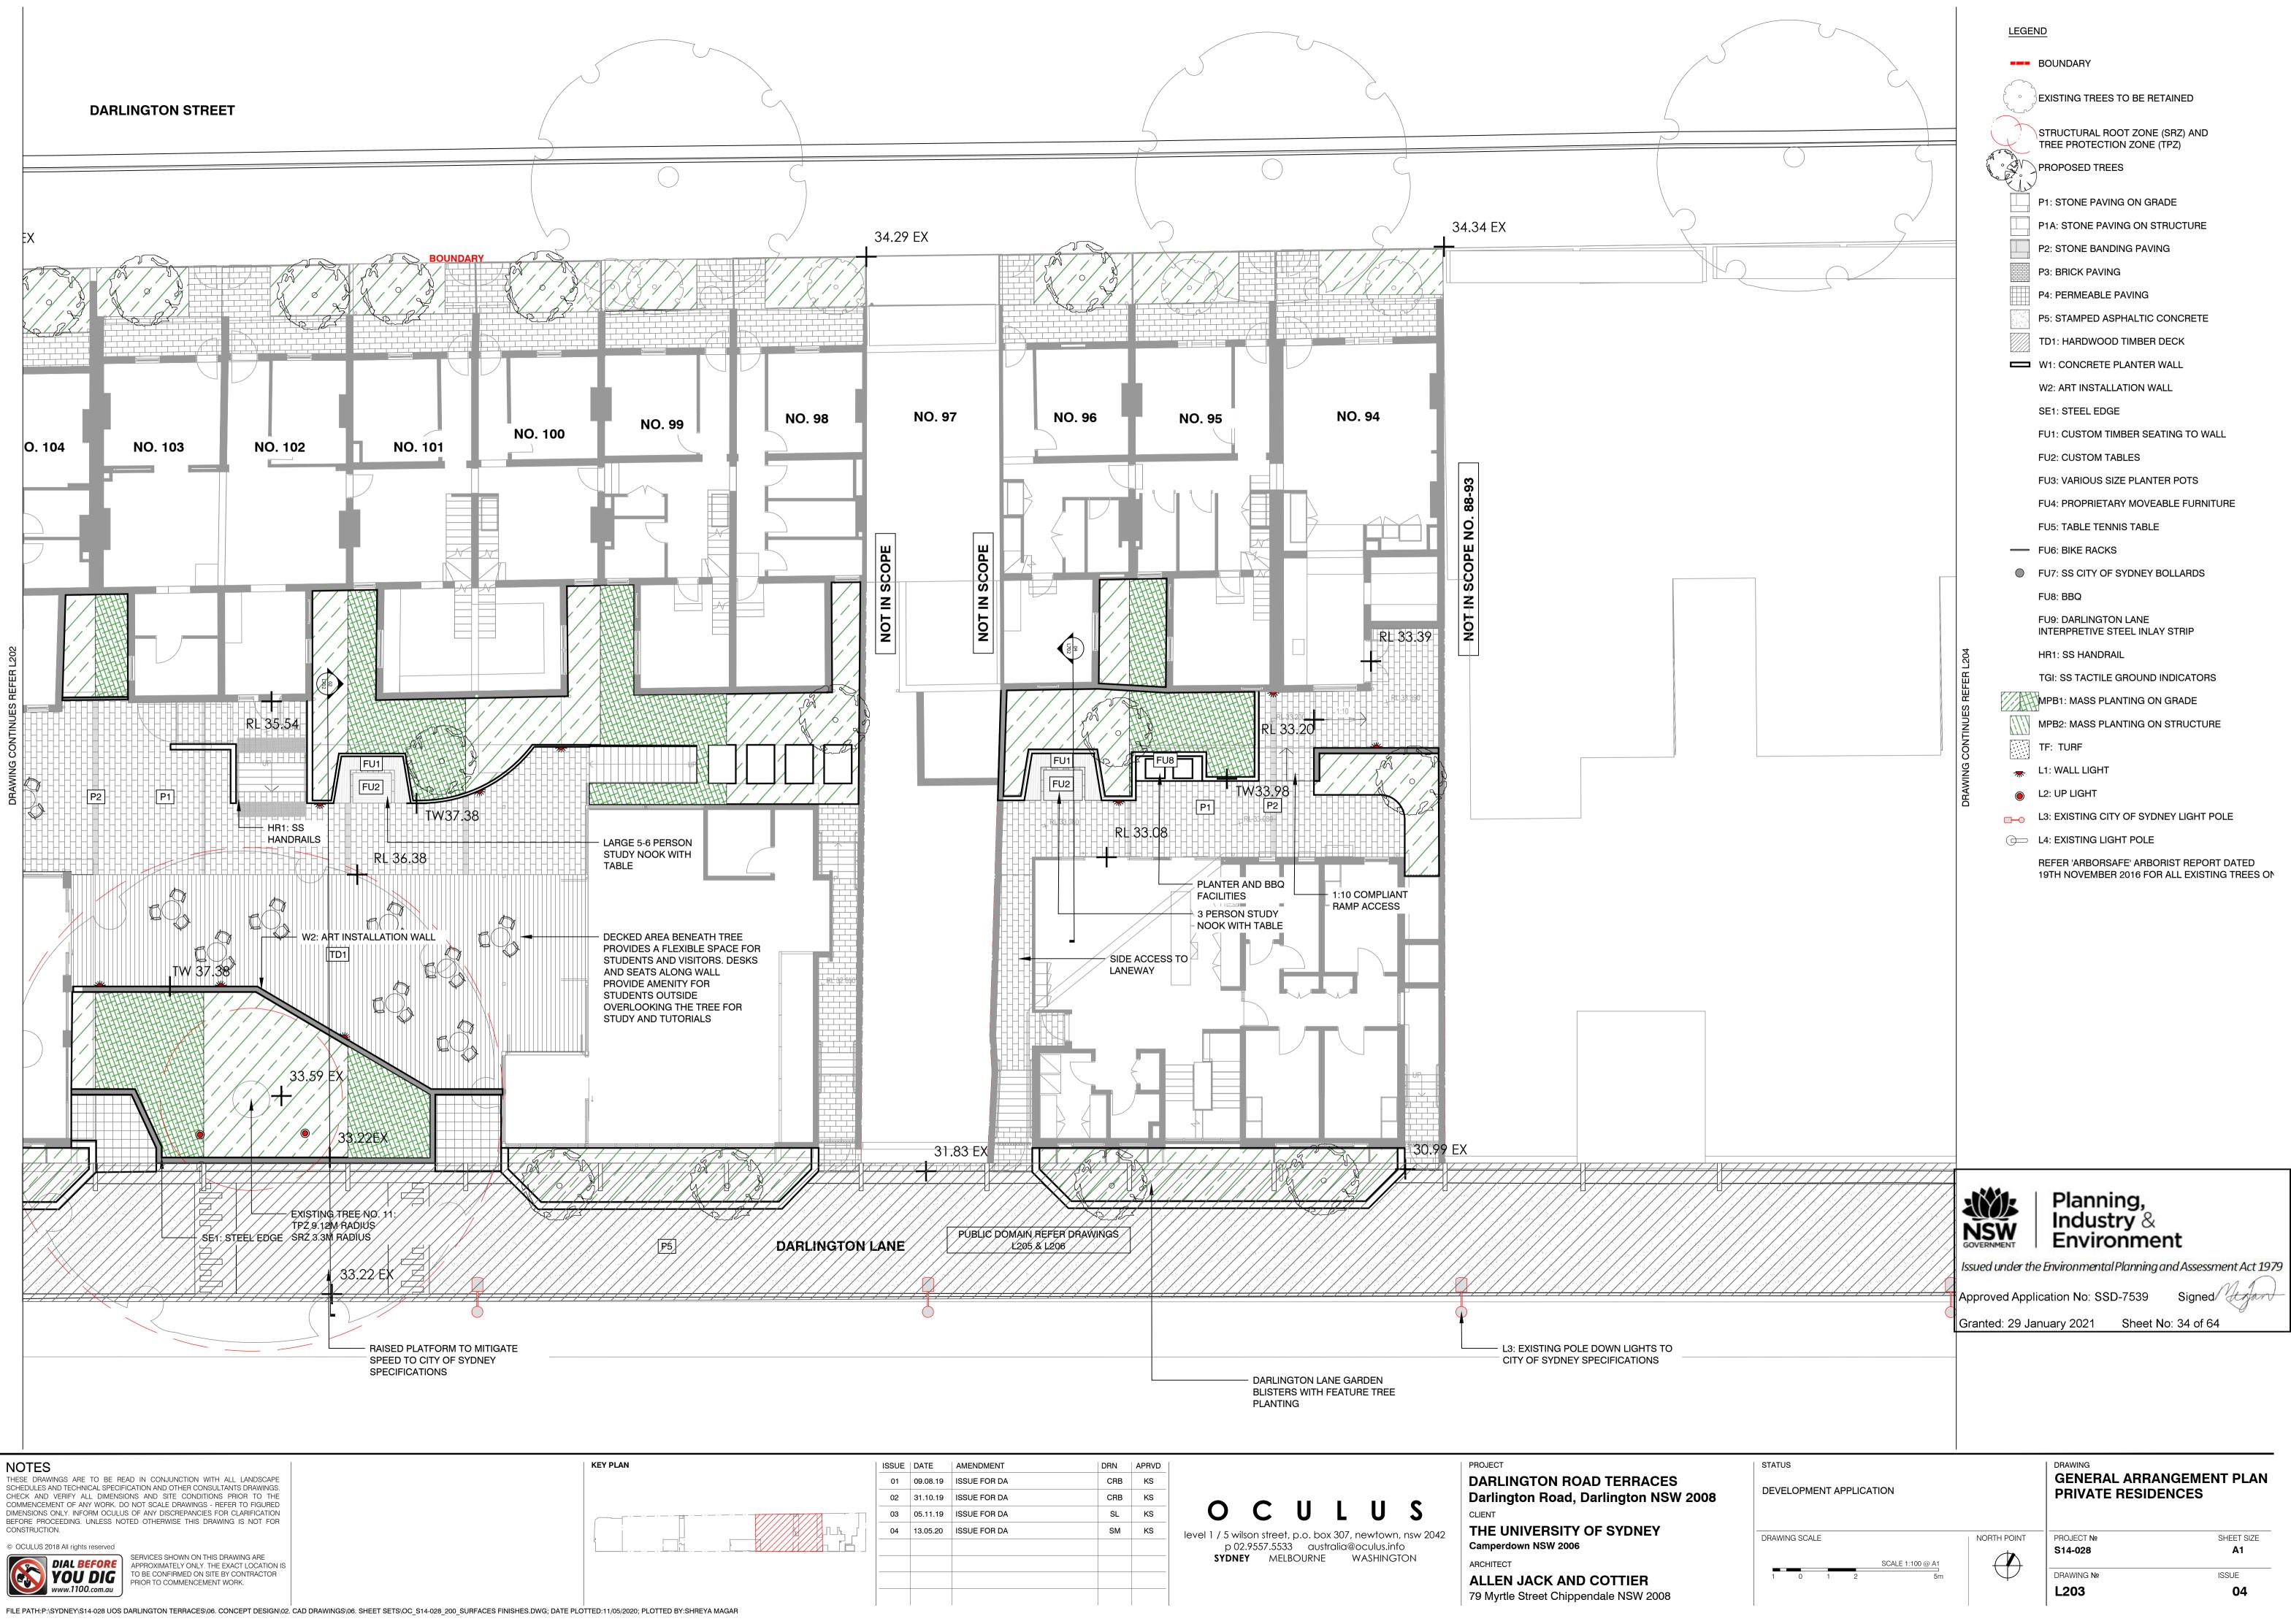




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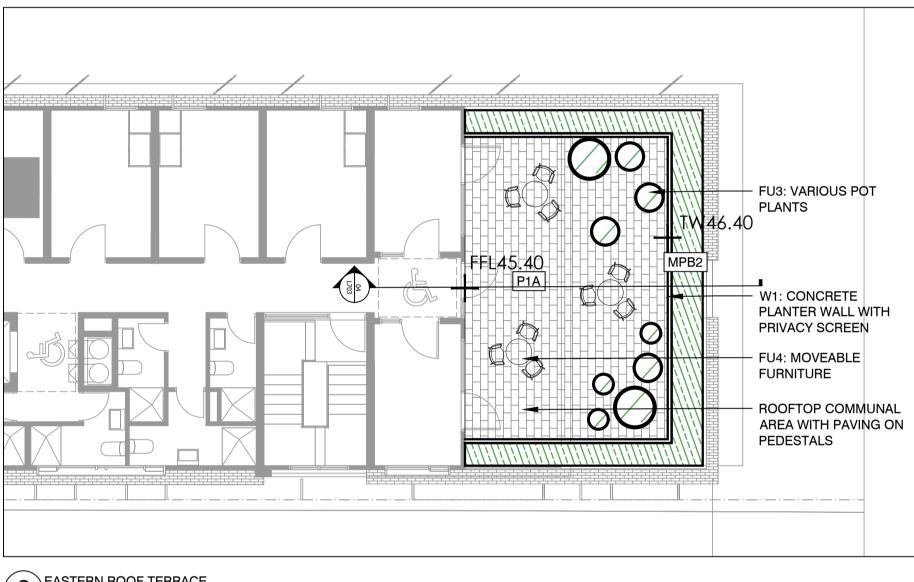
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2 EASTERN ROOF TERRACE SCALE 1:100

- VEHICULAR CROSSOVER TO EACH END OF DARLINGTON LANE. TO CITY OF SYDNEY SPECIFICATIONS

ISSUE	DATE	AMENDMENT	DRN	APRVD	PROJECT
01	09.08.19	ISSUE FOR DA	CRB	KS	DARLINGTON ROAD TERRACES
02	31.10.19	ISSUE FOR DA	CRB	KS	Darlington Road, Darlington NSW 2008
03	13.05.20	ISSUE FOR DA	SM	KS	

LEGEND

	BOUNDARY
	EXISTING TREES TO BE RETAINED
	STRUCTURAL ROOT ZONE (SRZ) AND TREE PROTECTION ZONE (TPZ)
	PROPOSED TREES
	P1: STONE PAVING ON GRADE
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	P5: STAMPED ASPHALTIC CONCRETE
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	W2: ART INSTALLATION WALL
	SE1: STEEL EDGE
	FU1: CUSTOM TIMBER SEATING TO WALL
	FU2: CUSTOM TABLES
	FU3: VARIOUS SIZE PLANTER POTS
	FU4: PROPRIETARY MOVEABLE FURNITURE
	FU5: TABLE TENNIS TABLE
	FU6: BIKE RACKS
\bigcirc	FU7: SS CITY OF SYDNEY BOLLARDS
	FU8: BBQ
	FU9: DARLINGTON LANE INTERPRETIVE STEEL INLAY STRIP
	HR1: SS HANDRAIL
	TGI: SS TACTILE GROUND INDICATORS
	MPB1: MASS PLANTING ON GRADE
	MPB2: MASS PLANTING ON STRUCTURE
	TF: TURF
*	L1: WALL LIGHT
۲	L2: UP LIGHT
	L3: EXISTING CITY OF SYDNEY LIGHT POLE
	REFER 'ARBORSAFE' ARBORIST REPORT DATED 19TH NOVEMBER 2016 FOR ALL EXISTING TREES ON

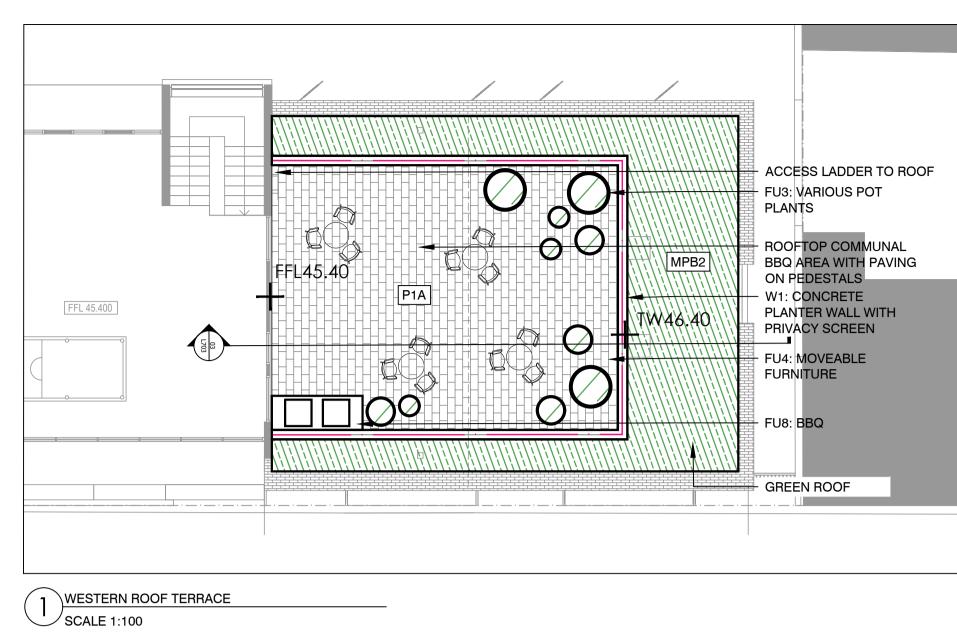



Issued under the Environmental Planning and Assessment Act 1979

Approved Application No: SSD-7539

Granted: 29 January 2021 Sheet No: 35 of 64

DRAWING GENERAL ARRANGEMENT PLAN

Signed /

DEVELOPMENT APPLICATION

DRAWING SCALE

STATUS

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NORTH POINT
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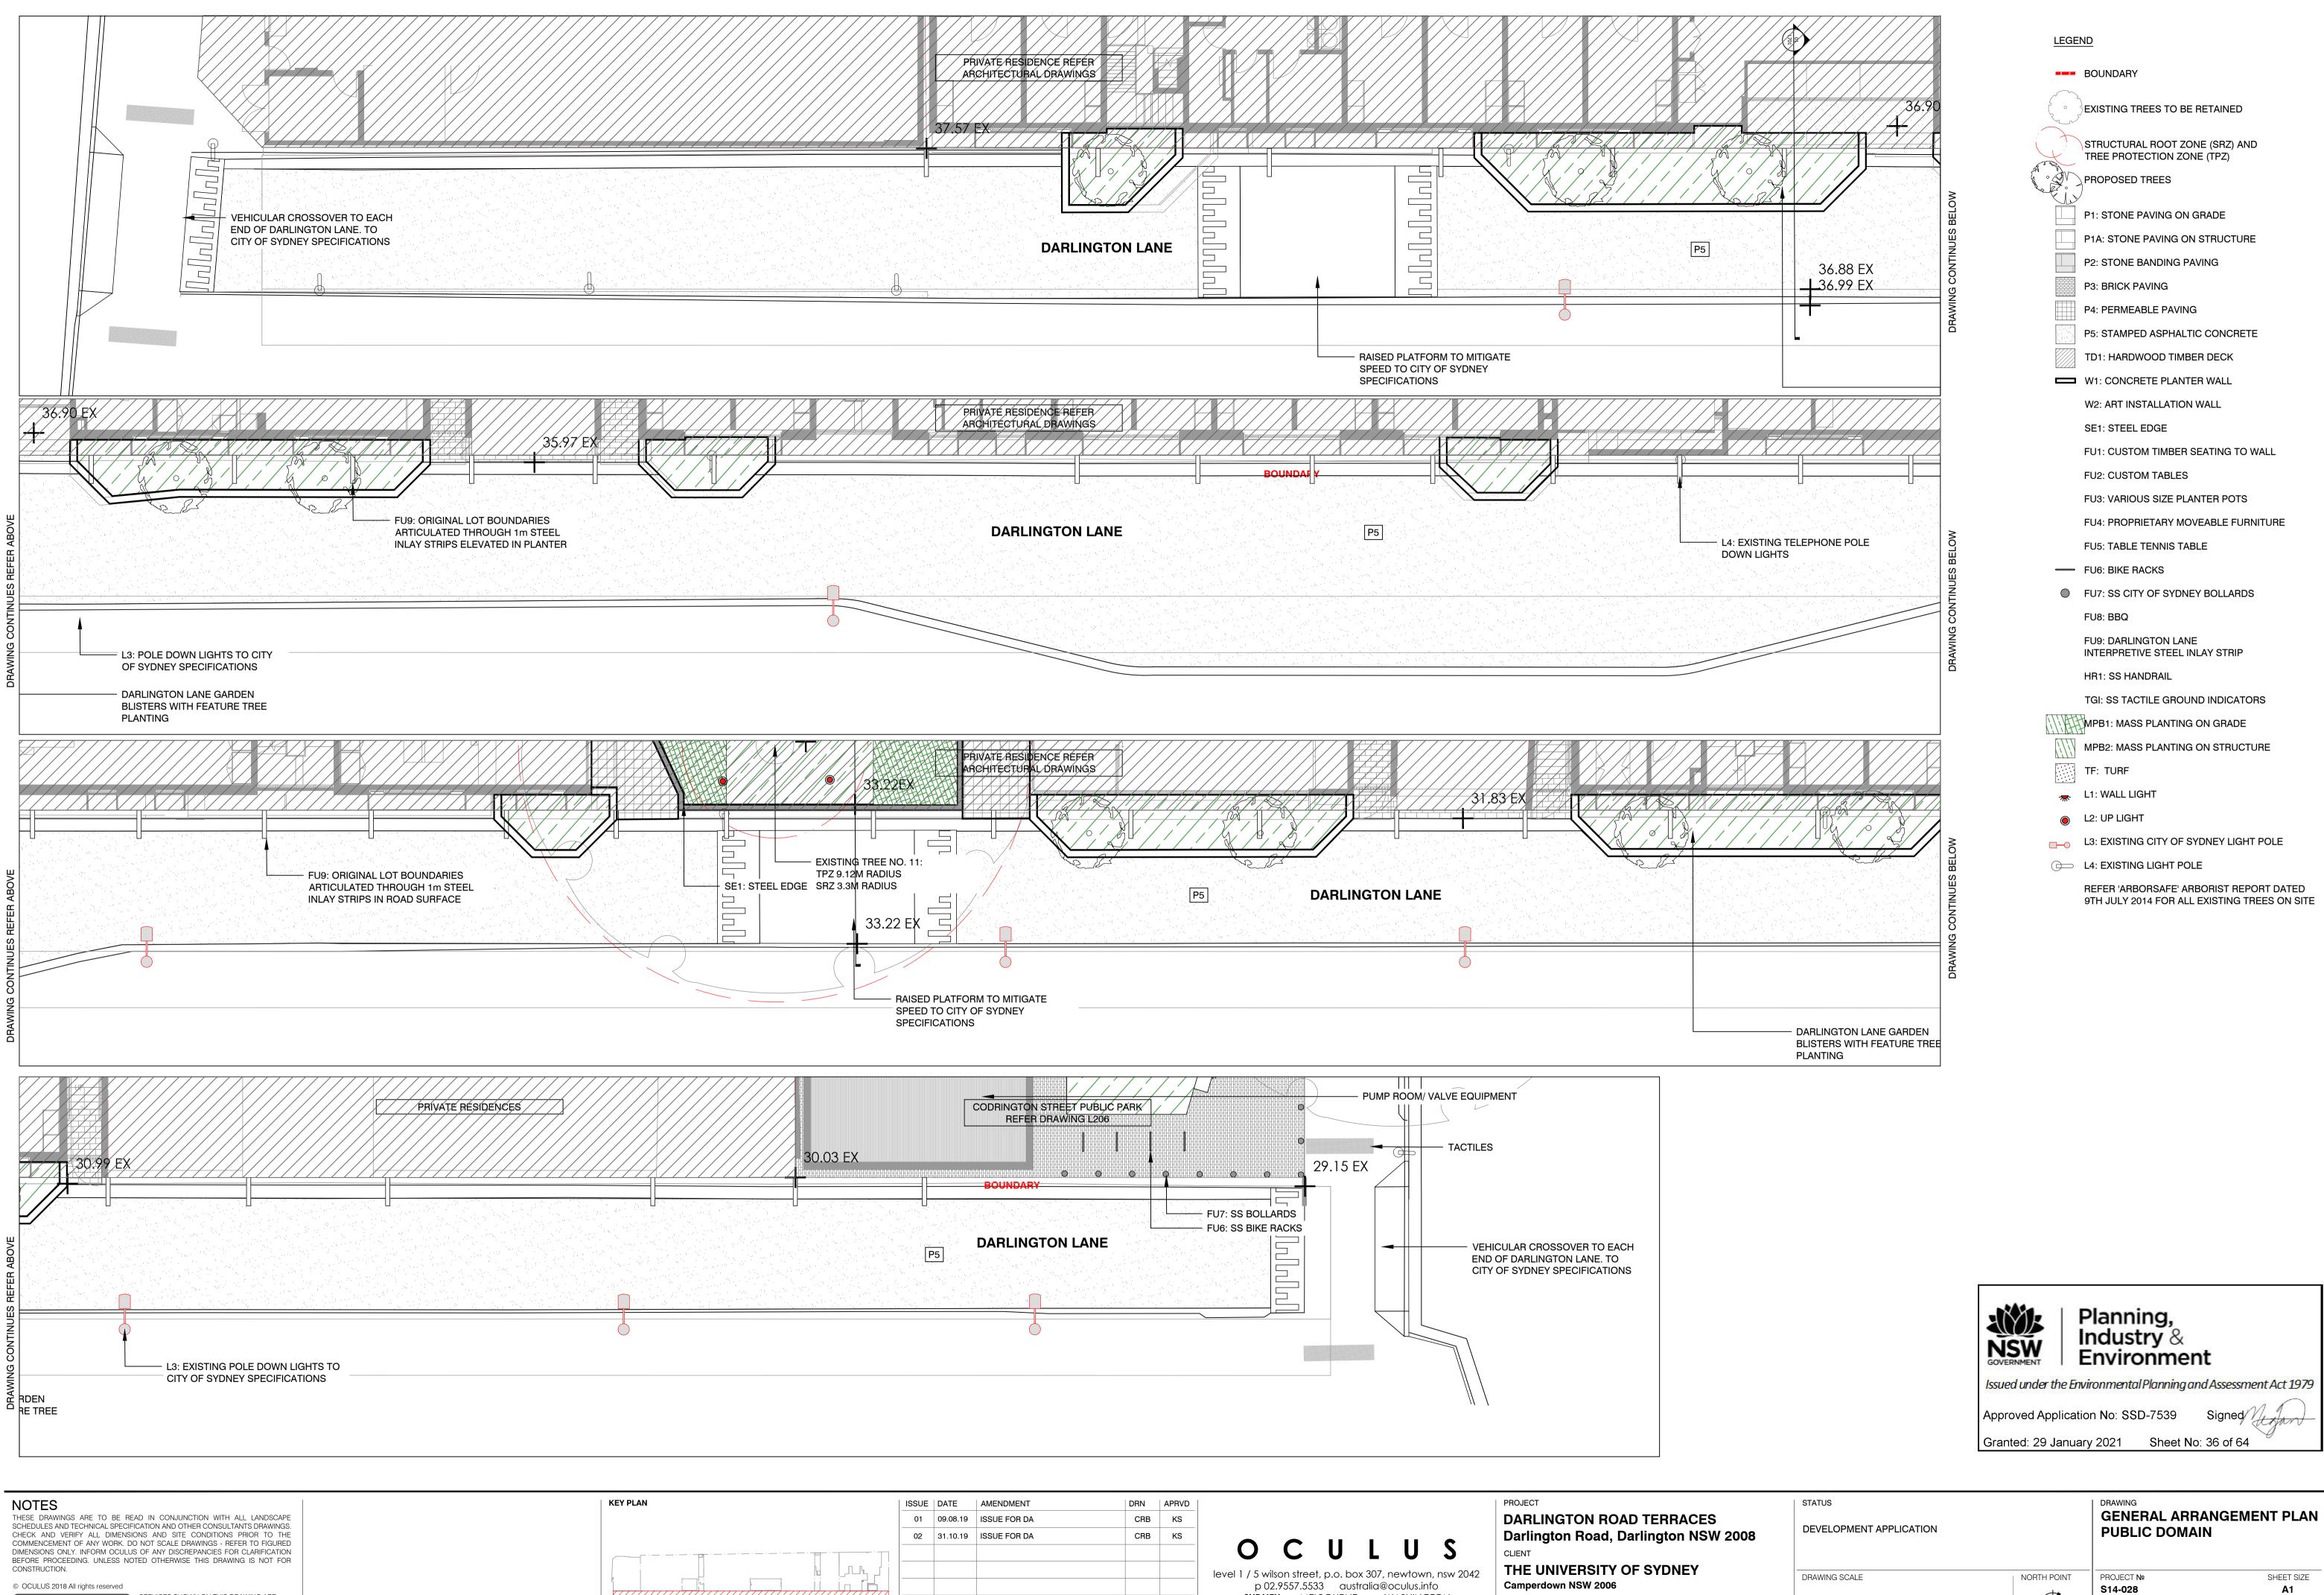
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DRAWING № L204

S14-028



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ALLEN JACK AND COTTIER 79 Myrtle Street Chippendale NSW 2008

BOUNDARY
EXISTING TREES TO BE RETAINED
STRUCTURAL ROOT ZONE (SRZ) AND TREE PROTECTION ZONE (TPZ)
PROPOSED TREES
P1: STONE PAVING ON GRADE
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FU8: BBQ
FU9: DARLINGTON LANE INTERPRETIVE STEEL INLAY STRIP
HR1: SS HANDRAIL
TGI: SS TACTILE GROUND INDICATORS
MPB1: MASS PLANTING ON GRADE
MPB2: MASS PLANTING ON STRUCTURE
TF: TURF
L1: WALL LIGHT
L2: UP LIGHT
L3: EXISTING CITY OF SYDNEY LIGHT POLE
REFER 'ARBORSAFE' ARBORIST REPORT DATE 9TH JULY 2014 FOR ALL EXISTING TREES ON S


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ISSUE 02



NOTES

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	ISSUE	DATE	AMENDMENT	DRN	APRVD	PROJECT
	01	09.08.19	ISSUE FOR DA	CRB	KS	DARLINGTON ROAD TERRACES
	02	31.10.19	ISSUE FOR DA	CRB	KS	Darlington Road, Darlington NSW 2008
						OCULUS CLIENT
						level 1 / 5 wilson street, p.o. box 307, newtown, nsw 2042 THE UNIVERSITY OF SYDNEY
						p 02.9557.5533 australia@oculus.info Camperdown NSW 2006
						SYDNEY MELBOURNE WASHINGTON ARCHITECT
						ALLEN JACK AND COTTIER
						79 Myrtle Street Chippendale NSW 2008


LEGEND

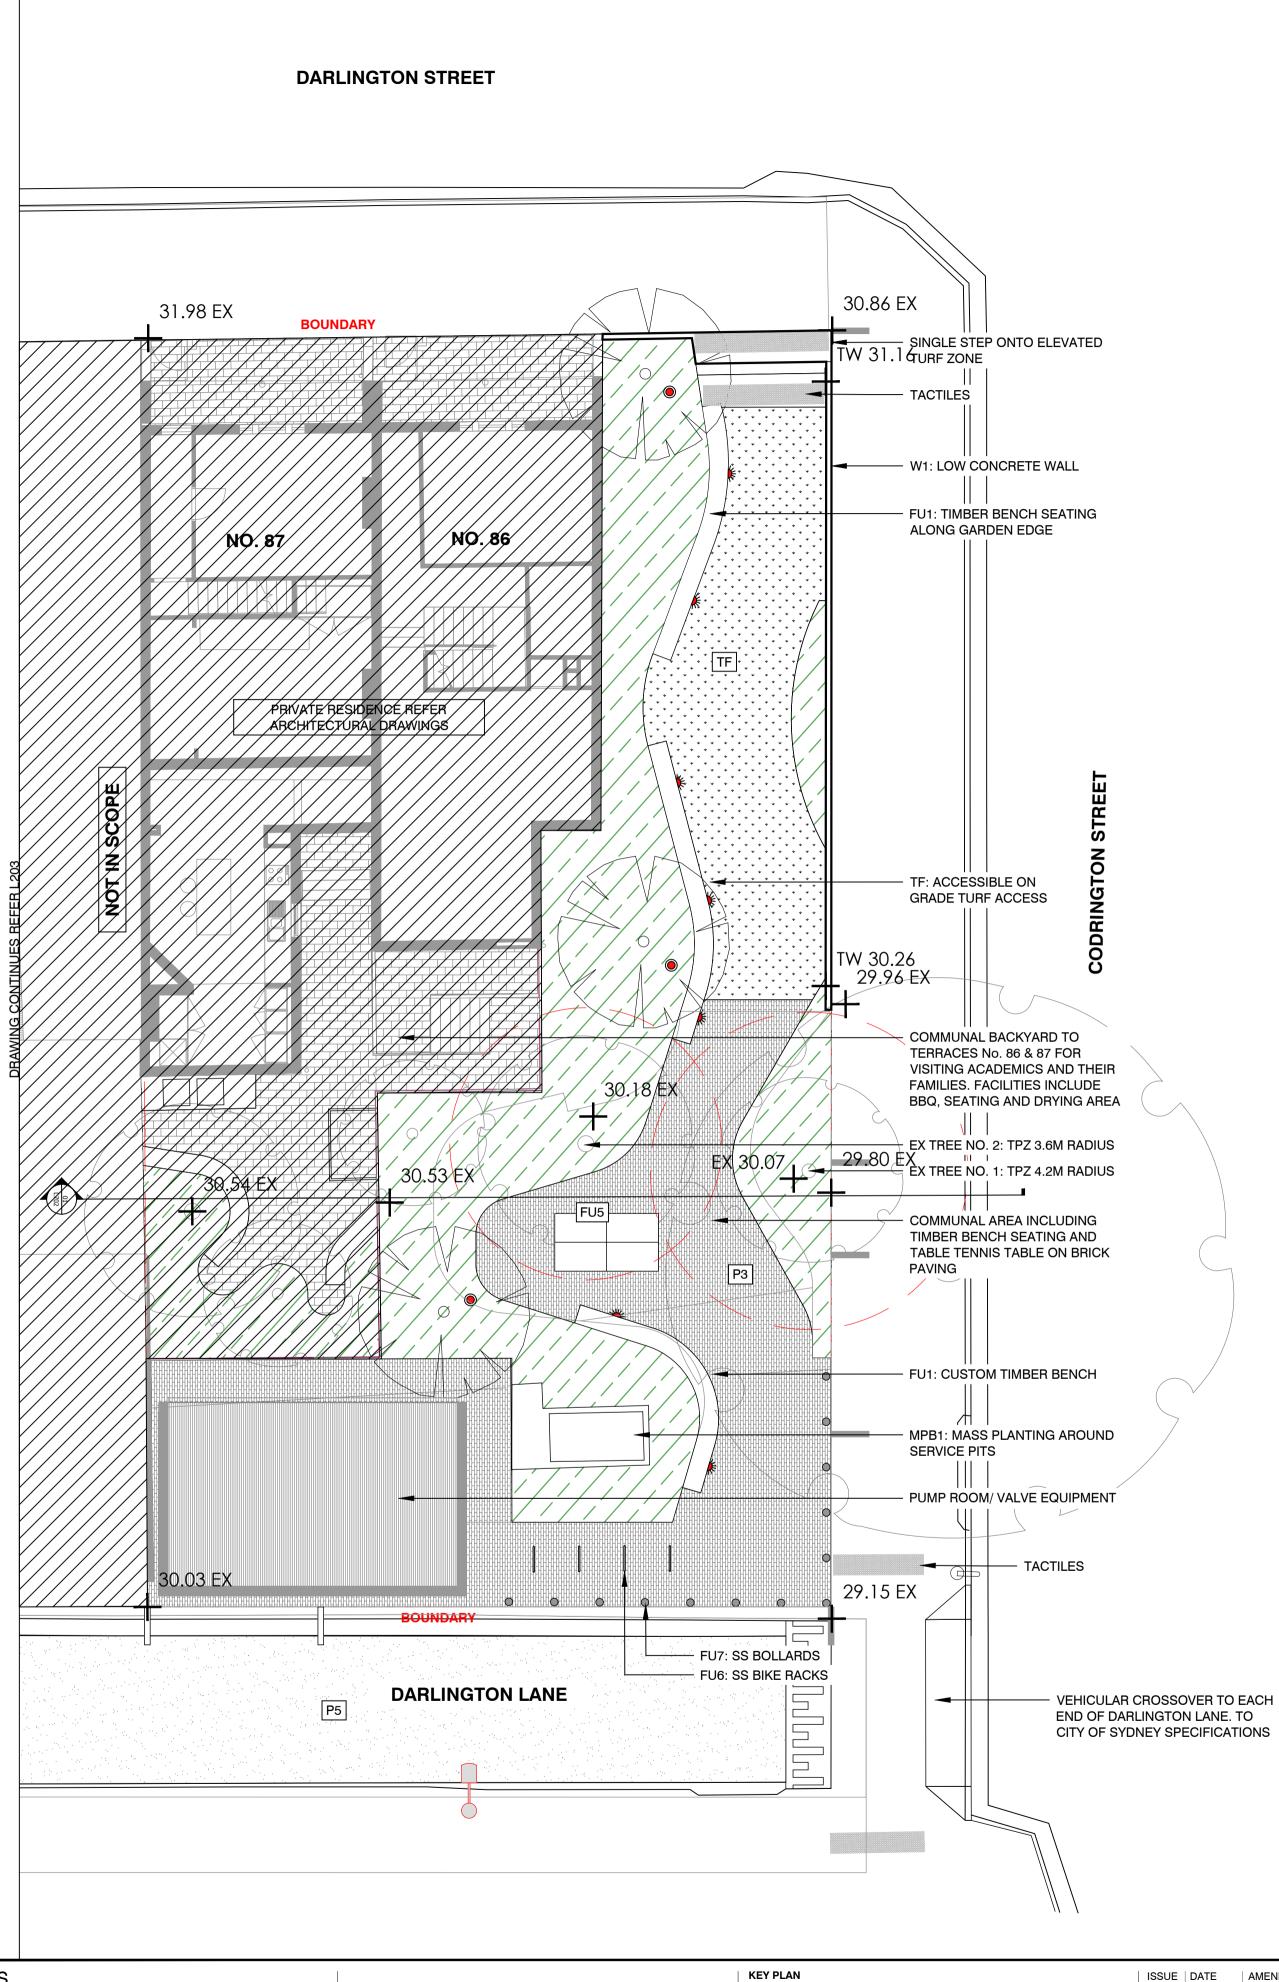	BOUNDARY
en e	EXISTING TREES TO BE RETAINED
	STRUCTURAL ROOT ZONE (SRZ) AND TREE PROTECTION ZONE (TPZ)
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	L4: EXISTING LIGHT POLE
	REFER 'ARBORSAFE' ARBORIST REPORT DATE

REFER 'ARBORSAFE' ARBORIST REPORT DATED 9TH JULY 2014 FOR ALL EXISTING TREES ON SITE



STATUS DEVELOPMENT APPLICATION	DRAWING GENERAL ARRANGEMENT PLAN PUBLIC DOMAIN		
DRAWING SCALE	NORTH POINT	PROJECT №	SHEET SIZE
SCALE 1:100 @ A1		S14-028	A1
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	ISSUE	DATE	AMENDMENT	DRN	APRVD
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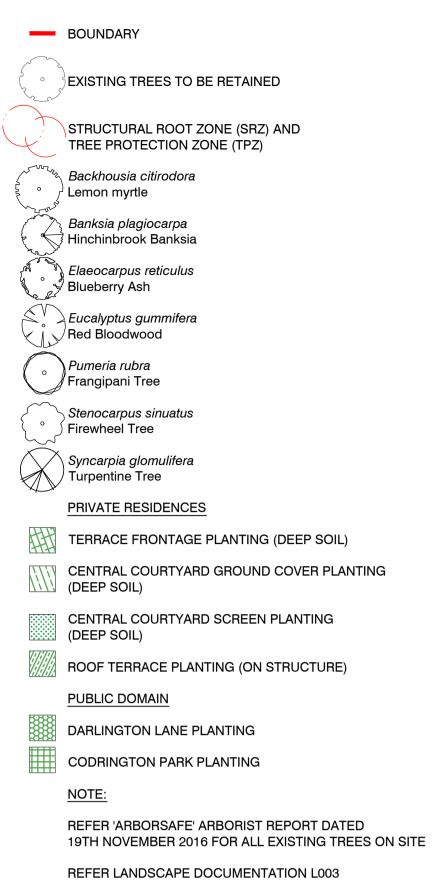
p 02.9557.5533 australia@oculus.info SYDNEY MELBOURNE WASHINGTON

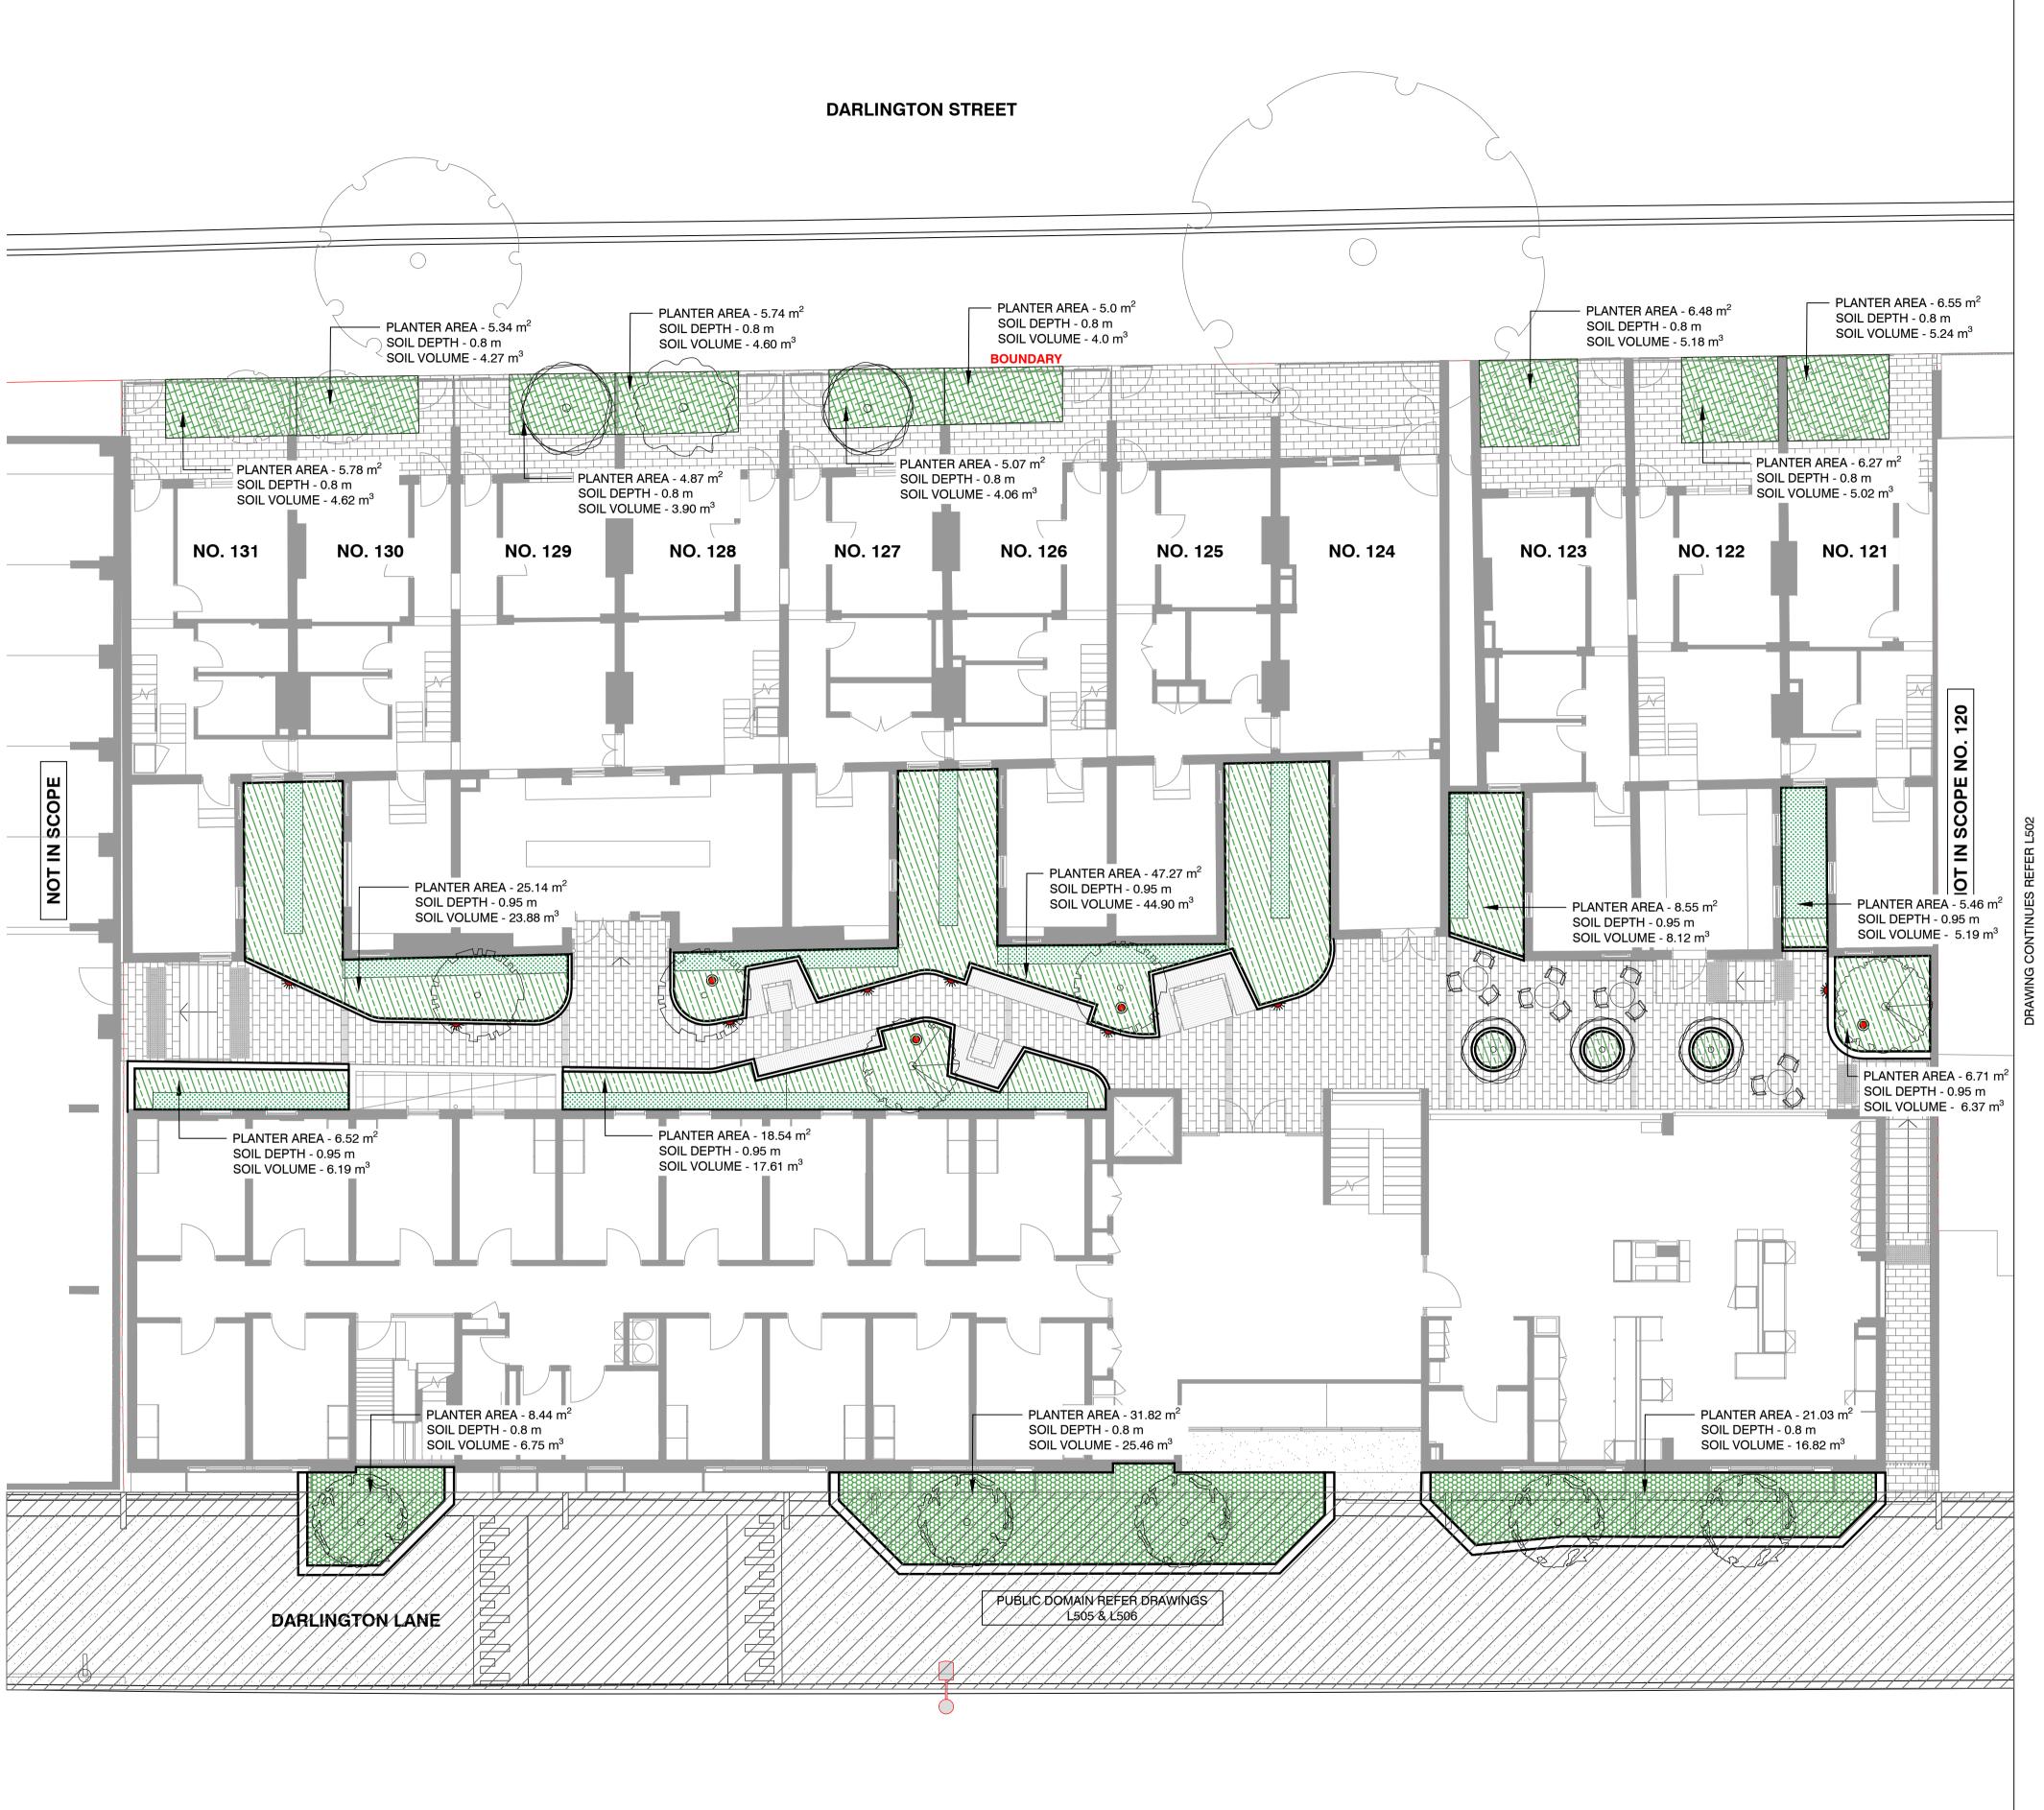PROJECT DARLINGTON ROAD TERRACES Darlington Road, Darlington NSW 2008 CLIENT

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ALLEN JACK AND COTTIER 79 Myrtle Street Chippendale NSW 2008

LEGEND



FOR PLANT SPECIES



NORTH POINT

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Planning, Industry & Environment

Issued under the Environmental Planning and Assessment Act 1979 Signed / Jun Approved Application No: SSD-7539 Granted: 29 January 2021 Sheet No: 38 of 64

DRAWING PLANTING PLAN PRIVATE RESIDENCES

DEVELOPMENT APPLICATION

DRAWING SCALE

STATUS

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S14-028 DRAWING № L501

PROJECT №

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ISSUE 05



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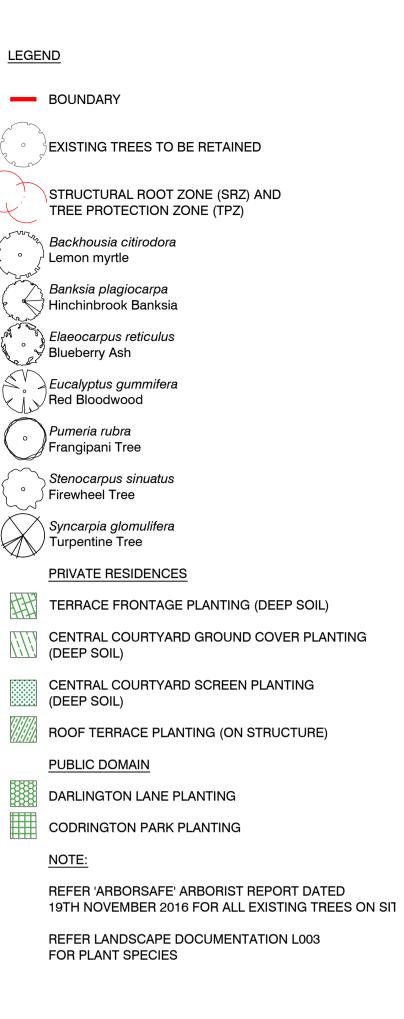
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ALLEN JACK AND COTTIER 79 Myrtle Street Chippendale NSW 2008







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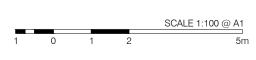
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Granted: 29 January 2021 Sheet No: 39 of 64

NORTH POINT

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DRAWING SCALE



DRAWING PLANTING PLAN **PRIVATE RESIDENCES**

SHEET SIZE A1

DRAWING № L502

PROJECT №

S14-028



NOTES

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KEY PLAN

	ISSUE	DATE	AMENDMENT	DRN	APRVD	
	01	09.08.19	ISSUE FOR DA	CRB	KS	
	02	31.10.19	ISSUE FOR DA	CRB	KS	
	03	05.11.19	ISSUE FOR DA	SL	KS	O C U L U S
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						p 02.9557.5533 australia@oculus.info
						SYDNEY MELBOURNE WASHINGTON




PROJECT DARLINGTON ROAD TERRACES Darlington Road, Darlington NSW 2008 CLIENT

THE UNIVERSITY OF SYDNEY Camperdown NSW 2006 ARCHITECT

ALLEN JACK AND COTTIER 79 Myrtle Street Chippendale NSW 2008

	NUNDARY ISTING TREES TO BE RETAINED ISTING TREES TO BE RETAINED RUCTURAL ROOT ZONE (SR2) AND EE PROTECTION ZONE (TPZ) ckhousia citirodora mon myrtle nksia plagiocarpa tochinbrook Banksia teocarpus reticulus teberry Ash calyptus gummifera d Bloodwood meria rubra ungipani Tree procarpus sinuatus ewheel Tree ncarpia glomulifera rpentine Tree IVATE RESIDENCES RRACE FRONTAGE PLANTING (DEEP INTRAL COURTYARD GROUND COVE EEP SOIL) OF TERRACE PLANTING (ON STRUC) BLIC DOMAIN RLINGTON LANE PLANTING DDRINGTON PARK PLANTING DTE: FER YABBORSAFE' ARBORIST REPOR TH NOVEMBER 2016 FOR ALL EXISTIN FER LANDSCAPE DOCUMENTATION R PLANT SPECIES	R PLANTING ING TURE) T DATED
	Dlanning	
	Planning, Industry & Environmental Planning and Assess ation No: SSD-7539 Signed uary 2021 Sheet No: 40 of 6	Megan
	DRAWING PLANTING PLAN PRIVATE RESIDENCES	
DRAWING SCALE SCALE 1:100 @ A1 1 0 1 2 5m	PROJECT № S14-028 DRAWING № L503	SHEET SIZE A1 ISSUE 04

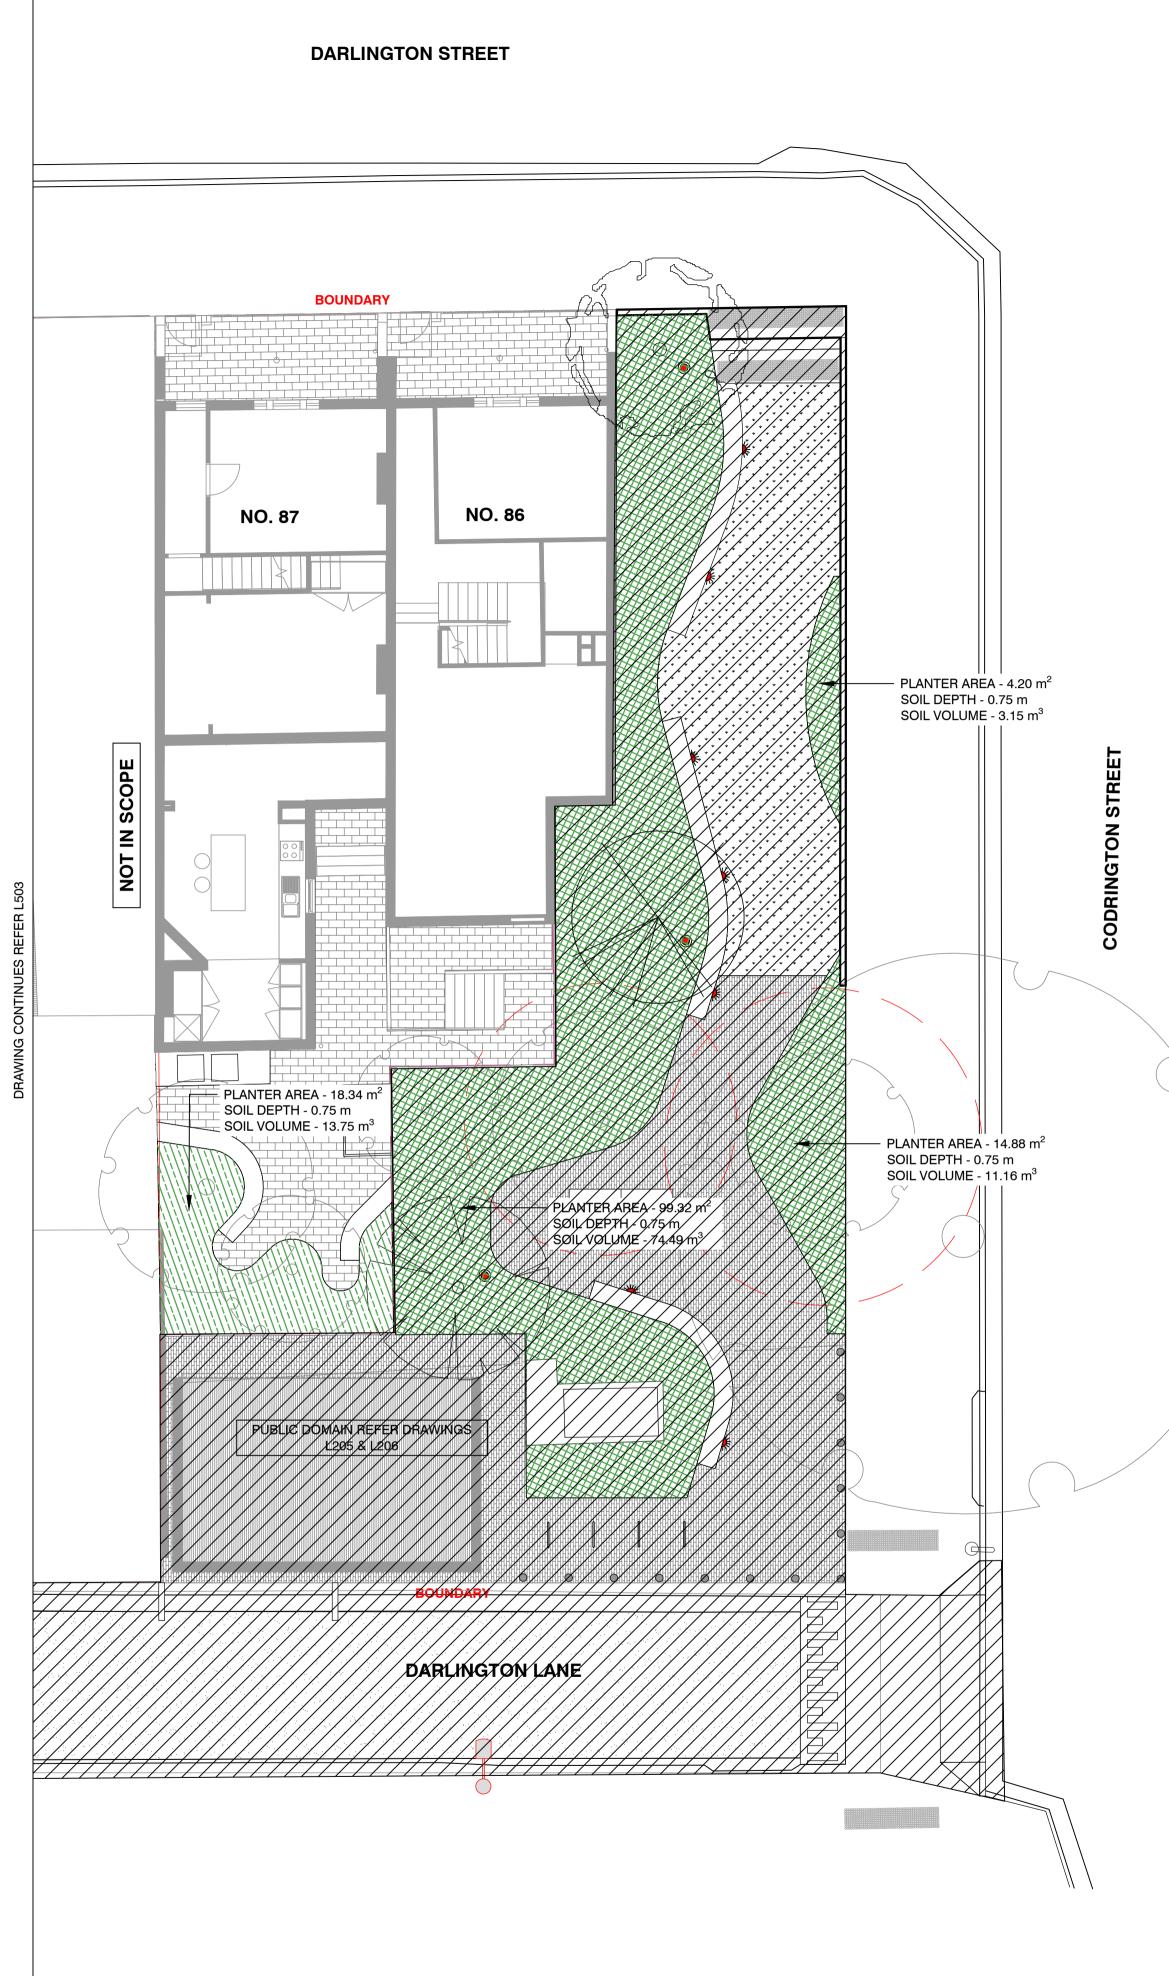


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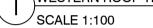
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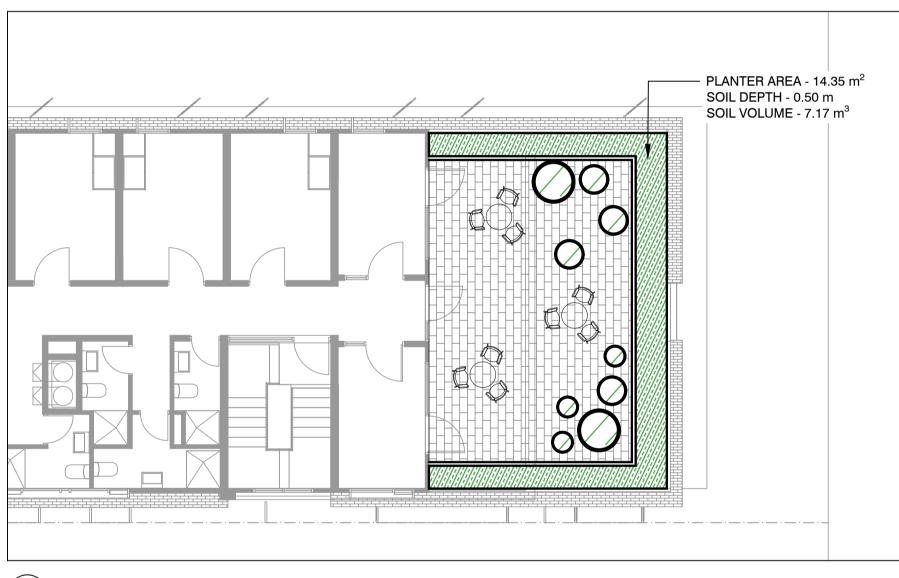


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KEY PLAN





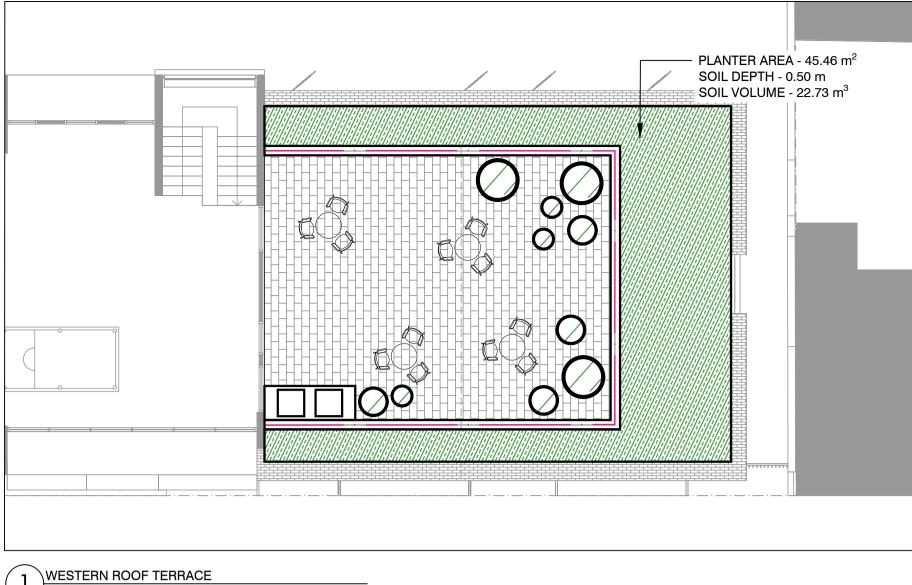

2 EASTERN ROOF TERRACE SCALE 1:100

ISSUE 01 02 03	DATE 09.08.19 31.10.19 12.05.20	AMENDMENT ISSUE FOR DA ISSUE FOR DA ISSUE FOR DA	DRN CRB CRB SM	APRVD KS KS KS	OCULUS S level 1 / 5 wilson street, p.o. box 307, newtown, nsw 2042 p 02.9557.5533 australia@oculus.info SYDNEY MELBOURNE WASHINGTON
					ALLEN JACK AND COTTIER 79 Myrtle Street Chippendale NSW 2008

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LEGEND

_	BOUNDARY
Lo co co	EXISTING TREES TO BE RETAINED
t.	STRUCTURAL ROOT ZONE (SRZ) AND TREE PROTECTION ZONE (TPZ)
A CONTRACTOR	<i>Backhousia citirodora</i> Lemon myrtle
Ś	Banksia plagiocarpa Hinchinbrook Banksia
	<i>Elaeocarpus reticulus</i> Blueberry Ash
	<i>Eucalyptus gummifera</i> Red Bloodwood
\bigcirc	<i>Pumeria rubra</i> Frangipani Tree
\bigcirc	<i>Stenocarpus sinuatus</i> Firewheel Tree
$\langle \rangle$	<i>Syncarpia glomulifera</i> Turpentine Tree
	PRIVATE RESIDENCES
	TERRACE FRONTAGE PLANTING (DEEP SOIL)
	CENTRAL COURTYARD GROUND COVER PLANTING (DEEP SOIL)
	CENTRAL COURTYARD SCREEN PLANTING (DEEP SOIL)
	ROOF TERRACE PLANTING (ON STRUCTURE)
	PUBLIC DOMAIN
	DARLINGTON LANE PLANTING
	CODRINGTON PARK PLANTING
	NOTE:
	REFER 'ARBORSAFE' ARBORIST REPORT DATED 19TH NOVEMBER 2016 FOR ALL EXISTING TREES ON
	REFER LANDSCAPE DOCUMENTATION L003 FOR PLANT SPECIES





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Approved Application No: SSD-7539


Signed Hofan Granted: 29 January 2021 Sheet No: 41 of 64


STATUS DEVELOPMENT APPLICATION	DRAWING PLANTING PLAN PRIVATE RESIDENCES	
DRAWING SCALE SCALE 1:100 @ A1		PROJECT № S14-028
1 0 1 2 5m	$ $ \forall	DRAWING №


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DRAWING **№** L504

ISSUE 03



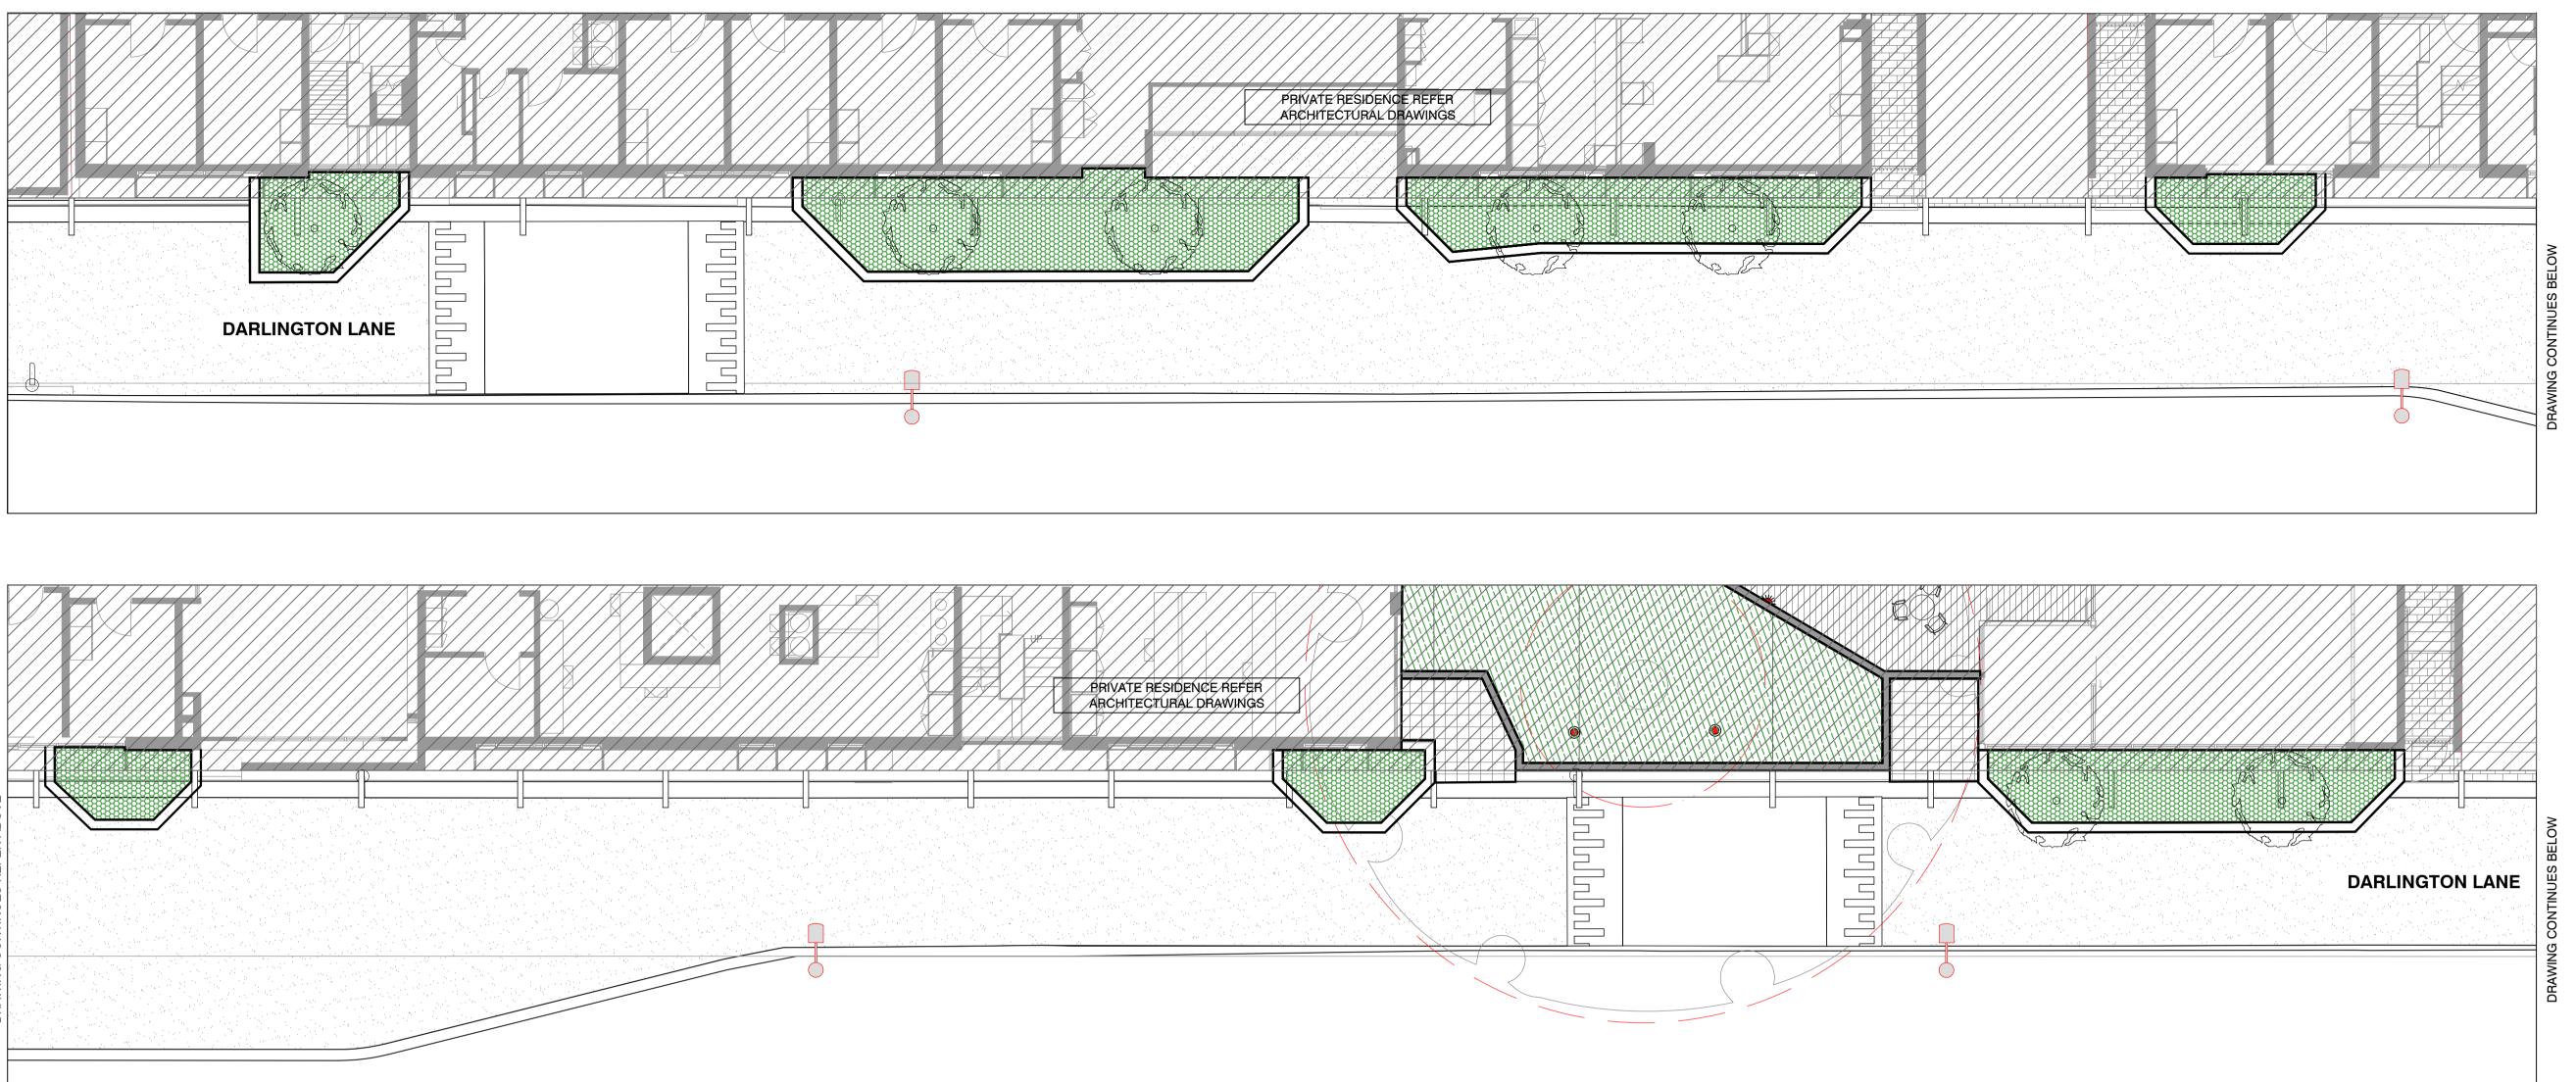


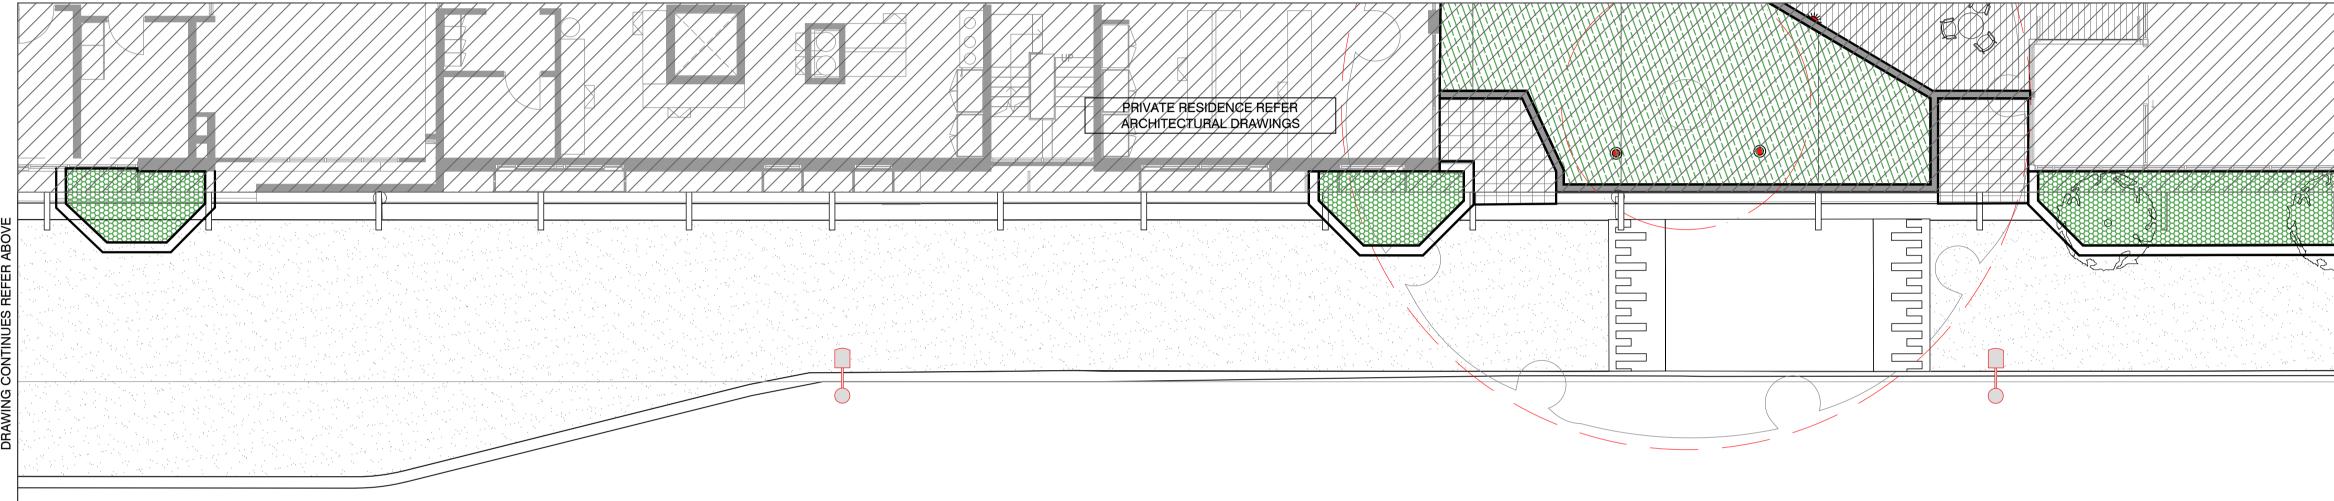

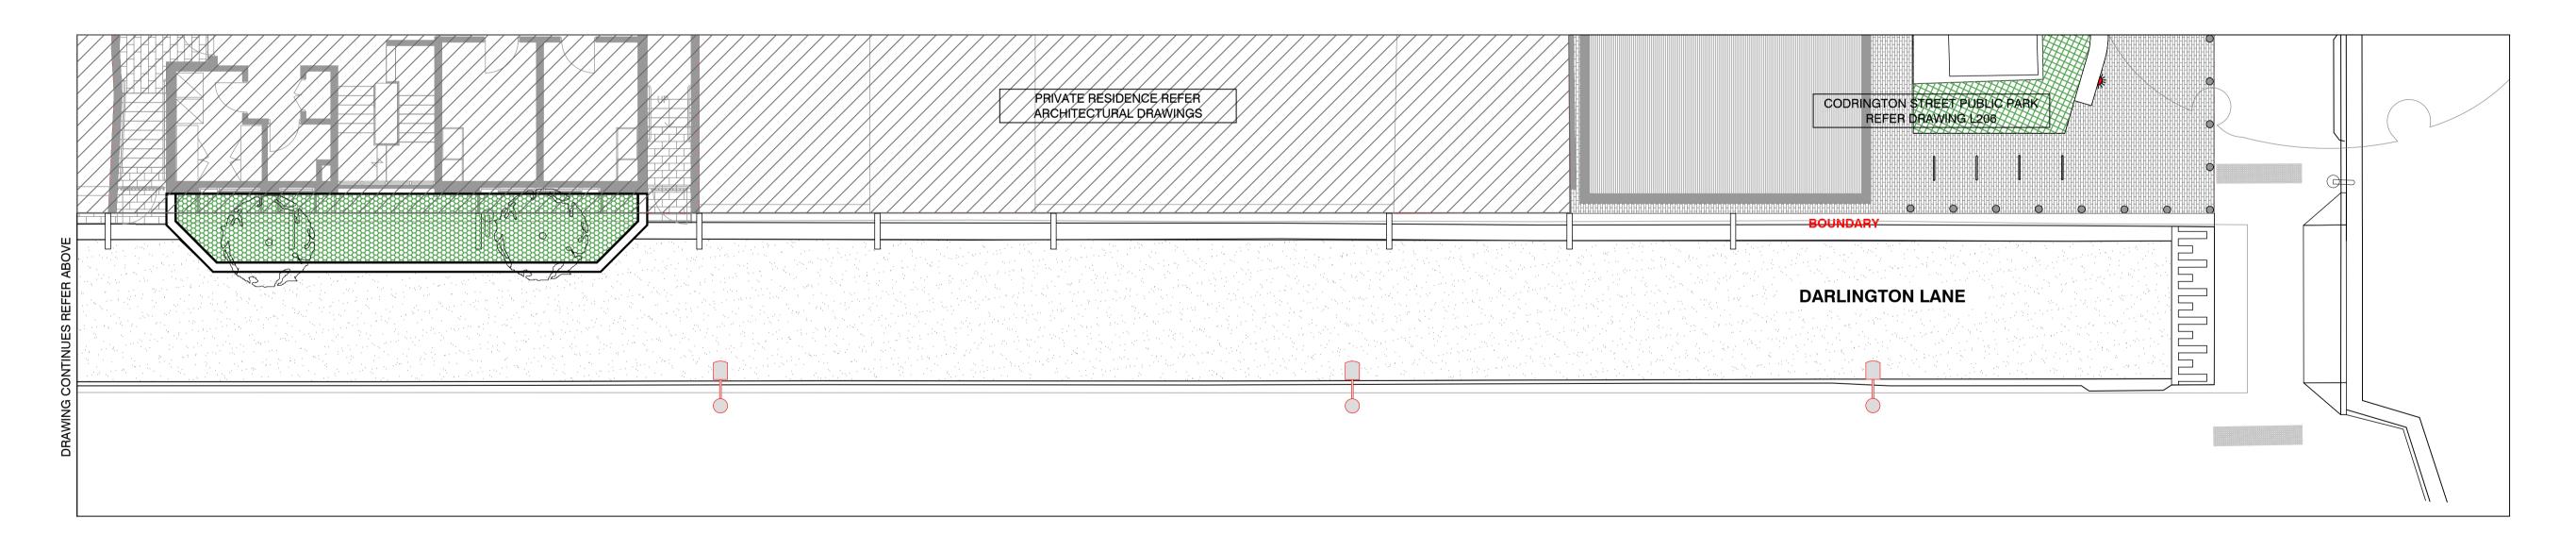NOTES	KEY PLAN	ISSUE	DATE	AMENDMENT	DRI	N APRVD						PROJECT
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DIAL BEFORE VOU DIG www.1100.com.au								MELDOOK				ARCHITECT
PRIOR TO COMMENCEMENT WORK.							_					ALLEN JACK AND COTTIER
												79 Myrtle Street Chippendale NSW 2008

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LEGEND	

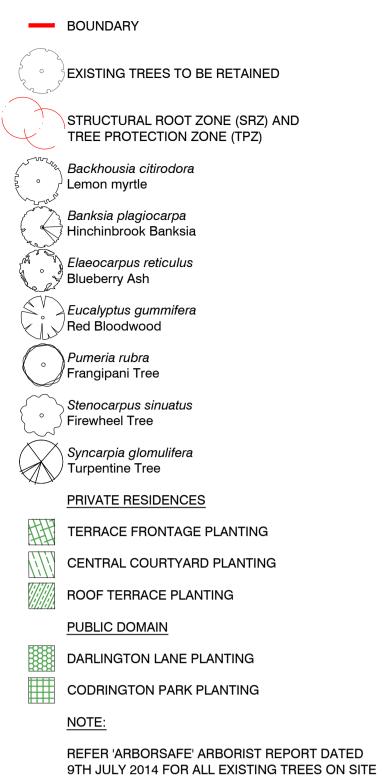

REFER LANDSCAPE DOCUMENTATION L003 FOR PLANT SPECIES



NORTH POINT

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Granted: 29 January 2021 Sheet No: 42 of 64

DEVELOPMENT APPLICATION	

DRAWING SCALE

STATUS



DRAWING PLANTING PLAN PUBLIC DOMAIN

SHEET SIZE A1


DRAWING № L505

PROJECT №

S14-028

ISSUE

02

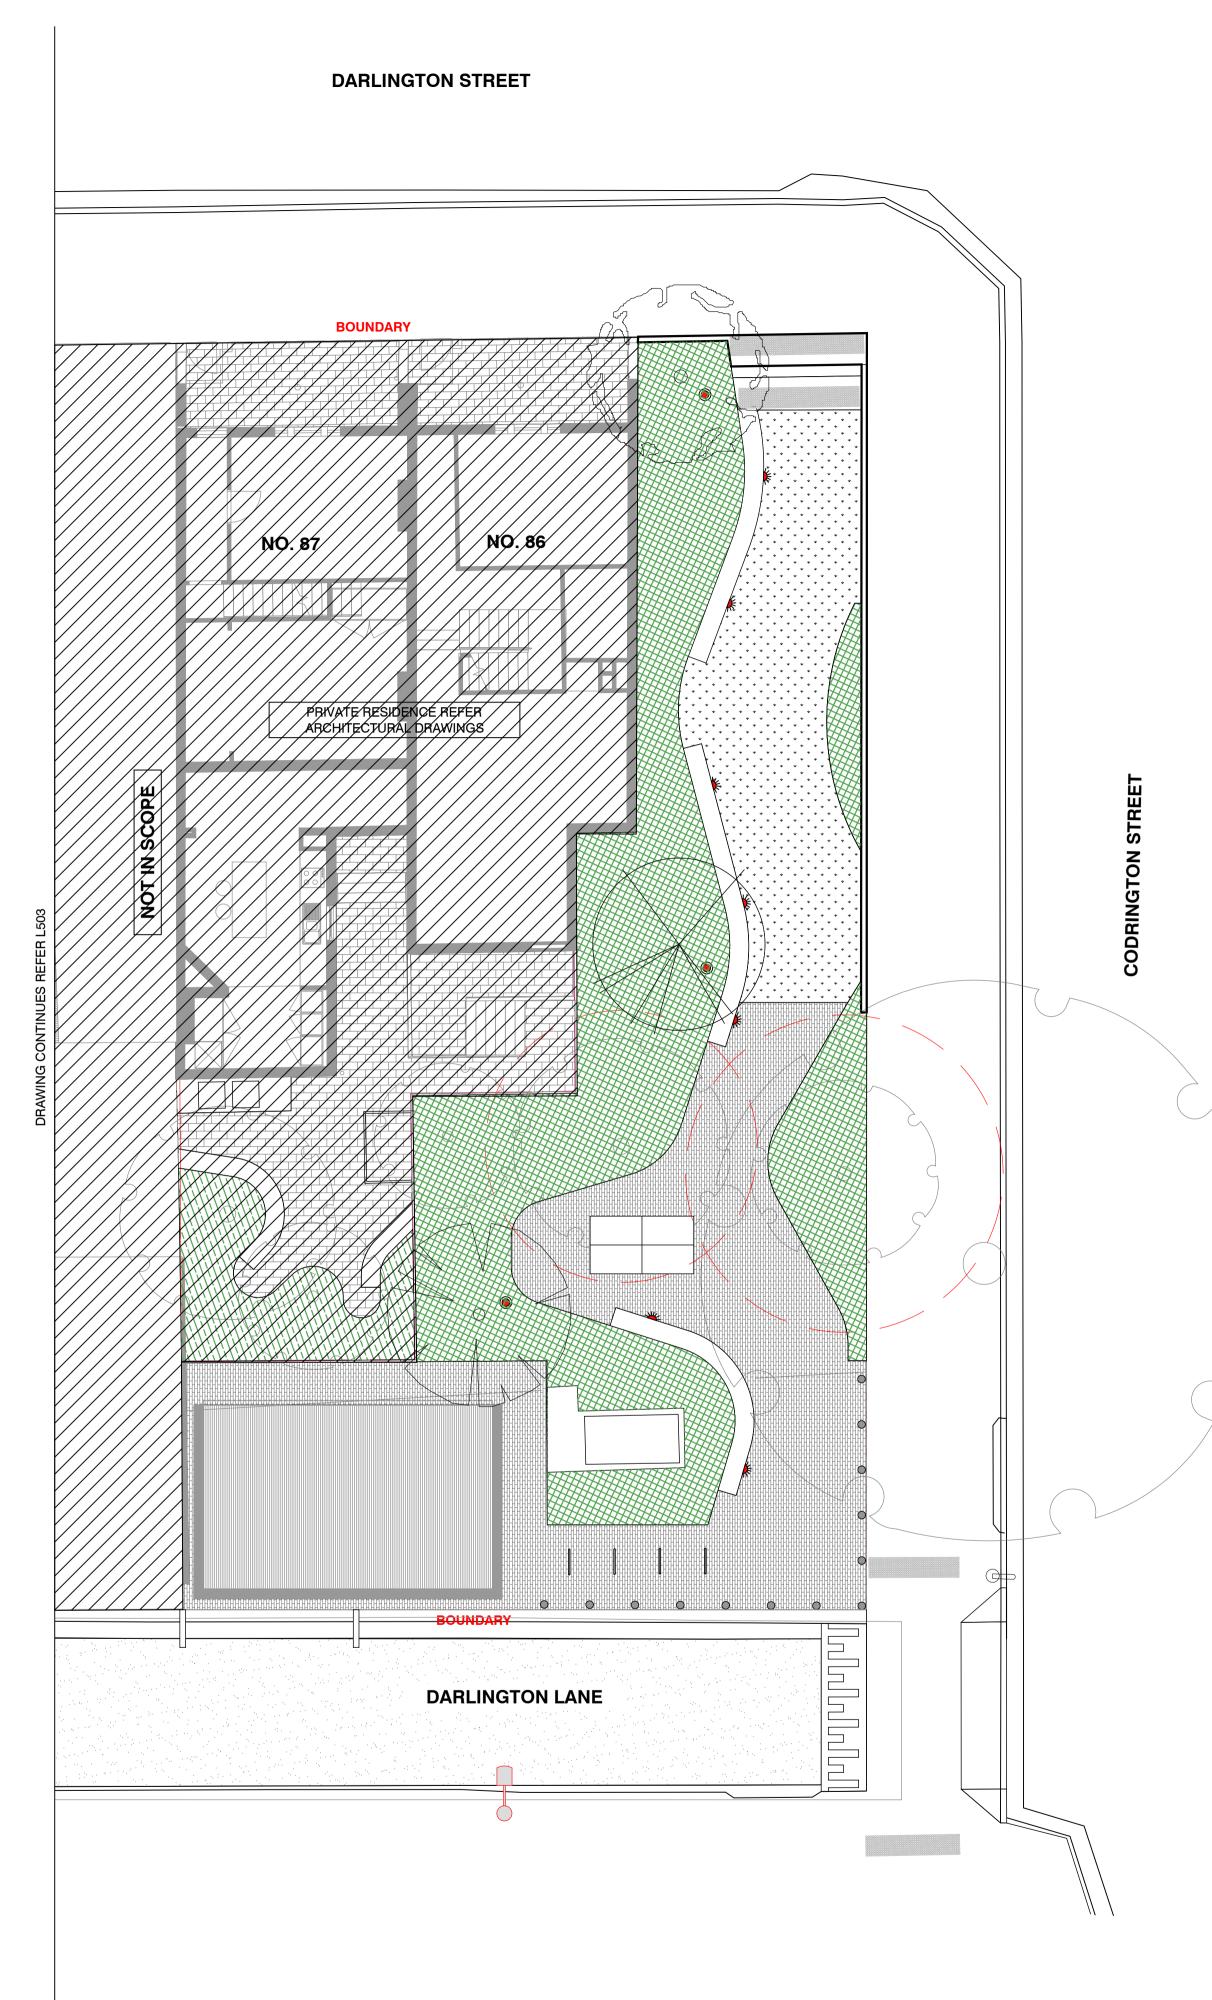

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KEY PLAN

ISSUE	DATE	AMENDMENT	DRN	APRVD
01	09.08.19	ISSUE FOR DA	CRB	KS
02	31.10.19	ISSUE FOR DA	CRB	KS



PROJECT DARLINGTON ROAD TERRACES Darlington Road, Darlington NSW 2008 CLIENT

THE UNIVERSITY OF SYDNEY Camperdown NSW 2006 ARCHITECT

ALLEN JACK AND COTTIER 79 Myrtle Street Chippendale NSW 2008

LEGEND

	BOUNDARY
Lo co co	EXISTING TREES TO BE RETAINED
t.	STRUCTURAL ROOT ZONE (SRZ) AND TREE PROTECTION ZONE (TPZ)
Contraction of the second seco	<i>Backhousia citirodora</i> Lemon myrtle
	Banksia plagiocarpa Hinchinbrook Banksia
	<i>Elaeocarpus reticulus</i> Blueberry Ash
	Eucalyptus gummifera Red Bloodwood
\bigcirc	<i>Pumeria rubra</i> Frangipani Tree
\bigcirc	<i>Stenocarpus sinuatus</i> Firewheel Tree
	<i>Syncarpia glomulifera</i> Turpentine Tree
	PRIVATE RESIDENCES
	TERRACE FRONTAGE PLANTING
	CENTRAL COURTYARD PLANTING
	ROOF TERRACE PLANTING
	PUBLIC DOMAIN
	DARLINGTON LANE PLANTING
	CODRINGTON PARK PLANTING
	NOTE:
	REFER 'ARBORSAFE' ARBORIST REPORT DATED 9TH JULY 2014 FOR ALL EXISTING TREES ON SITE

REFER LANDSCAPE DOCUMENTATION L003 FOR PLANT SPECIES





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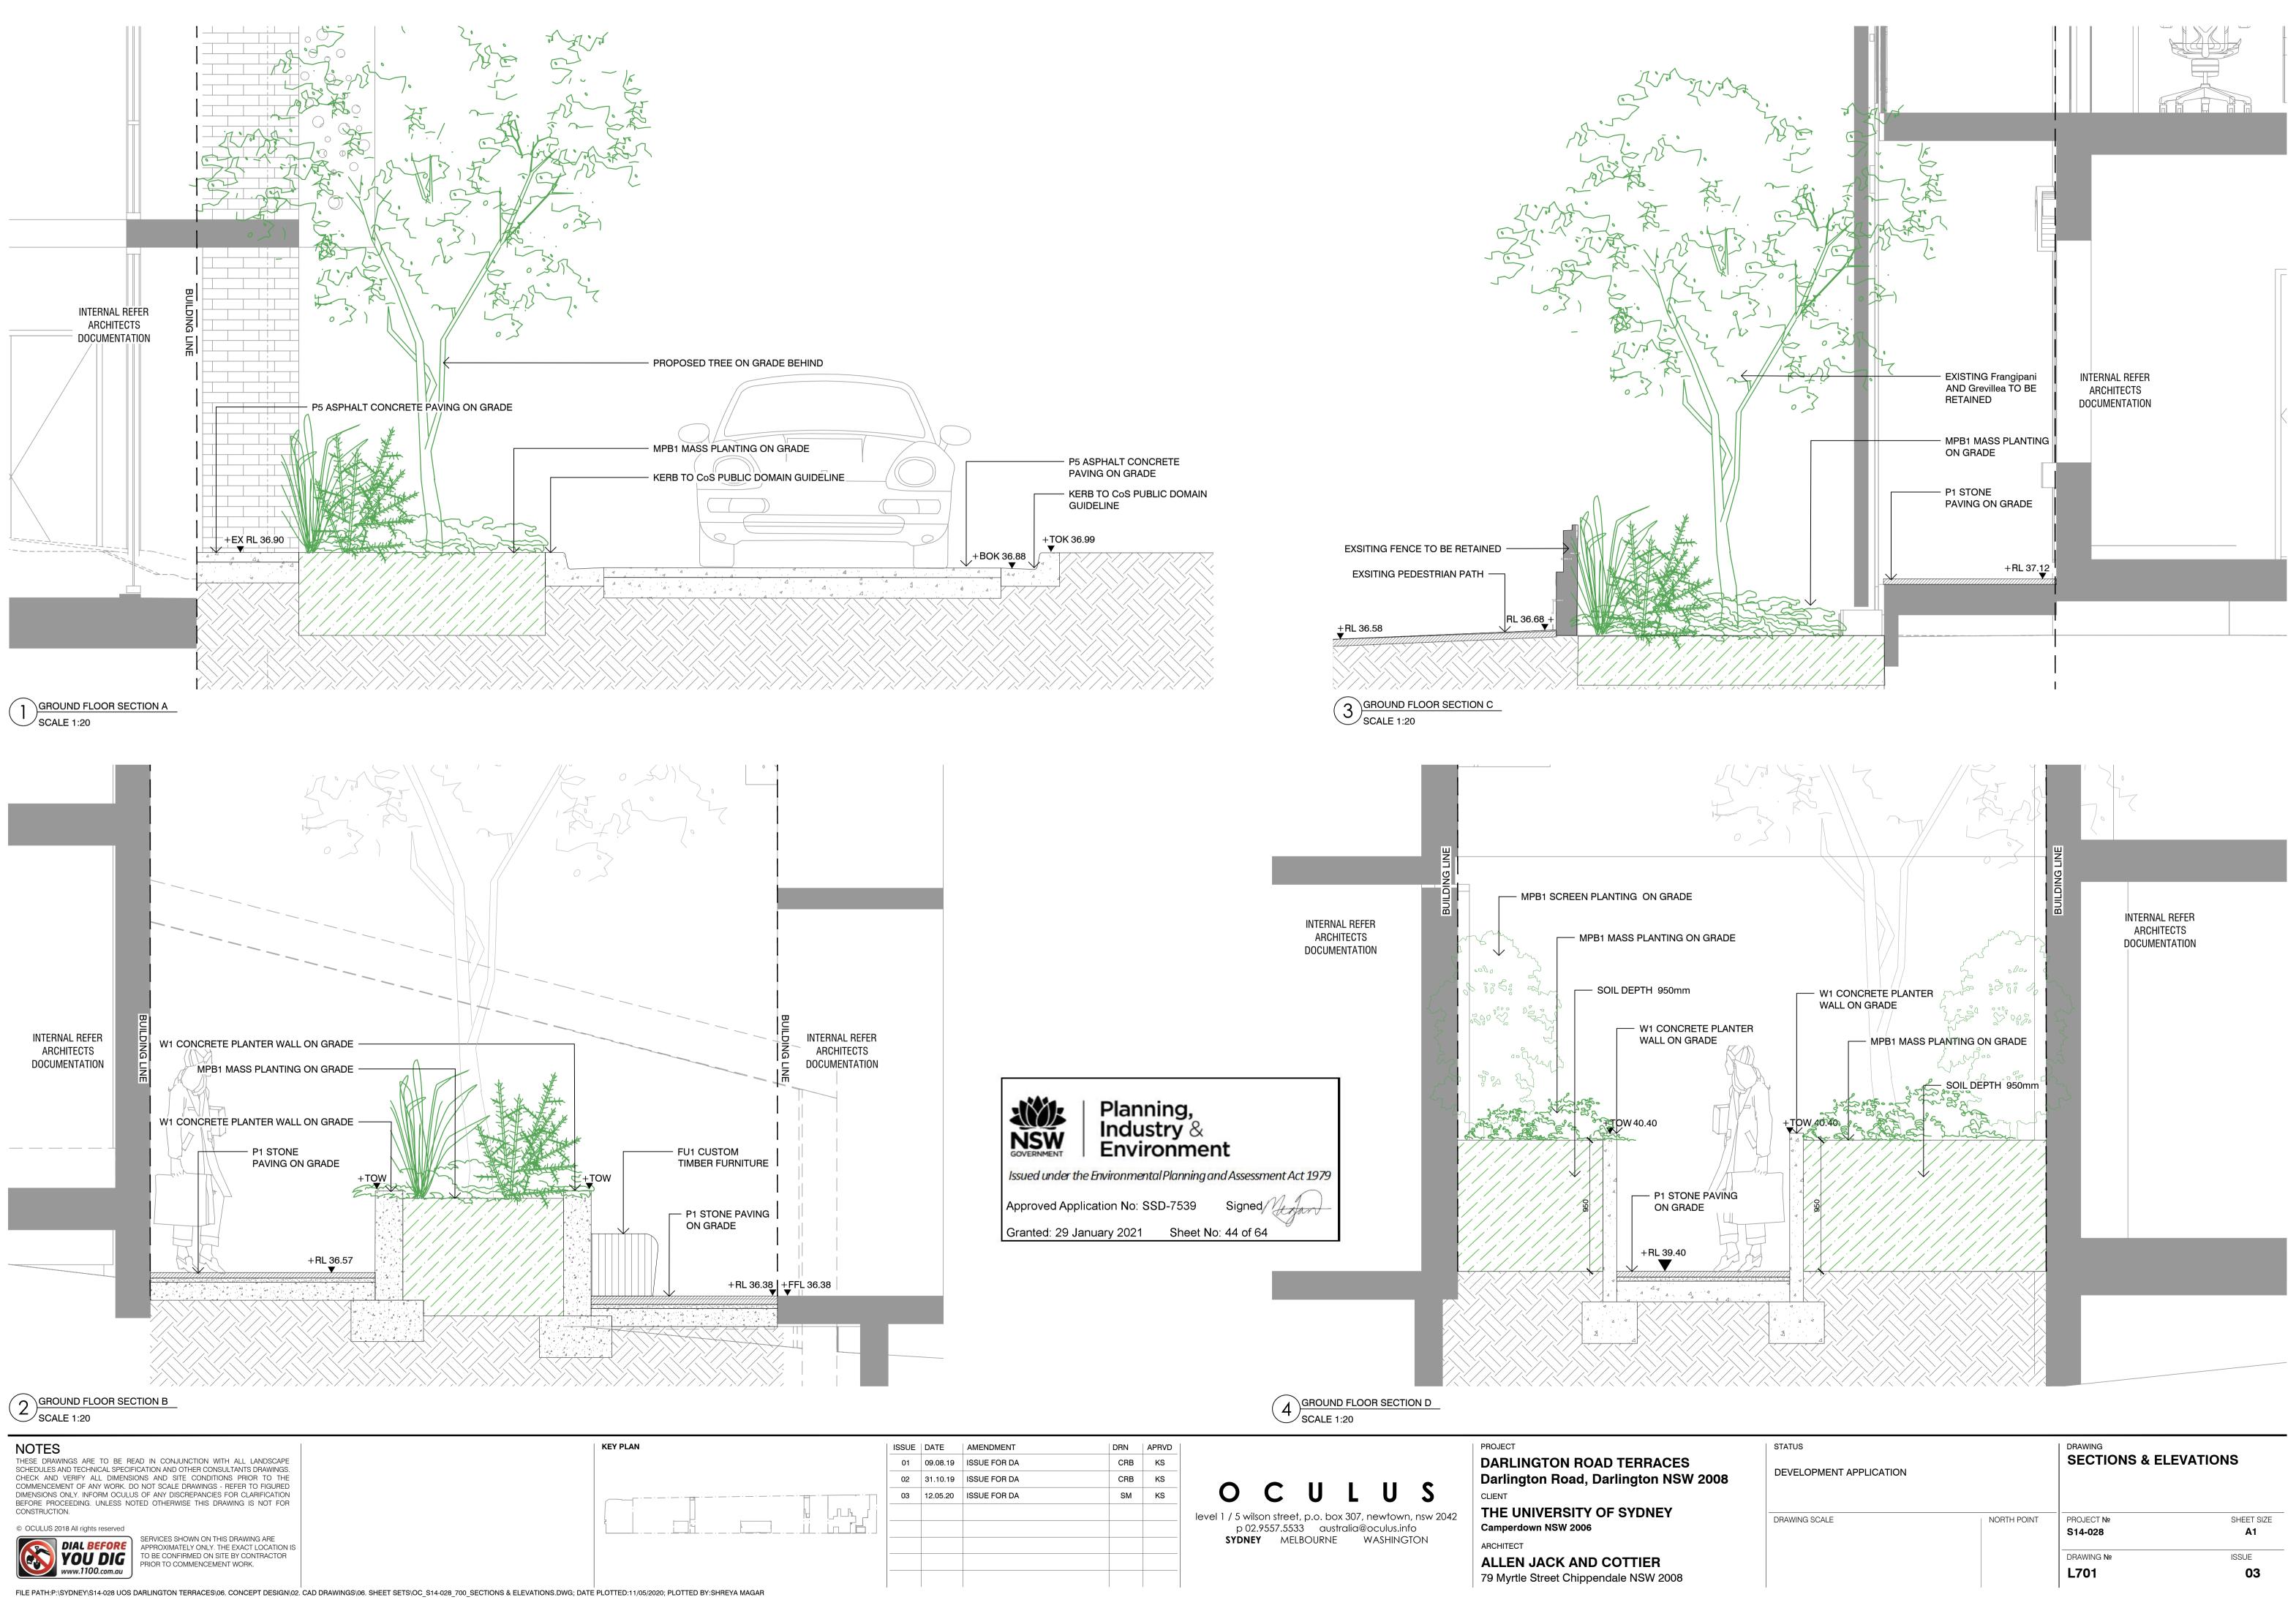
Granted: 29 January 2021 Sheet No: 43 of 64

STATUS	DRAWING PLANTING PLAN PUBLIC DOMAIN				
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SCALE 1:100 @ A1 1 0 1 2 5m		DRAWING №			


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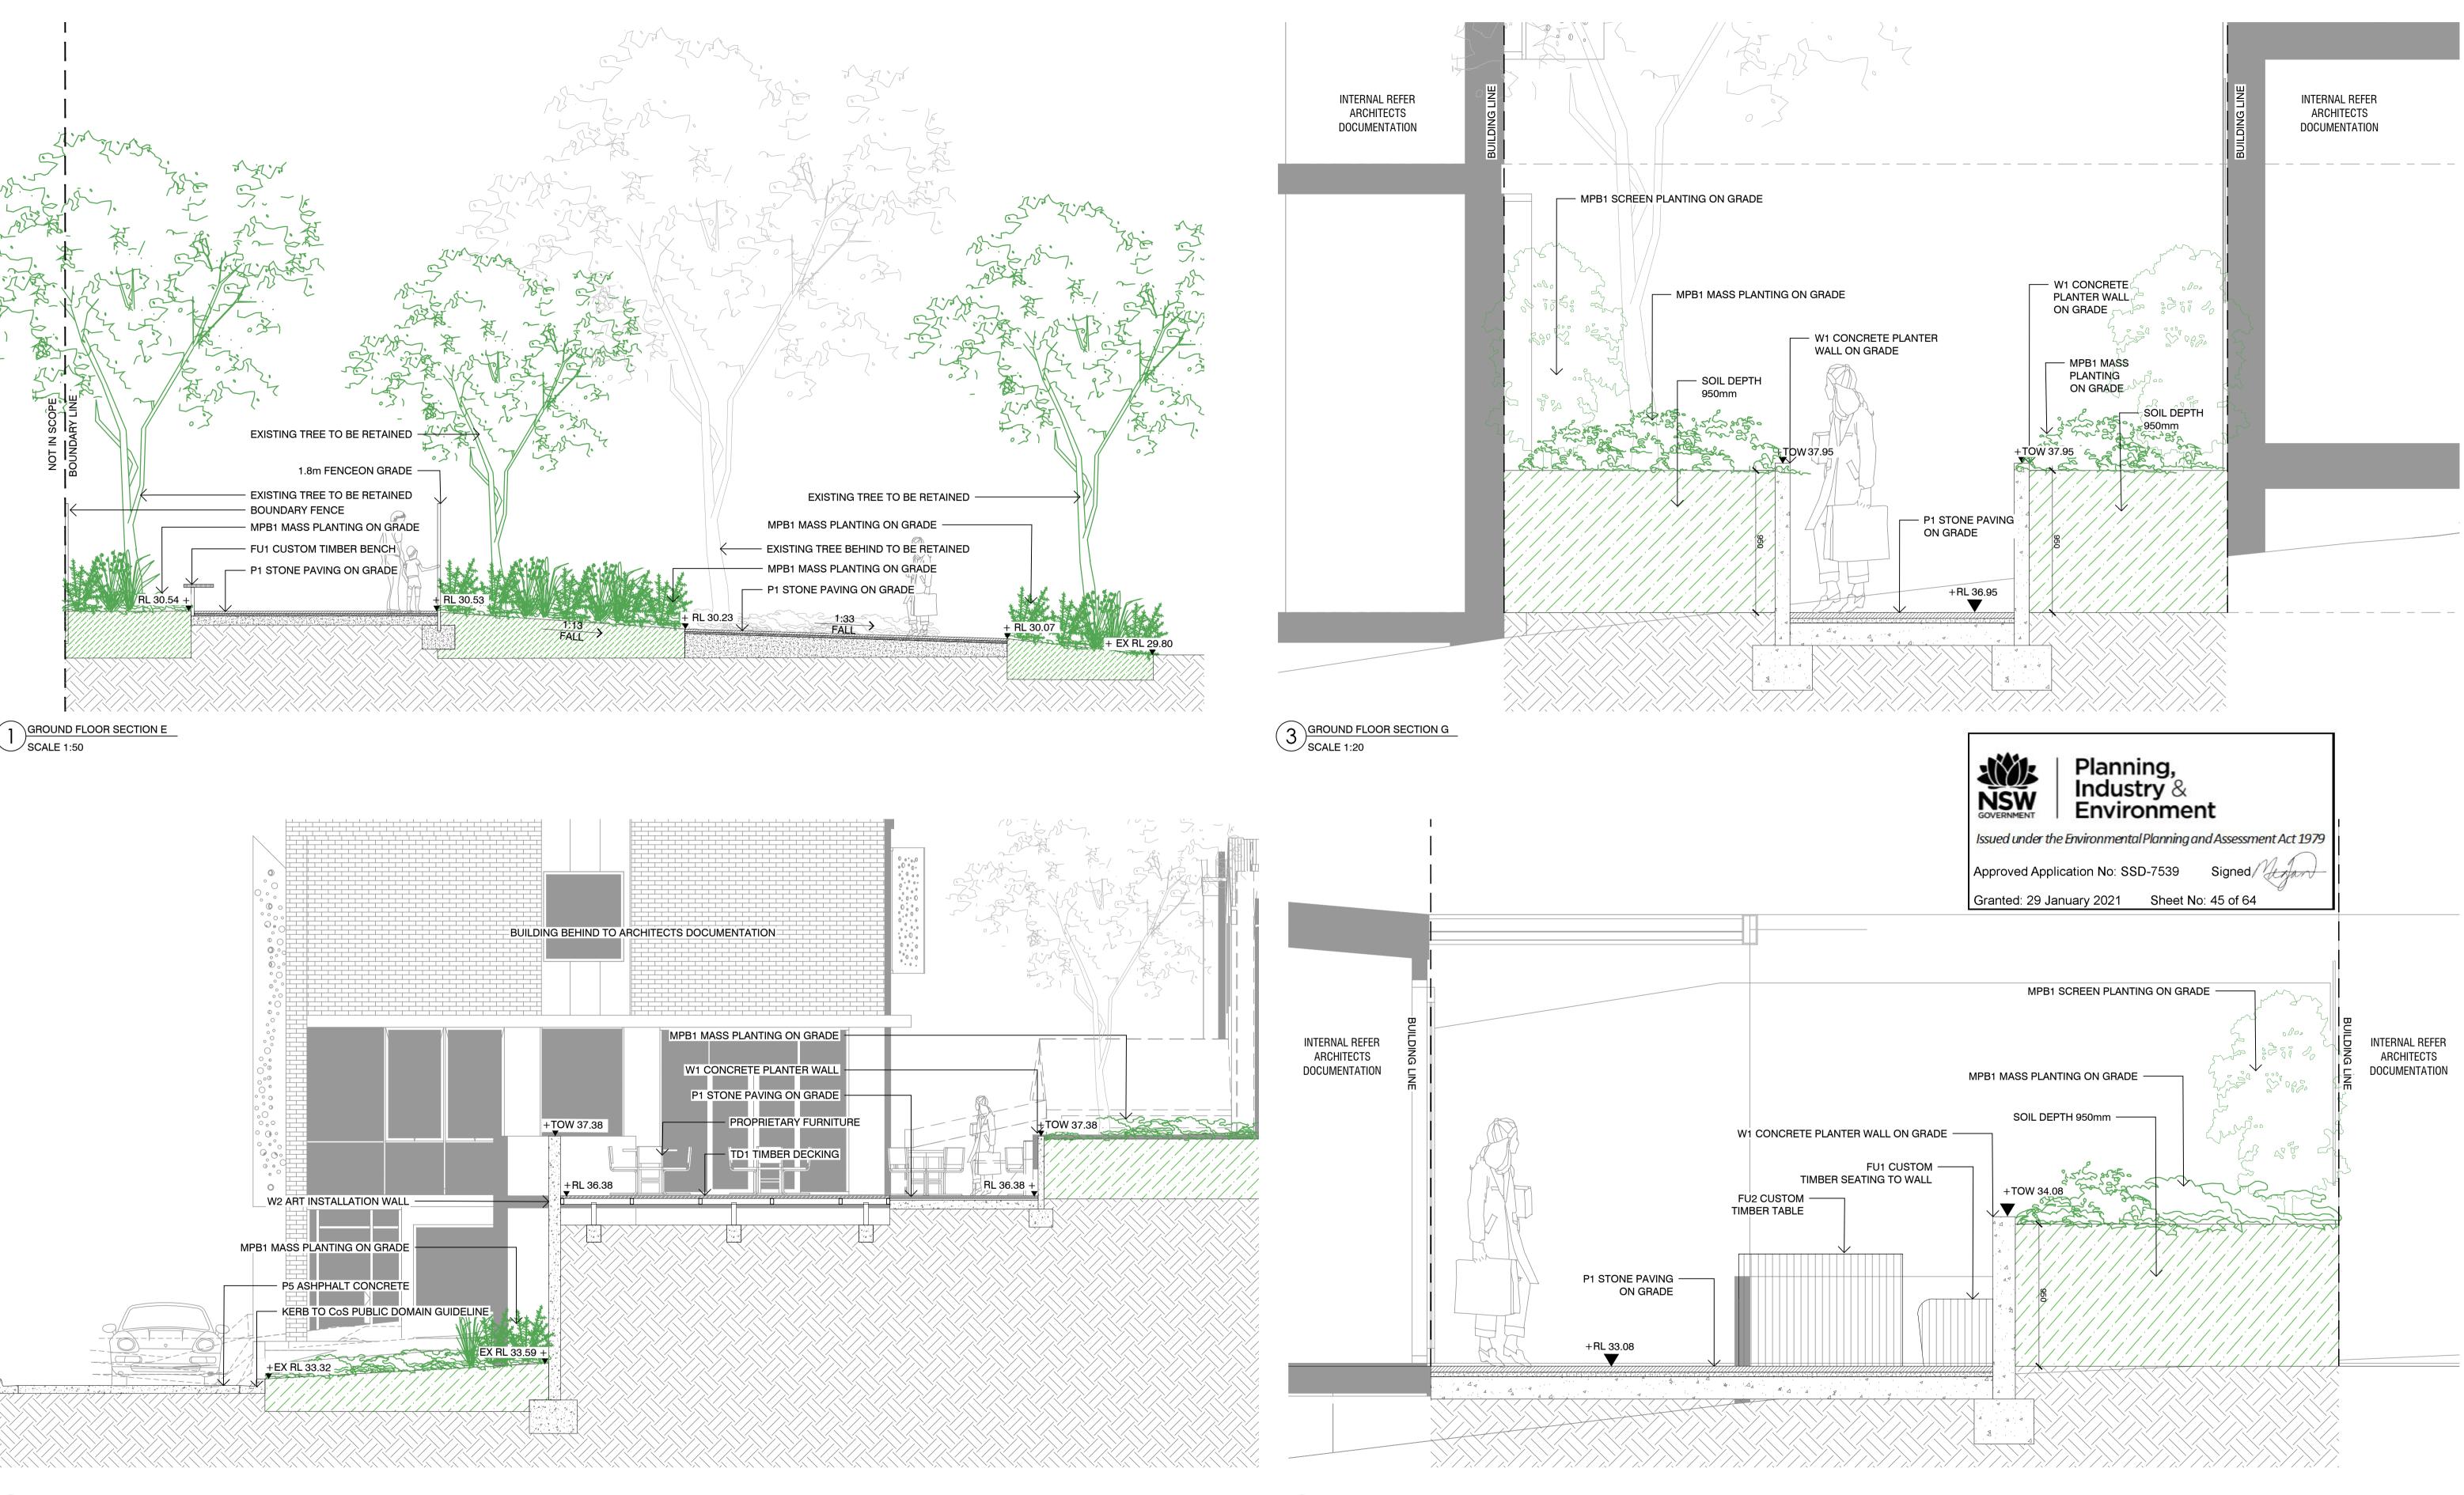
DRAWING **№** L506

ISSUE 02



STATUS DEVELOPMENT APPLICATION		DRAWING SECTIONS & ELEVATIONS	
DRAWING SCALE	NORTH POINT	PROJECT № \$14-028	SHEET SIZE A1
		DRAWING №	ISSUE
		L701	03



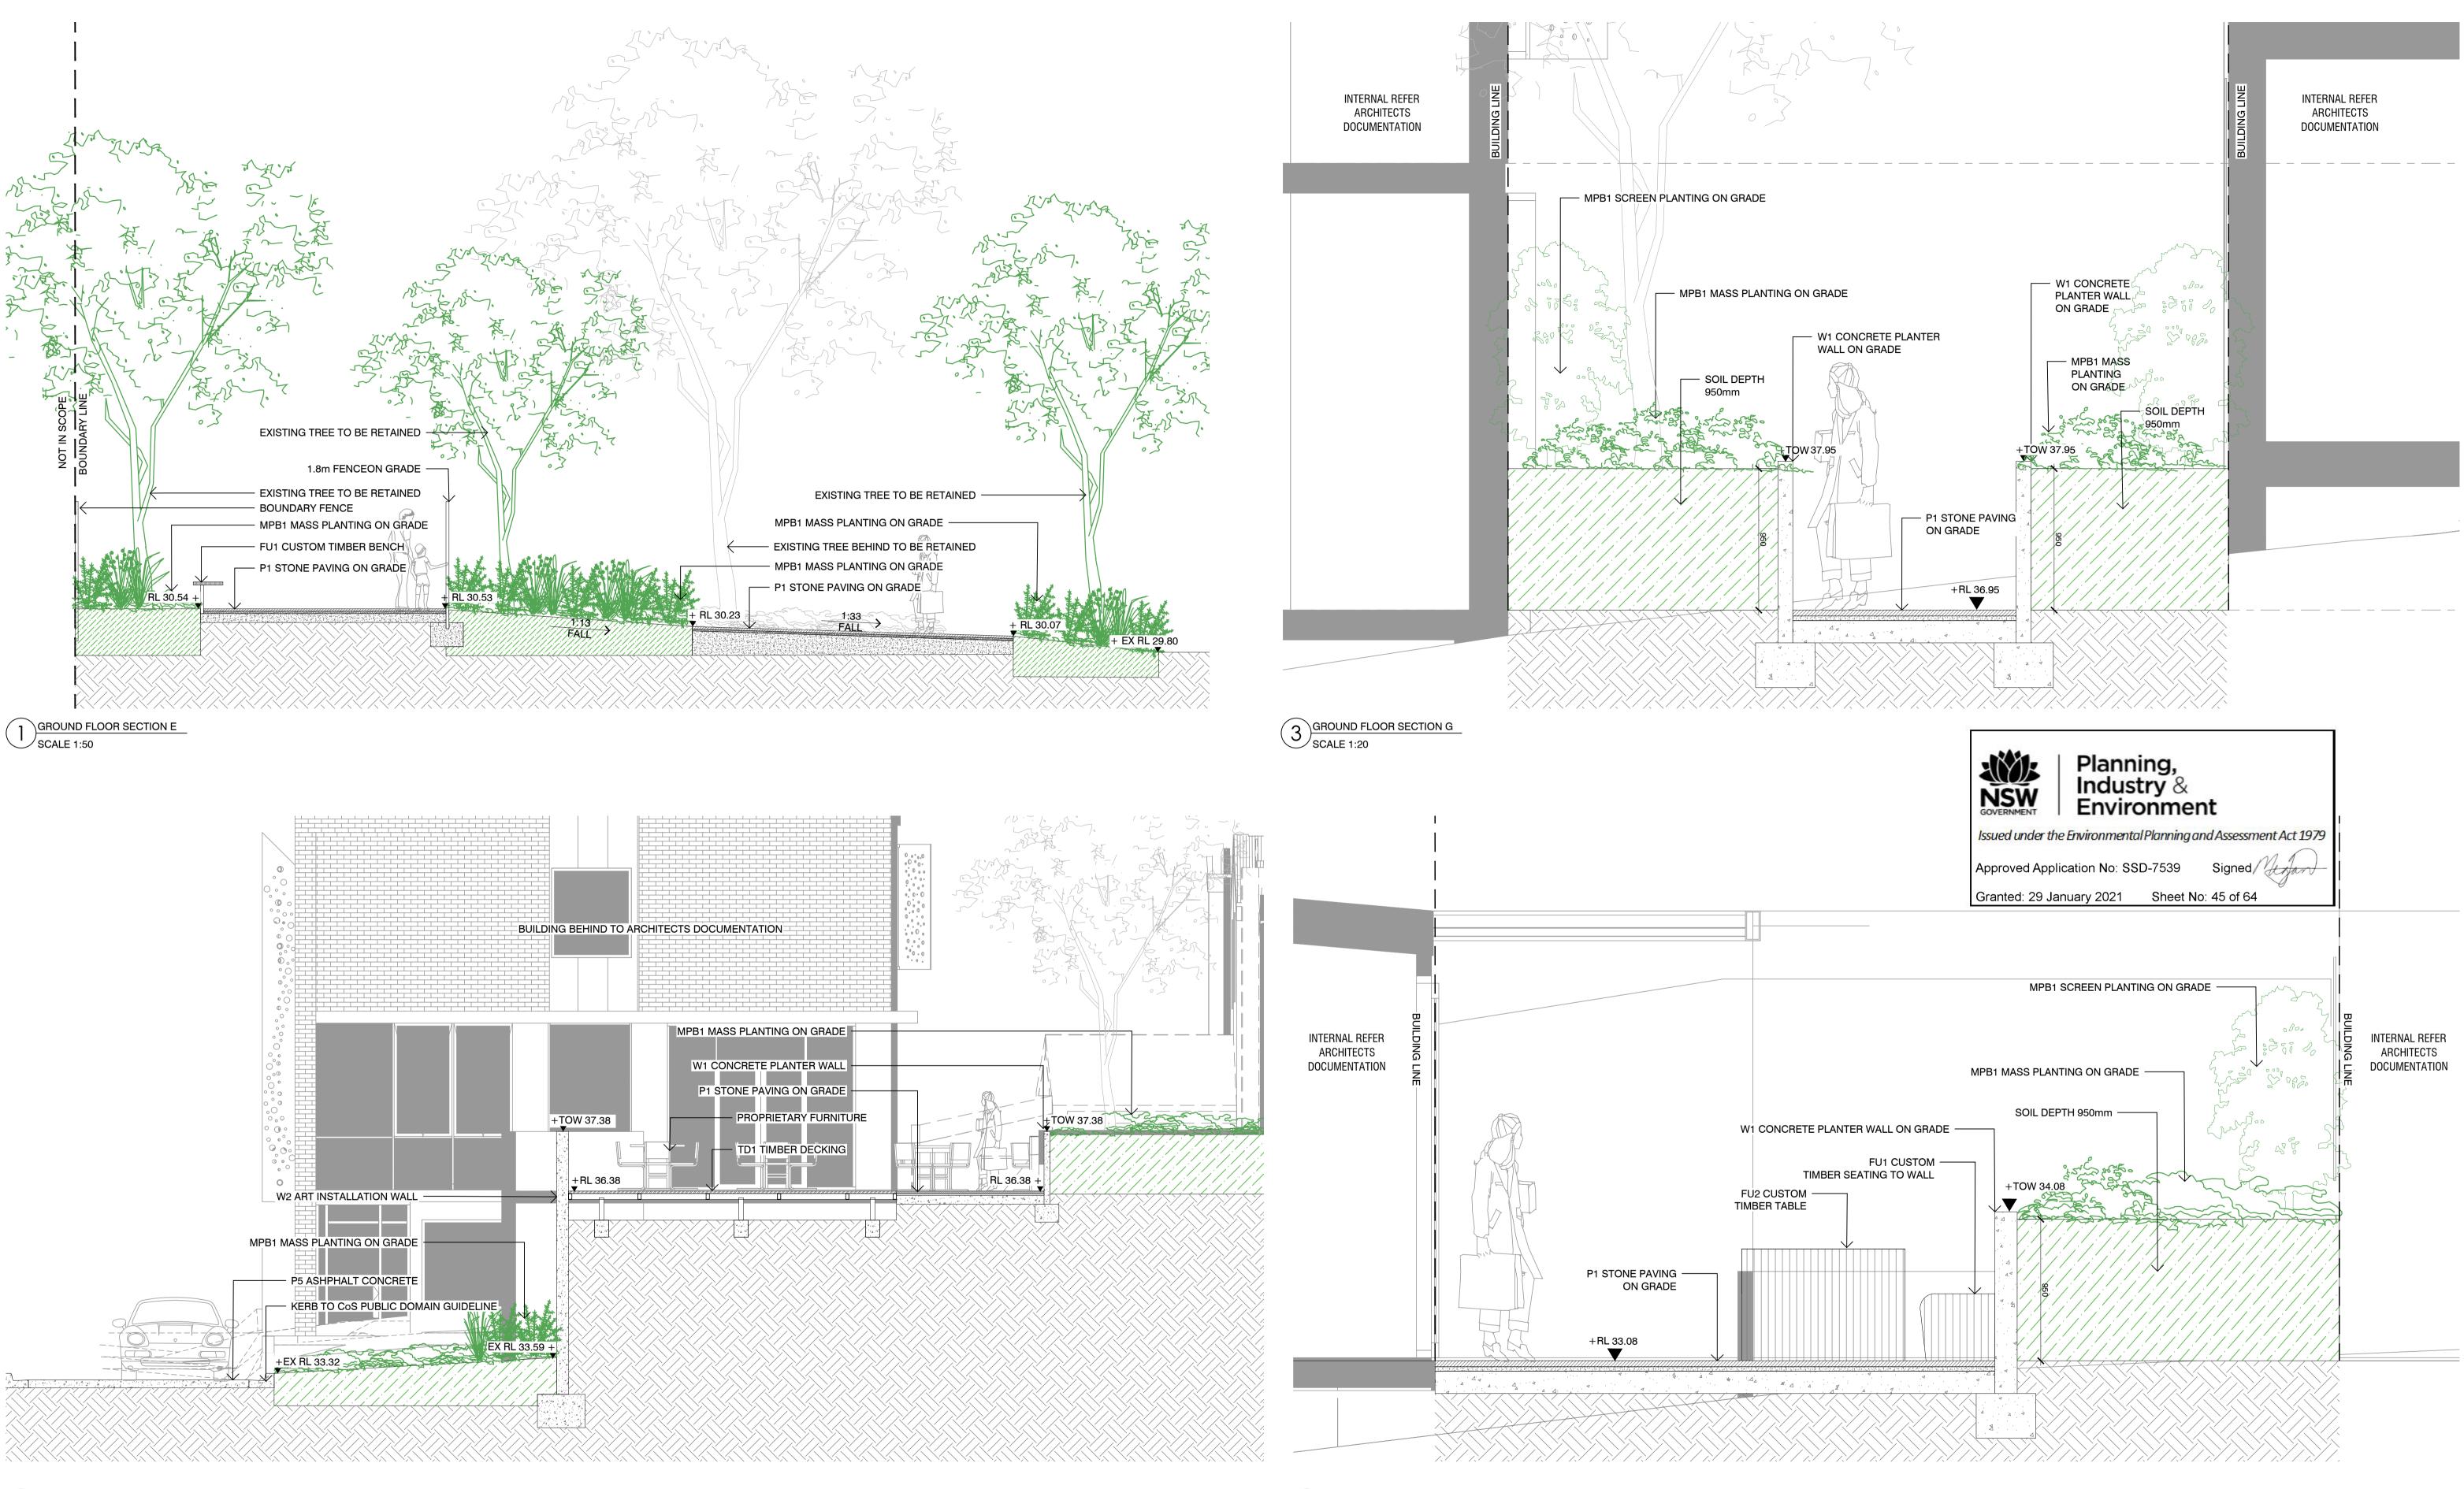

2 GROUND FLOOR SECTION F SCALE 1:50

NOTES	KEY PLAN
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4 GROUND FLOOR SECTION H SCALE 1:20

	ISSUE	DATE	AMENDMENT	DRN	APRVD
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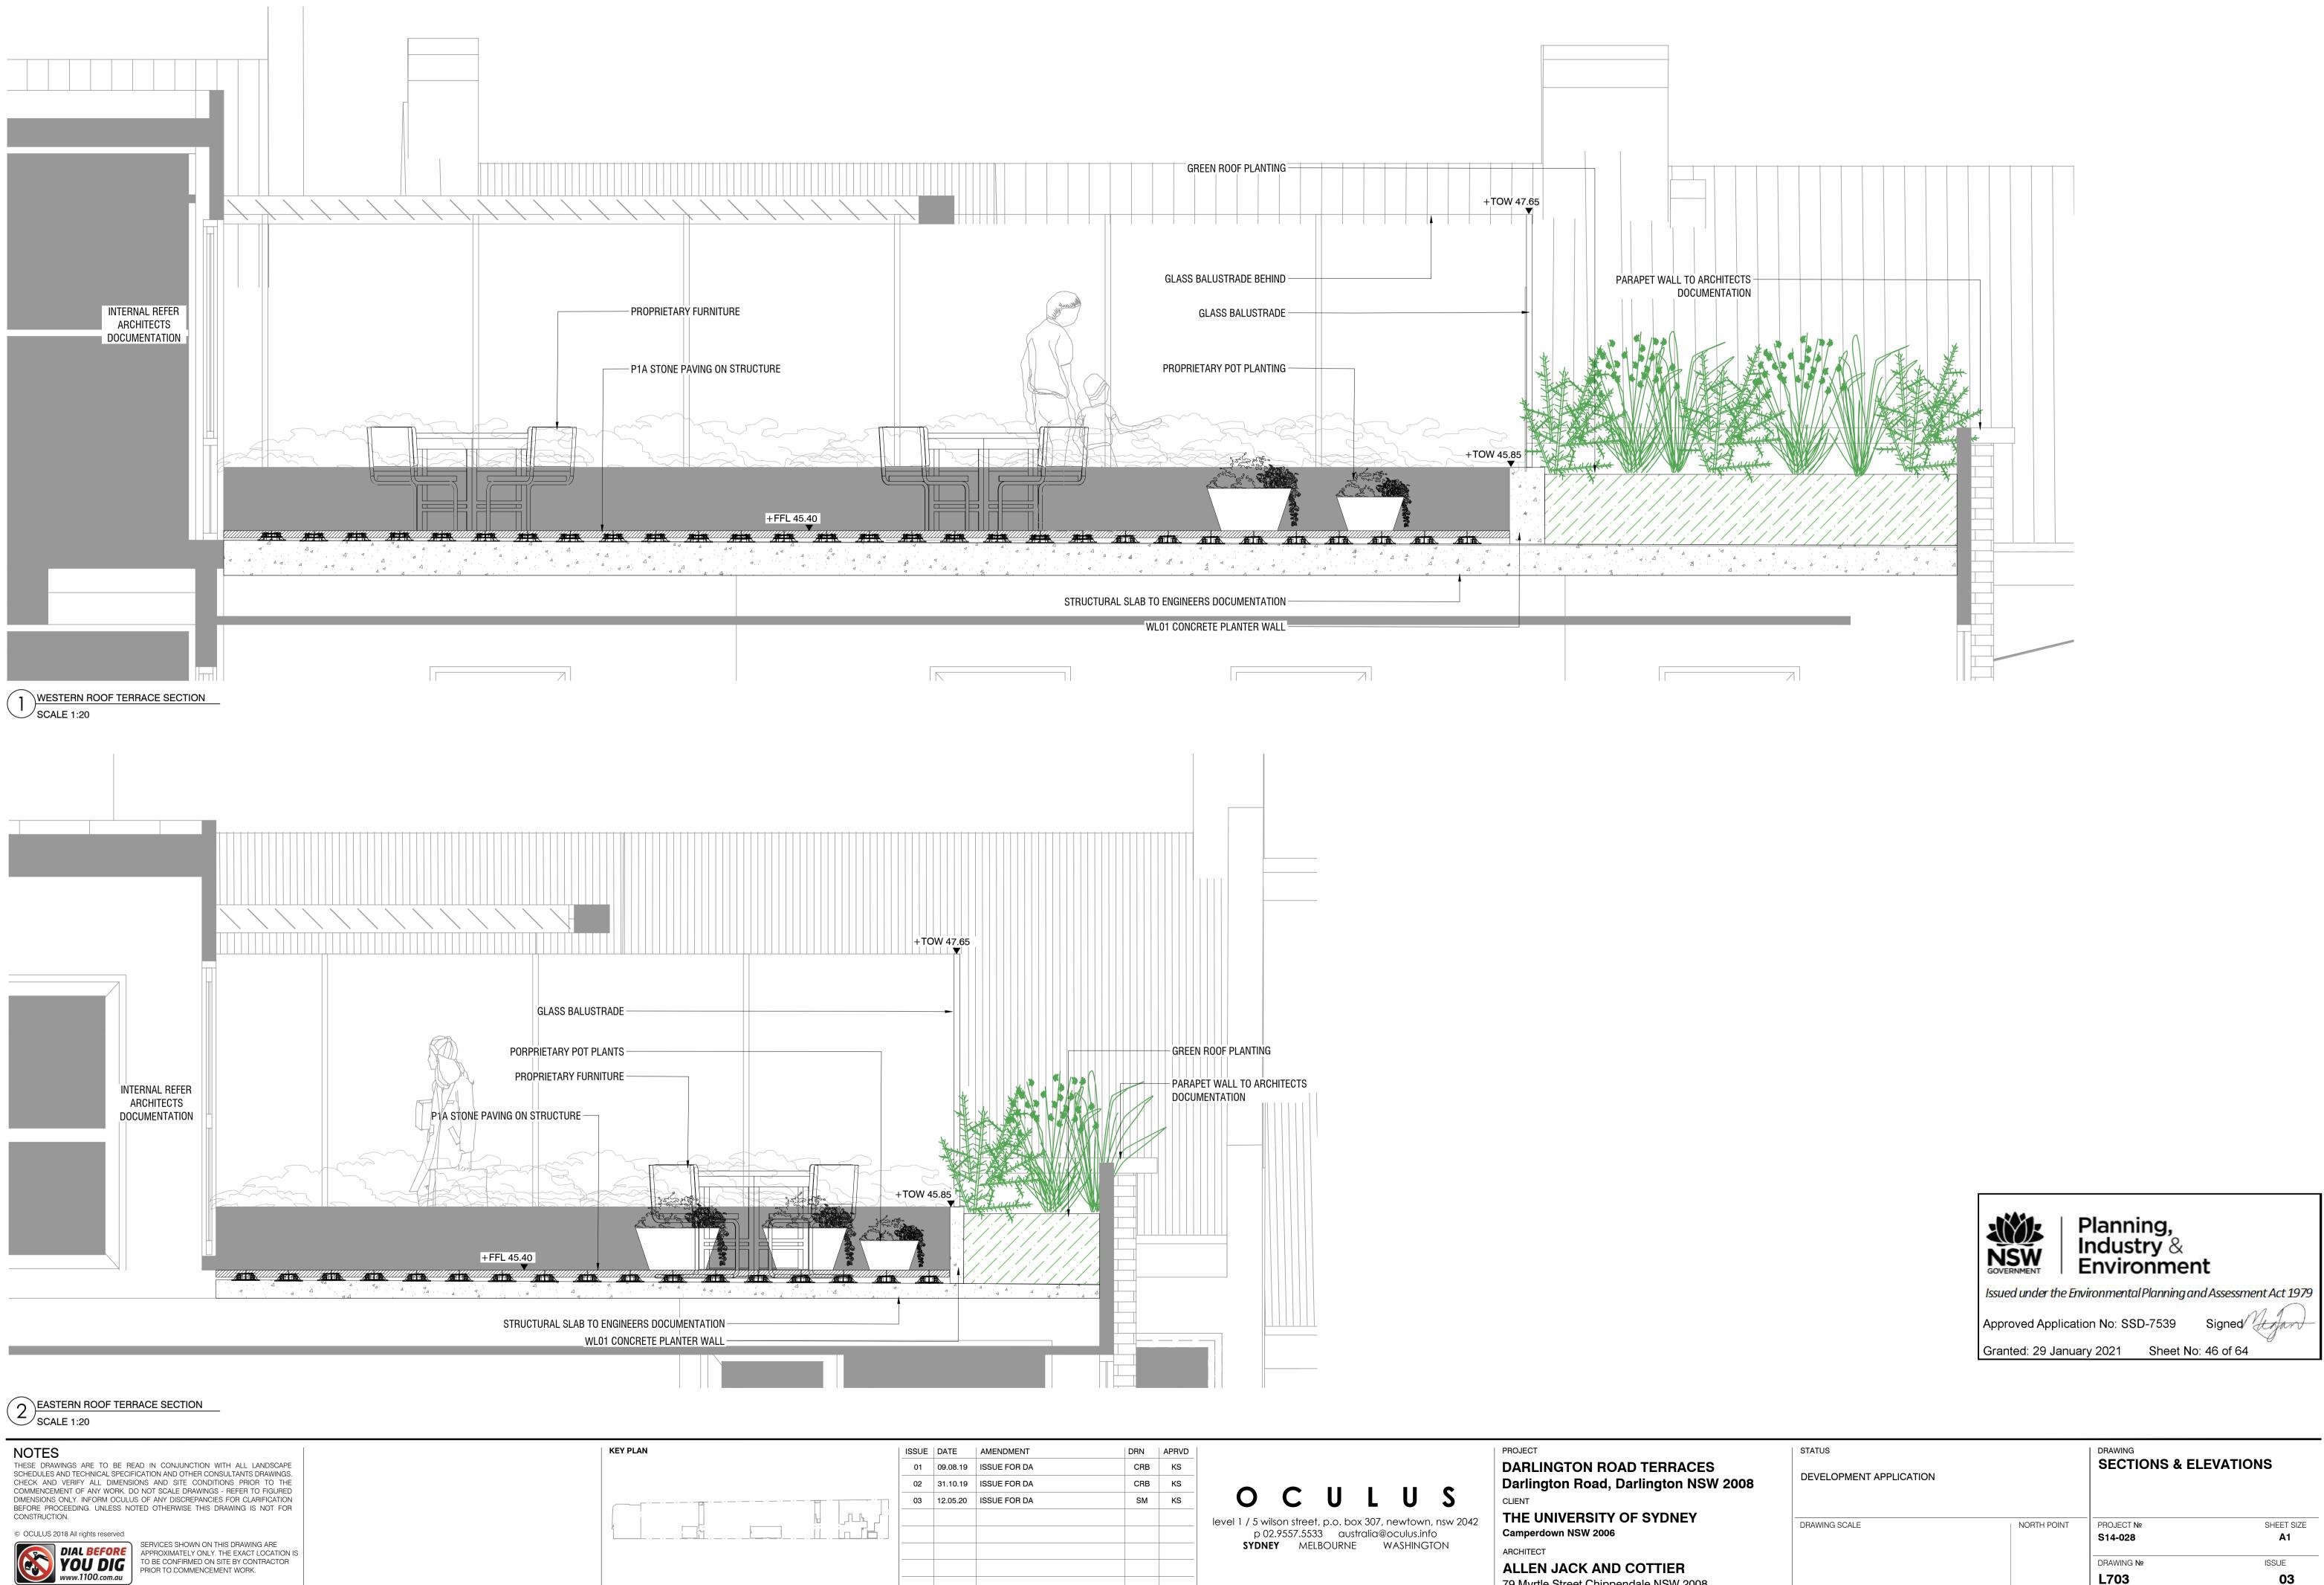


PROJECT DARLINGTON ROAD TERRACES Darlington Road, Darlington NSW 2008 CLIENT

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ALLEN JACK AND COTTIER 79 Myrtle Street Chippendale NSW 2008

STATUS		DRAWING SECTIONS & EL	EVATIONS
DRAWING SCALE	NORTH POINT	 PROJECT № S14-028	SHEET SIZE
		DRAWING №	ISSUE
		L702	03




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Camperdown NSW 2006
ARCHITECT

ALLEN JACK AND COTTIER 79 Myrtle Street Chippendale NSW 2008

STATUS			
DEVELOPMENT APPLICATION	SECTIONS & LEEVATIONS		
DRAWING SCALE	NORTH POINT	PROJECT № \$14-028	SHEET SIZE
		DRAWING № L703	ISSUE

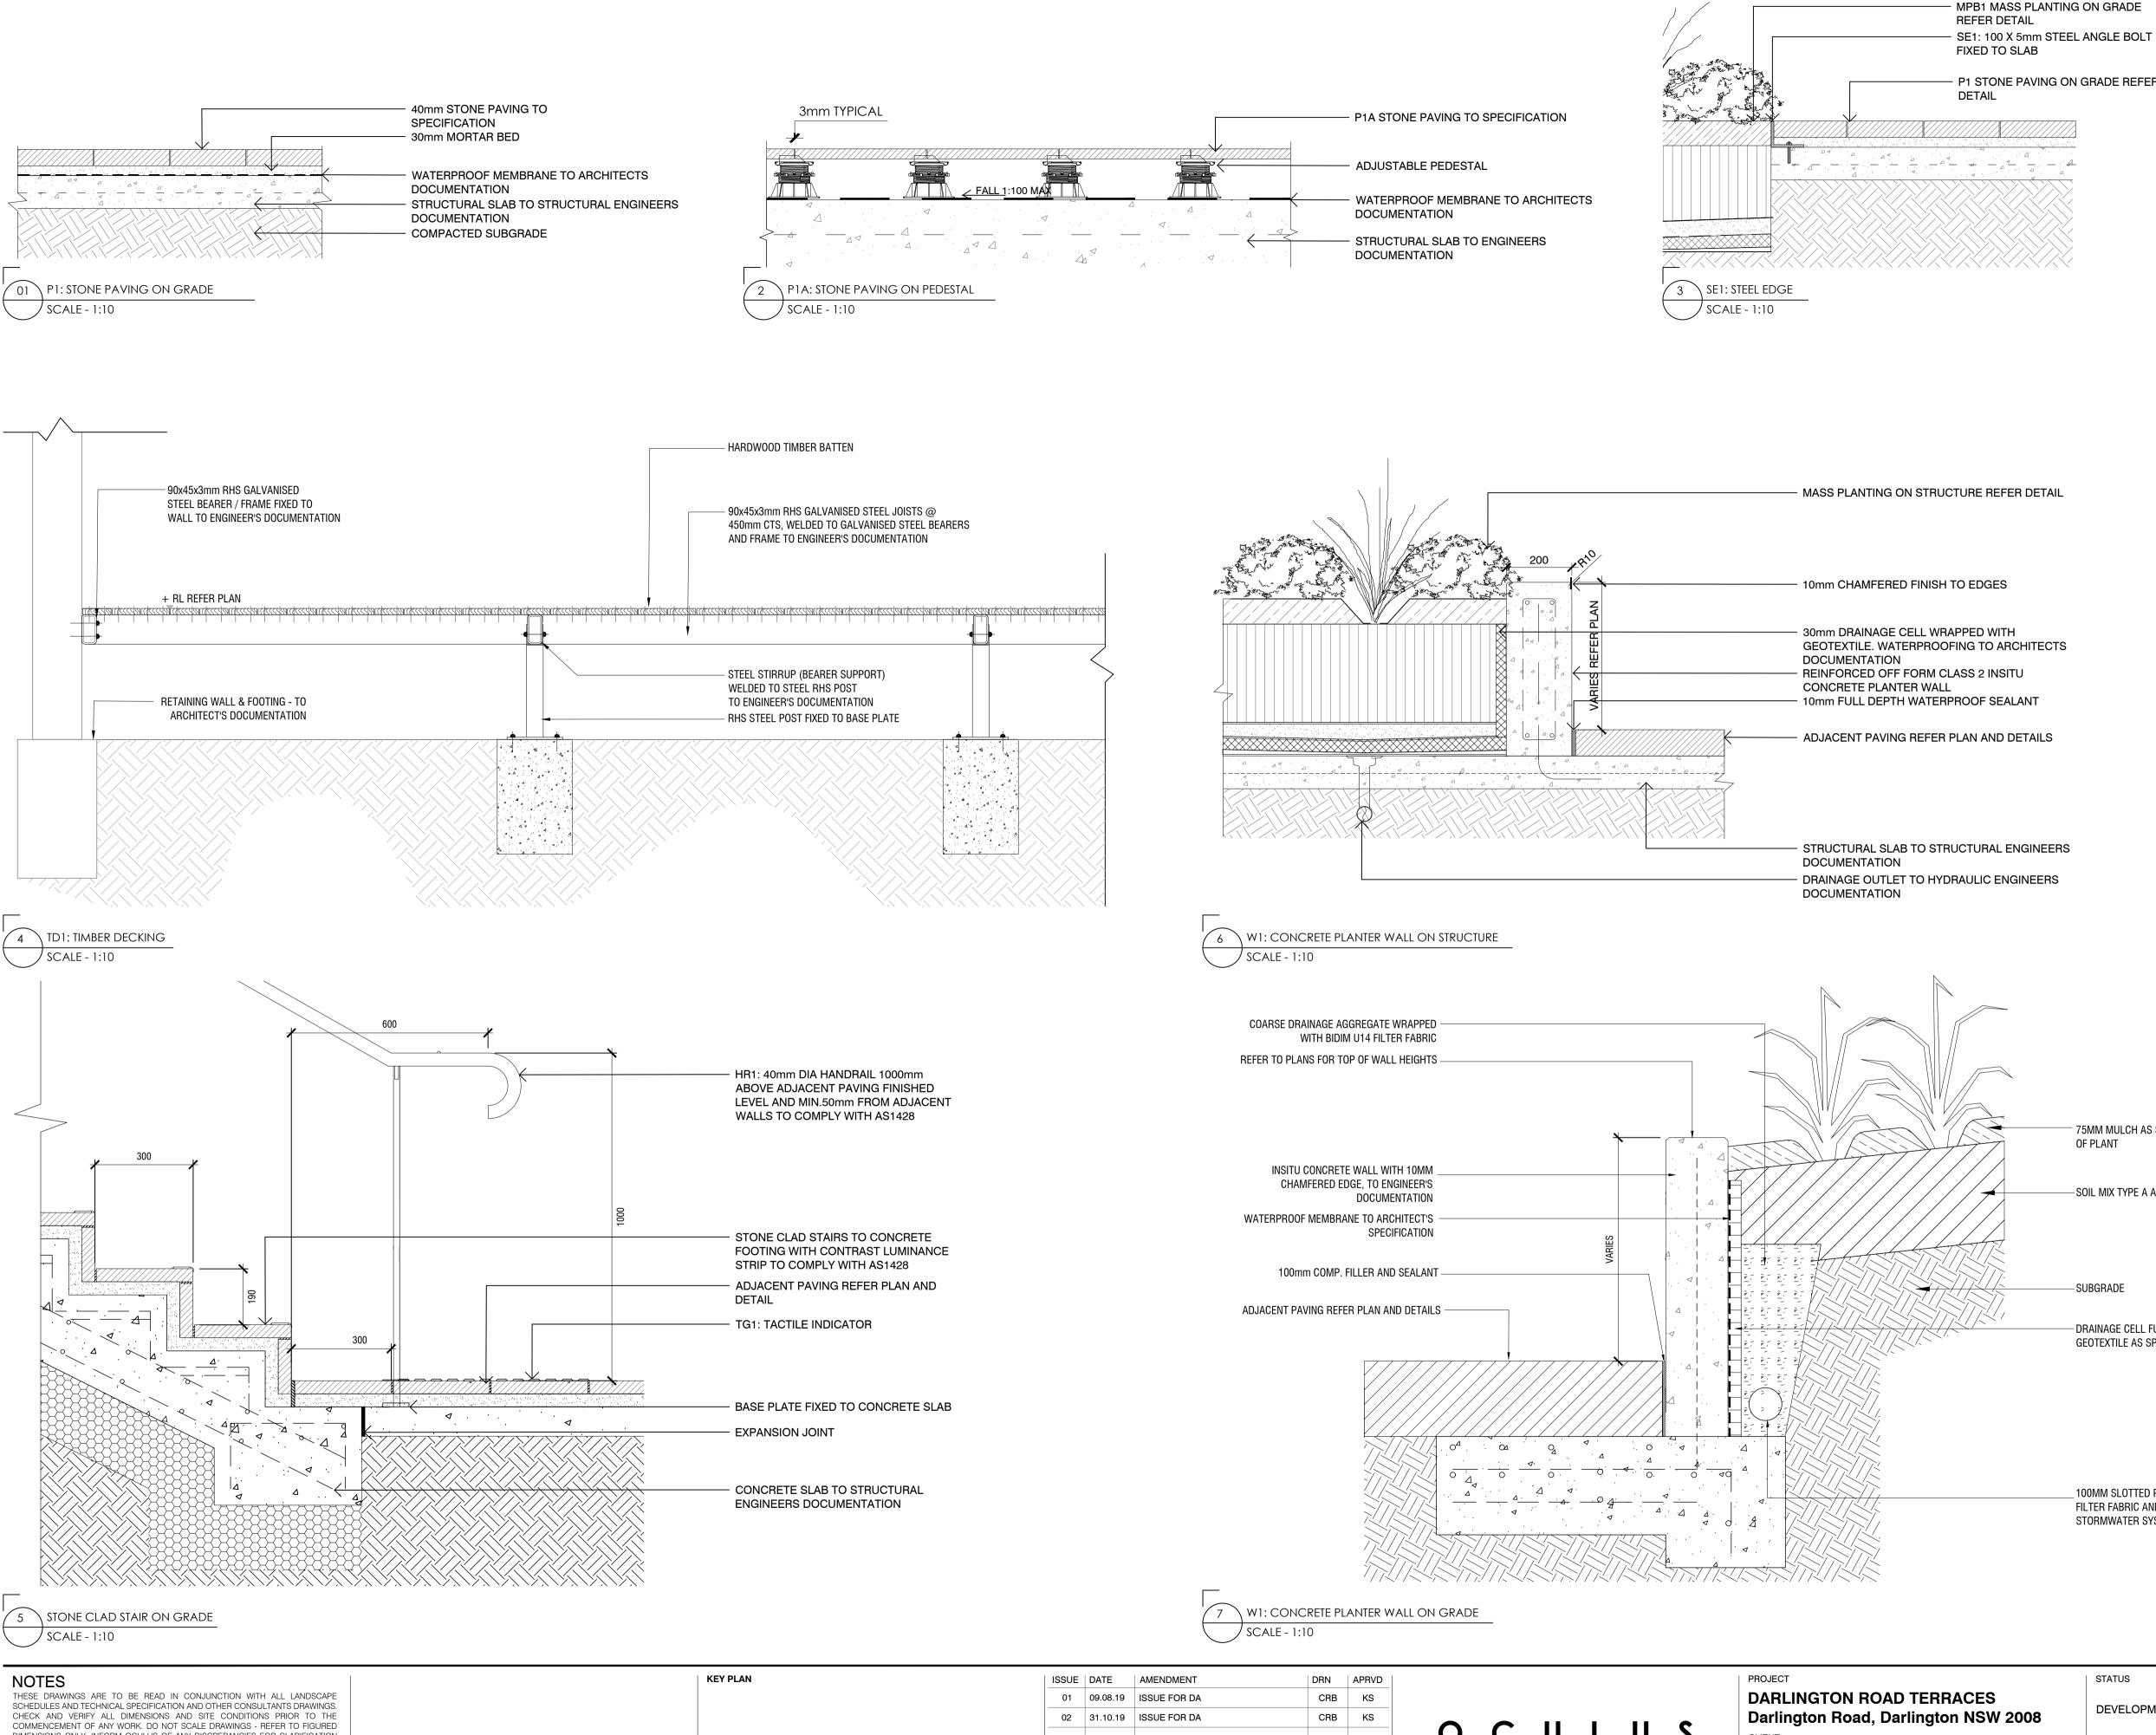

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STRUCTURAL SLAB TO STRUCTURAL ENGINEERS

	ISSUE	DATE	AMENDMENT	DRN	APRV
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	02	31.10.19	ISSUE FOR DA	CRB	KS
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level 1 / 5 wilson street, p.o. box 307, newtown, nsw 2042 p 02.9557.5533 australia@oculus.info SYDNEY MELBOURNE WASHINGTON

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ALLEN JACK AND COTTIER 79 Myrtle Street Chippendale NSW 2008

- P1 STONE PAVING ON GRADE REFER



75MM MULCH AS SPECIFIED, DISHED TO BASE OF PLANT -SOIL MIX TYPE A AS SPECIFIED

-SUBGRADE

- DRAINAGE CELL FULLY WRAPPED IN GEOTEXTILE AS SPECIFIED

100MM SLOTTED PIPE WRAPPED IN BIDIM U14 FILTER FABRIC AND CONNECTED TO STORMWATER SYSTEM






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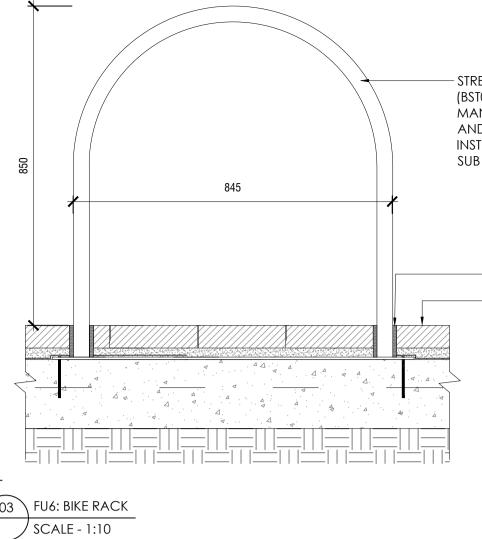
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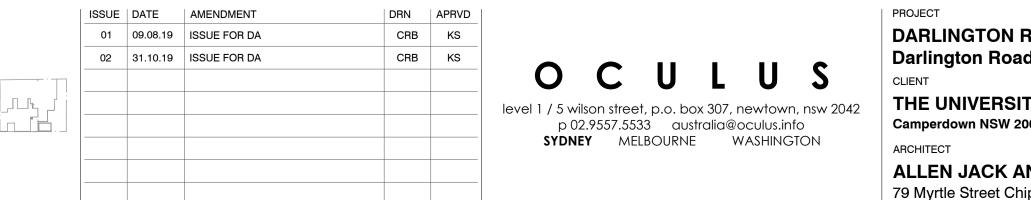
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DARLINGTON ROAD TERRACES Darlington Road, Darlington NSW 2008

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ALLEN JACK AND COTTIER 79 Myrtle Street Chippendale NSW 2008

- STREET FURNITURE SEMI HOOP (BST03) BIKE RACK. REFER TO MANUFACTURERS DETAILS AND SPECIFICATIONS FOR INSTRUCTIONS REGARDING SUB SURFACE MOUNTING

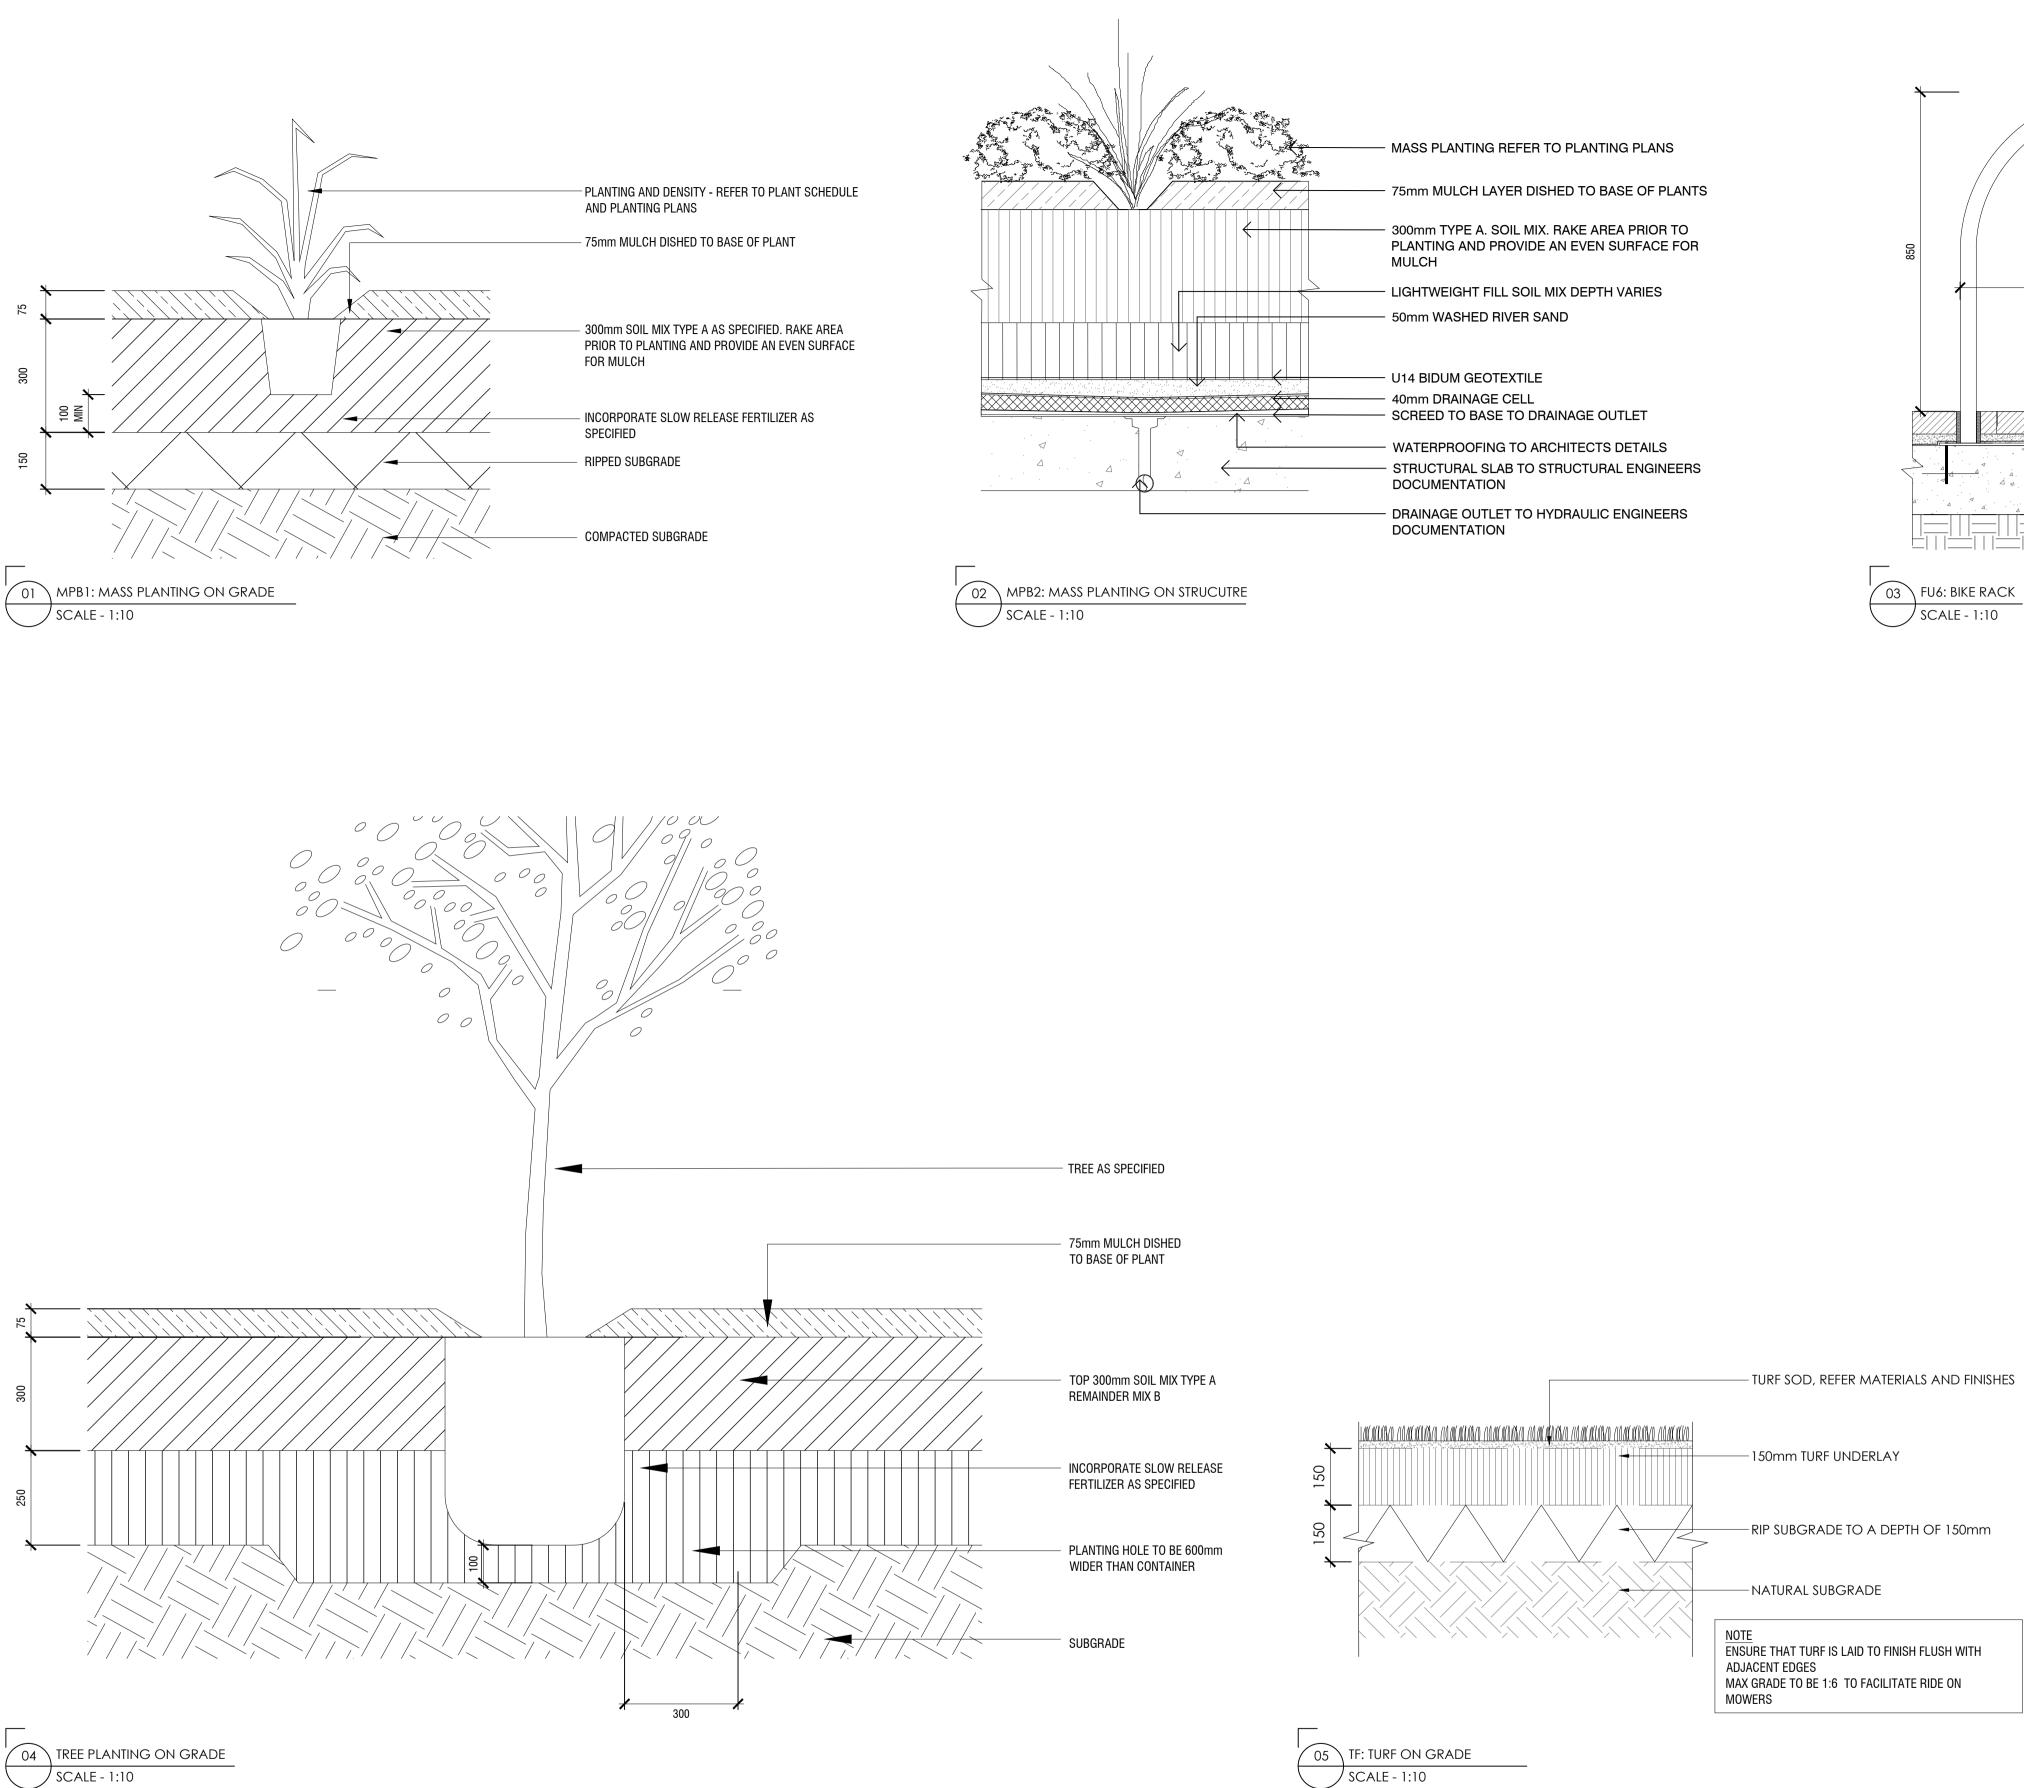-10mm SILICON JOINT

- ADJACENT PAVING REFER Plans







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Granted: 29 January 2021 Sheet No: 48 of 64


STATUS	DRAWING SOFTSCAPE DETAILS		
DEVELOPMENT APPLICATION			
DRAWING SCALE	NORTH POINT	PROJECT № S14-028	SHEET SIZE A1
		DRAWING №	ISSUE
		L802	02



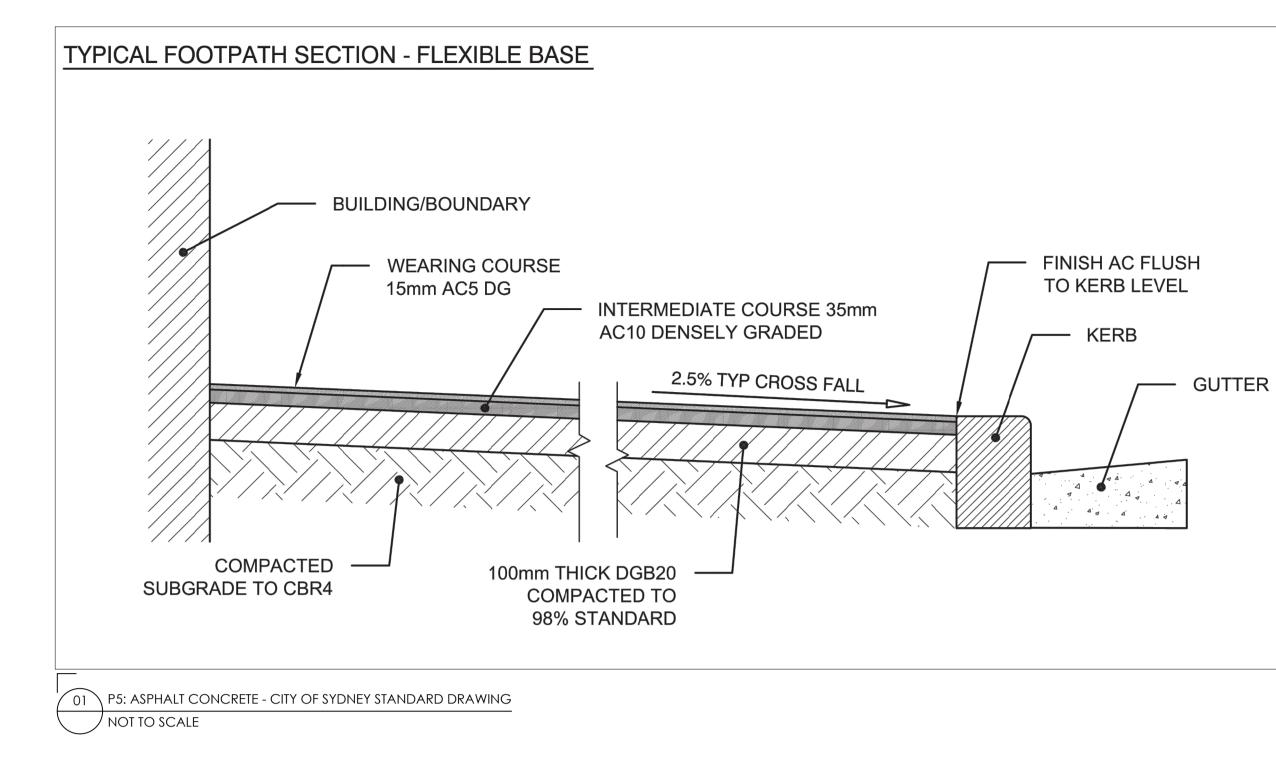

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	ISSUE	DATE	AMENDMENT	DRN	APRVD		PROJECT
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	02	31.10.19	ISSUE FOR DA	CRB	KS		Darlington Road, Darlington NSW 2008
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						level 1 / 5 wilson street, p.o. box 307, newtown, nsw 2042	THE UNIVERSITY OF SYDNEY
						p 02.9557.5533 australia@oculus.info	Camperdown NSW 2006
						SYDNEY MELBOURNE WASHINGTON	ARCHITECT
							ALLEN JACK AND COTTIER
							79 Myrtle Street Chippendale NSW 2008

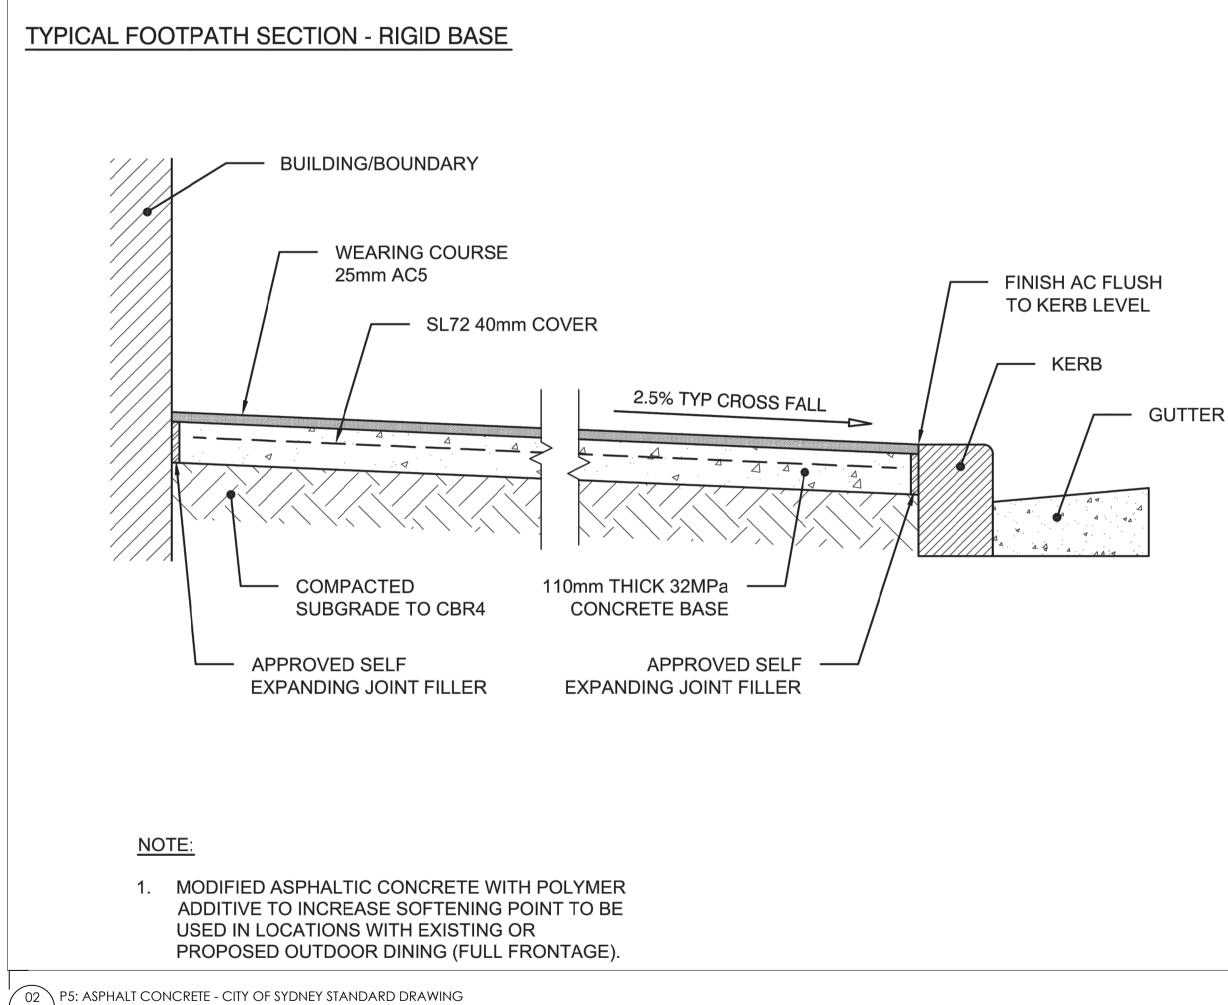

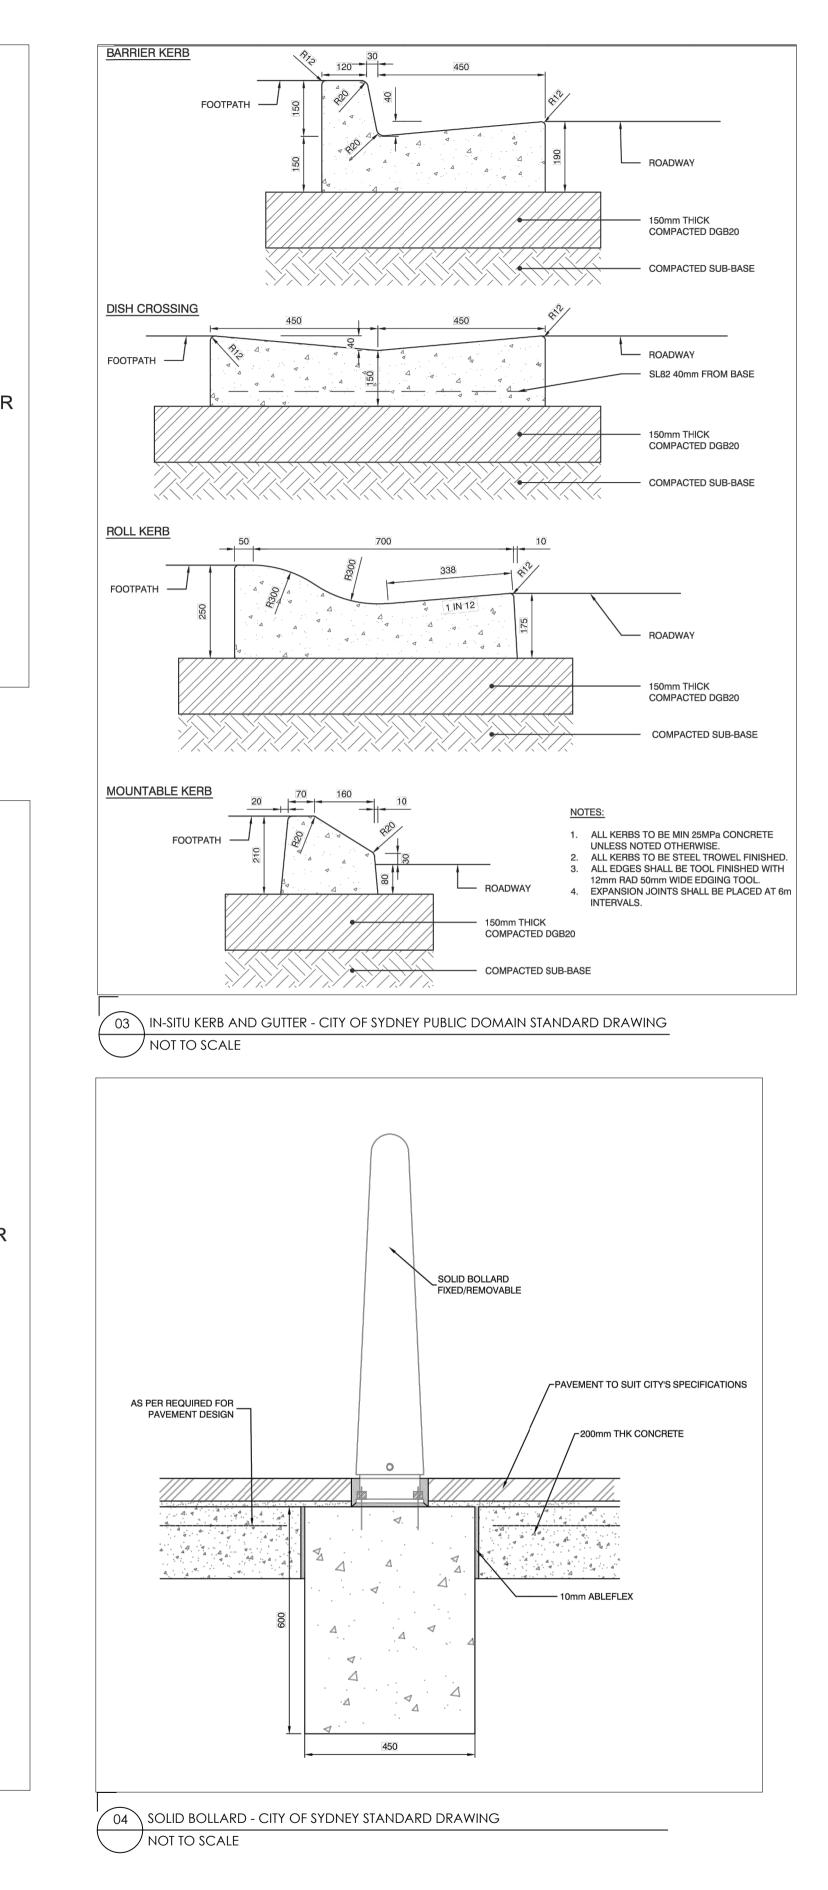
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Granted: 29 January 2021 Sheet No: 49 of 64

STATUS	DRAWING CITY OF SYDNEY DETAILS		
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		DRAWING №	ISSUE
		L803	02





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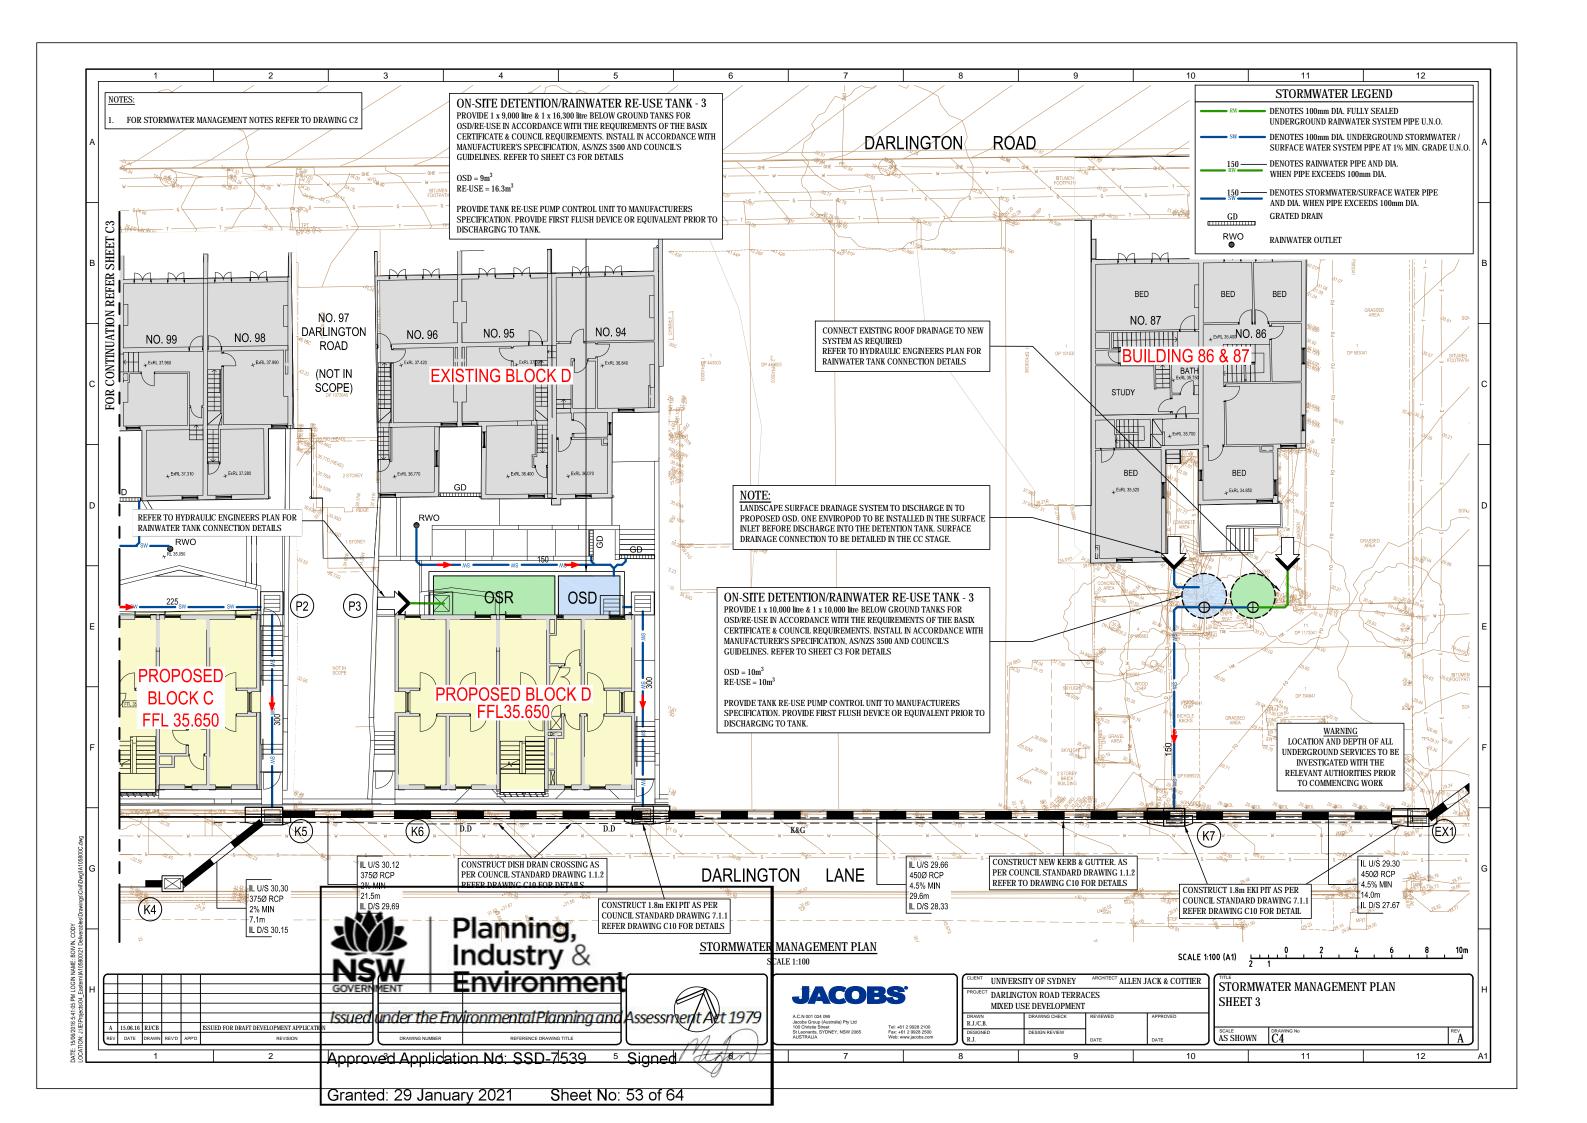
<u>PLAN</u> 1:50				
APPROVED SELF EXPANDING PROVIDE TOOL J AT CHANGE OF O 1 CONCRETE DRIVEWAY REFER TABLE FOR DETAILS COMPACTED SUB-BASE TO CBR4 MIN. 100mm THICK COMPACTED DGB20 ASE CONSTRUCTION 15mm EPOXY MODIFIED SAND/C	OINT BRADE 200 TYP	450 450 GUTTER APPROVED SE	ERED LIP. LIP CAN BE SADJACENT TO CYCL	
02 VEHICULAR CROSSING - CITY OF SYDNEY STAND	ARD DRAWING			GOVERNMENT Issued under the
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			8	Granted: 29 Ja
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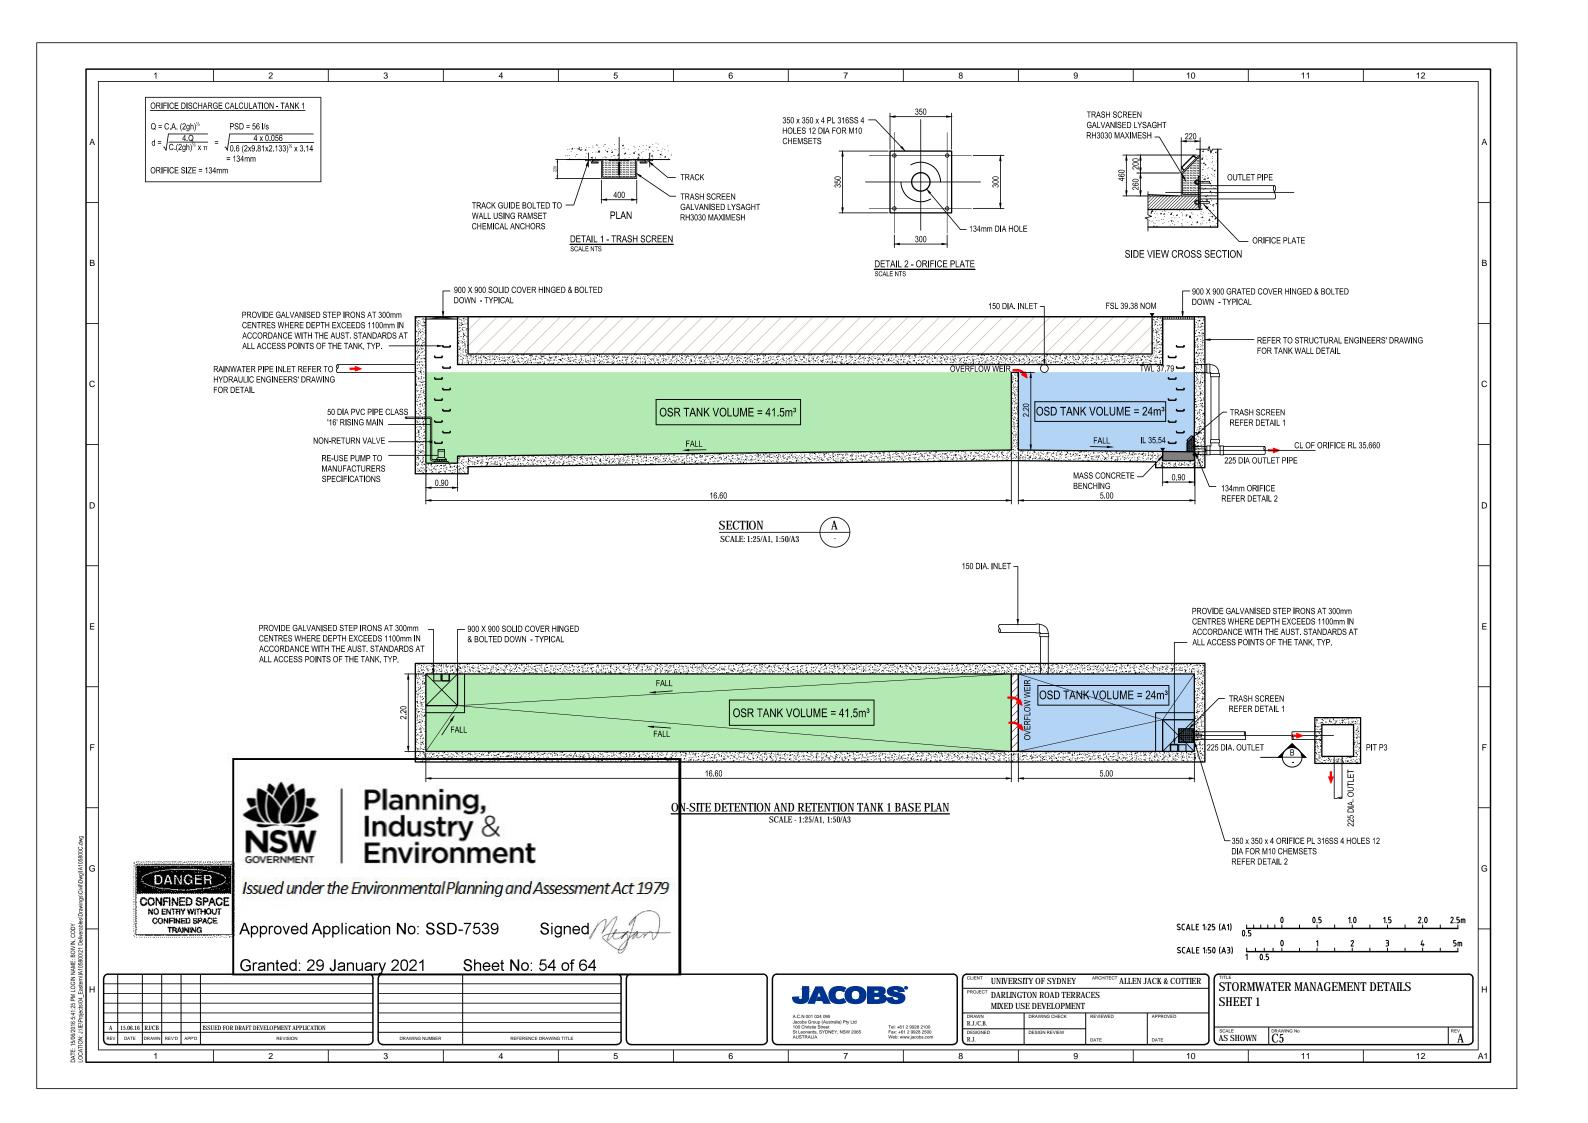
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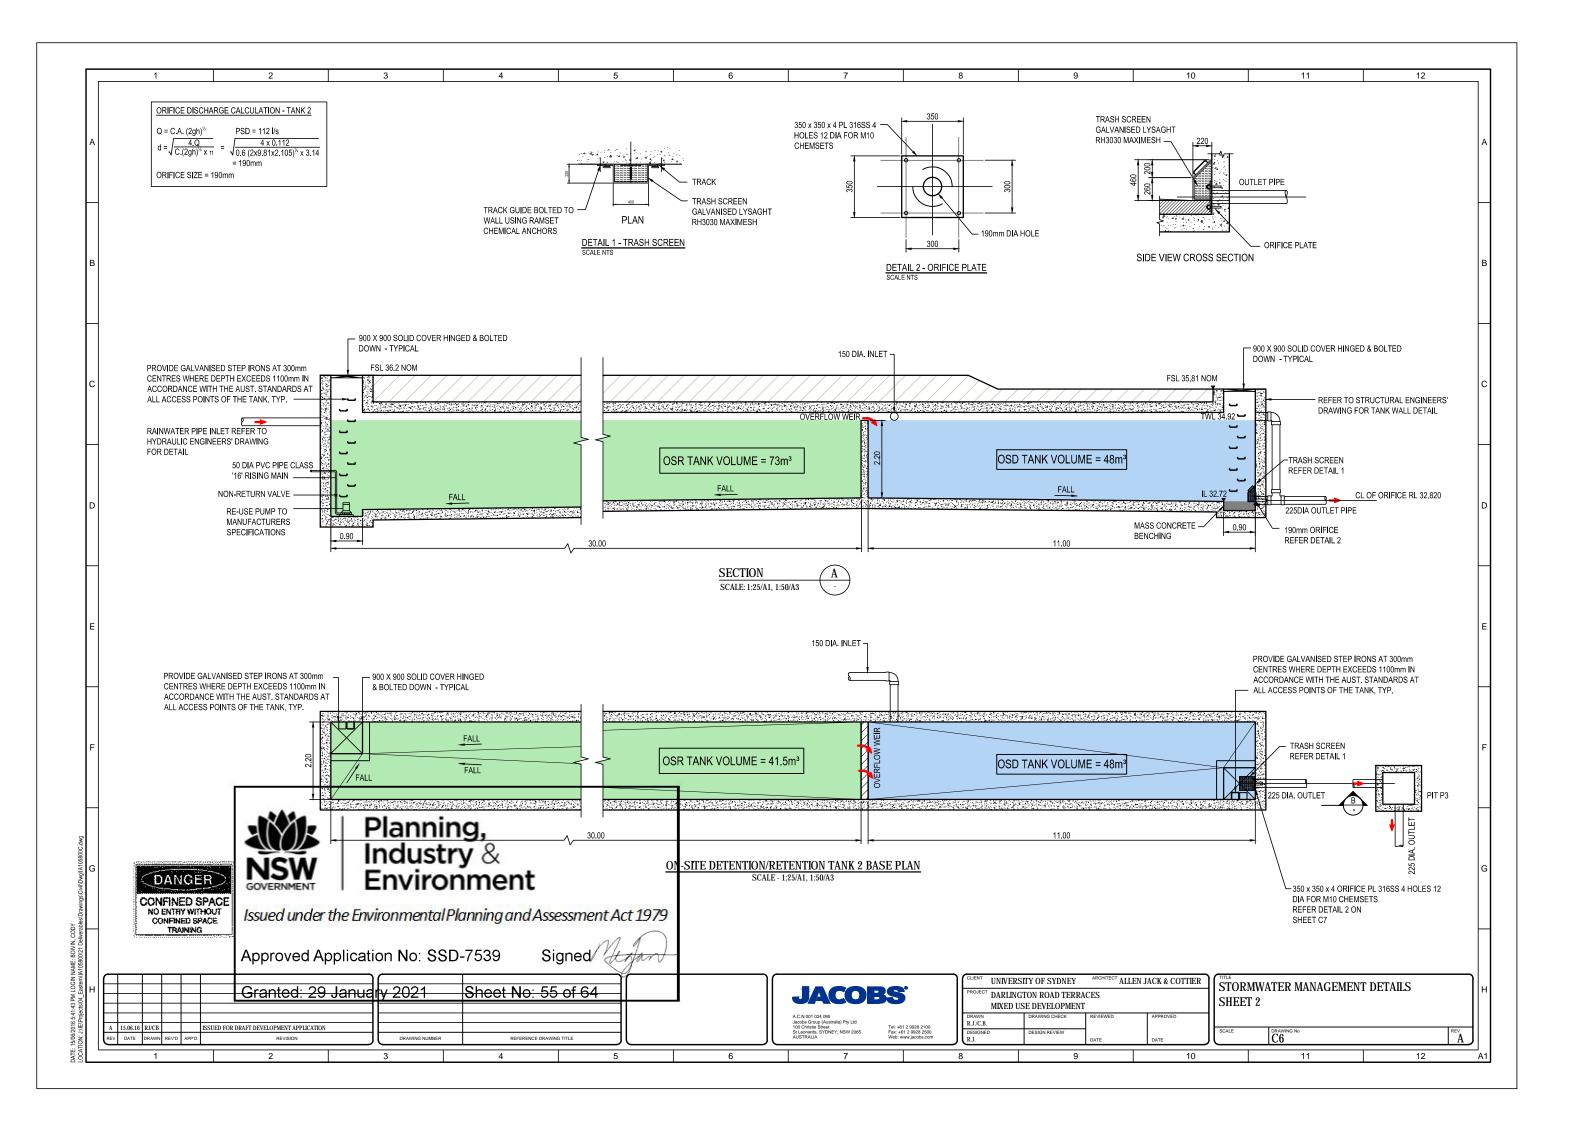
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DRAWING SCALE	NORTH POINT	PROJECT № S14-028 DRAWING № L804	SHEET SIZE A1 ISSUE 02

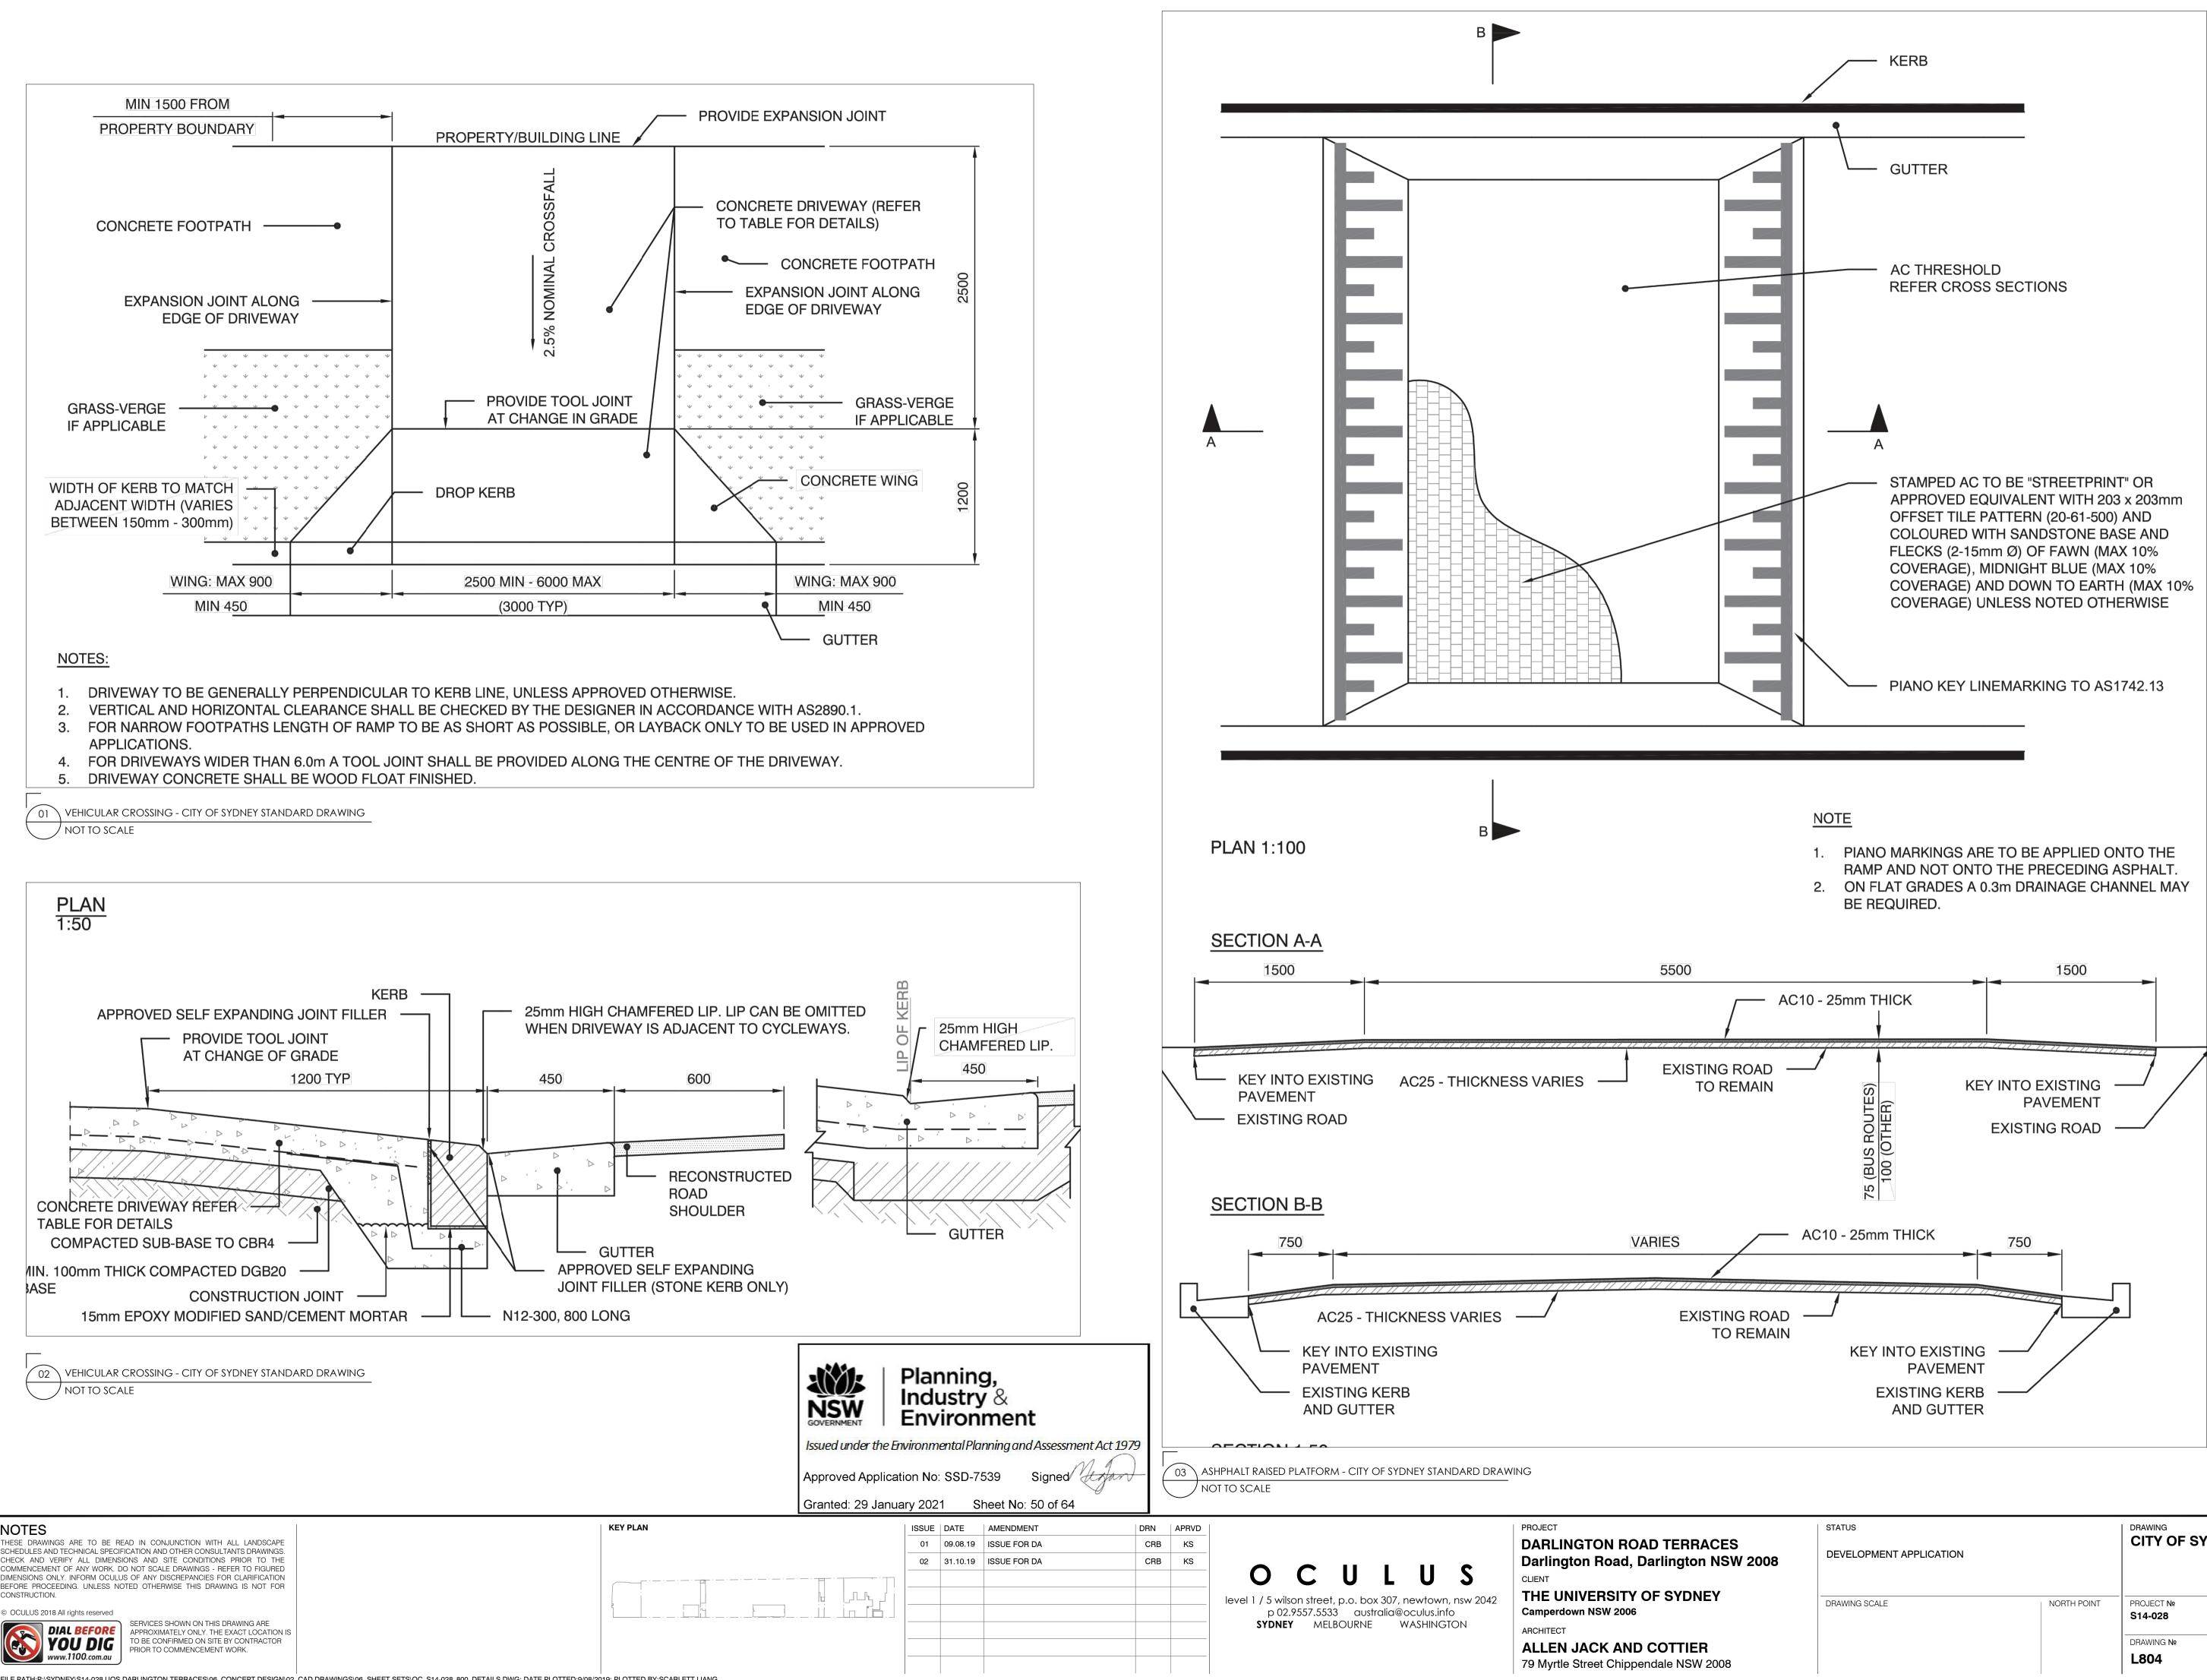







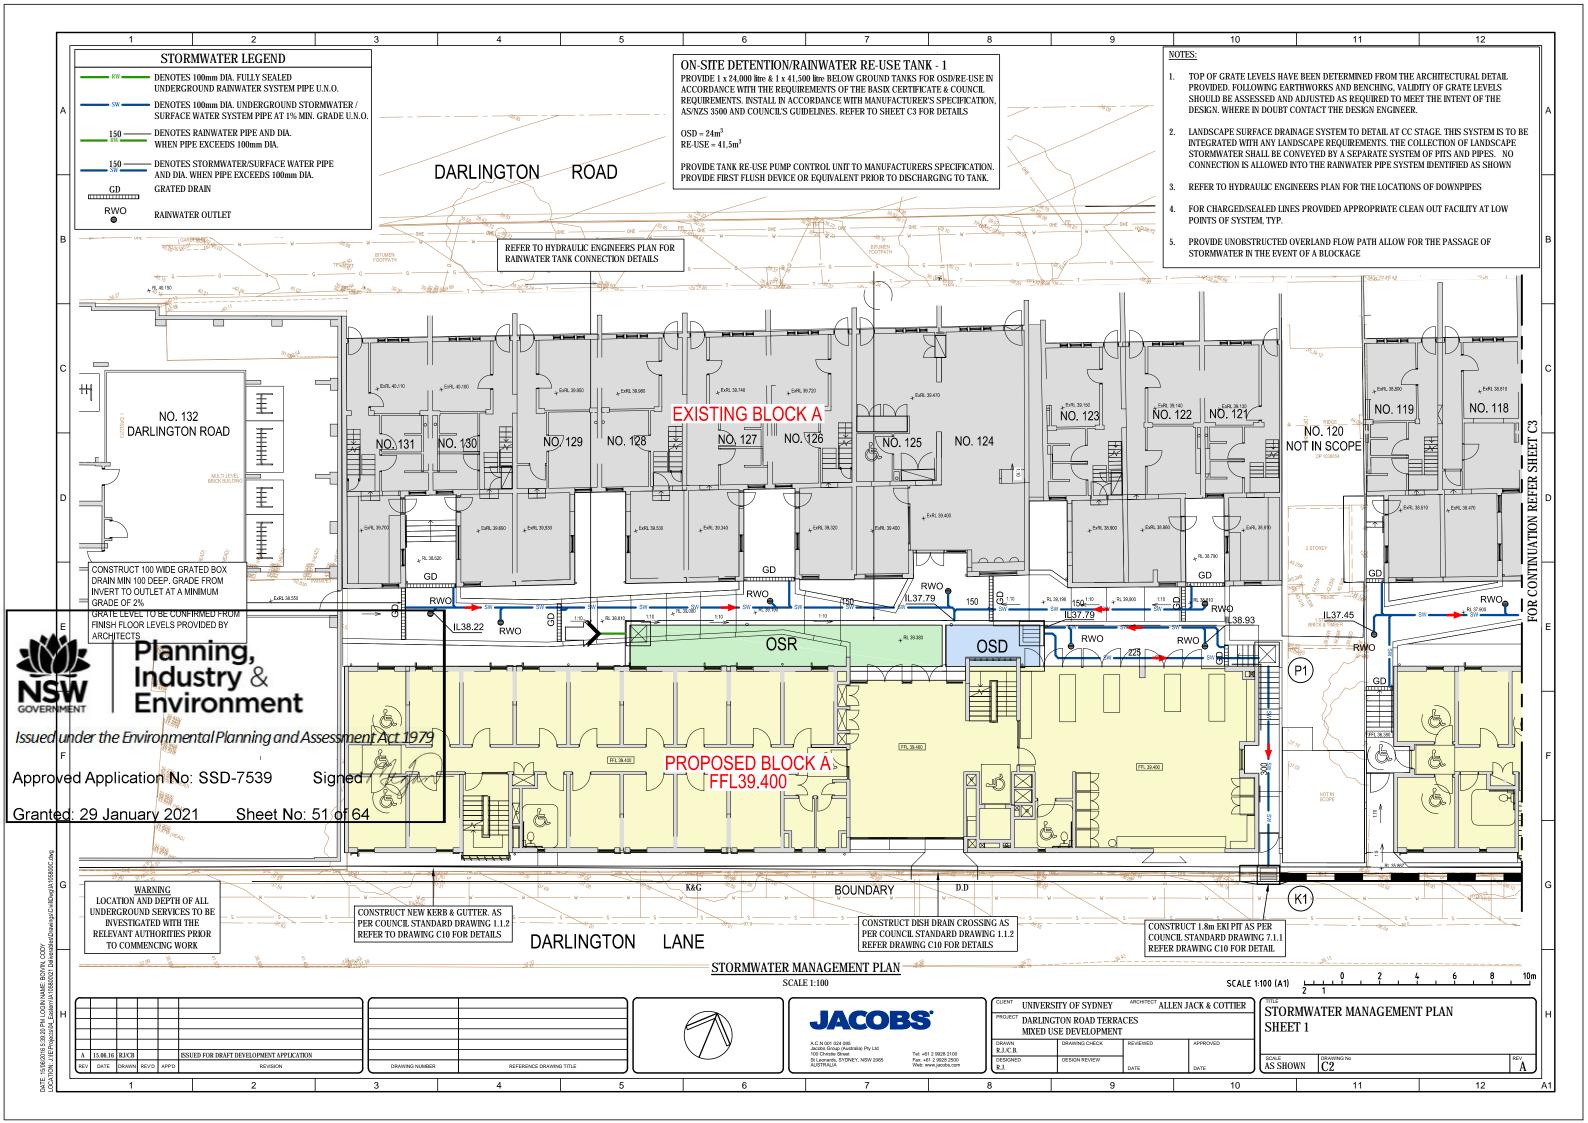

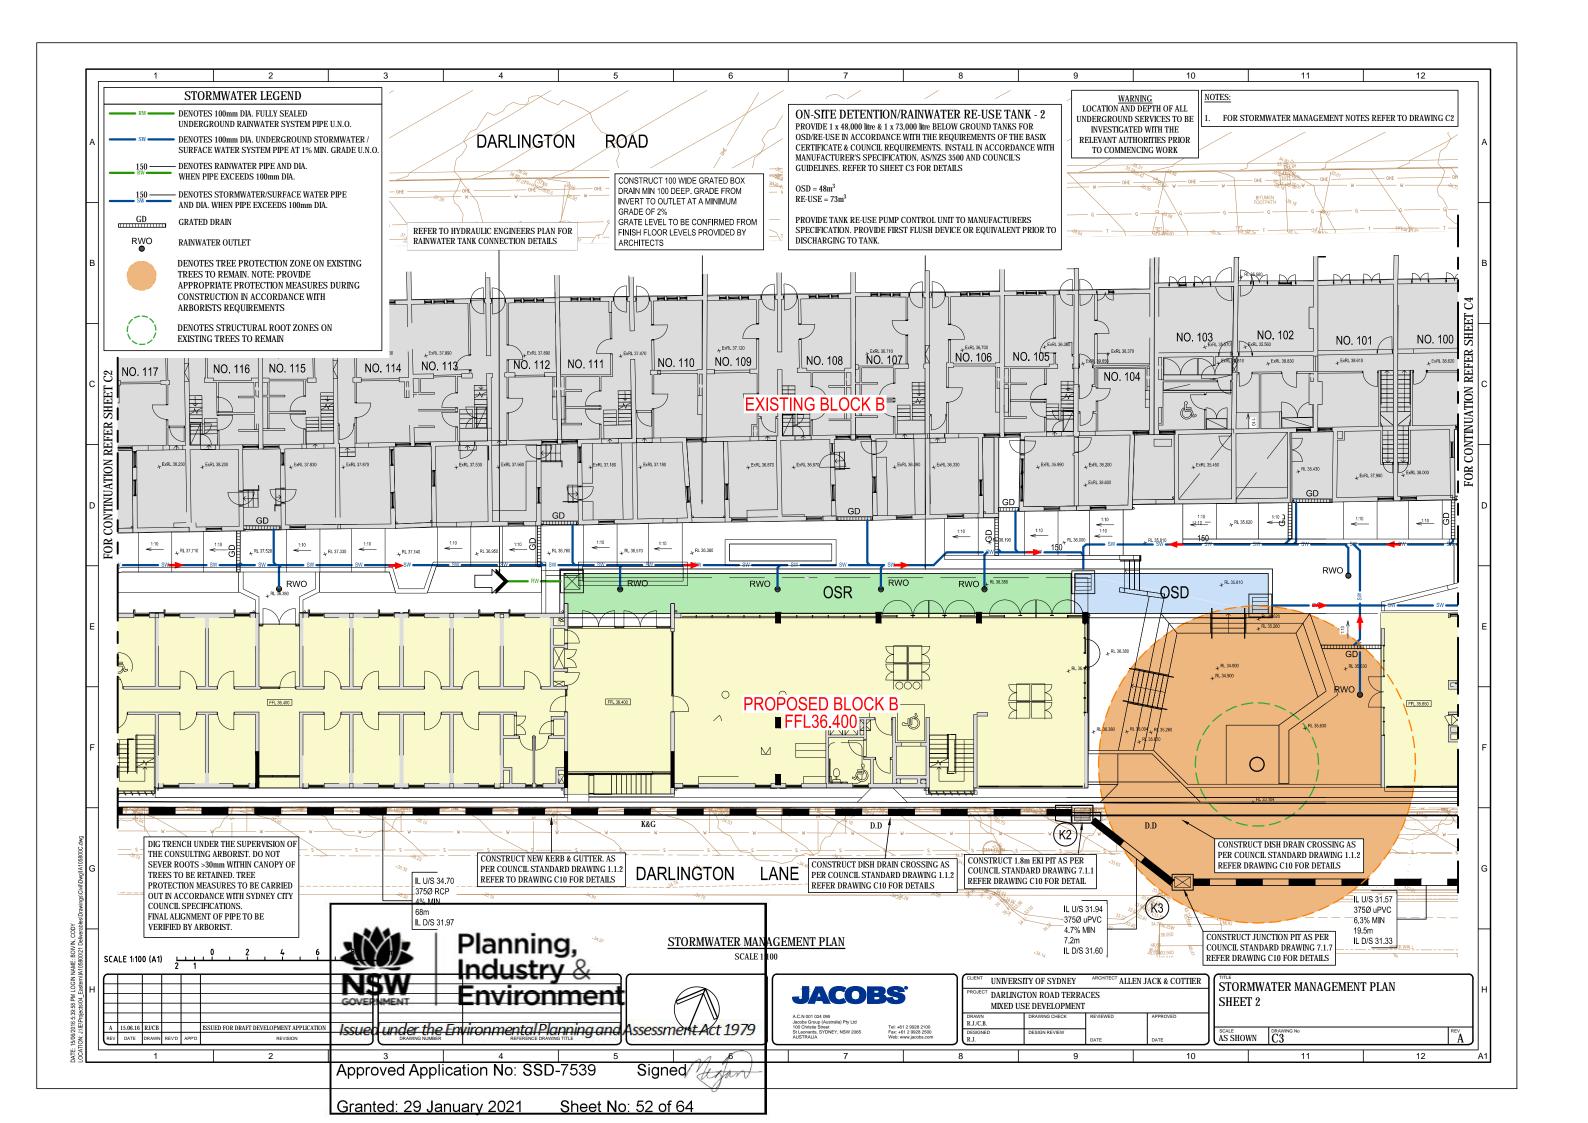


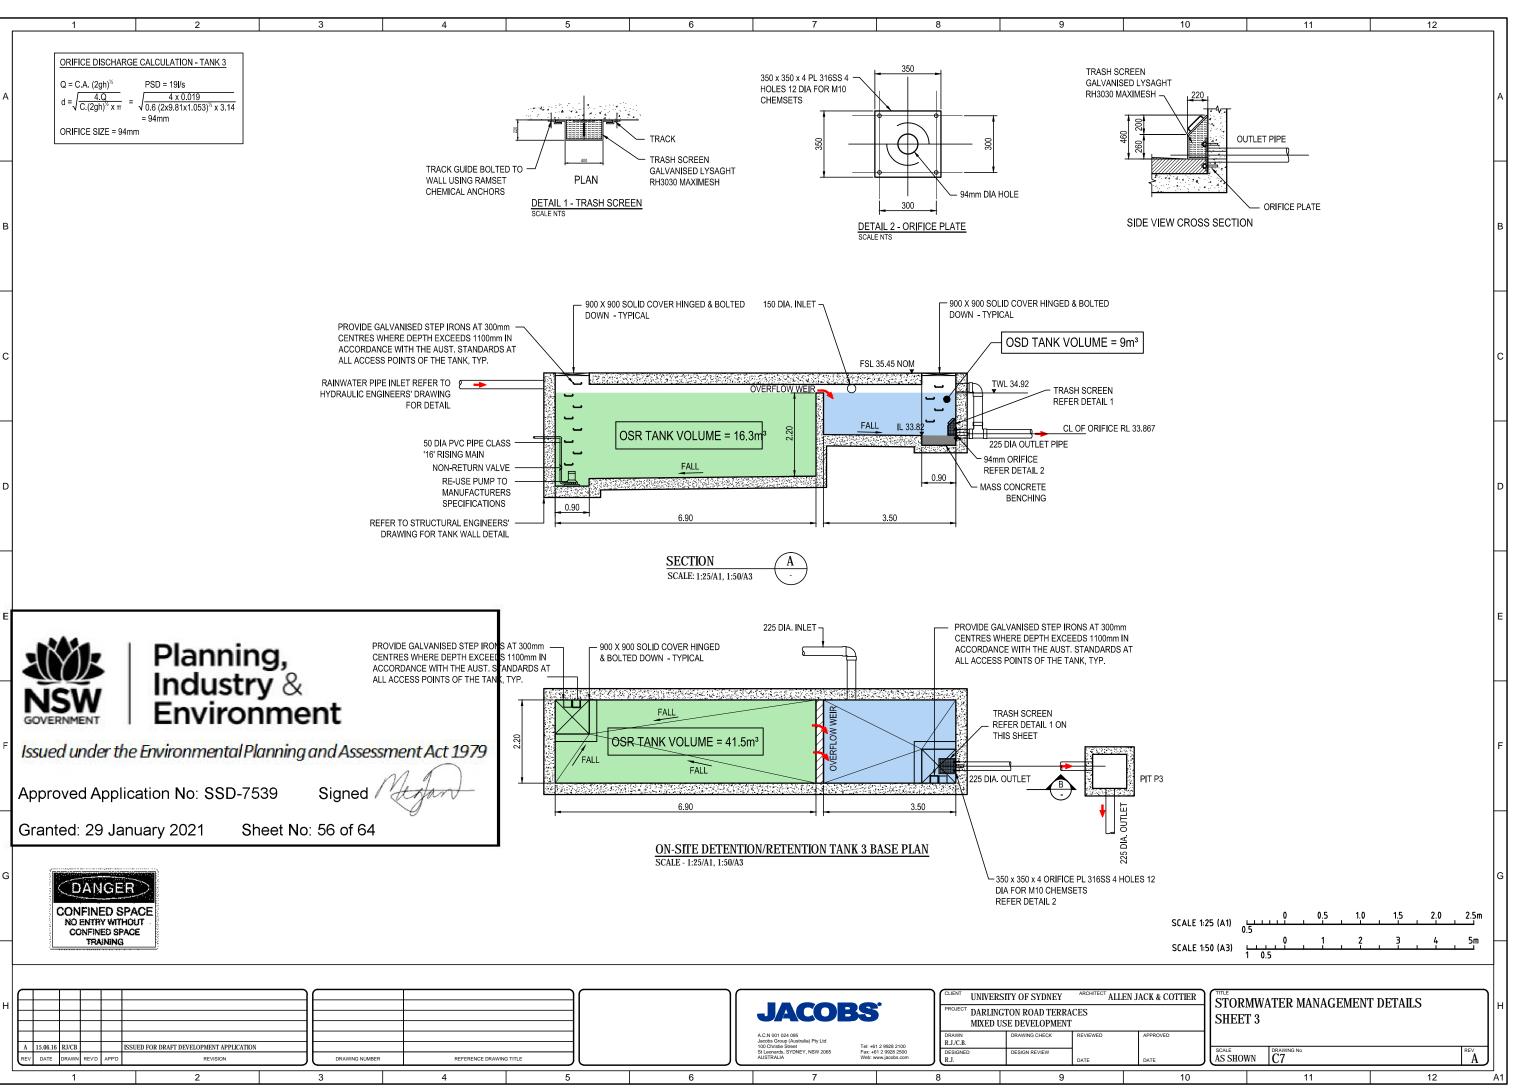

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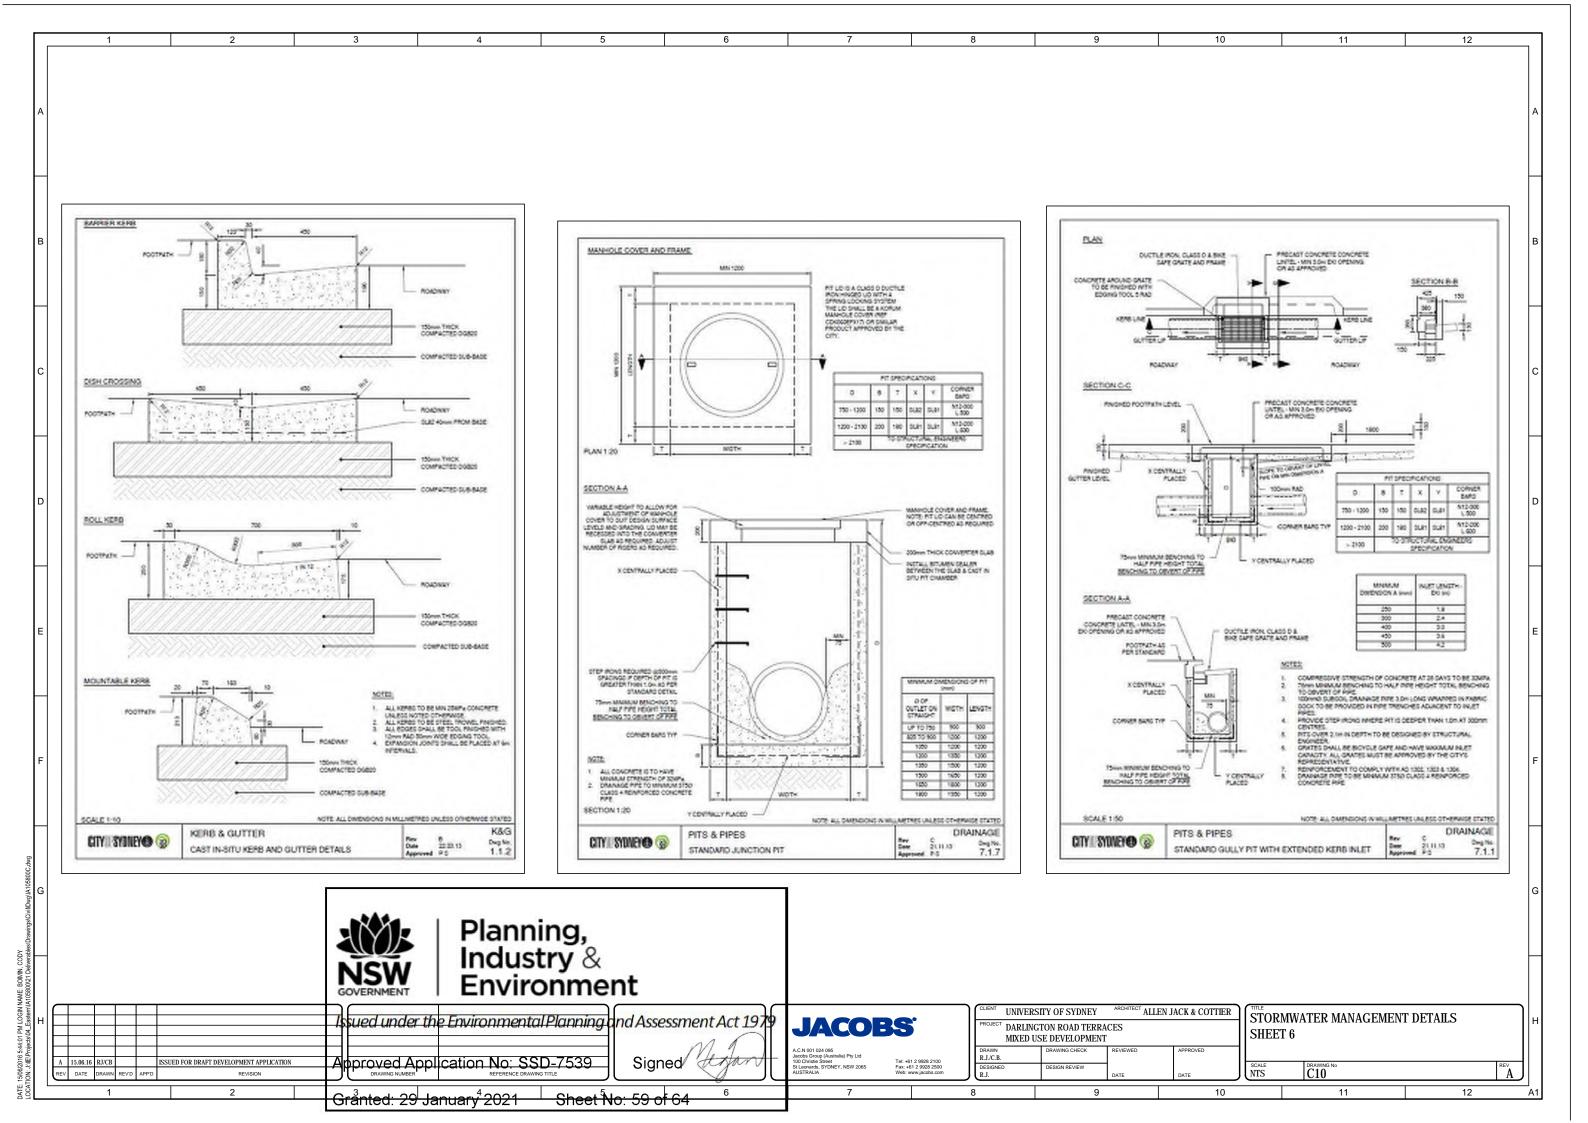
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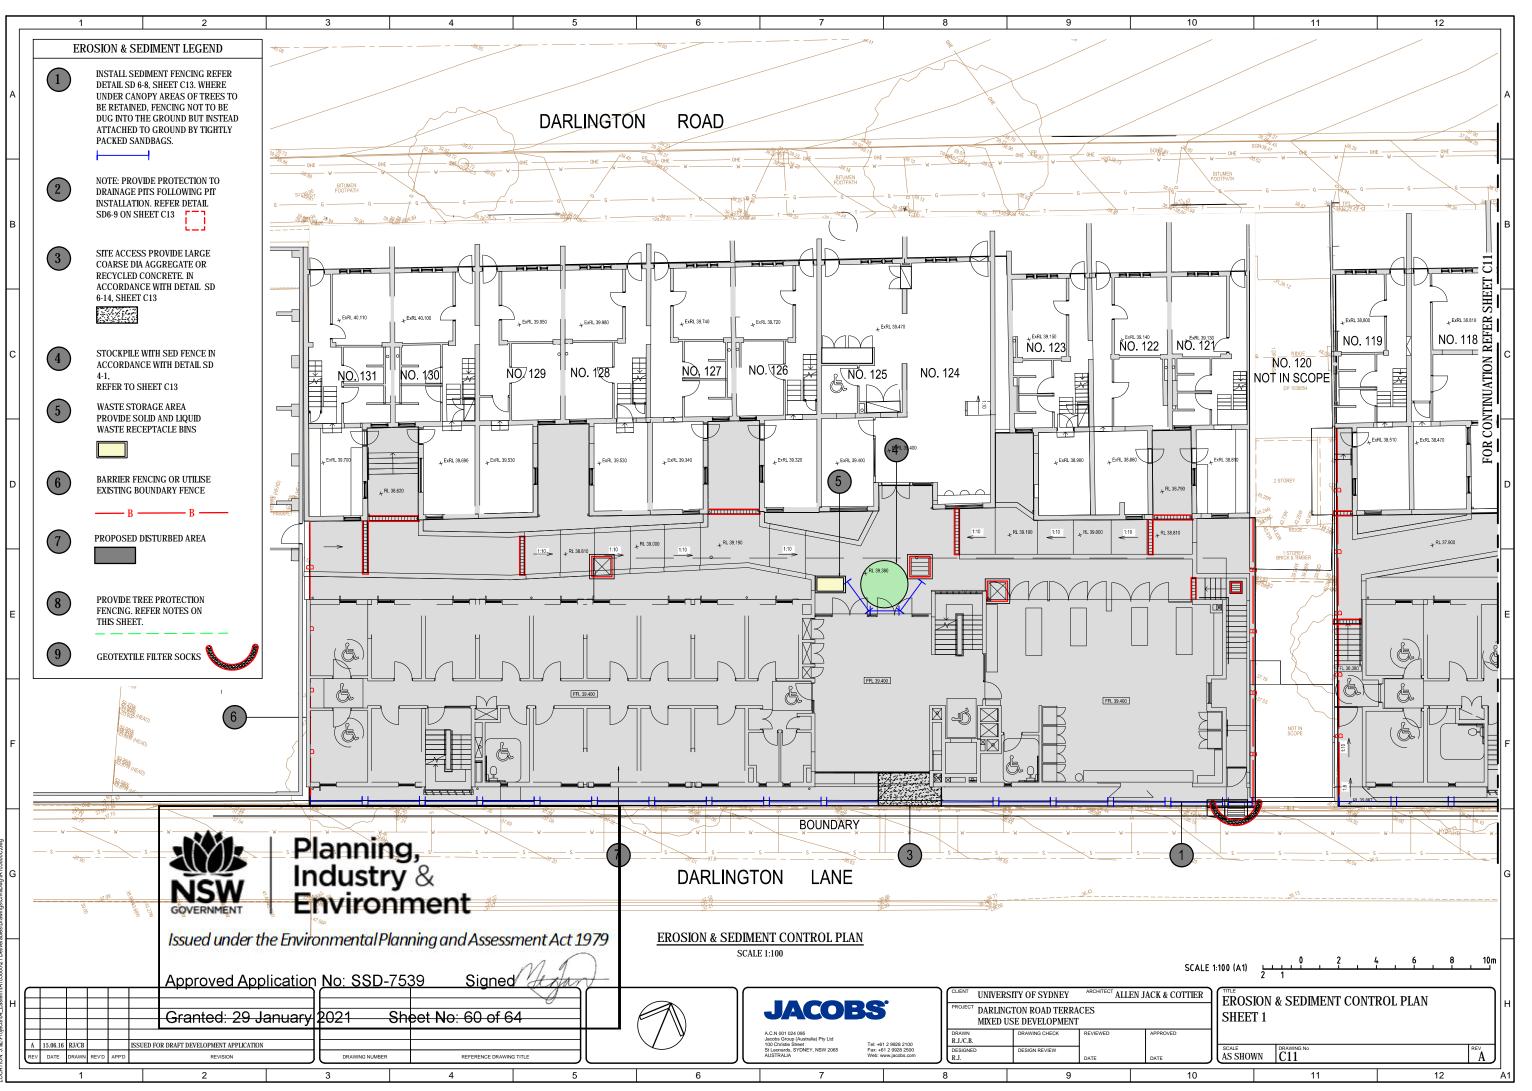

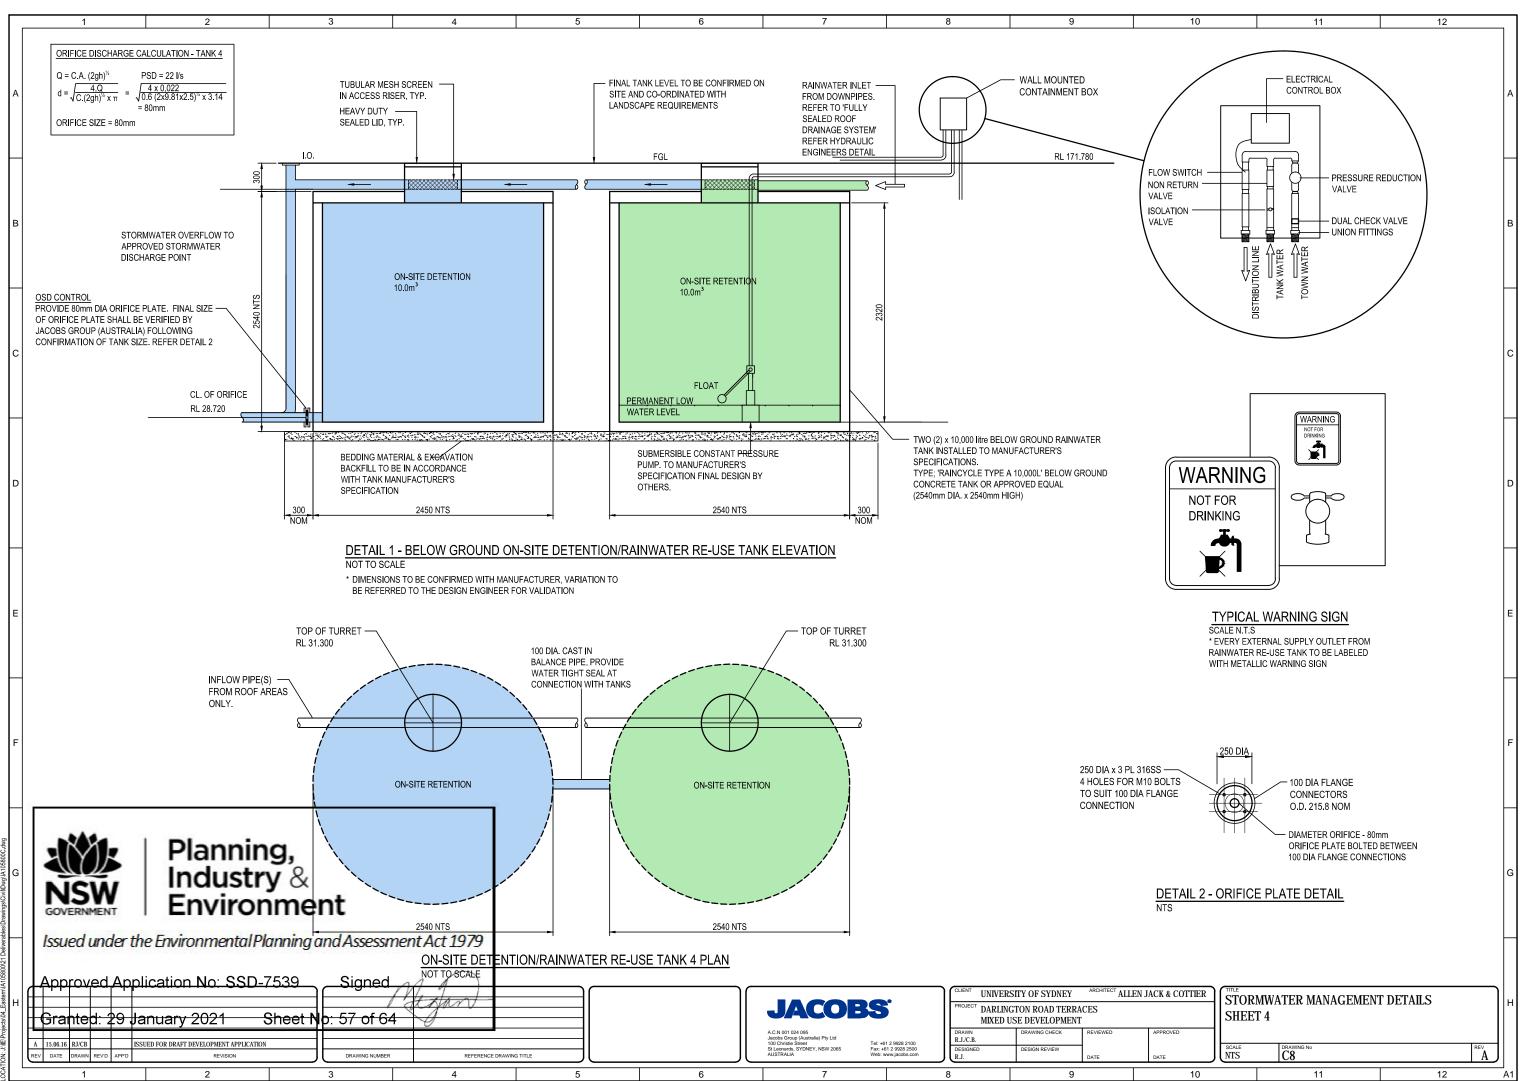
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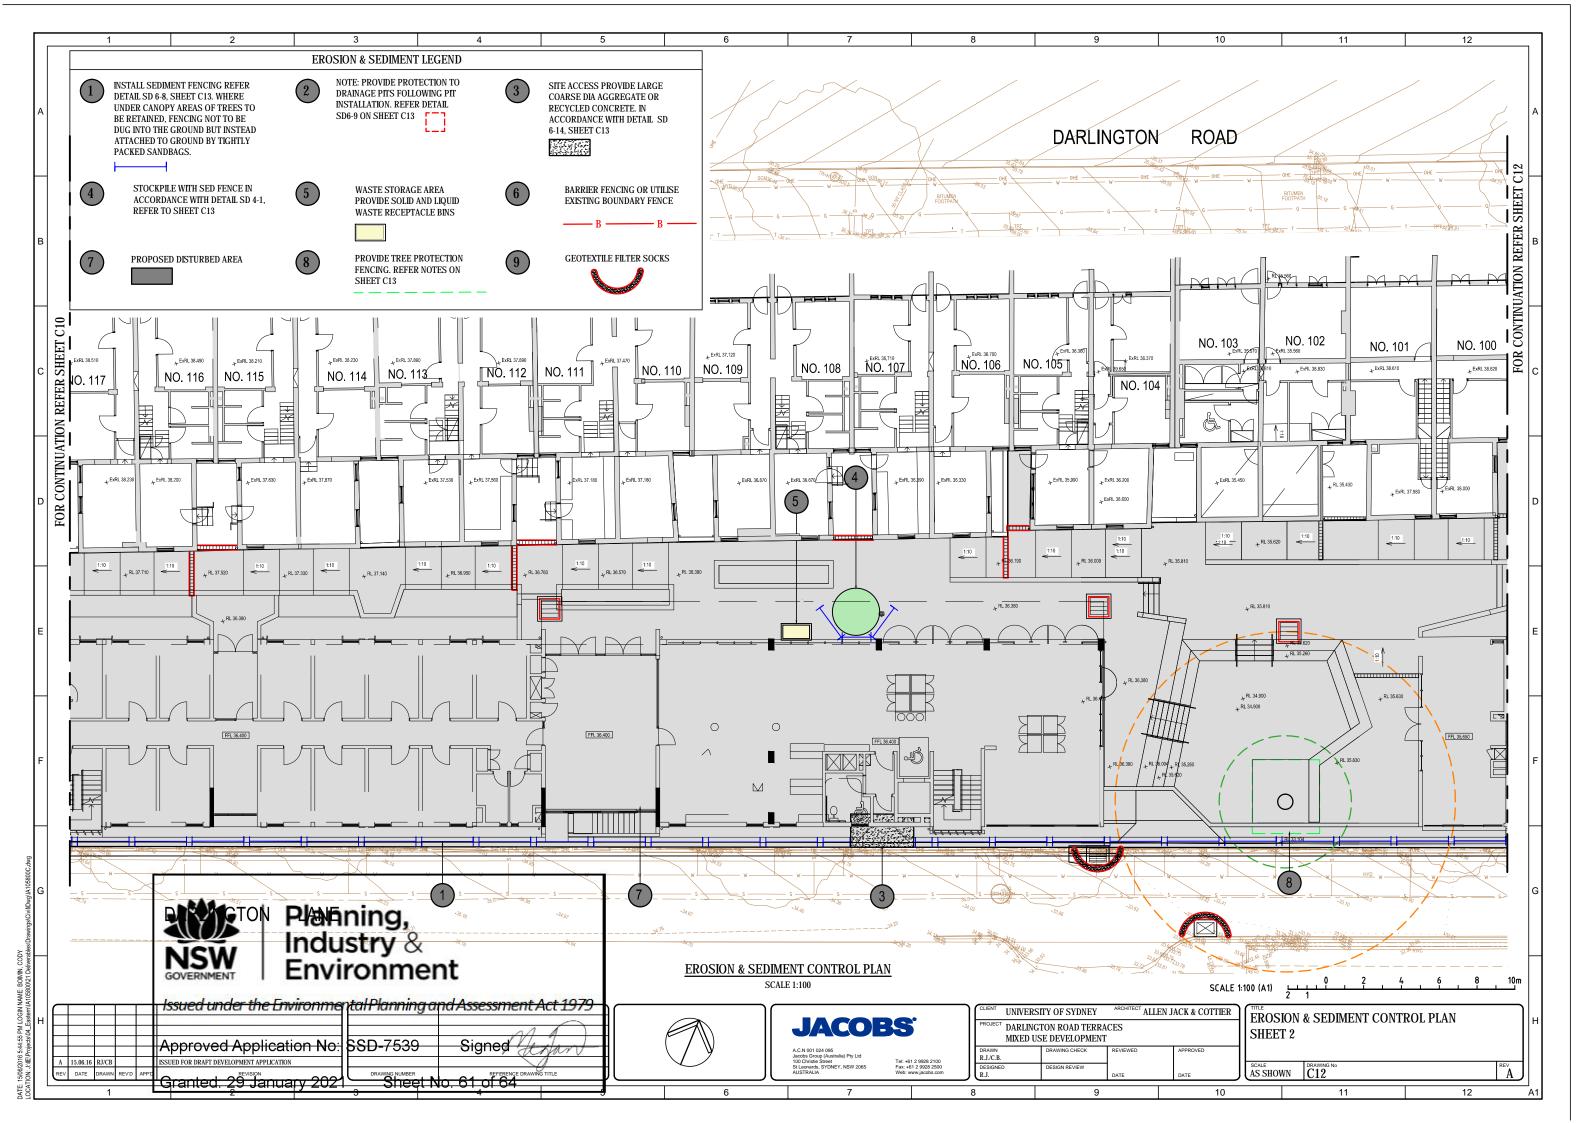
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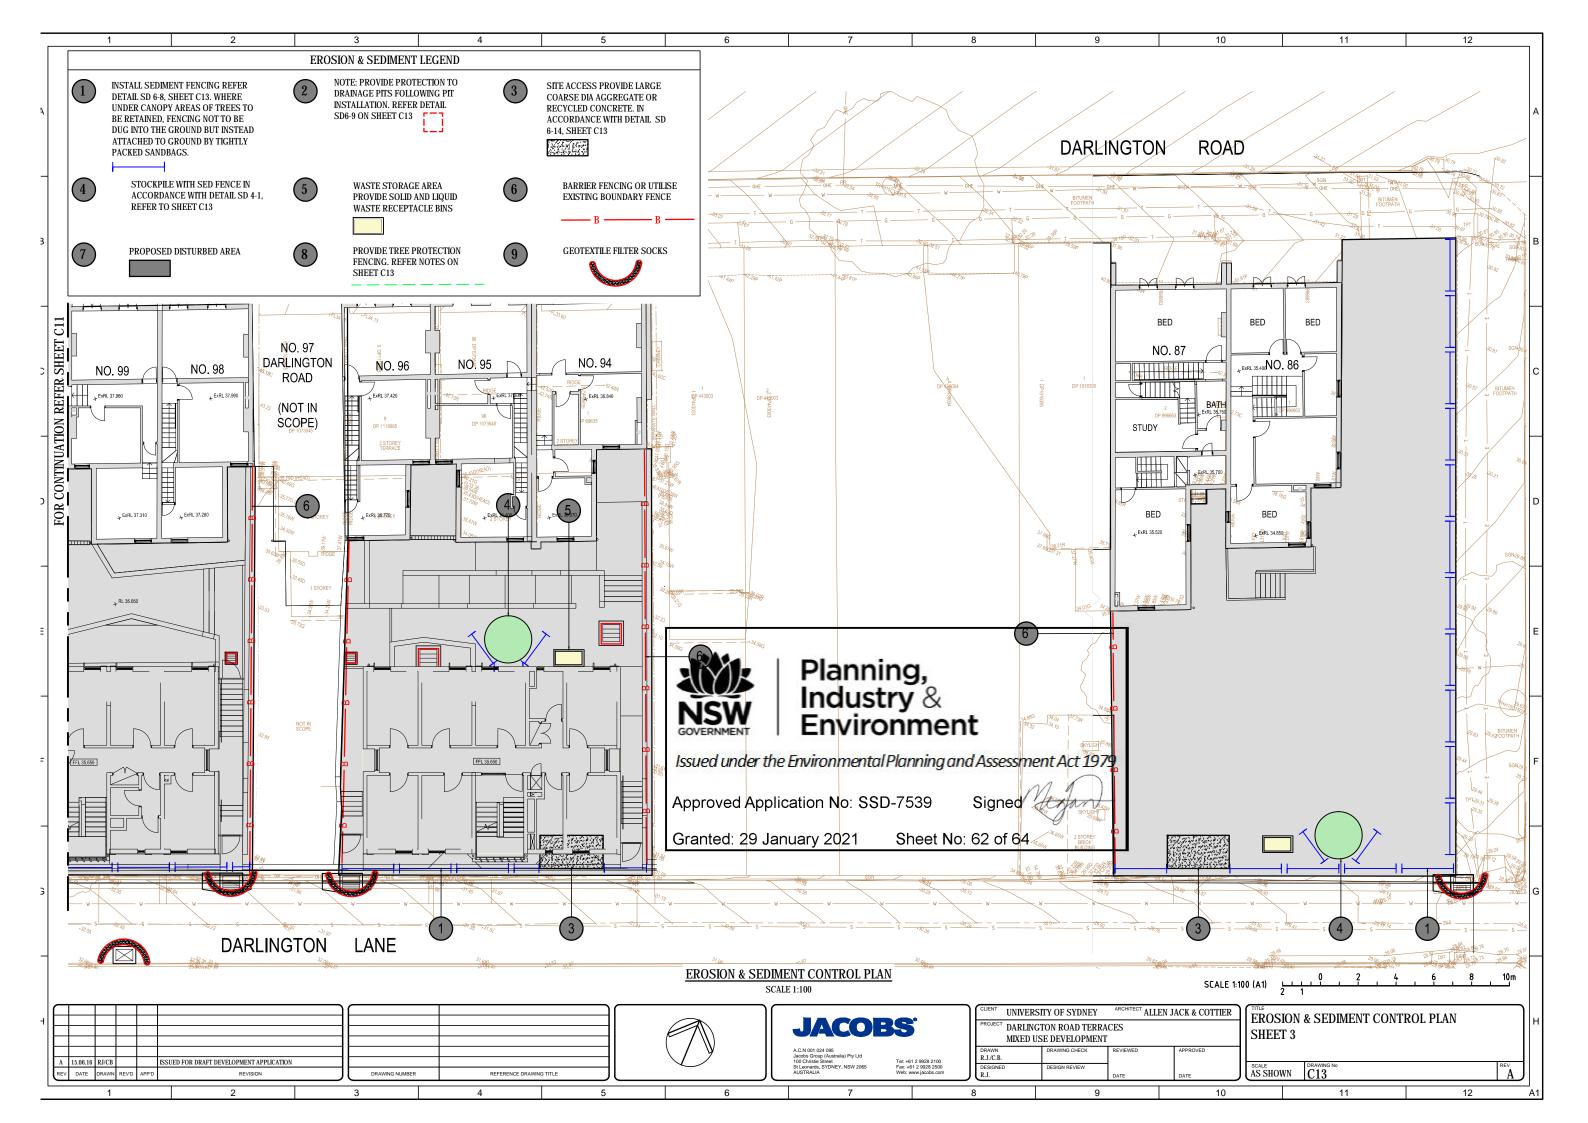
10	11		12	
10			12	
NIMUM PIPE COVE	R-AS/NZS	3500.3:2003	TABLE 7.1	A
		Cast iron,	Other	
ATION	0	luctile iron,	authorised	
	gal	vanised steel	products*	
		MINIMUM DEPTH	I OF COVER	
Not subject to vechicle load	lings			
Without pavement -				
(i)For single dwellings (ii) For other then item	(i)	NIL	100	E
With pavement of brick or		NIL	300	
unreinforced concrete		NIL#	50#	
Subject to vehicular loading	gs			⊢
Other then roads -				
(i)Without pavement (ii) with pavement of -		300	450	
(A) Reinforced concr heavy vehicle loa		NIL#A	100 #∆	
(B) Brick or unreinfor	ced		100#4	
concrete for light loading	vehicular	NIL#∆	75#∆	
Roads -				
(i)Sealed (ii) Unsealed				
		300	500∆	
Subject to construction equ embankment conditions	ipment or	300	500∆	
		300	500∆	
Indicates overlay above t	op of pipe of not le	ess than 50mm thick		
Below underside of pave	ment			
Subject to compliance wi	th AS1762, AS20.	33, AS/NZS2566.1, A	AS3725, AS4060	
IMUM INTERNAL [DIMENSIONS	S FOR STORM	1WATER AND	
IMUM INTERNAL [INLET PITS - A				E
INLET PITS – A		0.3:2003 TAI	BLE 8.2	E
INLET PITS – A	S/NZS 350		BLE 8.2	E
INLET PITS - A	S/NZS 350	0.3:2003 TAI	BLE 8.2	E
INLET PITS - A	S/NZS 350	0.3:2003 TAI MINIMUM INTERN/ DIMENSION (mm)	BLE 8.2	E
EPTH TO INVERT OF OUTLET ≤ 600	S/NZS 350 RECTA WIDTH 450	0.3:2003 TAI MINIMUM INTERN/ DIMENSION (mm) NGULAR LENGTH 450	BLE 8.2 AL CIRCULAR DIAMETER 600	E
INLET PITS – A	S/NZS 350	0.3:2003 TAI	AL CIRCULAR DIAMETER	
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INLET PITS - A EPTH TO INVERT OF OUTLET ≤ 600 > 600 ≤ 900 > 900 ≤ 1200	S/NZS 350 RECTA WIDTH 450 600 600	0.3:2003 TAI MINIMUM INTERN/ DIMENSION (mm) NGULAR LENGTH 450 600 900	BLE 8.2 AL CIRCULAR DIAMETER 600 900 1000	
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INLET PITS - A EPTH TO INVERT OF OUTLET ≤ 600 > 600 ≤ 900 > 900 ≤ 1200 > 1200 COTTIER TITLE STORMI SHEET 5	S/NZS 350 RECTA WIDTH 450 600 900 900 WATER MAN	0.3:2003 TAI	BLE 8.2	G
INLET PITS - A EPTH TO INVERT OF OUTLET ≤ 600 > 600 ≤ 900 > 900 ≤ 1200 > 1200	S/NZS 350 RECTA WIDTH 450 600 900 900 900 00 00 00 00 00 0	0.3:2003 TAI	BLE 8.2	F G
INLET PITS - A EPTH TO INVERT OF OUTLET ≤ 600 > 600 ≤ 900 > 900 ≤ 1200 > 1200	S/NZS 350 RECTA WIDTH 450 600 900 900 900 900 900 900 90	0.3:2003 TAI	BLE 8.2	F G




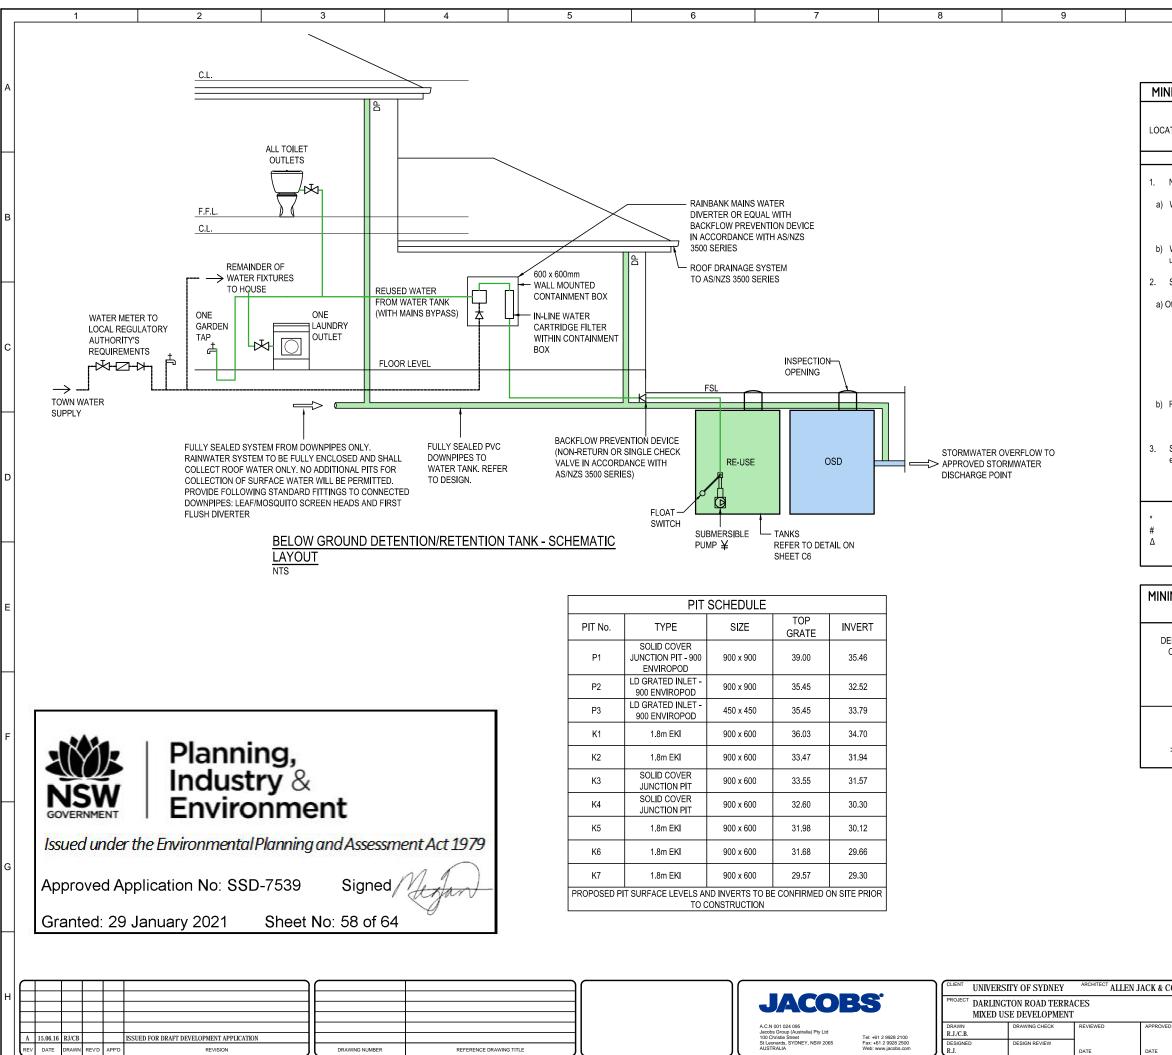

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GENERAL INSTRUCTIONS

- THIS SOIL AND WATER MANAGEMENT PLAN IS TO BE READ IN CONJUNCTION WITH OTHER ENGINEERING PLANS RELATING TO THIS DEVELOPMENT
- CONTRACTORS WILL ENSURE THAT ALL SOIL AND WATER 2. MANAGEMENT WORKS ARE UNDERTAKEN AS INSTRUCTED IN THIS SPECIFICATION AND CONSTRUCTED FOLLOWING THE GUIDELINES OF "MANAGING URBAN STORMWATER SOILS AND CONSTRUCTION", DEPT OF HOUSING, 1998 (BLUE BOOK).
- ALL SUBCONTRACTORS WILL BE INFORMED OF THEIR 3 RESPONSIBILITIES IN REDUCING THE POTENTIAL FOR SOIL EROSION AND POLLUTION TO DOWNSLOPE AREAS

LAND DISTURBANCE INSTRUCTIONS

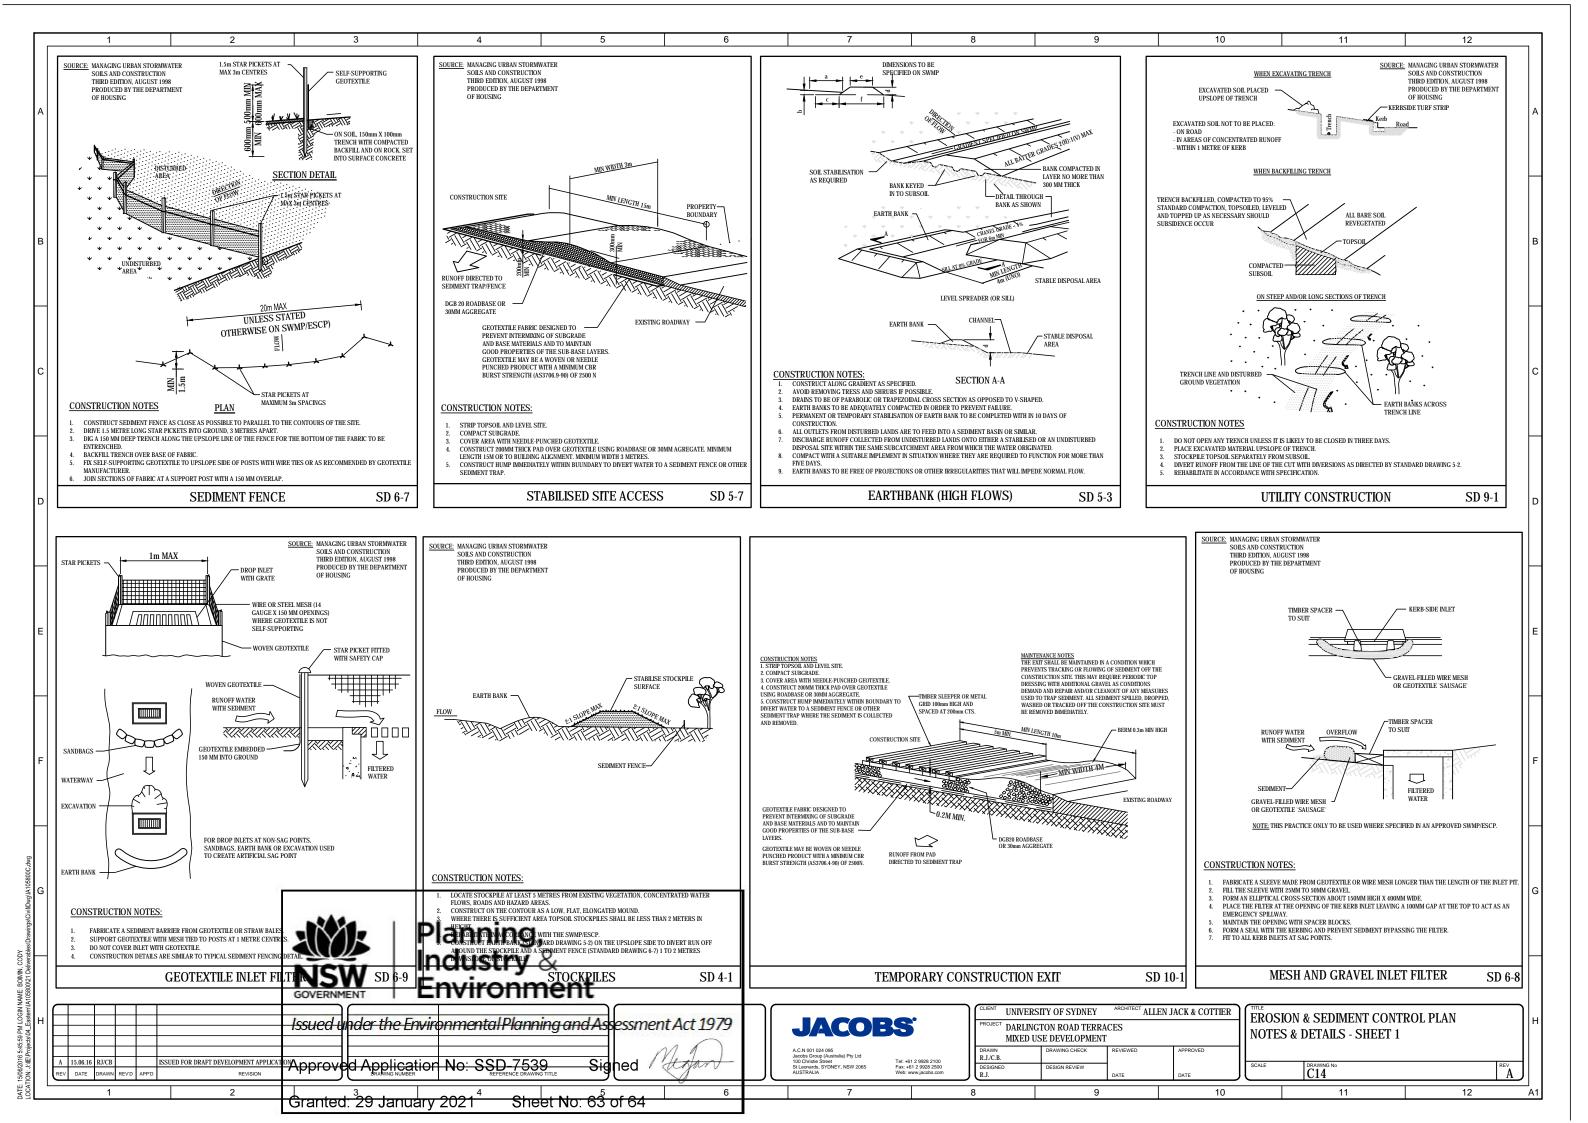- 4. DISTURBANCE TO BE NO FURTHER THAN 5 (PREFERABLY 2) METRES FROM THE EDGE OF ANY ESSENTIAL ENGINEERING ACTIVITY AS SHOWN ON APPROVED PLANS. ALL SITE WORKERS WILL CLEARLY RECOGNISE THESE ZONES THAT, WHERE APPROPRIATE, ARE IDENTIFIED WITH BARRIER FENCING (UPSLOPE) AND SEDIMENT FENCING (DOWNSLOPE) OR SIMILAR MATERIALS.
- ACCESS AREAS ARE TO BE LIMITED TO A MAXIMUM WIDTH OF 10 METRES THE SITE MANAGER WILL DETERMINE AND MARK THE LOCATION OF THESE ZONES ON-SITE. ALL SITE WORKERS WILL CLEARLY RECOGNISE THESE BOUNDARIES THAT, WHERE APPROPRIATE, ARE IDENTIFIED WITH BARRIER FENCING (UPSLOPE) AND SEDIMENT FENCING (DOWNSLOPE) OR SIMILAR MATERIALS.
- ENTRY TO LANDS NOT REQUIRED FOR CONSTRUCTION OR ACCESS IS PROHIBITED EXCEPT FOR ESSENTIAL THINNING OF PLANT GROWTH.
- WORKS ARE TO PROCEED IN THE FOLLOWING SEQUENCE: INSTALL ALL BARRIER AND SEDIMENT FENCING WHERE SHOWN ON THE PLAN.
- CONSTRUCT THE STABILISED SITE ACCESS.
- CONSTRUCT DIVERSION DRAINS AS REQUIRED. C) INSTALL MESH AND GRAVEL INLETS FOR ANY
- ADJACENT KERB INLETS.
- E) INSTALL GEOTEXTILE INLET FILTERS AROUND ANY ON-SITE DROP INLET PITS.
- CLEAR SITE AND STRIP AND STOCKPILE TOPSOIL IN F) LOCATIONS SHOWN ON THE PLAN.
- C) UNDERTAKE ALL ESSENTIAL CONSTRUCTION WORKS ENSURING THAT ROOF AND/OR PAVED AREA STORMWATER SYSTEMS ARE CONNECTED TO PERMANENT DRAINAGE AS SOON AS PRACTICABLE
- GRADE LOT AREAS TO FINAL GRADES AND APPLY H, PERMANENT STABILISATION (LANDSCAPING) WITHIN 20 DAYS OF COMPLETION OF CONSTRUCTION WORKS
- REMOVE TEMPORARY EROSION CONTROL MEASURES AFTER THE PERMANENT LANDSCAPING HAS BEEN COMPLETED
- ENSURE THAT SLOPE LENGTHS DO NOT EXCEED 80 5 METRES WHERE PRACTICABLE. SLOPE LENGTHS ARE DETERMINED BY SILTATION FENCING AND CATCH DRAM SPACING.
- ON COMPLETION OF MAJOR WORKS LEAVE DISTURBED LANDS WITH A SCARIFIED SURFACE TO ENCOURAGE WATER INFILTRATION AND ASSIST WITH KEYING TOPSO LATER

TREE PROTECTION FENCING NOTES

4

- THE TREE PROTECTION FENCE SHALL BE A MINIMUM OF 1800mm HIGH CHAIN LINK FABRIC ON 2400mm STAR PICKET OR 50mm DIA GWI PIPE ANCHOR POSTS DRIVEN 600mm INTO THE GROUND SO THAT THE FENCING CANNOT BE BREACHED OR MOVED
- INSTALL DIAGONAL CABLE BRACING IF REQUIRED FOR STABILITY
- ON CONSTRUCTION SITES WITH WIND BLOWN DUST & DEBRIS, ATTACH SHADE CLOTH OR SIMILAR GEOTEXTILE FABRIC TO COVER THE FENCE PANELS AND SCREEN THE TPZ FROM CONTAMINATION.
- THE TREE PROTECTION FENCE SHALL BE INSTALLED PRIOR TO ANY DEMOLITION, CLEARING, GRADING OR CONSTRUCTION WORK, AND REMAIN IN PLACE IN FUNCTIONING CONDITION UNTIL ALL CONSTRUCTION HAS BEEN COMPLETED
- NO PERSONS, MATERIAL, EQUIPMENT, OR DISPOSAL OF SOLIDS, LIQUID OR CHEMICAL WASTE - INCLUDING CONCRETE CLEANUP WASTE, PAINTERS WASTE AND SIMILAR - IS PERMITTED WITHIN THE TREE PROTECTION ZONE.
- A 600mm x 450mm PROHIBITION SIGN COMPLYING WITH AS1319 STATING "NO ENTRY TREE PROTECTION ZONE" AND INCLUDING CONTACT DETAILS OF THE SITE FOREMAN IS TO BE ATTACHED TO THE FENCE TO BE VISIBLE FROM ALL SECTORS OF THE SITE AND REMAIN IN PLACE UNTIL ALL CONSTRUCTION HAS BEEN COMPLETED
- THE USE OF FENCING SUPPORTED BY CONCRETE BASES OR SIMILAR TEMPORARY FENCING IS NOT ACCEPTABLE.

SITE MAINTENANCE INSTRUCTIONS

EROSION AND SEDIMENT CONTROL NOTES

- 7. THE SITE SUPERINTENDENT WILL INSPECT THE SITE AT LEAST WEEKLY AND AT THE CONCLUSION OF EVERY STORM EVENT TO
 - ENSURE THAT DRAINS OPERATE PROPERLY AND TO EFFECT ANY NECESSARY REPAIRS.
 - REMOVE SPILLED SAND OR OTHER MATERIALS FROM HAZARD AREAS, INCLUDING LANDS CLOSER THAN 5 METRES FROM AREAS OF LIKELY CONCENTRATED OR HIGH VELOCITY FLOWS ESPECIALLY WATERWAYS AND PAVED AREAS.
 - C) REMOVE TRAPPED SEDIMENT WHENEVER THE DESIGN CAPACITY OF THAT STRUCTURE HAS BEEN EXCEEDED
 - ENSURE REHABILITATED LANDS HAVE D) EFFECTIVELY REDUCED THE EROSION HAZARD AND TO INITIATE UPGRADING OR REPAIR AS NECESSARY.
- CONSTRUCT ADDITIONAL EROSION AND/OR E) SEDIMENT CONTROL WORKS AS MIGHT BECOME NECESSARY TO ENSURE THE DESIRED PROTECTION IS GIVEN TO DOWNSLOPE LANDS AND WATERWAYS. MAKE ONGOING CHANGES TO THE PLAN WHERE IT PROVES INADEQUATE IN PRACTICE OR IS SUBJECTED TO CHANGES IN CONDITIONS ON THE WORK-SITE OR ELSEWHERE IN THE CATCHMENT.
- MAINTAIN EROSION AND SEDIMENT CONTROL F) STRUCTURES IN A FULLY FUNCTIONING CONDITION UNTIL ALL EARTHWORK ACTIVITIES ARE COMPLETED AND THE SITE IS REHABILITATED.
- THE SITE SUPERINTENDENT WILL KEEP A LOGBOOK MAKING ENTRIES AT LEAST WEEKLY, IMMEDIATELY BEFORE FORECAST RAIN AND AFTER RAINFALL. ENTRIES WILL INCLUDE
- THE VOLUME AND INTENSITY OF ANY RAINFALL EVENTS.
- THE CONDITION OF ANY SOIL AND WATER MANAGEMENT WORKS.
- C) THE CONDITION OF VEGETATION AND ANY NEED TO IRRIGATE.
- THE NEED FOR DUST PREVENTION STRATEGIES.


ANY REMEDIAL WORKS TO BE UNDERTAKEN. THE LOGBOOK WILL BE KEPT ON-SITE AND MADE AVAILABLE TO ANY AUTHORISED PERSON UPON REQUEST IT WILL BE GIVEN TO THE PROJECT MANAGER AT THE

SEDIMENT CONTROL INSTRUCTIONS

CONCLUSION OF THE WORKS.

- SEDIMENT FENCES WILL BE INSTALLED AS SHOWN ON THE PLAN AND ELSEWHERE AT THE DISCRETION OF THE SITE SUPERINTENDENT TO CONTAIN SOIL AS NEAR AS POSSIBLE TO THEIR SOURCE.
- SEDIMENT FENCES WILL NOT HAVE CATCHMENT AREAS 10 EXCEEDING 900 SQUARE METRES AND HAVE A STORAGE DEPTH OF AT LEAST 0.6 METRES
- SEDIMENT REMOVED FROM ANY TRAPPING DEVICES WILL 11 BE RELOCATED WHERE FURTHER POLLUTION TO DOWNSLOPE LANDS AND WATERWAYS CANNOT OCCUR.
- STOCKPILES ARE NOT TO BE LOCATED WITHIN 5 METRES OF HAZARD AREAS INCLUDING AREAS OF HIGH VELOCITY FLOWS SUCH AS WATERWAYS, PAVED AREAS AND DRIVEWAYS
- WATER WILL BE PREVENTED FROM DIRECTLY ENTERING THE PERMANENT DRAINAGE SYSTEM UNLESS THE CATCHMENT AREA HAS BEEN PERMANENTLY LANDSCAPED AND/OR WATER HAS BEEN TREATED BY AN APPROVED DEVICE.
- TEMPORARY SEDIMENT TRAPS WILL REMAIN IN PLACE UNTIL AFTER THE LANDS THEY ARE PROTECTING ARE COMPLETELY REHABILITATED.
- ACCESS TO SITES SHOULD BE STABILISED TO REDUCE THE LIKELIHOOD OF VEHICLES TRACKING SOIL MATERIALS ONTO PUBLIC ROADS AND ENSURE ALL-WEATHER ENTRY/EXIT

Granted: 29 January 2021

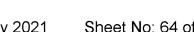

Sheet No: 64 of 64

Planning, Industry &

Environment

Issued under the Environmental Planning and Assessment Act 1979



^{CT} ALLEN JACK & C UNIVERSITY OF SYDNEY DARLINGTON ROAD TERRACES MIXED USE DEVELOPMENT R.J./C.B. ISSUED FOR DRAFT DEVELOPMENT APPLICATION R.J. DRAWING NUMBER REFERENCE DRAWING TITLE 10

10		11		12	_]
SOIL E	ROSION	CONTROL INSTRUC	TIONS		
		RS WILL BE CONSTRUCTED V			A
GR	ADIENT AS	PRACTICABLE BUT NO STEE			
•		V) WHERE SLOPE LENGTH LE	SS THAN 12		
•	2.5(H):1	1(V) WHERE SLOPE LENGTH I 3 METRES.	BETWEEN 12		Н
•	3(H):1() WHERE SLOPE LENGTH BE) METRES.	TWEEN 16		
•		V) WHERE SLOPE LENGTH G	REATER THAN		
	L WATERWA	AYS, DRAINS, SPILLWAYS AN			в
LE	AST THE 1:2	L BE CONSTRUCTED TO BE S 20 YEAR ARI, TIME OF CONCI			
18. WA		AND OTHER AREAS SUBJECT			
HA	VE A MAXIN	ED FLOWS AFTER CONSTRU AUM GROUNDCOVER C-FACT	OR OF 0.05 (70%		$\left \right $
CO	MPLETION	ER) WITHIN 10 WORKING DAY OF FORMATION. FLOW VELO	CITIES ARE TO		
) THOSE SHOWN IN TABLE 5- MWATER - SOILS AND CONST			
		1998 (BLUE BOOK). FOOT AND . BE PROHIBITED IN THESE AI			с
		AFTER CONSTRUCTION ARE T COUND-COVER C-FACTOR OF			
		ER) WITHIN 10 WORKING DAY OF FORMATION.	'S FROM		
20. AL	L LANDS, IN	ICLUDING WATERWAYS AND STRUCTION ARE TO HAVE A M			Н
GR	OUND-COV	ER C-FACTOR OF 0.15 (50% C RKING DAYS FROM INACTIVI	GROUND COVER)		
TH	OUGH WOR	RKS MAY CONTINUE LATER. F SHEET FLOW USE THE FOL			
GR	OUND COV	ER PLANT SPECIES FOR TEM	IPORARY		D
22. PE	RMANENT I	NESE MILLET 20 KG/HA AND (REHABILITATION OF LANDS A	FTER		
C-I	FACTOR OF	ON WILL ACHIEVE A GROUND LESS THAN 0.1 AND LESS TH	AN 0.05 WITHIN		
RE	GULARLY U	/LY PLANTED LANDS WILL BE JNTIL AN EFFECTIVE COVER I	S ESTABLISHED		\mid
SE	ED AND FE	ARE GROWING VIGOROUSLY. RTILISER WILL BE APPLIED A	S NECESSARY.		
		ON SHOULD BE AIMED AT RE- ECIES. NATURAL SURFACE S			
	PLACED AN	ID NON-PERSISTANT ANNUA SED.	L COVER CROPS		E
VASTE	E CONTR	ROL INSTRUCTIONS			
		BINS WILL BE PROVIDED FOR ND MORTAR SLURRIES, PAIN			$\left \right $
WA	ASHING, LIG	HTWEIGHT WASTE MATERIA SERVICES WILL BE PROVIDED	LS AND LITTER.		
WI	EEKLY. DISF	POSAL OF WASTE WILL BE IN Y THE SITE SUPERINTENDEN	A MANNER		
25. AL	L POSSIBLE	E POLLUTANT MATERIALS AR OF ANY POORLY DRAINED AF	E TO BE STORED		F
PR	ONE AREAS	S, STREAMBANKS, CHANNELS R DRAINAGE AREAS. STORE S	SAND		
MA	TERIALS IN	A DESIGNATED AREA UNDE	R COVER		
26. AL	L SITE STAI	IBLE AND WITHIN CONTAINM FF AND SUB-CONTACTORS AI	RE TO BE		\mid
CO	NTROL FAC	THEIR OBLIGATION TO USE CILITIES PROVIDED.			
MC	ONITORED T	ERING ACTIVITIES ARE TO BE TO ENSURE THAT WATER IS N	IOT POLLUTED		
PR	ODUCTS.	, TOXIC MATERIALS OR PETR			G
		IGNATED VEHICULAR WASHI E AREAS WHICH ARE TO HAV			
BU	NDS.				
					Н
OTTIER	11	SION & SEDIMENT CO			н
		ES & DETAILS - SHEE	Т 2		
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