Appendix E – Rehabilitation landscaping plans

LEGEND LHRRP PROPOSAL (2015) BOUNDARY ANSTO BUFFER BOUNDARY BOUNDARY TO EARLY WORKS BOUNDARY TO EASTERN ADDITIONAL REHABILITATION AREA BOUNDARY TO ARRT FACILITIES INSIDE SICTA LEASED AREA. REHABILITATION WORKS IN THIS AREA ONLY REQUIRED IF FACILITY IS BUILT, 1800h GALVANISED CHAINLINK FENCE EXISTING TREES RETAINED WOODLAND PLANTING (TREES AND GRASSES) OVER LOCALISED MOUNDS SEE INDICATIVE SPECIES LIST ON DRAWING LD02 BASE OF PROPOSED SOIL MOUND OVER FILL SHOWN DASHED WOODLAND PLANTING (FULL STRATA) ON EXISTING GROUND SEE INDICATIVE SPECIES LIST ON DRAWING LD02 'EARLY WORKS' WOODLAND PLANTING (FULL STRATA) ON EXISTING GROUND SEE INDICATIVE SPECIES LIST ON DRAWING LAUT-A PROPOSED SPECIMEN TREES IN EXISTING GROUND HYDROSEEDED NATIVE GRASS PROPOSED LAWN - HIGH USE AREAS SHARED PEDESTRIAN / CYCLE PATHWAY 2.5m WIDE PROPOSED ROAD 6m WIDE WATER COURSE PROPOSED GAS COLLECTOR EXISTING GAS COLLECTOR AREA OF TRANSITIONAL FOREST PROTECTED, NO WORKS,



DRAWING REGISTER

LA01	MASTERPLAN	1:5000
LA02	DETAILED MASTERPLAN NORTH	1:2000
LA03	DETAILED MASTERPLAN SOUTH	1:2000
LA04	LANDSCAPE SITE SECTIONS	1:2000
LA05	GRADING PLAN NORTH	1:2000
LA06	GRADING PLAN SOUTH	1:2000
LA07	STAGING STRATEGY	1:500
LA07-A	STAGING PLAN - EARLY WORKS	1:5000
LA08	DUCK POND PRECINCT	1:500
LA09	SOUTH ENTRY PRECINCT	1:500
LA10	WEST ENTRY / MILL POND PRECINCT	1:500
LA11	POND SECTIONS HASSELL 1998	AS SHOWN
LA12	POND DETAILS HASSELL 1998	AS SHOWN
LD01	LANDSCAPE DETAILS 1	AS SHOWN
LD02	LANDSCAPE DETAILS 2	AS SHOWN

LANDSCAPE AREA CALCULATIONS (m2)

DESCRIPTION	1998 PLAN	% OF SITE	2014 PLAN	% OF SITE	EASTERN ADDITIONAL REHAB, AREA	TOTAL (2014 PLAN + EASTERN ADDITIONAL REHAB AREA)
LAWN*	677,547 m2	55%	706,276 m2	57%	204,179 m2	910,455
WOODLAND PLANTING (Trees and Grasses)	390,237 m2	32%	339,781 m2	27%	46,918 m2	386,699
WOODLAND WITH UNDERSTORY	134,659 m2	11%	154,682 m2	13%	0 m2	154,682
WATER BODIES	34,554 m2	3%	36,258 m2	3%	0 m2	36,258
TOTALAREA	1,236,997 m2	100%	1,235,997 m2	100%	251,097 m2	1,488,094

*Including 86,961m2 of kikuyu lawn

TOTAL PARK AREA 1488094 m2


1 MASTERPLAN LA01 PLAN 1:5000


TaylorBrammer ALL STATES

218 Deliver Street.






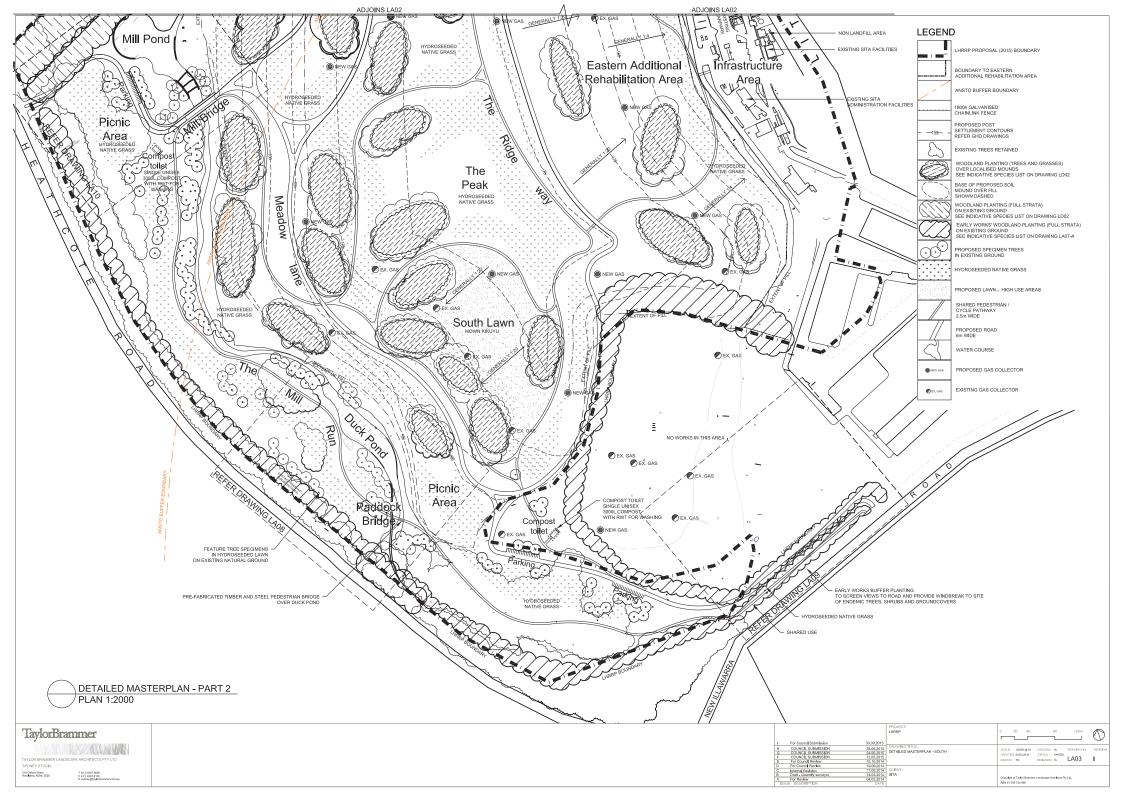

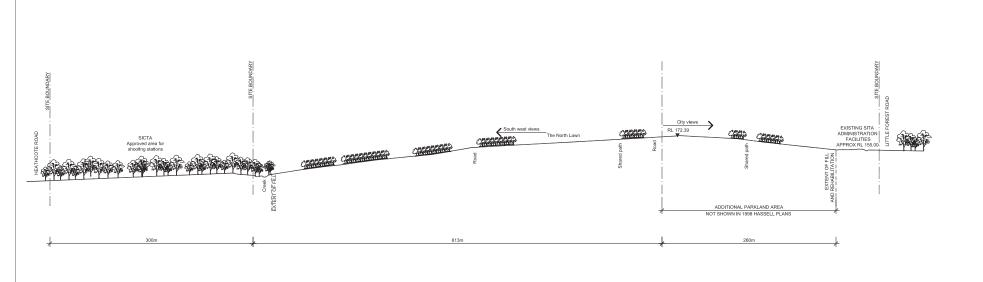



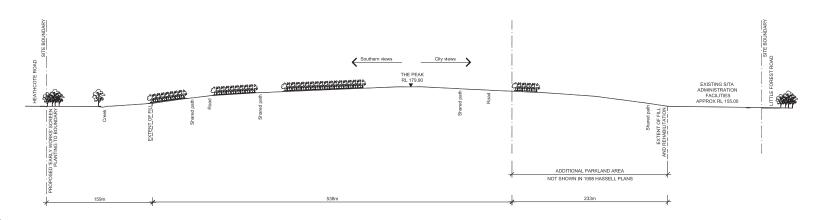

SITE SECTION B SCALE1:2000

TaylorBrammer


218 Oxford Street Woo&shra, NSW, 2025


TAYLOR BRAMMER LANDSCAPE ARCHITECTS PTY LTD SYDNEY STUDIO


	NATIONAL PROPERTY OF THE PROPE
LANDSCA	PE ARCHITECTS PTY LTD
	T 61 2 9387 8866
	F 61 2 9067 8155 E sydney@taylorbownmer.com.au

d	For Council Submission	30,09,2015	PROJECT
L	COUNCIL SUBMISSION	18,08,2015	LHRRP
K	COUNCIL SUBMISSION	28,08,2015	LHRRP
J	COUNCIL SUBMISSION	24,06,2015	
l .	COUNCIL SUBMISSION	14,05,2015	
Н	For Council Review	19,09,2014	DRAWING TITLE
G	INTERNAL REVISION	17,09,14	LANDSCAPE SITE SECTIONS
F	EX. SITA FACILITIES RL	22,08,2014	LANDSCAPE SHE SECTIONS
E	EASTERN AREA PLANTING, PATH, LEGEND	18,07,2014	
D	ADDITIONAL PLANTING ON MOUNDS,	14,07,2014	
	PLANTING TO EASTERN ADDITIONAL AREA		
	AND LEARLY WORKS DEFINITIONES		CLIENT:
С	LANDFORM	12,05,2014	SITA
В	Draft - Quantity surveyor	11.03.2014	oint.
A	For Review	03,03,2014	


SCALE 12866-(SAT CHECKER AA DRAWING INC REVISIONS CHECKER AA DRAWING INC REVISIONS CHECKER AS DRAWING INC REVISIONS TO DESIGNER: TO LAO4 M

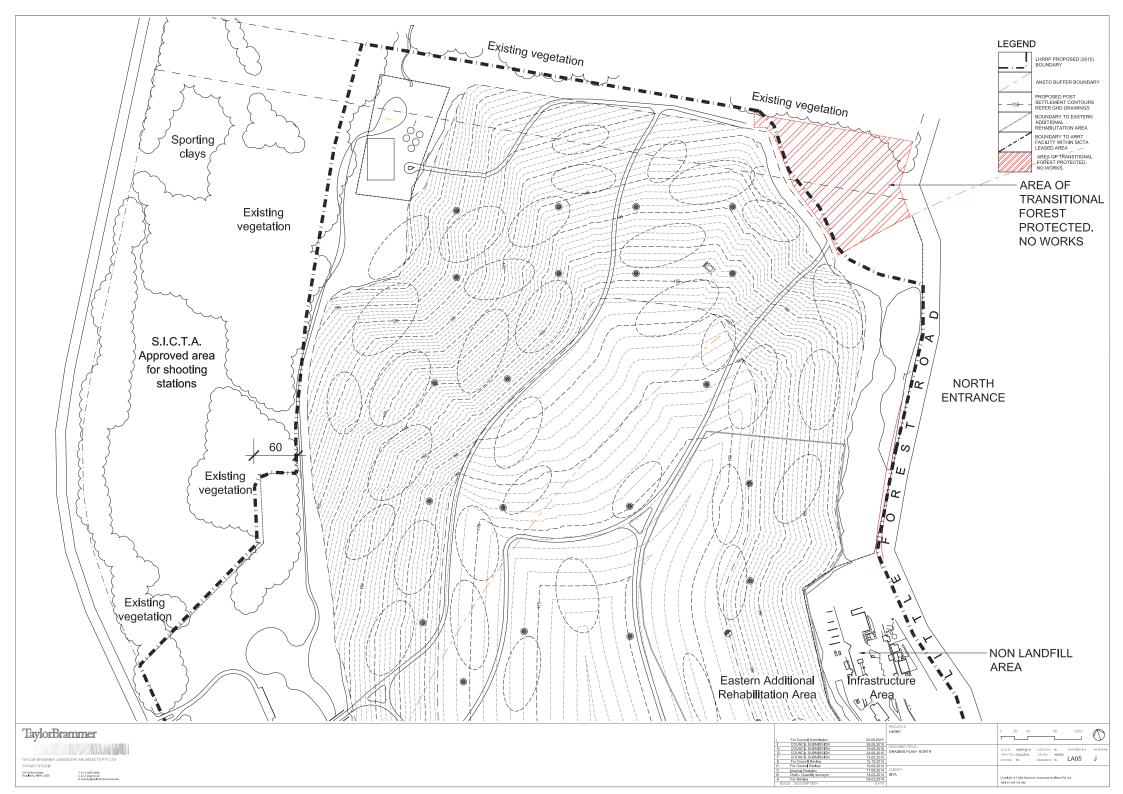

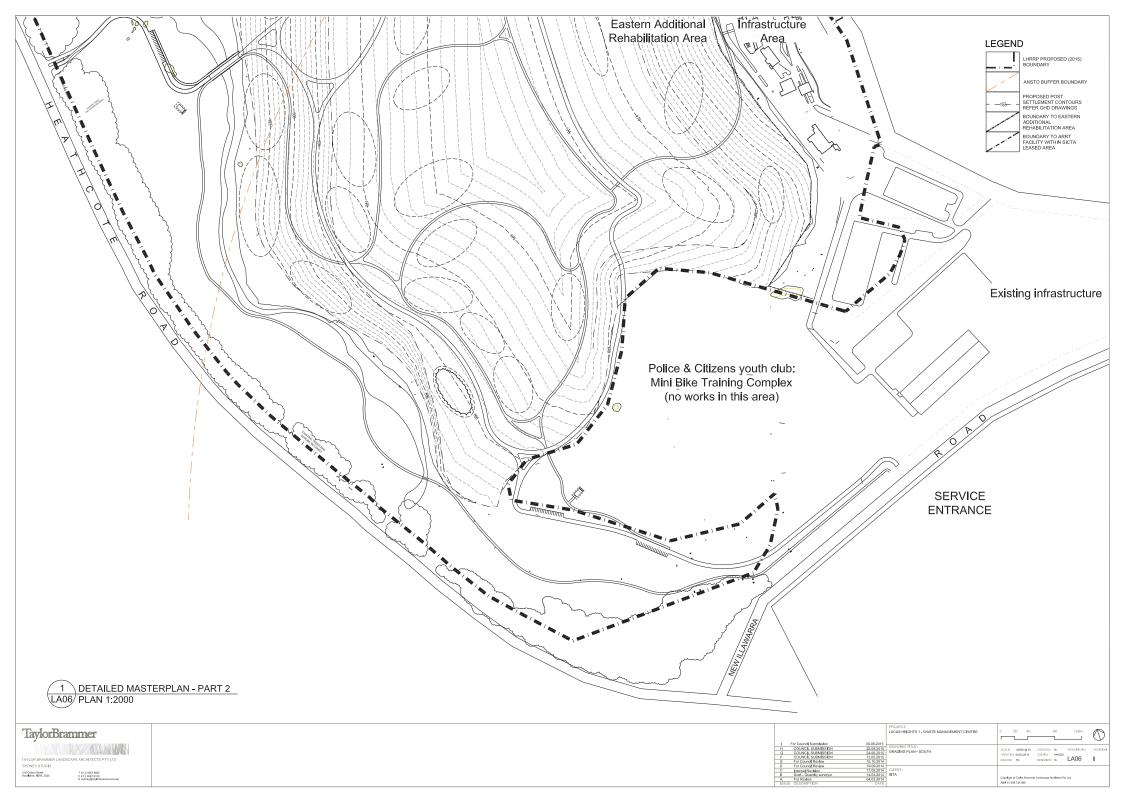

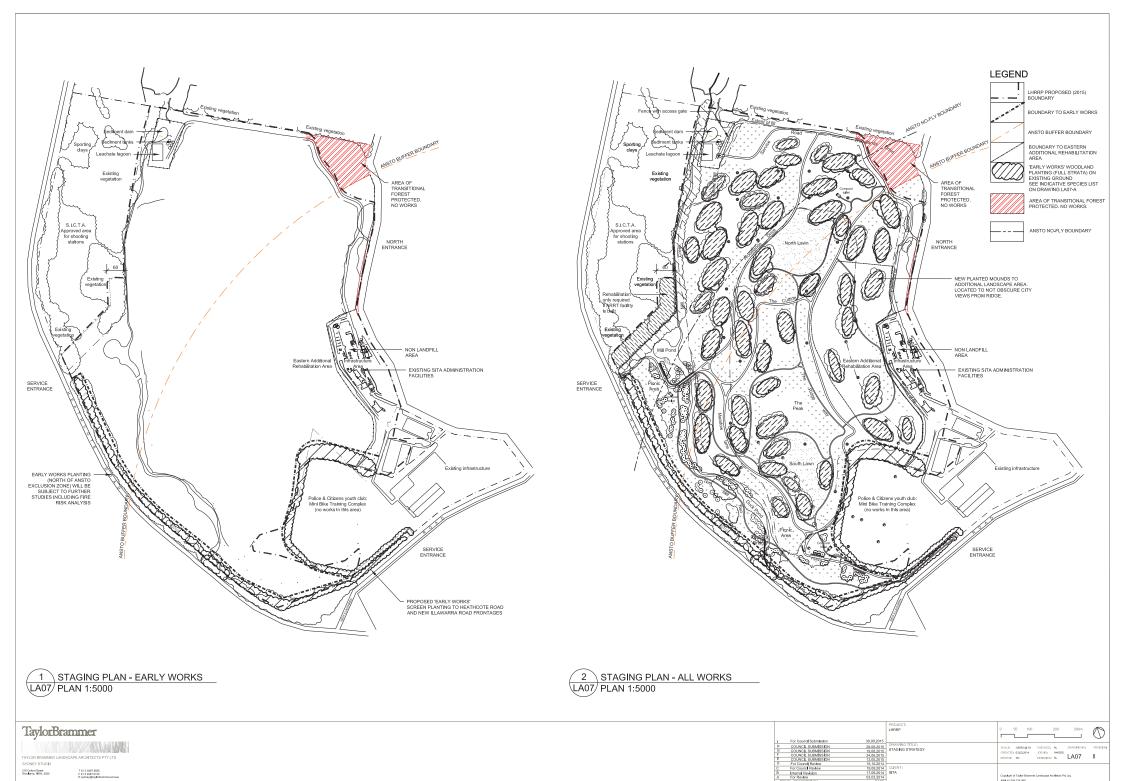



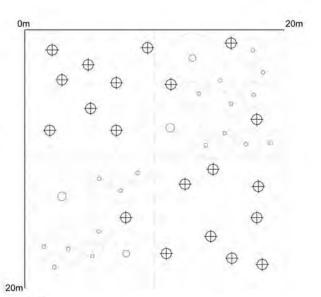

NOTE:

Plant Matrix to be modified subject to existing ground conditions

2 BUFFER PLANTING MATRIX L07-A DETAIL PLAN 1:100

> NOTE: The planting matrix will be applied to areas that are disturbed. All areas that exhibit existing native vegetation in the buffer area remain undisturbed.

PLANT SCHEDULE - BUFFER PLANTING MATRIX

	BOTANICAL NAME	COMMON NAME	MATURE HEIGHT (m)	POTSIZE	OTY
TREES					
20000	Eucalyptia gummiting	Bloodwood	20m	300mm	
	Eucalystus haarnastoma	Sorbbly gum	15/0	300mm	
	Euralyphus Inutenanylana	Yellow top ash	Sm	300:	20
	Eucalyptus obstans	Port Jackson malee	6m.	300mm	
	Eucalyptus pilularis	Blackbutt	20m	300mm	
SHRUBS					
BANKAN PARA	Acacia longifolia	Sydney Golden Wattle	Sm	14Dmm	
100	Bank sin encritation	Heath Leaf Bankels	3m	140mm	
	Boronia semulata	Native Rose	O. Birth	340mm	22
	Bursalla spinulosa	Blackthom	4m	140mm	**
	Lambertia formosa	Mountain Devil	2mi	3A0mm	
	Pullanese allighica	Wreath Bush Pea	2m	540mm	
GROUNDO	OVERS AND GRASSES				
	Disenda promes	Flax Dly	0.8m	habistock	
	Dichondra repena	Native Kidney Weed	340	fubestock	
	rébbertis acardens	Snake Vine		tubestock	
	Tanleyava nodosa	Knobby Club Rush	0.5ml	hibestock	780
	Lamaxim langifolis	Mat Rush	fm	tubestock	
	Planetorea pandorana	Wonga Wonga Vine		Libertock	
	Thernoda australia	Kangaroo Grass	0.5m	tubestock	


NOTE:


* Plant quantities on planting plan take procedures over quantities identified in this schedule.

STAGING PLAN - EARLY WORKS LA07-A PLAN 1:5000


TaylorBrammer 100 m W (O man tree


STAGING PLAN-EARLY WORKS LA07-A G

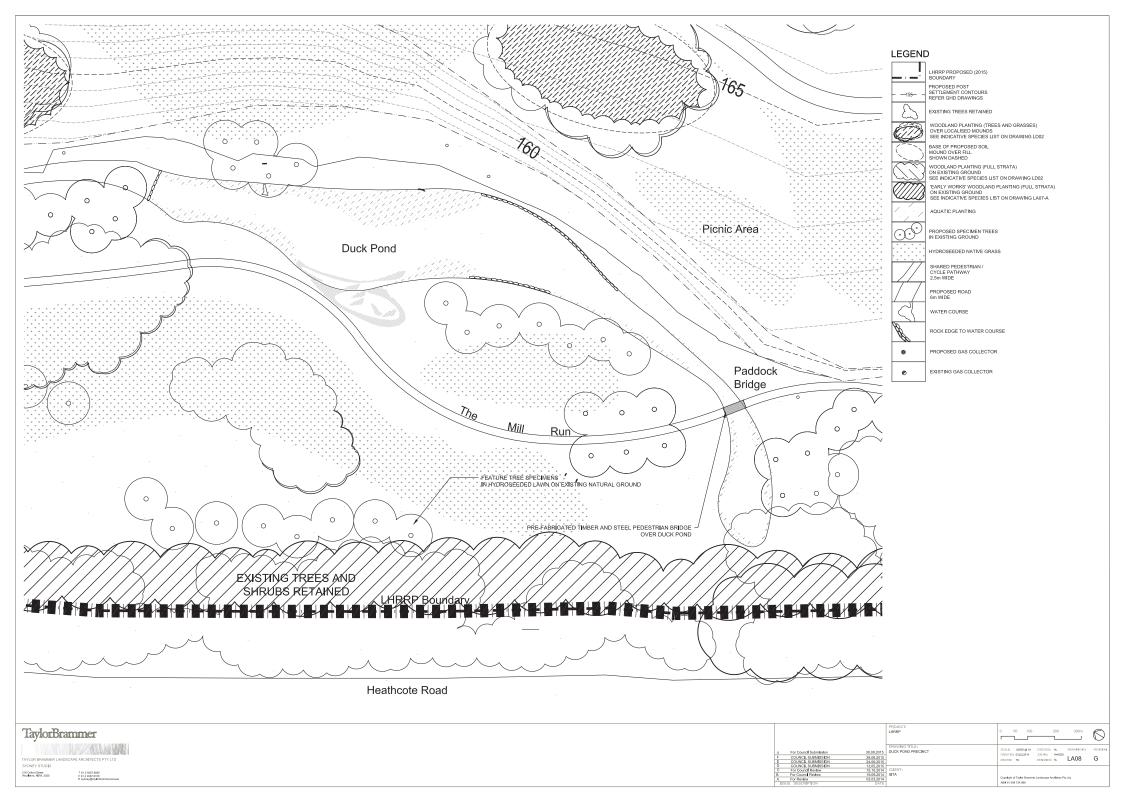

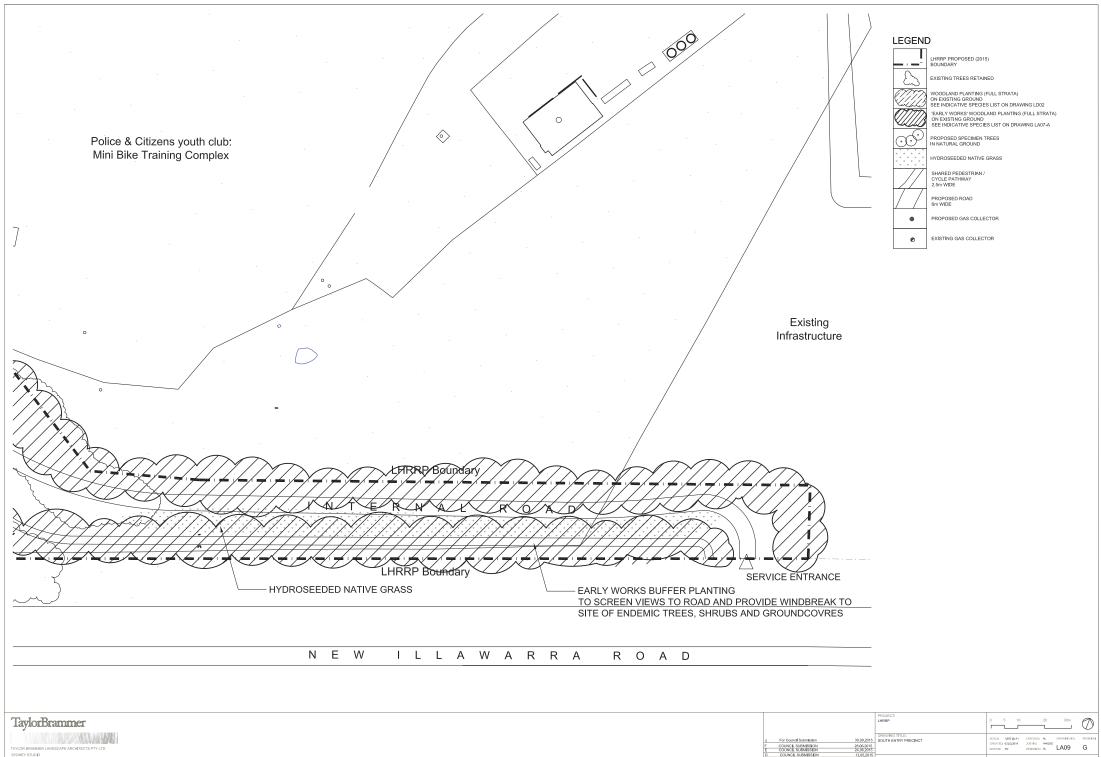


218 Colord Street Wookshra, HSW, 2025

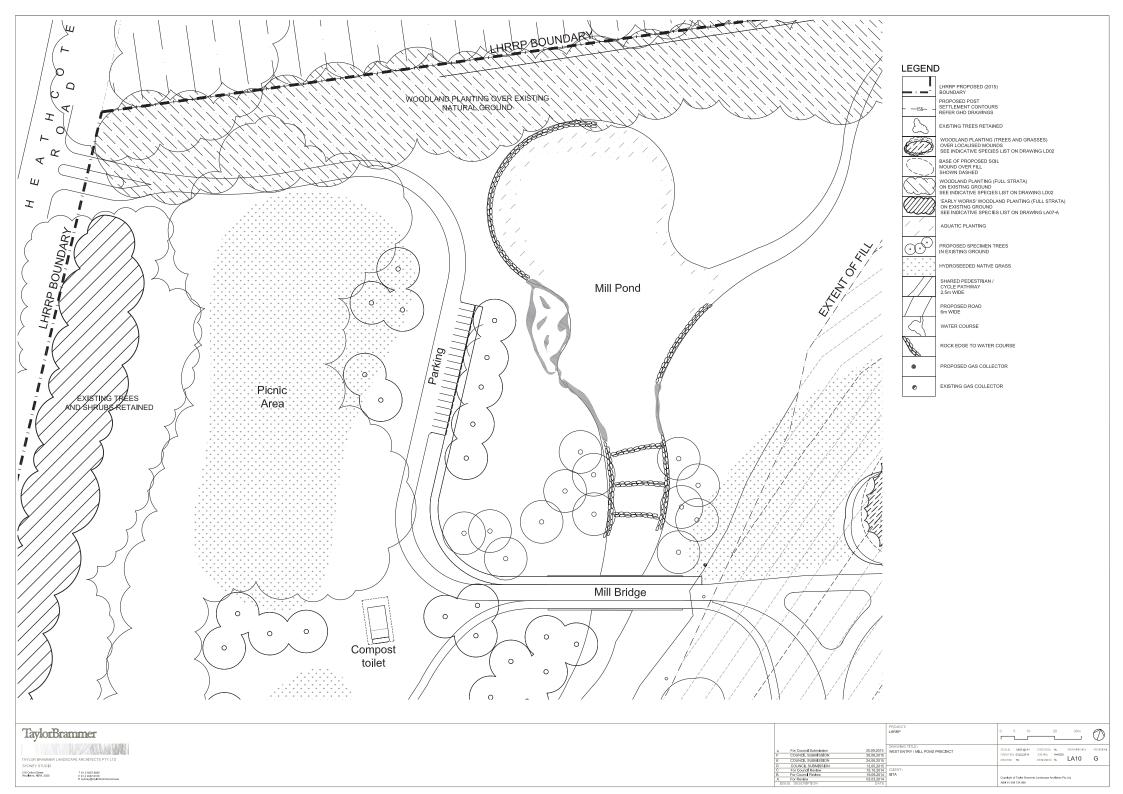


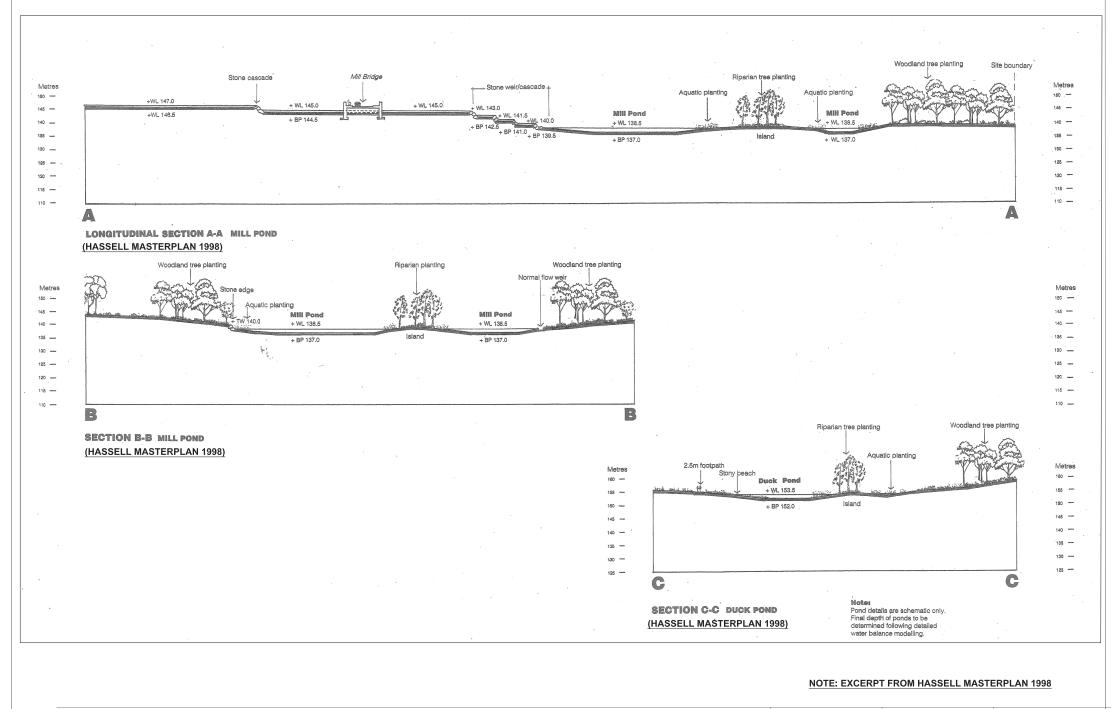

TaylorBrammer				PROJECT: SİTA MASTERPLAN	
TO SECTION AND ADDRESS OF THE PROPERTY OF THE				DRAWING TITLE: MILL POND & DUCK POND SECTIONS - HASSELL 1998	SCALE VARYIGAT CHECKED AL DRAWING NO. REVEN CREATED: 17.01.2014 JOB NO. 1940256
TAYLOR BRAMMER LANDSCAPE ARCHITECTS PTY LTD					DESIGNED: AL LA11 B
SYDNEY STUDIC				CLIENT:	
21 Clark Start T 2 200 M M6 F 1 2 20	В	COUNCIL SUBMISSION		D15 SITA	Constituted Tests Recognition of the Recognition of
Enjanginghornerama	ISSUE	COUNCIL SUBMISSION JE DESCRIPTION	18,08,21 DA	015 (TE)	ABN 61 098 724 988

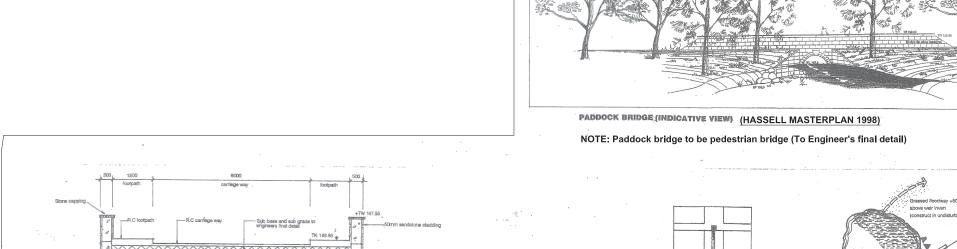

SCHEMATIC SECTION: MILL BRIDGE (to Engineer's final detail) (HASSELL MASTERPLAN 1998)

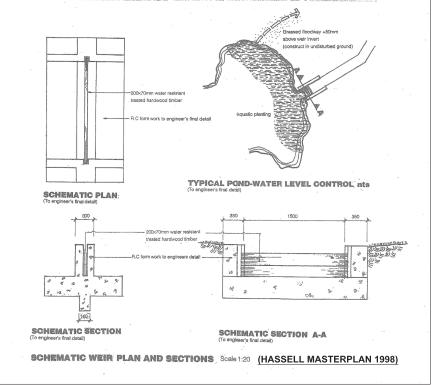



NOTE: EXCERPT FROM HASSELL MASTERPLAN 1998

TaylorBrammer

Taylor Bramer Landsoupe Architects style to
Synchet Studied
Studied State
Studied Sta


	PROJECT: SITA MASTERPLAN DRAWING TITLE: MILL 8 DUCK POND DETAILS - HASSELL 1998	SCALD WAY (AM CHECKED AL CHOWNES NO. REVISION COUNTER TRANSMENT ACCESSION AL CALL LATE B
	CLIENT: SITA	Copyright of Taylas Bommer Landscope Architects Pty Lts ABN 61-098-726-988

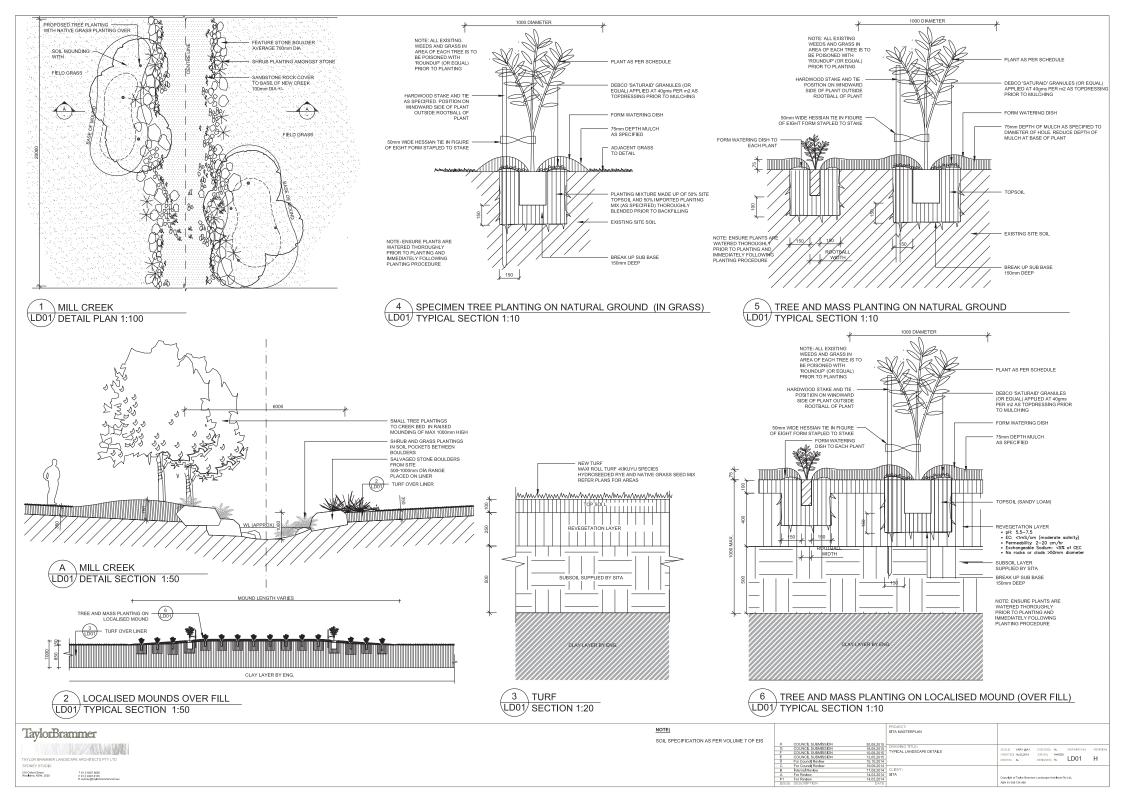

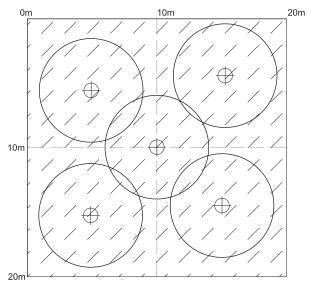

PLANT SCHEDULE - MOUND PLANTING MATRIX PLANTING OVER HILL Motificing will vary own the site. Species will any depending on position loss grisht better. The screetule between shows any disall selection. ID 00TAN-CALINAVE 0007/30N NAME HEIGHT 11 PCT SIZE 0TF Euceuptus heemastome Series again \odot Acadis melandigron Melaisuda quinquenen s Broad leaved deigenderk GROUNDCOVERS Themanta sustra is Keingando grass Weeting mescow grass Decthodia species Wallack grass Plant quantities on planting partities precedence over custoftes identified in this schedule.

MOUND PLANTING MATRIX LD02 DETAIL PLAN 1:100

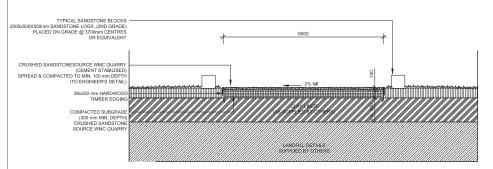

\UNSEALED ROAD (To Engineer's final details) LD02 TYPICAL SECTION SCALE1:50

INDICATIVE PLANT LIST

WOODLAND PLANTING. MOUNDS OVER FILL INDICATIVE SPECIES LIST

BOTANICAL NAMI	COMMON NAME	MATURE HEIGHT (m)	BOTANICAL NAME
TRFFS			TREES
Angegheen	hispida Dwarf apple	8	Allocasuarina littoralis
Panksia semala	Old man banksia	8	Ceratopetalum apetalu
Callica vince convertification	Black wattle	6	Melaleuca quinquener
Coratopolalum opolalum	Coarlowned	8	
Lecalyptics hacanastoma	Scribbly gum	15	SHRUBS
Lucatypius tentroanalana	Yellow top ash	5	Banksia robur
Lucatyptus andticadis	Whip stick maller	5	Bauera microphylla
Lincologitan eductions	Port Jackson mallee	6	Correa baeuerlenii
Loptospomini laevigalain	Coastal teatree	6	Epacris microphylla
RHKUBB			GROUNDCOVERS, R
Carpon Armonimology	Chefs cap correa	1	Dichondra repens
Harwa microphylla	White river ruse	0.3	Gahnia ervthrocarpa
Homeia somuluta	Nativerose	0.6	Gahnia sieberiana
Lynada microphylla	Coral Heath	0.5	Imperata cylindrica
Hildratta linearis	Showy guines flower	1	Isolepsis nodosa
			Juncus kraussii

Flax lity

Blady grass

Knobby club rush

Loonandra lonollolla WOODLAND PLANTING - OVER DEEP SOIL

GROUNDCOVERS AND GRASSES

Diamello pravino

Imponito extindaco

BOTANICAL NAME	COMMON NAME	MATURE HEIGHT (m)
TREES		
Acacia melanoxylcn	Blackwood	12
Allocasuarina littoralis	Black she oak	8
Angophora costate	Smooth banked apple	20
Ceratopetalum apetalum	Coachwood	8
Eucalyptus gummifera	Bloodwood	20
Eucalyptus haemastoma	Scribbly gum	15
Eucalyptus leuhmanniana	Yellow top ash	5
Eucalyptus multicaulis	Whip stick mallee	5
Eucalyptus obstars	Port Jackson mallee	6
Eucalyptus pilularis	Blackbutt	20
Leptospermum laevigatum	Coasta teatree	6
Melaleuca quinquenervia	Broad leaved paper bank	12
SHRUBS		
Acacia longifolia	Sydney zolden wattle	3
Acacia obtusifolia	Blunt leaf wattle	2
Bank sia ericifolia	Heath leaf banks ia	3
Banksia marginate	Silver banksia	2
Banksia robur	Swamp banksi a	2
Bauera microphylla	White r ver rose	0.3
Boronia semulata	Native ose	0.6
Bursaria spinulosa	Blackthorn	4
Callistemon citrinus	Red bottlebrush	4
Ceratopetalum gummiferum	NSW christmas bush	4

Chefs cap correa

Small leaf - tea tree

Coral Heath


GROUNDCOVERS AND GRASSES Dianella prunina

Ceratopetalum gummiferum Correa baeuerlenii

Epacris microphylla

Hibbertia linearis Leptospermum parvifolium

Flax lily Native (idney weed Goodenia hederacea Ivy lea goodenia Ground:over grevillea Gravillea 'Royal mantle Royal mantle grevillea Hibbertia scandens Snake v ne Imperata cylindrica Blady grass Isolepsis nodosa Knobby club rush Lomandra Ionaifolia Matrush Pandorea pandorana Wonga wonga vine Kangaroo grass

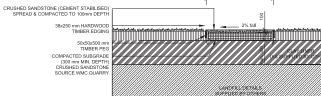

RECREATION TRAIL(To Engineer's final details)

LD02 TYPICAL SECTION SCALE 1:50

7	aylorBrammer

TAYLOR BRAMMER LANDSCAPE ARCHITECTS PTY LTD SYDNEY STUDIO 218 Oxford Street Woo&shro, NSW, 2025

SITA MASTERPLAN SCALE VARYIGAT CHECKER AL DRAWING NO. REVE CREATER: 17.00.2014 JOENS: 14-0255 DRAWIN: TO DESIGNED: AL LD02 F TYPICAL LANDSCAPE DETAILS 2

Coral Heath 0.5 GROUNDCOVERS, REEDS AND RUSHES Dichondra repens Native kidney week Gahnia erythrocarpa 1.5 Sword Sedge Gahnia sieberiana Sword Sedge 1.5 Imperata cylindrica Blady grass 0.4 Isolepsis nodosa 0.5 Knobby club rush Juncus kraussii Sea rush Juncus usitatus Common rush 0.6 1.5 Restio tetraphyllus Tassel rush LAWN AND NATIVE GRASSED AREA

COMMON NAME

Broad leaved paper bark

Black she oak

Swamp banksia

White river rose

Chefs cap correa

MATURE

HEIGHT (m)

12

0.3

WATERCOURSE PLANTING

Ceratopetalum apetalum Melaleuca quinquenervia

0.4

0.5

0.6

0.1

0.1

0.5

		IMATURE
BOTANICAL NAME	COMMON NAME	∃IG-:**:m
NATTVE GRASSES		
Themeda sustralia	Kanganga arass	1.4
Micro-seria stipolales	Weeding meadow grass	1.1
Dentwoods species	Vvet sick grass	1.2
Paterzon a sectres	Sikypuro effag	2.2
LAWK		
Perklastum pandestrum	⊀ c _i ;	

GHD

133 Castlereagh St Sydney NSW 2000

T: +61 2 9239 7100 F: +61 2 9239 7199 E: sydmail@ghd.com.au

© GHD 2015

This document is and shall remain the property of GHD. The document may only be used for the purpose for which it was commissioned and in accordance with the Terms of Engagement for the commission. Unauthorised use of this document in any form whatsoever is prohibited.

 $N:\AU\Sydney\Projects\21\23482\WP\201378.docx$

Document Status

Rev	Author	or Reviewer		Approved for Issue		
No.		Name	Signature	Name	Signature	Date
3	R Towner	D Gamble	Daid Gullo	D Gamble	Daid lasto	26/08/15

www.ghd.com

