

Report on Geotechnical Desktop Assessment

410-416 Victoria Avenue, Chatswood NSW

**Prepared for Novus Investco Pty Ltd** 

**Project 233988.01** 

24 March 2025



## **Document History**

#### **Details**

**Project No.** 233988.01

**Document Title** Report on Geotechnical Desktop Assessment

Site Address 410-416 Victoria Avenue, Chatswood

Report Prepared For Novus Investco Pty Ltd

**Filename** 233988.01.R.001.Rev0.

#### **Status and Review**

Status	Prepared by	Reviewed by	Date issued
Revision 0	Adam Teoh	Scott Easton	12 March 2025
Revision 1	Adam Teoh	Scott Easton	24 March 2025
Revision 2	Adam Teoh	Scott Easton	16 April 2025

## **Distribution of Copies**

Status	Issued to
Revision 0	Adrian Dunnett, Solis Projects Pty Ltd
Revision 1	Adrian Dunnett, Solis Projects Pty Ltd and Charles Maxwell, Novus Investco Pty Ltd
Revision 2	Adrian Dunnett, Solis Projects Pty Ltd and Charles Maxwell, Novus Investco Pty Ltd

The undersigned, on behalf of Douglas Partners Pty Ltd, confirm that this document and all attached drawings, logs and test results have been checked and reviewed for errors, omissions and inaccuracies.

Author Date

| dam | eth | 16 April 2025

Reviewer 16 April 2025





## **Table of Contents**

		1	Page No
1.	Intro	oduction	1
2.	Site	description	1
3.	Reg	jional mapping	2
	3.1	Soil landscape	2
	3.2	Geology	2
	3.3	Acid sulphate soils	2
	3.4	Salinity	2
	3.5	Hydrogeology	2
4.	Prev	vious Nearby Investigations	2
5.	Prop	posed Development	3
6.	Prel	liminary Comments	4
	6.1	Preliminary Geotechnical model	4
	6.2	Anticipated Geotechnical and Hydrogeological Issues	4
	6.3	Dilapidation Surveys	5
	6.4	Excavation	5
		6.4.1 Preliminary Excavation conditions	
		6.4.2 Vibrations	
		6.4.3 Disposal of Excavated Material	
	6.5	Excavation Support and Foundations	
	6.6	Groundwater	6
	6.7	Earthquake loading	6
	6.8	Further investigation	6
7.	Limi	itations	7

**Appendix A:** About This Report

**Appendix B:** Proposed Design Drawings



## Report on Geotechnical Desktop Assessment Proposed Mixed-Use Development 410-416 Victoria Avenue, Chatswood

#### 1. Introduction

This Geotechnical Assessment report has been prepared by Doulgas Partners Pty Ltd (Doulgas) to support a State Significant Development Application (SSDA) for a mixed-use development, known as Novus on Victoria, at 410-416 Victoria Ave, Chatswood NSW (the site). The investigation was commissioned by the proponent, to address Item 12 of the SEARs (SSD-63324208).

It is understood that the proposed development includes a 45-storey Build to Rent (BTR) development, with retail space on the ground floor and Level 1, over a three-level basement for car parking, storage units and service areas (i.e. substations, switch and pump rooms). It is anticipated, from the preliminary design drawings, that the lowest basement floor level will have a finished floor level at a reduced level (RL) of about 84.8 m with respect to the Australian height datum (AHD) and a bulk excavation level of RL 84.3 m, to accommodate the basement floor slab thickness. Excavation depths are therefore anticipated to depths of between 10 m to 12 m below surrounding street levels for the proposed two level basement.

The assessment consisted of a visual inspection of the site and a review of available information from published maps and reports and other geotechnical projects Douglas has undertaken in the area. No intrusive investigations have been undertaken by Douglas for this assessment due to the presence of existing buildings on the site, however, Douglas has been engaged to carry out additional geotechnical investigation at later stages of the project.

#### 2. Site description

The Site is located at 410-416 Victoria Avenue, Chatswood, also known as Lot A and B of Deposited Plan 406105 and Lot 4 of Deposited Plan 82303 and is a near rectangular area covering approximately 1,050 m<sup>2</sup> within the Willoughby City Council Local Government Area (LGA). The Site currently contains two-storey commercial buildings bounded by:

- The pedestrian walkway of Victoria Avenue to the north,
- The pedestrian walkway extension of Victor Street to the east,
- Post Office Lane to the south, and
- The property of 418 Victoria Avenue to the west.

The surface levels around the site generally fall from the western site boundary to the south east corner of the site from RL 96.1 m AHD to RL 94.3. m AHD.



#### 3. Regional mapping

#### 3.1 Soil landscape

Reference to the Sydney 1:100 000 Soil Landscape Series map indicates that most of the site is underlain by a landscape group known as the Blacktown soil landscape, with the boundary to the Glenorie soil landscape located approximately 40 m to the west of the Site.

The Blacktown soil landscape is a residual soil landscape and is characterised by topography of gently undulating rises on the Wianamatta Group shales, with local relief to 30 m and slope gradients of less than 5%.

Soil in the Blacktown soil landscape is typically shallow to moderately deep on crests, upper slopes and well-drained areas, and deep on lower slopes and in areas of poor drainage. These soils are typically moderately reactive and highly plastic with low soil fertility and poor soil drainage.

#### 3.2 Geology

Reference to the Sydney 1:100 000 Geological Series Map indicates that the site is underlain by Ashfield Shale, which typically comprises black to dark grey shale and laminate (finely interbedded sandstones and siltstones) which weathers to a residual clay profile of medium to high plasticity.

#### 3.3 Acid sulphate soils

Reference to the 1:25 000 Acid Sulphate Soil (ASS) Risk map indicates that the site is not known to be at risk of ASS.

#### 3.4 Salinity

Reference to the map of salinity potential in Western Sydney 2002 indicates that the site is not within an area of known salinity risk.

#### 3.5 Hydrogeology

A review of the WaterNSW database indicates registered groundwater well GW107757 is located approximately 260 m to the south of the Site, in Chatswood Park, and is reported to have been drilled to a termination depth of approximately 163 m below existing surface levels. A standing water level was noted, within the work summary sheet, at a depth of 25.6 m.

#### 4. Previous Nearby Investigations

DP has undertaken several geotechnical and contamination investigations and various construction monitoring projects in the area. Some of the investigations DP has undertaken or reviewed for this assessment include:

 Douglas project 86560.00 at 475 Victoria Ave, Chatswood, approximately 250 m to the west of the Site.



- Douglas project 5550 at 451 Victoria Ave, Chatswood, approximately 50 m to the north of the Site.
- Douglas project 73843.00 at 45 Victor St, Chatswood, approximately 40 m to the south of the Site.
- Douglas project 226554 at 763-769 Pacific Highway, Chatswood, approximately 350 m to the south west of the Site.
- Douglas project 86327.01 at 42 Archer Street, Chatswood, approximately 380 m to the south east of the Site.

From our work on these nearby sites, the ground profile was found to typically consist of

- Fill: Generally comprising pavement layers and sandy or clayey fill; overlying
- Residual Clay: Generally comprising medium to high plasticity, stiff to very stiff clay or silty clay which grades to hard, extremely weathered siltstone with depth;
- Interbedded Siltstone and Sandstone: encountered at depths of between 1.0 m and 3.0 m, with some locations up to 6 m and generally highly weathered and very low to low strength to depths of between 9 m and 10 m, before grading to fresh and medium to high strength rock.

Groundwater was measured in wells installed at:

- 763-769 Pacific Highway, Chatswood, approximately 360 m to the south west of the Site, with groundwater encountered at RL92.7 m on 6 December 2024, which was 5 m below the residual clay and siltstone interface.
- 42 Archer Street, Chatswood, approximately 380 m to the south east of the Site, with groundwater encountered at depths of between RL85.5 m and RL83.1 m within the siltstone bedrock.

#### 5. Proposed Development

It is understood from the provided architectural drawing set by Fender Katsalidis Pty Ltd (Drawing 23115-DA-000 to SK-0076 dated 19 December 2024) that the proposed development will consist of the demolition of all existing structures and the construction of a new 45-storey BTR development over a three-level basement. The provided architectural plans are provided in Appendix B.

Initial survey data for the site indicates that the existing ground surface levels range between RL 96 m AHD at the western boundary of the site, to RL 94.3 m AHD, in the south-eastern corner of the site. The proposed basement finished floor level is inferred to be at RL 84.8 m AHD. Assuming a bulk excavation level of 0.5 m below (RL 84.3AHD) it is anticipated that basement excavation may extend to depths of approximately between 10 m to 12 m.



#### 6. Preliminary Comments

#### 6.1 Preliminary Geotechnical model

The inferred geotechnical model for the site is:

- **FILL:** concrete slab over fill layers within the footprint of the existing site buildings, with varying compaction and varying proportions of clay, silt, sand and gravel to depths of up to 1.0 m. Anthropogenic materials may also be encountered within the fill given its variable and man-made nature; overlying
- **RESIDUAL CLAY:** brown to red-brown clay initially of stiff consistency, grading to very stiff with depth and then hard as the residual clay transitions to extremely weathered siltstone. Residual clay is anticipated to be present to depths of between 1 m and 2 m but possibly up to 4 m;
- **INTERBEDDED SILTSTONE AND SANDSTONE BEDROCK:** likely to be encountered below the residual clay and initially being very low to low strength, highly weathered to moderately weathered siltstone and sandstone. Medium strength and stronger siltstone and sandstone is likely to be encountered below depths of approximately between 9 m and 10 m.

Groundwater is anticipated to be within the bedrock with preliminary groundwater levels estimated to be at approximately RL 90 m AHD with fluctuations of up to ±2 m. Groundwater levels are subject to change and further details must be obtained from groundwater monitoring and measurements during later investigation stages.

Registered groundwater well GW107757 located approximately 260 m to the east in Chatswood Park, had a standing water level recorded at a depth of 25.6 m and is considered indicative of the regional groundwater table depth in the general area due to the well being installed to a depth of 162 m. The shallower water level measurements in the area may be associated with perched seepage along the clay and rock surface and water within the joints and fractures in the rock.

#### 6.2 Anticipated Geotechnical and Hydrogeological Issues

The anticipated key geotechnical and hydrogeological issues that need to be considered for the proposed development are:

- The anticipated groundwater level on the site is above the proposed excavation level, however, a deeper registered bore about 260 m from the site indicated groundwater at greater depths. It is expected that a drained basement may be suitable for the proposed development, given the likely low permeability of the subsurface materials intersected by the proposed basement;
- the proposed basement excavation is likely to induce ground movement with the magnitude subject to the proposed shoring wall type and ground conditions encountered. These movements would need to be quantified prior to commencement of excavation works on site as nearby structures and infrastructure/services are present (i.e. neighbouring buildings);
- if anchors are used to temporarily support the shoring, it will be necessary to obtain permission from affected parties prior to installation.



#### 6.3 Dilapidation Surveys

Dilapidation surveys should be carried out on adjacent/existing buildings, as well as pavements and significant infrastructure that may be affected by the excavation works, prior to these works commencing.

#### 6.4 Excavation

#### 6.4.1 Preliminary Excavation conditions

It is anticipated that excavation for the proposed basement will be required to depths of between 9.5 m and 11.5 m. The basement excavation can be expected to require the removal of mostly fill, residual clay and weathered very low to low strength siltstone bedrock, which should be readily achieved using buckets of conventional earthmoving equipment, particularly if fitted with 'rock teeth'. Medium strength or stronger rock is also anticipated to be exposed at the base of the basement excavation, particularly for detailed excavation (e.g. lift pits, footings) and would require the use of rock hammers for effective removal. Rock saws may be required near site boundaries to reduce overbreak and vibrations.

#### 6.4.2 Vibrations

During excavation, it will be necessary to use appropriate methods and equipment to keep ground vibrations at adjacent buildings and structures within acceptable limits. The level of acceptable vibration is dependent on various factors including the type of structure (e.g., reinforced concrete or brick structures etc.), its structural condition, the frequency range of vibrations produced by the construction equipment, the natural frequency of the structure and the vibration transmitting medium.

Vibrations generated from construction activities should be managed in accordance with the relevant Australian Standards (such as AS2670) and construction guidelines. It is understood that a Construction Noise & Vibration Report will be prepared by others to address vibration requirements.

#### 6.4.3 Disposal of Excavated Material

All excavated materials will need to be disposed of in accordance with the provisions of the current legislation and guidelines including the Waste Classification Guidelines (EPA, 2014). This includes fill and natural materials that may be removed from the site.

#### 6.5 Excavation Support and Foundations

It is understood from the supplied architectural drawings, that the basement excavation will require lateral support of excavations between 10 m and 12 m in depth. Based on the findings of our preliminary geotechnical model (Section 6.1) the proposed basement is likely to intersect fill, residual clay and interbedded siltstone and sandstone and expose medium strength and possibly stronger rock at the base of the excavation.

At this current stage in planning and preliminary design it is recommended that intrusive investigations are undertaken so that subsurface conditions of the site can be assessed, and subsequently suitable shoring and foundation systems may be designed.



6.6

#### 6.6 Groundwater

Groundwater is expected to occur primarily as perched seepage along the soil–rock interface and through joints and bedding planes within the rock exposed in the basement floor and walls. These conditions are typically associated with low-permeability materials, and Douglas' experience on similar sites in the Chatswood area indicates that groundwater inflows through these strata are generally very limited — due either to the depth of the regional water table or the low hydraulic conductivity of the soil and rock mass. The regional groundwater table is expected to lie below the base of the proposed basement excavation.

At this preliminary (desktop) stage, groundwater inflows are anticipated to be less than the 3 ML/year threshold for exemption from a Water Access Licence (WAL) for temporary dewatering during construction with any associated dewatering impacts expected to fall within the "minimal impact" criteria defined by the NSW Aquifer Interference Policy (AIP). Any seepage inflows are expected to be readily managed via perimeter and subfloor drainage systems discharging to a sump-and-pump arrangement for a drained basement.

Once site access is available, groundwater monitoring and investigation will be undertaken to confirm subsurface and groundwater conditions at the site. This information will be necessary to determine whether the proposed basement intersects groundwater, thereby triggering the requirement for a Groundwater Impact Assessment, typically in the form of a preliminary Dewatering Management Plan, to satisfy the Secretary's Environmental Assessment Requirements (SEARs).

For a drained basement design, these investigations and assessments will be required to quantitatively assess inflows and evaluate potential environmental impacts, including those addressed under the AIP and other relevant statutory considerations before the approval of a drained basement.

If a drained basement is proposed it is also noted that groundwater inflows may lead to the precipitation of a red-brown iron oxide residue due to the oxidation of soluble iron commonly present in groundwater. Accordingly, perimeter and subfloor drains should be designed to allow easy access for inspection, maintenance, and periodic cleaning.

#### 6.7 Earthquake loading

Weathered bedrock is anticipated at depths of up to 3 m below existing surface levels, therefore the site can be preliminarily classified as a ' $B_{\rm e}$  – Rock site'. However, this classification is subject to further confirmation from the later stages of geotechnical investigation.

#### 6.8 Further investigation

The comments provided in this report are preliminary and further geotechnical investigations are proposed on site, for detailed design and prior to the commencement of excavation works, to obtain further information on the site once suitable access is available. The investigations proposed include (but are not necessarily limited to):

 drilling of boreholes for subsurface profiling. Boreholes should be extended at least 5 m below the lowest excavation level (such as lift pits) and should also prove at least 5 m of medium strength or stronger siltstone;



- installation of at least three groundwater monitoring wells;
- install data loggers to measure groundwater levels before and during construction (min 3 months data);
- permeability testing within the monitoring wells;
- obtain groundwater quality data from the wells;
- groundwater modelling to assess inflows and drawdown.

Further geotechnical analysis and assessment may also include analysis of shoring systems and ground movements, assessment of neighbouring building footings/movements and services including Sydney Water assets.

#### 7. Limitations

Douglas Partners Pty Ltd (Douglas) has prepared this report for this project at 410-416 Victoria Ave, Chatswood in accordance with Douglas' proposal 233988.00.P.001.Rev1 dated 19 February 2025 and acceptance from Adrian Dunnet of Solis Projects Pty Ltd. The work was carried out under a Consultant Agreement between Novus Investco Pty Ltd and Douglas Partners Pty Ltd. This report is provided for the exclusive use of Novus Investco Pty Ltd for this project only and for the purposes as described in the report. It should not be used by or relied upon for other projects or purposes on the same or other sites, or by a third party. Any party so relying upon this report beyond its exclusive use and purpose as stated above, and without the express written consent of Douglas, does so entirely at its own risk and without recourse to Douglas for any loss or damage. In preparing this report Douglas has necessarily relied upon information provided by the client and / or their agents.

Douglas' advice is based upon the conditions encountered during previous investigations on and around the site by Douglas and others. The accuracy of the advice provided by Douglas in this report may be affected by undetected variations in ground conditions across the site between and beyond the sampling and / or testing locations.

The assessment of atypical safety hazards arising from this advice is restricted to the geotechnical components set out in this report and based on known project conditions and stated design advice and assumptions. While some recommendations for safe controls may be provided, detailed 'safety in design' assessment is outside the current scope of this report and requires additional project data and assessment.

This report must be read in conjunction with all of the attached and should be kept in its entirety without separation of individual pages or sections. Douglas cannot be held responsible for interpretations or conclusions made by others unless they are supported by an expressed statement, interpretation, outcome or conclusion stated in this report.

This report, or sections from this report, should not be used as part of a specification for a project, without review and agreement by Douglas. This is because this report has been written as advice and opinion rather than instructions for construction.

## Appendix A

About This Report

## **About this Report**



November 2023

#### Introduction

These notes have been provided to amplify DP's report in regard to classification methods, field procedures and the comments section. Not all are necessarily relevant to all reports.

DP's reports are based on information gained from limited subsurface excavations and sampling, supplemented by knowledge of local geology and experience. For this reason, they must be regarded as interpretive rather than factual documents, limited to some extent by the scope of information on which they rely.

#### Copyright

This report is the property of Douglas Partners Pty Ltd. The report may only be used for the purpose for which it was commissioned and in accordance with the Conditions of Engagement for the commission supplied at the time of proposal. Unauthorised use of this report in any form whatsoever is prohibited.

#### **Borehole and Test Pit Logs**

The borehole and test pit logs presented in this report are an engineering and/or geological interpretation of the subsurface conditions, and their reliability will depend to some extent on frequency of sampling and the method of drilling or excavation. Ideally, continuous undisturbed sampling or core drilling will provide the most reliable assessment, but this is not always practicable or possible to justify on economic grounds. In any case the boreholes and test pits represent only a very small sample of the total subsurface profile.

Interpretation of the information and its application to design and construction should therefore take into account the spacing of boreholes or pits, the frequency of sampling, and the possibility of other than 'straight line' variations between the test locations.

#### **Groundwater**

Where groundwater levels are measured in boreholes there are several potential problems, namely:

- In low permeability soils groundwater may enter the hole very slowly or perhaps not at all during the time the hole is left open;
- A localised, perched water table may lead to an erroneous indication of the true water table;
- Water table levels will vary from time to time with seasons or recent weather changes. They may not be the same at

- the time of construction as are indicated in the report; and
- The use of water or mud as a drilling fluid will mask any groundwater inflow. Water has to be blown out of the hole and drilling mud must first be washed out of the hole if water measurements are to be made.

More reliable measurements can be made by installing standpipes which are read at intervals over several days, or perhaps weeks for low permeability soils. Piezometers, sealed in a particular stratum, may be advisable in low permeability soils or where there may be interference from a perched water table.

#### **Reports**

The report has been prepared by qualified personnel, is based on the information obtained from field and laboratory testing, and has been undertaken to current engineering standards of interpretation and analysis. Where the report has been prepared for a specific design proposal, the information and interpretation may not be relevant if the design proposal is changed. If this happens, DP will be pleased to review the report and the sufficiency of the investigation work.

Every care is taken with the report as it relates to interpretation of subsurface conditions, discussion of geotechnical and environmental aspects, and recommendations or suggestions for design and construction. However, DP cannot always anticipate or assume responsibility for:

- Unexpected variations in ground conditions. The potential for this will depend partly on borehole or pit spacing and sampling frequency;
- Changes in policy or interpretations of policy by statutory authorities; or
- The actions of contractors responding to commercial pressures.

If these occur, DP will be pleased to assist with investigations or advice to resolve the matter.

continued next page



### **About this Report**

#### **Site Anomalies**

In the event that conditions encountered on site during construction appear to vary from those which were expected from the information contained in the report, DP requests that it be immediately notified. Most problems are much more readily resolved when conditions are exposed rather than at some later stage, well after the event.

#### **Information for Contractual Purposes**

Where information obtained from this report is provided for tendering purposes, it is recommended that all information, including the written report and discussion, be made available. In circumstances where the discussion or comments section is not relevant to the contractual situation, it may be appropriate to prepare a specially edited document. DP would be pleased to assist in this regard and/or to make additional report copies available for contract purposes at a nominal charge.

#### **Site Inspection**

The company will always be pleased to provide engineering inspection services for geotechnical and environmental aspects of work to which this report is related. This could range from a site visit to confirm that conditions exposed are as expected, to full time engineering presence on site.

intentionally blank

intentionally blank



## Appendix B

Proposed Design Drawings

DRAWING TITLE

DA 000 COVER PAGE AND CONTENTS

DA 002 SITE ANALYSIS + DESIGN PRINCIPLES

DA 003 BUILT FORM SEPARATION

DA 004 SITE SURVEY

DA 005 DEMOLITION PLAN

DA 006 DEVELOPMENT SUMMARY

DA 097 BASEMENT 03 FLOOR PLAN

DA 098 BASEMENT 02 FLOOR PLAN

DA 099 BASEMENT 01 FLOOR PLAN

DA 100 GROUND FLOOR PLAN

DA 101 LEVEL 01 FLOOR PLAN

DA 102 LEVEL 02 FLOOR PLAN DA 103 LEVEL 03 - 04 FLOOR PLAN

DA 105 LEVEL 05 FLOOR PLAN

DA 106 LEVEL 06 FLOOR PLAN

DA 107 LEVEL 07-22 FLOOR PLAN

DA 123 LEVEL 23 FLOOR PLAN (MID RISE PLANT)

DA 135 LEVEL 24-43 FLOOR PLAN

DA 144 LEVEL 44 FLOOR PLAN

DA 145 LEVEL 45 FLOOR PLAN (PLANT)

DA 146 LEVEL 46 FLOOR PLAN (ROOF PLANT)

DA 147 ROOF PLAN

DA 200 NORTH ELEVATION - TOWER

SOUTH ELEVATION - TOWER

DA 202 EAST ELEVATION - TOWER

DA 203 WEST ELEVATION - TOWER

DA 204 PODIUM ELEVATIONS - NORTH

DA 205 PODIUM ELEVATIONS - SOUTH

DA 206 PODIUM ELEVATIONS - EAST DA 207 TOWER ELEVATIONS

DA 250 SECTIONS

DA 251 SECTIONS

DA 252 PODIUM SECTIONS

DA 253 PODIUM SECTIONS DA 255 FAÇADE STRATEGY

DA 300 MATERIALITY PALETTE

DA 301 RENDERS

DA 302 RENDERS

DA 400 VIEWS FROM THE SUN

VIEWS FROM THE SUN

DA 402 VIEWS FROM THE SUN

VIEWS FROM THE SUN

DA 404 VIEWS FROM THE SUN

DA 405 SHADOW DIAGRAMS

DA 406 SHADOW DIAGRAMS SHADOW DIAGRAMS

COMPLIANCE - GFA

COMPLIANCE - GFA

COMPLIANCE - GBA

DA 505 SEPP 65 COMPLIANCE - SOLAR AND CROSS VENTILATION

STORAGE DRAWINGS AND SCHEDULES

COMPLIANCE - GBA

COMPLIANCE - COMMUNAL OPEN SPACE, TERRACE AND LANDSCAPE

COMPLIANCE - LIVABLE/ADAPTABLE APARTMENTS



Autodesk Docs://23115 410-416 Victoria Avenue Chatswood/23115\_GENERAL\_R24.rvt

A SSDA LODGEMENT

18.03.25

**QUALITY ASSURANCE** (FK IS A CERTIFIED COMPANY TO ISO 9001-2015)

UNCONTROLLED COPY

IF THIS DRAWING IS STAMPED 'UNCONTROLLED COPY' THEN IT IS TO BE CONSIDERED A DRAFT, SUBJECT TO REVISION WITHOUT NOTICE NOT FOR CONSTRUCTION

NOTES
THIS DRAWING IS COPYRIGHT AND SHALL REMAIN THE PROPERTY OF FENDER KATSALIDIS (AUST) PTY LTD CHECK AND VERIFY ALL DIMENSIONS ON SITE PRIOR TO COMMENCING WORK. DRAWING TO BE READ IN CONJUNCTION WITH ALL OTHER CONTRACT DOCUMENTS. DO NOT SCALE DRAWINGS. USE FIGURED DIMENSIONS ONLY. SEEK CLARIFICATION OF INCONSISTENCES / CONFLICTS.

18.03.25


23115


410-416 VICTORIA AVE CHATSWOOD


NOVUS ON VICTORIA

COVER PAGE AND CONTENTS

FENDER KATSALIDIS WWW.FKAUSTRALIA.COM L21, 259 GEORGE STREET, SYDNEY NEW SOUTH WALES 2000 AUSTRALIA TELEPHONE: +61 2 8216 3500 FENDER KATSALIDIS (AUST) PTY LTD ACN 092 943 032

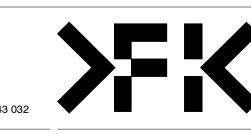


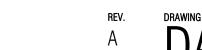

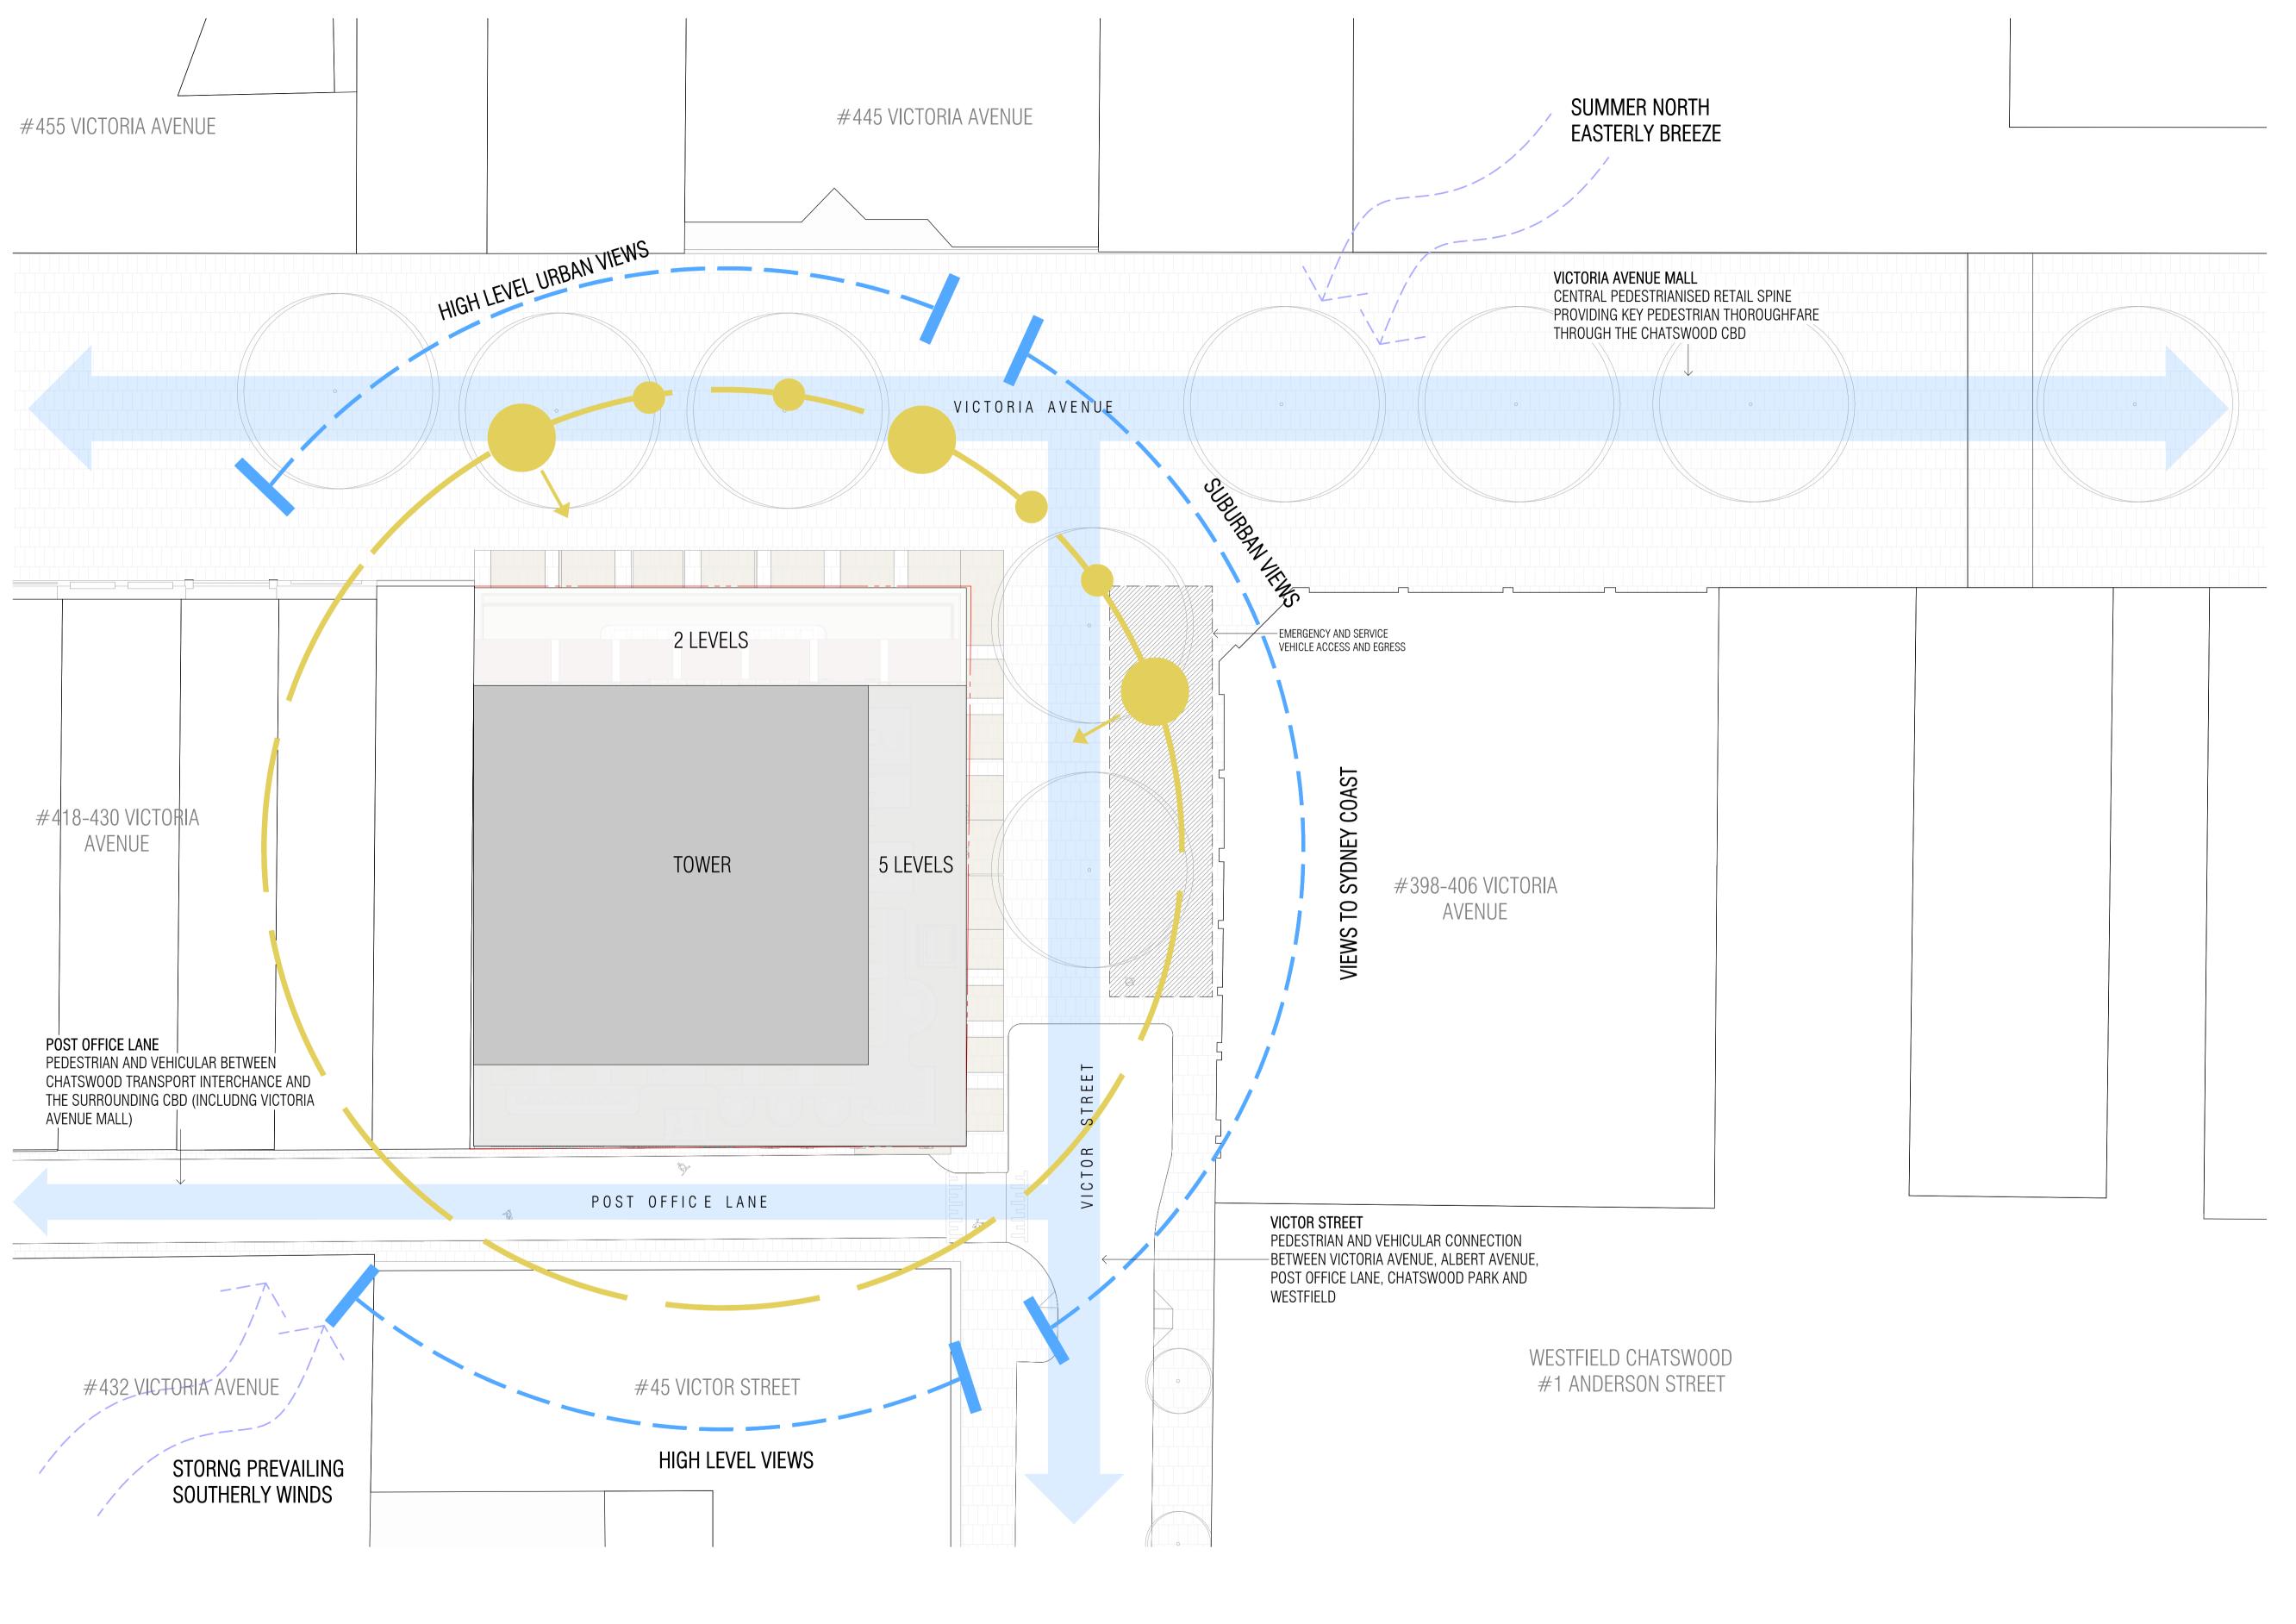

Autodesk Docs://23115 410-416 Victoria Avenue Chatswood/23115\_GENERAL\_R24.rvt **QUALITY ASSURANCE** (FK IS A CERTIFIED COMPANY TO ISO 9001-2015) A SSDA LODGEMENT 18.03.25 IF THIS DRAWING IS STAMPED 'UNCONTROLLED COPY' THEN IT IS TO BE CONSIDERED A DRAFT, SUBJECT TO REVISION WITHOUT NOTICE NOT FOR CONSTRUCTION



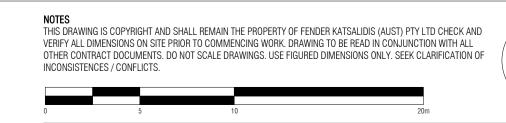

18.03.25

23115





1:200@A1

NOVUS ON VICTORIA 410-416 VICTORIA AVE CHATSWOOD

SITE ANALYSIS + DESIGN PRINCIPLES

FENDER KATSALIDIS
WWW.FKAUSTRALIA.COM
L21, 259 GEORGE STREET, SYDNEY NEW SOUTH WALES 2000 AUSTRALIA TELEPHONE: +61 2 8216 3500 FENDER KATSALIDIS (AUST) PTY LTD ACN 092 943 032

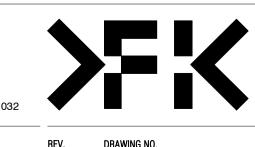

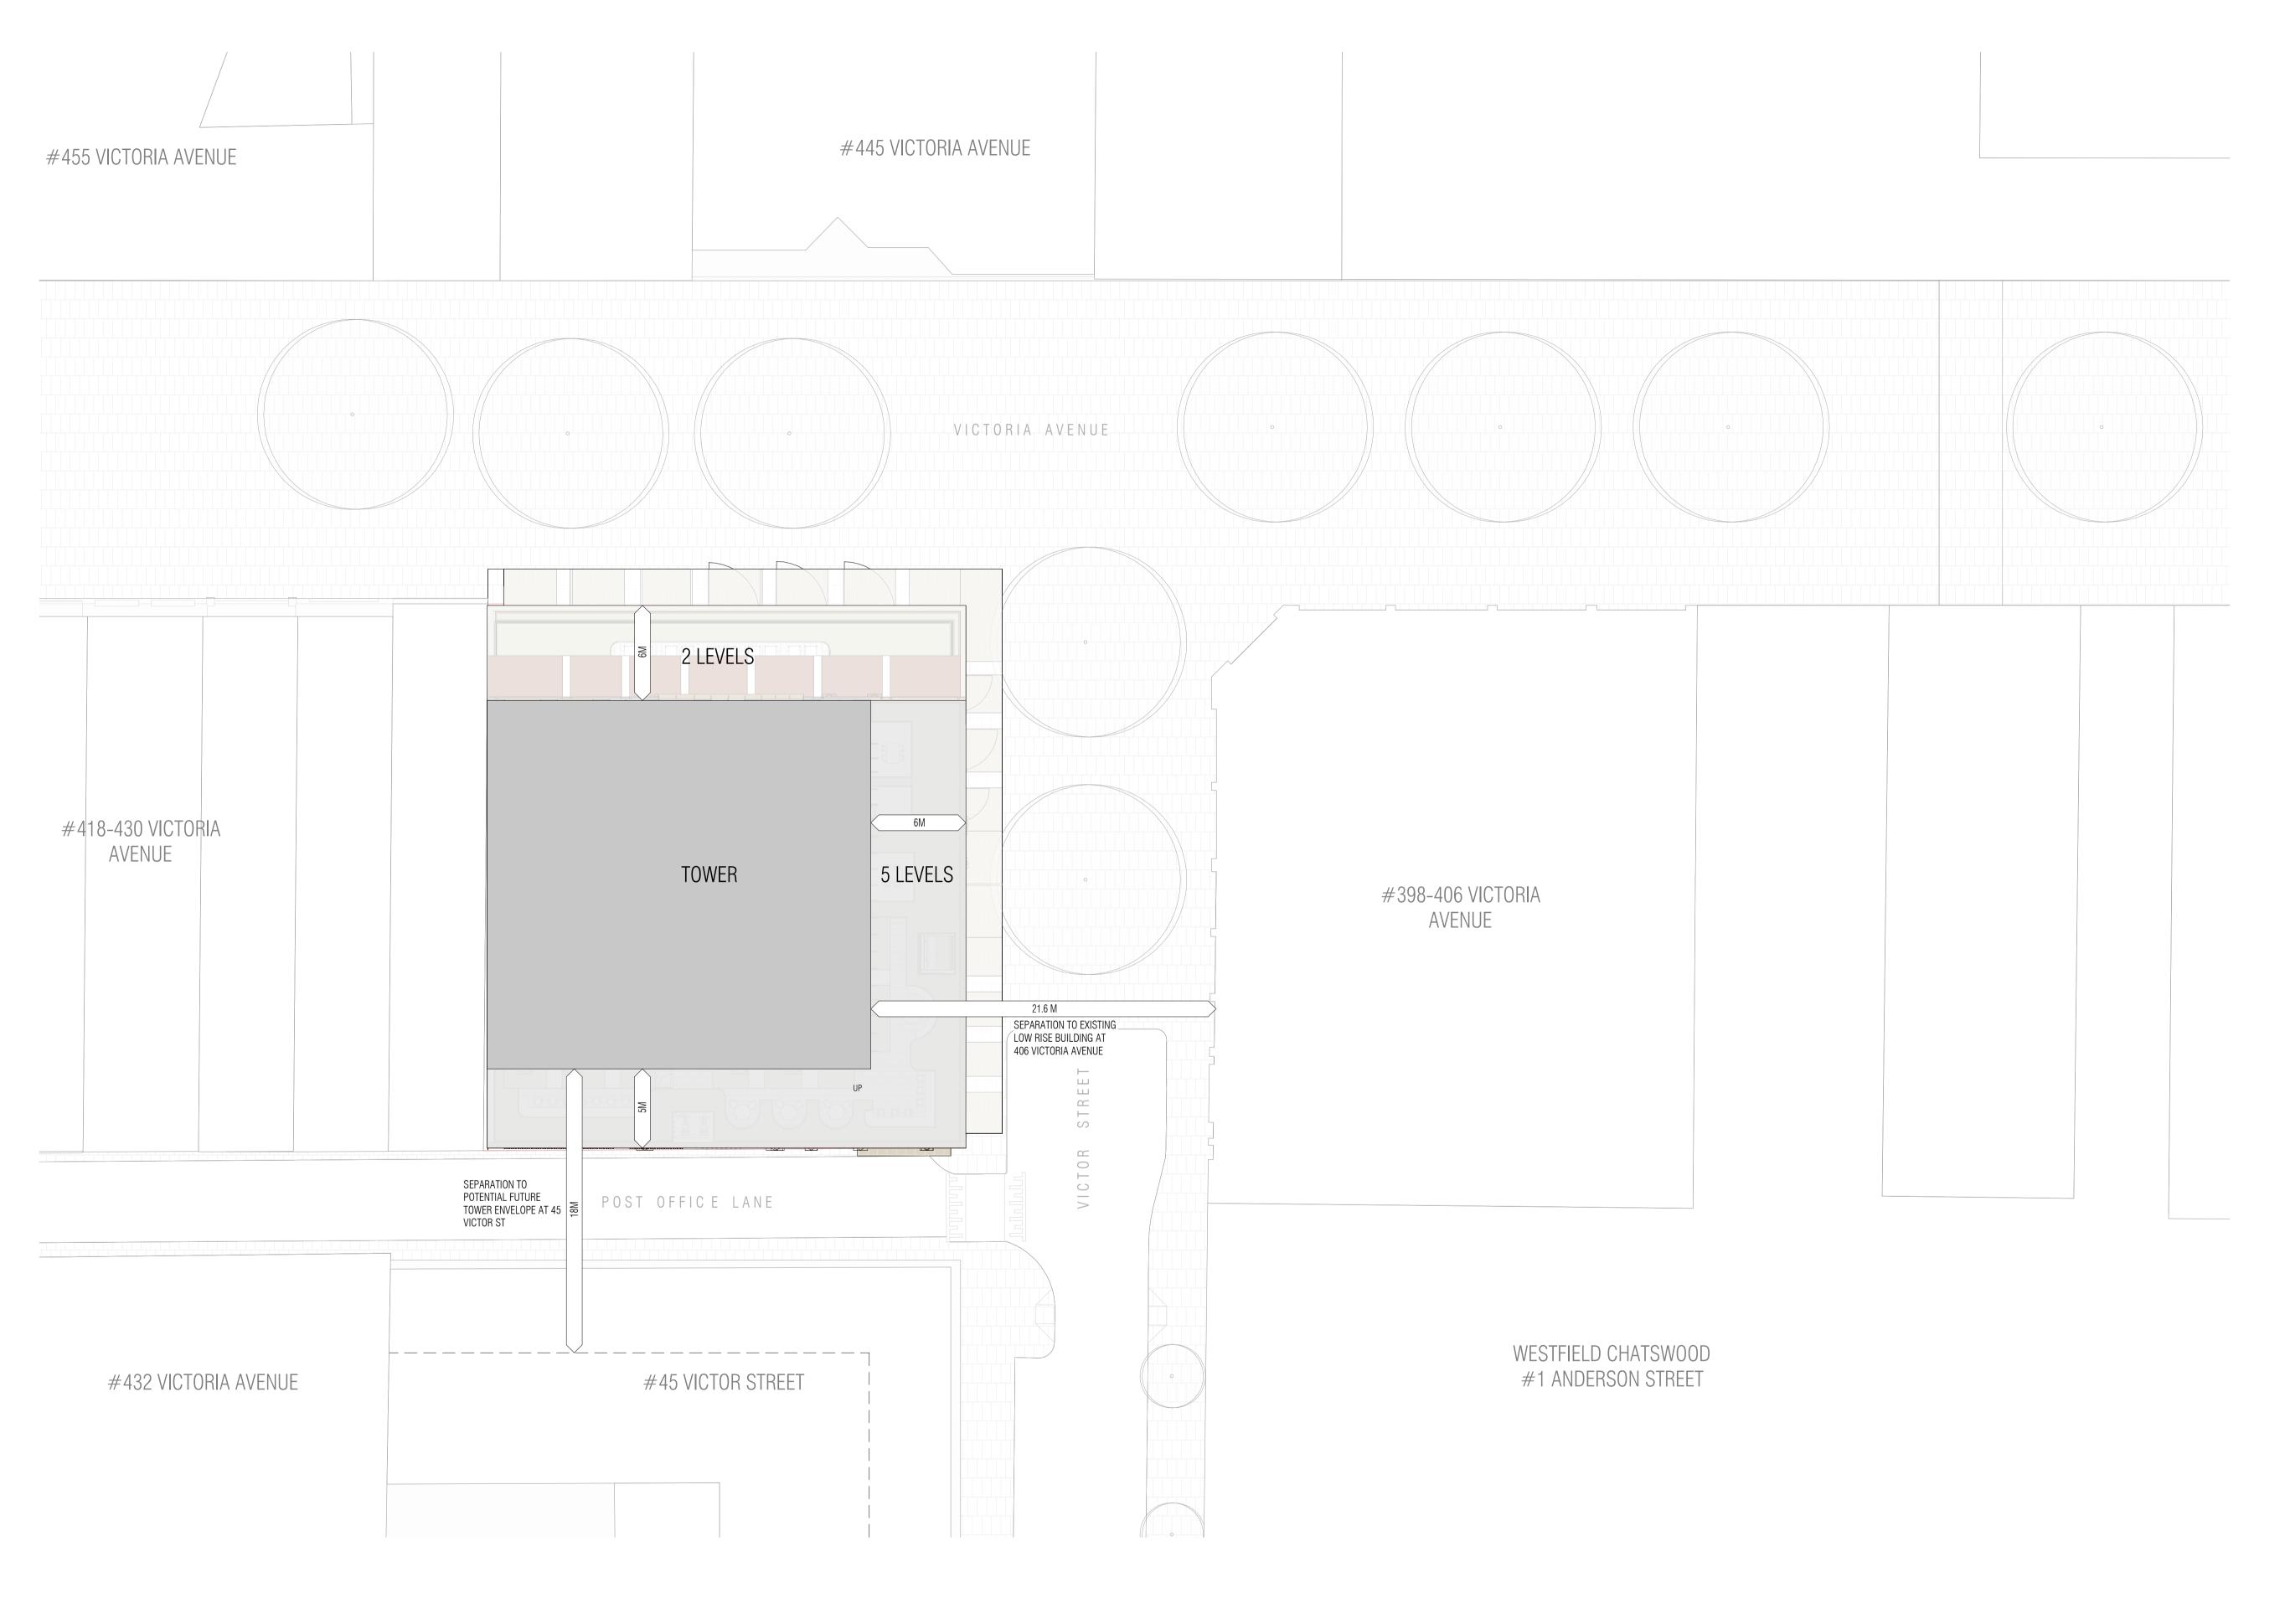

18.03.25

A SSDA LODGEMENT

QUALITY ASSURANCE (FK IS A CERTIFIED COMPANY TO ISO 9001-2015)

THIS PROJECT IS SUBJECT TO THE FK QUALITY ASSURANCE SYSTEM UNCONTROLLED COPY NOTES
THIS DRAWING IS COPYRIGHT AND SHALL REMAIN THE PROPERTY OF FENDER KATSALIDIS (AUST) PTY LTD CHECK AND VERIFY ALL DIMENSIONS ON SITE PRIOR TO COMMENCING WORK. DRAWING TO BE READ IN CONJUNCTION WITH ALL OTHER CONTRACT DOCUMENTS. DO NOT SCALE DRAWINGS. USE FIGURED DIMENSIONS ONLY. SEEK CLARIFICATION OF





NOVUS ON VICTORIA 410-416 VICTORIA AVE CHATSWOOD

FENDER KATSALIDIS
WWW.FKAUSTRALIA.COM
L21, 259 GEORGE STREET, SYDNEY NEW SOUTH WALES 2000 AUSTRALIA TELEPHONE: +61 2 8216 3500 FENDER KATSALIDIS (AUST) PTY LTD ACN 092 943 032



IF THIS DRAWING IS STAMPED 'UNCONTROLLED COPY' THEN IT IS TO BE CONSIDERED A DRAFT, SUBJECT TO REVISION WITHOUT NOTICE NOT FOR CONSTRUCTION

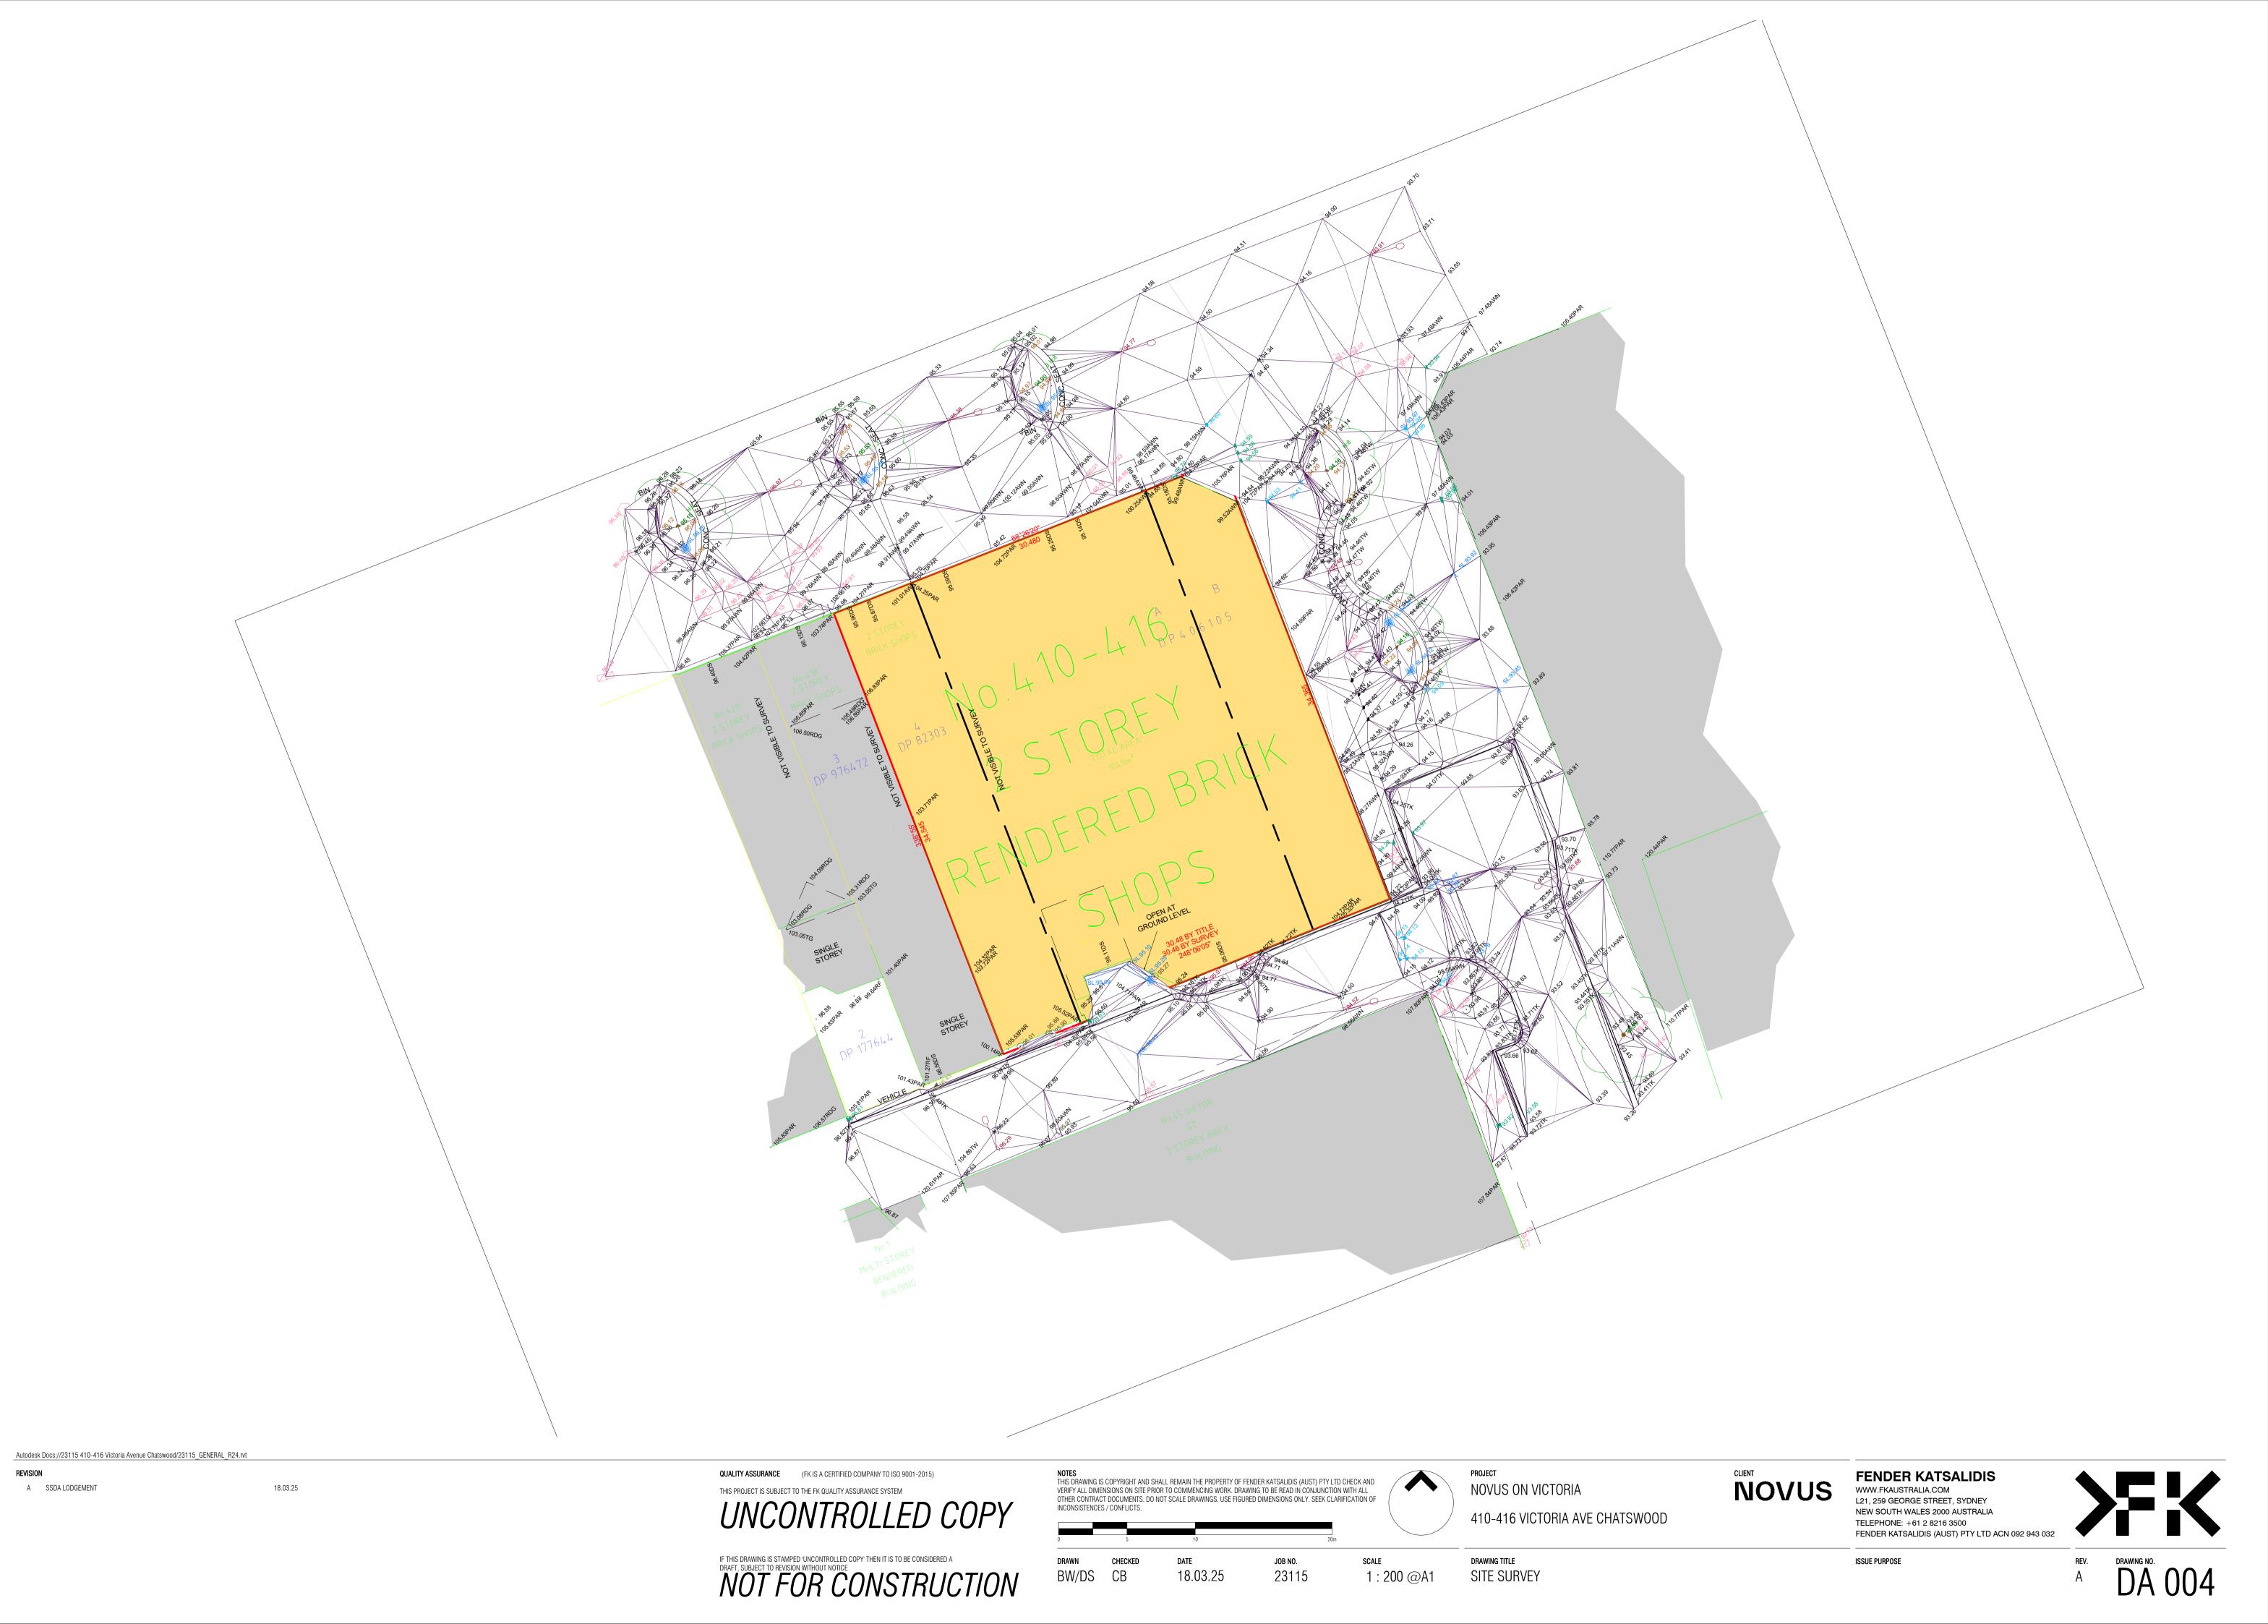

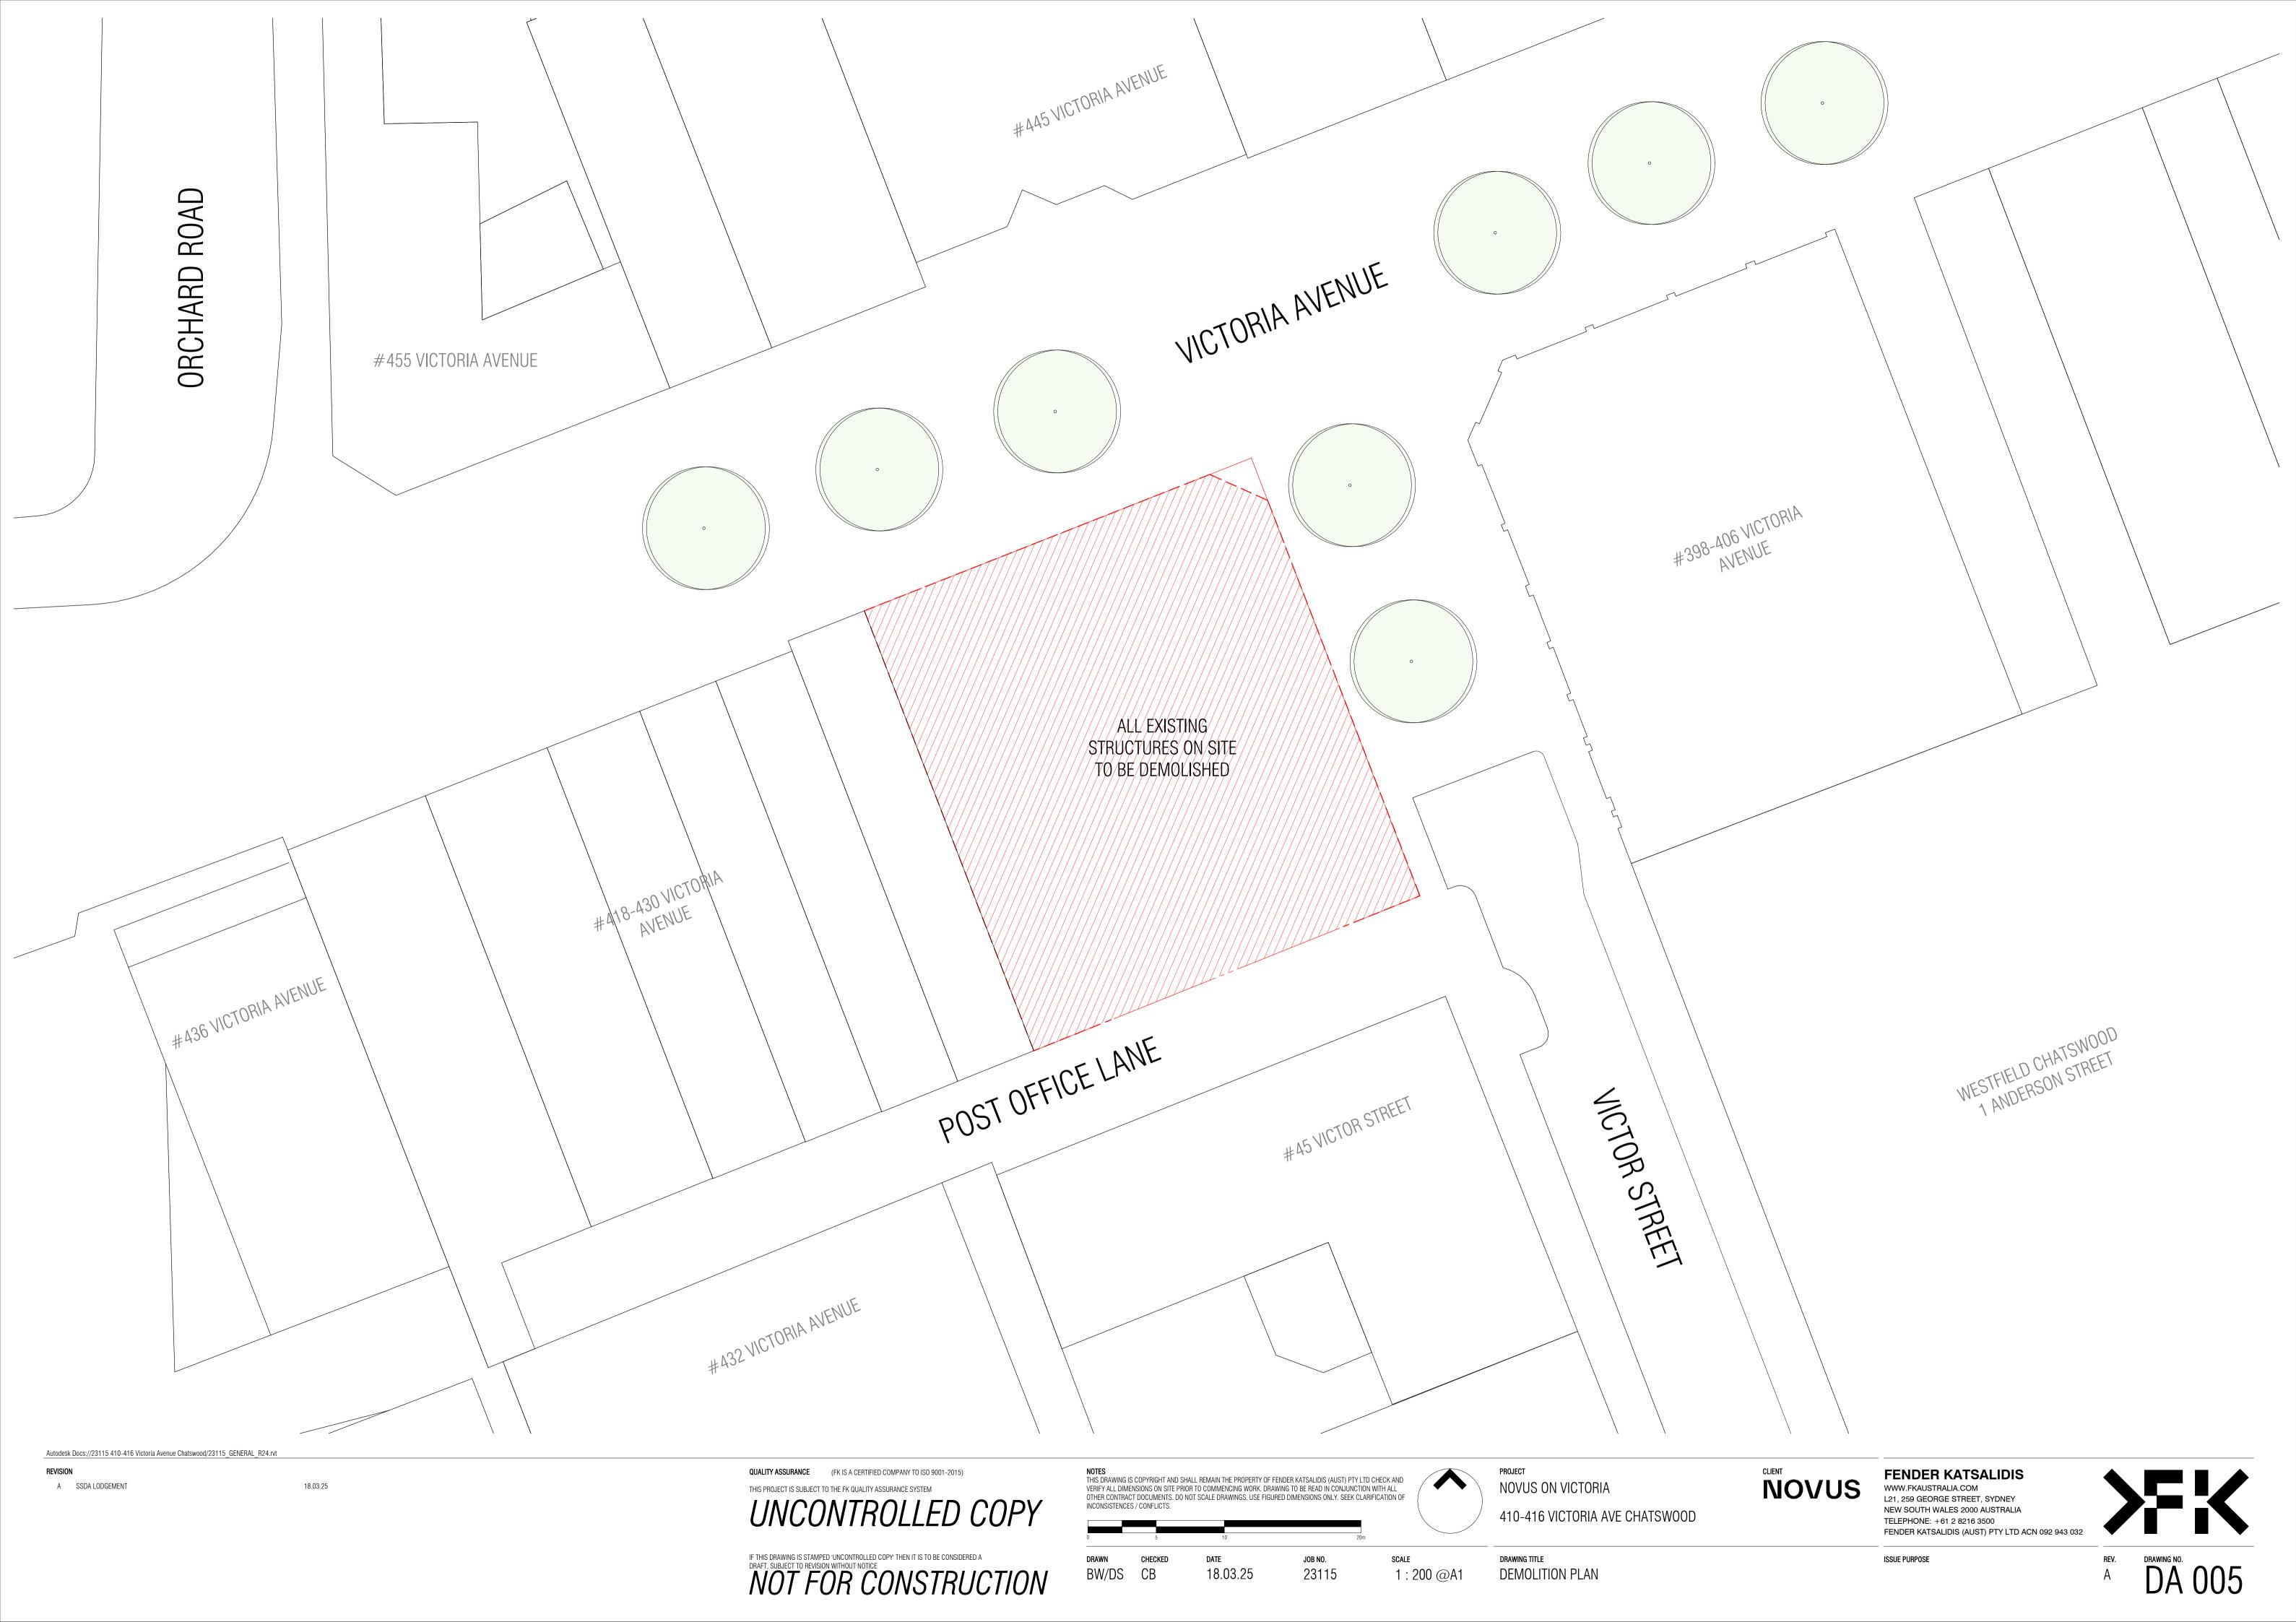

# **KEY METRICS**

SITE AREA - 1049.876 m<sup>2</sup>

PROPOSED OVERALL GFA - 18,437 m<sup>2</sup> - 16,280 m<sup>2</sup> PROPOSED RESIDENTIAL GFA PROPOSED RETAIL GFA - 1,110 m<sup>2</sup> - 1,047 m<sup>2</sup> PROPOSED AMENITY GFA

DEVELOPMENT SUMMARY										
APARTMENT MIX  NIA NLA TOTAL AMENITY RE								DEOL		
LEVEL	STUDIO	1 BED	2 BED	3 BED	TOTAL	NIA RESIDENTIAL	NLA RETAIL	NSA/NLA	AMENITY -INTERNAL	RESI TERRACE
BASEMENT 3	0	0	0	0	0	0 m <sup>2</sup>	0 m <sup>2</sup>	0 m <sup>2</sup>	253 m <sup>2</sup>	0 m
BASEMENT 2	0	0	0	0	0	0 m <sup>2</sup>	0 m <sup>2</sup>	0 m <sup>2</sup>	83 m <sup>2</sup>	0 m
BASEMENT 1	0	0	0	0	0	0 m <sup>2</sup>	60 m <sup>2</sup>	60 m <sup>2</sup>	82 m <sup>2</sup>	0 m
GROUND	0	0	0	0	0	0 m <sup>2</sup>	376 m <sup>2</sup>	376 m <sup>2</sup>	0 m <sup>2</sup>	0 m
LEVEL 1	0	0	0	0	0	0 m <sup>2</sup>	789 m²	789 m <sup>2</sup>	0 m <sup>2</sup>	0 m
LEVEL 2	0	0	0	0	0	0 m <sup>2</sup>	0 m <sup>2</sup>	0 m <sup>2</sup>	786 m <sup>2</sup>	343 m
LEVEL 3	3	2	2	1	8	499 m²	0 m <sup>2</sup>	499 m <sup>2</sup>	0 m <sup>2</sup>	0 m
LEVEL 4	3	2	2	1	8	499 m²	0 m <sup>2</sup>	499 m <sup>2</sup>	0 m <sup>2</sup>	0 m
LEVEL 5	3	2	2	1	8	499 m²	0 m <sup>2</sup>	499 m <sup>2</sup>	40 m <sup>2</sup>	0 m
LEVEL 6	2	1	1	0	4	190 m <sup>2</sup>	0 m <sup>2</sup>	190 m <sup>2</sup>	158 m <sup>2</sup>	237 m
LEVEL 7	4	2	1	0	7	318 m <sup>2</sup>	0 m <sup>2</sup>		0 m <sup>2</sup>	0 m
LEVEL 7 LEVEL 8	4	2	1	0	7	318 m <sup>2</sup>		318 m <sup>2</sup>	0 m <sup>2</sup>	0 m
	<u> </u>				7		0 m <sup>2</sup>			
LEVEL 9	4	2	1	0		318 m <sup>2</sup>	0 m <sup>2</sup>	318 m <sup>2</sup>	0 m <sup>2</sup>	0 m
LEVEL 10	4	2	1	0	7	318 m <sup>2</sup>	0 m <sup>2</sup>		0 m <sup>2</sup>	0 m
LEVEL 11	4	2	1	0	7	318 m <sup>2</sup>	0 m <sup>2</sup>	318 m <sup>2</sup>	0 m <sup>2</sup>	0 m
_EVEL 12	4	2	1	0	7	318 m <sup>2</sup>	0 m <sup>2</sup>	318 m <sup>2</sup>	0 m <sup>2</sup>	0 m
LEVEL 13	4	2	1	0	7	318 m <sup>2</sup>	0 m <sup>2</sup>		0 m <sup>2</sup>	0 m
LEVEL 14	4	2	1	0	7	318 m <sup>2</sup>	0 m <sup>2</sup>	318 m <sup>2</sup>	0 m <sup>2</sup>	0 m
LEVEL 15	4	2	1	0	7	318 m <sup>2</sup>	0 m <sup>2</sup>	318 m <sup>2</sup>	0 m <sup>2</sup>	0 m
_EVEL 16	4	2	1	0	7	318 m <sup>2</sup>	0 m <sup>2</sup>	318 m <sup>2</sup>	0 m <sup>2</sup>	0 m
_EVEL 17	4	2	1	0	7	318 m <sup>2</sup>	0 m <sup>2</sup>	318 m <sup>2</sup>	0 m <sup>2</sup>	0 m
_EVEL 18	4	2	1	0	7	318 m <sup>2</sup>	0 m <sup>2</sup>	318 m <sup>2</sup>	0 m <sup>2</sup>	0 m
LEVEL 19	4	2	1	0	7	318 m <sup>2</sup>	0 m <sup>2</sup>	318 m <sup>2</sup>	0 m <sup>2</sup>	0 m
LEVEL 20	4	2	1	0	7	318 m <sup>2</sup>	$0 \text{ m}^2$	318 m <sup>2</sup>	$0 \text{ m}^2$	0 m
LEVEL 21	4	2	1	0	7	318 m <sup>2</sup>	0 m <sup>2</sup>	318 m <sup>2</sup>	0 m <sup>2</sup>	0 m
LEVEL 22	4	2	1	0	7	318 m <sup>2</sup>	0 m <sup>2</sup>	318 m <sup>2</sup>	0 m <sup>2</sup>	0 m
LEVEL 23	0	0	0	0	0	0 m <sup>2</sup>	0 m <sup>2</sup>	0 m <sup>2</sup>	208 m <sup>2</sup>	208 m
LEVEL 24	2	2	2	0	6	324 m <sup>2</sup>	0 m <sup>2</sup>	324 m <sup>2</sup>	0 m <sup>2</sup>	0 m
LEVEL 25	2	2	2	0	6	324 m <sup>2</sup>	0 m <sup>2</sup>	324 m²	0 m <sup>2</sup>	0 m
LEVEL 26	2	2	2	0	6	324 m <sup>2</sup>	0 m <sup>2</sup>	324 m²	0 m <sup>2</sup>	0 m
LEVEL 27	2	2	2	0	6	324 m²	0 m <sup>2</sup>		0 m <sup>2</sup>	0 m
LEVEL 28	2	2	2	0	6		0 m <sup>2</sup>		0 m <sup>2</sup>	0 m
LEVEL 29	2	2	2	0	6		0 m <sup>2</sup>		0 m <sup>2</sup>	0 m
LEVEL 30	2	2	2	0	6		0 m <sup>2</sup>		0 m <sup>2</sup>	0 m
LEVEL 31	2	2	2	0	6		0 m <sup>2</sup>		0 m <sup>2</sup>	0 m
LEVEL 32	2	2	2	0	6		0 m <sup>2</sup>		0 m <sup>2</sup>	0 m
LEVEL 32	2	2	2	0	6	324 m <sup>2</sup>	0 m <sup>2</sup>		0 m <sup>2</sup>	0 m
LEVEL 33	2	2	2	0	6		0 m <sup>2</sup>		0 m <sup>2</sup>	0 m
LEVEL 34 LEVEL 35	2	2	2	0	6		0 m <sup>2</sup>		0 m <sup>2</sup>	0 m
LEVEL 35 LEVEL 36	2	2	2	0	6		0 m <sup>2</sup>		0 m <sup>2</sup>	0 m
LEVEL 30 LEVEL 37	2	2	2	0	6		0 m <sup>2</sup>		0 m <sup>2</sup>	0 m
_EVEL 37 _EVEL 38			2		6					
	2	2		0			0 m <sup>2</sup>		0 m <sup>2</sup>	0 m
LEVEL 39	2		2	0	6		0 m <sup>2</sup>		0 m <sup>2</sup>	0 m
LEVEL 40	2	2	2	0	6		0 m <sup>2</sup>		0 m <sup>2</sup>	0 m
LEVEL 41	2	2	2	0	6		0 m <sup>2</sup>		0 m <sup>2</sup>	0 m
EVEL 42	2	2	2	0	6		0 m <sup>2</sup>		0 m <sup>2</sup>	0 m
_EVEL 43	2	2	2	0	6		0 m <sup>2</sup>		0 m <sup>2</sup>	0 m
LEVEL 44	0	0	0	0	0		0 m <sup>2</sup>		434 m <sup>2</sup>	0 m
LEVEL 45	0	0	0	0	0	0 m <sup>2</sup>	0 m <sup>2</sup>	0 m <sup>2</sup>	0 m <sup>2</sup>	0 m
_EVEL 46	0	0	0	0	0	0 m <sup>2</sup>	0 m <sup>2</sup>	0 m <sup>2</sup>	0 m <sup>2</sup>	0 m
TOTALS	115	79	63	3	260	13245 m <sup>2</sup>	1225 m <sup>2</sup>	14470 m <sup>2</sup>	2044 m <sup>2</sup>	788 m
	STUDIO	1 BED	2 BED	3 BED	TOTAL					

CAR PARKING SCHEDULE							
	CAR	SHARE	CARS	HARE			
LEVEL	STANDARD	ACCESSIBLE	STANDARD	ACCESSIBLE	TOTAL		
BASEMENT 2	0	1	8	0	9		
BASEMENT 1	0	0	0	0	0		
TOTALS	0	1	8	0	9		

MOTORCYCLE PARKING SCHEDULE								
LEVEL	RESIDENTIAL	COMMERCIAL	RETAIL	TOTAL				
BASEMENT 2	0	3	0	3				
BASEMENT 1	0	0	0	0				
TOTAL	0	0	0	0				

AREA SCHE	EDULE - GFA
LEVEL	GFA
BASEMENT 3	20 m <sup>2</sup>
GROUND	540 m <sup>2</sup>
LEVEL 1	736 m <sup>2</sup>
LEVEL 2	439 m <sup>2</sup>
LEVEL 3	594 m <sup>2</sup>
LEVEL 4	595 m <sup>2</sup>
LEVEL 5	595 m <sup>2</sup>
LEVEL 6	405 m <sup>2</sup>
LEVEL 7	389 m <sup>2</sup>
LEVEL 8	389 m <sup>2</sup>
LEVEL 9	389 m <sup>2</sup>
LEVEL 10	389 m <sup>2</sup>
LEVEL 11	389 m <sup>2</sup>
LEVEL 12	389 m <sup>2</sup>
LEVEL 13	389 m <sup>2</sup>
LEVEL 14	389 m <sup>2</sup>
LEVEL 15	389 m²
LEVEL 16	389 m <sup>2</sup>
LEVEL 17	389 m <sup>2</sup>
LEVEL 18	389 m <sup>2</sup>
LEVEL 19	389 m <sup>2</sup>
LEVEL 20	389 m <sup>2</sup>
LEVEL 21	389 m²
LEVEL 22	389 m²
LEVEL 23	65 m <sup>2</sup>
LEVEL 24	390 m <sup>2</sup>
LEVEL 25	390 m <sup>2</sup>
LEVEL 26	390 m <sup>2</sup>
LEVEL 27	390 m <sup>2</sup>
LEVEL 28	390 m²

CAR PARKS PROVIDED

MOTORCYCLE PARKING PROVIDED

AREA SCHE	DULE - GF
LEVEL	GFA
BASEMENT 3	20 r
GROUND	540 r
LEVEL 1	736 r
LEVEL 2	439 r
LEVEL 3	594 r
LEVEL 4	595 r
LEVEL 5	595 r
LEVEL 6	405 r
LEVEL 7	389 r
LEVEL 8	389 r
LEVEL 9	389 r
LEVEL 10	389 r
LEVEL 11	389 r
LEVEL 12	389 r
LEVEL 13	389 r
LEVEL 14	389 r
LEVEL 14	389 r
LEVEL 16	
	389 1
LEVEL 17	389 1
LEVEL 18	389 1
LEVEL 19	389 ו
LEVEL 20	289 r
LEVEL 21	389 ו
LEVEL 22	389 ו
LEVEL 23	65 ı
LEVEL 24	390 ו
LEVEL 25	390 ı
LEVEL 26	390 ו
LEVEL 27	390 ı
LEVEL 28	390 ı
LEVEL 29	390 ı
LEVEL 30	390 ı
LEVEL 31	390 ı
LEVEL 32	390 ו
LEVEL 33	390 ו
LEVEL 34	390 ı
LEVEL 35	390 ı
LEVEL 36	390 ı
LEVEL 37	390 ו
LEVEL 38	390 ו
LEVEL 39	390 r
LEVEL 40	390 r
LEVEL 41	390 ו
LEVEL 42	390 r
LEVEL 43	390 ו
LEVEL 44	428 r
TOTAL	4201

	ODA.
LEVEL BASEMENT 3	GBA
	1037 m <sup>2</sup>
BASEMENT 2	1037 m <sup>2</sup>
BASEMENT 1	1037 m <sup>2</sup>
GROUND	1042 m <sup>2</sup>
LEVEL 1	1017 m <sup>2</sup>
LEVEL 2	1001 m <sup>2</sup>
LEVEL 3	823 m <sup>2</sup>
LEVEL 4	823 m <sup>2</sup>
LEVEL 5	823 m <sup>2</sup>
LEVEL 6	552 m <sup>2</sup>
LEVEL 7	552 m <sup>2</sup>
LEVEL 8	552 m <sup>2</sup>
LEVEL 9	552 m <sup>2</sup>
LEVEL 10	552 m <sup>2</sup>
LEVEL 11	552 m <sup>2</sup>
LEVEL 12	552 m <sup>2</sup>
LEVEL 13	552 m <sup>2</sup>
LEVEL 14	552 m <sup>2</sup>
LEVEL 15	552 m <sup>2</sup>
LEVEL 16	552 m <sup>2</sup>
LEVEL 17	552 m <sup>2</sup>
LEVEL 17 LEVEL 18	552 m <sup>2</sup>
LEVEL 18 LEVEL 19	552 m <sup>2</sup>
LEVEL 19 LEVEL 20	
	552 m <sup>2</sup>
LEVEL 21	552 m <sup>2</sup>
LEVEL 22	552 m <sup>2</sup>
LEVEL 23	553 m <sup>2</sup>
LEVEL 24	552 m <sup>2</sup>
LEVEL 25	552 m <sup>2</sup>
LEVEL 26	552 m <sup>2</sup>
LEVEL 27	552 m <sup>2</sup>
LEVEL 28	552 m <sup>2</sup>
LEVEL 29	552 m <sup>2</sup>
LEVEL 30	552 m <sup>2</sup>
LEVEL 31	552 m <sup>2</sup>
LEVEL 32	552 m <sup>2</sup>
LEVEL 33	552 m <sup>2</sup>
LEVEL 34	552 m <sup>2</sup>
LEVEL 35	552 m <sup>2</sup>
LEVEL 36	552 m <sup>2</sup>
LEVEL 37	552 m <sup>2</sup>
LEVEL 38	552 m <sup>2</sup>
LEVEL 39	552 m <sup>2</sup>
LEVEL 39 LEVEL 40	552 m <sup>2</sup>
LEVEL 40	552 m <sup>2</sup>
LEVEL 41 LEVEL 42	
	552 m <sup>2</sup>
LEVEL 43	553 m <sup>2</sup>
LEVEL 44	553 m <sup>2</sup>
LEVEL 45	553 m <sup>2</sup>

30736 m<sup>2</sup>

- **09** ( 01 DDA CAR SPACE)

- 03

GFA RESIDENTIAL

GFA

GFA RETAIL

**GFA AMENITY** 

LEVEL

LEVEL BASEMENT 3

LEVEL 2

LEVEL 6 LEVEL 44

TOTAL

GROUND

LEVEL 1

TOTAL

16280 m<sup>2</sup>

374 m<sup>2</sup>

736 m<sup>2</sup> 1110 m<sup>2</sup>

20 m<sup>2</sup>

439 m<sup>2</sup> 160 m<sup>2</sup>

428 m<sup>2</sup>

1047 m<sup>2</sup>

GFA

GFA

# ADG COMPLIANCE

SOLAR - 2 HRS SUNLIGHT TO LIVING/PRIVATE OPEN SPACE

>2HR 216 UNITS 83% 0 HR 45 UNITS 17% **CROSS VENTILATION** 

COMPLIANT 26 UNITS 62% NOT COMPLIANT 16 UNITS 38%

	TOTAL				
EVEL	APARTMENTS	2 HR	2 HR %	0 HR	0 HR %
ASEMENT 3	0	0	0%	0	0%
ASEMENT 2	0	0	0%	0	0%
SEMENT 1	0	0	0%	0	0%
ROUND	0	0	0%	0	0%
VEL 1	0	0	0%	0	0%
VEL 2	0	0	0%	0	0%
VEL 3	8	5	2%	3	1%
VEL 4	8	5	2%	3	1%
VEL 5	8	5	2%	3	1%
VEL 6	4	4	2%	0	0%
	7	6		1	0%
VEL 7			2%		
VEL 8	7	6	2%	1	0%
VEL 9	7	6	2%	1	0%
VEL 10	7	6	2%	1	0%
VEL 11	7	6	2%	1	0%
VEL 12	7	6	2%	1	0%
VEL 13	7	6	2%	1	0%
VEL 14	7	6	2%	1	0%
VEL 15	7	6	2%	1	0%
VEL 16	7	6	2%	1	0%
VEL 17	7	6	2%	1	0%
VEL 18	7	6	2%	1	0%
VEL 19	7	6	2%	1	0%
VEL 20	7	6	2%	1	0%
VEL 21	7	6	2%	1	0%
VEL 22	7	6	2%	1	0%
VEL 23	0	0	0%	0	0%
VEL 24	6	5	2%	1	0%
VEL 25	6	5	2%	1	0%
VEL 26	6	5	2%	1	0%
VEL 27	6	5	2%	1	0%
VEL 28	6	5	2%	1	0%
VEL 20	6	5	2%	1	0%
VEL 29 VEL 30	6	5 5	2%	1	0%
VEL 31	6	5	2%	1	0%
VEL 32	6	5	2%	1	0%
VEL 33	6	5	2%	1	0%
VEL 34	6	5	2%	1	0%
VEL 35	6	5	2%	1	0%
VEL 36	6	5	2%	1	0%
VEL 37	6	5	2%	1	0%
VEL 38	6	5	2%	1	0%
VEL 39	6	5	2%	1	0%
VEL 40	6	5	2%	1	0%
VEL 41	6	5	2%	1	0%
VEL 42	6	5	2%	1	0%
VEL 43	6	5	2%	1	0%
VEL 44	0	0	0%	0	0%
VEL 45	0	0	0%	0	0%
VEL 46	0	0	0%	0	0%
OTALS	260	215	83%	45	17%

ADG COMPLIANCE - CROSS VENT					
LEVEL	TOTAL	CV COUNT			
GROUND	0	0			
LEVEL 1	0	0			
LEVEL 2	0	0			
LEVEL 3	8	6			
LEVEL 4	8	6			
LEVEL 5	8	6			
LEVEL 6	4	2			
LEVEL 7	7	3			
LEVEL 8	7	3			
TOTALS	42	26			

ADG COMPLIANCE - CROSS VENT % 62%

Autodesk Docs://23115 410-416 Victoria Avenue Chatswood/23115\_GENERAL\_R24.rvt

A SSDA LODGEMENT

18.03.25

**QUALITY ASSURANCE** (FK IS A CERTIFIED COMPANY TO ISO 9001-2015)

18437 m<sup>2</sup>

UNCONTROLLED COPY

IF THIS DRAWING IS STAMPED 'UNCONTROLLED COPY' THEN IT IS TO BE CONSIDERED A DRAFT, SUBJECT TO REVISION WITHOUT NOTICE NOT FOR CONSTRUCTION

**NOTES**THIS DRAWING IS COPYRIGHT AND SHALL REMAIN THE PROPERTY OF FENDER KATSALIDIS (AUST) PTY LTD CHECK AND VERIFY ALL DIMENSIONS ON SITE PRIOR TO COMMENCING WORK. DRAWING TO BE READ IN CONJUNCTION WITH ALL OTHER CONTRACT DOCUMENTS. DO NOT SCALE DRAWINGS. USE FIGURED DIMENSIONS ONLY. SEEK CLARIFICATION OF INCONSISTENCES / CONFLICTS.


410-416 VICTORIA AVE CHATSWOOD

NOVUS ON VICTORIA

FENDER KATSALIDIS
WWW.FKAUSTRALIA.COM L21, 259 GEORGE STREET, SYDNEY NEW SOUTH WALES 2000 AUSTRALIA TELEPHONE: +61 2 8216 3500 FENDER KATSALIDIS (AUST) PTY LTD ACN 092 943 032



DRAWING TITLE SCALE 18.03.25 DEVELOPMENT SUMMARY 23115 @A1

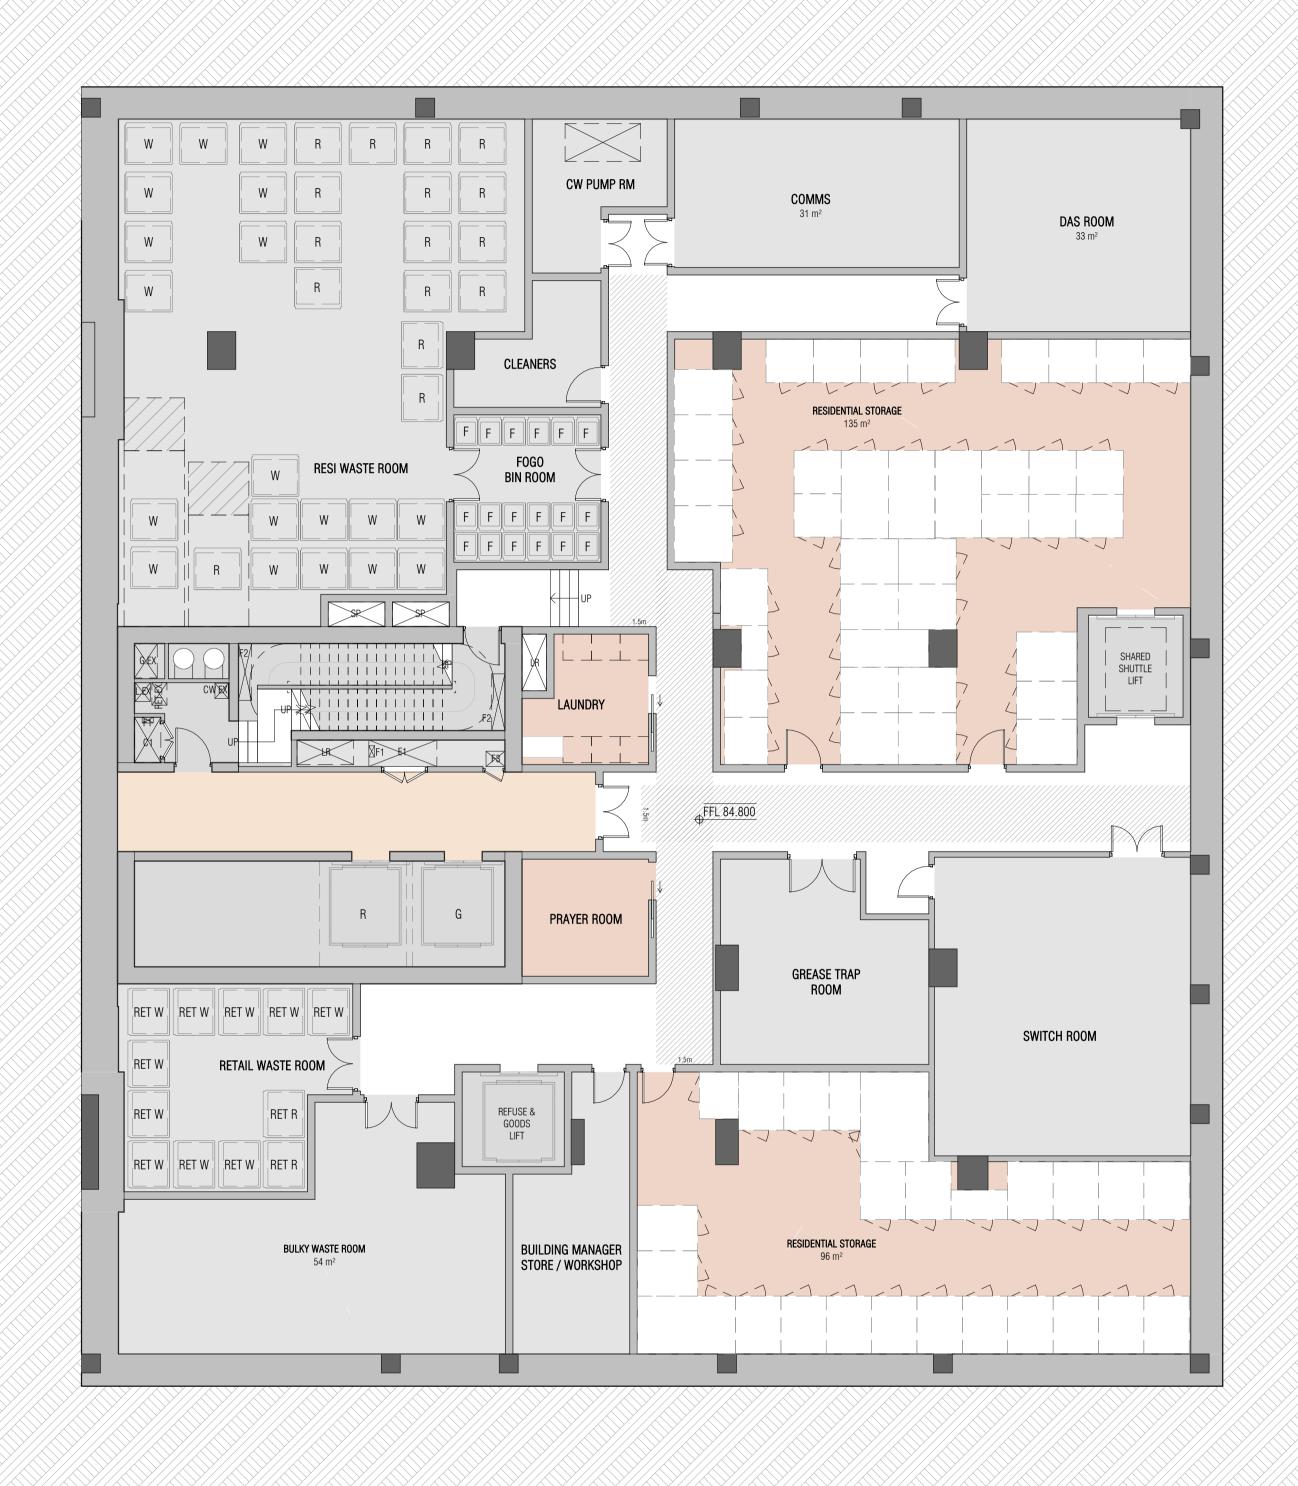

REVISION A SSDA LODGEMENT

18.03.25

**QUALITY ASSURANCE** (FK IS A CERTIFIED COMPANY TO ISO 9001-2015) THIS PROJECT IS SUBJECT TO THE FK QUALITY ASSURANCE SYSTEM UNCONTROLLED COPY IF THIS DRAWING IS STAMPED 'UNCONTROLLED COPY' THEN IT IS TO BE CONSIDERED A DRAFT, SUBJECT TO REVISION WITHOUT NOTICE NOT FOR CONSTRUCTION


NOTES
THIS DRAWING IS COPYRIGHT AND SHALL REMAIN THE PROPERTY OF FENDER KATSALIDIS (AUST) PTY LTD CHECK AND VERIFY ALL DIMENSIONS ON SITE PRIOR TO COMMENCING WORK. DRAWING TO BE READ IN CONJUNCTION WITH ALL OTHER CONTRACT DOCUMENTS. DO NOT SCALE DRAWINGS. USE FIGURED DIMENSIONS ONLY. SEEK CLARIFICATION OF INCONSISTENCES / CONFLICTS.








FENDER KATSALIDIS
WWW.FKAUSTRALIA.COM
L21, 259 GEORGE STREET, SYDNEY NEW SOUTH WALES 2000 AUSTRALIA TELEPHONE: +61 2 8216 3500 FENDER KATSALIDIS (AUST) PTY LTD ACN 092 943 032

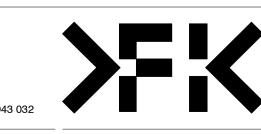

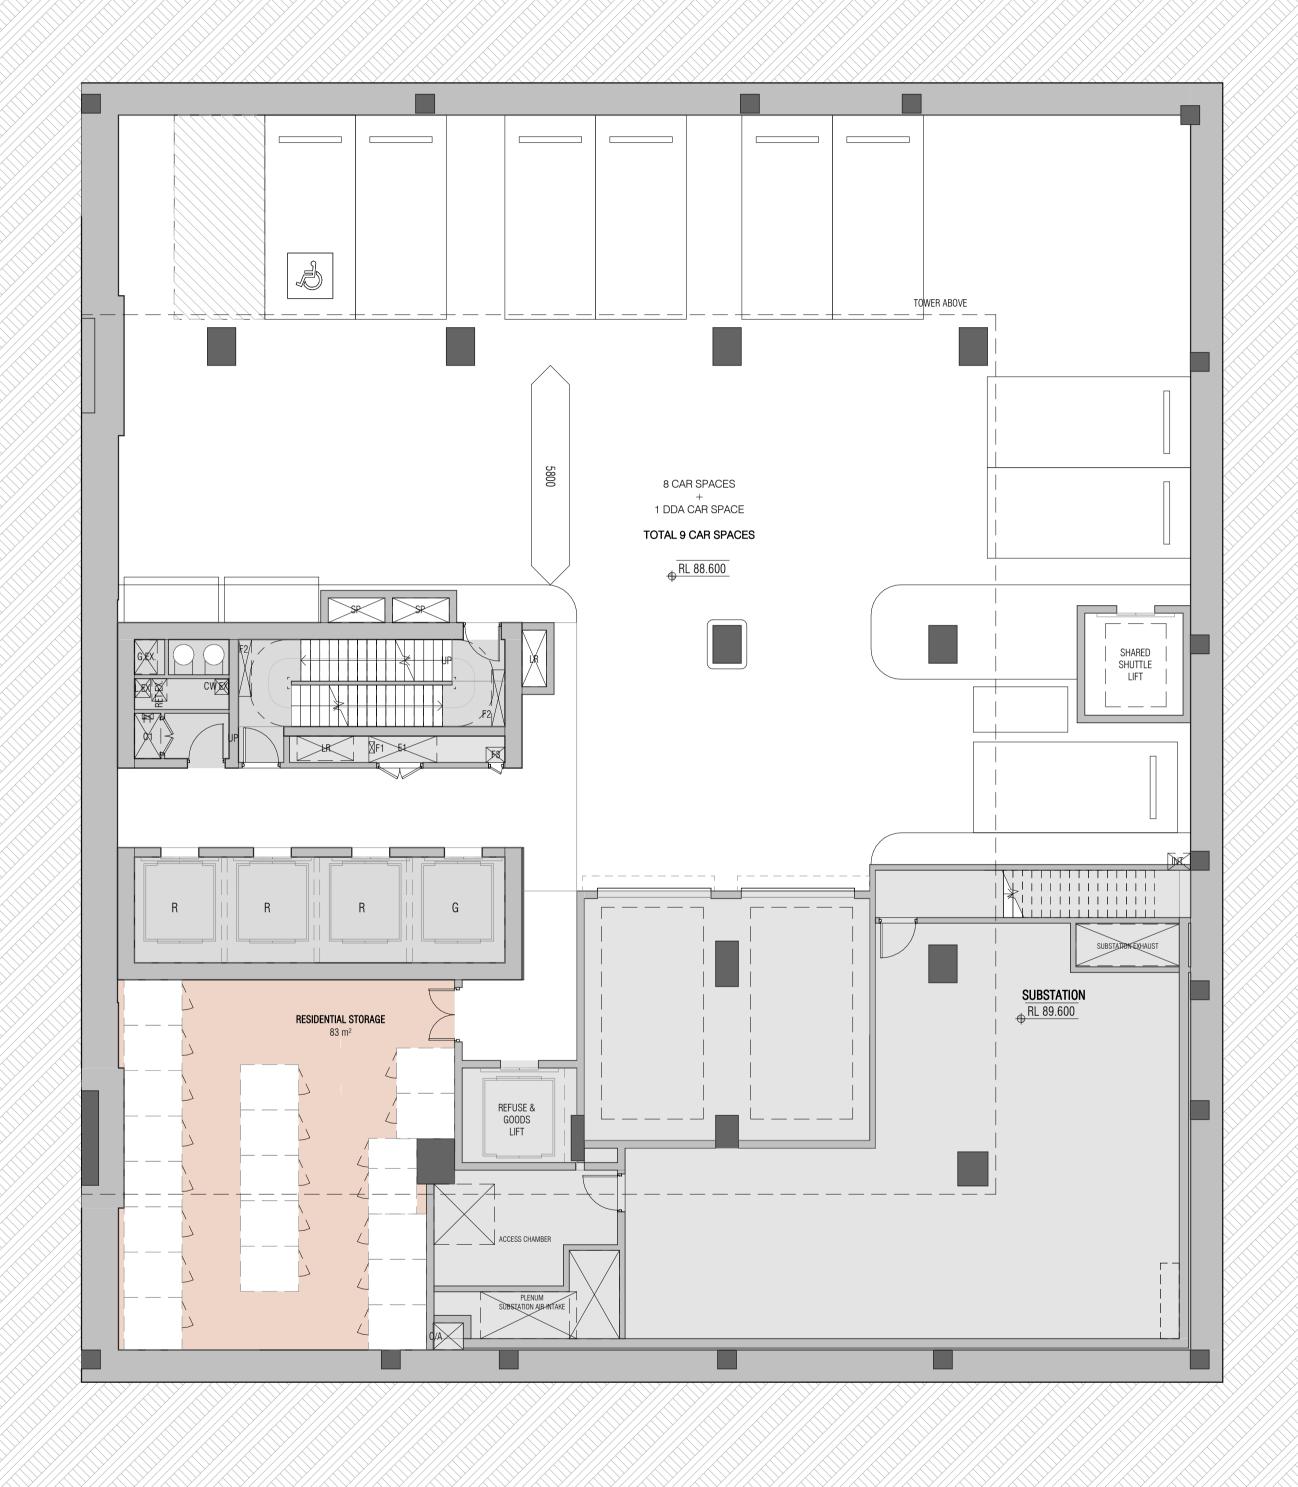

REVISION

A SSDA LODGEMENT

18.03.25


QUALITY ASSURANCE (FK IS A CERTIFIED COMPANY TO ISO 9001-2015)

THIS PROJECT IS SUBJECT TO THE FK QUALITY ASSURANCE SYSTEM

UNCONTROLLED COPY


IF THIS DRAWING IS STAMPED 'UNCONTROLLED COPY' THEN IT IS TO BE CONSIDERED A DRAFT, SUBJECT TO REVISION WITHOUT NOTICE

NOT FOR CONSTRUCTION

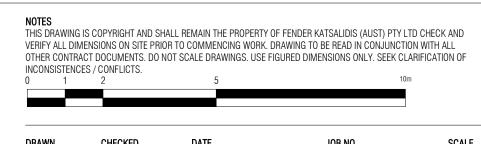

18.03.25

23115

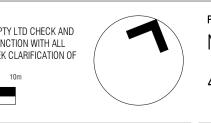

1:100@A1



BASEMENT 02 FLOOR PLAN



FENDER KATSALIDIS


WWW.FKAUSTRALIA.COM


L21, 259 GEORGE STREET, SYDNEY

NEW SOUTH WALES 2000 AUSTRALIA

TELEPHONE: +61 2 8216 3500

FENDER KATSALIDIS (AUST) PTY LTD ACN 092 943 032

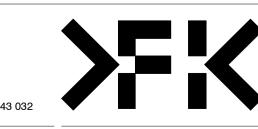

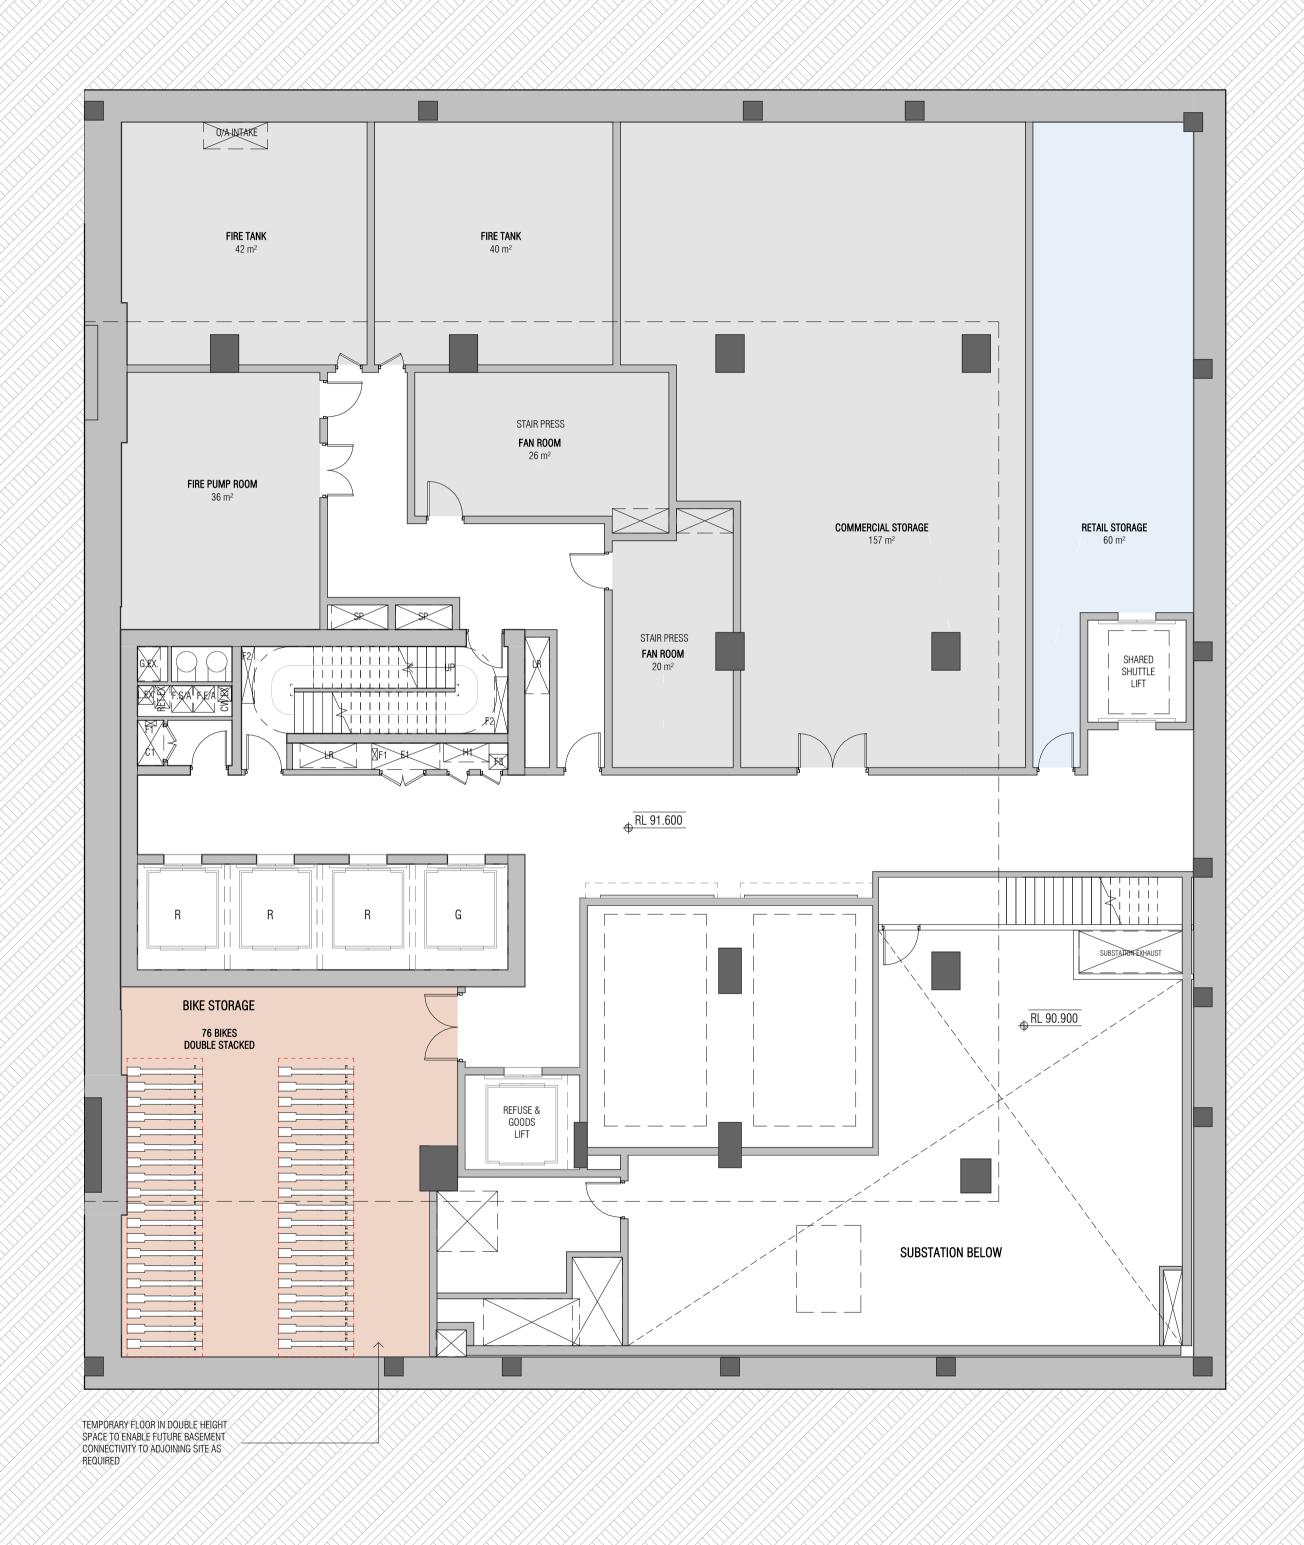


REVISION A SSDA LODGEMENT

18.03.25

**QUALITY ASSURANCE** (FK IS A CERTIFIED COMPANY TO ISO 9001-2015) THIS PROJECT IS SUBJECT TO THE FK QUALITY ASSURANCE SYSTEM UNCONTROLLED COPY IF THIS DRAWING IS STAMPED 'UNCONTROLLED COPY' THEN IT IS TO BE CONSIDERED A DRAFT, SUBJECT TO REVISION WITHOUT NOTICE NOT FOR CONSTRUCTION

NOTES
THIS DRAWING IS COPYRIGHT AND SHALL REMAIN THE PROPERTY OF FENDER KATSALIDIS (AUST) PTY LTD CHECK AND VERIFY ALL DIMENSIONS ON SITE PRIOR TO COMMENCING WORK. DRAWING TO BE READ IN CONJUNCTION WITH ALL OTHER CONTRACT DOCUMENTS, DO NOT SCALE DRAWINGS. USE FIGURED DIMENSIONS ONLY. SEEK CLARIFICATION OF INCONSISTENCES / CONFLICTS.

18.03.25

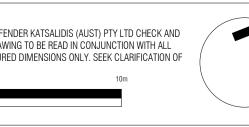


1:100@A1


23115



BASEMENT 01 FLOOR PLAN

FENDER KATSALIDIS
WWW.FKAUSTRALIA.COM
L21, 259 GEORGE STREET, SYDNEY
NEW SOUTH WALES 2000 AUSTRALIA TELEPHONE: +61 2 8216 3500 FENDER KATSALIDIS (AUST) PTY LTD ACN 092 943 032

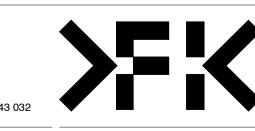

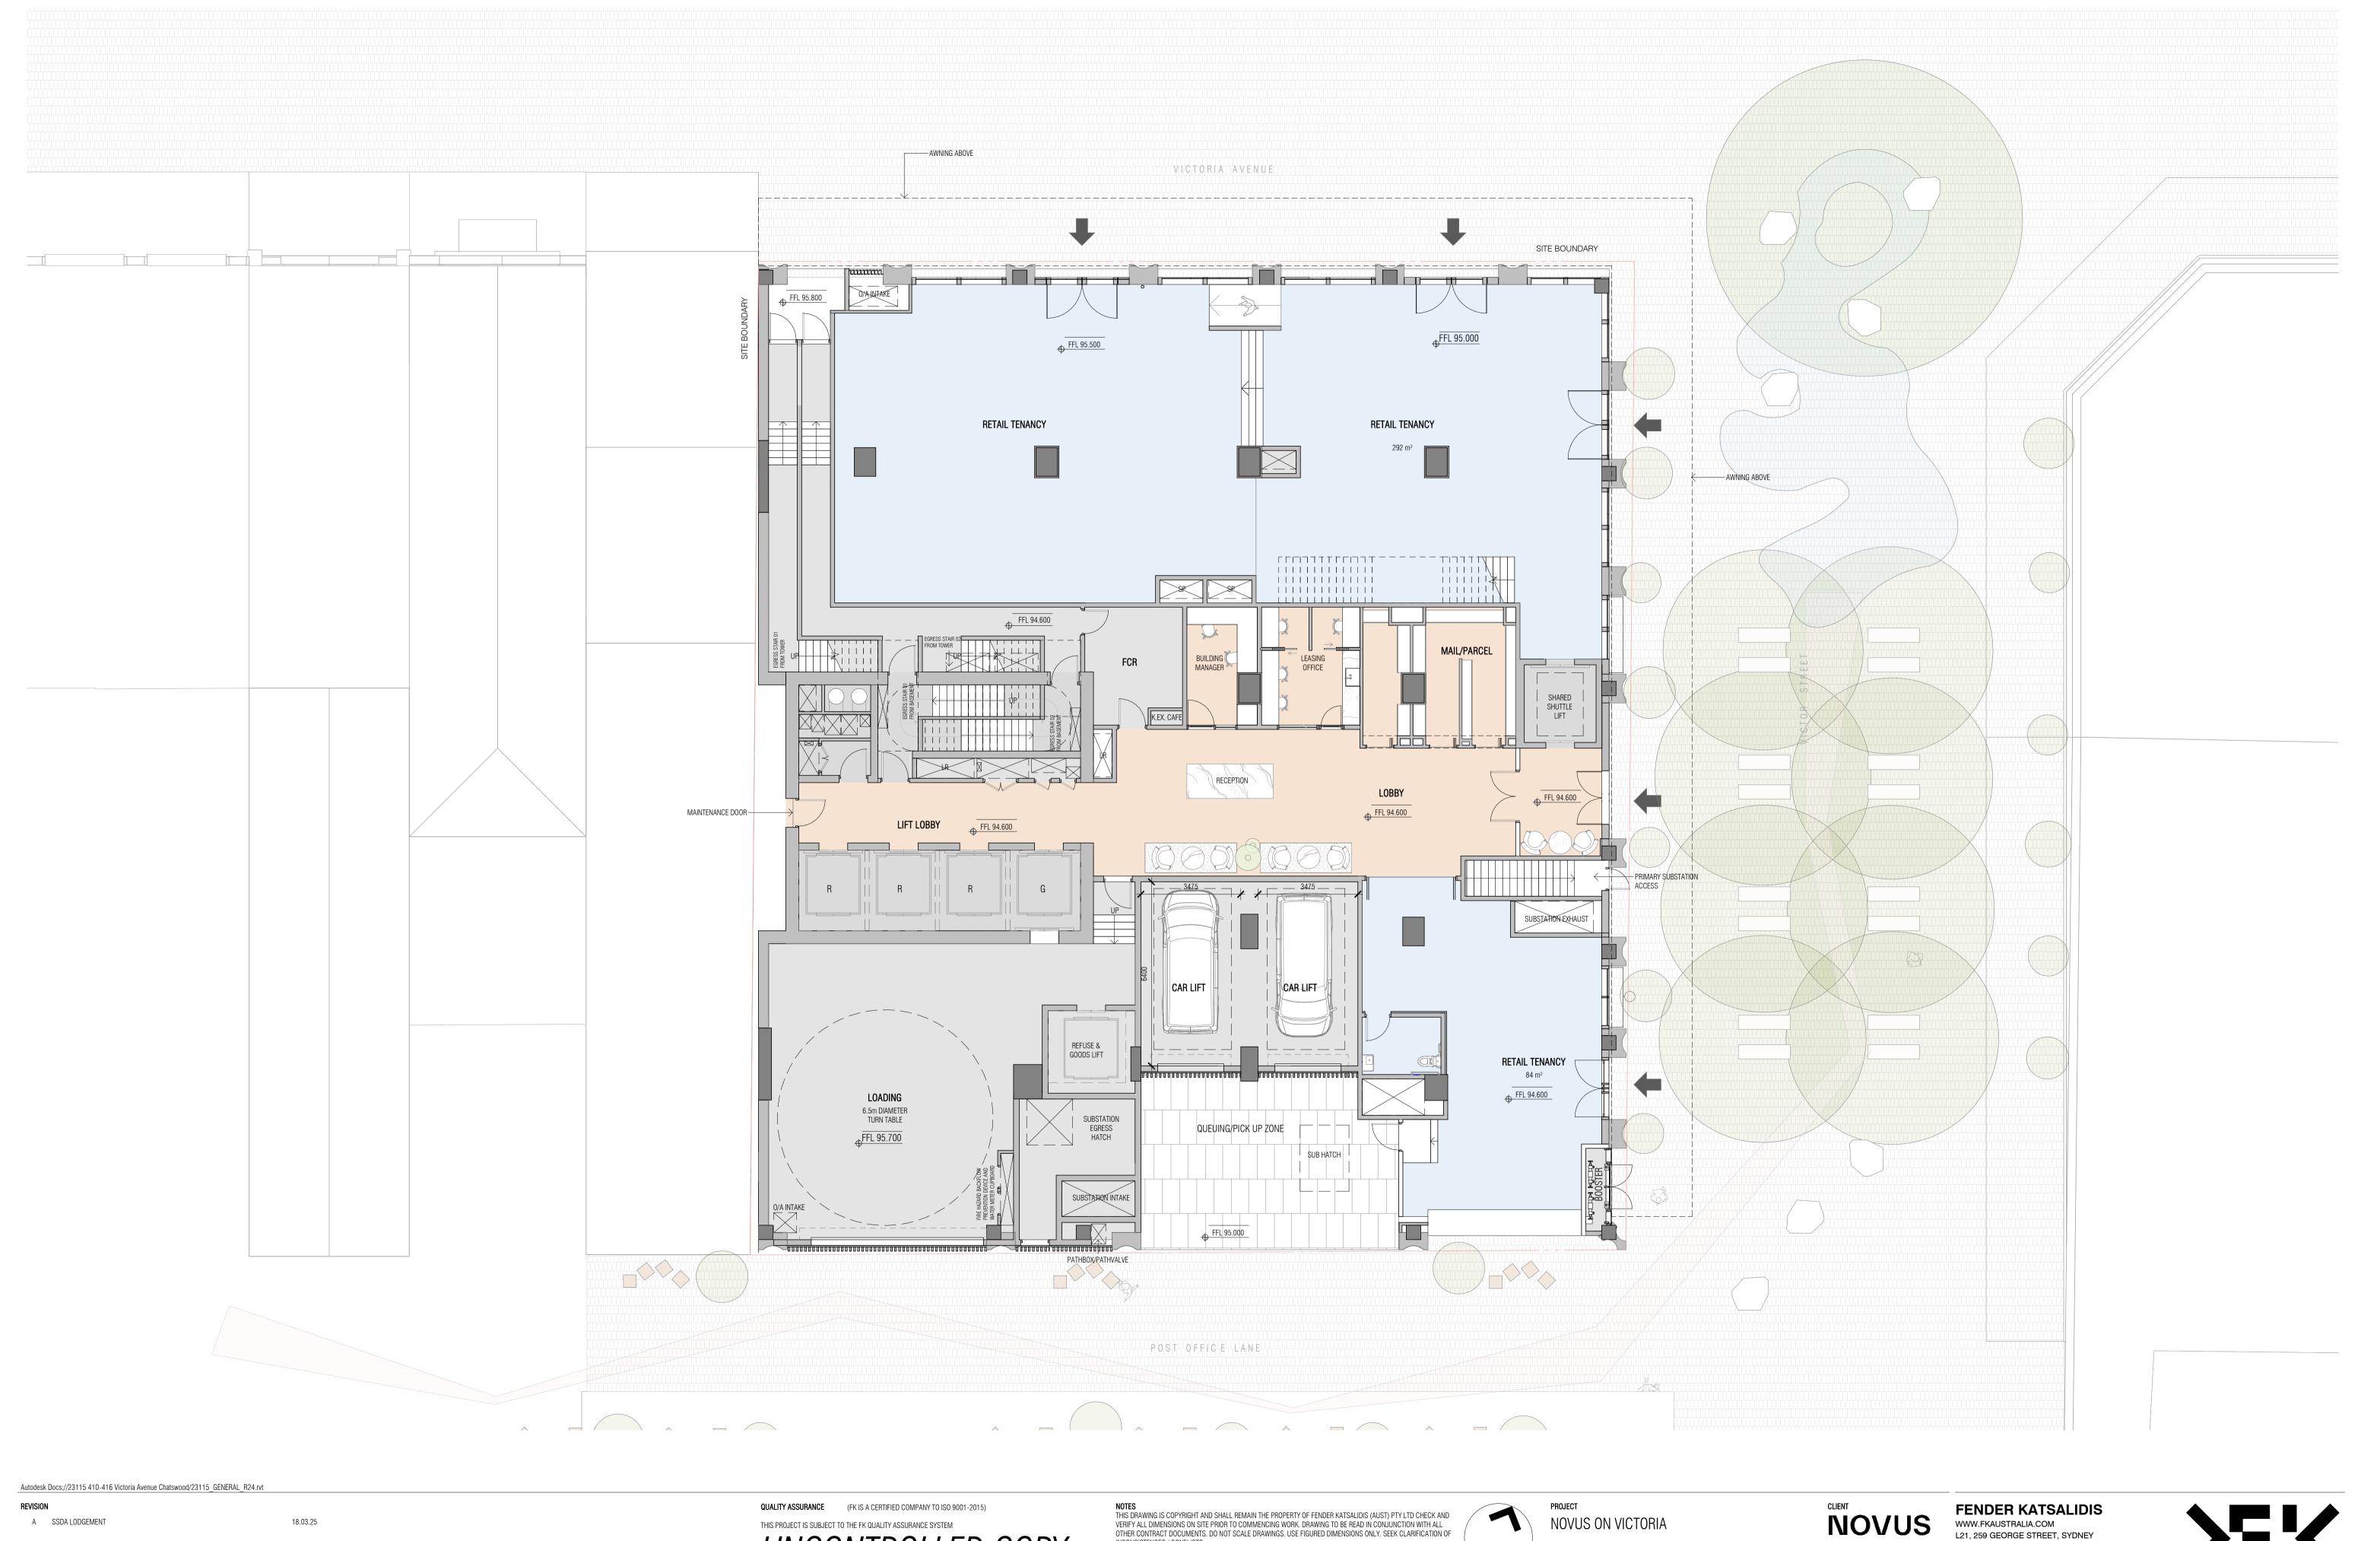

THIS PROJECT IS SUBJECT TO THE FK QUALITY ASSURANCE SYSTEM

UNCONTROLLED COPY

IF THIS DRAWING IS STAMPED 'UNCONTROLLED COPY' THEN IT IS TO BE CONSIDERED A DRAFT, SUBJECT TO REVISION WITHOUT NOTICE NOT FOR CONSTRUCTION

18.03.25

23115





1:100@A1

NOVUS ON VICTORIA 410-416 VICTORIA AVE CHATSWOOD

GROUND FLOOR PLAN

FENDER KATSALIDIS
WWW.FKAUSTRALIA.COM
L21, 259 GEORGE STREET, SYDNEY
NEW SOUTH WALES 2000 AUSTRALIA TELEPHONE: +61 2 8216 3500 FENDER KATSALIDIS (AUST) PTY LTD ACN 092 943 032

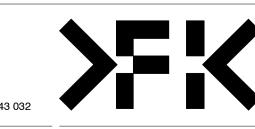

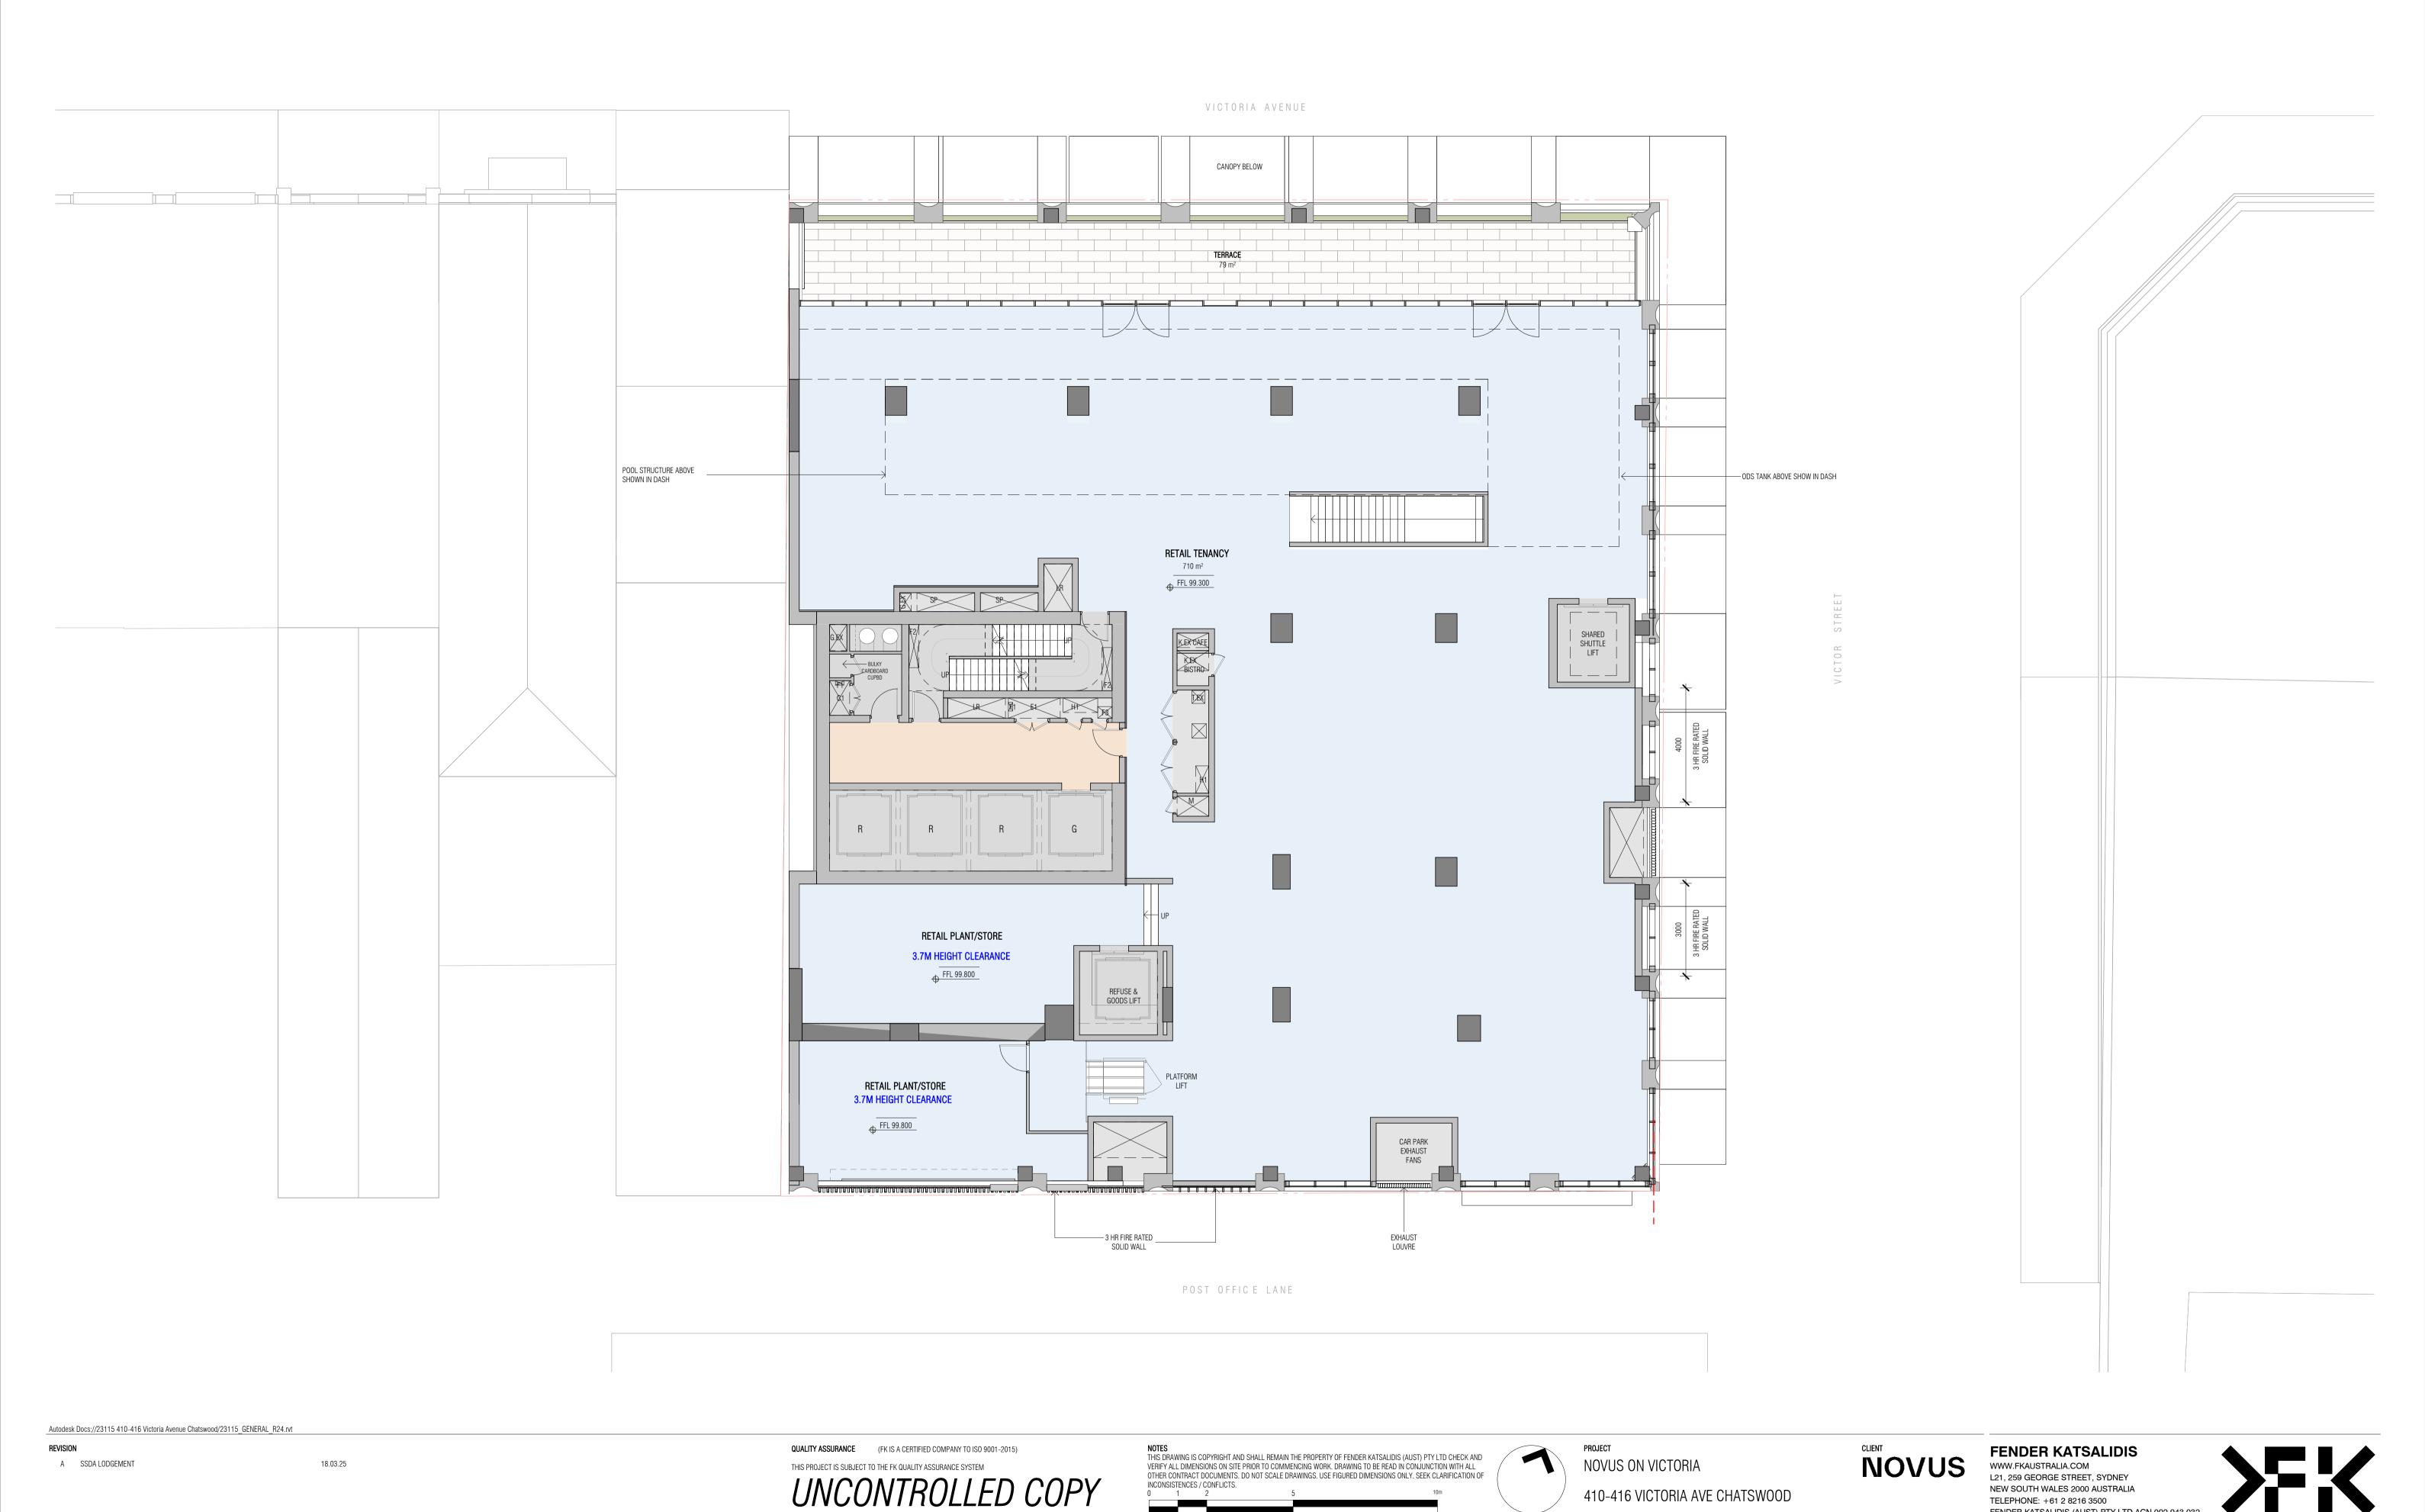

18.03.25

23115

1:100@A1


LEVEL 01 FLOOR PLAN

IF THIS DRAWING IS STAMPED 'UNCONTROLLED COPY' THEN IT IS TO BE CONSIDERED A DRAFT, SUBJECT TO REVISION WITHOUT NOTICE NOT FOR CONSTRUCTION

TELEPHONE: +61 2 8216 3500

ISSUE PURPOSE

FENDER KATSALIDIS (AUST) PTY LTD ACN 092 943 032

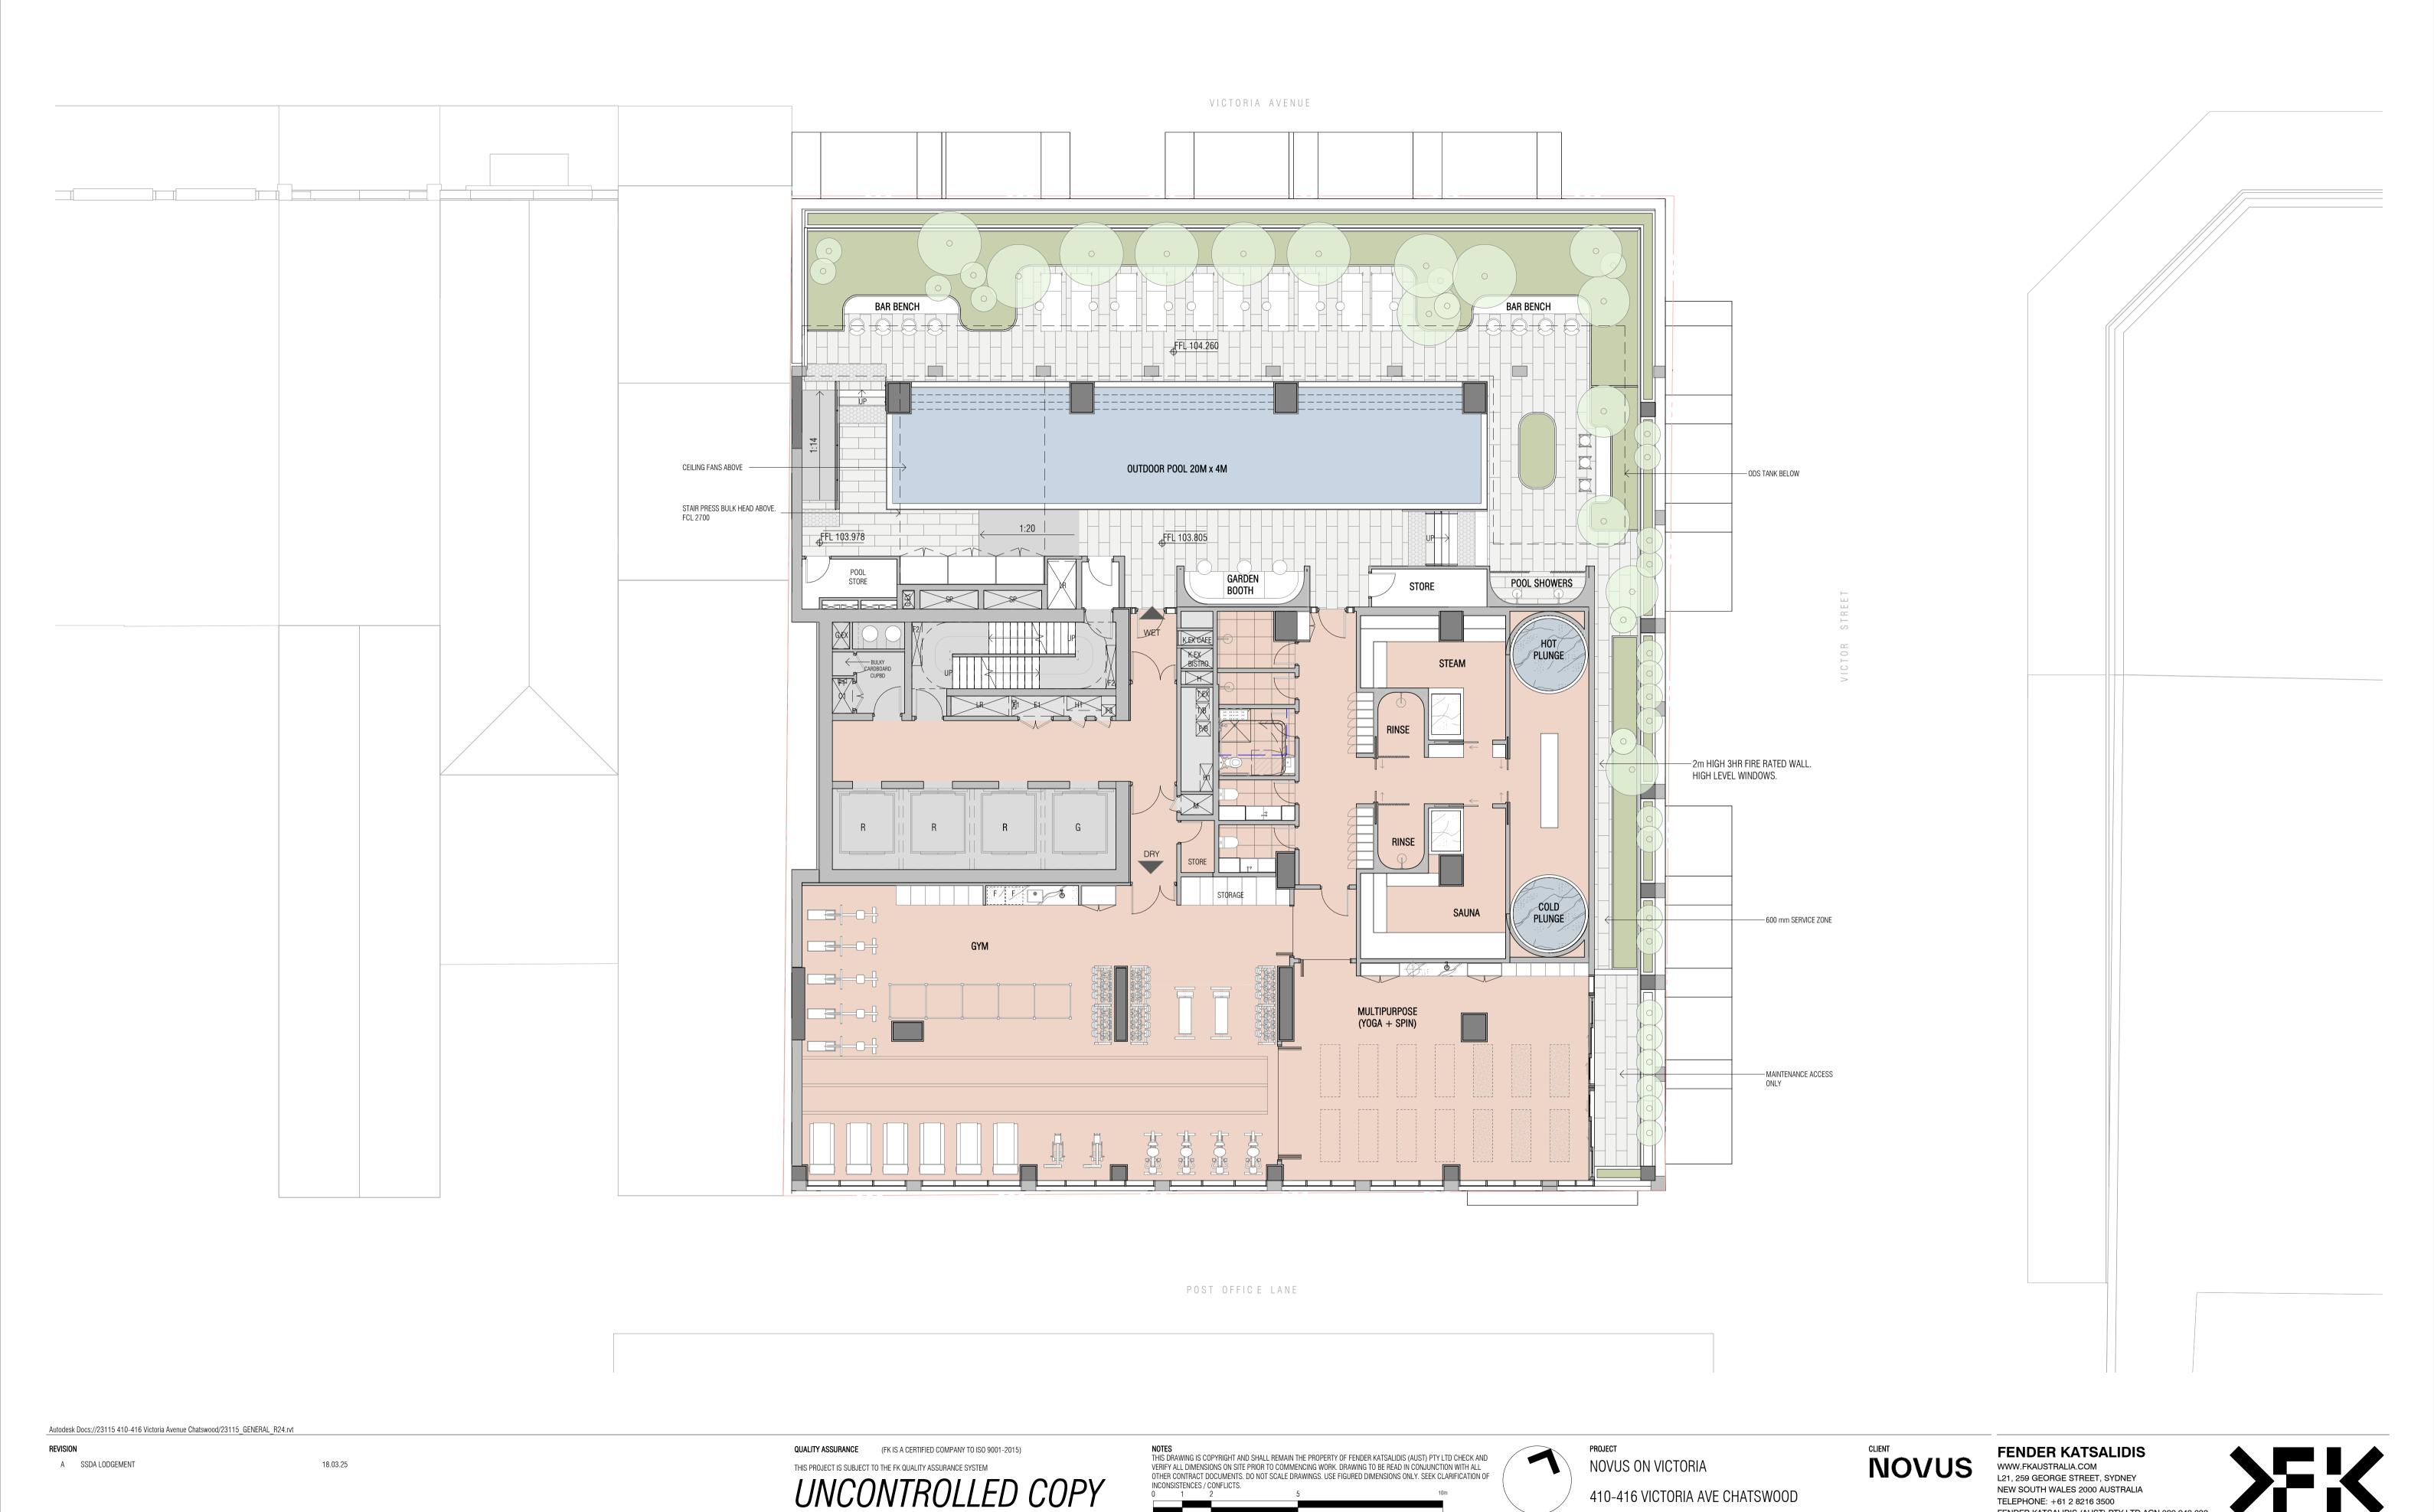

INCONSISTENCES / CONFLICTS.

BW/DS CB

18.03.25

23115

1:100@A1

IF THIS DRAWING IS STAMPED 'UNCONTROLLED COPY' THEN IT IS TO BE CONSIDERED A DRAFT, SUBJECT TO REVISION WITHOUT NOTICE NOT FOR CONSTRUCTION

TELEPHONE: +61 2 8216 3500

FENDER KATSALIDIS (AUST) PTY LTD ACN 092 943 032

410-416 VICTORIA AVE CHATSWOOD

LEVEL 02 FLOOR PLAN

A SSDA LODGEMENT

18.03.25

**QUALITY ASSURANCE** (FK IS A CERTIFIED COMPANY TO ISO 9001-2015) THIS PROJECT IS SUBJECT TO THE FK QUALITY ASSURANCE SYSTEM

UNCONTROLLED COPY

IF THIS DRAWING IS STAMPED 'UNCONTROLLED COPY' THEN IT IS TO BE CONSIDERED A DRAFT, SUBJECT TO REVISION WITHOUT NOTICE NOT FOR CONSTRUCTION

NOTES
THIS DRAWING IS COPYRIGHT AND SHALL REMAIN THE PROPERTY OF FENDER KATSALIDIS (AUST) PTY LTD CHECK AND VERIFY ALL DIMENSIONS ON SITE PRIOR TO COMMENCING WORK. DRAWING TO BE READ IN CONJUNCTION WITH ALL OTHER CONTRACT DOCUMENTS. DO NOT SCALE DRAWINGS. USE FIGURED DIMENSIONS ONLY. SEEK CLARIFICATION OF

18.03.25

23115


BW/DS CB

1:100@A1

NOVUS ON VICTORIA 410-416 VICTORIA AVE CHATSWOOD

LEVEL 03 - 04 FLOOR PLAN

FENDER KATSALIDIS
WWW.FKAUSTRALIA.COM
L21, 259 GEORGE STREET, SYDNEY
NEW SOUTH WALES 2000 AUSTRALIA TELEPHONE: +61 2 8216 3500 FENDER KATSALIDIS (AUST) PTY LTD ACN 092 943 032

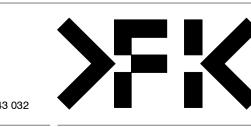

A SSDA LODGEMENT

18.03.25

**QUALITY ASSURANCE** (FK IS A CERTIFIED COMPANY TO ISO 9001-2015) THIS PROJECT IS SUBJECT TO THE FK QUALITY ASSURANCE SYSTEM

UNCONTROLLED COPY IF THIS DRAWING IS STAMPED 'UNCONTROLLED COPY' THEN IT IS TO BE CONSIDERED A DRAFT, SUBJECT TO REVISION WITHOUT NOTICE NOT FOR CONSTRUCTION NOTES
THIS DRAWING IS COPYRIGHT AND SHALL REMAIN THE PROPERTY OF FENDER KATSALIDIS (AUST) PTY LTD CHECK AND VERIFY ALL DIMENSIONS ON SITE PRIOR TO COMMENCING WORK. DRAWING TO BE READ IN CONJUNCTION WITH ALL OTHER CONTRACT DOCUMENTS. DO NOT SCALE DRAWINGS. USE FIGURED DIMENSIONS ONLY. SEEK CLARIFICATION OF

18.03.25

BW/DS CB




1:100@A1

23115



LEVEL 05 FLOOR PLAN

FENDER KATSALIDIS
WWW.FKAUSTRALIA.COM
L21, 259 GEORGE STREET, SYDNEY
NEW SOUTH WALES 2000 AUSTRALIA TELEPHONE: +61 2 8216 3500 FENDER KATSALIDIS (AUST) PTY LTD ACN 092 943 032

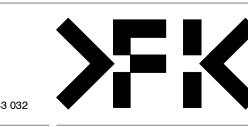




A SSDA LODGEMENT

18.03.25

**QUALITY ASSURANCE** (FK IS A CERTIFIED COMPANY TO ISO 9001-2015) THIS PROJECT IS SUBJECT TO THE FK QUALITY ASSURANCE SYSTEM


UNCONTROLLED COPY

NOTES
THIS DRAWING IS COPYRIGHT AND SHALL REMAIN THE PROPERTY OF FENDER KATSALIDIS (AUST) PTY LTD CHECK AND VERIFY ALL DIMENSIONS ON SITE PRIOR TO COMMENCING WORK. DRAWING TO BE READ IN CONJUNCTION WITH ALL OTHER CONTRACT DOCUMENTS, DO NOT SCALE DRAWINGS. USE FIGURED DIMENSIONS ONLY. SEEK CLARIFICATION OF INCONSISTENCES / CONFLICTS.

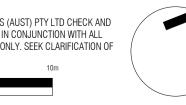



FENDER KATSALIDIS
WWW.FKAUSTRALIA.COM
L21, 259 GEORGE STREET, SYDNEY
NEW SOUTH WALES 2000 AUSTRALIA TELEPHONE: +61 2 8216 3500 FENDER KATSALIDIS (AUST) PTY LTD ACN 092 943 032

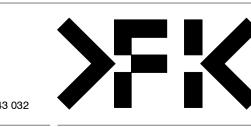



Autodesk Docs://23115 410-416 Victoria Avenue Chatswood/23115\_GENERAL\_R24.rvt

REVISION

A SSDA LODGEMENT

18.03.25

QUALITY ASSURANCE (FK IS A CERTIFIED COMPANY TO ISO 9001-2015)

THIS PROJECT IS SUBJECT TO THE FK QUALITY ASSURANCE SYSTEM

THIS PROJECT IS SUBJECT TO THE FK QUALITY ASSURANCE SYSTEM

UNCONTROLLED COPY

drawn checked BW/DS CB

NOTES
THIS DRAWING IS COPYRIGHT AND SHALL REMAIN THE PROPERTY OF FENDER KATSALIDIS (AUST) PTY LTD CHECK AND VERIFY ALL DIMENSIONS ON SITE PRIOR TO COMMENCING WORK. DRAWING TO BE READ IN CONJUNCTION WITH ALL OTHER CONTRACT DOCUMENTS. DO NOT SCALE DRAWINGS. USE FIGURED DIMENSIONS ONLY. SEEK CLARIFICATION OF INCONSISTENCES / CONFLICTS.

0 1 2 5 10m



NOVUS ON VICTORIA
410-416 VICTORIA AVE CHATSWOOD



FENDER KATSALIDIS


WWW.FKAUSTRALIA.COM

L21, 259 GEORGE STREET, SYDNEY

NEW SOUTH WALES 2000 AUSTRALIA


TELEPHONE: +61 2 8216 3500

FENDER KATSALIDIS (AUST) PTY LTD ACN 092 943 032

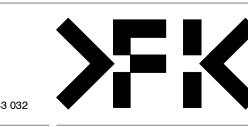

ISSUE PURPOSE

REV. DRAWING NO. A DA 10

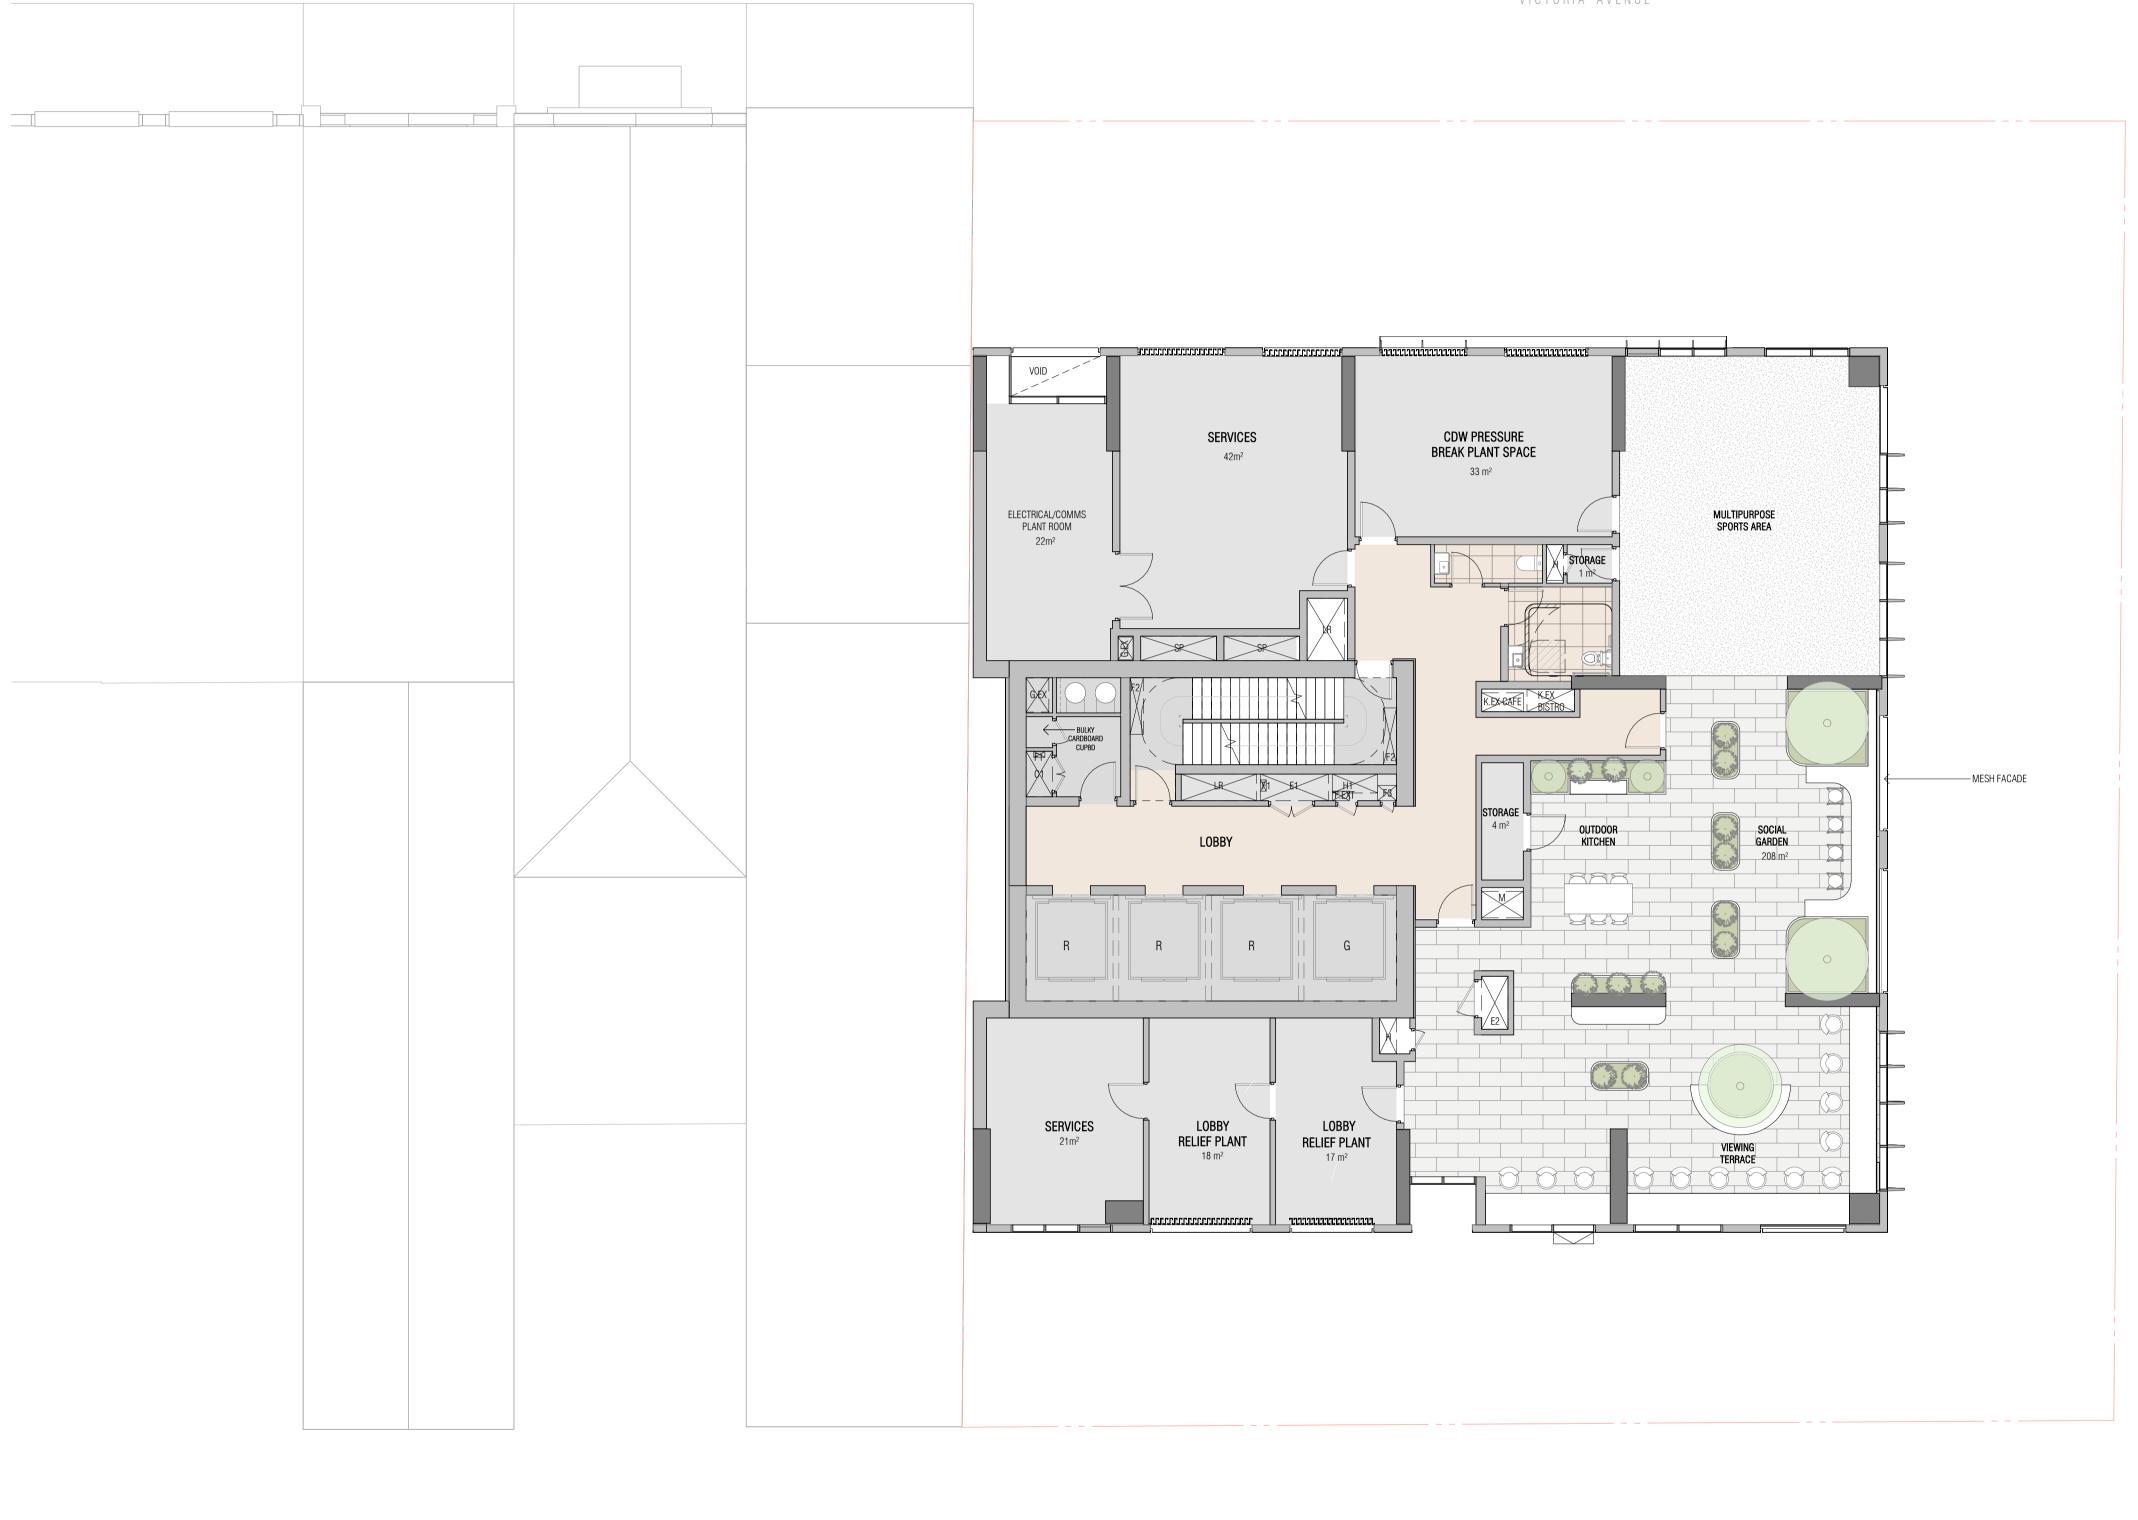

Autodesk Docs://23115 410-416 Victoria Avenue Chatswood/23115\_GENERAL\_R24.rvt

A SSDA LODGEMENT

18.03.25

**QUALITY ASSURANCE** (FK IS A CERTIFIED COMPANY TO ISO 9001-2015) THIS PROJECT IS SUBJECT TO THE FK QUALITY ASSURANCE SYSTEM

UNCONTROLLED COPY

IF THIS DRAWING IS STAMPED 'UNCONTROLLED COPY' THEN IT IS TO BE CONSIDERED A DRAFT, SUBJECT TO REVISION WITHOUT NOTICE NOT FOR CONSTRUCTION

NOTES
THIS DRAWING IS COPYRIGHT AND SHALL REMAIN THE PROPERTY OF FENDER KATSALIDIS (AUST) PTY LTD CHECK AND VERIFY ALL DIMENSIONS ON SITE PRIOR TO COMMENCING WORK. DRAWING TO BE READ IN CONJUNCTION WITH ALL OTHER CONTRACT DOCUMENTS. DO NOT SCALE DRAWINGS. USE FIGURED DIMENSIONS ONLY. SEEK CLARIFICATION OF

18.03.25

23115

1:100@A1

NOVUS ON VICTORIA 410-416 VICTORIA AVE CHATSWOOD

LEVEL 23 FLOOR PLAN (MID RISE PLANT)

FENDER KATSALIDIS
WWW.FKAUSTRALIA.COM
L21, 259 GEORGE STREET, SYDNEY
NEW SOUTH WALES 2000 AUSTRALIA TELEPHONE: +61 2 8216 3500 FENDER KATSALIDIS (AUST) PTY LTD ACN 092 943 032



Autodesk Docs://23115 410-416 Victoria Avenue Chatswood/23115\_GENERAL\_R24.rvt

REVISION

A SSDA LODGEMENT

18.03.25

QUALITY ASSURANCE (FK IS A CERTIFIED COMPANY TO ISO 9001-2015)

THIS PROJECT IS SUBJECT TO THE FK QUALITY ASSURANCE SYSTEM

UNCONTROLLED COPY

IF THIS DRAWING IS STAMPED 'UNCONTROLLED COPY' THEN IT IS TO BE CONSIDERED A DRAFT, SUBJECT TO REVISION WITHOUT NOTICE NOT FOR CONSTRUCTION

DRAWN CHECKED
BW/DS CB

DATE JOB NO.
18.03.25 23115

NOTES
THIS DRAWING IS COPYRIGHT AND SHALL REMAIN THE PROPERTY OF FENDER KATSALIDIS (AUST) PTY LTD CHECK AND VERIFY ALL DIMENSIONS ON SITE PRIOR TO COMMENCING WORK. DRAWING TO BE READ IN CONJUNCTION WITH ALL OTHER CONTRACT DOCUMENTS, DO NOT SCALE DRAWINGS. USE FIGURED DIMENSIONS ONLY. SEEK CLARIFICATION OF

scale 1:100@A1 NOVUS ON VICTORIA 410-416 VICTORIA AVE CHATSWOOD

LEVEL 24-43 FLOOR PLAN

NOVUS

FENDER KATSALIDIS

WWW.FKAUSTRALIA.COM

L21, 259 GEORGE STREET, SYDNEY

NEW SOUTH WALES 2000 AUSTRALIA


TELEPHONE: +61 2 8216 3500

FENDER KATSALIDIS (AUST) PTY LTD ACN 092 943 032

3 032

ISSUE PURPOSE

REV. DRAWING NO. DA 13

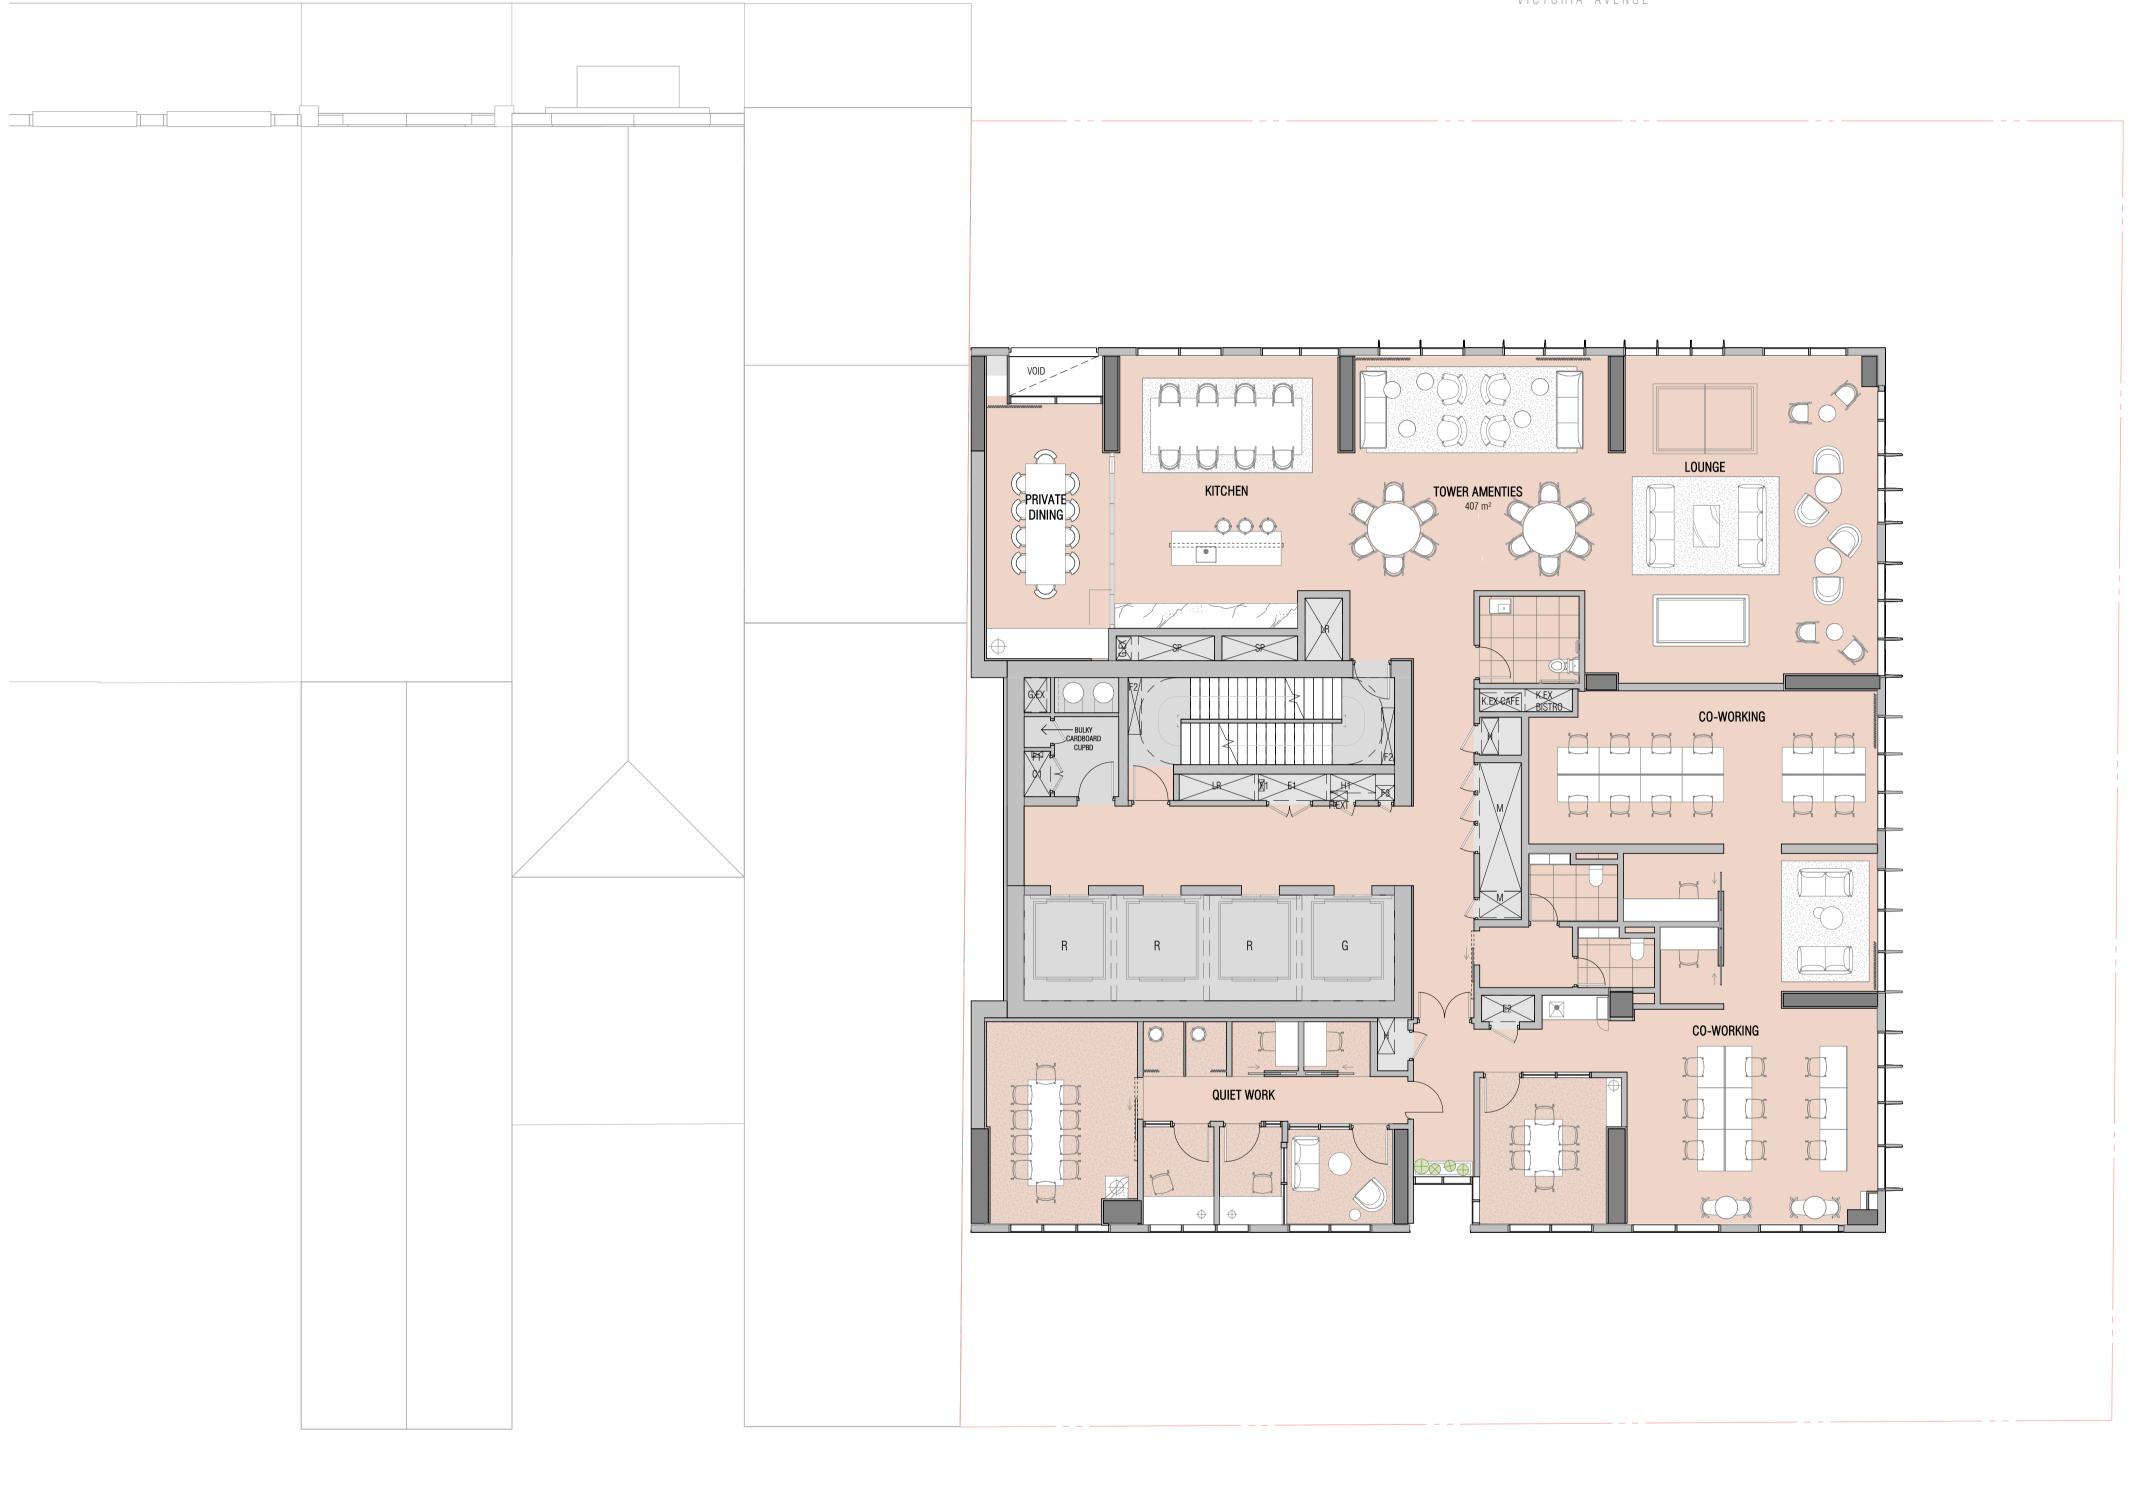

Autodesk Docs://23115 410-416 Victoria Avenue Chatswood/23115\_GENERAL\_R24.rvt

A SSDA LODGEMENT

18.03.25

**QUALITY ASSURANCE** (FK IS A CERTIFIED COMPANY TO ISO 9001-2015) THIS PROJECT IS SUBJECT TO THE FK QUALITY ASSURANCE SYSTEM

UNCONTROLLED COPY

BW/DS CB

NOTES
THIS DRAWING IS COPYRIGHT AND SHALL REMAIN THE PROPERTY OF FENDER KATSALIDIS (AUST) PTY LTD CHECK AND VERIFY ALL DIMENSIONS ON SITE PRIOR TO COMMENCING WORK. DRAWING TO BE READ IN CONJUNCTION WITH ALL OTHER CONTRACT DOCUMENTS. DO NOT SCALE DRAWINGS. USE FIGURED DIMENSIONS ONLY. SEEK CLARIFICATION OF INCONSISTENCES / CONFLICTS.

23115

18.03.25




1:100@A1

NOVUS ON VICTORIA 410-416 VICTORIA AVE CHATSWOOD

LEVEL 44 FLOOR PLAN



FENDER KATSALIDIS
WWW.FKAUSTRALIA.COM
L21, 259 GEORGE STREET, SYDNEY
NEW SOUTH WALES 2000 AUSTRALIA TELEPHONE: +61 2 8216 3500 FENDER KATSALIDIS (AUST) PTY LTD ACN 092 943 032

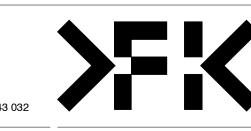

OR STREET

POST OFFICE LANE

Autodesk Docs://23115 410-416 Victoria Avenue Chatswood/23115\_GENERAL\_R24.rvt

REVISION

A SSDA LODGEMENT

18.03.25

QUALITY ASSURANCE (FK IS A CERTIFIED COMPANY TO ISO 9001-2015)

THIS PROJECT IS SUBJECT TO THE FK QUALITY ASSURANCE SYSTEM

UNCONTROLLED COPY

IF THIS DRAWING IS STAMPED 'UNCONTROLLED COPY' THEN IT IS TO BE CONSIDERED A DRAFT, SUBJECT TO REVISION WITHOUT NOTICE


NOT FOR CONSTRUCTION

NOTES
THIS DRAWING IS COPYRIGHT AND SHALL REMAIN THE PROPERTY OF FENDER KATSALIDIS (AUST) PTY LTD CHECK AND VERIFY ALL DIMENSIONS ON SITE PRIOR TO COMMENCING WORK. DRAWING TO BE READ IN CONJUNCTION WITH ALL OTHER CONTRACT DOCUMENTS. DO NOT SCALE DRAWINGS. USE FIGURED DIMENSIONS ONLY. SEEK CLARIFICATION OF INCONSISTENCES / CONFLICTS.

0 1 2 5 10m

23115

18.03.25

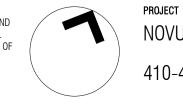

1:100@A1

NOVUS ON VICTORIA
410-416 VICTORIA AVE CHATSWOOD

LEVEL 45 FLOOR PLAN (PLANT)



FENDER KATSALIDIS


WWW.FKAUSTRALIA.COM

L21, 259 GEORGE STREET, SYDNEY

NEW SOUTH WALES 2000 AUSTRALIA

TELEPHONE: +61 2 8216 3500

FENDER KATSALIDIS (AUST) PTY LTD ACN 092 943 032

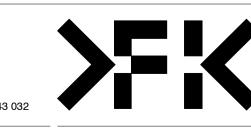

ISSUE PURPOSE

REV. DRAWING NO. A DA 14

Autodesk Docs://23115 410-416 Victoria Avenue Chatswood/23115\_GENERAL\_R24.rvt

A SSDA LODGEMENT

18.03.25

QUALITY ASSURANCE (FK IS A CERTIFIED COMPANY TO ISO 9001-2015)

UNCONTROLLED COPY

NOTES
THIS DRAWING IS COPYRIGHT AND SHALL REMAIN THE PROPERTY OF FENDER KATSALIDIS (AUST) PTY LTD CHECK AND VERIFY ALL DIMENSIONS ON SITE PRIOR TO COMMENCING WORK. DRAWING TO BE READ IN CONJUNCTION WITH ALL OTHER CONTRACT DOCUMENTS. DO NOT SCALE DRAWINGS. USE FIGURED DIMENSIONS ONLY. SEEK CLARIFICATION OF IF THIS DRAWING IS STAMPED 'UNCONTROLLED COPY' THEN IT IS TO BE CONSIDERED A DRAFT, SUBJECT TO REVISION WITHOUT NOTICE NOT FOR CONSTRUCTION

18.03.25


1:100@A1

23115

NOVUS ON VICTORIA 410-416 VICTORIA AVE CHATSWOOD

LEVEL 46 FLOOR PLAN (ROOF PLANT)

FENDER KATSALIDIS
WWW.FKAUSTRALIA.COM
L21, 259 GEORGE STREET, SYDNEY
NEW SOUTH WALES 2000 AUSTRALIA TELEPHONE: +61 2 8216 3500 FENDER KATSALIDIS (AUST) PTY LTD ACN 092 943 032

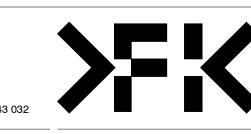

REVISION

A SSDA LODGEMENT

18.03.25

QUALITY ASSURANCE (FK IS A CERTIFIED COMPANY TO ISO 9001-2015)

THIS PROJECT IS SUBJECT TO THE FK QUALITY ASSURANCE SYSTEM

THIS PROJECT IS SUBJECT TO THE FK QUALITY ASSURANCE SYSTEM

UNCONTROLLED COPY


IF THIS DRAWING IS STAMPED 'UNCONTROLLED COPY' THEN IT IS TO BE CONSIDERED A DRAWN CHECKE DRAFT, SUBJECT TO REVISION WITHOUT NOTICE BW/DS CB

NOTES
THIS DRAWING IS COPYRIGHT AND SHALL REMAIN THE PROPERTY OF FENDER KATSALIDIS (AUST) PTY LTD CHECK AND VERIFY ALL DIMENSIONS ON SITE PRIOR TO COMMENCING WORK. DRAWING TO BE READ IN CONJUNCTION WITH ALL OTHER CONTRACT DOCUMENTS. DO NOT SCALE DRAWINGS. USE FIGURED DIMENSIONS ONLY. SEEK CLARIFICATION OF INCONSISTENCES / CONFLICTS.

O 1 2 5 10m

23115

18.03.25

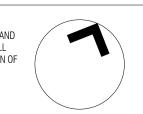

1:100@A1

NOVUS ON VICTORIA
410-416 VICTORIA AVE CHATSWOOD

DRAWING TITLE

ROOF PLAN

NOVUS

FENDER KATSALIDIS


WWW.FKAUSTRALIA.COM

L21, 259 GEORGE STREET, SYDNEY

NEW SOUTH WALES 2000 AUSTRALIA


TELEPHONE: +61 2 8216 3500


FENDER KATSALIDIS (AUST) PTY LTD ACN 092 943 032

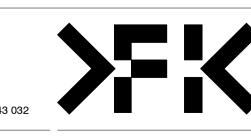


ISSUE PURPOSE

REV. DRAWING NO. A DA 14

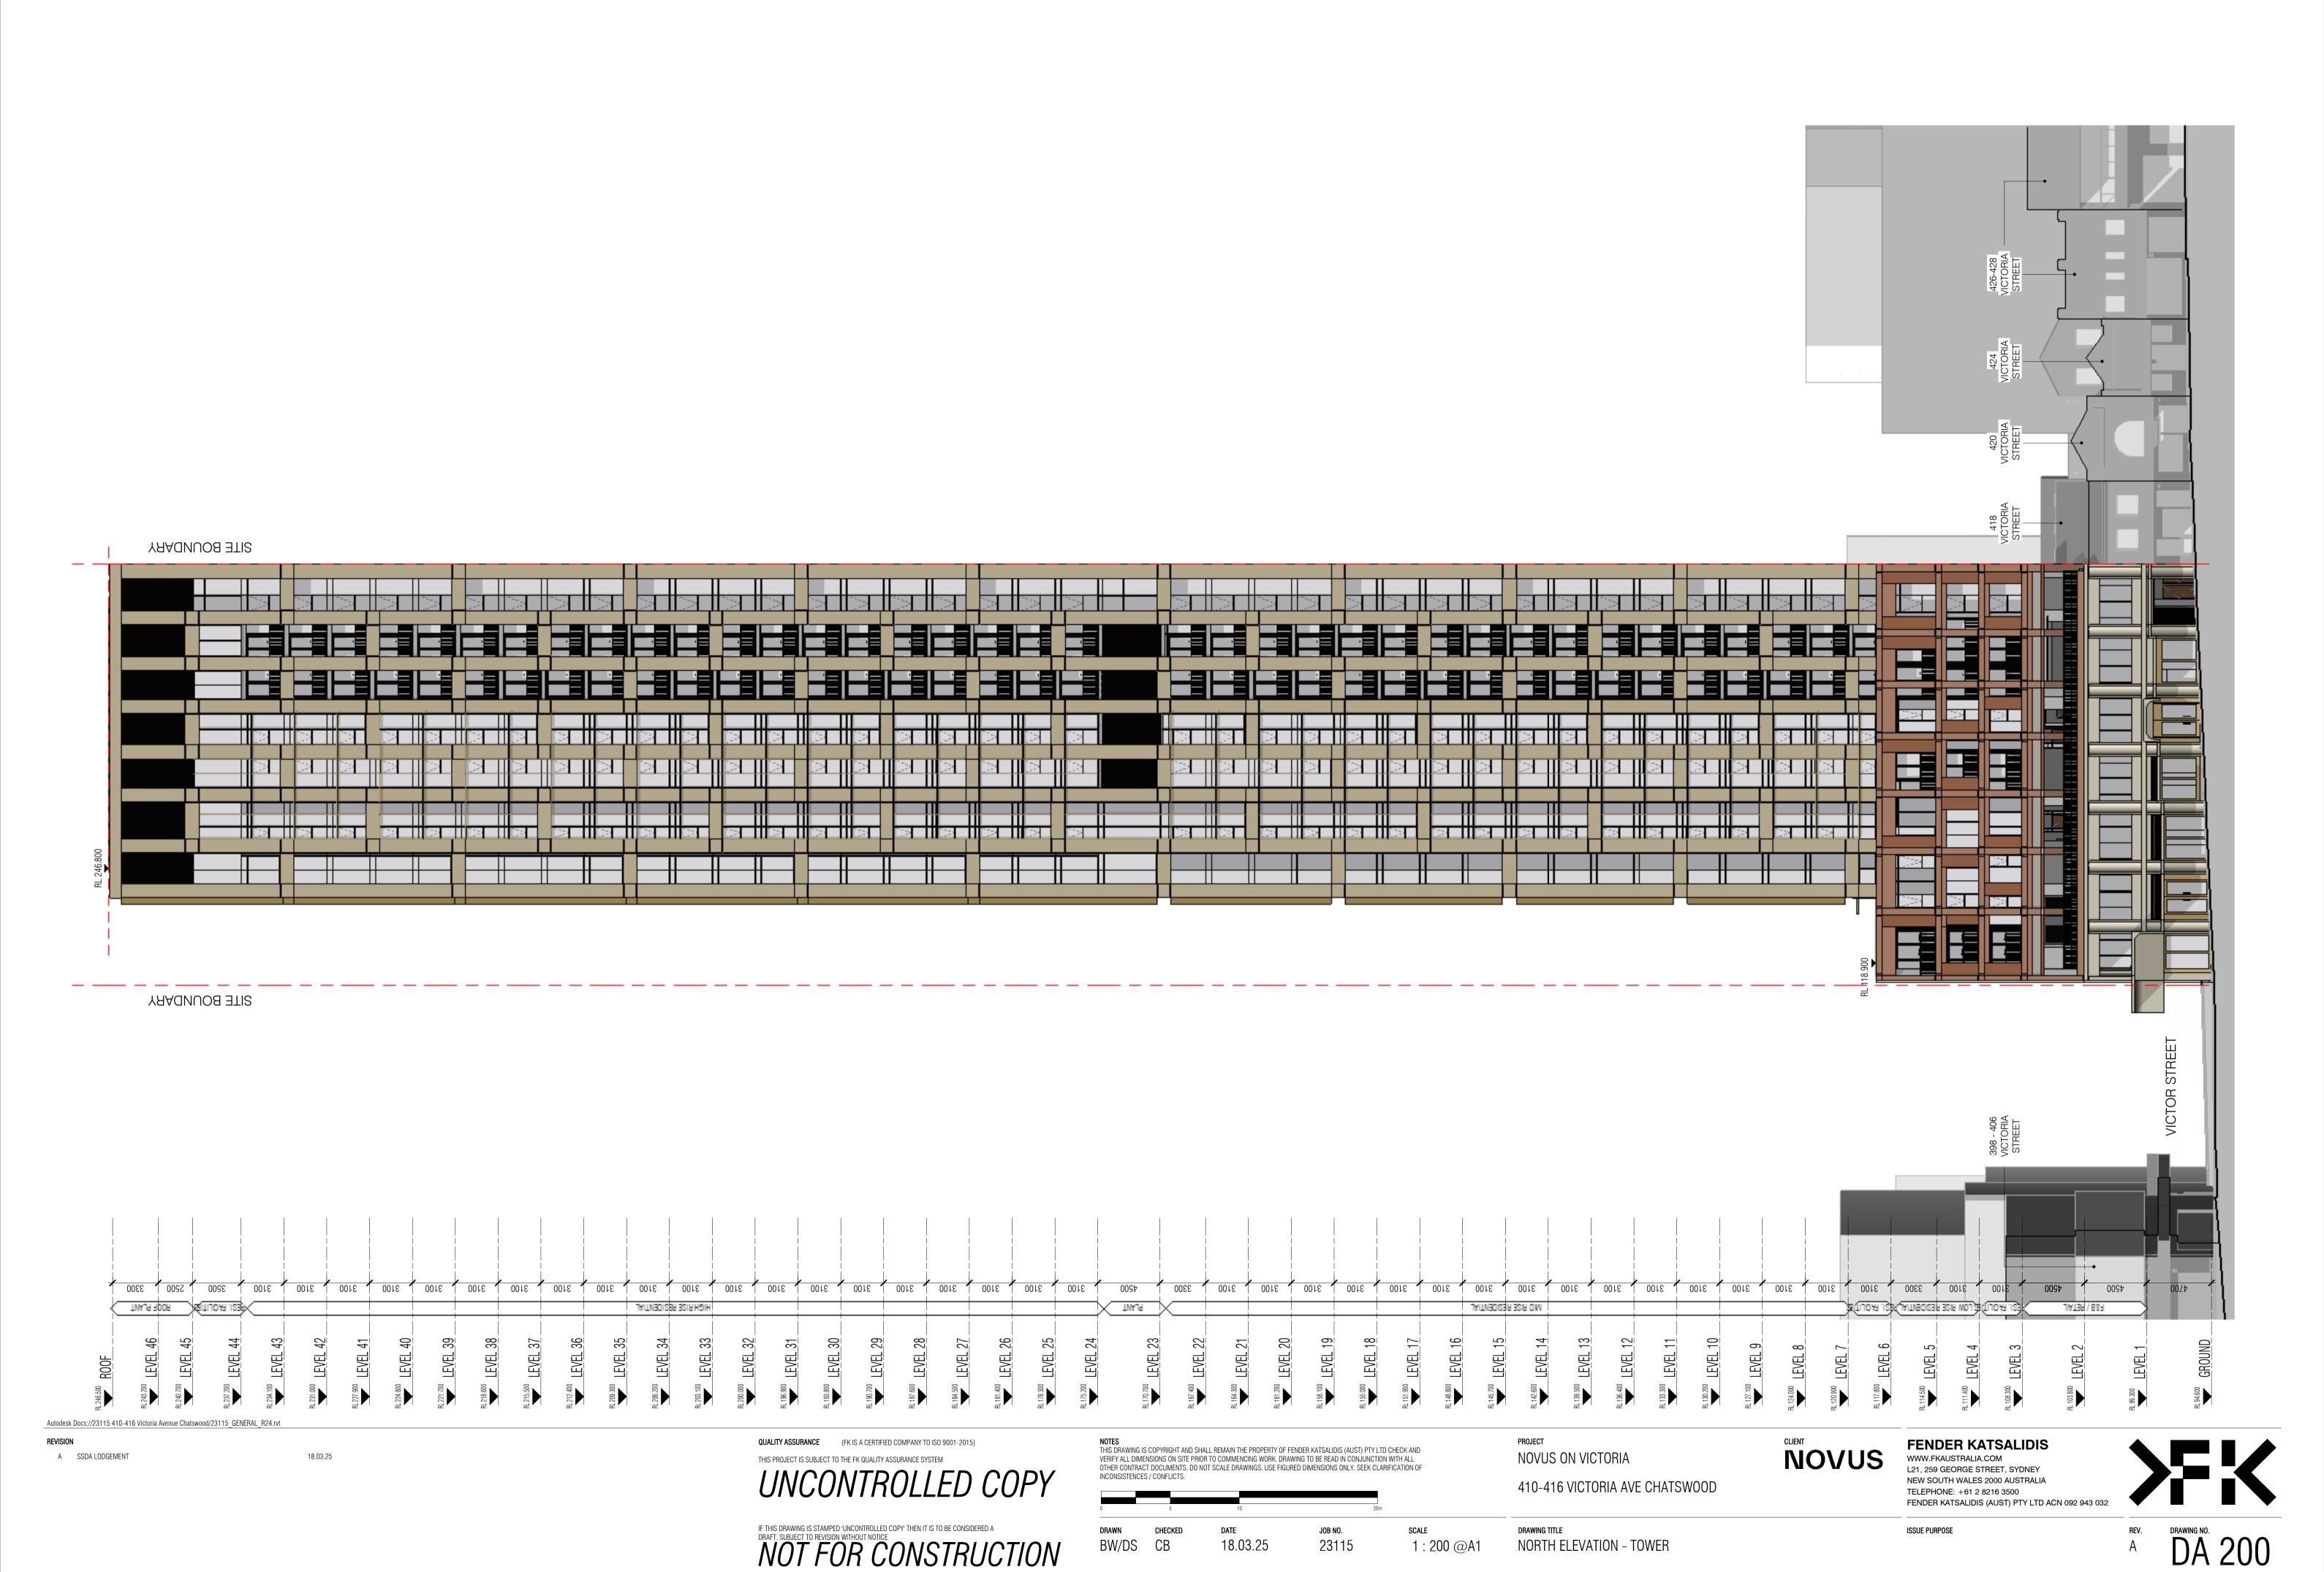

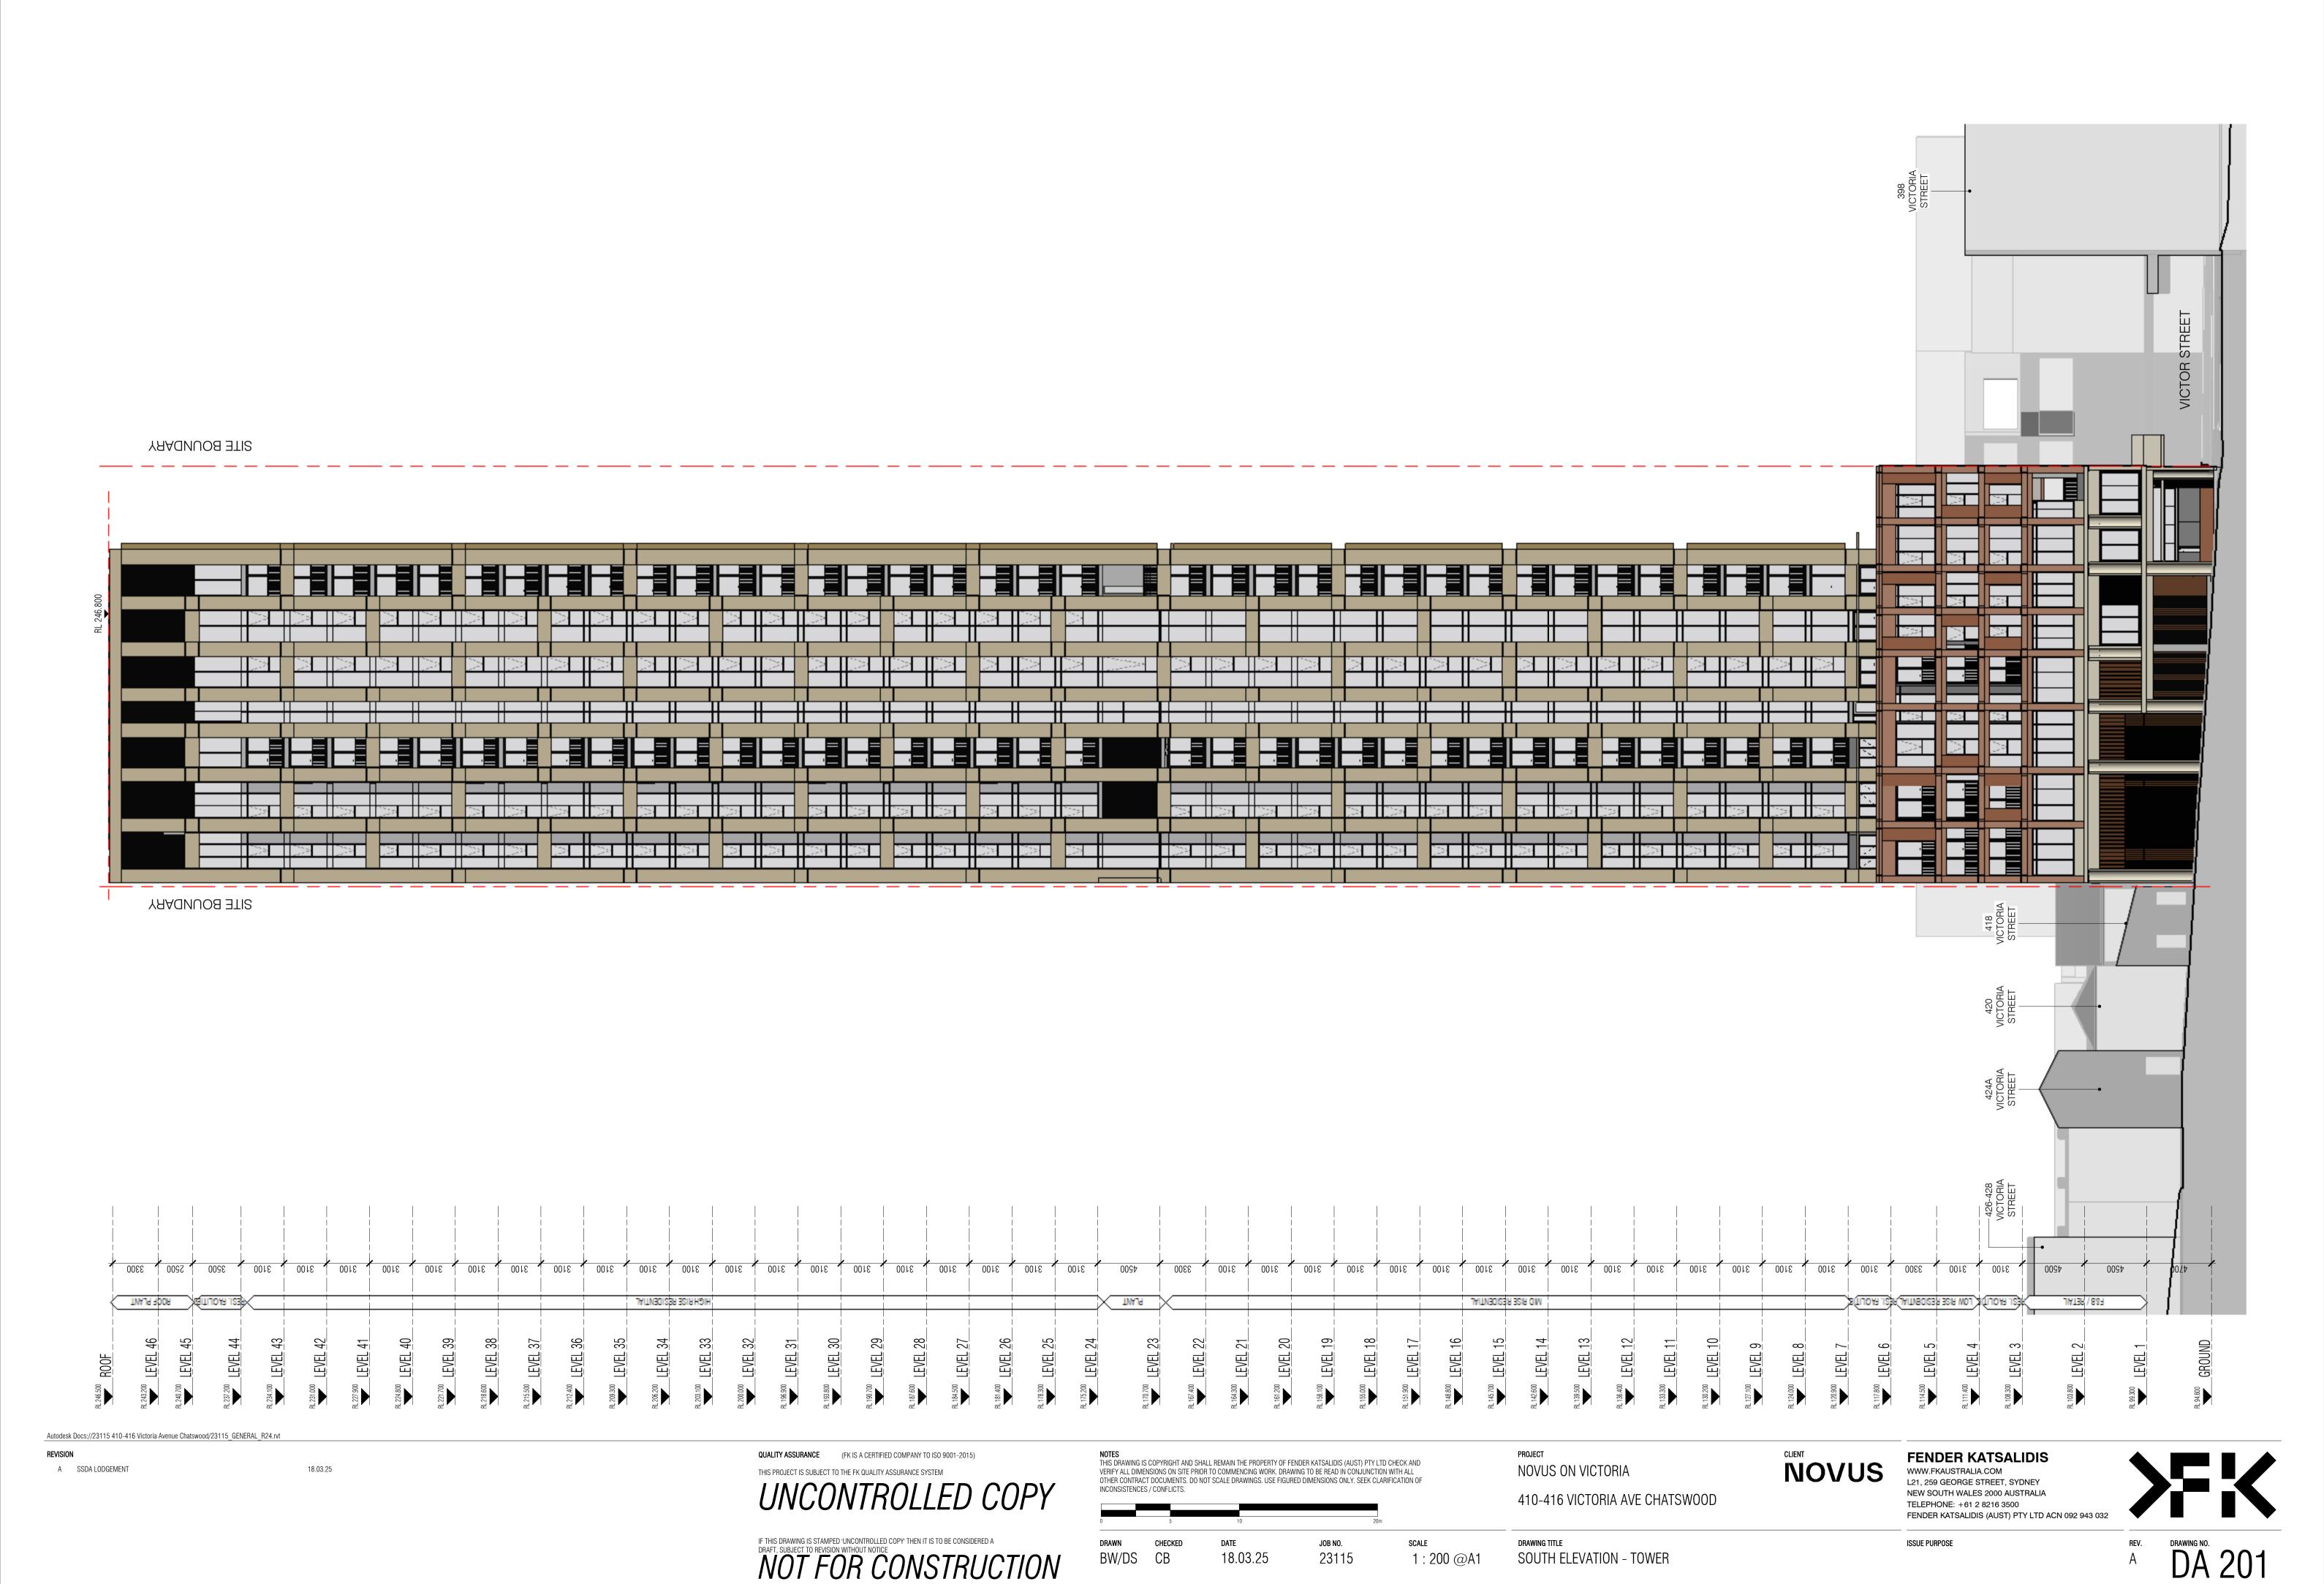

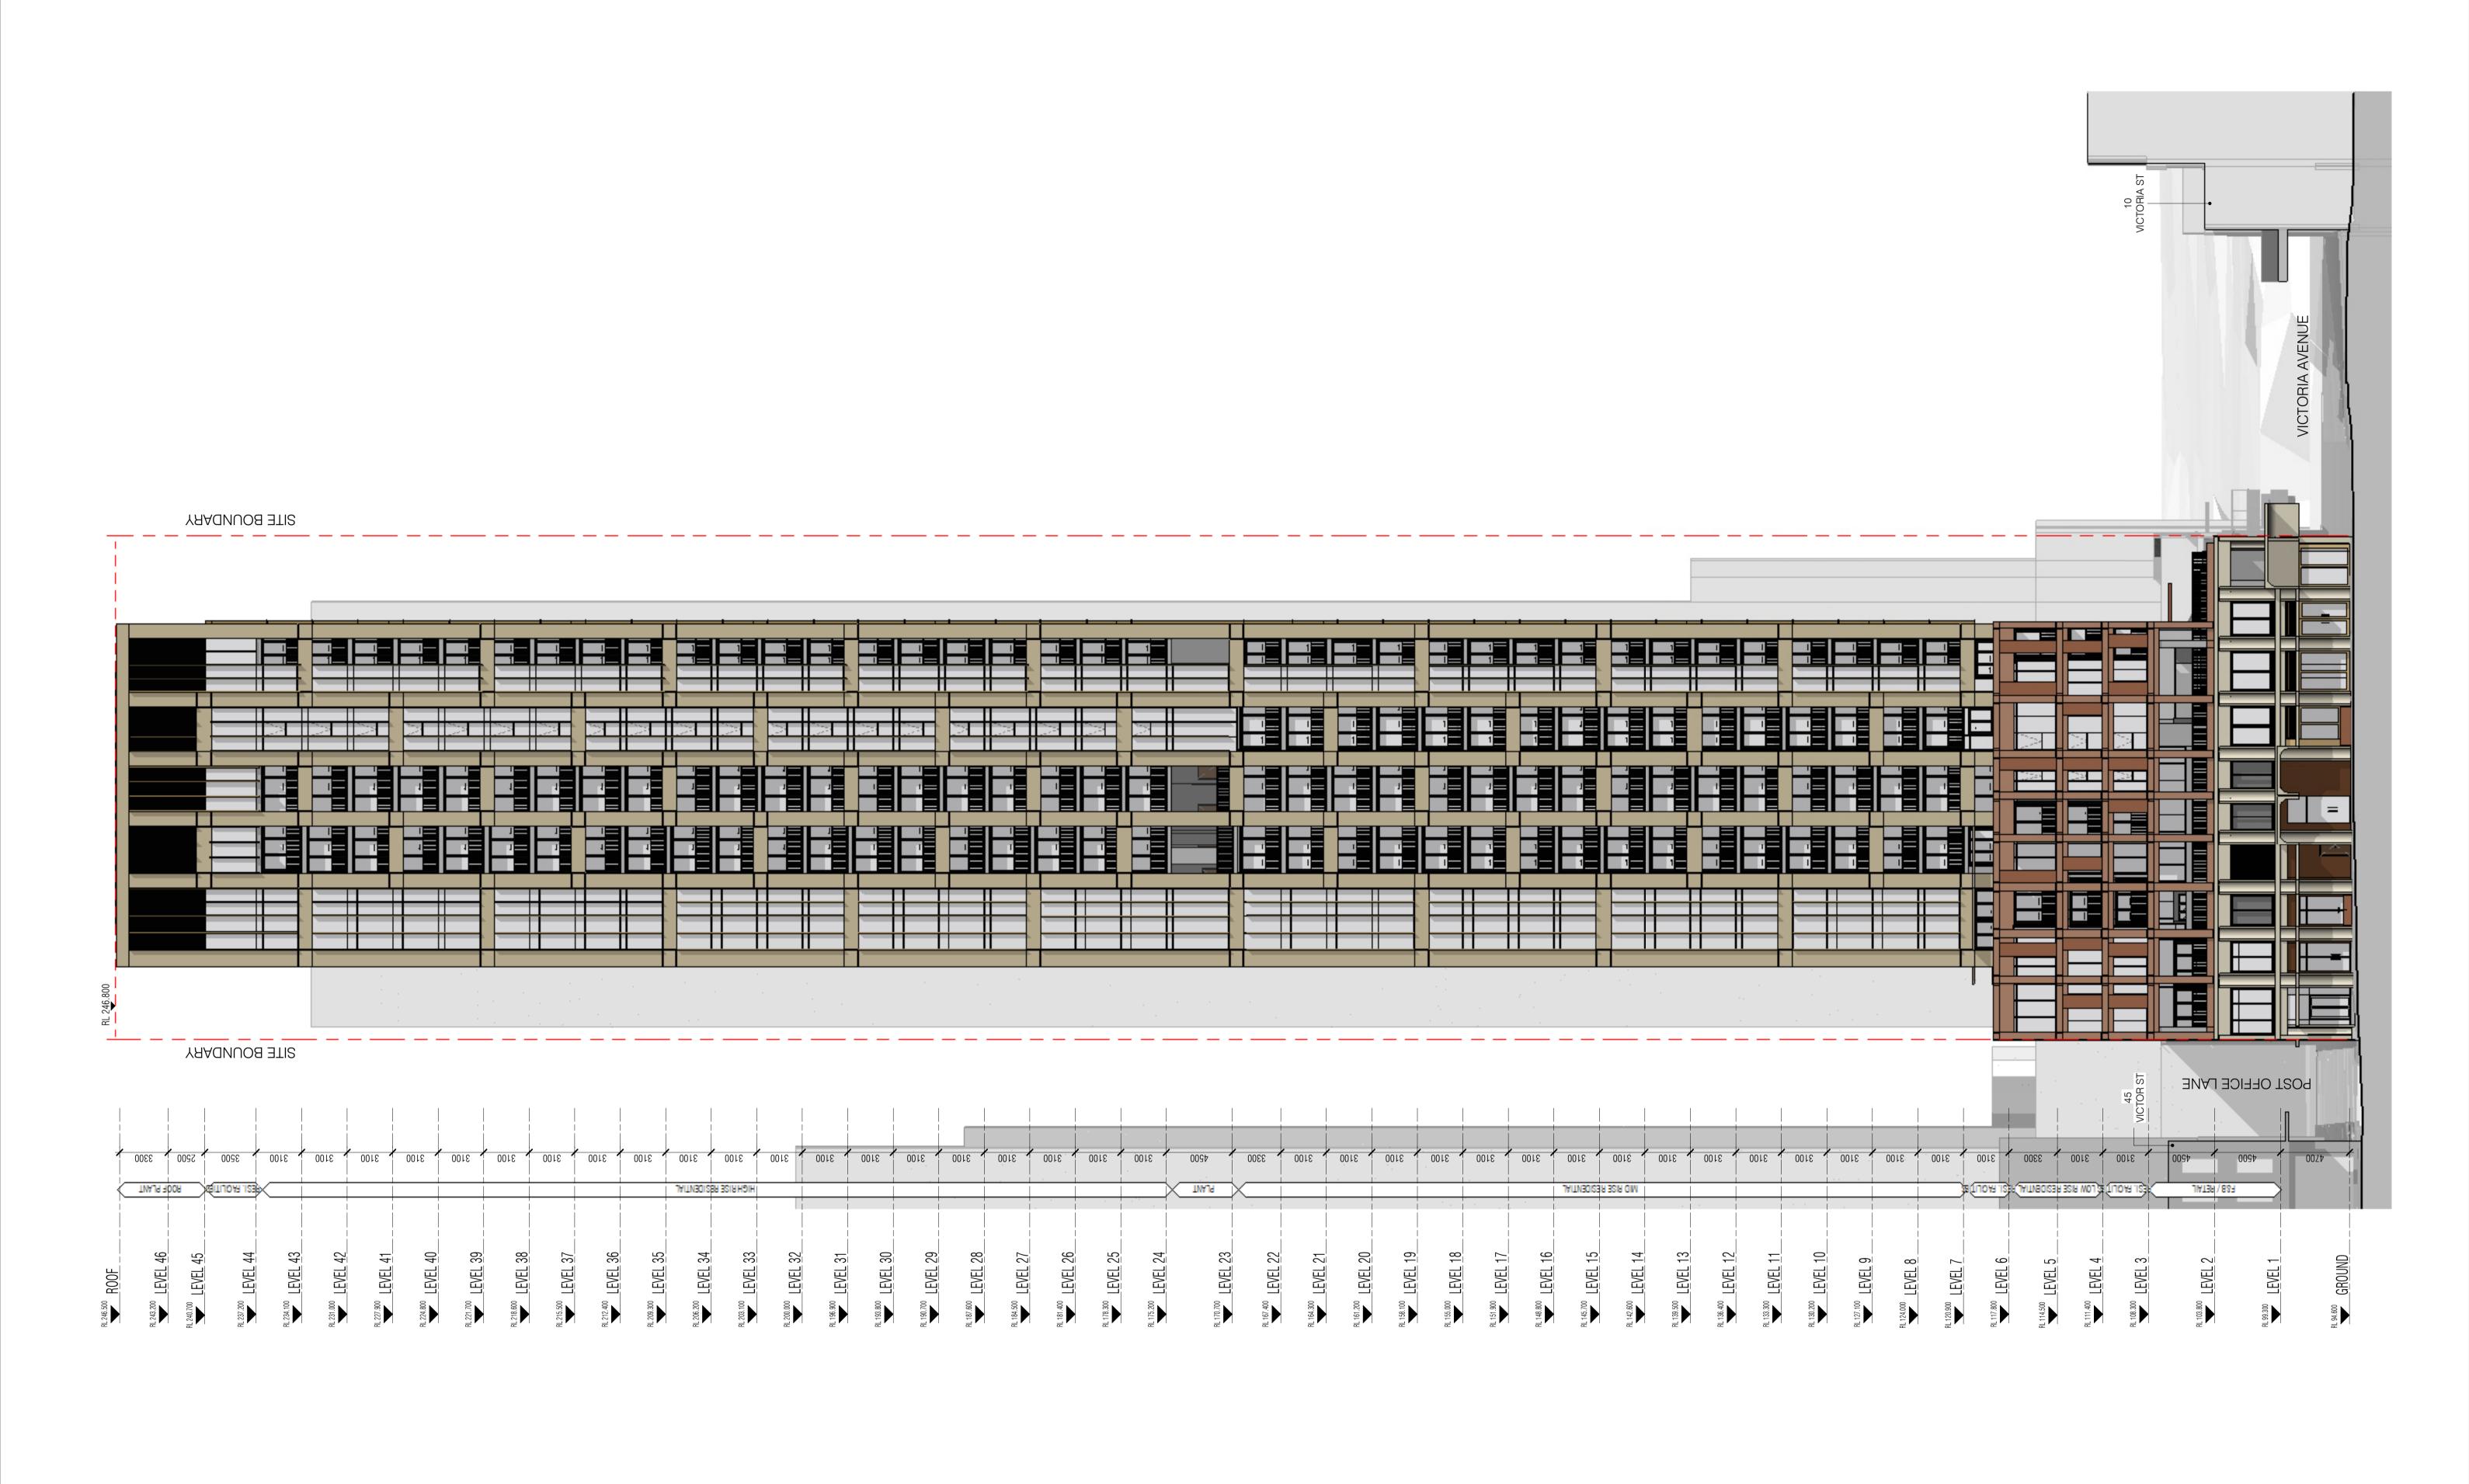

A SSDA LODGEMENT

18.03.25

**QUALITY ASSURANCE** (FK IS A CERTIFIED COMPANY TO ISO 9001-2015) THIS PROJECT IS SUBJECT TO THE FK QUALITY ASSURANCE SYSTEM

UNCONTROLLED COPY


IF THIS DRAWING IS STAMPED 'UNCONTROLLED COPY' THEN IT IS TO BE CONSIDERED A DRAFT, SUBJECT TO REVISION WITHOUT NOTICE NOT FOR CONSTRUCTION

NOTES
THIS DRAWING IS COPYRIGHT AND SHALL REMAIN THE PROPERTY OF FENDER KATSALIDIS (AUST) PTY LTD CHECK AND VERIFY ALL DIMENSIONS ON SITE PRIOR TO COMMENCING WORK. DRAWING TO BE READ IN CONJUNCTION WITH ALL OTHER CONTRACT DOCUMENTS. DO NOT SCALE DRAWINGS. USE FIGURED DIMENSIONS ONLY. SEEK CLARIFICATION OF INCONSISTENCES / CONFLICTS.

NOVUS ON VICTORIA 410-416 VICTORIA AVE CHATSWOOD NOVUS

FENDER KATSALIDIS
WWW.FKAUSTRALIA.COM
L21, 259 GEORGE STREET, SYDNEY NEW SOUTH WALES 2000 AUSTRALIA TELEPHONE: +61 2 8216 3500 FENDER KATSALIDIS (AUST) PTY LTD ACN 092 943 032



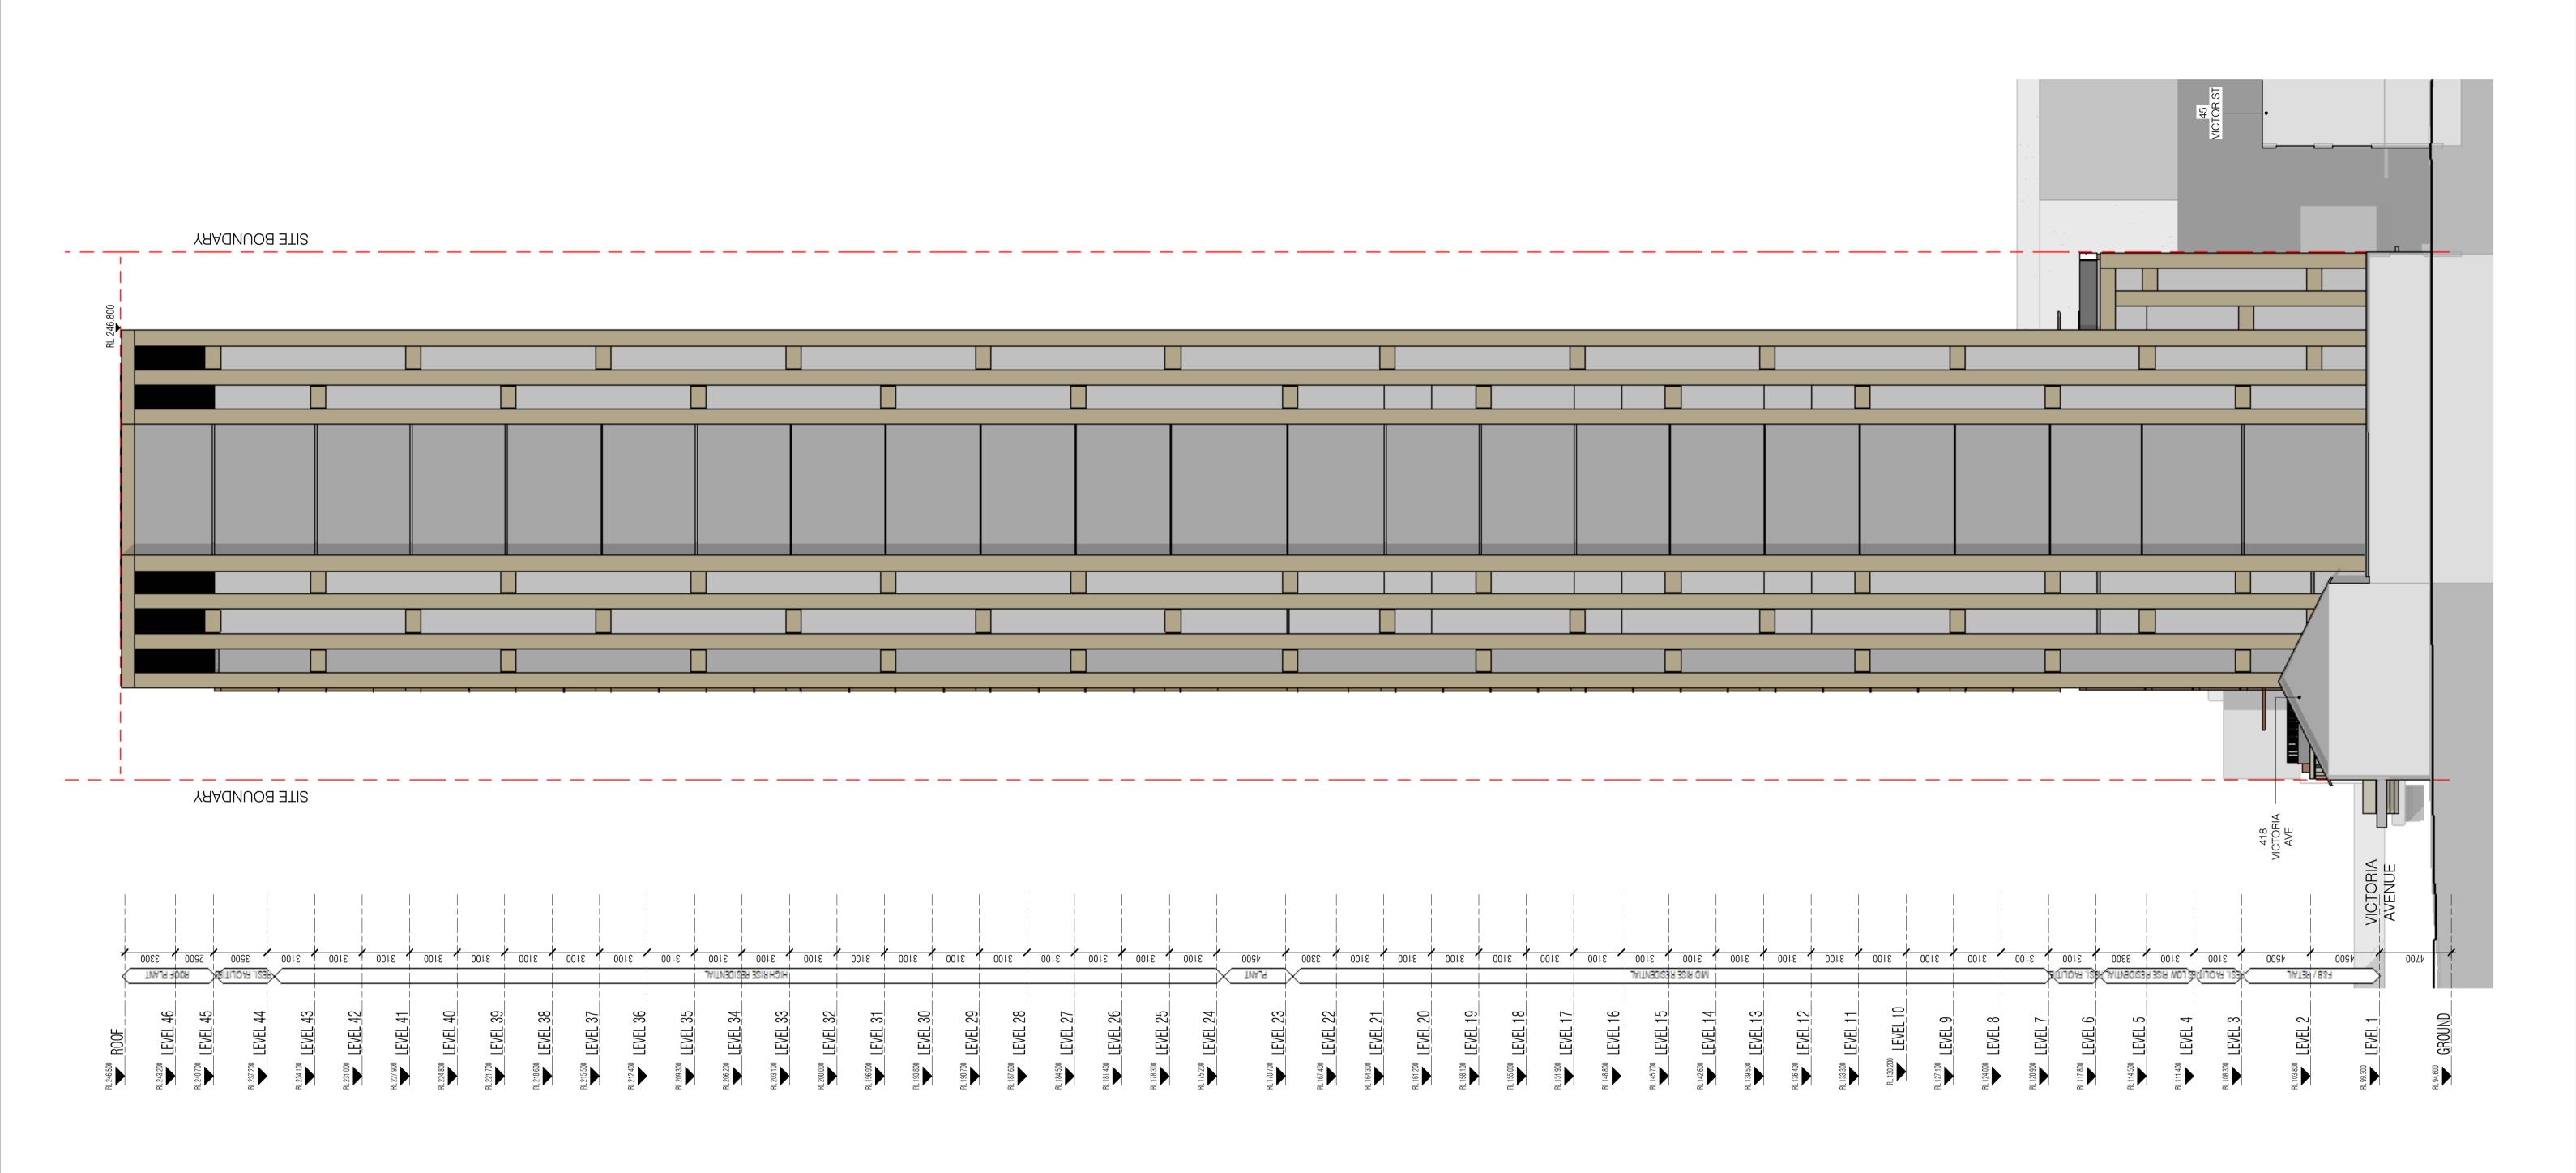

Autodesk Docs://23115 410-416 Victoria Avenue Chatswood/23115\_GENERAL\_R24.rvt REVISION A SSDA LODGEMENT

18.03.25

**QUALITY ASSURANCE** (FK IS A CERTIFIED COMPANY TO ISO 9001-2015) THIS PROJECT IS SUBJECT TO THE FK QUALITY ASSURANCE SYSTEM UNCONTROLLED COPY IF THIS DRAWING IS STAMPED 'UNCONTROLLED COPY' THEN IT IS TO BE CONSIDERED A DRAFT, SUBJECT TO REVISION WITHOUT NOTICE NOT FOR CONSTRUCTION

NOTES
THIS DRAWING IS COPYRIGHT AND SHALL REMAIN THE PROPERTY OF FENDER KATSALIDIS (AUST) PTY LTD CHECK AND VERIFY ALL DIMENSIONS ON SITE PRIOR TO COMMENCING WORK. DRAWING TO BE READ IN CONJUNCTION WITH ALL OTHER CONTRACT DOCUMENTS. DO NOT SCALE DRAWINGS. USE FIGURED DIMENSIONS ONLY. SEEK CLARIFICATION OF INCONSISTENCES / CONFLICTS.

18.03.25

BW/DS CB

SCALE

1:200@A1

23115

PROJECT NOVUS ON VICTORIA 410-416 VICTORIA AVE CHATSWOOD

DRAWING TITLE

WEST ELEVATION - TOWER

NOVUS NEW SOUTH WALES 2000 AUSTRALIA TELEPHONE: +61 2 8216 3500

ISSUE PURPOSE

FENDER KATSALIDIS
WWW.FKAUSTRALIA.COM
L21, 259 GEORGE STREET, SYDNEY FENDER KATSALIDIS (AUST) PTY LTD ACN 092 943 032





APARTMENT VENTILATION LOUVRES NOT SHOWN FOR CLARITY - TO BE COORDINATED WITH MECHANICAL DESIGN AT A FUTURE STAGE. REFER TO FACADE STRATEGY FOR INTENDED LOUVRES DETAILS.

- (Aw01) METAL AWNING, CHARCOAL GREY COLOUR
- (Aw02) METAL AWNING, BEIGE COLOUR
- (Ba01) METAL PALISADE BALUSTRADE, CHARCOAL GREY COLOUR
- Cf01 PIGMENTED PRECAST PANEL, WARM GREY COLOUR
- Cf02 CEMENTITOUS PANEL, BROWN COLOUR
- ©103 CEMENTITOUS PANEL, DARK BROWN COLOUR
- GO1 SILVER COLOUR VISION GLASS
- G02 CLEAR GLASS
- ©03 COLOURBACK GLASS
- METALLIC LOVRES, CHARCOAL GREY COLOUR
- (LO3) METALLIC LOVRES, DARK BRONZE
- MO1 METAL CLADDING / FRAMING, DARK BEIGE
- MO2 DARK BRONZE ROLLER SHUTTER WITH VERTICAL FINS

Autodesk Docs://23115 410-416 Victoria Avenue Chatswood/23115\_GENERAL\_R24.rvt

A SSDA LODGEMENT

18.03.25

**QUALITY ASSURANCE** (FK IS A CERTIFIED COMPANY TO ISO 9001-2015)

THIS PROJECT IS SUBJECT TO THE FK QUALITY ASSURANCE SYSTEM UNCONTROLLED COPY

IF THIS DRAWING IS STAMPED 'UNCONTROLLED COPY' THEN IT IS TO BE CONSIDERED A DRAFT, SUBJECT TO REVISION WITHOUT NOTICE NOT FOR CONSTRUCTION

NOTES
THIS DRAWING IS COPYRIGHT AND SHALL REMAIN THE PROPERTY OF FENDER KATSALIDIS (AUST) PTY LTD CHECK AND VERIFY ALL DIMENSIONS ON SITE PRIOR TO COMMENCING WORK. DRAWING TO BE READ IN CONJUNCTION WITH ALL OTHER CONTRACT DOCUMENTS. DO NOT SCALE DRAWINGS. USE FIGURED DIMENSIONS ONLY. SEEK CLARIFICATION OF  ${\tt INCONSISTENCES\,/\,CONFLICTS}.$ 

18.03.25

BW/DS CB

23115 1:100@A1 410-416 VICTORIA AVE CHATSWOOD

PROJECT

NOVUS ON VICTORIA

PODIUM ELEVATIONS - NORTH

NOVUS

FENDER KATSALIDIS WWW.FKAUSTRALIA.COM L21, 259 GEORGE STREET, SYDNEY NEW SOUTH WALES 2000 AUSTRALIA TELEPHONE: +61 2 8216 3500

ISSUE PURPOSE

FENDER KATSALIDIS (AUST) PTY LTD ACN 092 943 032



APARTMENT VENTILATION LOUVRES NOT SHOWN FOR CLARITY - TO BE COORDINATED WITH MECHANICAL DESIGN AT A FUTURE STAGE. REFER TO FACADE STRATEGY FOR INTENDED LOUVRES DETAILS.

- METAL AWNING, CHARCOAL GREY COLOUR
- (Aw02) METAL AWNING, BEIGE COLOUR
- (Ba01) METAL PALISADE BALUSTRADE, CHARCOAL GREY COLOUR
- Cf01 PIGMENTED PRECAST PANEL, WARM GREY COLOUR
- CEMENTITOUS PANEL, BROWN COLOUR
- CEMENTITOUS PANEL, DARK BROWN COLOUR
- GO1 SILVER COLOUR VISION GLASS
- G02 CLEAR GLASS
- ©3 COLOURBACK GLASS
- METALLIC LOVRES, CHARCOAL GREY COLOUR
- (LO3) METALLIC LOVRES, DARK BRONZE
- Metal Cladding / Framing, dark beige
- MO2 DARK BRONZE ROLLER SHUTTER WITH VERTICAL FINS

Autodesk Docs://23115 410-416 Victoria Avenue Chatswood/23115\_GENERAL\_R24.rvt

REVISION A SSDA LODGEMENT

18.03.25

**QUALITY ASSURANCE** (FK IS A CERTIFIED COMPANY TO ISO 9001-2015)

THIS PROJECT IS SUBJECT TO THE FK QUALITY ASSURANCE SYSTEM UNCONTROLLED COPY

IF THIS DRAWING IS STAMPED 'UNCONTROLLED COPY' THEN IT IS TO BE CONSIDERED A DRAFT, SUBJECT TO REVISION WITHOUT NOTICE NOT FOR CONSTRUCTION

NOTES
THIS DRAWING IS COPYRIGHT AND SHALL REMAIN THE PROPERTY OF FENDER KATSALIDIS (AUST) PTY LTD CHECK AND VERIFY ALL DIMENSIONS ON SITE PRIOR TO COMMENCING WORK. DRAWING TO BE READ IN CONJUNCTION WITH ALL OTHER CONTRACT DOCUMENTS. DO NOT SCALE DRAWINGS. USE FIGURED DIMENSIONS ONLY. SEEK CLARIFICATION OF INCONSISTENCES / CONFLICTS.

18.03.25

23115

1:100@A1


410-416 VICTORIA AVE CHATSWOOD

PODIUM ELEVATIONS - SOUTH

NOVUS ON VICTORIA

NOVUS

FENDER KATSALIDIS WWW.FKAUSTRALIA.COM L21, 259 GEORGE STREET, SYDNEY NEW SOUTH WALES 2000 AUSTRALIA TELEPHONE: +61 2 8216 3500

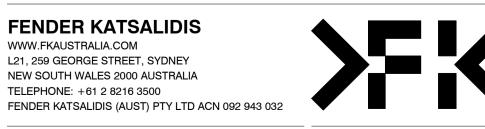



# NOTE

APARTMENT VENTILATION LOUVRES NOT SHOWN FOR CLARITY - TO BE COORDINATED WITH MECHANICAL DESIGN AT A FUTURE STAGE. REFER TO FACADE STRATEGY FOR INTENDED LOUVRES DETAILS.

- METAL AWNING, CHARCOAL GREY COLOUR
- METAL AWNING, BEIGE COLOUR
- (Ba01) METAL PALISADE BALUSTRADE, CHARCOAL GREY COLOUR
- Cf01 PIGMENTED PRECAST PANEL, WARM GREY COLOUR
- CEMENTITOUS PANEL, BROWN COLOUR
- CEMENTITOUS PANEL, DARK BROWN COLOUR
- GO1 SILVER COLOUR VISION GLASS
- G02 CLEAR GLASS
- ©03 COLOURBACK GLASS
- METALLIC LOVRES, CHARCOAL GREY COLOUR
- (LO3) METALLIC LOVRES, DARK BRONZE
- Metal Cladding / Framing, dark beige
- MO2 DARK BRONZE ROLLER SHUTTER WITH VERTICAL FINS

Autodesk Docs://23115 410-416 Victoria Avenue Chatswood/23115\_GENERAL\_R24.rvt

A SSDA LODGEMENT

18.03.25

**QUALITY ASSURANCE** (FK IS A CERTIFIED COMPANY TO ISO 9001-2015) THIS PROJECT IS SUBJECT TO THE FK QUALITY ASSURANCE SYSTEM

UNCONTROLLED COPY

IF THIS DRAWING IS STAMPED 'UNCONTROLLED COPY' THEN IT IS TO BE CONSIDERED A DRAFT, SUBJECT TO REVISION WITHOUT NOTICE NOT FOR CONSTRUCTION

NOTES
THIS DRAWING IS COPYRIGHT AND SHALL REMAIN THE PROPERTY OF FENDER KATSALIDIS (AUST) PTY LTD CHECK AND VERIFY ALL DIMENSIONS ON SITE PRIOR TO COMMENCING WORK. DRAWING TO BE READ IN CONJUNCTION WITH ALL OTHER CONTRACT DOCUMENTS. DO NOT SCALE DRAWINGS. USE FIGURED DIMENSIONS ONLY. SEEK CLARIFICATION OF  ${\tt INCONSISTENCES\,/\,CONFLICTS}.$ 

18.03.25

BW/DS CB

23115

1:100@A1


NOVUS ON VICTORIA


PODIUM ELEVATIONS - EAST


410-416 VICTORIA AVE CHATSWOOD

NOVUS

FENDER KATSALIDIS WWW.FKAUSTRALIA.COM L21, 259 GEORGE STREET, SYDNEY NEW SOUTH WALES 2000 AUSTRALIA TELEPHONE: +61 2 8216 3500

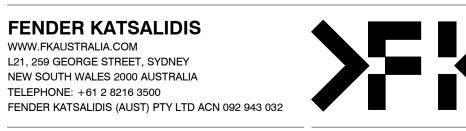

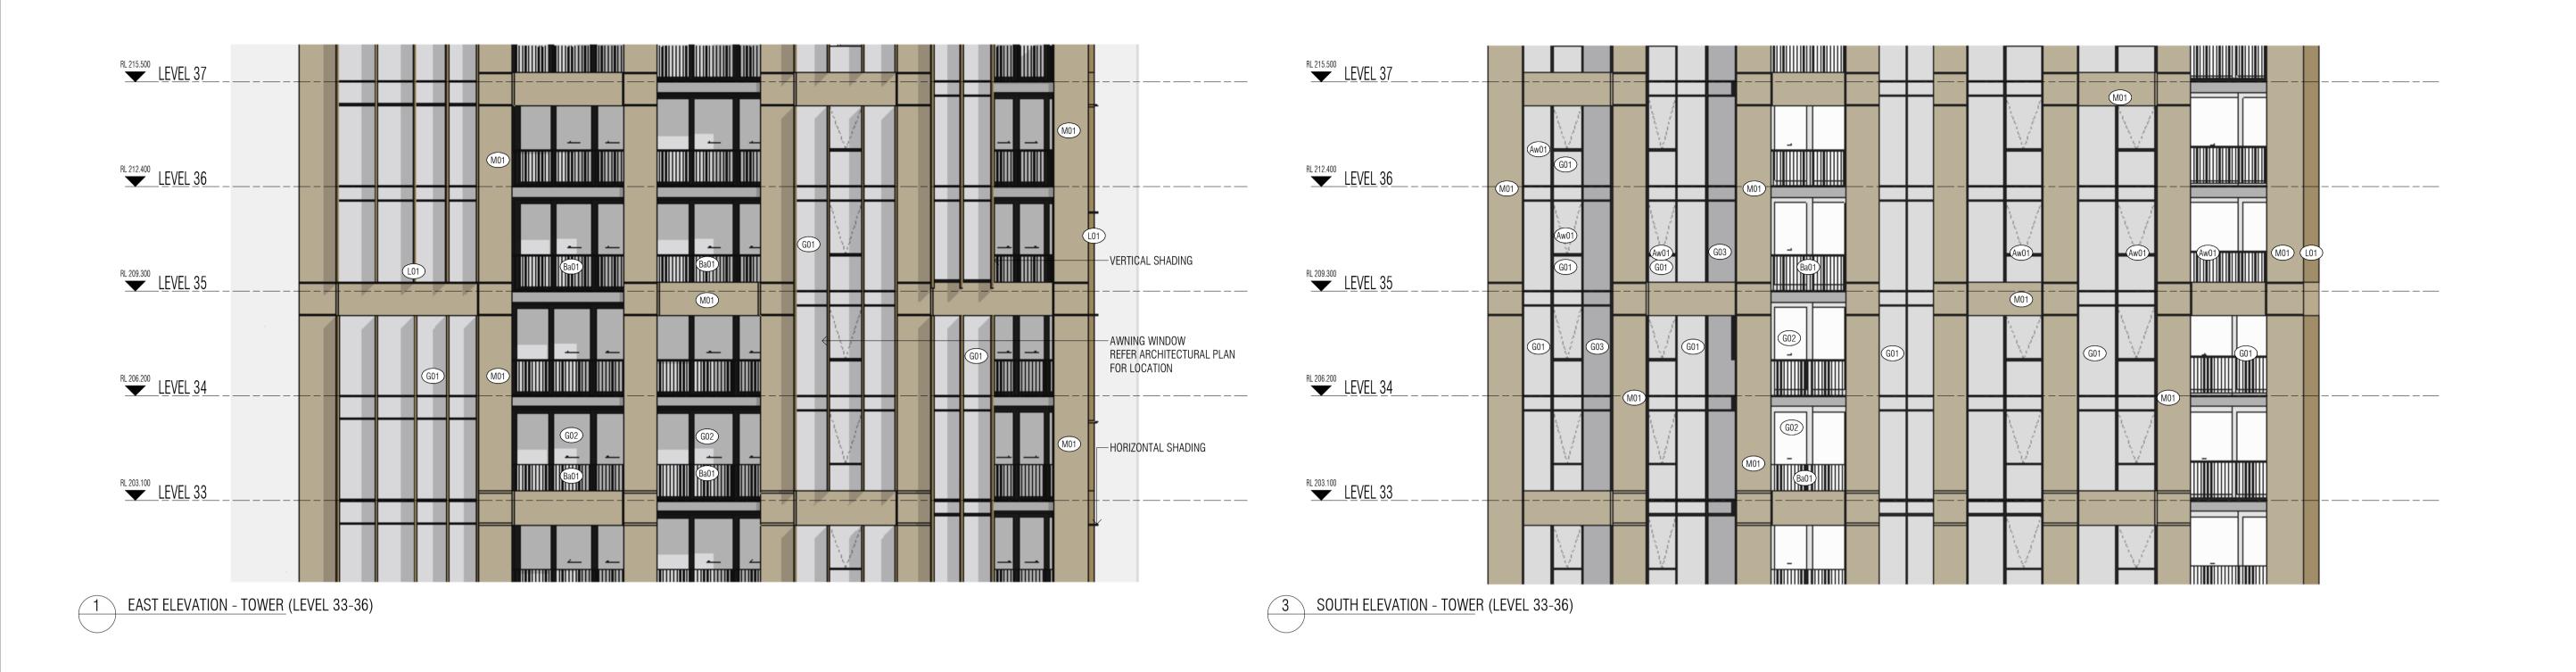

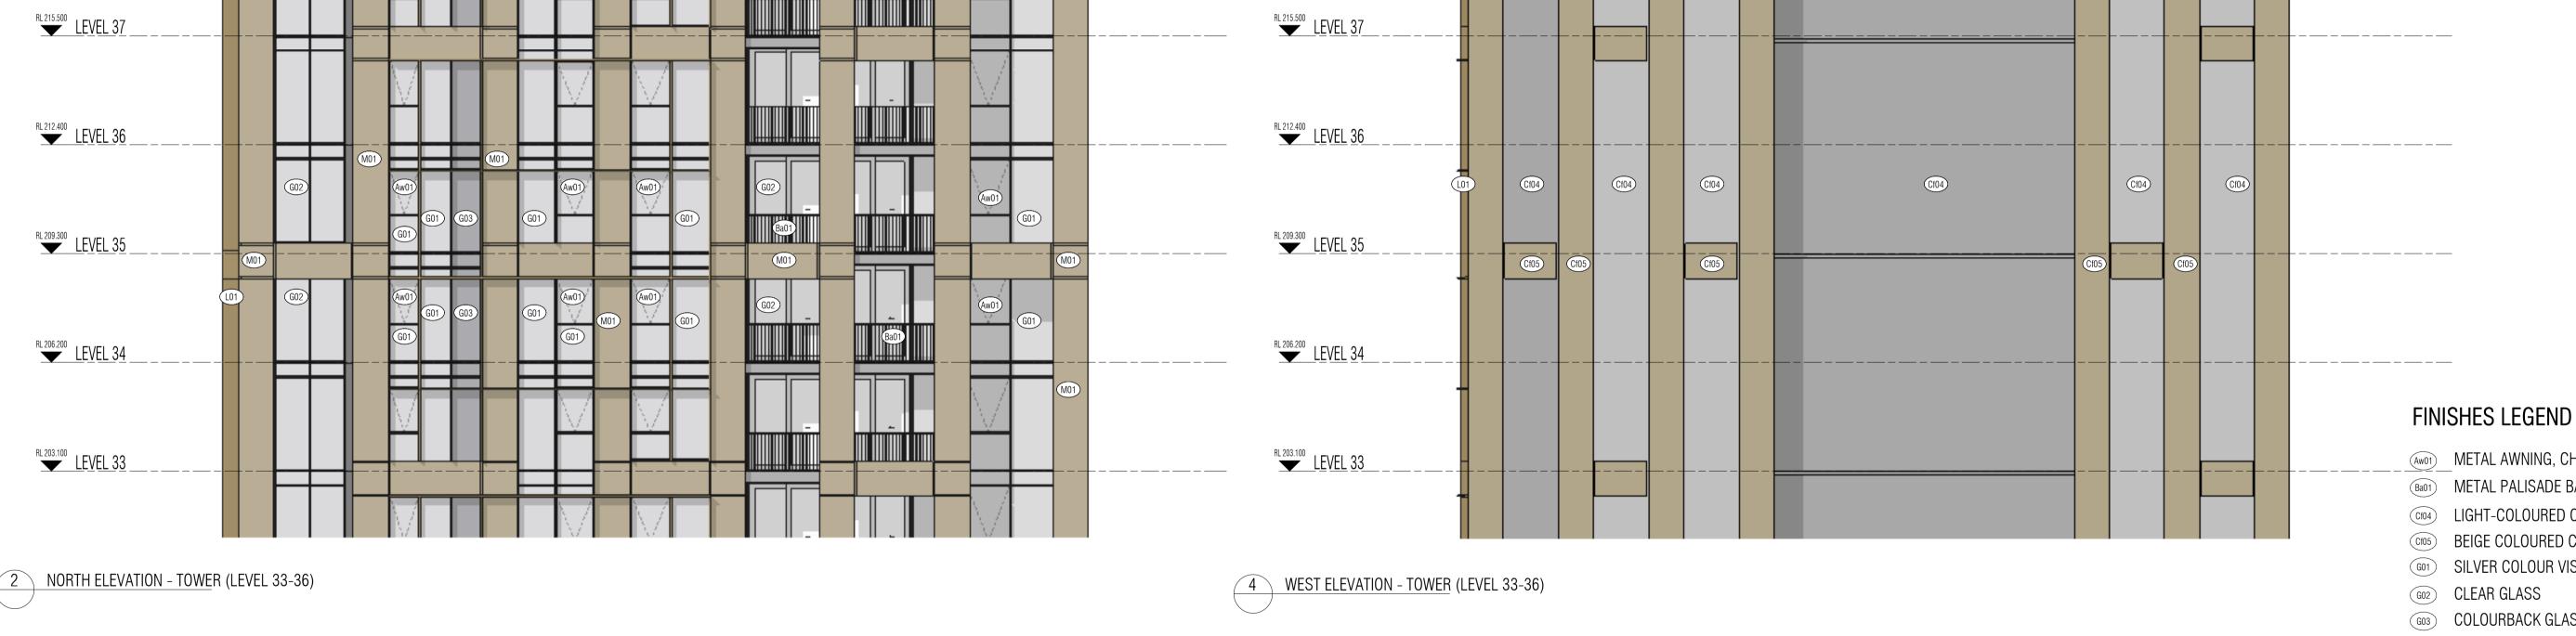

(Aw01) METAL AWNING, CHARCOAL GREY COLOUR

METAL PALISADE BALUSTRADE, CHARCOAL GREY COLOUR Cf04 LIGHT-COLOURED CONCRETE FINISH

BEIGE COLOURED CONCRETE FINISH

G01 SILVER COLOUR VISION GLASS

G02 CLEAR GLASS

G03 COLOURBACK GLASS

(LO1) METALLIC LOVRES, LIGHT BEIGE COLOUR

Metal Cladding, dark beige colour

## NOTE

APARTMENT VENTILATION LOUVRES NOT SHOWN FOR CLARITY - TO BE COORDINATED WITH MECHANICAL DESIGN AT A FUTURE STAGE. REFER TO FACADE STRATEGY FOR INTENDED LOUVRES DETAILS.

Autodesk Docs://23115 410-416 Victoria Avenue Chatswood/23115\_GENERAL\_R24.rvt

A SSDA LODGEMENT

18.03.25

**QUALITY ASSURANCE** (FK IS A CERTIFIED COMPANY TO ISO 9001-2015) THIS PROJECT IS SUBJECT TO THE FK QUALITY ASSURANCE SYSTEM UNCONTROLLED COPY

INCONSISTENCES / CONFLICTS. IF THIS DRAWING IS STAMPED 'UNCONTROLLED COPY' THEN IT IS TO BE CONSIDERED A DRAFT, SUBJECT TO REVISION WITHOUT NOTICE NOT FOR CONSTRUCTION

BW/DS CB

**NOTES**THIS DRAWING IS COPYRIGHT AND SHALL REMAIN THE PROPERTY OF FENDER KATSALIDIS (AUST) PTY LTD CHECK AND VERIFY ALL DIMENSIONS ON SITE PRIOR TO COMMENCING WORK. DRAWING TO BE READ IN CONJUNCTION WITH ALL OTHER CONTRACT DOCUMENTS. DO NOT SCALE DRAWINGS. USE FIGURED DIMENSIONS ONLY. SEEK CLARIFICATION OF

23115

18.03.25

NOVUS ON VICTORIA 410-416 VICTORIA AVE CHATSWOOD

DRAWING TITLE


TOWER ELEVATIONS

1:100@A1

NOVUS

FENDER KATSALIDIS
WWW.FKAUSTRALIA.COM
L21, 259 GEORGE STREET, SYDNEY NEW SOUTH WALES 2000 AUSTRALIA TELEPHONE: +61 2 8216 3500 FENDER KATSALIDIS (AUST) PTY LTD ACN 092 943 032



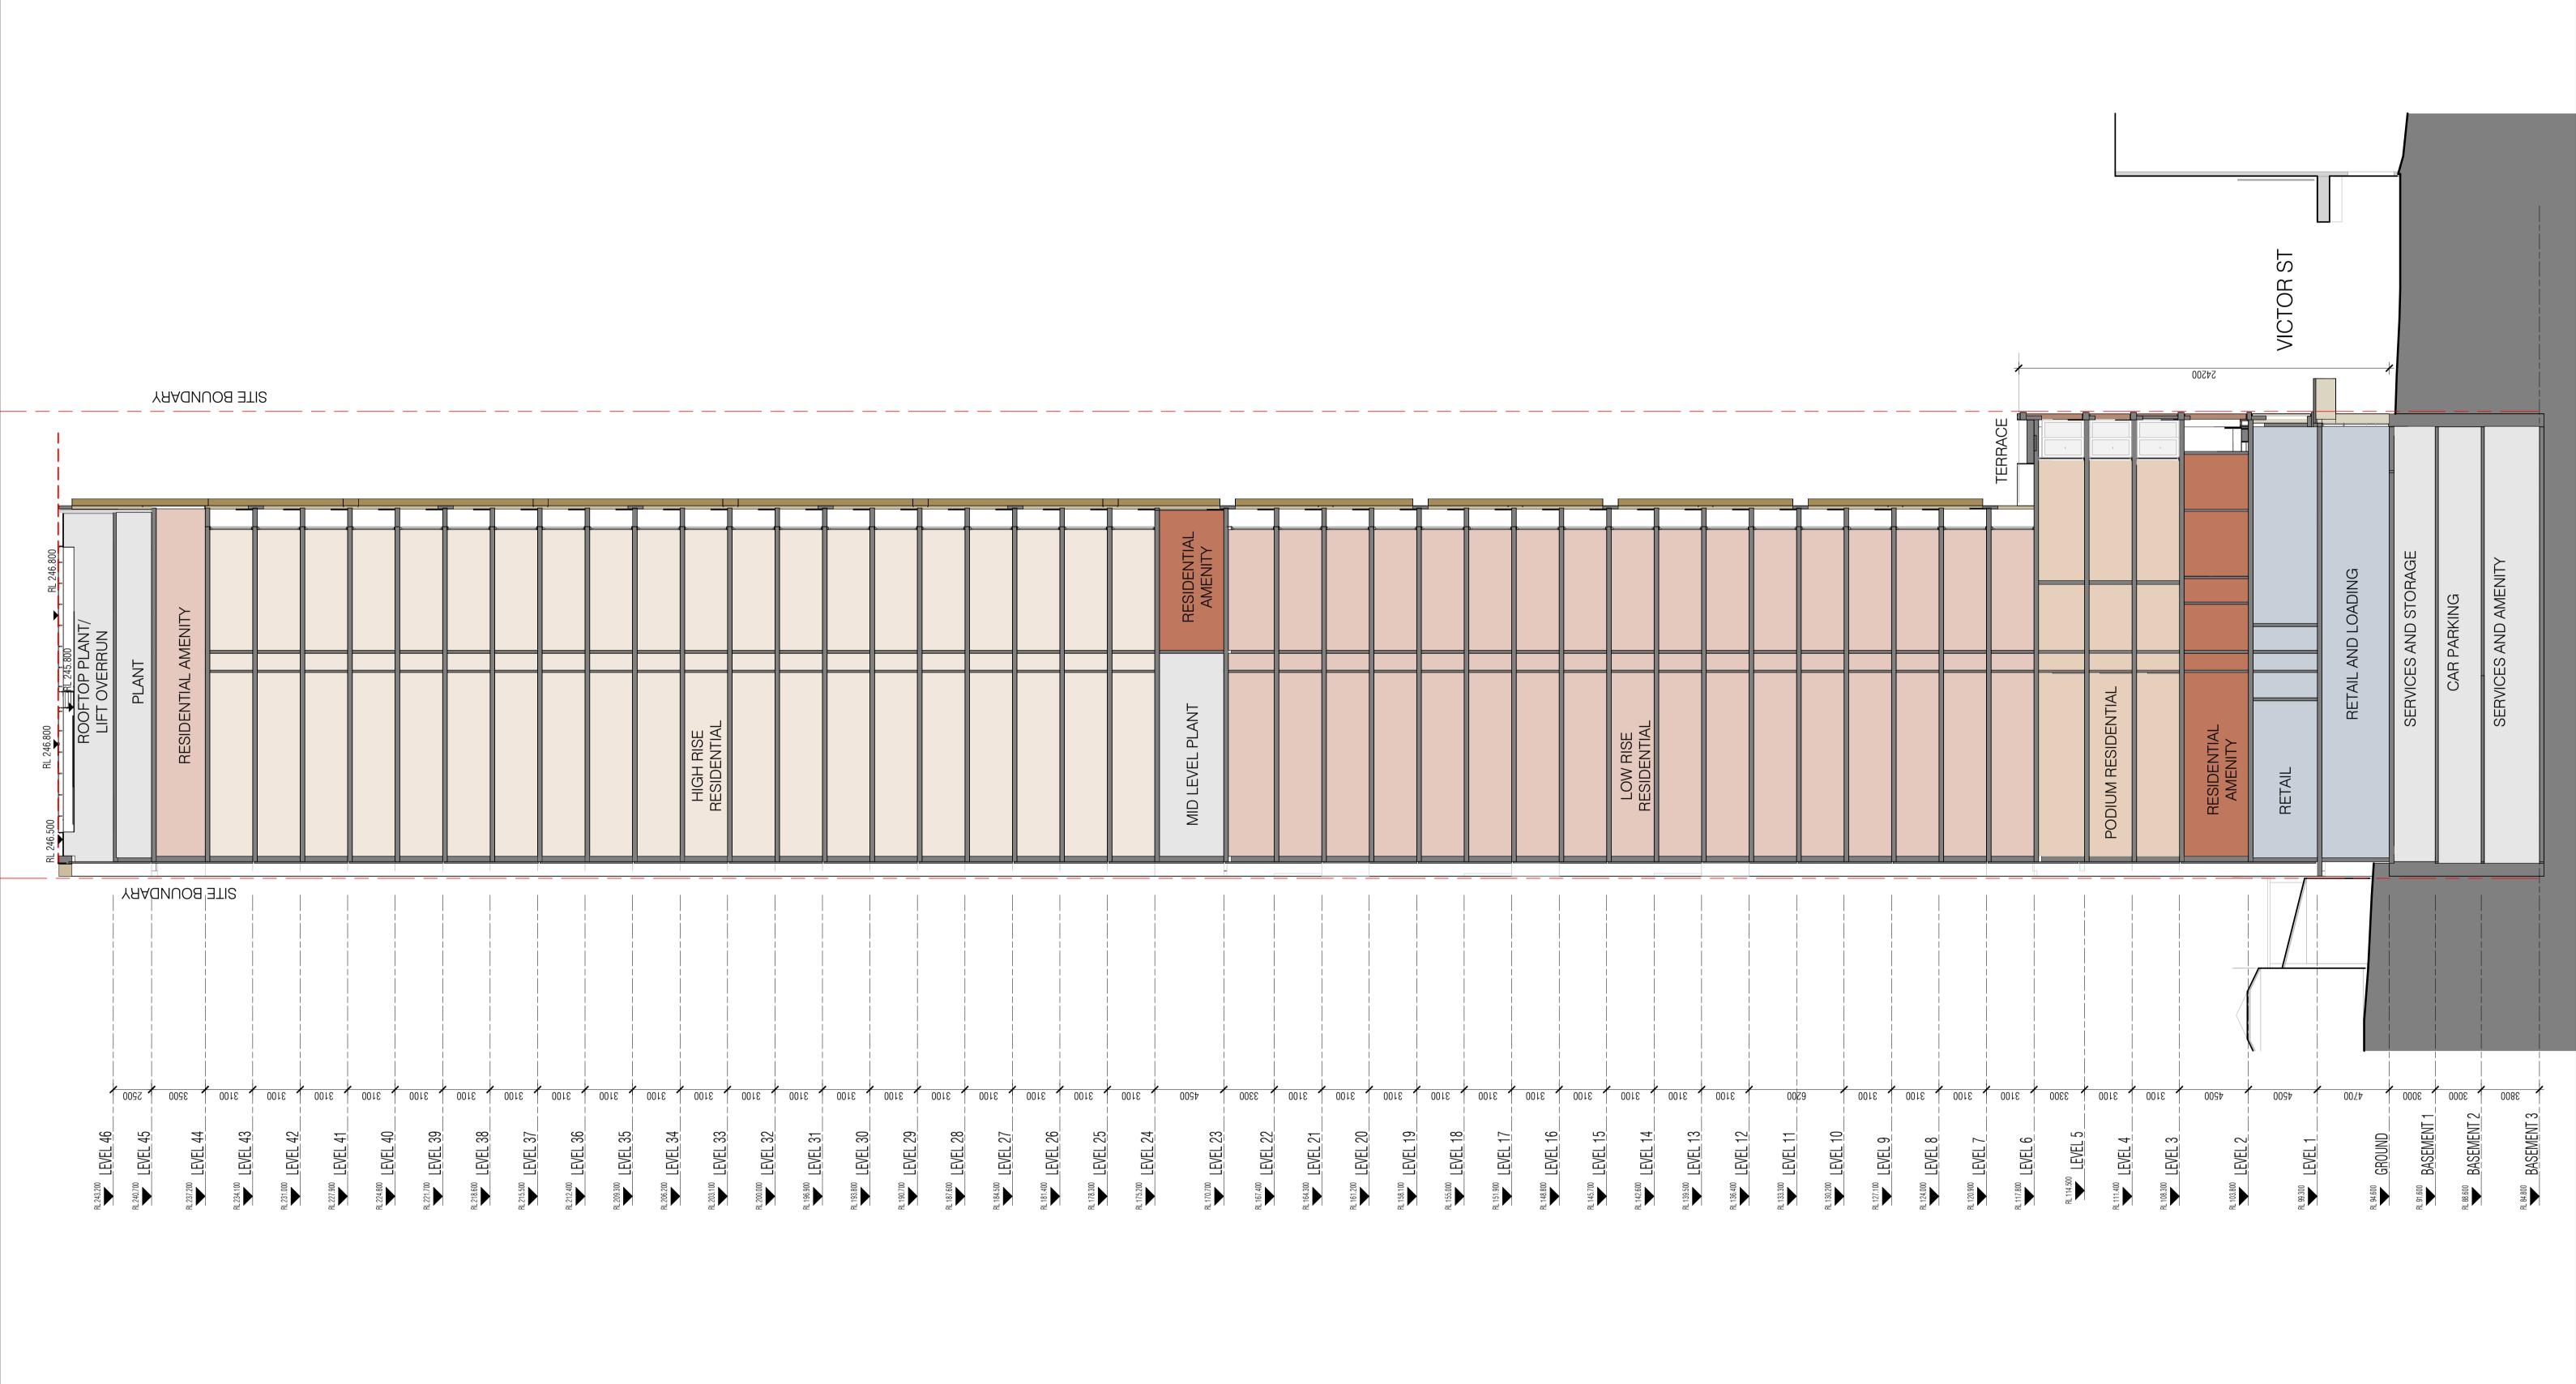

REVISION

A SSDA LODGEMENT

Autodesk Docs://23115 410-416 Victoria Avenue Chatswood/23115\_GENERAL\_R24.rvt

18.03.25

QUALITY ASSURANCE (FK IS A CERTIFIED COMPANY TO ISO 9001-2015)

THIS PROJECT IS SUBJECT TO THE FK QUALITY ASSURANCE SYSTEM

UNCONTROLLED COPY

IF THIS DRAWING IS STAMPED 'UNCONTROLLED COPY' THEN IT IS TO BE CONSIDERED A DRAFT, SUBJECT TO REVISION WITHOUT NOTICE

NOTES
THIS DRAWING IS COPYRIGHT AND SHALL REMAIN THE PROPERTY OF FENDER KATSALIDIS (AUST) PTY LTD CHECK AND VERIFY ALL DIMENSIONS ON SITE PRIOR TO COMMENCING WORK. DRAWING TO BE READ IN CONJUNCTION WITH ALL OTHER CONTRACT DOCUMENTS. DO NOT SCALE DRAWINGS. USE FIGURED DIMENSIONS ONLY. SEEK CLARIFICATION OF INCONSISTENCES / CONFLICTS.

NOVUS ON VICTORIA
410-416 VICTORIA AVE CHATSWOOD

FENDER KA
WWW.FKAUSTRALIA.
L21, 259 GEORGE ST
NEW SOUTH WALES:
TELEPHONE: +61 2 8

FENDER KATSALIDIS


WWW.FKAUSTRALIA.COM

L21, 259 GEORGE STREET, SYDNEY

NEW SOUTH WALES 2000 AUSTRALIA


TELEPHONE: +61 2 8216 3500

FENDER KATSALIDIS (AUST) PTY LTD ACN 092 943 032

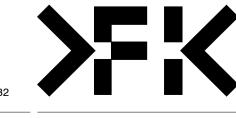

SCALE

1:200@A1

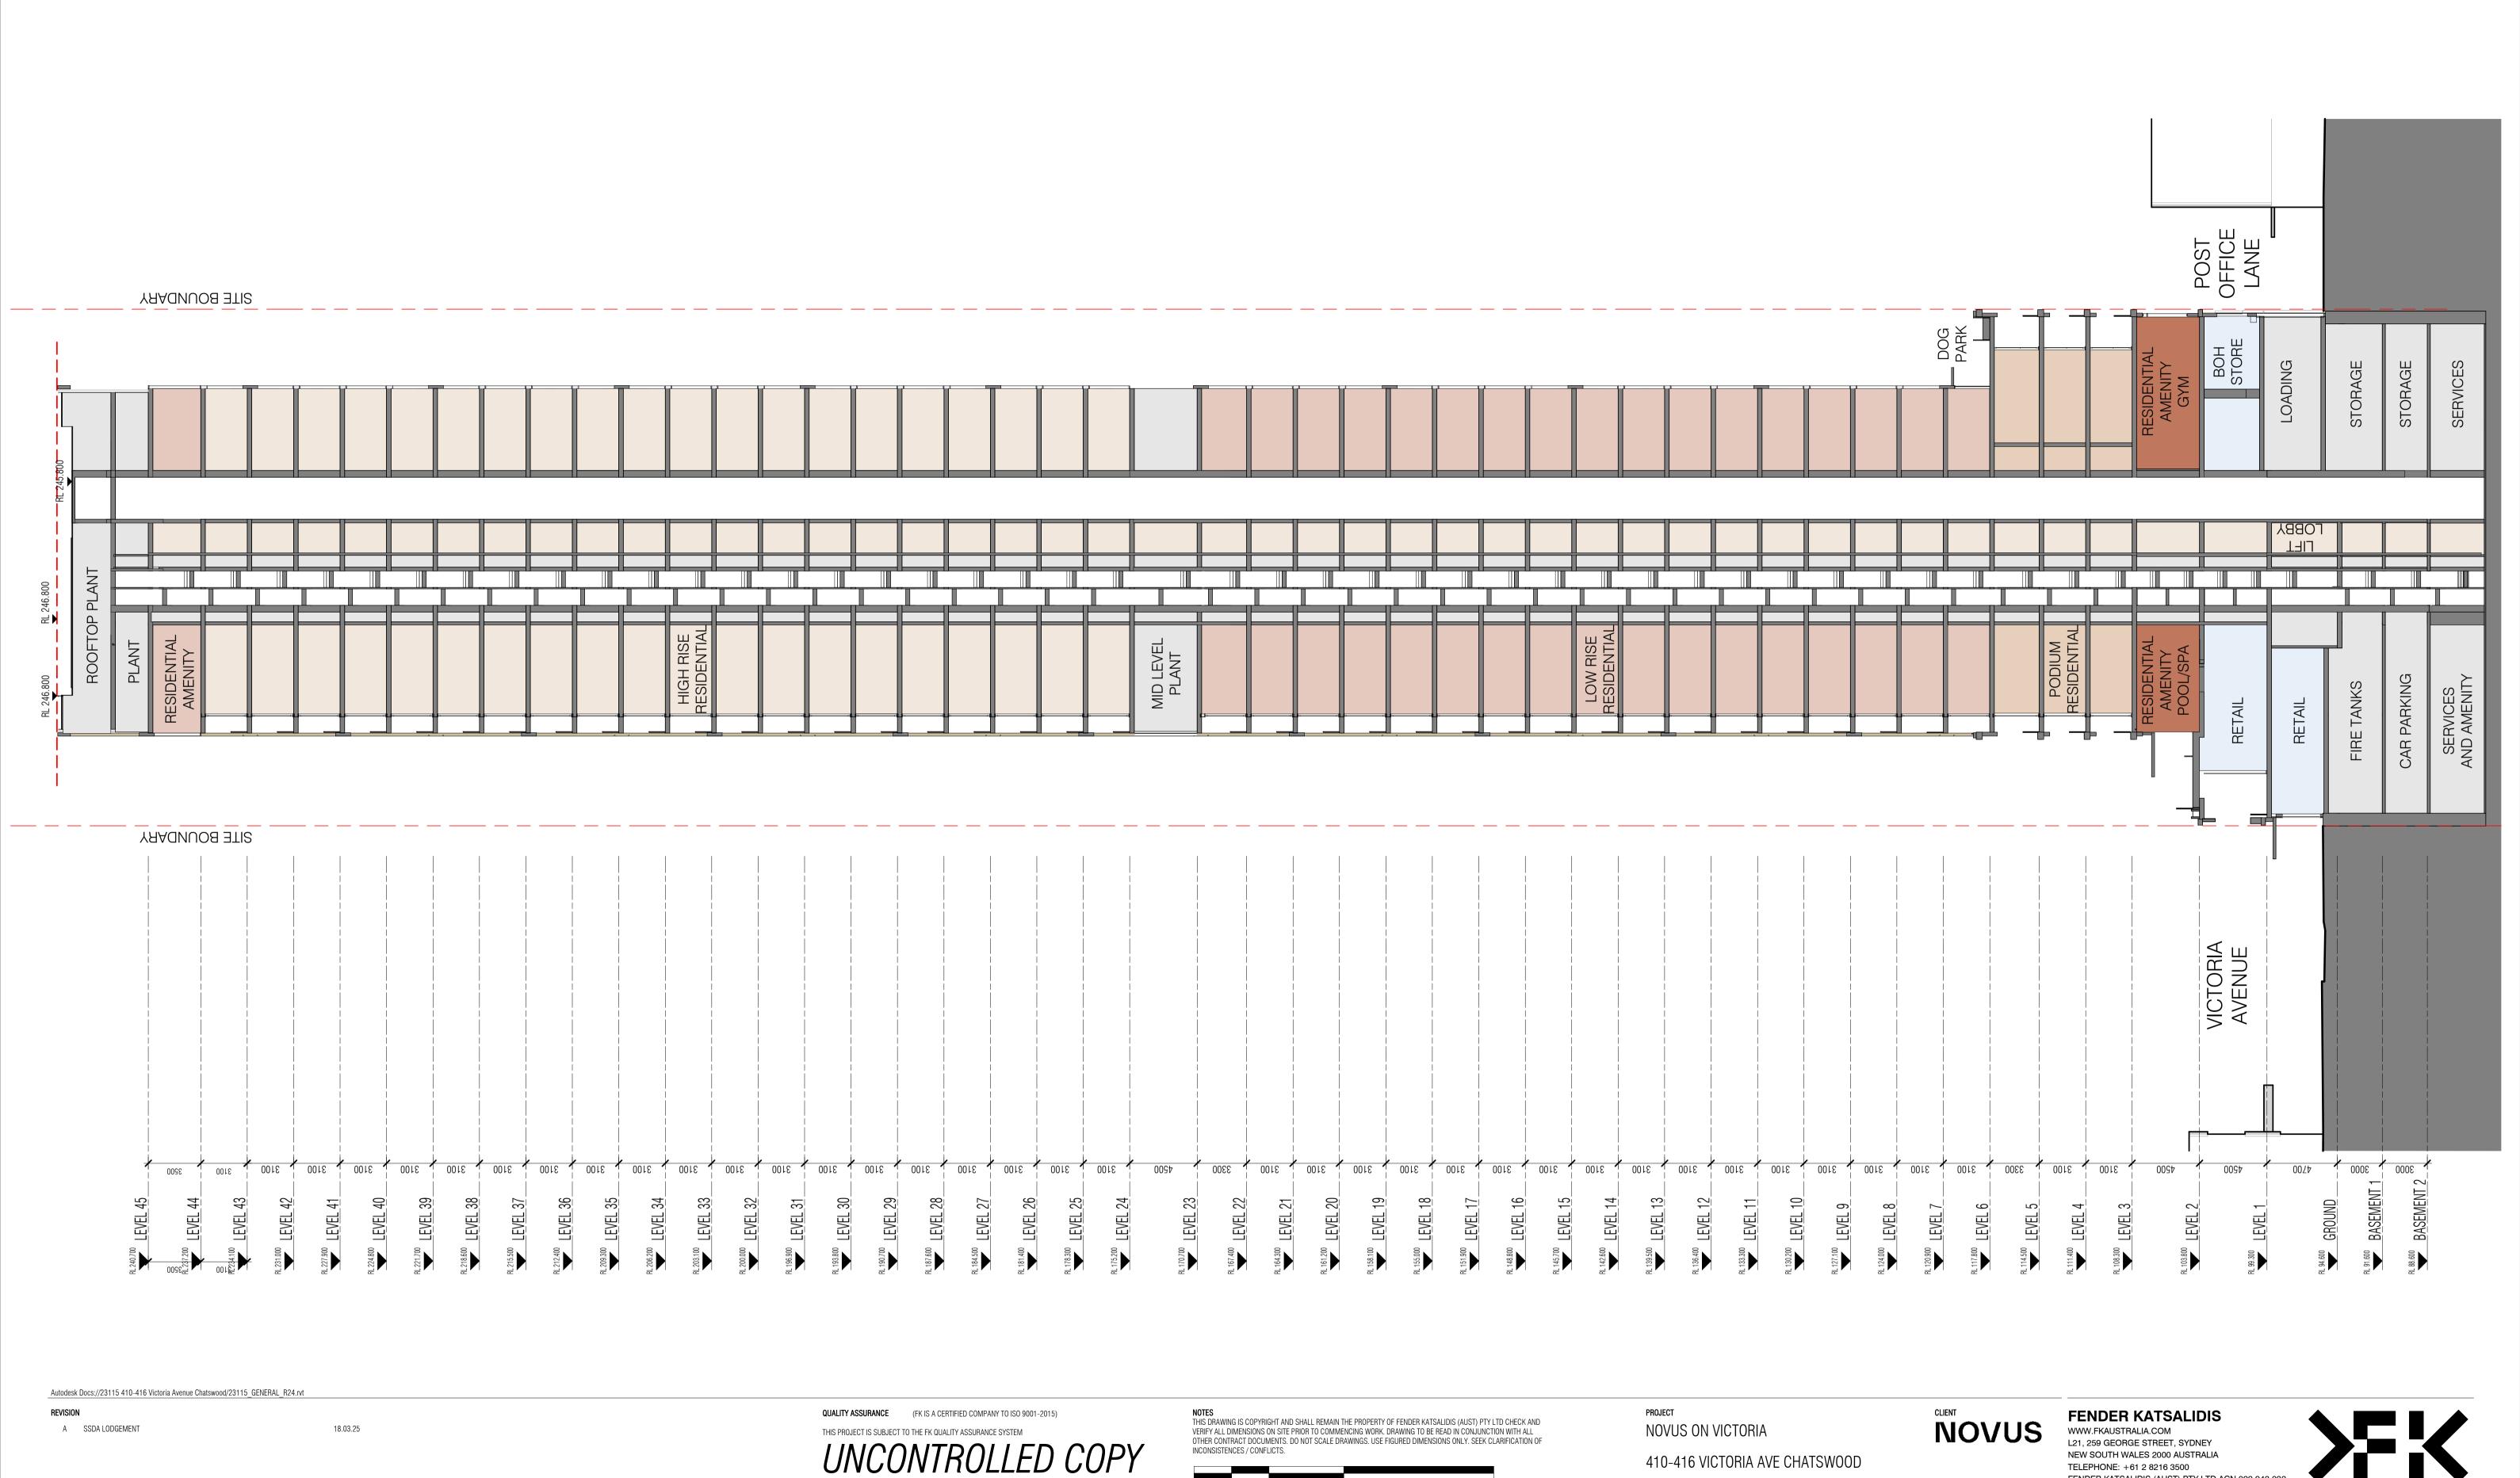

IF THIS DRAWING IS STAMPED 'UNCONTROLLED COPY' THEN IT IS TO BE CONSIDERED A DRAFT, SUBJECT TO REVISION WITHOUT NOTICE NOT FOR CONSTRUCTION

NEW SOUTH WALES 2000 AUSTRALIA

FENDER KATSALIDIS (AUST) PTY LTD ACN 092 943 032

DA 251

TELEPHONE: +61 2 8216 3500

ISSUE PURPOSE

410-416 VICTORIA AVE CHATSWOOD

DRAWING TITLE


SECTIONS

SCALE

1:200@A1

23115

18.03.25

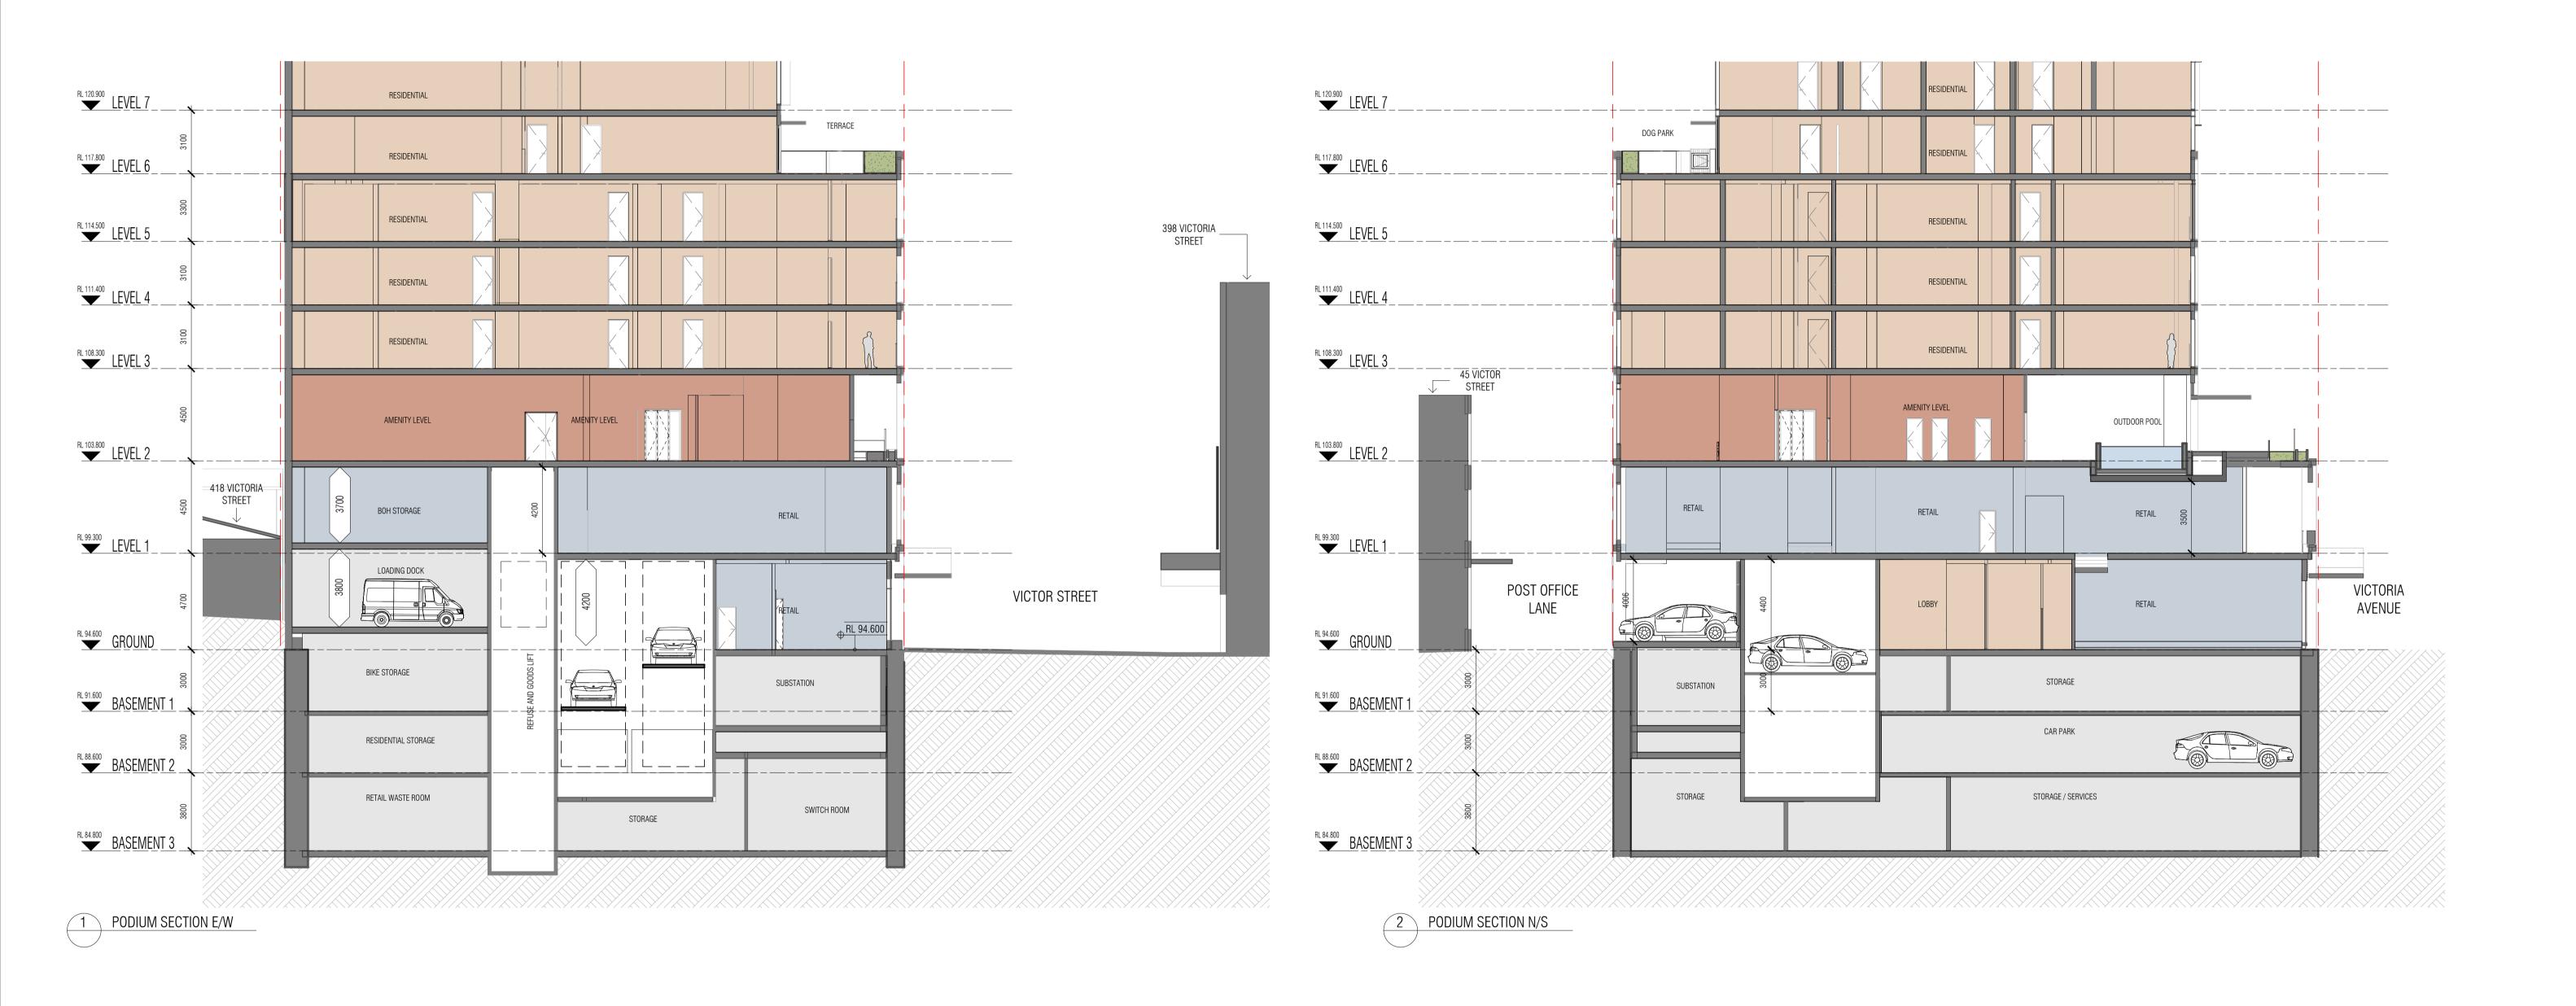

REVISION

A SSDA LODGEMENT

18.03.25

QUALITY ASSURANCE (FK IS A CERTIFIED COMPANY TO ISO 9001-2015)

THIS PROJECT IS SUBJECT TO THE FK QUALITY ASSURANCE SYSTEM

UNCONTROLLED COPY

NOTES
THIS DRAWING IS COPYRIGHT AND SHALL REMAIN THE PROPERTY OF FENDER KATSALIDIS (AUST) PTY LTD CHECK AND VERIFY ALL DIMENSIONS ON SITE PRIOR TO COMMENCING WORK. DRAWING TO BE READ IN CONJUNCTION WITH ALL OTHER CONTRACT DOCUMENTS. DO NOT SCALE DRAWINGS. USE FIGURED DIMENSIONS ONLY. SEEK CLARIFICATION OF INCONSISTENCES / CONFLICTS.

NOVUS ON VICTORIA
410-416 VICTORIA AVE CHATSWOOD

NOVUS

FENDER KATSALIDIS


WWW.FKAUSTRALIA.COM

L21, 259 GEORGE STREET, SYDNEY

NEW SOUTH WALES 2000 AUSTRALIA


TELEPHONE: +61 2 8216 3500


FENDER KATSALIDIS (AUST) PTY LTD ACN 092 943 032

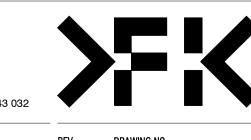



DRAWING TITLE

PODIUM SECTIONS

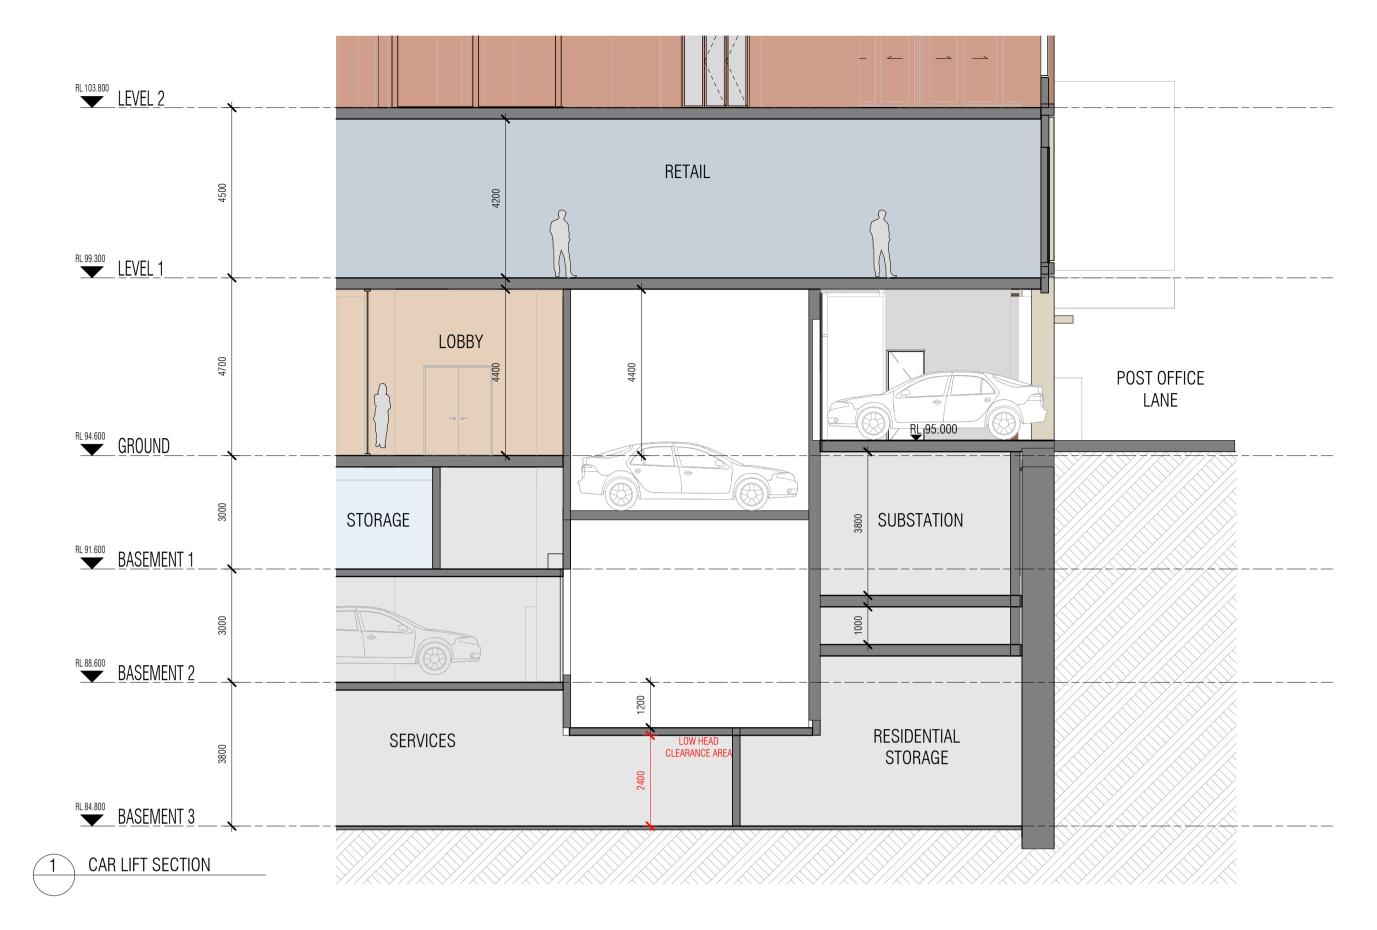

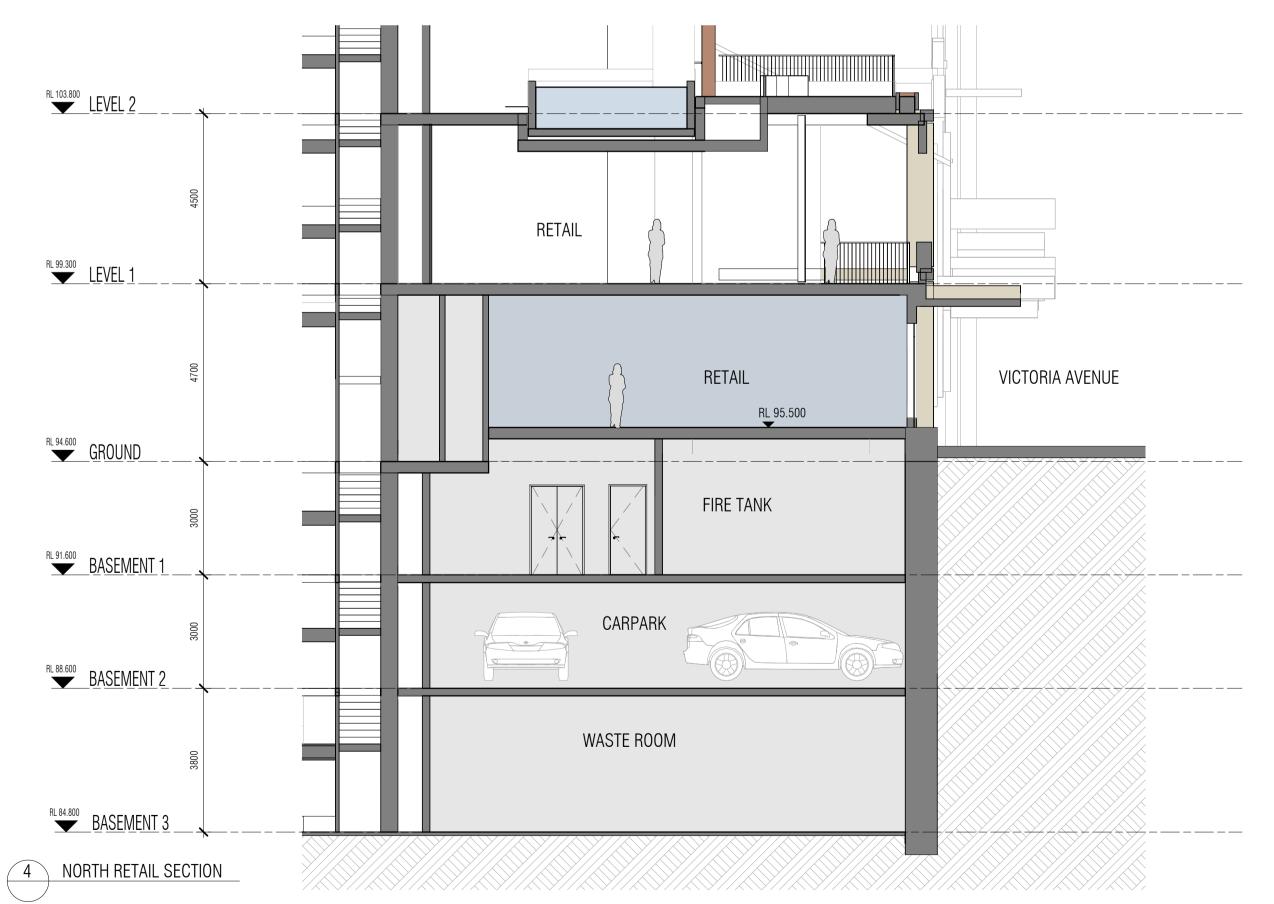

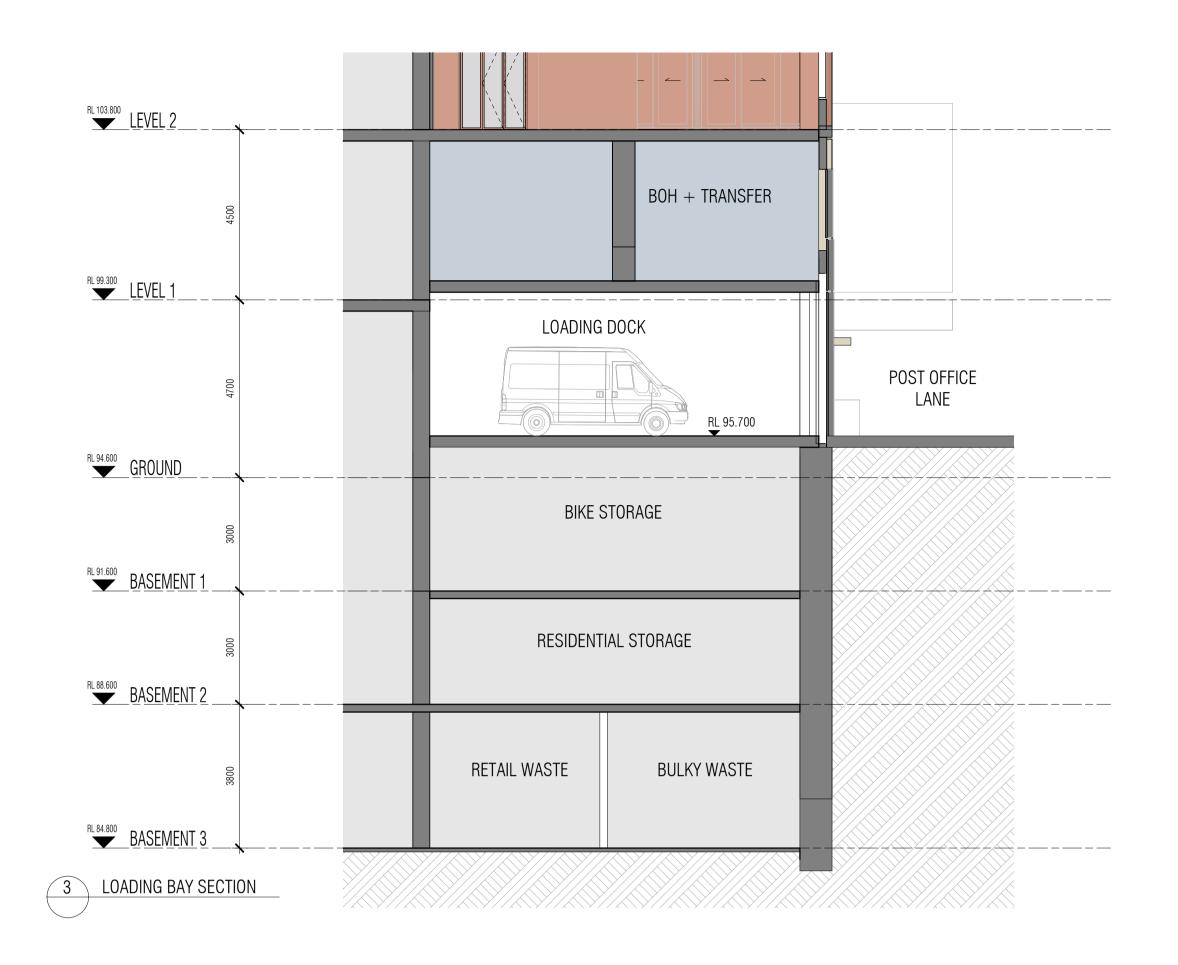

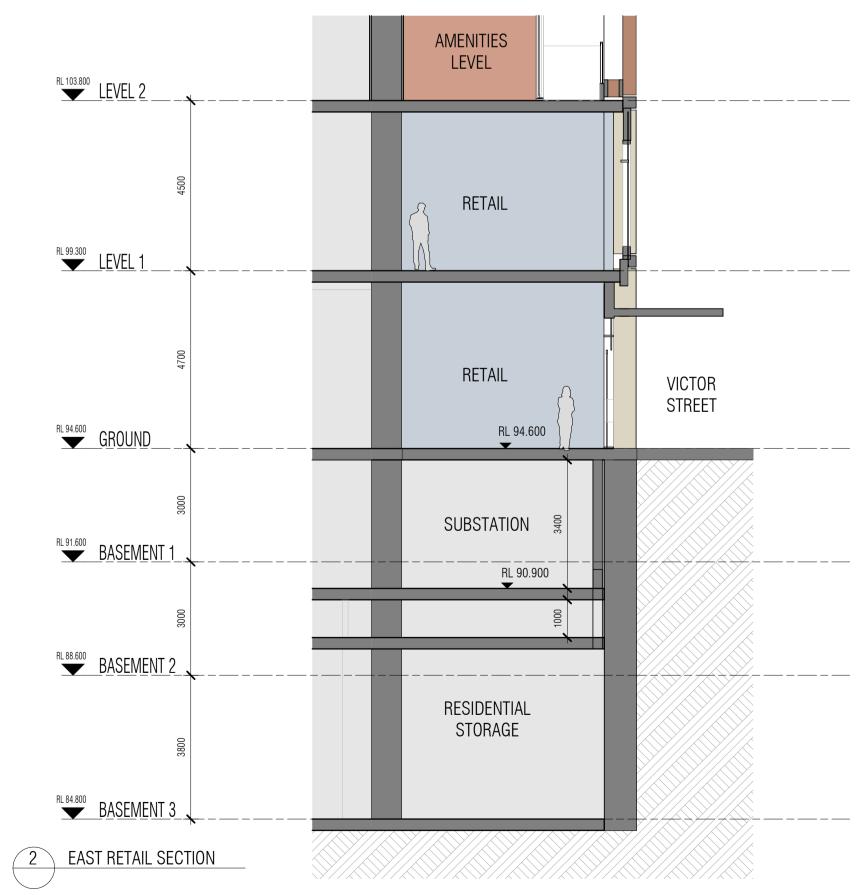

A SSDA LODGEMENT

18.03.25

QUALITY ASSURANCE (FK IS A CERTIFIED COMPANY TO ISO 9001-2015)

THIS PROJECT IS SUBJECT TO THE FK QUALITY ASSURANCE SYSTEM

THIS PROJECT IS SUBJECT TO THE FK QUALITY ASSURANCE SYSTEM

UNCONTROLLED COPY

IF THIS DRAWING IS STAMPED 'UNCONTROLLED COPY' THEN IT IS TO BE CONSIDERED A DRAFT, SUBJECT TO REVISION WITHOUT NOTICE NOT FOR CONSTRUCTION

NOTES
THIS DRAWING IS COPYRIGHT AND SHALL REMAIN THE PROPERTY OF FENDER KATSALIDIS (AUST) PTY LTD CHECK AND VERIFY ALL DIMENSIONS ON SITE PRIOR TO COMMENCING WORK. DRAWING TO BE READ IN CONJUNCTION WITH ALL OTHER CONTRACT DOCUMENTS. DO NOT SCALE DRAWINGS. USE FIGURED DIMENSIONS ONLY. SEEK CLARIFICATION OF INCONSISTENCES / CONFLICTS.

18.03.25

23115

BW/DS CB

NOVUS ON VICTORIA
410-416 VICTORIA AVE CHATSWOOD

DRAWING TITLE

1:100@A1

PODIUM SECTIONS

NOVUS

FENDER KATSALIDIS


WWW.FKAUSTRALIA.COM

L21, 259 GEORGE STREET, SYDNEY


NEW SOUTH WALES 2000 AUSTRALIA

TELEPHONE: +61 2 8216 3500

FENDER KATSALIDIS (AUST) PTY LTD ACN 092 943 032

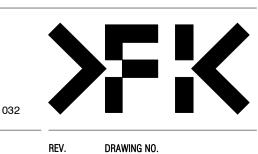



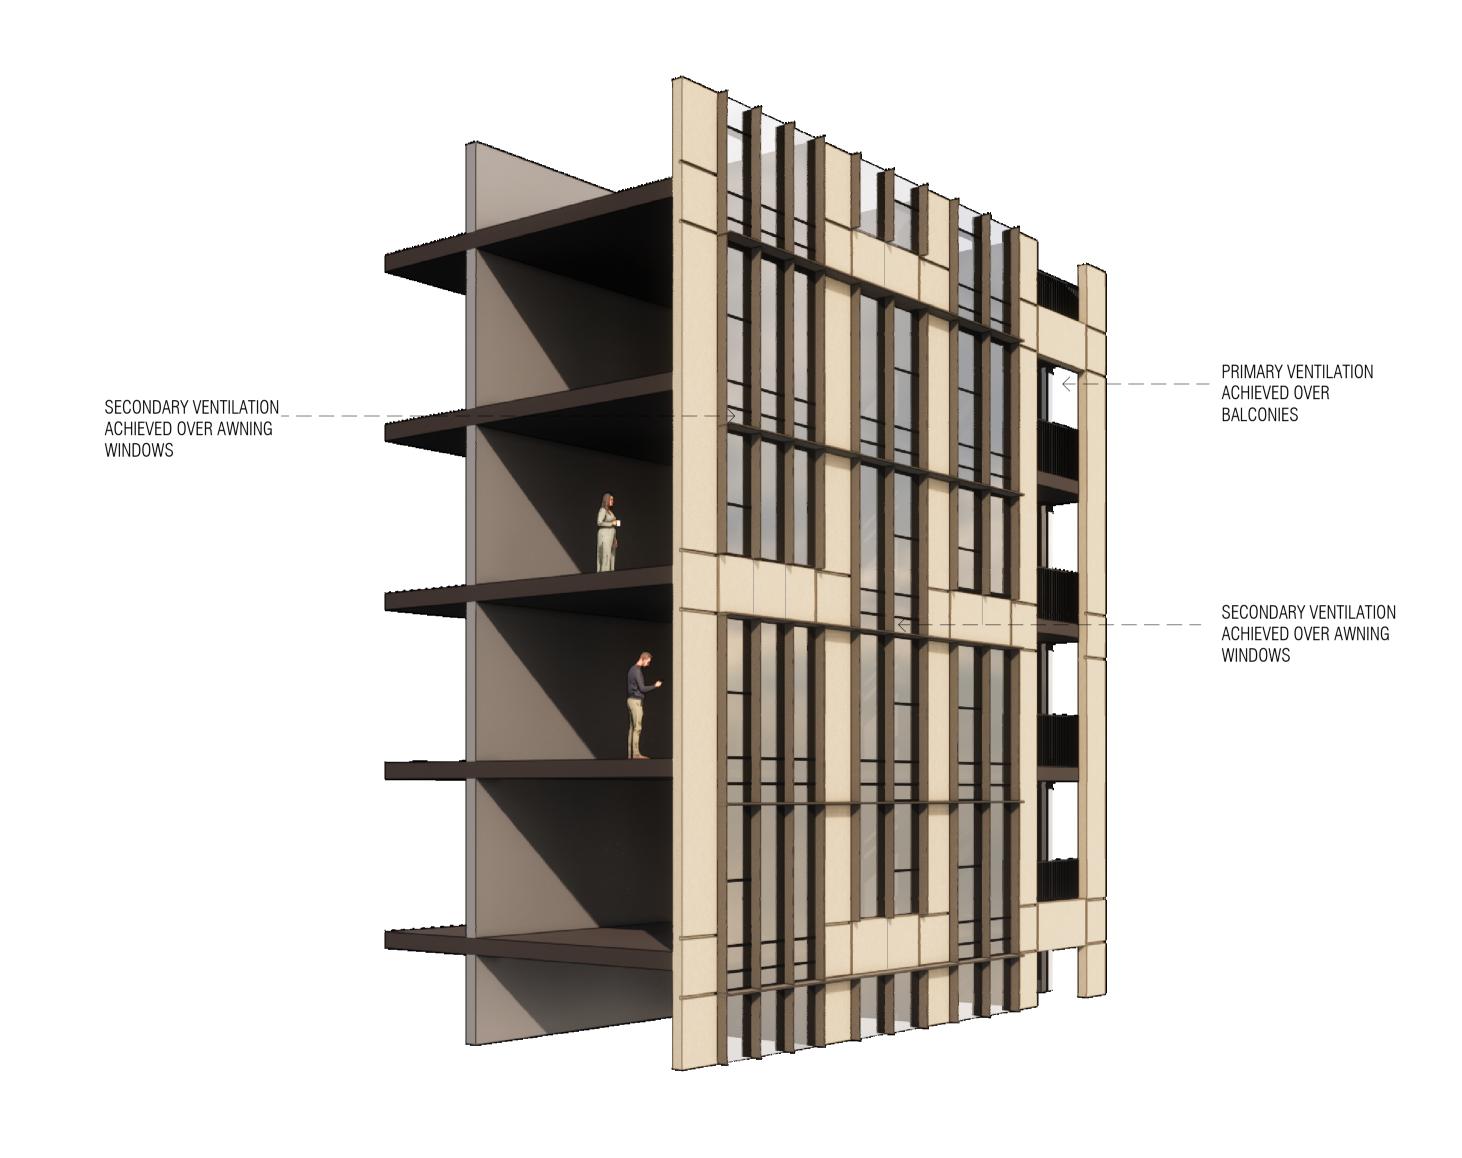

TOWER FACADE PODIUM FACADE

Autodesk Docs://23115 410-416 Victoria Avenue Chatswood/23115\_GENERAL\_R24.rvt

A SSDA LODGEMENT

18.03.25

QUALITY ASSURANCE (FK IS A CERTIFIED COMPANY TO ISO 9001-2015)

UNCONTROLLED COPY

IF THIS DRAWING IS STAMPED 'UNCONTROLLED COPY' THEN IT IS TO BE CONSIDERED A DRAFT, SUBJECT TO REVISION WITHOUT NOTICE NOT FOR CONSTRUCTION

NOTES
THIS DRAWING IS COPYRIGHT AND SHALL REMAIN THE PROPERTY OF FENDER KATSALIDIS (AUST) PTY LTD CHECK AND VERIFY ALL DIMENSIONS ON SITE PRIOR TO COMMENCING WORK. DRAWING TO BE READ IN CONJUNCTION WITH ALL OTHER CONTRACT DOCUMENTS. DO NOT SCALE DRAWINGS. USE FIGURED DIMENSIONS ONLY. SEEK CLARIFICATION OF INCONSISTENCES / CONFLICTS.

18.03.25

23115

@A1

BW/DS CB

NOVUS ON VICTORIA 410-416 VICTORIA AVE CHATSWOOD

FAÇADE STRATEGY

FENDER KATSALIDIS
WWW.FKAUSTRALIA.COM
L21, 259 GEORGE STREET, SYDNEY NEW SOUTH WALES 2000 AUSTRALIA TELEPHONE: +61 2 8216 3500 FENDER KATSALIDIS (AUST) PTY LTD ACN 092 943 032





## EXTERIOR FINISHES LEGEND

- (AW01) METAL AWNING, CHARCOAL GREY COLOUR
- Aw02 METAL AWNING, BEIGE COLOUR
- METAL PALISADE BALUSTRADE, CHARCOAL GREY COLOUR
- Cf01 PIGMENTED PRECAST PANEL, WARM GREY COLOUR
- Cf02 CEMENTITOUS PANEL, BROWN COLOUR
- CEMENTIOUS PRECAST PANEL, DARK BROWN COLOUR
- Cf04 LIGHT-COLOURED CONCRETE FINISH
- ©105 BEIGE-COLOURED CONCRETE FINISH

18.03.25

- GO1 SILVER COLOUR VISION GLASS
- G02 CLEAR GLASS
- G03 COLOURBACK GLASS
- (L01) METALLIC LOVRES, LIGHT BEIGE COLOUR
- METALLIC LOVRES, CHARCOAL COLOUR
- (LO3) METALLIC LOVRES, DARK BRONZE
- MO1 METAL CLADDING, DARK BEIGE COLOUR
- MO2 DARK BRONZE ROLLER SHUTTER WITH VERTICAL FINS

Autodesk Docs://23115 410-416 Victoria Avenue Chatswood/23115\_GENERAL\_R24.rvt

A SSDA LODGEMENT

**QUALITY ASSURANCE** (FK IS A CERTIFIED COMPANY TO ISO 9001-2015)

UNCONTROLLED COPY

IF THIS DRAWING IS STAMPED 'UNCONTROLLED COPY' THEN IT IS TO BE CONSIDERED A DRAFT, SUBJECT TO REVISION WITHOUT NOTICE NOT FOR CONSTRUCTION

NOTES
THIS DRAWING IS COPYRIGHT AND SHALL REMAIN THE PROPERTY OF FENDER KATSALIDIS (AUST) PTY LTD CHECK AND VERIFY ALL DIMENSIONS ON SITE PRIOR TO COMMENCING WORK. DRAWING TO BE READ IN CONJUNCTION WITH ALL OTHER CONTRACT DOCUMENTS. DO NOT SCALE DRAWINGS. USE FIGURED DIMENSIONS ONLY. SEEK CLARIFICATION OF INCONSISTENCES / CONFLICTS.

NOVUS ON VICTORIA 410-416 VICTORIA AVE CHATSWOOD

FENDER KATSALIDIS
WWW.FKAUSTRALIA.COM
L21, 259 GEORGE STREET, SYDNEY NEW SOUTH WALES 2000 AUSTRALIA TELEPHONE: +61 2 8216 3500

FENDER KATSALIDIS (AUST) PTY LTD ACN 092 943 032



A SSDA LODGEMENT

18.03.25

**QUALITY ASSURANCE** (FK IS A CERTIFIED COMPANY TO ISO 9001-2015)

UNCONTROLLED COPY

IF THIS DRAWING IS STAMPED 'UNCONTROLLED COPY' THEN IT IS TO BE CONSIDERED A DRAFT, SUBJECT TO REVISION WITHOUT NOTICE NOTICE

NOTES
THIS DRAWING IS COPYRIGHT AND SHALL REMAIN THE PROPERTY OF FENDER KATSALIDIS (AUST) PTY LTD CHECK AND VERIFY ALL DIMENSIONS ON SITE PRIOR TO COMMENCING WORK. DRAWING TO BE READ IN CONJUNCTION WITH ALL OTHER CONTRACT DOCUMENTS. DO NOT SCALE DRAWINGS. USE FIGURED DIMENSIONS ONLY. SEEK CLARIFICATION OF INCONSISTENCES / CONFLICTS.

NOVUS ON VICTORIA 410-416 VICTORIA AVE CHATSWOOD

DRAWING TITLE

RENDERS

FENDER KATSALIDIS


WWW.FKAUSTRALIA.COM

L21, 259 GEORGE STREET, SYDNEY

NEW SOUTH WALES 2000 AUSTRALIA

TELEPHONE: +61 2 8216 3500

FENDER KATSALIDIS (AUST) PTY LTD ACN 092 943 032

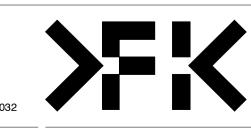



A SSDA LODGEMENT

18.03.25

**QUALITY ASSURANCE** (FK IS A CERTIFIED COMPANY TO ISO 9001-2015)

UNCONTROLLED COPY

IF THIS DRAWING IS STAMPED 'UNCONTROLLED COPY' THEN IT IS TO BE CONSIDERED A DRAFT, SUBJECT TO REVISION WITHOUT NOTICE NOT FOR CONSTRUCTION

NOTES
THIS DRAWING IS COPYRIGHT AND SHALL REMAIN THE PROPERTY OF FENDER KATSALIDIS (AUST) PTY LTD CHECK AND VERIFY ALL DIMENSIONS ON SITE PRIOR TO COMMENCING WORK. DRAWING TO BE READ IN CONJUNCTION WITH ALL OTHER CONTRACT DOCUMENTS. DO NOT SCALE DRAWINGS. USE FIGURED DIMENSIONS ONLY. SEEK CLARIFICATION OF INCONSISTENCES / CONFLICTS.

18.03.25

410-416 VICTORIA AVE CHATSWOOD


NOVUS ON VICTORIA

DRAWING TITLE

RENDERS

NOVUS

FENDER KATSALIDIS
WWW.FKAUSTRALIA.COM
L21, 259 GEORGE STREET, SYDNEY
NEW SOUTH WALES 2000 AUSTRALIA TELEPHONE: +61 2 8216 3500 FENDER KATSALIDIS (AUST) PTY LTD ACN 092 943 032

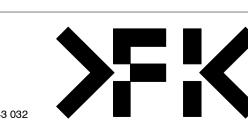





A SSDA LODGEMENT

QUALITY ASSURANCE (FK IS A CERTIFIED COMPANY TO ISO 9001-2015)

THIS PROJECT IS SUBJECT TO THE FK QUALITY ASSURANCE SYSTEM

UNCONTROLLED COPY

IF THIS DRAWING IS STAMPED 'UNCONTROLLED COPY' THEN IT IS TO BE CONSIDERED A DRAFT, SUBJECT TO REVISION WITHOUT NOTICE NOT FOR CONSTRUCTION

NOTES
THIS DRAWING IS COPYRIGHT AND SHALL REMAIN THE PROPERTY OF FENDER KATSALIDIS (AUST) PTY LTD CHECK AND VERIFY ALL DIMENSIONS ON SITE PRIOR TO COMMENCING WORK. DRAWING TO BE READ IN CONJUNCTION WITH ALL OTHER CONTRACT DOCUMENTS. DO NOT SCALE DRAWINGS. USE FIGURED DIMENSIONS ONLY. SEEK CLARIFICATION OF INCONSISTENCES / CONFLICTS.

18.03.25


NOVUS ON VICTORIA


DRAWING TITLE


RENDERS

410-416 VICTORIA AVE CHATSWOOD

FENDER KATSALIDIS
WWW.FKAUSTRALIA.COM
L21, 259 GEORGE STREET, SYDNEY
NEW SOUTH WALES 2000 AUSTRALIA TELEPHONE: +61 2 8216 3500

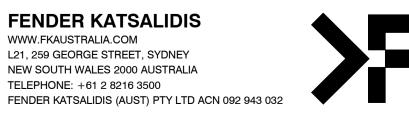

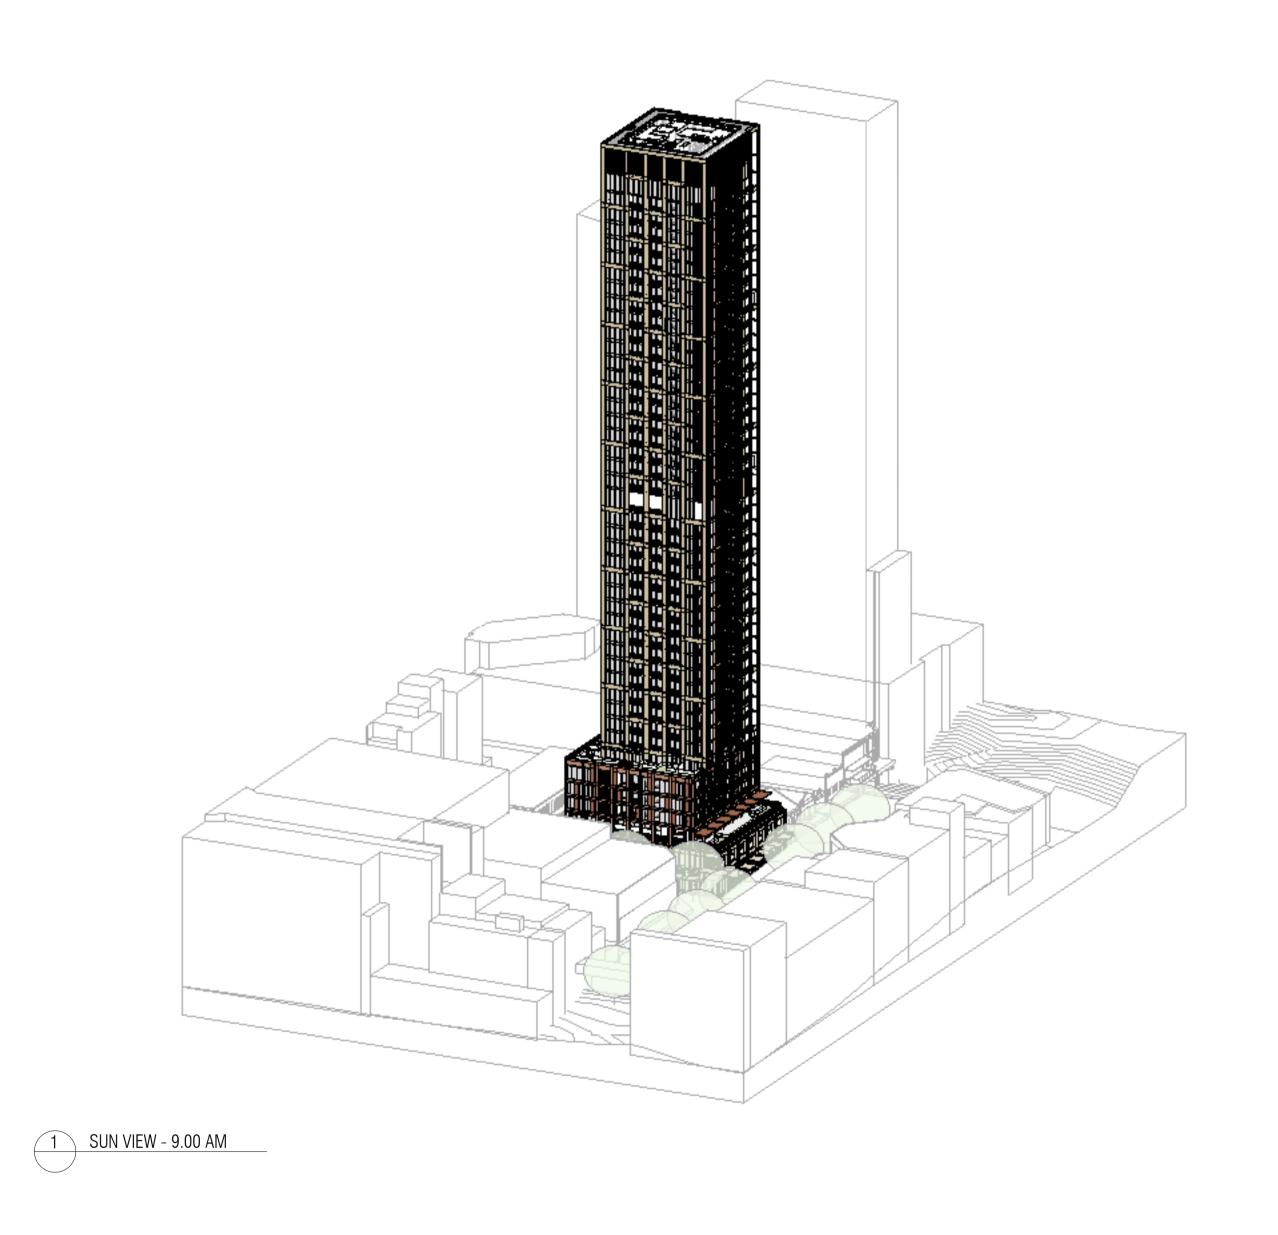

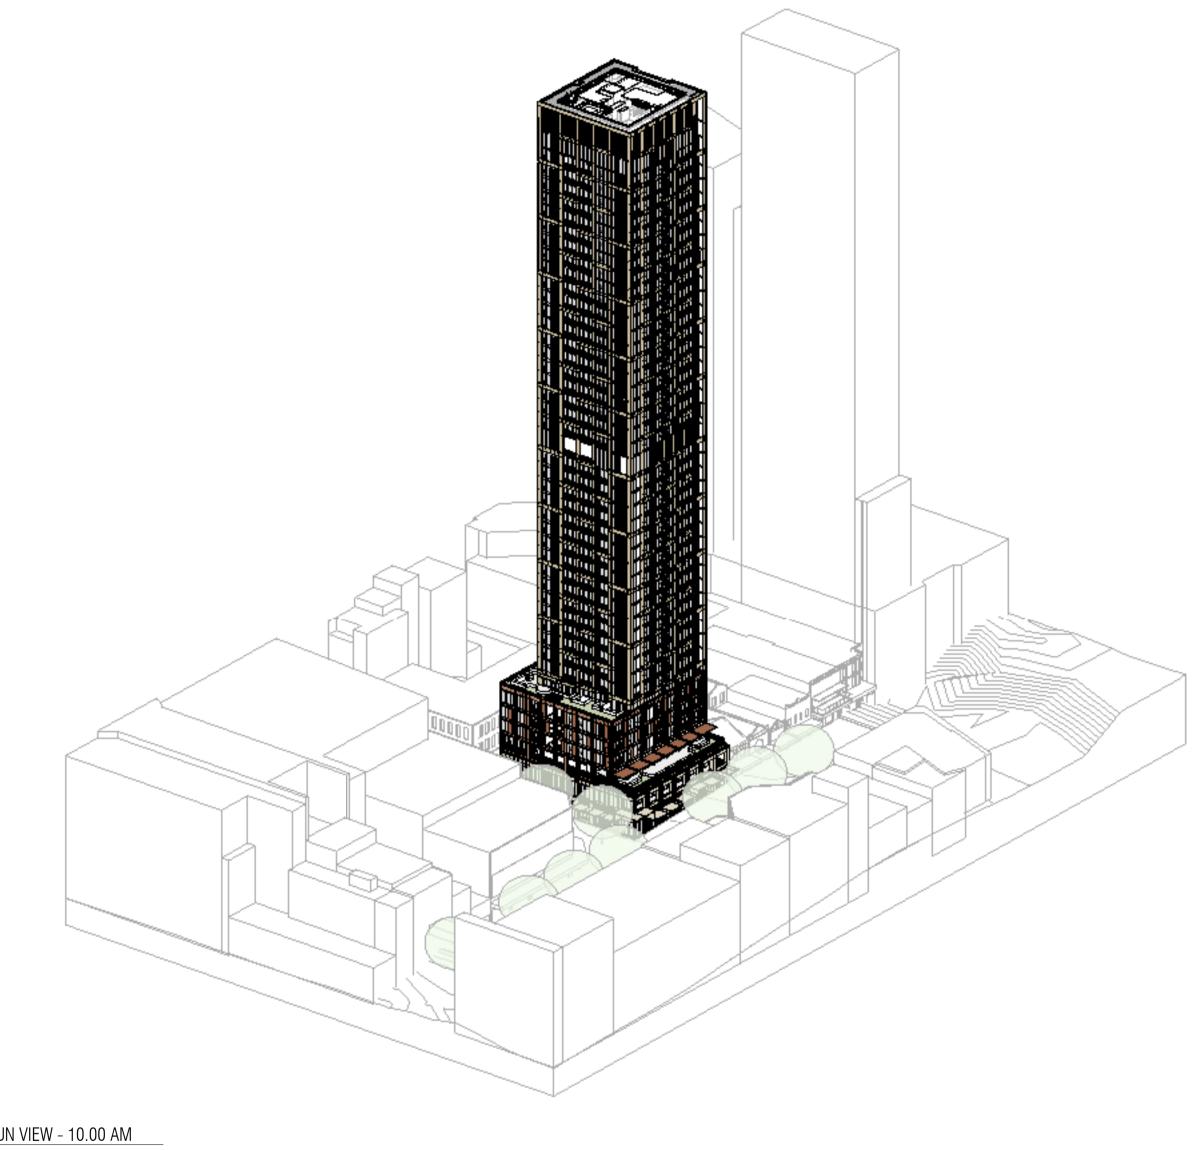

2 SUN VIEW - 10.00 AM

Autodesk Docs://23115 410-416 Victoria Avenue Chatswood/23115\_GENERAL\_R24.rvt

A SSDA LODGEMENT

18.03.25

QUALITY ASSURANCE (FK IS A CERTIFIED COMPANY TO ISO 9001-2015)

THIS PROJECT IS SUBJECT TO THE FK QUALITY ASSURANCE SYSTEM UNCONTROLLED COPY

IF THIS DRAWING IS STAMPED 'UNCONTROLLED COPY' THEN IT IS TO BE CONSIDERED A DRAFT, SUBJECT TO REVISION WITHOUT NOTICE NOT FOR CONSTRUCTION

NOTES
THIS DRAWING IS COPYRIGHT AND SHALL REMAIN THE PROPERTY OF FENDER KATSALIDIS (AUST) PTY LTD CHECK AND VERIFY ALL DIMENSIONS ON SITE PRIOR TO COMMENCING WORK. DRAWING TO BE READ IN CONJUNCTION WITH ALL OTHER CONTRACT DOCUMENTS. DO NOT SCALE DRAWINGS. USE FIGURED DIMENSIONS ONLY. SEEK CLARIFICATION OF INCONSISTENCES / CONFLICTS.

18.03.25


23115


NOVUS ON VICTORIA 410-416 VICTORIA AVE CHATSWOOD


DRAWING TITLE

VIEWS FROM THE SUN

FENDER KATSALIDIS
WWW.FKAUSTRALIA.COM
L21, 259 GEORGE STREET, SYDNEY
NEW SOUTH WALES 2000 AUSTRALIA TELEPHONE: +61 2 8216 3500 FENDER KATSALIDIS (AUST) PTY LTD ACN 092 943 032

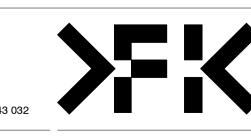

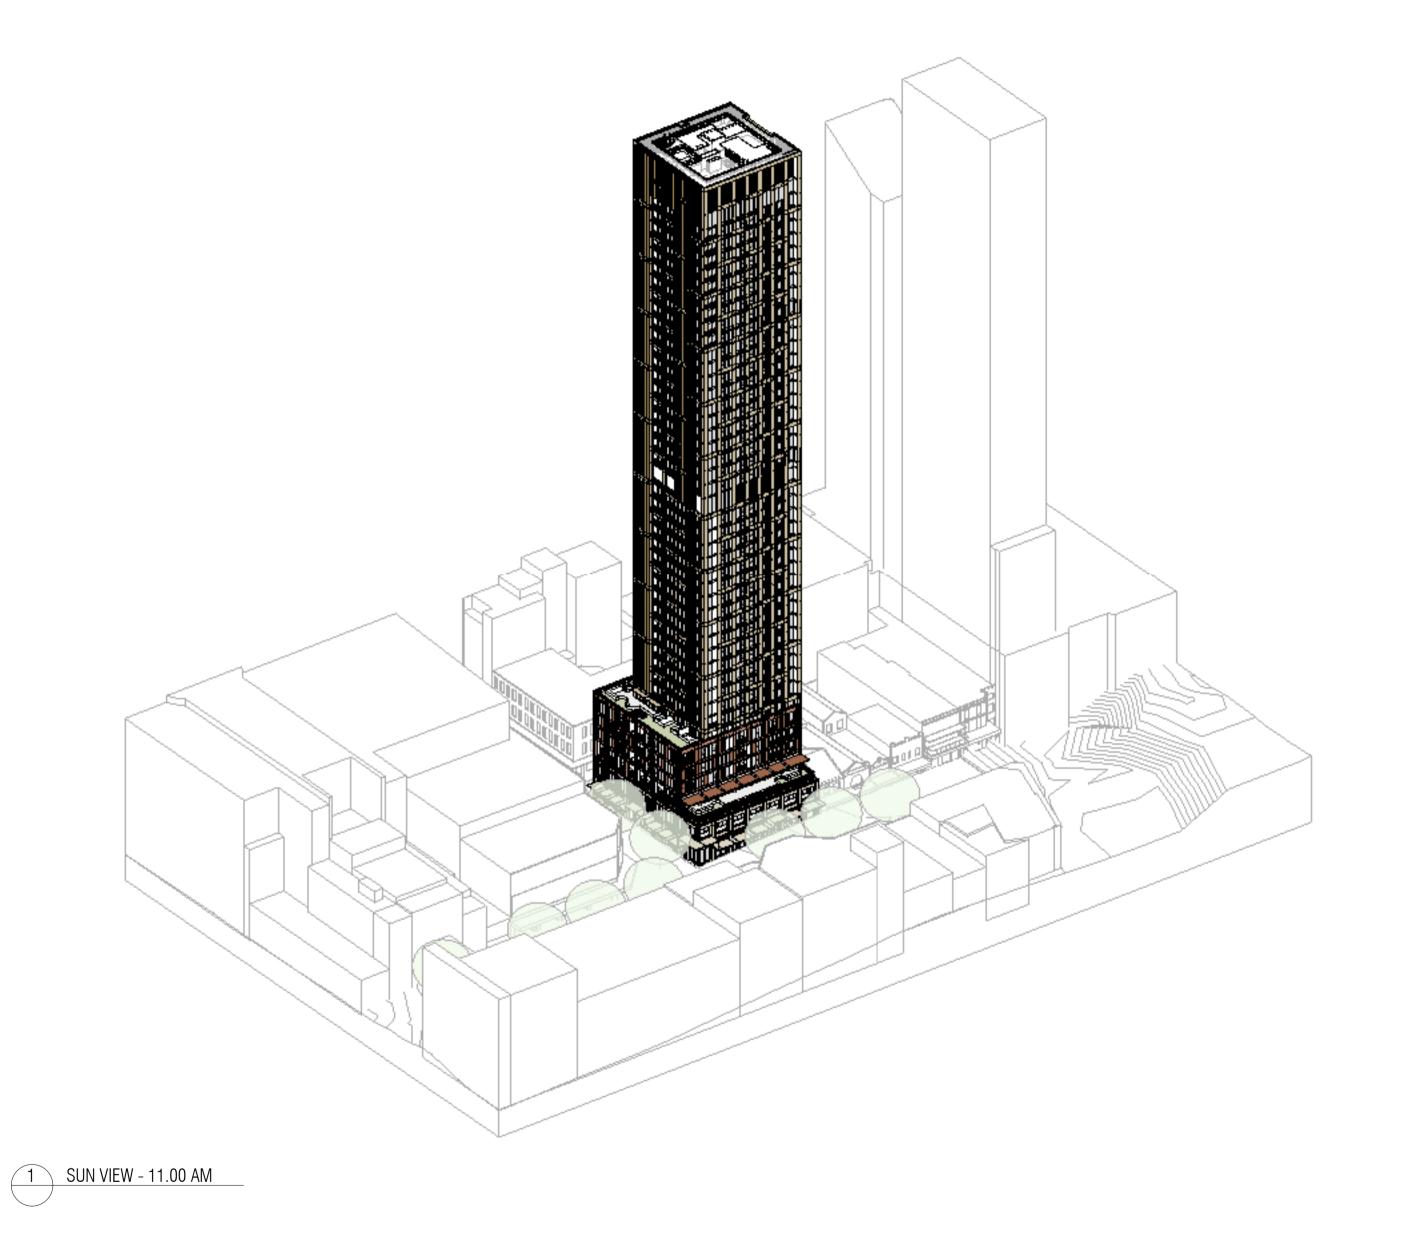

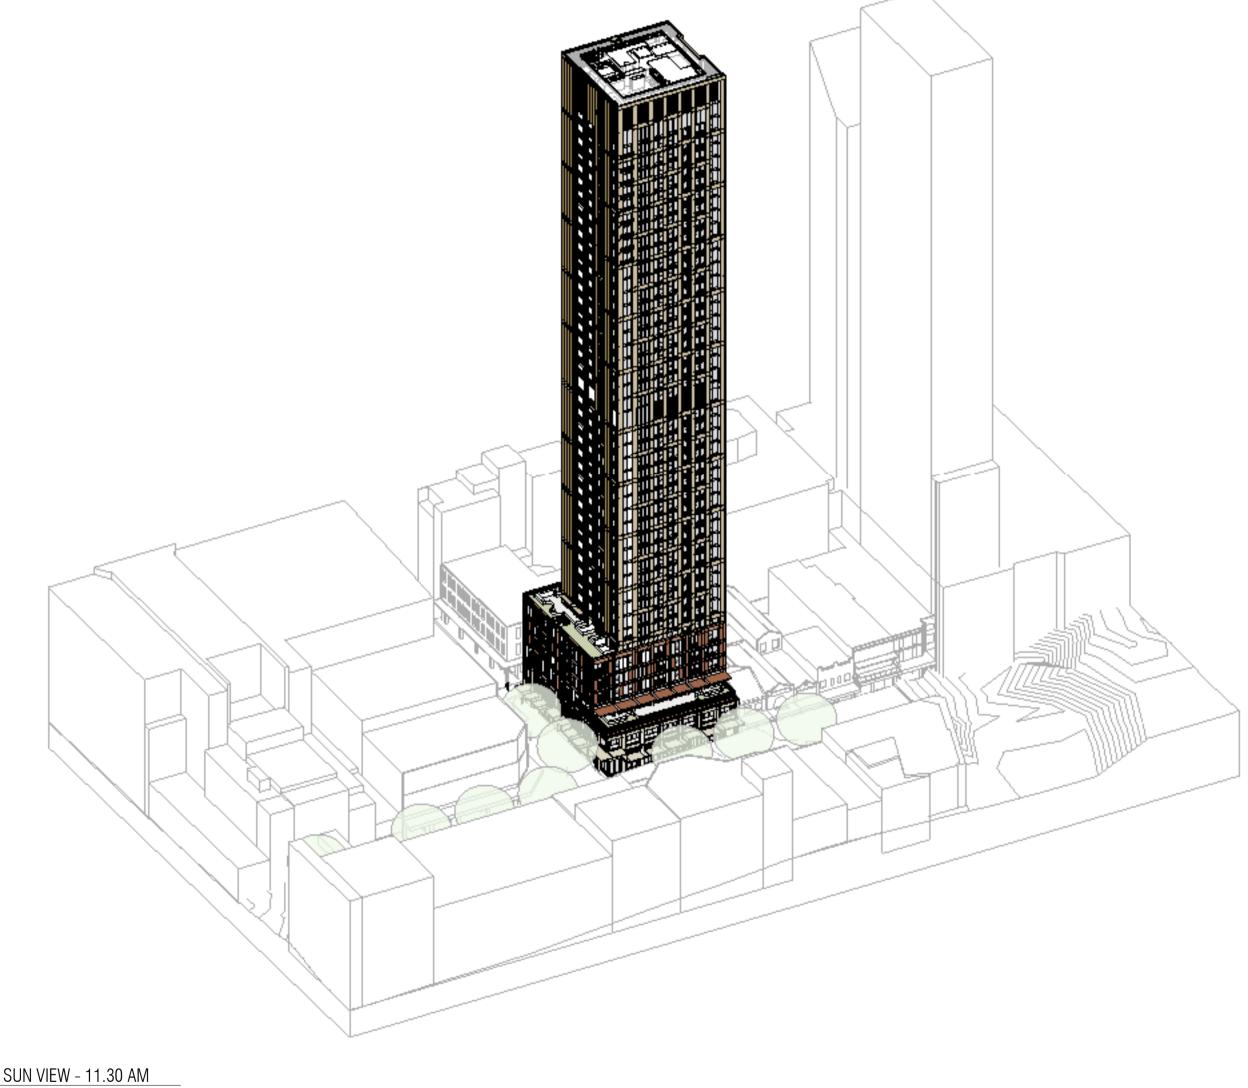

2 SUN VIEW - 11.30 AM

Autodesk Docs://23115 410-416 Victoria Avenue Chatswood/23115\_GENERAL\_R24.rvt

A SSDA LODGEMENT

18.03.25

QUALITY ASSURANCE (FK IS A CERTIFIED COMPANY TO ISO 9001-2015)


THIS PROJECT IS SUBJECT TO THE FK QUALITY ASSURANCE SYSTEM UNCONTROLLED COPY

IF THIS DRAWING IS STAMPED 'UNCONTROLLED COPY' THEN IT IS TO BE CONSIDERED A DRAFT, SUBJECT TO REVISION WITHOUT NOTICE NOT FOR CONSTRUCTION


NOTES
THIS DRAWING IS COPYRIGHT AND SHALL REMAIN THE PROPERTY OF FENDER KATSALIDIS (AUST) PTY LTD CHECK AND VERIFY ALL DIMENSIONS ON SITE PRIOR TO COMMENCING WORK. DRAWING TO BE READ IN CONJUNCTION WITH ALL OTHER CONTRACT DOCUMENTS. DO NOT SCALE DRAWINGS. USE FIGURED DIMENSIONS ONLY. SEEK CLARIFICATION OF INCONSISTENCES / CONFLICTS.

NOVUS ON VICTORIA 410-416 VICTORIA AVE CHATSWOOD

FENDER KATSALIDIS
WWW.FKAUSTRALIA.COM
L21, 259 GEORGE STREET, SYDNEY
NEW SOUTH WALES 2000 AUSTRALIA TELEPHONE: +61 2 8216 3500 FENDER KATSALIDIS (AUST) PTY LTD ACN 092 943 032

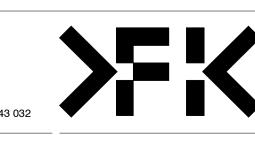

DRAWING TITLE 18.03.25 VIEWS FROM THE SUN

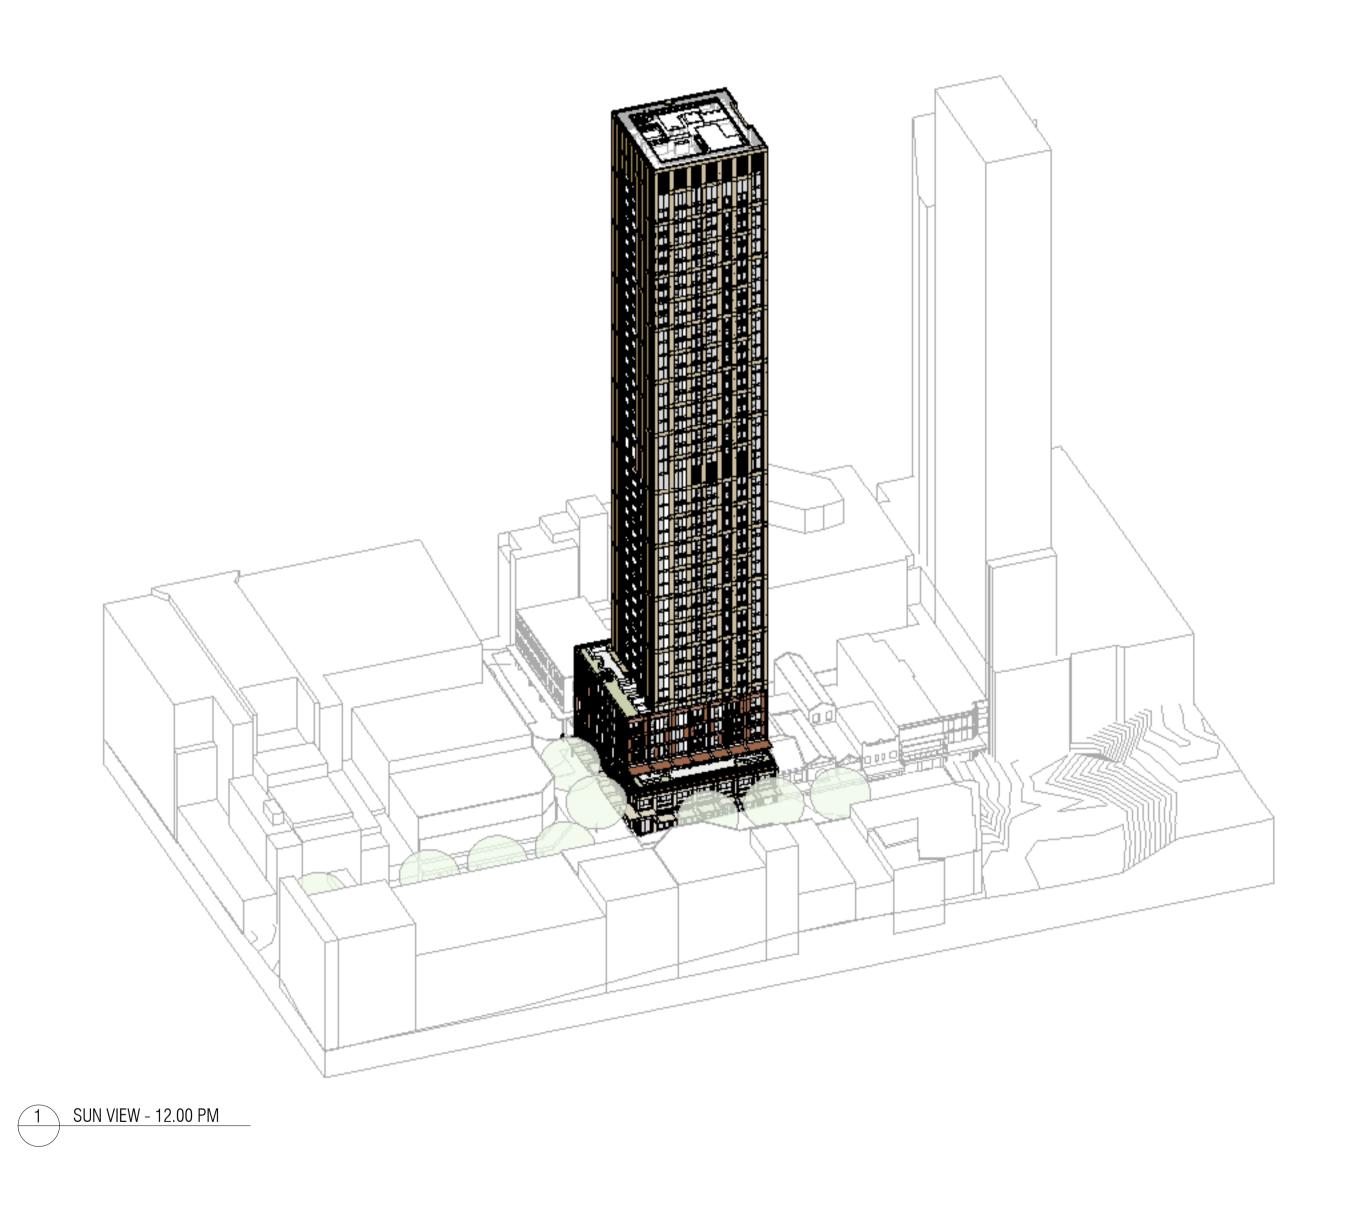



REVISION

A SSDA LODGEMENT

18.03.25

QUALITY ASSURANCE (FK IS A CERTIFIED COMPANY TO ISO 9001-2015)

THIS PROJECT IS SUBJECT TO THE FK QUALITY ASSURANCE SYSTEM

UNCONTROLLED COPY

IF THIS DRAWING IS STAMPED 'UNCONTROLLED COPY' THEN IT IS TO BE CONSIDERED A DRAFT, SUBJECT TO REVISION WITHOUT NOTICE NOT FOR CONSTRUCTION

NOTES
THIS DRAWING IS COPYRIGHT AND SHALL REMAIN THE PROPERTY OF FENDER KATSALIDIS (AUST) PTY LTD CHECK AND VERIFY ALL DIMENSIONS ON SITE PRIOR TO COMMENCING WORK. DRAWING TO BE READ IN CONJUNCTION WITH ALL OTHER CONTRACT DOCUMENTS. DO NOT SCALE DRAWINGS. USE FIGURED DIMENSIONS ONLY. SEEK CLARIFICATION OF INCONSISTENCES / CONFLICTS.

NOVUS ON VICTORIA
410-416 VICTORIA AVE CHATSWOOD

NOVUS

FENDER KATSALIDIS


WWW.FKAUSTRALIA.COM

L21, 259 GEORGE STREET, SYDNEY


NEW SOUTH WALES 2000 AUSTRALIA

TELEPHONE: +61 2 8216 3500

FENDER KATSALIDIS (AUST) PTY LTD ACN 092 943 032

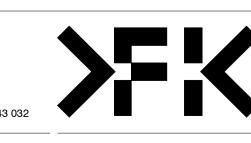

cked date job no. scale drawing title 3 18.03.25 23115 @A1 VIEWS FROM THE SUN

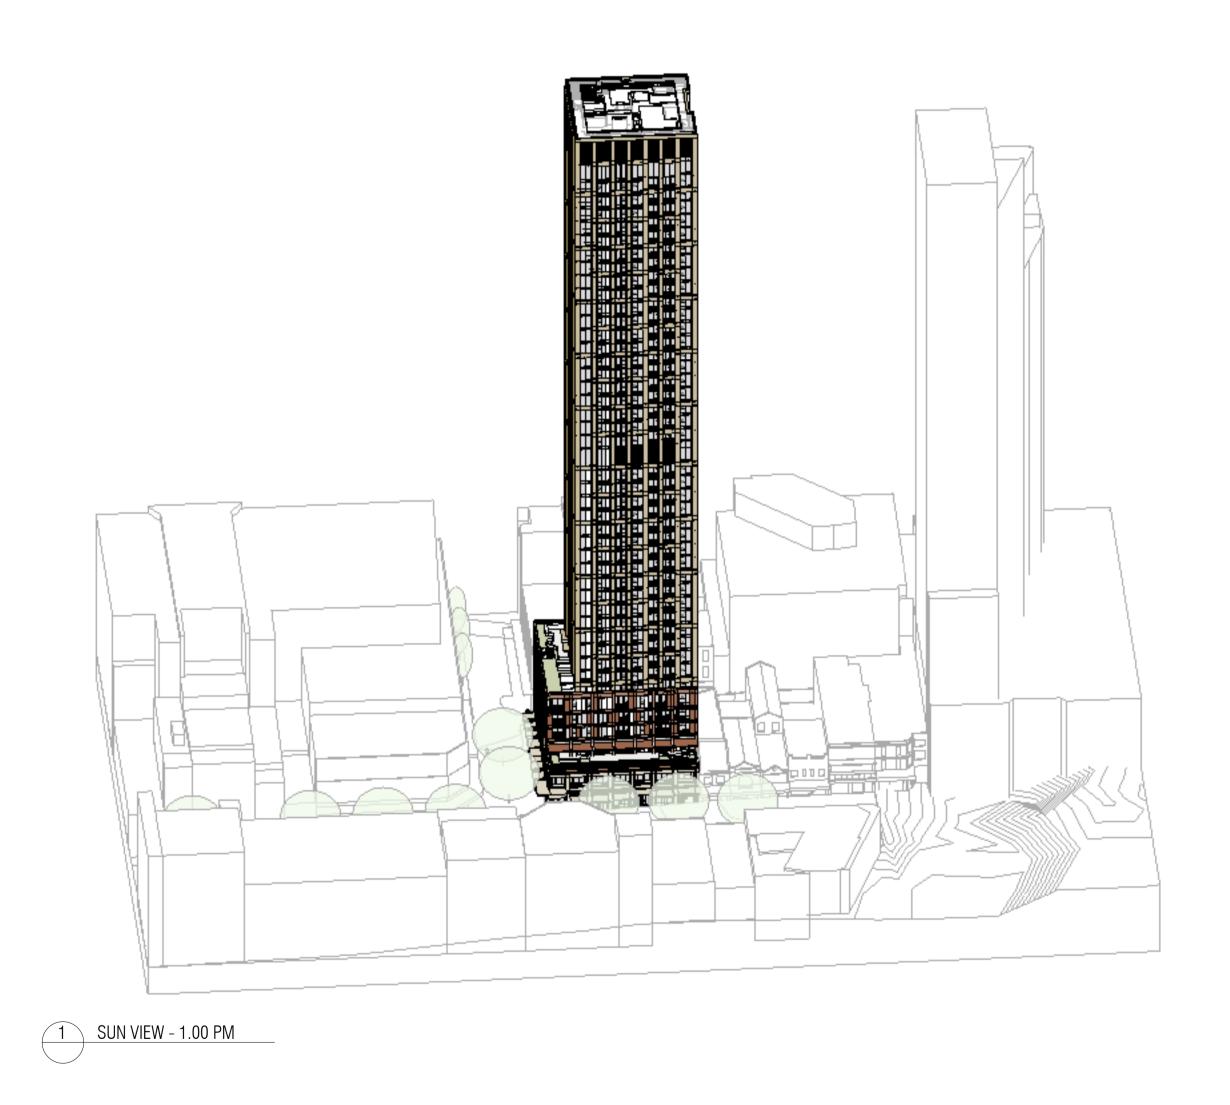



A SSDA LODGEMENT

18.03.25

**QUALITY ASSURANCE** (FK IS A CERTIFIED COMPANY TO ISO 9001-2015)

THIS PROJECT IS SUBJECT TO THE FK QUALITY ASSURANCE SYSTEM UNCONTROLLED COPY

IF THIS DRAWING IS STAMPED 'UNCONTROLLED COPY' THEN IT IS TO BE CONSIDERED A DRAFT, SUBJECT TO REVISION WITHOUT NOTICE NOT FOR CONSTRUCTION

NOTES
THIS DRAWING IS COPYRIGHT AND SHALL REMAIN THE PROPERTY OF FENDER KATSALIDIS (AUST) PTY LTD CHECK AND VERIFY ALL DIMENSIONS ON SITE PRIOR TO COMMENCING WORK. DRAWING TO BE READ IN CONJUNCTION WITH ALL OTHER CONTRACT DOCUMENTS. DO NOT SCALE DRAWINGS. USE FIGURED DIMENSIONS ONLY. SEEK CLARIFICATION OF INCONSISTENCES / CONFLICTS.

18.03.25

@A1


23115


NOVUS ON VICTORIA 410-416 VICTORIA AVE CHATSWOOD


DRAWING TITLE

VIEWS FROM THE SUN

FENDER KATSALIDIS
WWW.FKAUSTRALIA.COM
L21, 259 GEORGE STREET, SYDNEY
NEW SOUTH WALES 2000 AUSTRALIA TELEPHONE: +61 2 8216 3500 FENDER KATSALIDIS (AUST) PTY LTD ACN 092 943 032

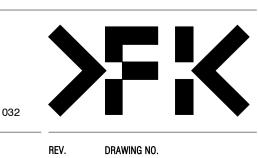

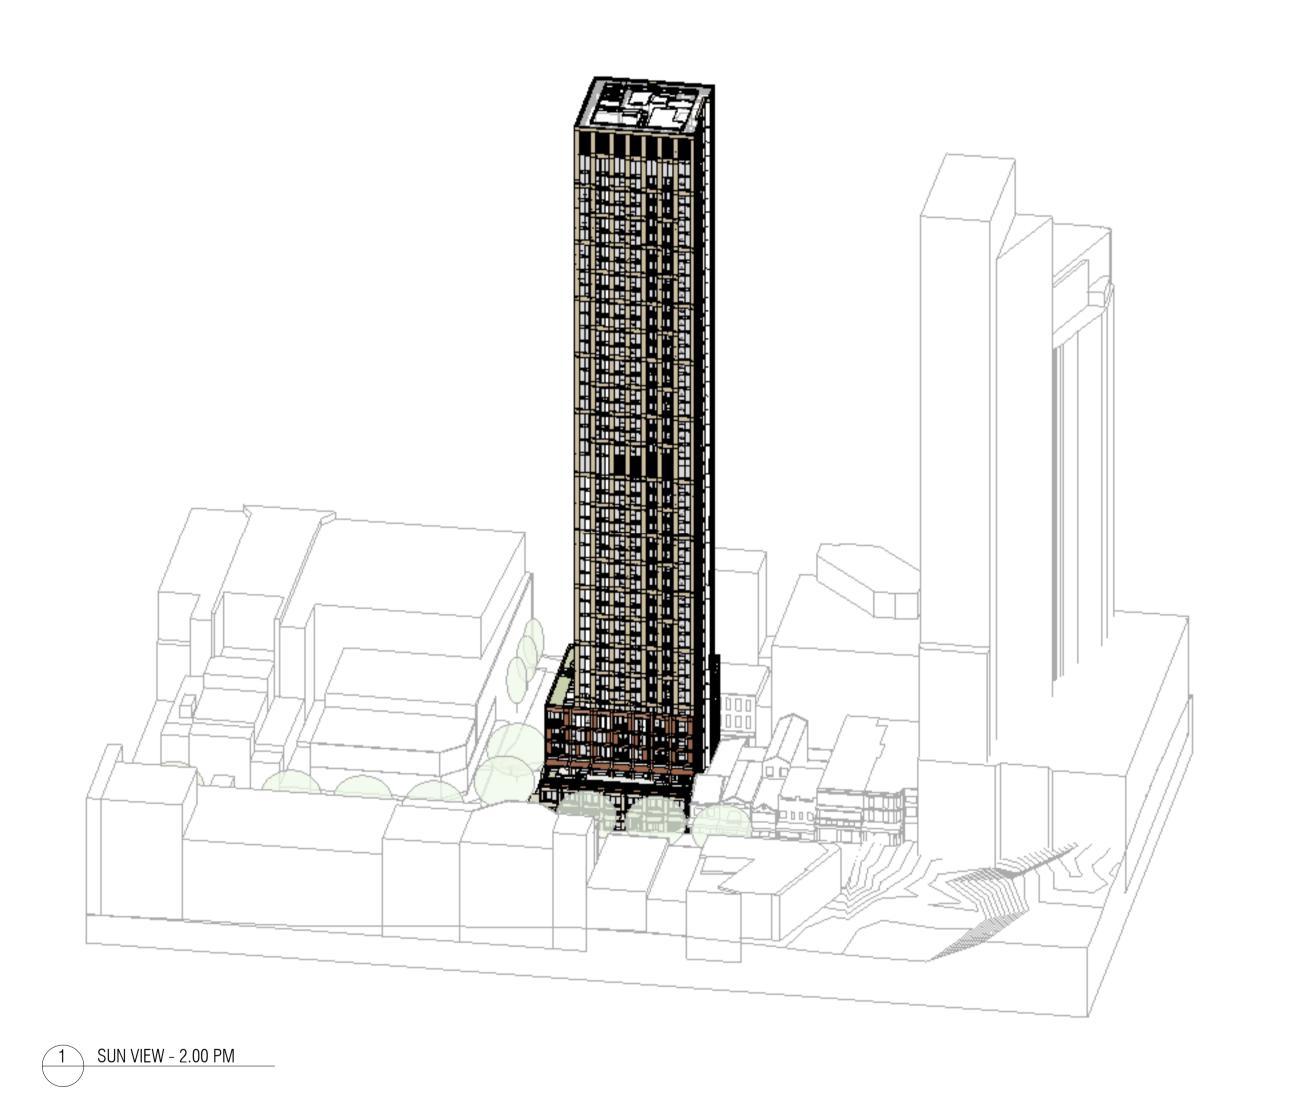

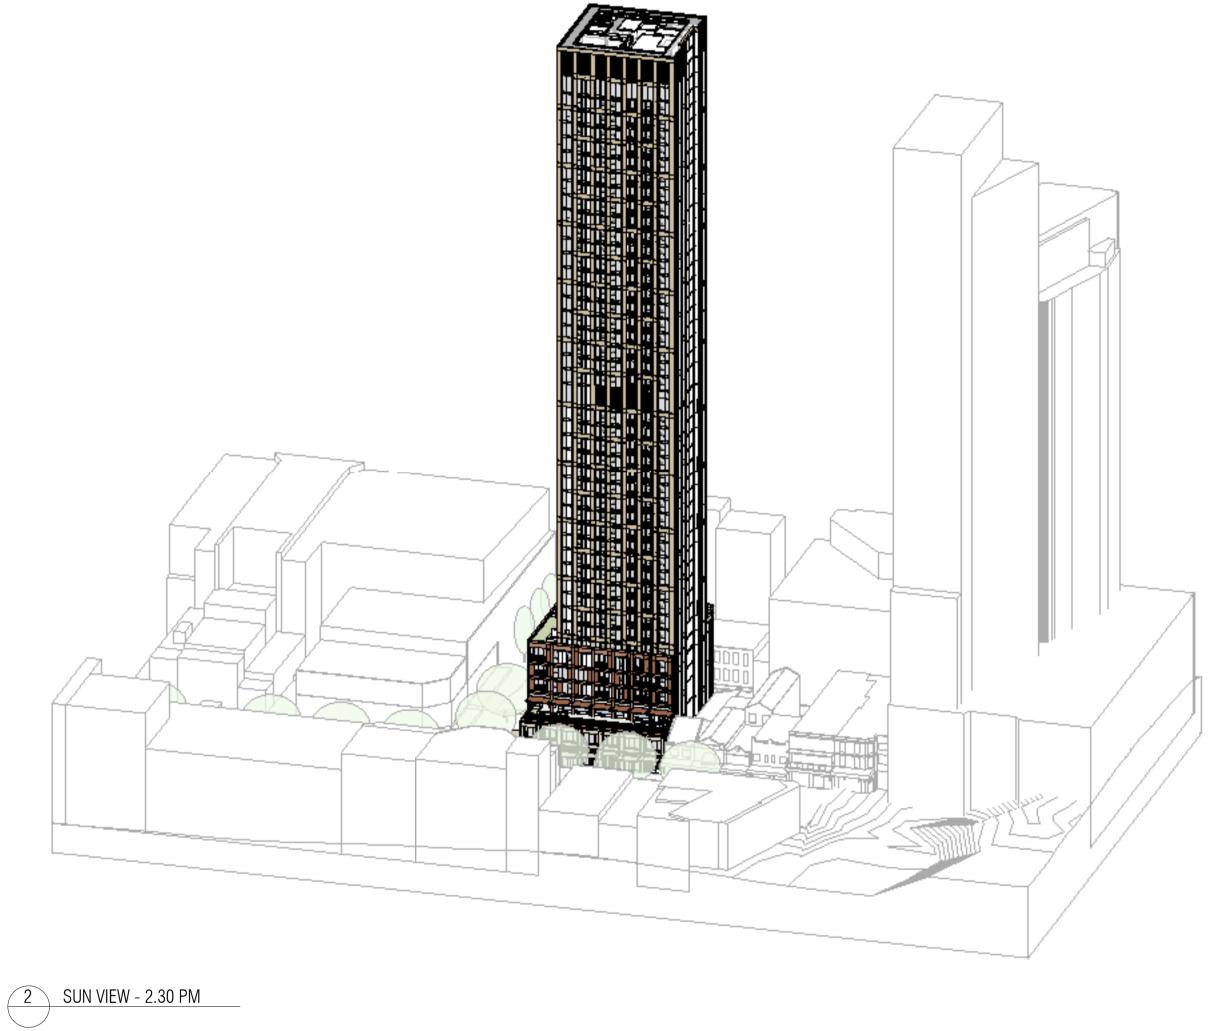

23115

Autodesk Docs://23115 410-416 Victoria Avenue Chatswood/23115\_GENERAL\_R24.rvt

A SSDA LODGEMENT

18.03.25

QUALITY ASSURANCE (FK IS A CERTIFIED COMPANY TO ISO 9001-2015)

THIS PROJECT IS SUBJECT TO THE FK QUALITY ASSURANCE SYSTEM UNCONTROLLED COPY

IF THIS DRAWING IS STAMPED 'UNCONTROLLED COPY' THEN IT IS TO BE CONSIDERED A DRAFT, SUBJECT TO REVISION WITHOUT NOTICE NOT FOR CONSTRUCTION

NOTES
THIS DRAWING IS COPYRIGHT AND SHALL REMAIN THE PROPERTY OF FENDER KATSALIDIS (AUST) PTY LTD CHECK AND VERIFY ALL DIMENSIONS ON SITE PRIOR TO COMMENCING WORK. DRAWING TO BE READ IN CONJUNCTION WITH ALL OTHER CONTRACT DOCUMENTS. DO NOT SCALE DRAWINGS. USE FIGURED DIMENSIONS ONLY. SEEK CLARIFICATION OF INCONSISTENCES / CONFLICTS.

18.03.25


@A1


NOVUS ON VICTORIA 410-416 VICTORIA AVE CHATSWOOD

DRAWING TITLE

VIEWS FROM THE SUN

FENDER KATSALIDIS
WWW.FKAUSTRALIA.COM
L21, 259 GEORGE STREET, SYDNEY
NEW SOUTH WALES 2000 AUSTRALIA TELEPHONE: +61 2 8216 3500 FENDER KATSALIDIS (AUST) PTY LTD ACN 092 943 032

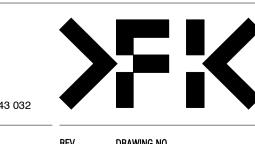

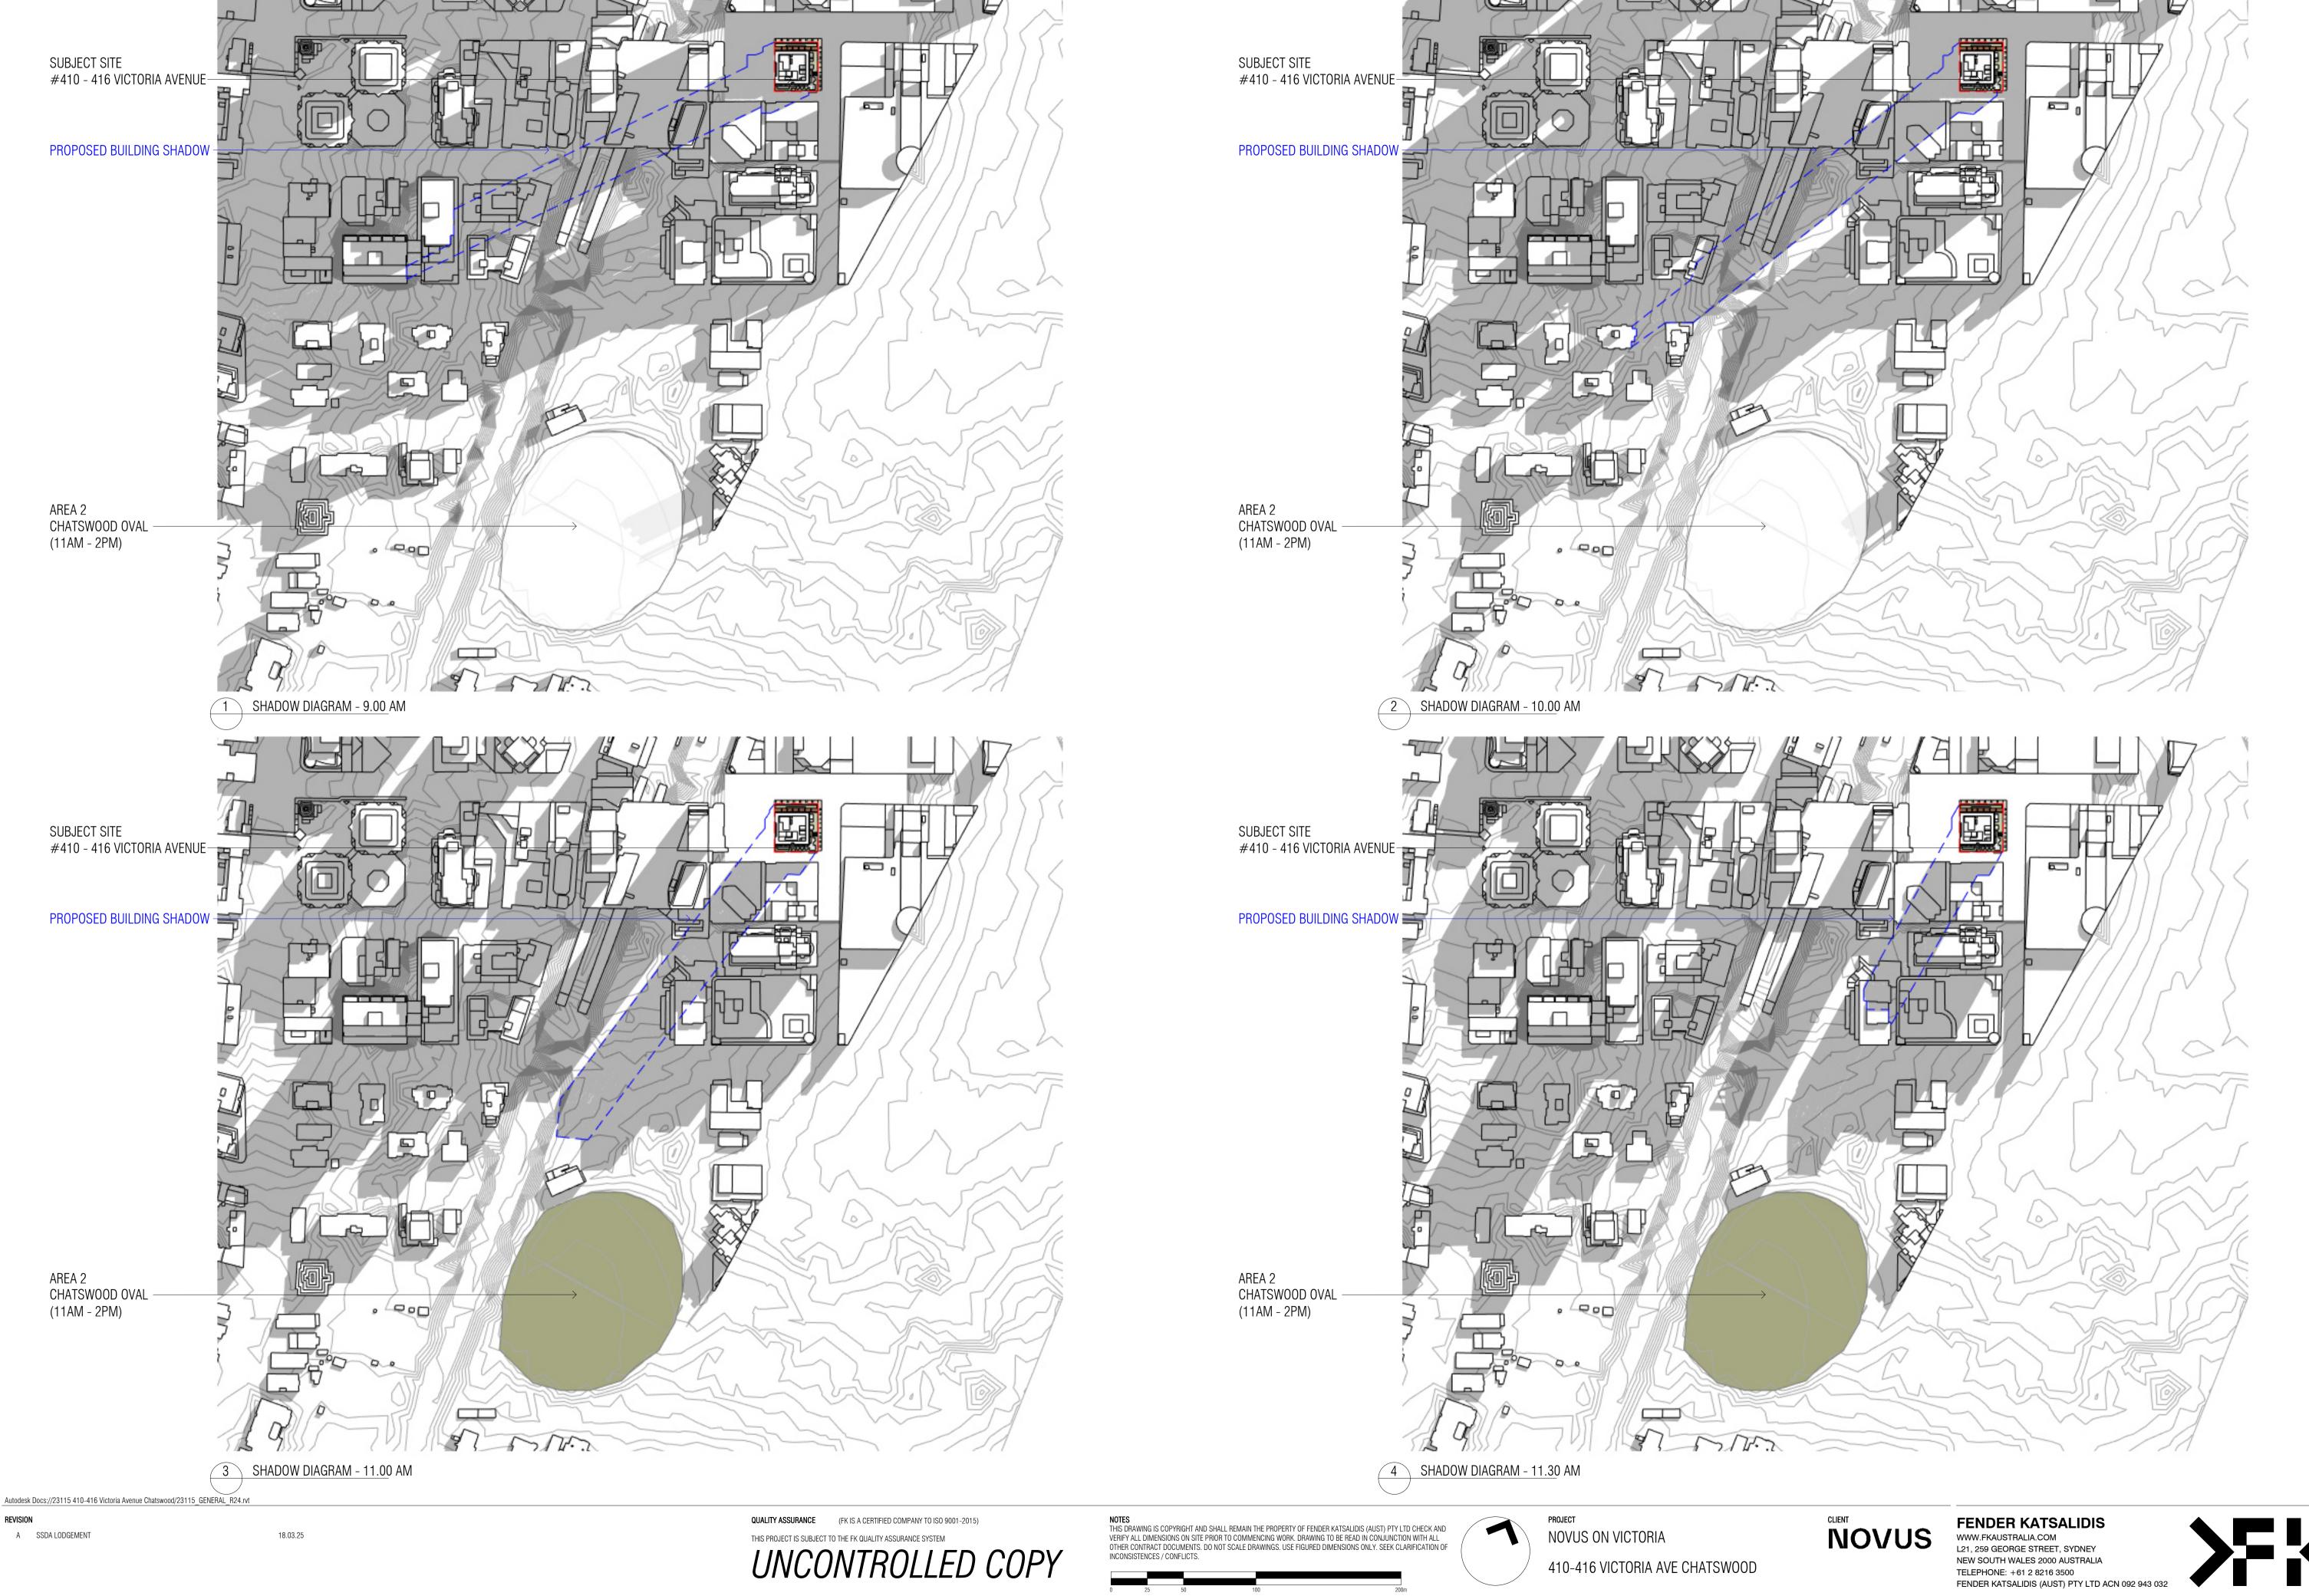

18.03.25


23115

1:2000@A1

SHADOW DIAGRAMS

IF THIS DRAWING IS STAMPED 'UNCONTROLLED COPY' THEN IT IS TO BE CONSIDERED A DRAFT, SUBJECT TO REVISION WITHOUT NOTICE NOT FOR CONSTRUCTION

DA 405

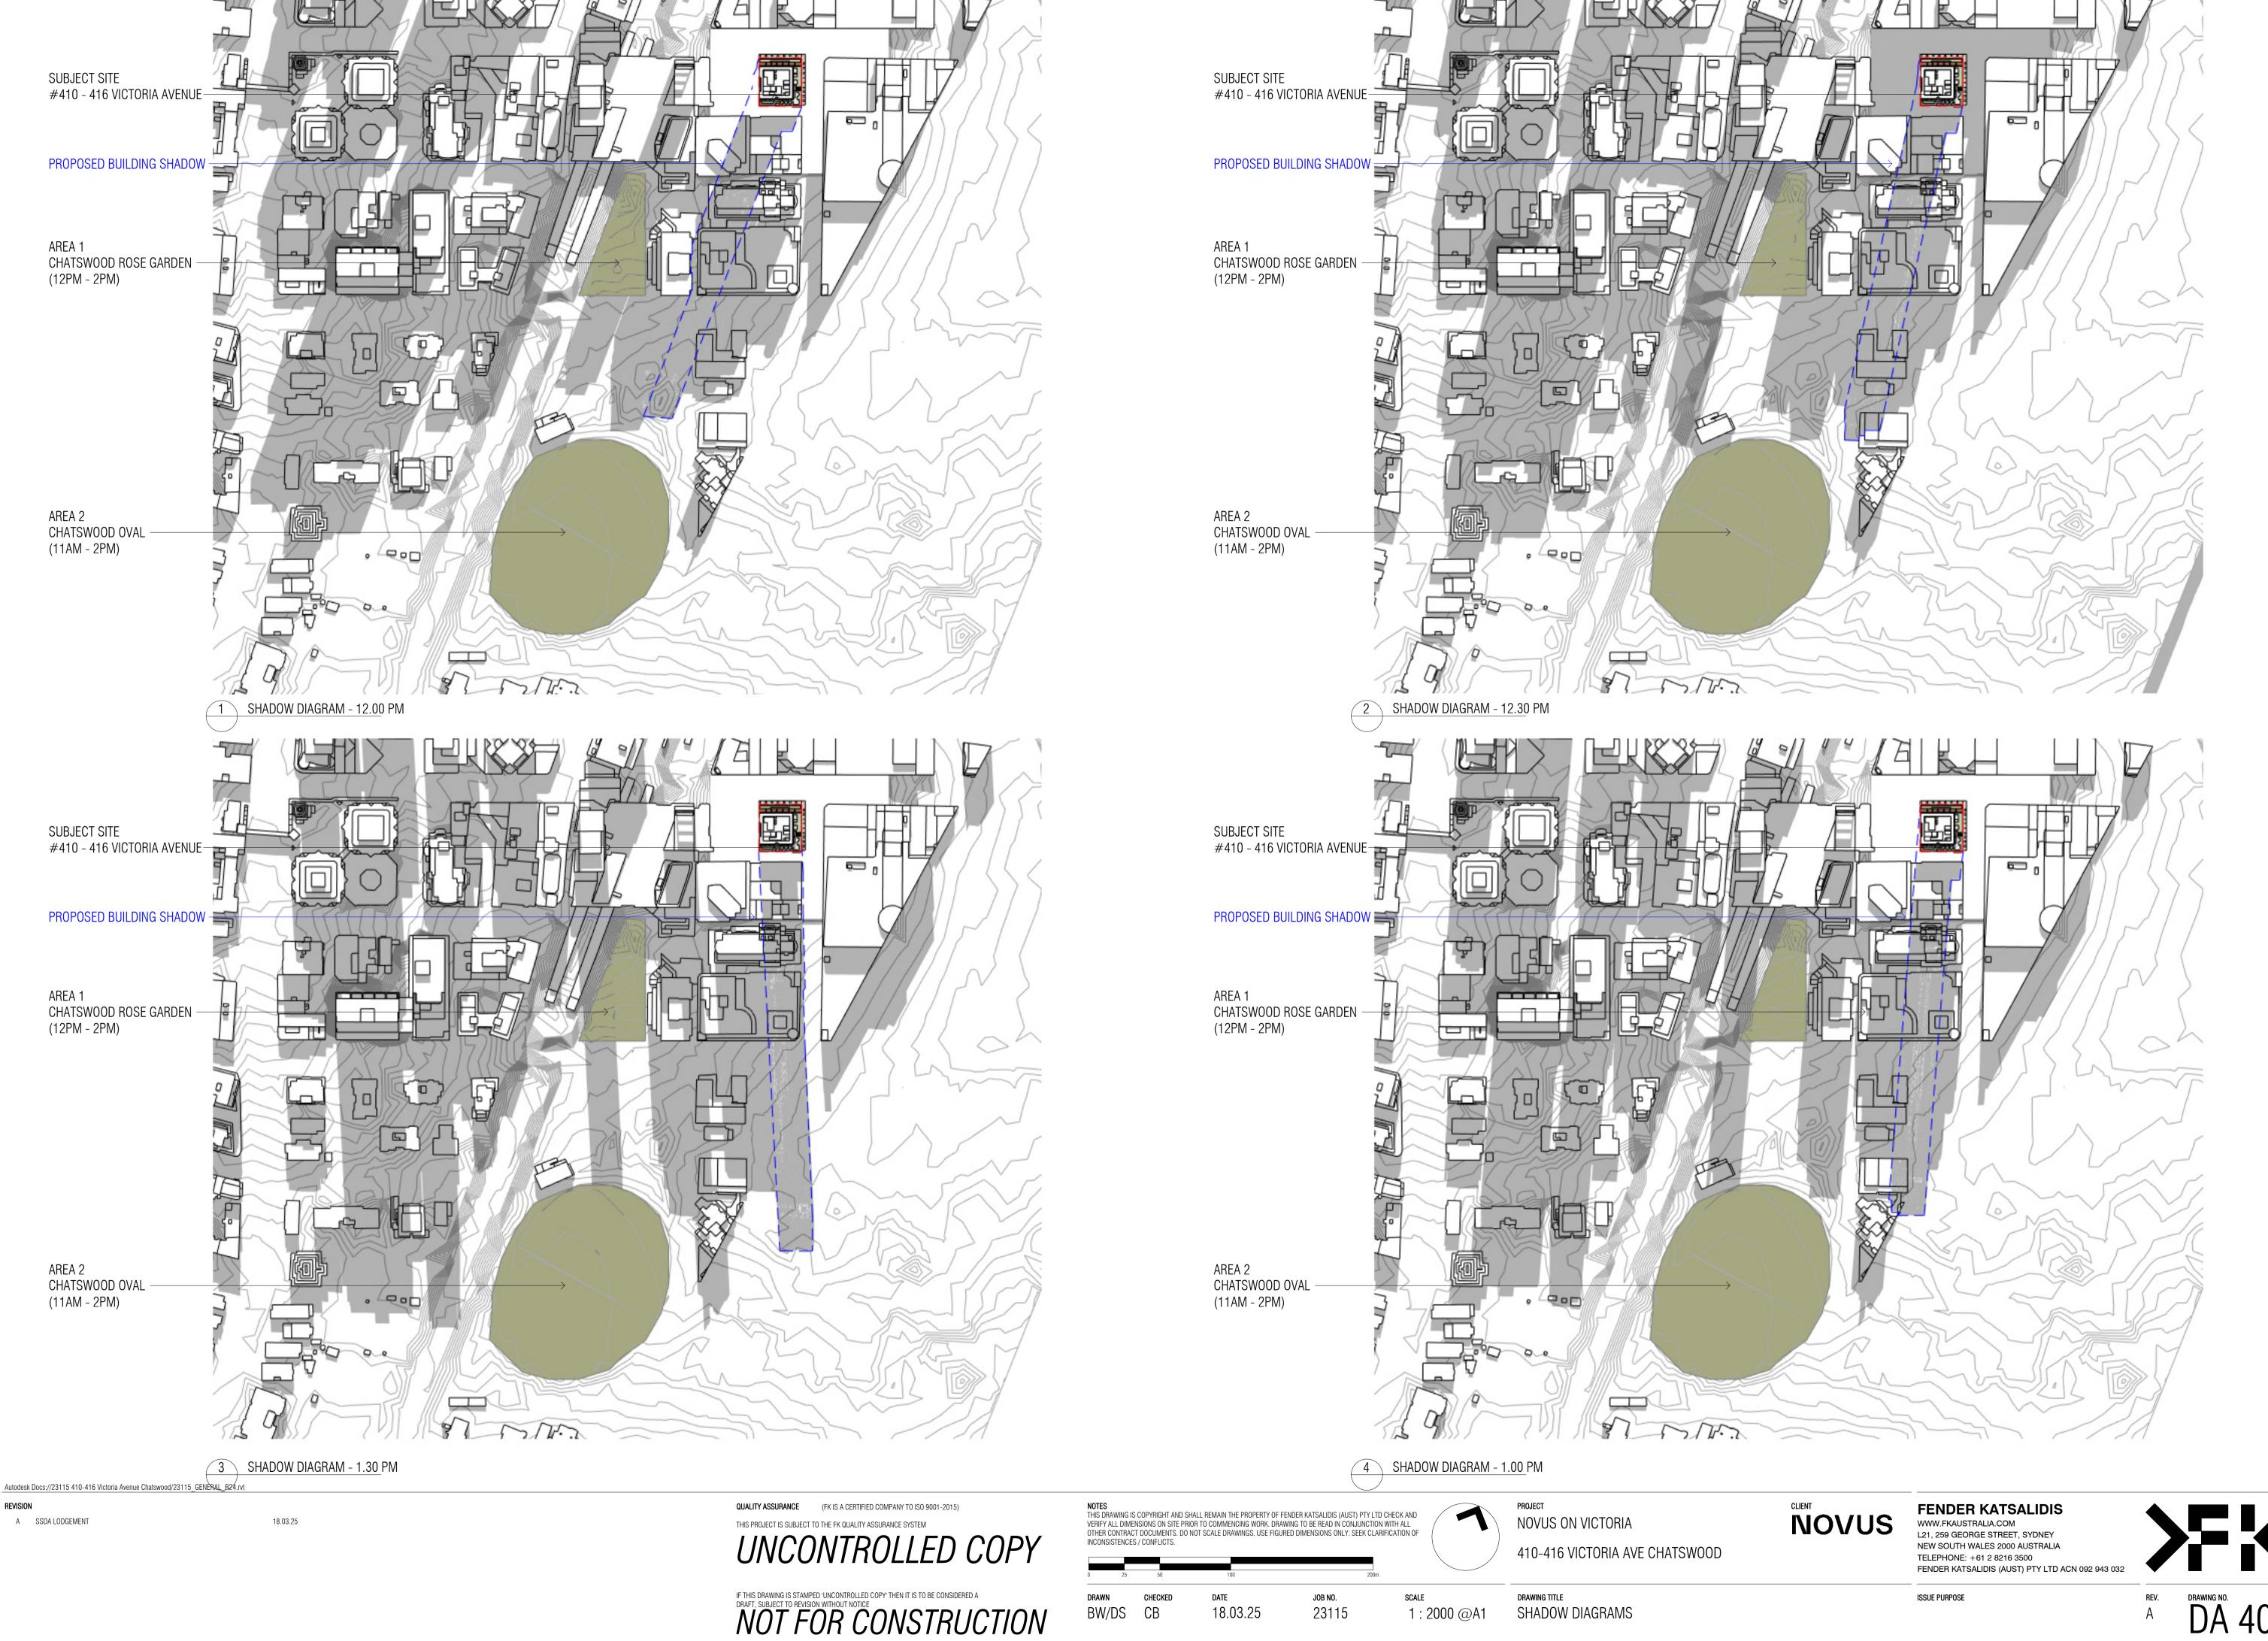



18.03.25

23115

1:2000@A1

SHADOW DIAGRAMS

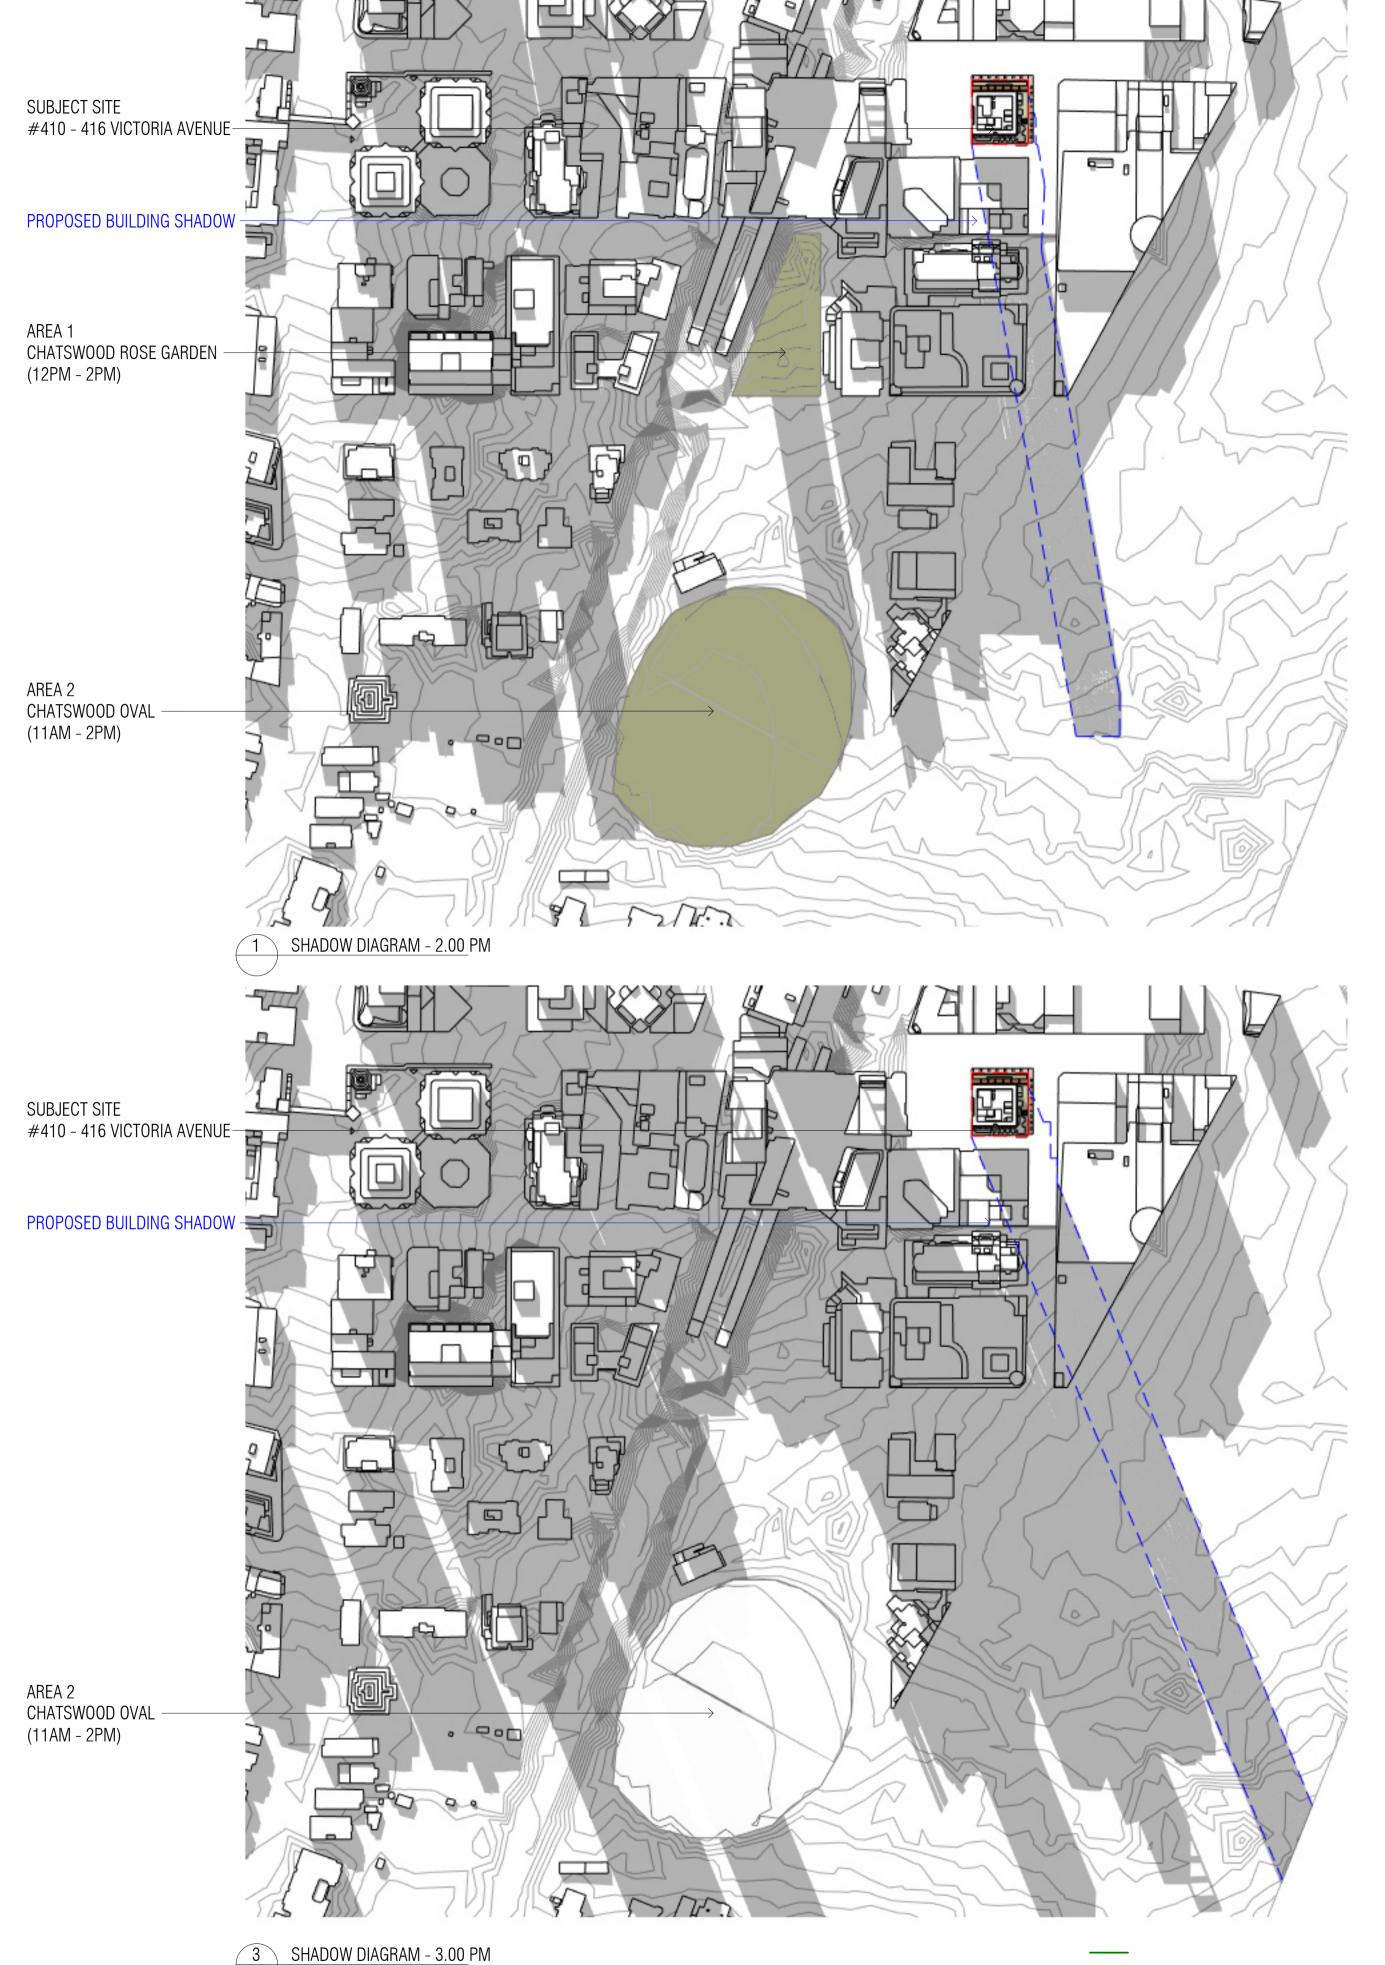

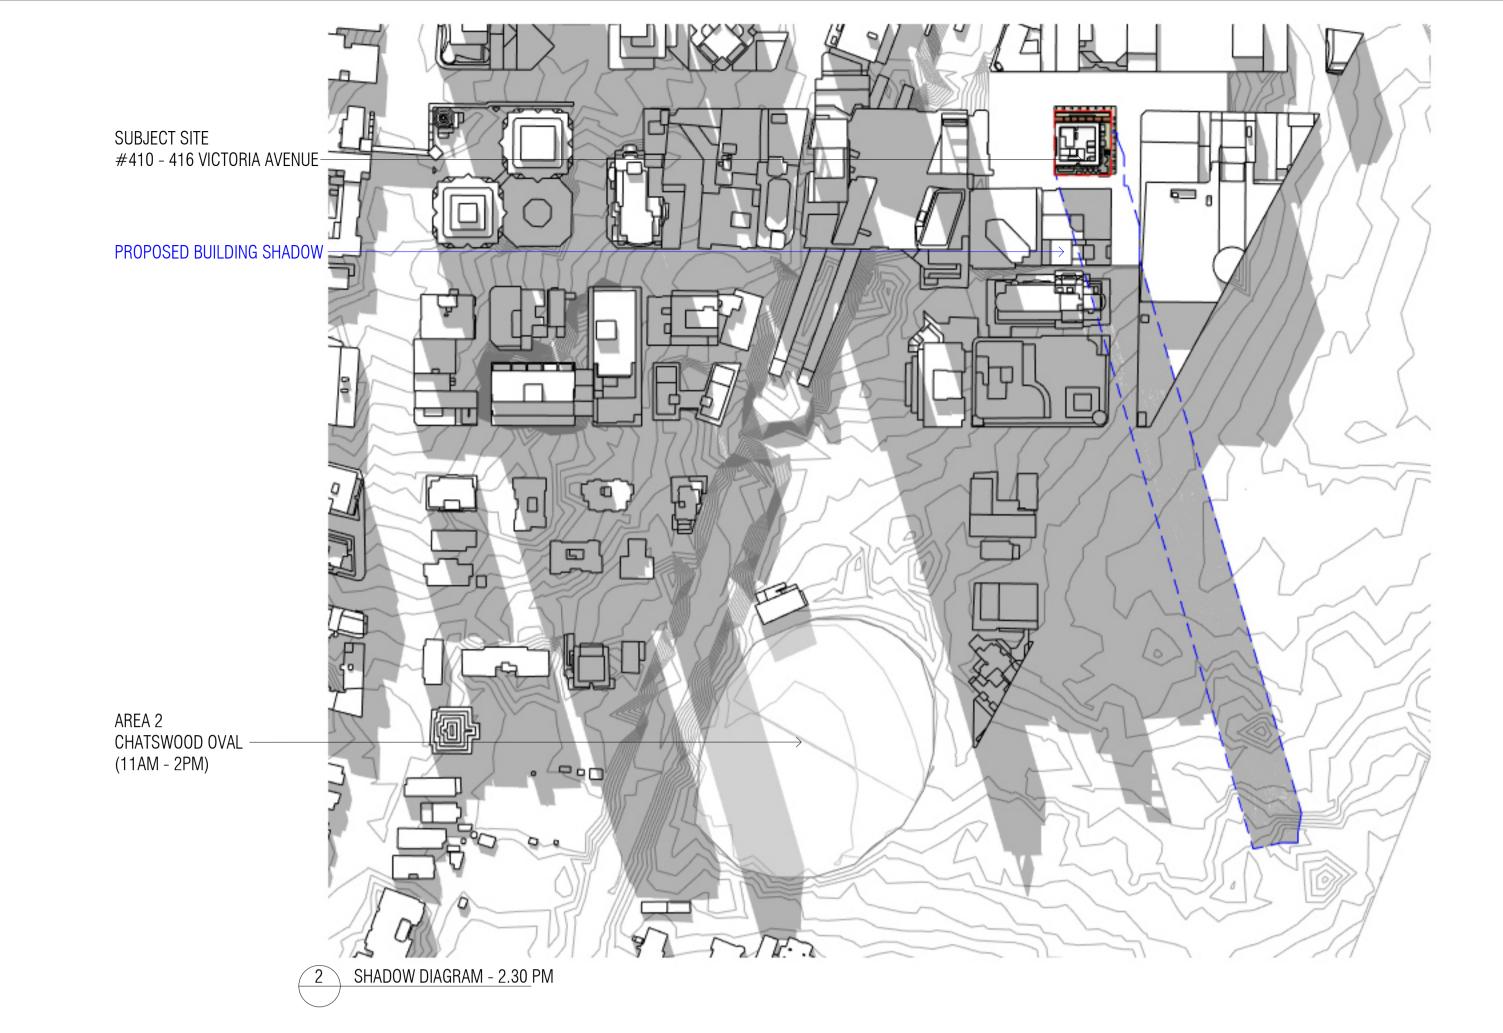

18.03.25

A SSDA LODGEMENT

**QUALITY ASSURANCE** (FK IS A CERTIFIED COMPANY TO ISO 9001-2015) THIS PROJECT IS SUBJECT TO THE FK QUALITY ASSURANCE SYSTEM UNCONTROLLED COPY NOTES
THIS DRAWING IS COPYRIGHT AND SHALL REMAIN THE PROPERTY OF FENDER KATSALIDIS (AUST) PTY LTD CHECK AND VERIFY ALL DIMENSIONS ON SITE PRIOR TO COMMENCING WORK. DRAWING TO BE READ IN CONJUNCTION WITH ALL OTHER CONTRACT DOCUMENTS. DO NOT SCALE DRAWINGS. USE FIGURED DIMENSIONS ONLY. SEEK CLARIFICATION OF

18.03.25

23115


BW/DS CB

1:2000@A1

NOVUS ON VICTORIA 410-416 VICTORIA AVE CHATSWOOD


NOVUS


FENDER KATSALIDIS
WWW.FKAUSTRALIA.COM
L21, 259 GEORGE STREET, SYDNEY
NEW SOUTH WALES 2000 AUSTRALIA TELEPHONE: +61 2 8216 3500 FENDER KATSALIDIS (AUST) PTY LTD ACN 092 943 032

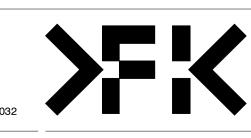



IF THIS DRAWING IS STAMPED 'UNCONTROLLED COPY' THEN IT IS TO BE CONSIDERED A DRAFT, SUBJECT TO REVISION WITHOUT NOTICE NOT FOR CONSTRUCTION


SHADOW DIAGRAMS

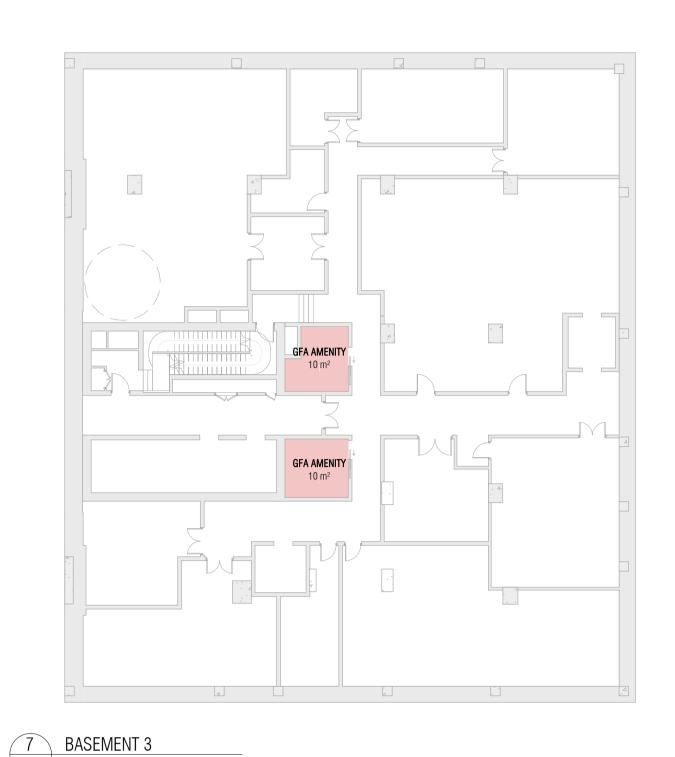


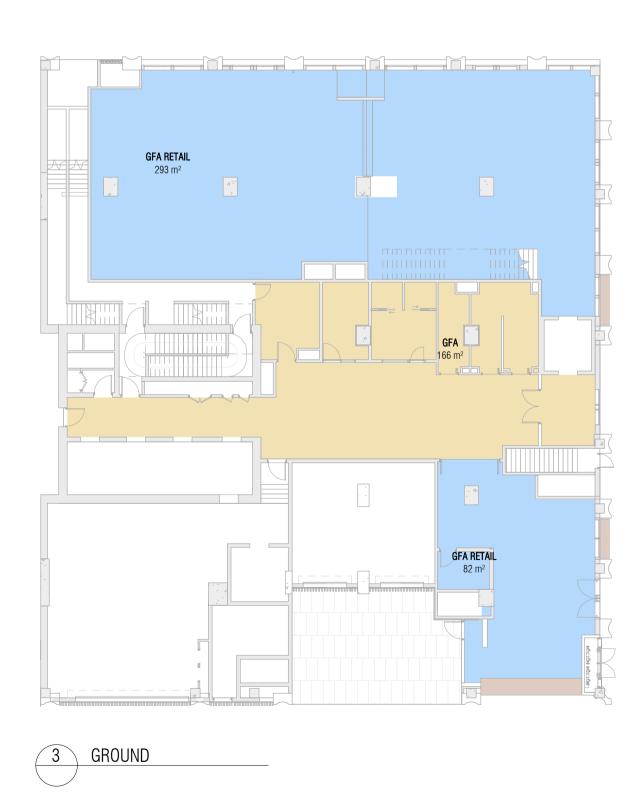

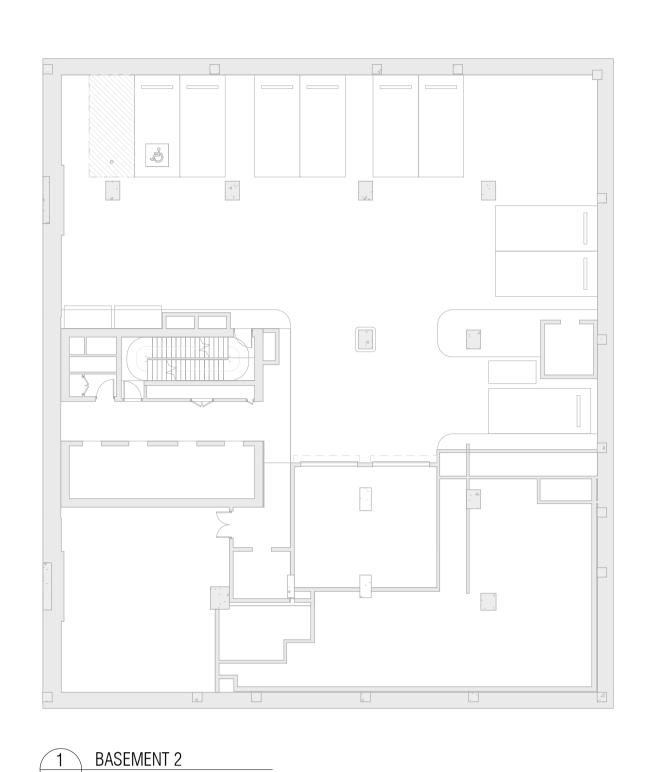

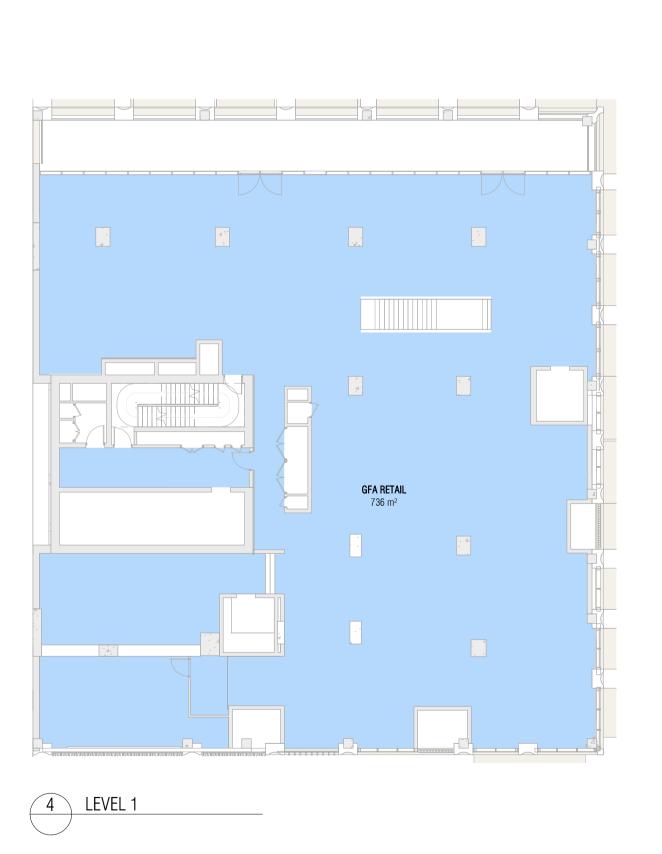

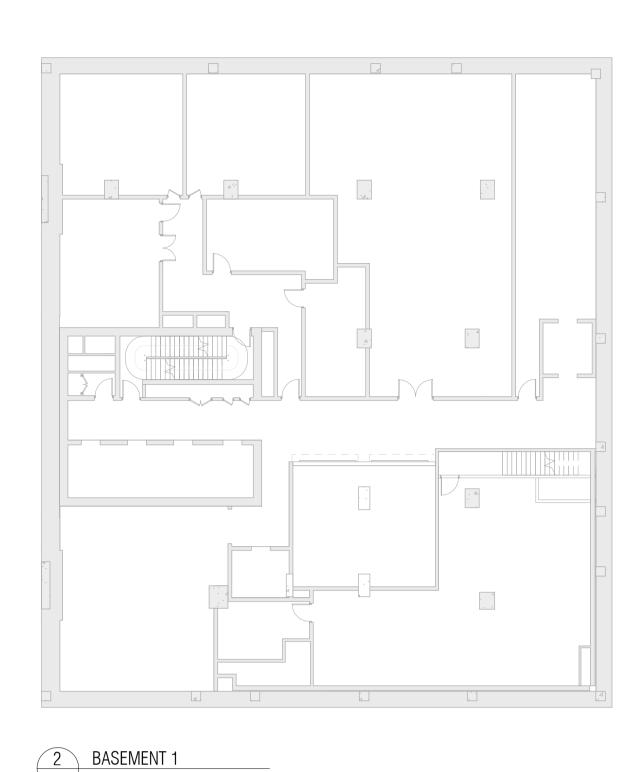

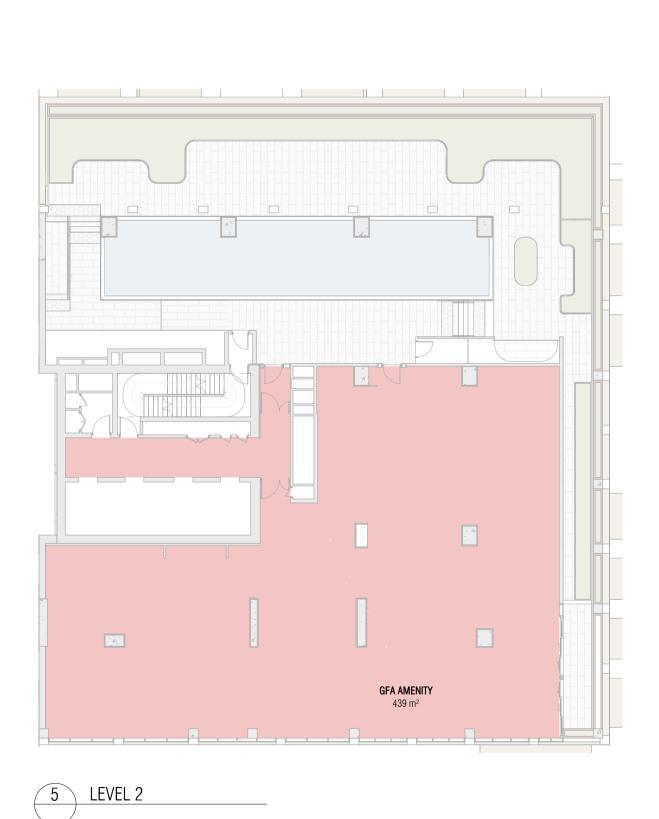

GFA RESIDENTIAL GFA 16280 m<sup>2</sup>

GFA A	MENITY
LEVEL	GFA
BASEMENT 3	20 m <sup>2</sup>
LEVEL 2	439 m²
LEVEL 6	160 m <sup>2</sup>
LEVEL 44	428 m <sup>2</sup>
TOTAL	1047 m <sup>2</sup>

GFA RETAIL		
LEVEL	GFA	
GROUND	374 m <sup>2</sup>	
LEVEL 1	736 m <sup>2</sup>	
TOTAL	1110 m <sup>2</sup>	

Gross floor area means the sum of the floor area of each floor of a building measured from the internal face of external walls, or from the internal face of walls separating the building from any other building, measured at a height of 1.4 metres above the floor, and includes—

(a) the area of a mezzanine, and (b) habitable rooms in a basement or an attic, and (c) any shop, auditorium, cinema, and the like, in a basement or attic, but excludes— (d) any area for common vertical circulation, such as lifts and stairs, and

(e) any basement— (i) storage, and (ii) vehicular access, loading areas, garbage and services, and

(f) plant rooms, lift towers and other areas used


exclusively for mechanical services or ducting, (g) car parking to meet any requirements of the consent authority (including access to that car parking), and (h) any space used for the loading or unloading of goods (including access to it), and
(i) terraces and balconies with outer walls less than 1.4 metres high, and
(j) voids above a floor at the level of a storey or storey above.

Autodesk Docs://23115 410-416 Victoria Avenue Chatswood/23115\_GENERAL\_R24.rvt

A SSDA LODGEMENT

18.03.25

**QUALITY ASSURANCE** (FK IS A CERTIFIED COMPANY TO ISO 9001-2015) THIS PROJECT IS SUBJECT TO THE FK QUALITY ASSURANCE SYSTEM UNCONTROLLED COPY

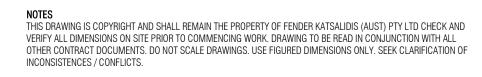










FENDER KATSALIDIS
WWW.FKAUSTRALIA.COM
L21, 259 GEORGE STREET, SYDNEY NEW SOUTH WALES 2000 AUSTRALIA TELEPHONE: +61 2 8216 3500 FENDER KATSALIDIS (AUST) PTY LTD ACN 092 943 032






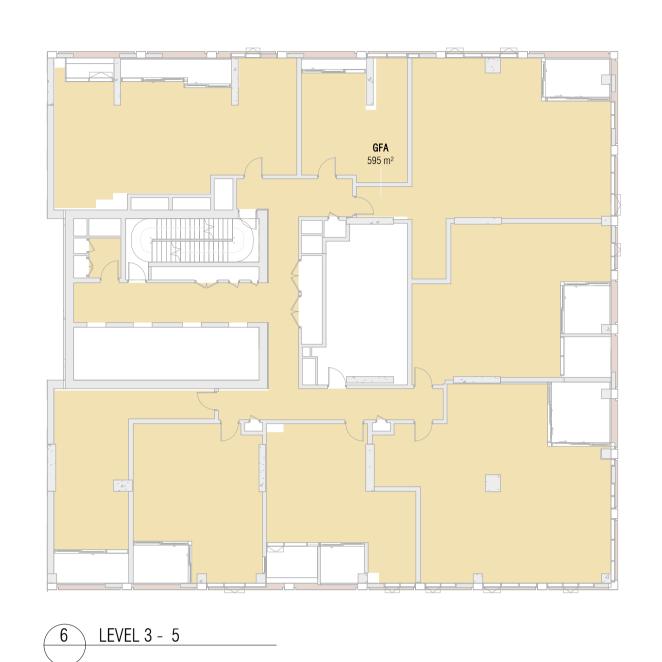

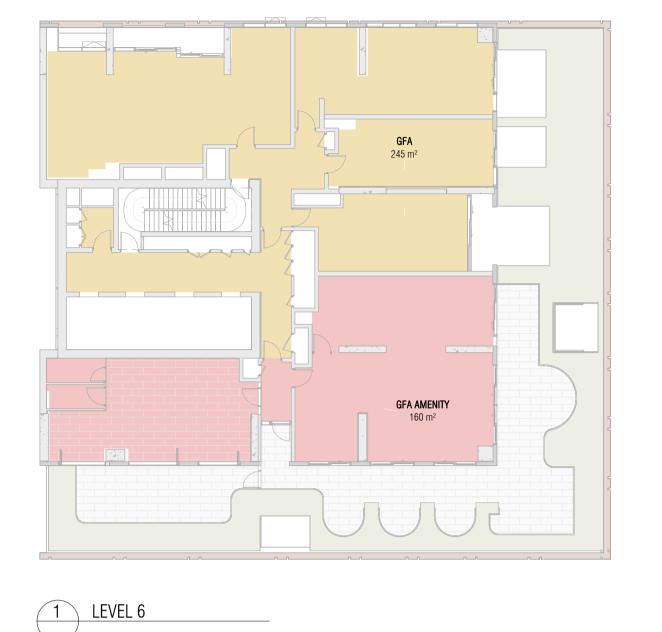

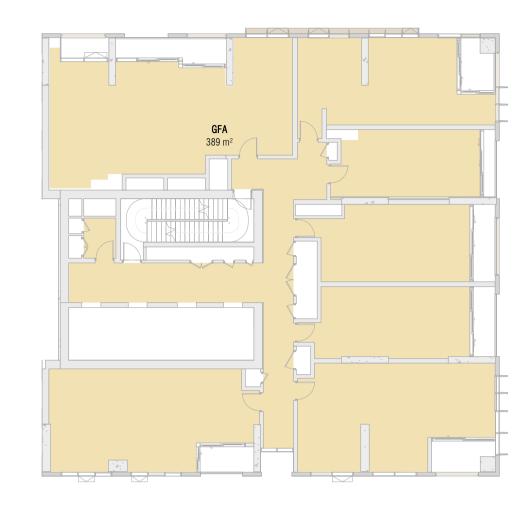

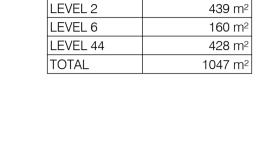

LEVEL BASEMENT 3

GFA RESIDENTIAL

GFA

GFA AMENITY

16280 m<sup>2</sup>

20 m<sup>2</sup>

GFA RETAIL LEVEL GROUND 374 m<sup>2</sup> LEVEL 1 736 m<sup>2</sup> TOTAL 1110 m<sup>2</sup>

Gross floor area means the sum of the floor area of each floor of a building measured from the internal face of external walls, or from the internal face of walls separating the building from any other building, measured at a height of 1.4 metres above the floor, and includes—

(a) the area of a mezzanine, and (b) habitable rooms in a basement or an attic, and(c) any shop, auditorium, cinema, and the like, in a basement or attic, but excludes—


(d) any area for common vertical circulation, such as lifts and stairs, and (e) any basement— (i) storage, and

(f) plant rooms, lift towers and other areas used


(ii) vehicular access, loading areas, garbage and

(g) car parking to meet any requirements of the consent authority (including access to that car


parking), and (h) any space used for the loading or unloading of goods (including access to it), and
(i) terraces and balconies with outer walls less than 1.4 metres high, and (j) voids above a floor at the level of a storey or storey above.

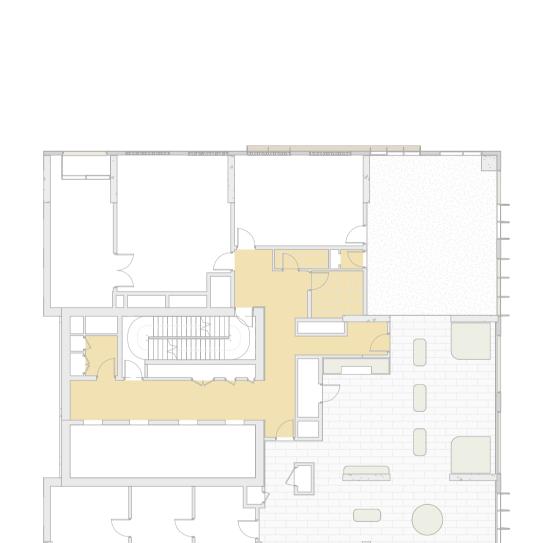



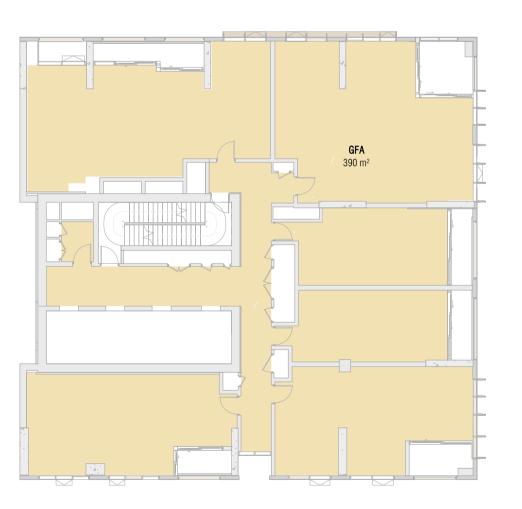



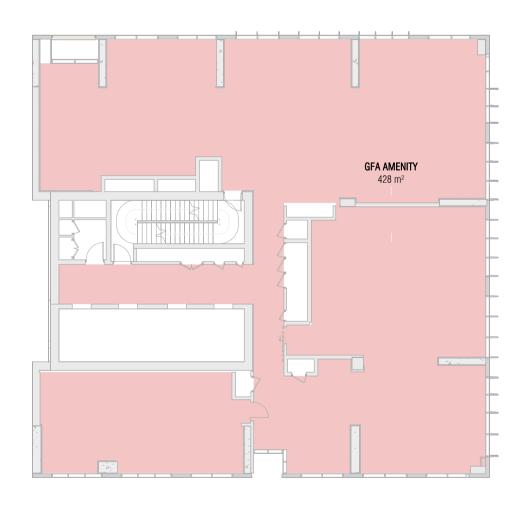

3 LEVEL 44

Autodesk Docs://23115 410-416 Victoria Avenue Chatswood/23115\_GENERAL\_R24.rvt

REVISION A SSDA LODGEMENT

18.03.25

**QUALITY ASSURANCE** (FK IS A CERTIFIED COMPANY TO ISO 9001-2015) THIS PROJECT IS SUBJECT TO THE FK QUALITY ASSURANCE SYSTEM


UNCONTROLLED COPY


NOTES
THIS DRAWING IS COPYRIGHT AND SHALL REMAIN THE PROPERTY OF FENDER KATSALIDIS (AUST) PTY LTD CHECK AND VERIFY ALL DIMENSIONS ON SITE PRIOR TO COMMENCING WORK. DRAWING TO BE READ IN CONJUNCTION WITH ALL OTHER CONTRACT DOCUMENTS. DO NOT SCALE DRAWINGS. USE FIGURED DIMENSIONS ONLY. SEEK CLARIFICATION OF INCONSISTENCES / CONFLICTS.




NOVUS ON VICTORIA 410-416 VICTORIA AVE CHATSWOOD NOVUS

FENDER KATSALIDIS
WWW.FKAUSTRALIA.COM
L21, 259 GEORGE STREET, SYDNEY NEW SOUTH WALES 2000 AUSTRALIA TELEPHONE: +61 2 8216 3500 FENDER KATSALIDIS (AUST) PTY LTD ACN 092 943 032

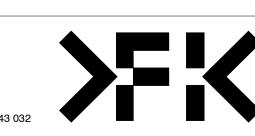


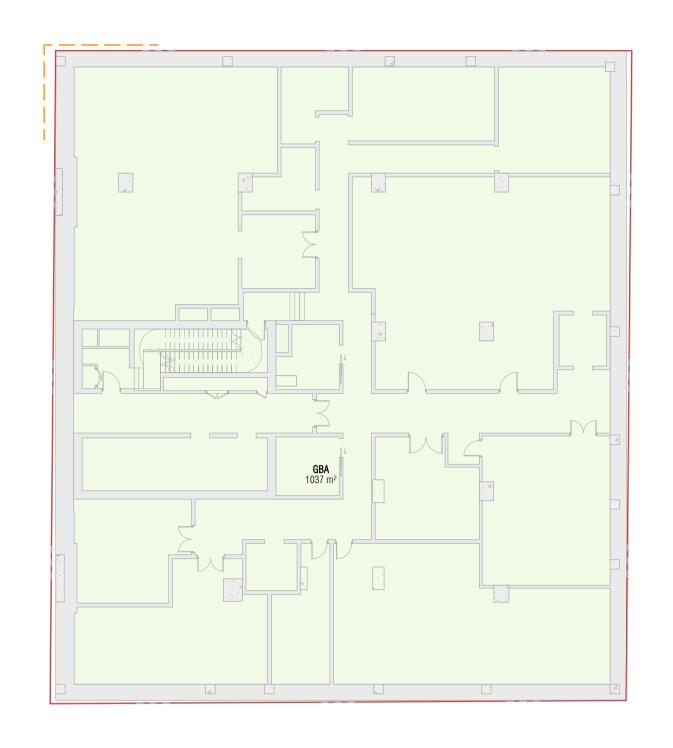




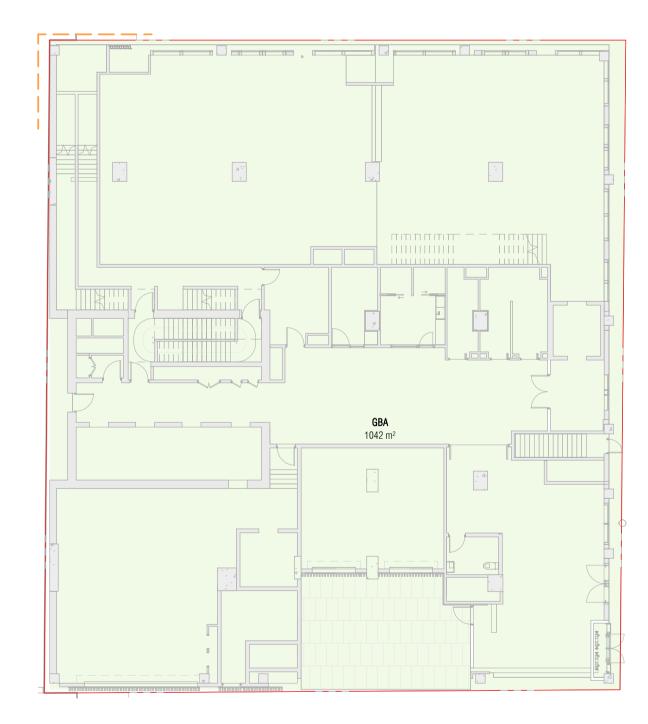




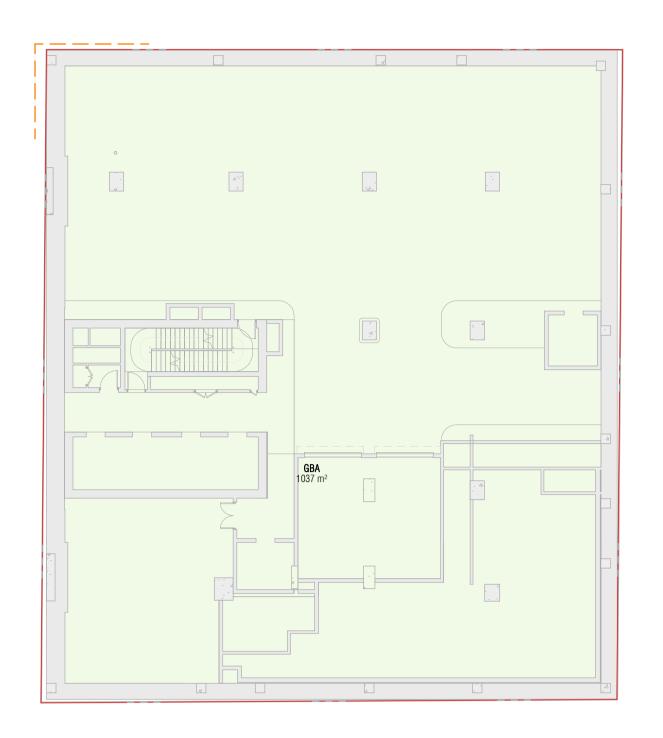


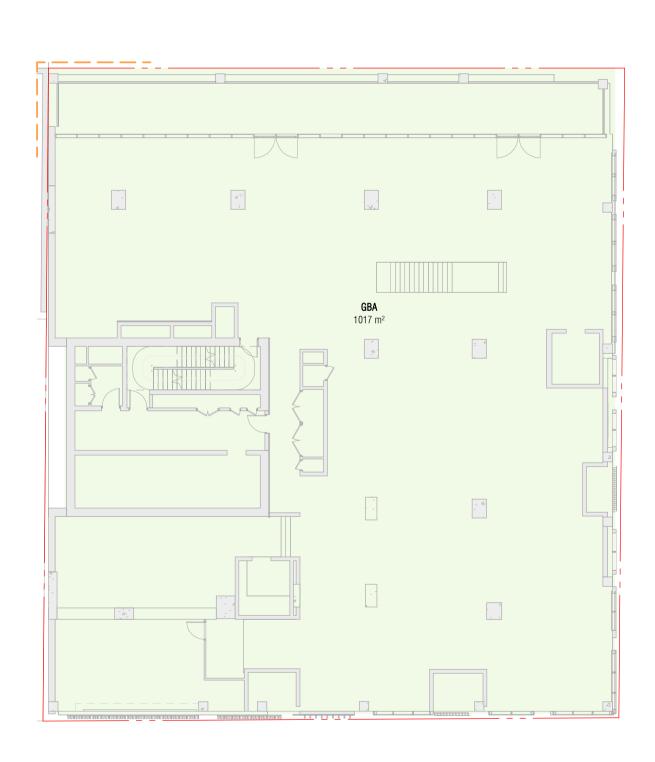



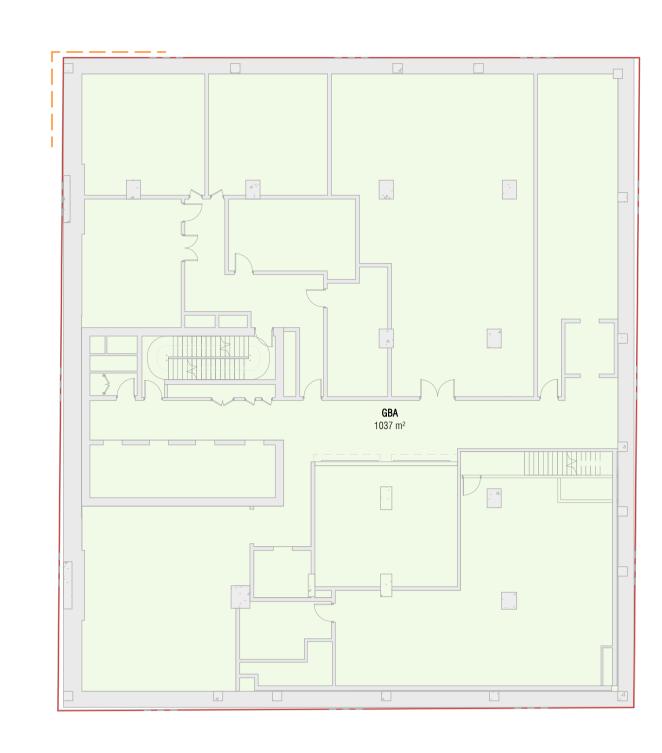



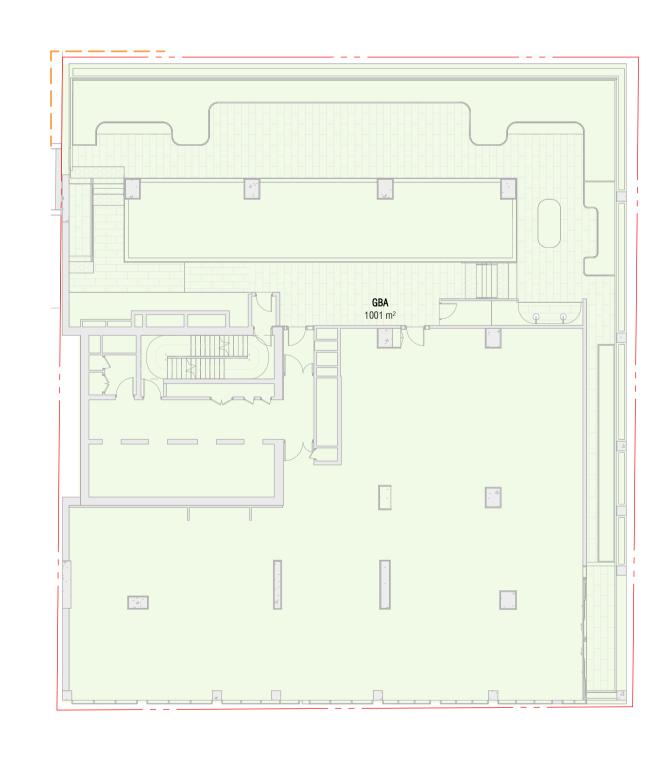

5 LEVEL 2

Autodesk Docs://23115 410-416 Victoria Avenue Chatswood/23115\_GENERAL\_R24.rvt

A SSDA LODGEMENT

18.03.25

**QUALITY ASSURANCE** (FK IS A CERTIFIED COMPANY TO ISO 9001-2015) UNCONTROLLED COPY

NOTES
THIS DRAWING IS COPYRIGHT AND SHALL REMAIN THE PROPERTY OF FENDER KATSALIDIS (AUST) PTY LTD CHECK AND VERIFY ALL DIMENSIONS ON SITE PRIOR TO COMMENCING WORK. DRAWING TO BE READ IN CONJUNCTION WITH ALL OTHER CONTRACT DOCUMENTS. DO NOT SCALE DRAWINGS. USE FIGURED DIMENSIONS ONLY. SEEK CLARIFICATION OF INCONSISTENCES / CONFLICTS.

18.03.25




NOVUS ON VICTORIA 410-416 VICTORIA AVE CHATSWOOD

COMPLIANCE - GBA

NOVUS

FENDER KATSALIDIS
WWW.FKAUSTRALIA.COM
L21, 259 GEORGE STREET, SYDNEY
NEW SOUTH WALES 2000 AUSTRALIA TELEPHONE: +61 2 8216 3500 FENDER KATSALIDIS (AUST) PTY LTD ACN 092 943 032

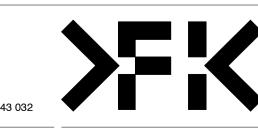

BASEMENT 3 1037 m<sup>2</sup>

1037 m<sup>2</sup> 1037 m<sup>2</sup>

1042 m<sup>2</sup>

1017 m<sup>2</sup>

1001 m<sup>2</sup>

823 m<sup>2</sup>

823 m<sup>2</sup>

823 m<sup>2</sup>

552 m<sup>2</sup>

553 m<sup>2</sup>

552 m<sup>2</sup>

552 m<sup>2</sup>

552 m<sup>2</sup>

552 m<sup>2</sup>

552 m<sup>2</sup>

552 m<sup>2</sup> 552 m<sup>2</sup> 552 m<sup>2</sup>

552 m<sup>2</sup> 552 m<sup>2</sup>

552 m<sup>2</sup>

552 m<sup>2</sup>

552 m<sup>2</sup>

552 m<sup>2</sup>

552 m<sup>2</sup>

552 m<sup>2</sup>

552 m<sup>2</sup>

552 m<sup>2</sup>

553 m<sup>2</sup>

553 m<sup>2</sup>

553 m<sup>2</sup> 30736 m<sup>2</sup>

BASEMENT 2

GROUND

LEVEL 1

LEVEL 2

LEVEL 3

LEVEL 4

LEVEL 5

LEVEL 6

LEVEL 7

LEVEL 8

LEVEL 9

LEVEL 10

LEVEL 11

LEVEL 12

LEVEL 13

LEVEL 14

LEVEL 15

LEVEL 16

LEVEL 17

LEVEL 18

LEVEL 19

LEVEL 20

LEVEL 21

LEVEL 22

LEVEL 23

LEVEL 24

LEVEL 25

LEVEL 26

LEVEL 27

LEVEL 28

LEVEL 29 LEVEL 30 LEVEL 31

LEVEL 32 LEVEL 33

LEVEL 34

LEVEL 35

LEVEL 36

LEVEL 37

LEVEL 38

LEVEL 39


LEVEL 40


LEVEL 42


LEVEL 43


LEVEL 44


LEVEL 45 TOTAL

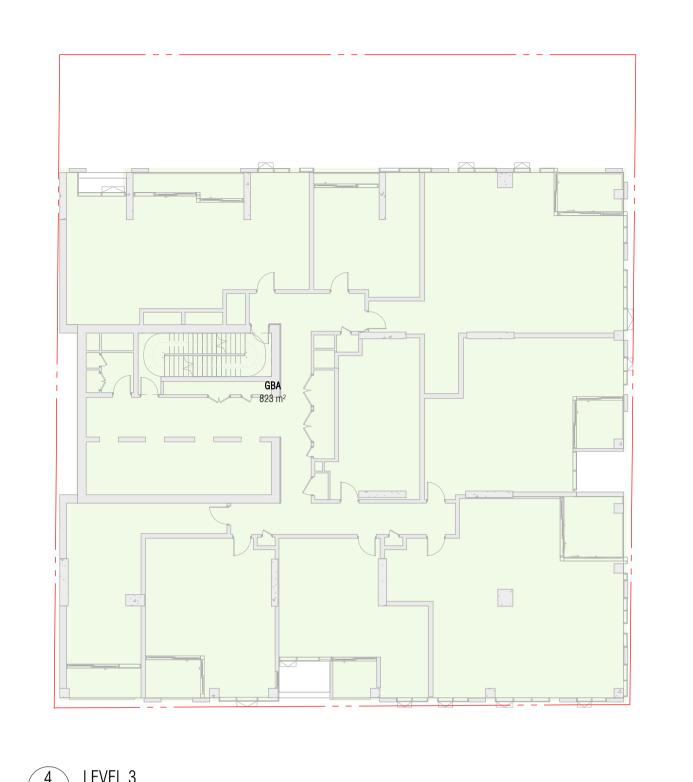


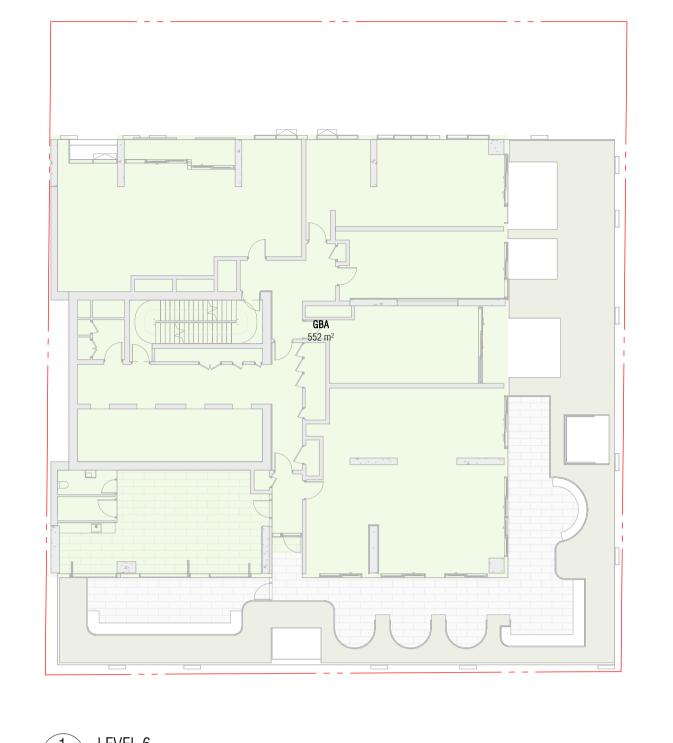


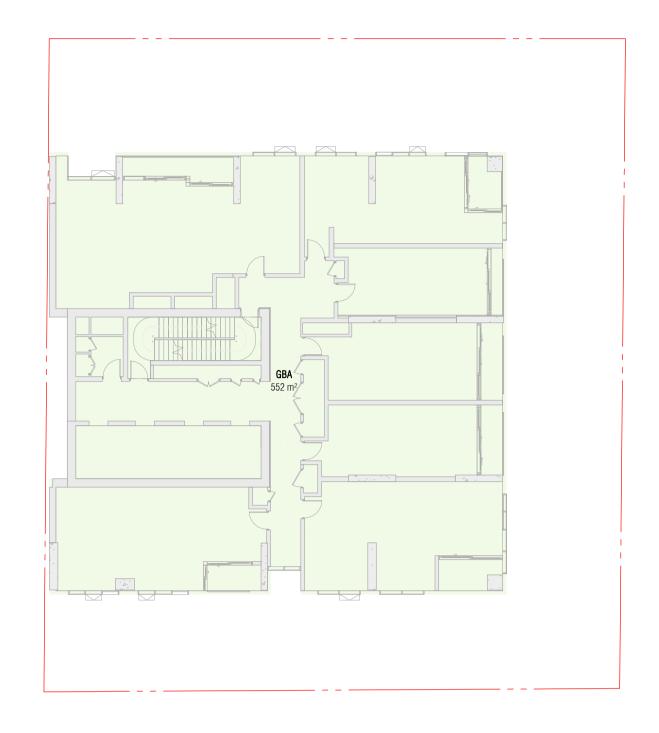

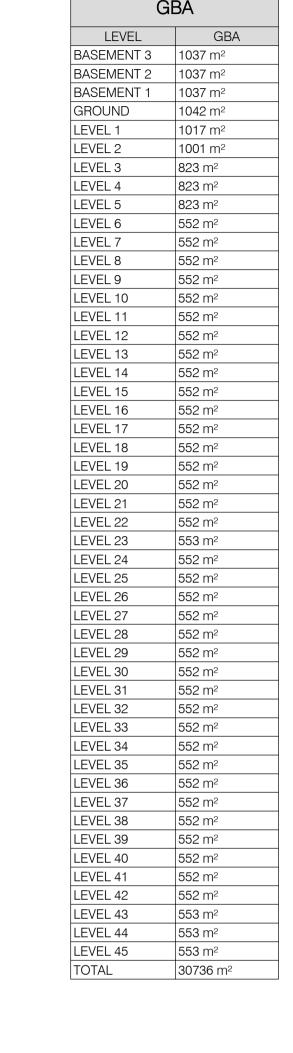

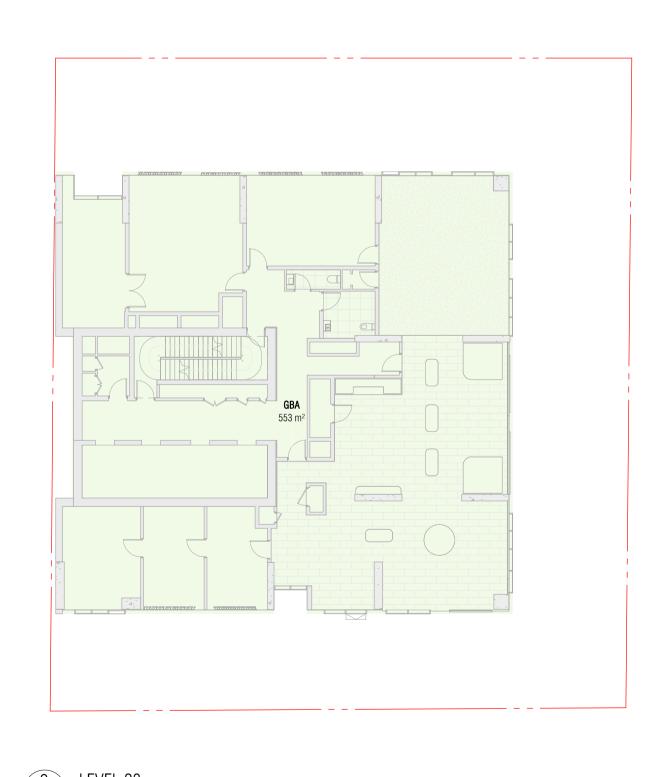

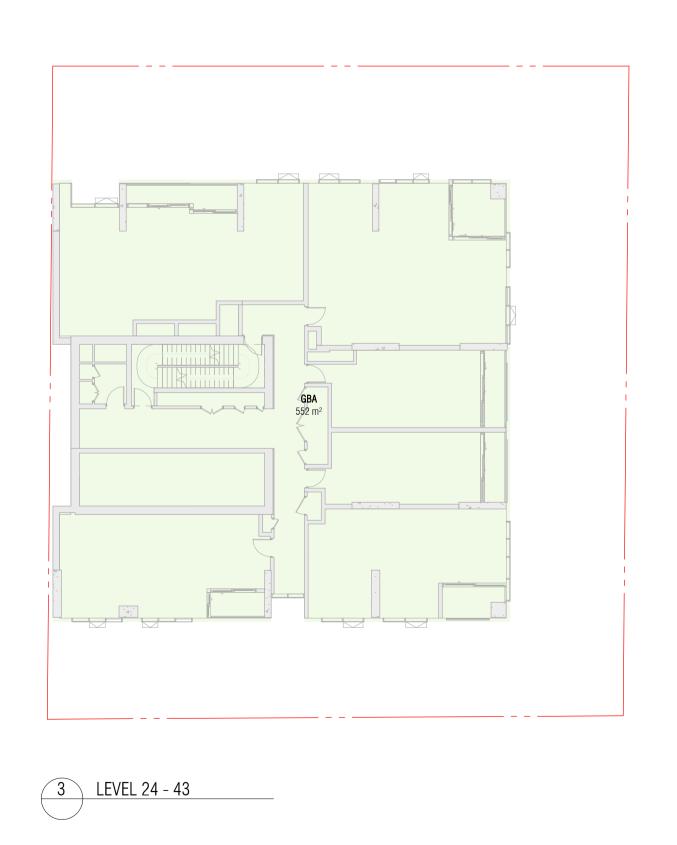

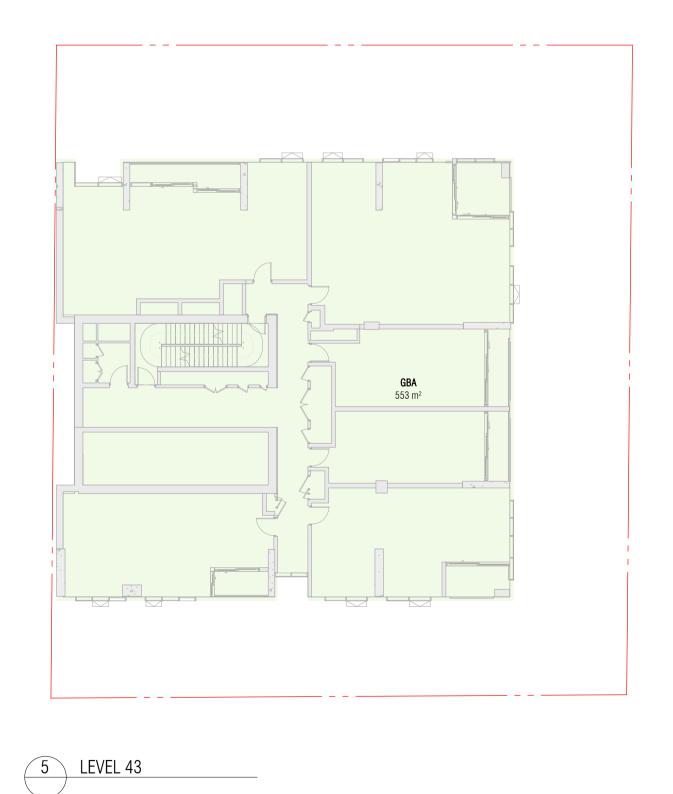

A SSDA LODGEMENT

18.03.25

**QUALITY ASSURANCE** (FK IS A CERTIFIED COMPANY TO ISO 9001-2015) UNCONTROLLED COPY

NOTES
THIS DRAWING IS COPYRIGHT AND SHALL REMAIN THE PROPERTY OF FENDER KATSALIDIS (AUST) PTY LTD CHECK AND VERIFY ALL DIMENSIONS ON SITE PRIOR TO COMMENCING WORK. DRAWING TO BE READ IN CONJUNCTION WITH ALL OTHER CONTRACT DOCUMENTS. DO NOT SCALE DRAWINGS. USE FIGURED DIMENSIONS ONLY. SEEK CLARIFICATION OF INCONSISTENCES / CONFLICTS.

18.03.25






6 LEVEL 7 - 22




FENDER KATSALIDIS
WWW.FKAUSTRALIA.COM
L21, 259 GEORGE STREET, SYDNEY NEW SOUTH WALES 2000 AUSTRALIA TELEPHONE: +61 2 8216 3500 FENDER KATSALIDIS (AUST) PTY LTD ACN 092 943 032

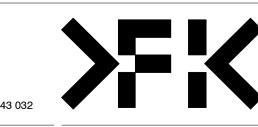







LEVEL	TOTAL APARTMENTS	2 HR	2 HR %	0 HR	0 HR %
BASEMENT 3	0	0	0%	0	0%
BASEMENT 2	0	0	0%	0	0%
BASEMENT 1	0	0	0%	0	0%
GROUND	0	0	0%	0	0%
LEVEL 1	0	0	0%	0	0%
LEVEL 2	0	0	0%	0	0%
LEVEL 3	8	5	2%	3	1%
LEVEL 4	8	5	2%	3	1%
LEVEL 5	8	5	2%	3	1%
LEVEL 6	4	4	2%	0	0%
LEVEL 7	7	6	2%	1	0%
LEVEL 8	7	6	2%	1	0%
LEVEL 9	7	6	2%	1	0%
LEVEL 10	7	6	2%	1	0%
LEVEL 11	7	6	2%	1	0%
LEVEL 12	7	6	2%	1	0%
LEVEL 13	7	6	2%	1	0%
LEVEL 14	7	6	2%	1	0%
LEVEL 15	7	6	2%	1	0%
LEVEL 16	7	6	2%	1	0%
LEVEL 17	7	6	2%	1	0%
LEVEL 18	7	6	2%	1	0%
LEVEL 19	7	6	2%	1	0%
LEVEL 20	7	6	2%	1	0%
LEVEL 21	7	6	2%	1	0%
LEVEL 22	7	6	2%	1	0%
LEVEL 23	0	0	0%	0	0%
LEVEL 24	6	5	2%	1	0%
LEVEL 25	6	5	2%	1	0%
LEVEL 26	6	5	2%	1	0%
LEVEL 27	6	5	2%	1	0%
LEVEL 28	6	5	2%	1	0%
LEVEL 29	6	5	2%	1	0%
LEVEL 30	6	5	2%	1	0%
LEVEL 31	6	5	2%	1	0%
LEVEL 32	6	5	2%	1	0%
LEVEL 33	6	5	2%	1	0%
LEVEL 34	6	5	2%	1	0%
LEVEL 35	6	5	2%	1	0%
LEVEL 36	6	5	2%	1	0%
LEVEL 37	6	5	2%	1	0%
LEVEL 38	6	5	2%	1	0%
LEVEL 39	6	5	2%	1	0%
LEVEL 40	6	5	2%	1	0%
LEVEL 41	6	5	2%	1	0%
LEVEL 42	6	5	2%	1	0%
LEVEL 43	6	5	2%	1	0%
LEVEL 44	0	0	0%	0	0%
LEVEL 45	0	0	0%	0	0%
LEVEL 46	0	0	0%	0	0%
TOTALS	260	215	83%	45	17%

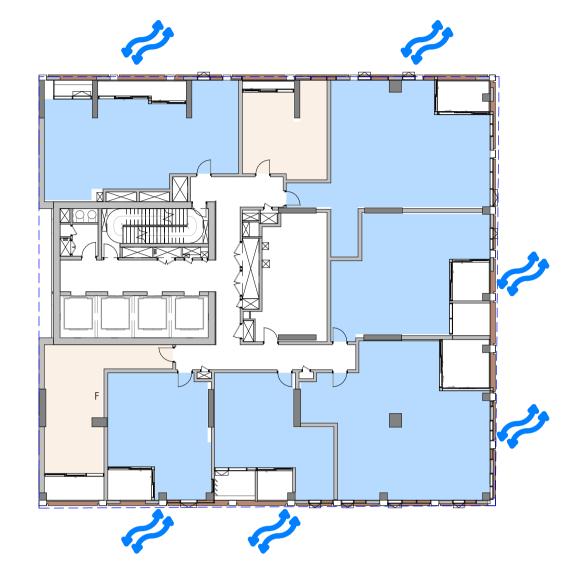

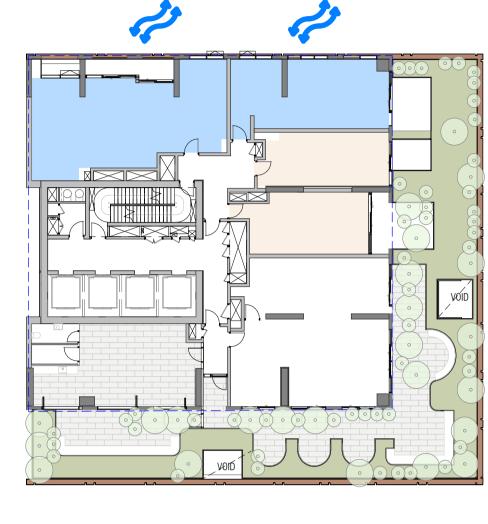

5 LEVEL 3 - CV

6 LEVEL 6 - CV

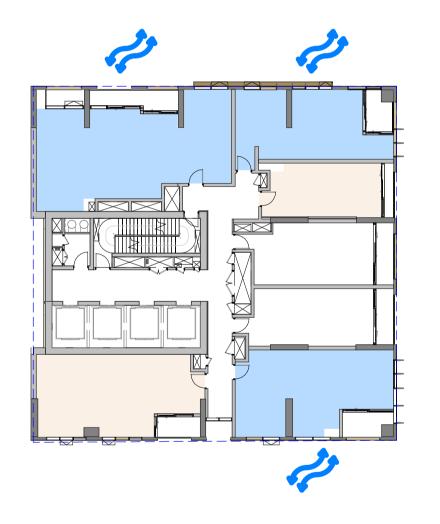

ADG COMPLIANCE - CROSS VENT			
LEVEL	TOTAL	CV COUNT	
GROUND	0	C	
LEVEL 1	0	C	
LEVEL 2	0	C	
LEVEL 3	8	6	
LEVEL 4	8	6	
LEVEL 5	8	6	
LEVEL 6	4	2	
LEVEL 7	7	3	
LEVEL 8	7	3	
TOTALS	42	26	

ADG COMPLIANCE - CROSS VENT % 62%

3 LEVEL 7 - 22 - SOLAR

>2HR

4 LEVEL 24 - 35 - SOLAR

7 LEVEL 7 - 8 CV

Autodesk Docs://23115 410-416 Victoria Avenue Chatswood/23115\_GENERAL\_R24.rvt

A SSDA LODGEMENT

18.03.25

**QUALITY ASSURANCE** (FK IS A CERTIFIED COMPANY TO ISO 9001-2015)

UNCONTROLLED COPY

IF THIS DRAWING IS STAMPED 'UNCONTROLLED COPY' THEN IT IS TO BE CONSIDERED A DRAFT, SUBJECT TO REVISION WITHOUT NOTICE NOT FOR CONSTRUCTION


NOTES
THIS DRAWING IS COPYRIGHT AND SHALL REMAIN THE PROPERTY OF FENDER KATSALIDIS (AUST) PTY LTD CHECK AND VERIFY ALL DIMENSIONS ON SITE PRIOR TO COMMENCING WORK. DRAWING TO BE READ IN CONJUNCTION WITH ALL OTHER CONTRACT DOCUMENTS. DO NOT SCALE DRAWINGS. USE FIGURED DIMENSIONS ONLY. SEEK CLARIFICATION OF INCONSISTENCES / CONFLICTS.



NOVUS ON VICTORIA 410-416 VICTORIA AVE CHATSWOOD

FENDER KATSALIDIS
WWW.FKAUSTRALIA.COM
L21, 259 GEORGE STREET, SYDNEY NEW SOUTH WALES 2000 AUSTRALIA TELEPHONE: +61 2 8216 3500 FENDER KATSALIDIS (AUST) PTY LTD ACN 092 943 032



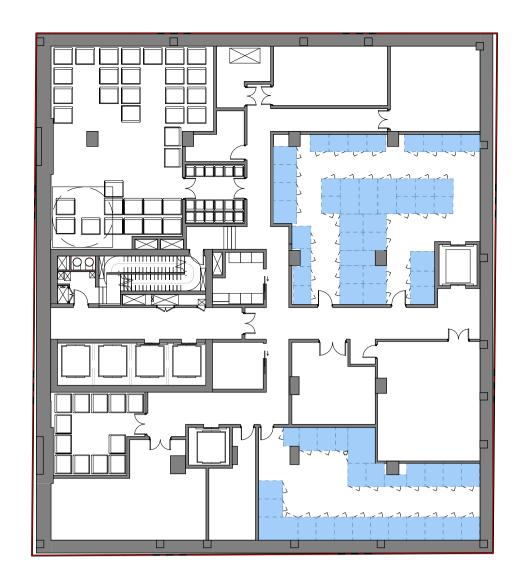






2 LEVEL 03 - 04 - STORAGE PLAN



5 LEVEL 07-22 - STORAGE PLAN




A SSDA LODGEMENT 18.03.25

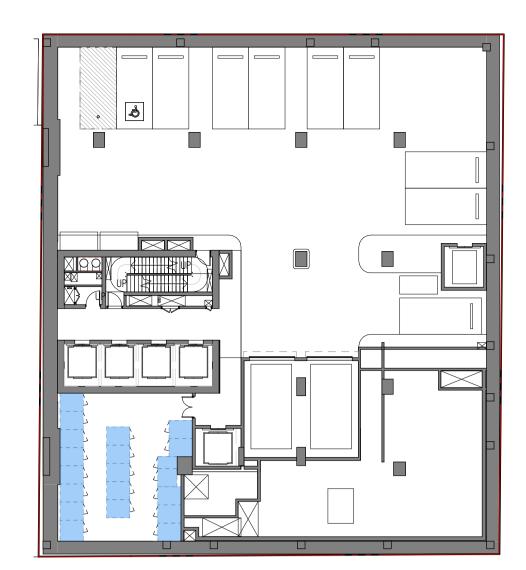

3 BASEMENT 02 - STORAGE PLAN



1 LEVEL 05 - STORAGE PLAN

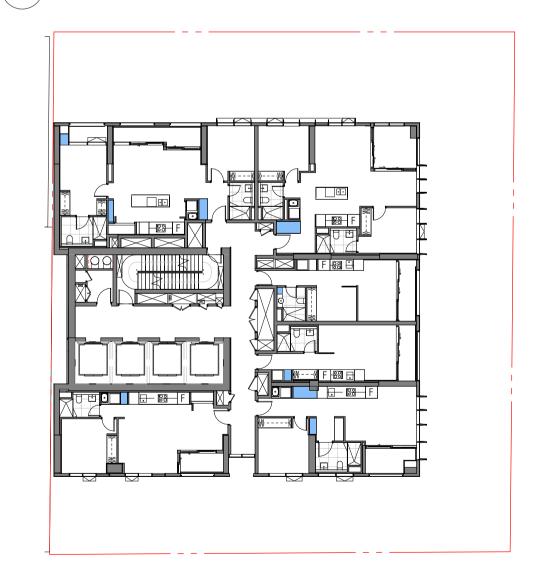

6 LEVEL 24-43 - STORAGE PLAN

ADDITIONAL STORAGE - BASEMENT 03			
STORAGE SCHEDULE			
VVV	CAGE VOLUME (m³)	CAGE AREA (m²)	
BASEMENT 3	3		
1	4.42	2.1	
2	3.86	1.8	
3	3.86	1.8	
4	3.86	1.8	
5	3.86	1.8	
6	4.93	2.3	
7	3.01	1.4	
8	3.01	1.4	
8	3.01	1.4	
9	3.01	1.4	
10	3.05	1.5	
11	6.06	2.9	
12	3.00	1.4	
13	6.13	2.9	
14	6.13	2.9	
15	3.86	1.8	
16	4.42	2.1	
17	3.01	1.4	
18	3.01	1.4	
19	3.01	1.4	
21	4.03	1.9	
23	3.86	1.8	

3.86

3.86

3.86

3.86

3.86 3.86

3.86

3.86

3.86 3.86

2.47

3.86

3.86

3.86

3.86

3.86

3.86

4.83

3.01

3.01

3.01

1.74

3.86

3.95

4.03

3.36

4.35

3.01

3.00

3.05

3.00

3.05

3.00

3.86

3.86

4.03

3.86

3.86

2.66

9.00

8.37

2.68

Grand total 246.18

246.18

1.2

1.8

1.8

1.8

1.8

1.8 2.3

1.4

1.4

1.4

0.8

1.8

1.9

1.9

1.6

2.1

1.4

1.4

1.5

1.4

1.5

1.4

1.8

1.8

1.9

1.8

1.8

1.3

4.3

4.0

1.3

117.2

117.2

1.8	LEVEL 5		
1.8	88	3.78	1.8
1.8	89	3.78	1.8
1.8	90	1.58	0.8
1.8	91	3.94	1.9
1.8	92	3.94	1.9
1.8	93	3.94	1.9
1.8	94	3.78	1.8
1.8	95	3.78	1.8
1.8	96	3.78	1.8

97 17.2 53.1 Grand total 111.60

### ADDITIONAL STORAGE - BASEMENT 02 + LEVEL 05 PODIUM - LEVEL 03 - 04

BASEMENT 2		
68	3.86	1.8
69	3.86	1.8
70	2.14	1.0
71	3.21	1.5
72	3.86	1.8
73	3.86	1.8
74	3.86	1.8
75	3.86	1.8
76	3.86	1.8
77	3.86	1.8
78	3.86	1.8
79	3.86	1.8
80	4.48	2.1
81	3.86	1.8
82	3.86	1.8
83	3.86	1.8
84	3.86	1.8
85	3.86	1.8
86	3.86	1.8
87	3.86	1.8
	75.53	36.0

STORAGE SCHEDULE

CAGE VOLUME | CAGE AREA

	13.33	30.0
/FL		
VEL 5		
	3.78	1.8
	3.78	1.8
	1.58	0.8
	3.94	1.9
	3.94	1.9
	3.94	1.9
	3.78	1.8
	3.78	1.8
	3.78	1.8
	3.78	1.8
	26.07	17.0

STORAGE

APARTMENT STORAGE

 (m <sup>2</sup> )	NO.	AREA(m <sup>2</sup> )	VOLUME(m <sup>3</sup> )
(111 )	110.	/\lite/\(\lite\)	VOLOIVIL(III )
	LEVEL 3		
1.8	301 - 2 BED		
1.8	301A	0.51	1.22
1.0	301B	0.41	0.98
1.5	301B	0.81	1.95
1.8		1.73	4.14
1.8			
1.8	302 - STUDIO		
1.8	302A	0.85	2.05
1.8		0.85	2.05
1.8			
1.8	303 - 2 BED		
1.8	303A	0.75	1.80
2.1	303B	0.39	0.92
1.8	303D	0.52	1.25
1.8		1.66	3.97
1.8			
1.8	304 - 1 BED		
4.0	20.44	1 0 4	0.04

305 - 3 BED		
305A	0.47	1.12
305B	0.34	0.82
305C	0.56	1.34
305D	0.80	1.92
	2.17	5.20
306 - STUDIO		
306A	0.29	0.70

306B	0.92	2.21
	1.21	2.92
307 - 1 BED		
307A	0.72	1.72

308 - STUDIO		
308A	1.00	2.40
308B	0.11	0.27

### PODIUM - LEVEL 05 + LEVEL 06

LEVEL 5

501 - 2 BED

501A 0.41

501B 0.51

501C 0.81

	APARTMENT STORAGE		
	STORAGE NO.	AREA(m²)	VOLUME(m <sup>3</sup> )
ı		, ,	,

	LEVEL 7		
	701 - 2 BED		
	701A	0.41	0.98
	701B	0.51	1.22
	701C	0.81	1.95
		1.73	4.14

1.31

704 - STUDIO

705 - STUDIO

706 - 1 BED 706A

707 - 1 BED

STORAGE

LEVEL 35

3501 - 2 BED

3501A 0.41

704A 0.16

705A 0.38

706A 0.49

707A 0.36

1.31

0.16

1.28

1.77

0.36

APARTMENT STORAGE

HIGH RISE - LEVEL 24 - 43

APARTMENT STORAGE

AREA(m<sup>2</sup>) VOLUME(m<sup>3</sup>)

3.13

3.13

0.38

0.38

0.90 0.90

3.08

1.17 4.25

0.86

AREA(m²) VOLUME(m³)

0.98

MID RISE - LEVEL 07-22

STORAGE

2 - STUDIO			702 - ST
502A	0.85	2.05	702
	0.85	2.05	

0.98

1.22

1.95 4.14

503 - 2 BED		
503A	0.39	0.92
503C	0.75	1.80
503E	0.52	1.25
	1.66	3.97

504-1 BED		
504A	1.34	3.
	1.34	3.

	505 - 3 BED		
	505A	0.47	1.12
	505B	0.34	0.82
	505C	0.56	1.34
	505D	0.80	1.92
_		2.17	5.20

506 - STUDIO		
506A	0.29	0.70
506B	0.92	2.21
	1.21	2.92

507 - 1 BED		
507A	0.26	0.63
507B	0.72	1.72
	0.98	2.35

508 - STUDIO		
508B	0.11	0.27
508C	1.00	2.40
	1.11	2.67

LEVEL 6 601 - 2 BED		
601A	0.41	0.98
601B	0.51	1.22
601C	0.81	1.95
	1.73	4.14

602 - 1 BED		
602	1.31	3.13
	1.31	3.13

604 - STUDIO		
604A	0.16	0.38
	0.16	0.38

3501B	0.51	1.22
3501C	0.81	1.95
	1.73	4.14

3502 - 2 BED			
3502A	1.27	3.05	
	1.27	3.05	

3503 - STUDIO		
3503A	0.16	0.38
	0.16	0.38

3504 - STUDIO			
	3504A	0.38	0.90
,		0.38	0.90

3505 - 1 BED		
3505A	1.28	3.08
3505B	0.49	1.17
	1.77	4.25

3506 - 1 BED			
3506A	0.36	0.86	
	0.36	0.86	

THE APARTMENT STORAGE SCHEDULE REFLECTS TYPICAL LEVELS ONLY. INDIVIDUAL LEVELS ARE NOT SHOWN, AND THE STORAGE COUNT CORRESPONDS TO THE TYPICAL PLANS ADJACENT.

**QUALITY ASSURANCE** (FK IS A CERTIFIED COMPANY TO ISO 9001-2015) THIS PROJECT IS SUBJECT TO THE FK QUALITY ASSURANCE SYSTEM UNCONTROLLED COPY NOTES
THIS DRAWING IS COPYRIGHT AND SHALL REMAIN THE PROPERTY OF FENDER KATSALIDIS (AUST) PTY LTD CHECK AND VERIFY ALL DIMENSIONS ON SITE PRIOR TO COMMENCING WORK. DRAWING TO BE READ IN CONJUNCTION WITH ALL

OTHER CONTRACT DOCUMENTS. DO NOT SCALE DRAWINGS. USE FIGURED DIMENSIONS ONLY. SEEK CLARIFICATION OF INCONSISTENCES / CONFLICTS.

410-416 VICTORIA AVE CHATSWOOD

NOVUS ON VICTORIA

FENDER KATSALIDIS WWW.FKAUSTRALIA.COM L21, 259 GEORGE STREET, SYDNEY NEW SOUTH WALES 2000 AUSTRALIA TELEPHONE: +61 2 8216 3500 FENDER KATSALIDIS (AUST) PTY LTD ACN 092 943 032




SCALE DRAFT, SUBJECT TO REVISION WITHOUT NOTICE

NOT FOR CONSTRUCTION BW/DS CB 18.03.25 23115

STORAGE DRAWINGS AND SCHEDULES



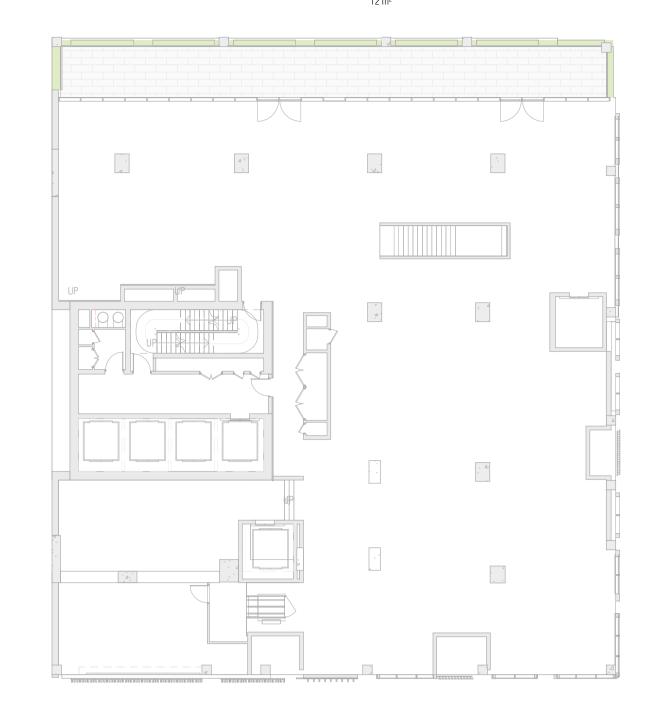


1 LEVEL 1

PLANTING 57 m<sup>2</sup>



2 LEVEL 2

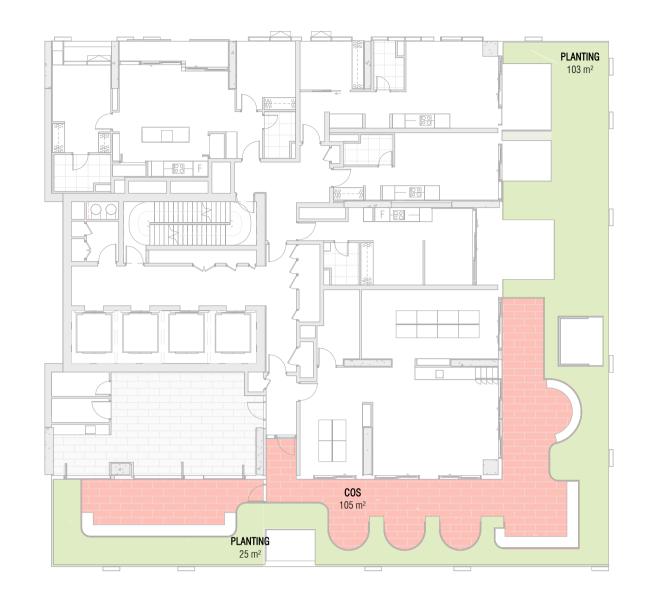

3 LEVEL 6



4 LEVEL 23

PLANTING		
Level	Area	Name
LEVEL 1	12 m <sup>2</sup>	PLANTING
LEVEL 2	124 m <sup>2</sup>	PLANTING
LEVEL 6	128 m <sup>2</sup>	PLANTING
LEVEL 23	17 m <sup>2</sup>	PLANTING
TOTAL	281 m <sup>2</sup>	

TERRACE		
Level	Area	Name
LEVEL 2	105 m <sup>2</sup>	COS
LEVEL 6	105 m <sup>2</sup>	COS
LEVEL 23	176 m <sup>2</sup>	COS
TOTAL	386 m <sup>2</sup>	

Autodesk Docs://23115 410-416 Victoria Avenue Chatswood/23115\_GENERAL\_R24.rvt

A SSDA LODGEMENT 18.03.25

QUALITY ASSURANCE (FK IS A CERTIFIED COMPANY TO ISO 9001-2015)

THIS PROJECT IS SUBJECT TO THE FK QUALITY ASSURANCE SYSTEM

UNCONTROLLED COPY

IF THIS DRAWING IS STAMPED 'UNCONTROLLED COPY' THEN IT IS TO BE CONSIDERED A DRAFT, SUBJECT TO REVISION WITHOUT NOTICE

NOT FOR CONSTRUCTION

NOTES
THIS DRAWING IS COPYRIGHT AND SHALL REMAIN THE PROPERTY OF FENDER KATSALIDIS (AUST) PTY LTD CHECK AND VERIFY ALL DIMENSIONS ON SITE PRIOR TO COMMENCING WORK. DRAWING TO BE READ IN CONJUNCTION WITH ALL OTHER CONTRACT DOCUMENTS. DO NOT SCALE DRAWINGS. USE FIGURED DIMENSIONS ONLY. SEEK CLARIFICATION OF INCONSISTENCES / CONFLICTS.



NOVUS ON VICTORIA
410-416 VICTORIA AVE CHATSWOOD

NOVUS


FENDER KATSALIDIS


WWW.FKAUSTRALIA.COM
L21, 259 GEORGE STREET, SYDNEY
NEW SOUTH WALES 2000 AUSTRALIA
TELEPHONE: +61 2 8216 3500
FENDER KATSALIDIS (AUST) PTY LTD ACN 092 943 032


33 032

DRAWN CHECKED DATE JOB NO. SCALE DRAWING TITLE
BW/DS CB 18.03.25 23115 1:200 @A1 COMPLIANCE - COMMUNAL OPEN SPACE, TERRACE AND LANDSCAPE



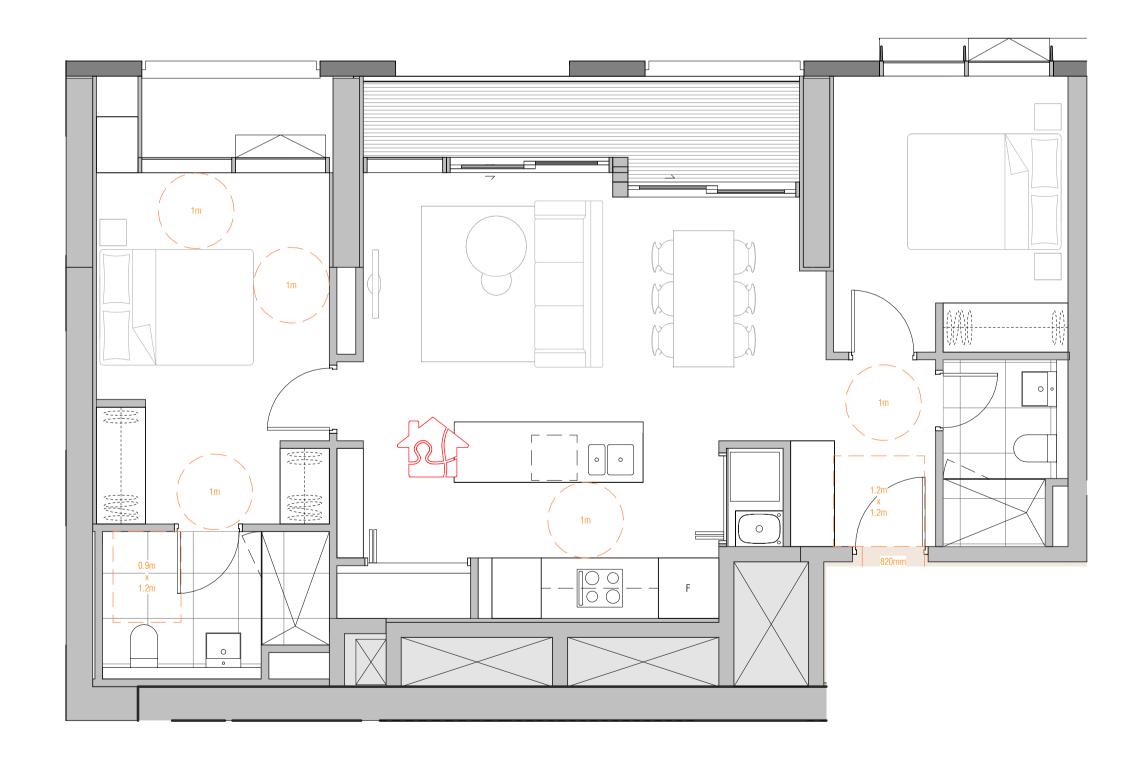

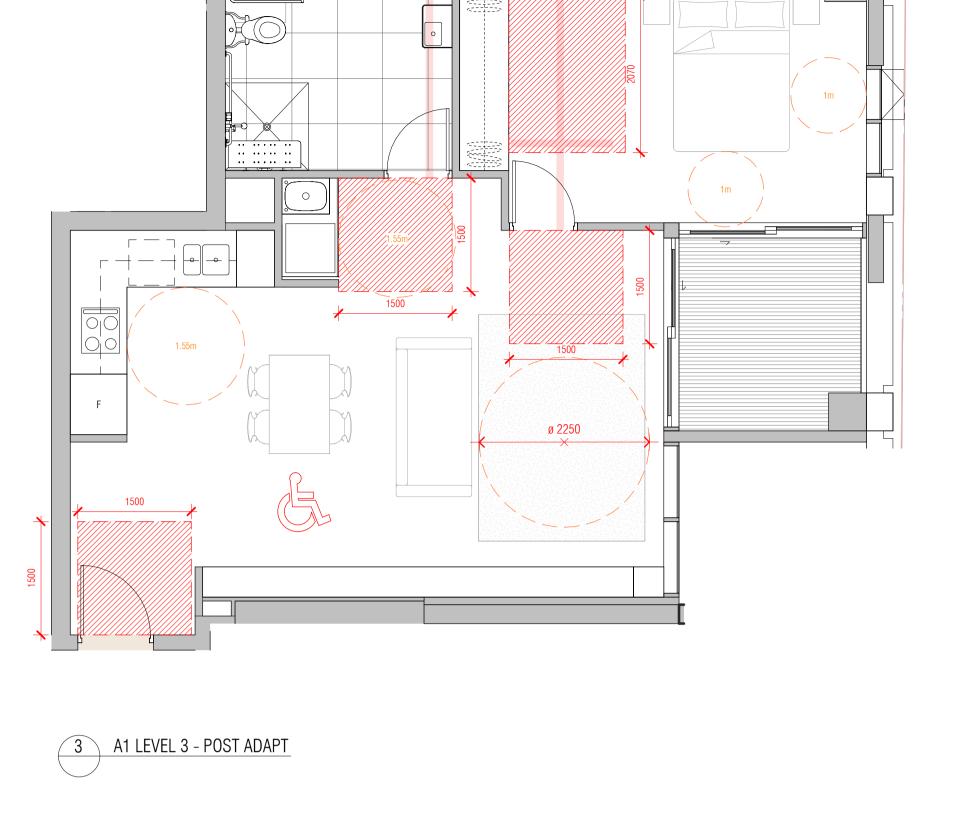

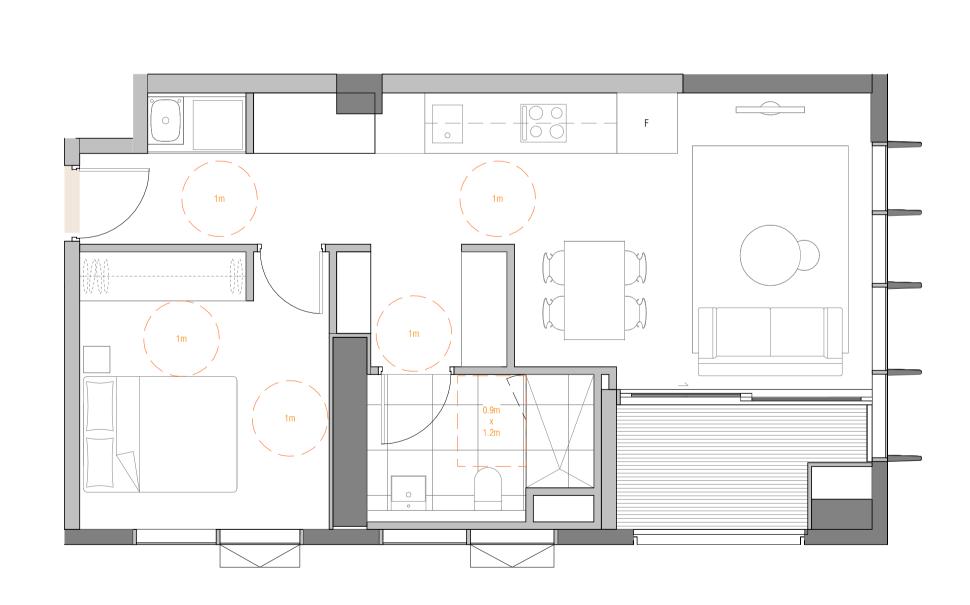

# 76 LIVABLE APARTMENTS -SILVER LEVEL (29%)

LHA SILVER		
LEVEL	NUMBER	
[		
LEVEL 3	301	
LEVEL 4	401	
LEVEL 5	501	
LEVEL 6	601	
LEVEL 7	701	
LEVEL 7	706	
LEVEL 8	801	
LEVEL 8	806	
LEVEL 9	901	
LEVEL 9	906	
LEVEL 10	1001	
LEVEL 10	1006	
LEVEL 11	1101	
LEVEL 11	1106	
LEVEL 12	1201	
LEVEL 12	1206	
LEVEL 13	1301	
LEVEL 13	1306	
LEVEL 14	1401	
LEVEL 14	1406	
LEVEL 15	1501	
LEVEL 15	1506	
LEVEL 16	1601	
LEVEL 16	1606	
LEVEL 17	1701	
LEVEL 17	1706	
LEVEL 18	1801	
LEVEL 18	1806	
LEVEL 19	1901	
LEVEL 19	1906	
LEVEL 20	2001	
LEVEL 20	2006	
LEVEL 21	2101	
LEVEL 21	2106	
LEVEL 22	2201	
LEVEL 22	2206	
LEVEL 24	2401	
LEVEL 24	2405	
LEVEL 25	2501	
	2001	

LHA SILVER		
LEVEL	NUMBER	
LEVEL 25	2505	
LEVEL 26	2601	
LEVEL 26	2605	
LEVEL 27	2701	
LEVEL 27	2705	
LEVEL 28	2801	
LEVEL 28	2805	
LEVEL 29	2901	
LEVEL 29	2905	
LEVEL 30	3001	
LEVEL 30	3005	
LEVEL 31	3101	
LEVEL 31	3105	
LEVEL 32	3201	
LEVEL 32	3205	
LEVEL 33	3301	
LEVEL 33	3305	
LEVEL 34	3401	
LEVEL 34	3405	
LEVEL 35	3501	
LEVEL 35	3505	
LEVEL 36	3601	
LEVEL 36	3605	
LEVEL 37	3701	
LEVEL 37	3705	
LEVEL 38	3801	
LEVEL 38	3805	
LEVEL 39	3901	
LEVEL 39	3905	
LEVEL 40	4001	
LEVEL 40	4005	
LEVEL 41	4101	
LEVEL 41	4105	
LEVEL 42	4201	
LEVEL 42	4205	
LEVEL 43	4301	
LEVEL 43	4305	
TOTAL LHA UN		

TOTAL LHA UNITS: 76

## 3 ADAPTABLE UNITS

ADAPTABLE		
LEVEL	NUMBER	
LEVEL 3		304
LEVEL 4		404
LEVEL 5		504
TOTAL ADAPTAB	LE UNITS: 3	

2 LIVABLE APARTMENT TYPE 01

4 LIVABLE APARTMENT TYPE 02

Autodesk Docs://23115 410-416 Victoria Avenue Chatswood/23115\_GENERAL\_R24.rvt

A SSDA LODGEMENT

18.03.25

**QUALITY ASSURANCE** (FK IS A CERTIFIED COMPANY TO ISO 9001-2015) THIS PROJECT IS SUBJECT TO THE FK QUALITY ASSURANCE SYSTEM UNCONTROLLED COPY

IF THIS DRAWING IS STAMPED 'UNCONTROLLED COPY' THEN IT IS TO BE CONSIDERED A DRAFT, SUBJECT TO REVISION WITHOUT NOTICE NOT FOR CONSTRUCTION

NOTES
THIS DRAWING IS COPYRIGHT AND SHALL REMAIN THE PROPERTY OF FENDER KATSALIDIS (AUST) PTY LTD CHECK AND VERIFY ALL DIMENSIONS ON SITE PRIOR TO COMMENCING WORK. DRAWING TO BE READ IN CONJUNCTION WITH ALL OTHER CONTRACT DOCUMENTS. DO NOT SCALE DRAWINGS. USE FIGURED DIMENSIONS ONLY. SEEK CLARIFICATION OF

18.03.25 23115 1:50@A1

NOVUS ON VICTORIA 410-416 VICTORIA AVE CHATSWOOD NOVUS

FENDER KATSALIDIS
WWW.FKAUSTRALIA.COM
L21, 259 GEORGE STREET, SYDNEY NEW SOUTH WALES 2000 AUSTRALIA TELEPHONE: +61 2 8216 3500 FENDER KATSALIDIS (AUST) PTY LTD ACN 092 943 032



ISSUE PURPOSE COMPLIANCE - LIVABLE/ADAPTABLE APARTMENTS