

Multi-Story Warehouse and Distribution Centre Charter Hall Design Report March 2022

ISSUE 04

Client

Charter Hall



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architecture

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Acknowledgment of Country

We acknowledge the enduring spirit of Country and the stories, songlines, languages, land, skies and waters that have nurtured the local people here since the beginning of time. We pay our respects to the local peoples of the Gadigal of the Eora Nation what we now call Sydney, who have cared for their Country for thousands of generations.

We also acknowledge the peoples of the Gadigal of the Eora Nation who hold trade and care responsibilities to the Country upon which the distributions centre will be developed.

We pay respect to their elders past, present and emerging and recognise their continuing, living practices, acknowledging the intricate knowledges and kinship relationships they each hold to this Country. They are, and forever will be, embedded within this space.

We also acknowledge the many First Nations people who now know this Country as their home and mother and recognise the care-taking relationships they hold here.

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D1 INTRODUCTION

INTRODUCTION

Executive Summary

Charter Hall are seeking to establish a state of the art multistory industrial development located at 520 Gardeners Road

The Proposal

Construction of a multi level warehouse and distribution centre comprising 21,952 m2 of warehouse and distribution GFA with 5,557 m2 ancillary office space, landscaping at ground and second floor levels, bicycle and car parking.

Development Summary

The proposal comprises the redevelopment of the site as summarised below:

- Construction, fit out and operation of a two-storey warehouse and distribution centre comprising approximately 27,509 m2 GFA including:
- Provision of end of trip spaces at ground floor level _ and 144 car parking spaces at second floor level.
- Approximately 4,511m2 of hard and soft landscaping _ at ground level and an additional 1,634 m2 of soft landscaping on the level two rooftop.

18,988m²	27,509m²	15%	15%
Site Area	Gross Floor Area	Deep Soil Area	Tree Canopy Cover
20,144m²	531m²	1,278m²	21,952m²
Warehouse	Ancillary	Service Vehicle Storage	Total Warehouse Area
144 Staff & Visitor Car Parking	3 Share Car Parking	12 Motorbike Parking	



INTRODUCTION

Compliance With SEAR's

This document has been prepared in consideration of the Planning Secretary's Environmental Assessment Requirements (SEARs). Table 3 and 4 below summaries all key issues relevant to this report and how they have been responded to.

Reference	Requirements	Response/Ref	
Issue and Ass	sessment Requirements		
3 Design Quality	Design Quality	Section 3.0 De design exceller	
	Demonstrate how the development will achieve:	guidelines.	
	 design excellence in accordance with any applicable EPI provisions. 		
	 good design in accordance with the seven objectives for good design in Better Placed. 		
4	Built Form and Urban Design		
	- Explain and illustrate the proposed built form, including a detailed site and context analysis to justify the proposed site planning and design approach.	building respo	
	 Demonstrate how the proposed built form (layout, height, bulk, scale, separation, setbacks, interface and articulation) addresses and responds to the context, site characteristics, streetscape and existing and future character of the locality. 		
	 Demonstrate how the building design will deliver a high-quality development, including consideration of façade design, articulation, materials, finishes, colours, any signage and integration of services. 		

/Reference

Design Proposal - Demonstrates how the building responds to ellence and the 7 objectives for good design in the Better Placed

ction 3.0 Design Proposal - This section demonstrates how the sponds to built form and urban design

02 LOCATION & CONTEXT

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LOCATION & CONTEXT

Locality - The Greater Sydney Context & Alexandria



The site is located within the suburb of Alexandria under the Sydney Local Government Area ().

The site is located approximately 6 km south of Sydney CBD, and 2.5 km North of Sydney airport.

The site is located on the corner of Bourke and Gardeners Roads. The site is well connected with left in and signalized right in vehicular access on the south east corner along Gardeners Road.

Second vehicular entry and exit on the north west corner along Bourke Road

Other significant Roads in the greater context include the Princes highway intersecting Canal Road to the west, M8 St Peters Interchange and Botany Road intersecting Gardeners Road to the east.

The site is also situated within close proximity to Mascot train stations and Mascot Bus Terminus.



B Bus Terminu:

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LOCATION & CONTEXT

Planning Controls





(Source: Extract from Sydney Local Environment Plan 2012)





SITE CONTEXT

The Site



Site Context

Located at the edge of souther enterprise area, the site has 2 frontages - Gardeners Road to the south and Bourke to the west.

The site is surrounded by a range of diverse land use.

In the immediate context:

The North and East of the site is wrapped by an existing 4 level data centre, with approved expansion to the south.

Gardeners Road to the south is fronted by offices with medium density mixed used residential to the east and west of these office.

Along Bourke Road to the west is mix of both large and small industrial distribution centre.

Bourke Road also connects the site to local centres and Mascot trains station.

Beyond the immediate context the North, East and west of the site of the site is connecting to general industrial area that consists standalone warehouses as well as industrial units which provides space for small businesses and south of the site is predominately mix used buildings .

> MIXED USE - ENTERPRISE CORRIDOR MIXED USE - RESIDENTIAL



SITE ANALYSIS Topography & Existing Trees



Existing Structure

The site is currently is occupied by a large purpose built shed for Bunnings.

Existing Topography

The site is relatively flat given that it is a large developed site, having a gentle slope of about 0.3m difference from north to south, 0.5m from east to west and 0.2m across the site


Existing Trees

The site has 2 small clusters of trees to the north west and south east corners of the site



SITE ANALYSIS

Street Frontages, Solar Access

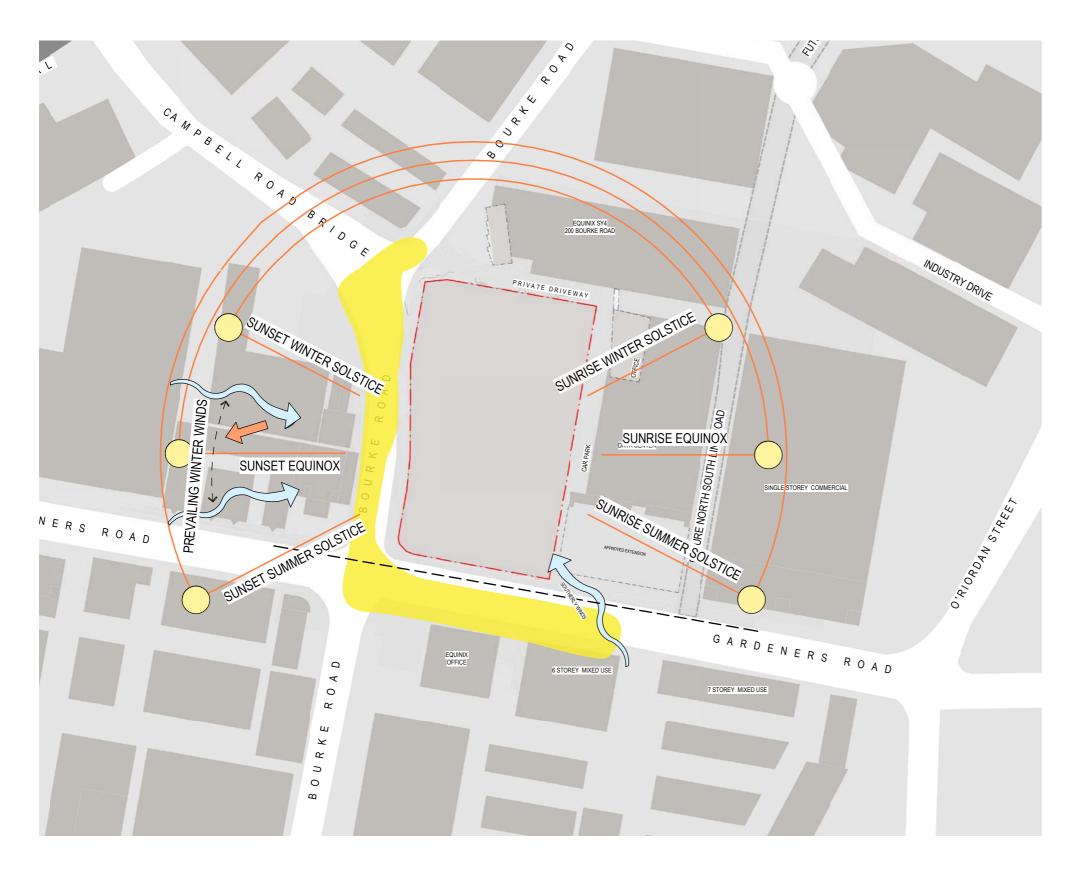

Street Frontages


The site has two street frontages: Frontage on Gardeners Road to the south and a frontage on Bourke Road to the west.

Solar Access

The site also enjoys good solar access on the north and is subject to moderate overshadowing within the site



site analysis Pedestrian & Transport Network

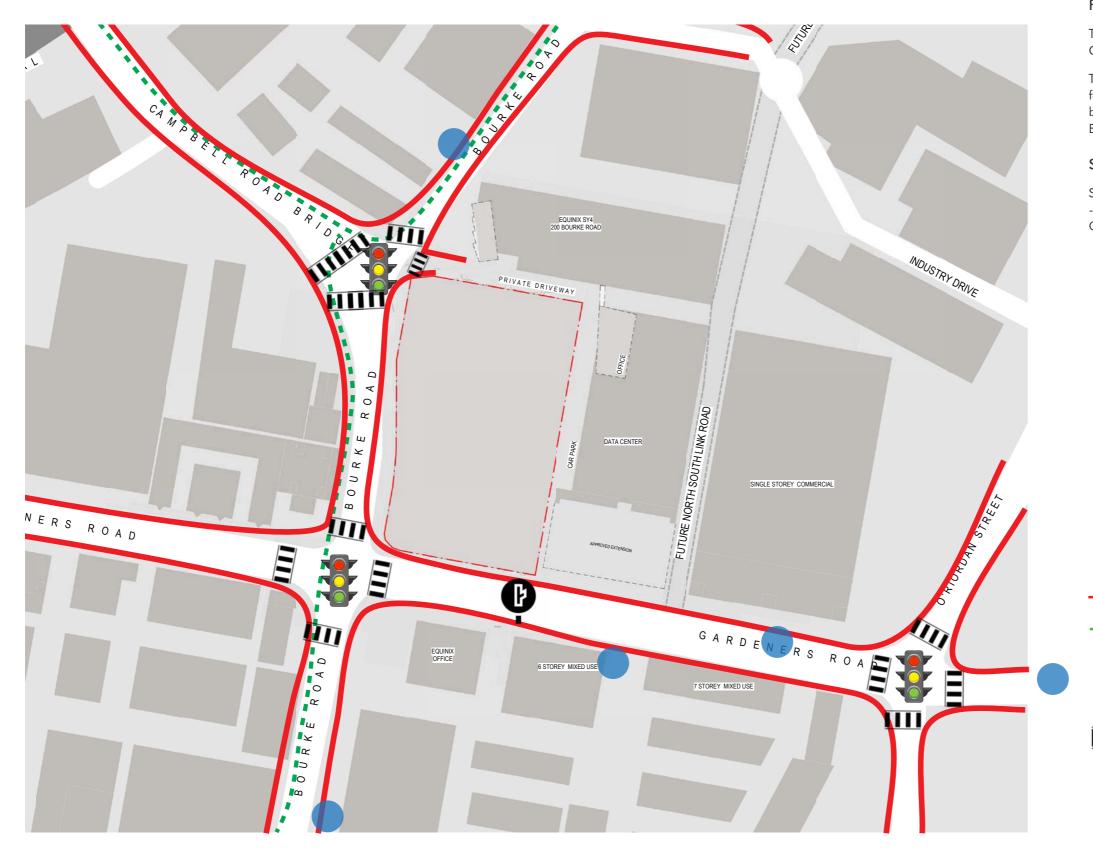

Pedestrian & Transport Network

The site is conveniently serviced by a few bus stops on Gardeners Road and Bourke Road

The site is also well-serviced by established pedestrian footpaths and bicycle paths. Street crossings are supported by signalized intersection - Bourke Road + Gardeners Road, Bourke Road and Cambell Road Bridge


Street Crossings

Street crossings are supported by signalized intersection - Bourke Road + Gardeners Road , Bourke Road and Cambell Road Bridge



SITE ANALYSIS

Key Views Of The Site, Site Access

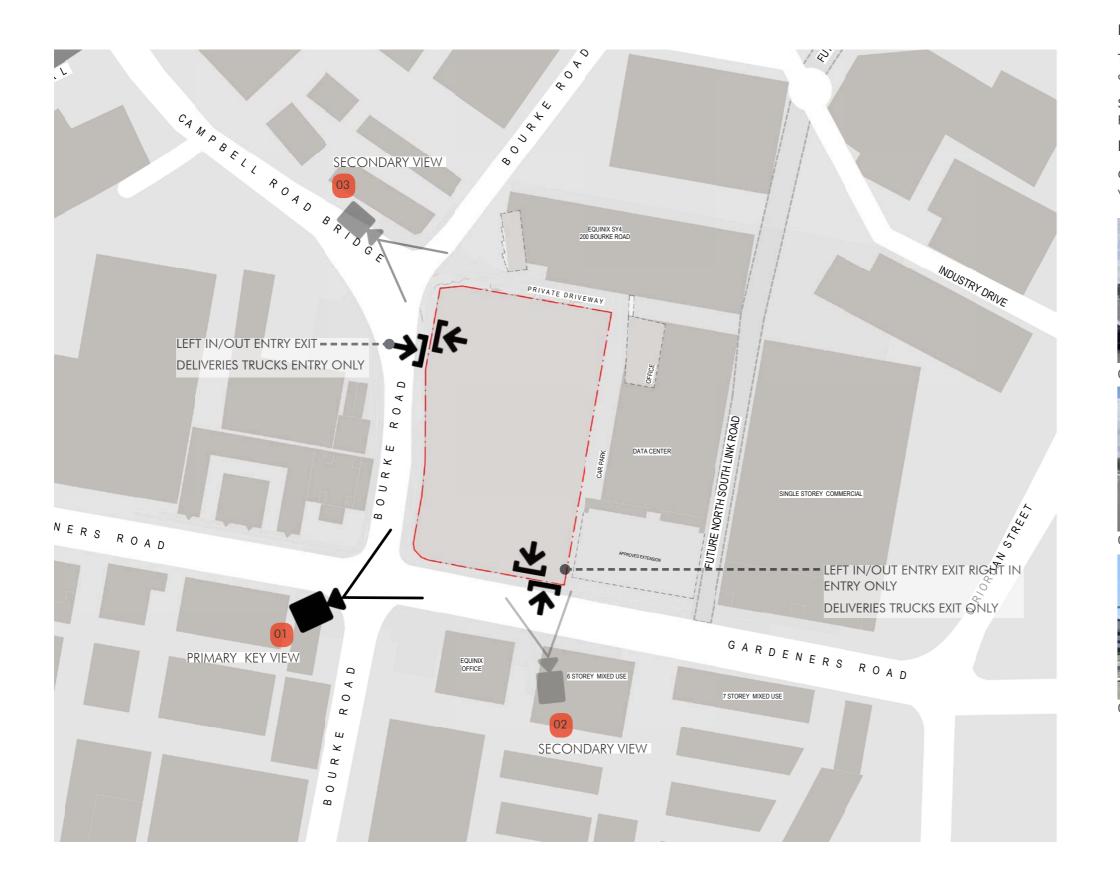

Existing Vehicular Entry and Exit

The site is well connected with left in and signalized right in on the south east corner along Gardeners Road.

Second entry and exit on the north west corner along Bourke Road

Key View of The Site

Corner of Bourke Road and Gardeners Road is the main view to present the development.




01 - View from corner of Bourke and Gardeners Road




02 - View from South East corner on Gardeners Road



03 - View from North West corner on Bourke Road

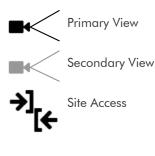

Design Principles

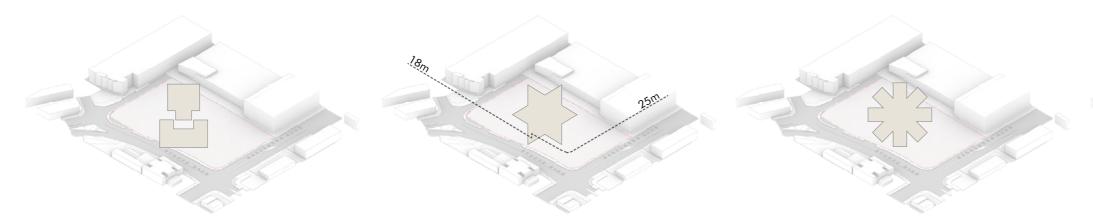

BETTER FIT Context & Location

An investigation into the distinctive character of the local area, including prominent natural & built features, social, economic, and environmental conditions, the overall built environment.

The design responds intelligently and sensitively to these factors and makes a positive contribution to the streetscape, neighbourhood and neighbouring sites. The design has also considered the future desired character of the area and its interfaces.

BETTER LOOK AND FEEL Built Form and Scale

The built form successfully responds to its setting and the future character and setting of the location.

Its prominent location on the Road intersection and Road exposure has been recognised, in addition the form and scale of the built form also responds to the functionality of the space, operation and integration with the surrounding use context so as to present a modern considered approach to the continuation of employment in the neighbourhood.

BETTER WORKING Functionality & Quality

The design seeks to balance the needs of the user efficiently and effectively.


Space and purpose have been designed to respond to a well thought through relationship and ease of what this spaces is used.

Space have been made as flexible and as adaptive as possible to minimise possible future modifications and maximise the life cycle of the development.

Material selections, durability and their relationships have been considered as has the detailing and weather implications to ensure the quality of the finished form and its life cycle into the future.

Landscape

The design recognises that landscape and building operate together and as an integrated and sustainable system.

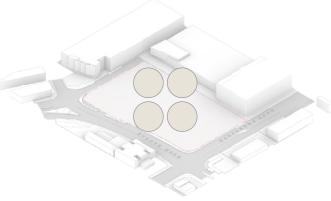


BETTER FOR COMMUNITY Legibility

The built form has a clear identity and its uses and components have been clearly defined for ease of operations and use. The overall design has enabled this legibility to compliment the design outcome.

Community

The design responds to the local community context, the wider social context. The function itself will create employment opportunity for the diverse local community and encourage diverse social interaction.

DESIGN PROPOSAL Design Principles

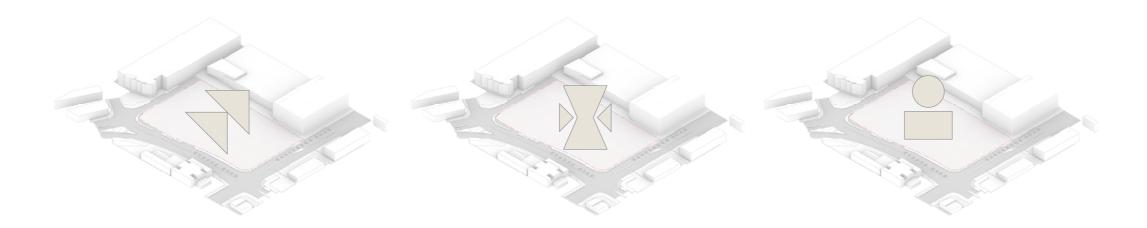

BETTER VALUE

Amenity

The design has successfully responded with the provision of a variety of uses, proximity to supporting amenity as well as optimising internal and external amenity for the users.

BETTER PERFORMANCE

Sustainability

The design has considered a sustainable landscape in an urban setting and sought to improve and organise the existing urban realm and streetscape, responding to the desired future character.

The built form and function has considered practical and effective sustainable measures, relating to shading, ventilation, power generation and water.

BETTER FOR PEOPLE

Safety

Safety has been considered and evaluated in the design process to ensure risk and harm are minimised and safe behaviour and use are supported.

Aesthetics

The design has taken on board the design principles identified and produced a building that has resolved the challenges and embraced the opportunities to achieve an elegant coherent outcome.

The arrangement of built form and space has been considered in it's context. The design has addressed the varying scales and form of the building in the selection and association of materials and colour. This has enabled a skilled integrated and considered design response.

Design Proposition

How do you create a warehouse and distribution centre (referred to typology hence forth) that is traditionally found on the fringes of urban development and bring it into the heart of any city?

How do you create a development which allows for servicing the needs of the city without reducing efficiency of supply chain and helps in reducing time, traffic emission's, effort and cost? A development which provides easy access and availability to the work force.

Why are these typologies found in the fringes?

- The lack of or unavailability of large parcels of land that could accommodate the functioning of the program
- The functions are considered as undesired due to the large amounts of noise pollution and traffic congestion it brings to an locality.
- This typology does not provide amenity to the locality they are located within.
- The built form is designed more functional and introverted, Serving only the need of the projects.

The fundamental drivers for this type of development

- High land cost Industrial land value in Sydney have raised dramatically in past 5 years and continue to climb _
- Limited land availability in key locations _
- Consumer expectations are changing as fast deliveries become increasingly important to customers, warehouses in _ close proximity to the end user are in high demand
- Tenants want to optimise and increase efficiency of cartage and container costs by creating centralised network locations


Considerations For multi-storey development

- Low Population density
- Land availability in the right network location _
- Decreased floor plates means that tenants focus on the efficiency and process flow of their facilities. This increases cost and increases the dependency on automation

Key Responses To Proposition:

The following pages demonstrate how our proposal looks to mitigate the above mentioned impacts through

- Locating the site
- Stacking the program
- Activated frontages
- Public amenities
- Acoustic treatment
- Visual impact

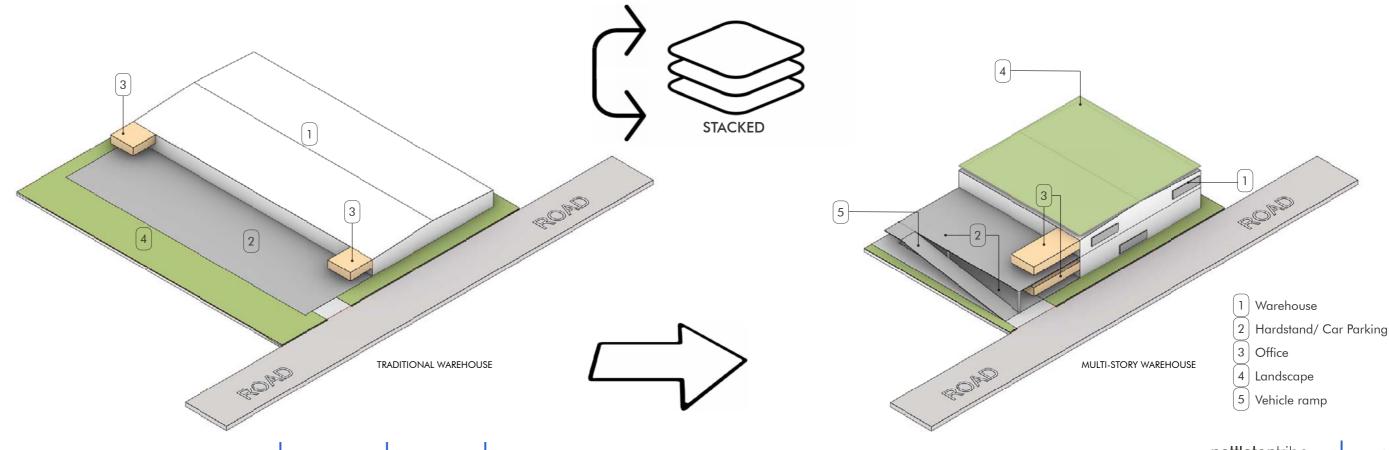

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DESIGN PROPOSAL Design Proposition

A Multi-story warehouse is a development consisting of more than one level, increasing the usable floor space per square metre of the land and creating more efficient and sustainable design.

To date, the concept has seen limited take-up in Australia due to availability of relatively cheap and developable land. However in many countries like Hong Kong & Singapore limited land availability has led to developments of several multistory warehouses , at times 20 stories tall.

Another driver in demand for multi-strorey warehousing is the growing need for occupiers to be located close to ports and the consumer base.

In Sydney, with the airport and sea ports expanding in output, along with infrastructure projects and the changing use of land, the demand for space in South Sydney is high. Multi-storey warehousing is one way to deal with diminishing land supply without impacting the consumer whilst delivering a development that can contribute positively to the local area.










March 2022 [04]

Design Evolution

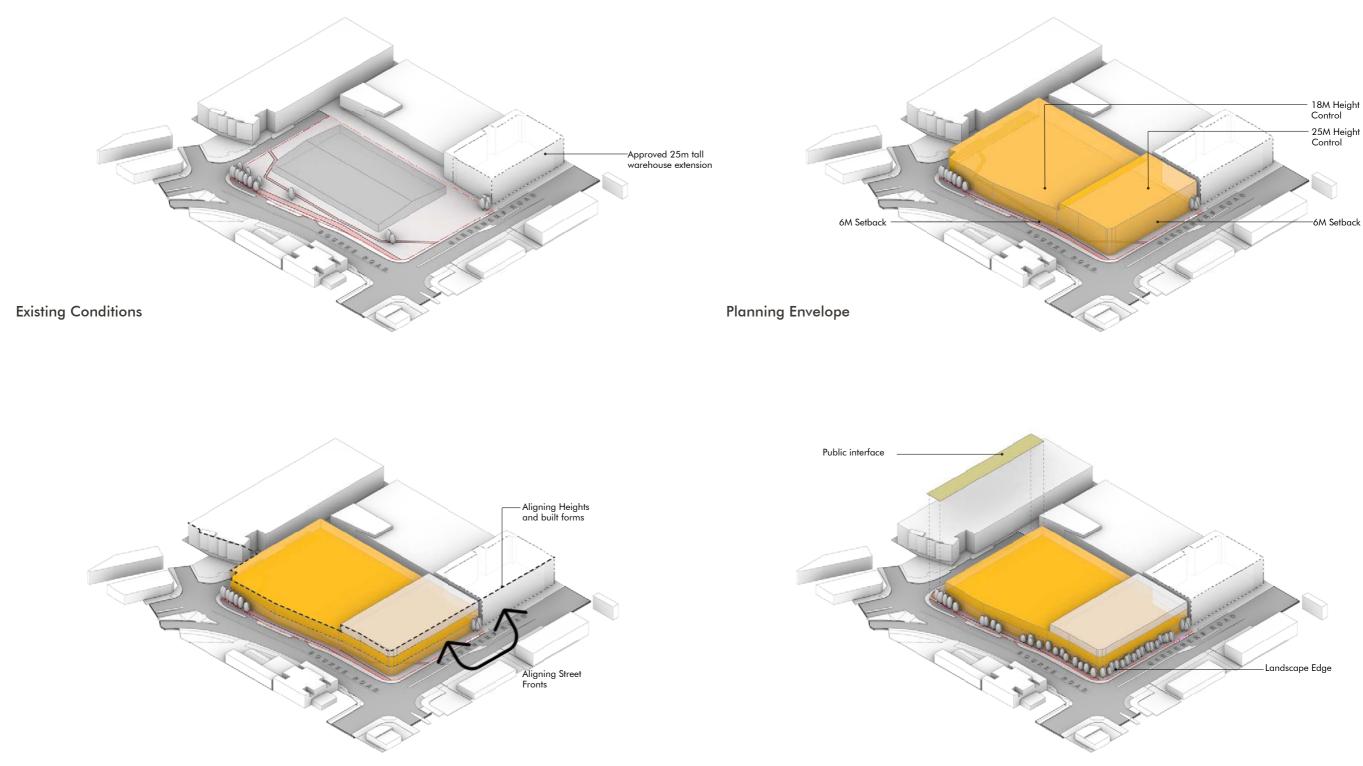


Dividing The Envelope


Splitting the envelope in 9m functioning volumes for storage use, additional height on top on Gardeners Road is used as office as height in sufficient for warehouse use

Public Realm

The norther edge of the building is set back to introduce a public edge to interface with neighbouring context and enjoy less exposed street face.


DESIGN PROPOSAL Design Evolution

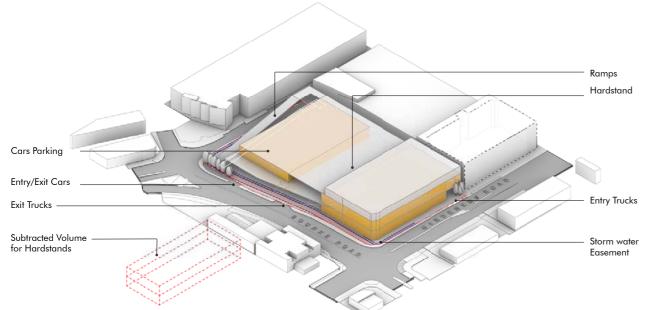


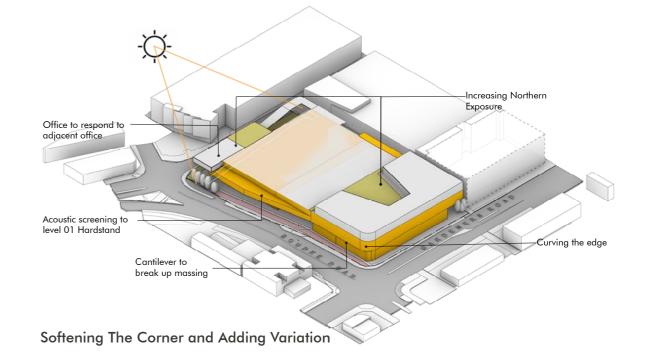

Adding Hardstands Entry / Ramp


Using existing entry along Gardeners Road for truck entry and providing and new exit at Bourke Road. Using existing entry/exit on Bourke Road for car access. Splitting the movements of car and trucks on site.

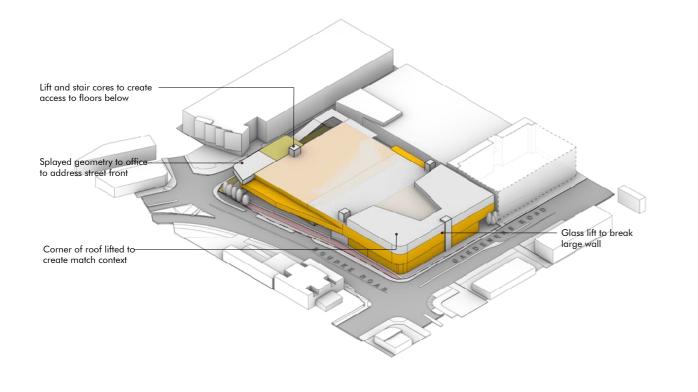

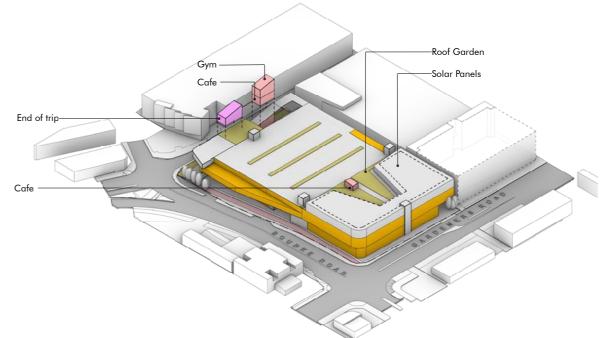

Public Amenity

Public Domain And Landscape Design

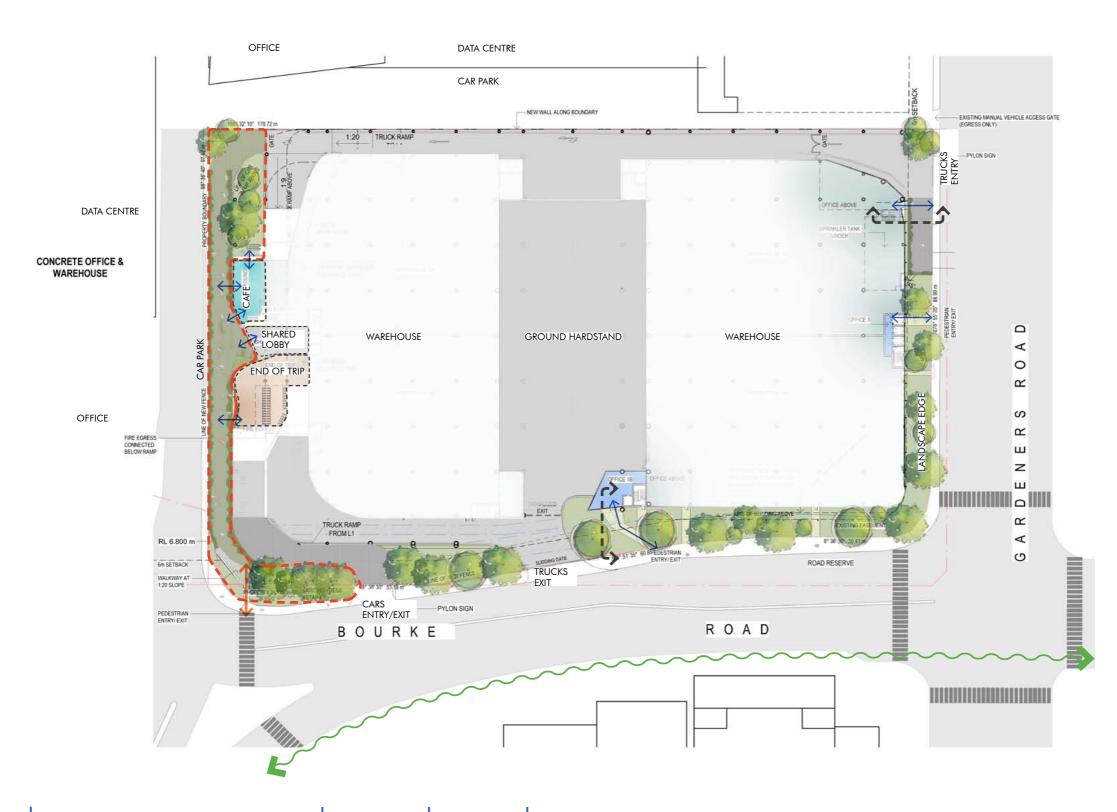

4 STORY BUILDING B/200 BOURKE ROAD



Section Building Entry Pedestrian/Bike Entry Existing Bike Path Existing Pedestrian Crossover




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DESIGN PROPOSAL Public Domain And Landscape Design



DESIGN PROPOSAL Public Domain And Landscape Design



Setback to Road

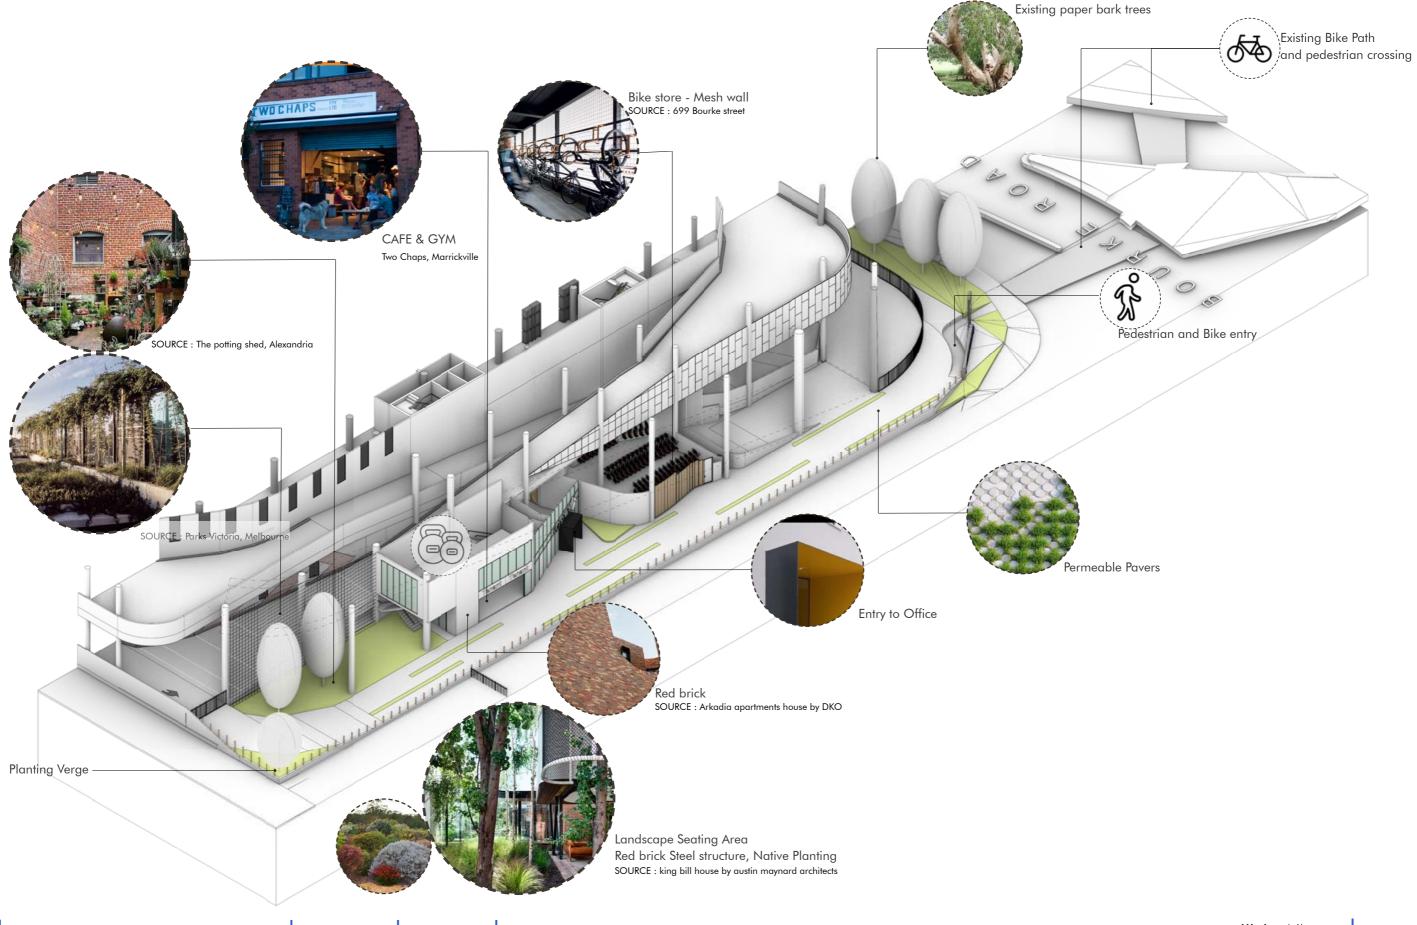Dynamic section response


Horizontal sections shifts create a dynamic built form. This form creates and distinct silhouette for the city and elegantly integrates the 2 verticals mass with the base.


Grafting : Singular Mass Peeling

Due to the functioning of the typology the building is cut into two vertical masses having distinct identities. These are grafted onto one and other to produce a seamless mass that peels to respond to the site, light, air and views


Optimise Orientation

The northern office is further splayed outwards to optimise norther exposure and address the street intersections of Bourke road and Campbell bridge road.

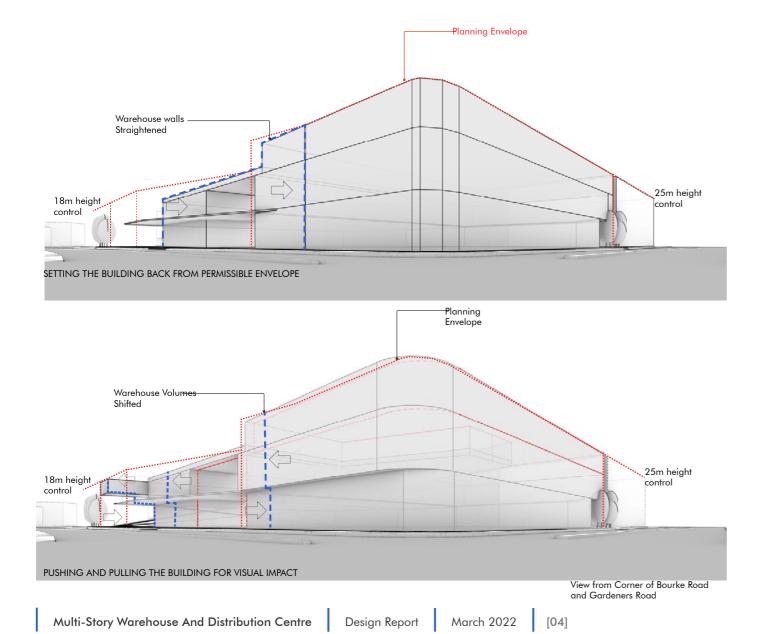

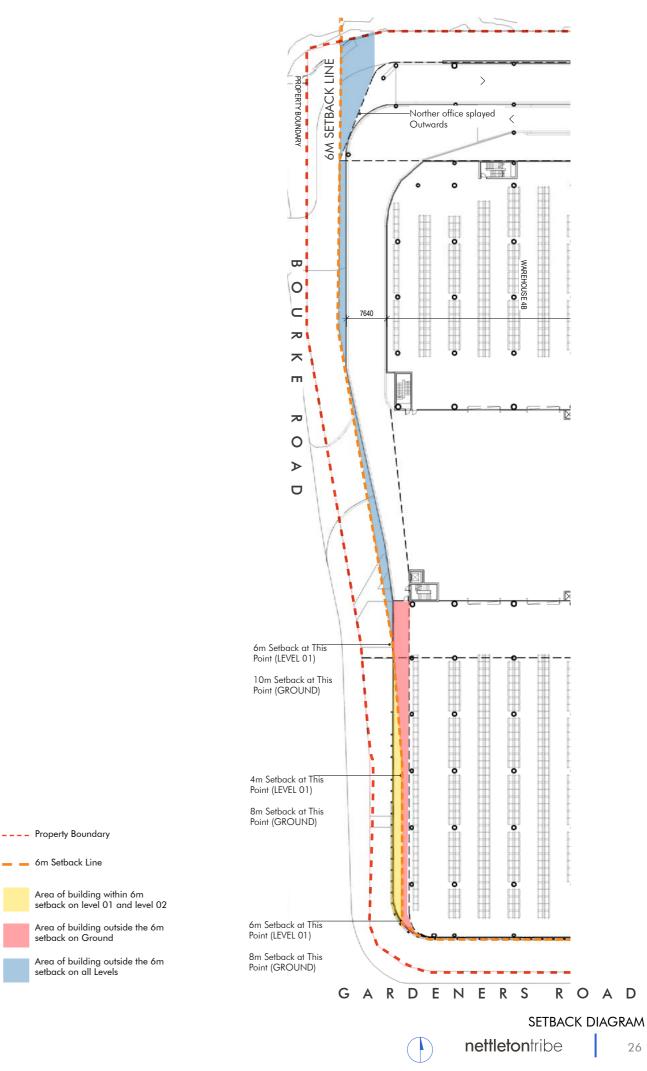

Traffic Management

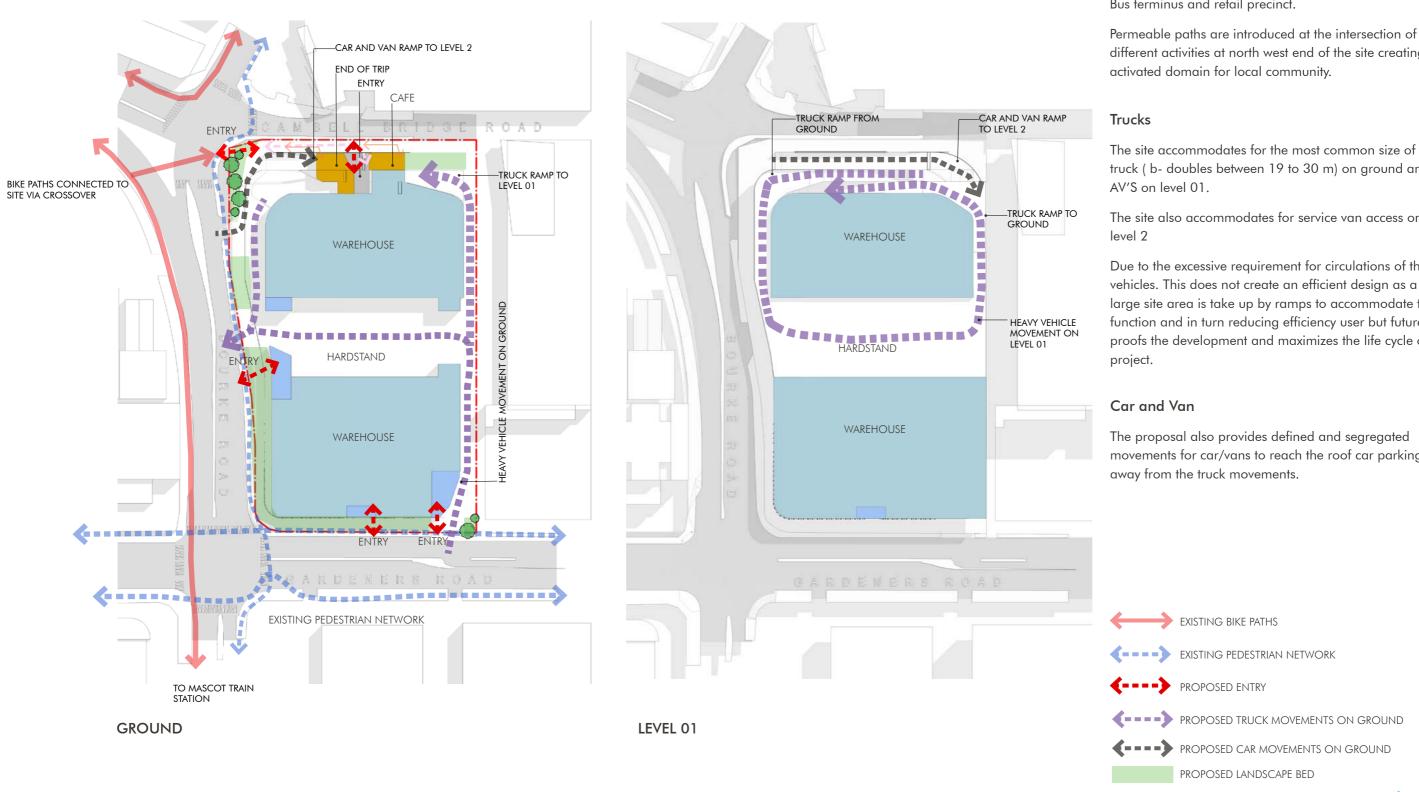

Existing pedestrian and cycle movements.

Existing cycle path and Pedestrian movements are along Bourke and Gardeners Road connection to Mascot Train. Bus terminus and retail precinct.

Permeable paths are introduced at the intersection of different activities at north west end of the site creating an


truck (b- doubles between 19 to 30 m) on ground and

The site also accommodates for service van access on


Due to the excessive requirement for circulations of these vehicles. This does not create an efficient design as a large site area is take up by ramps to accommodate this function and in turn reducing efficiency user but future proofs the development and maximizes the life cycle of

movements for car/vans to reach the roof car parking



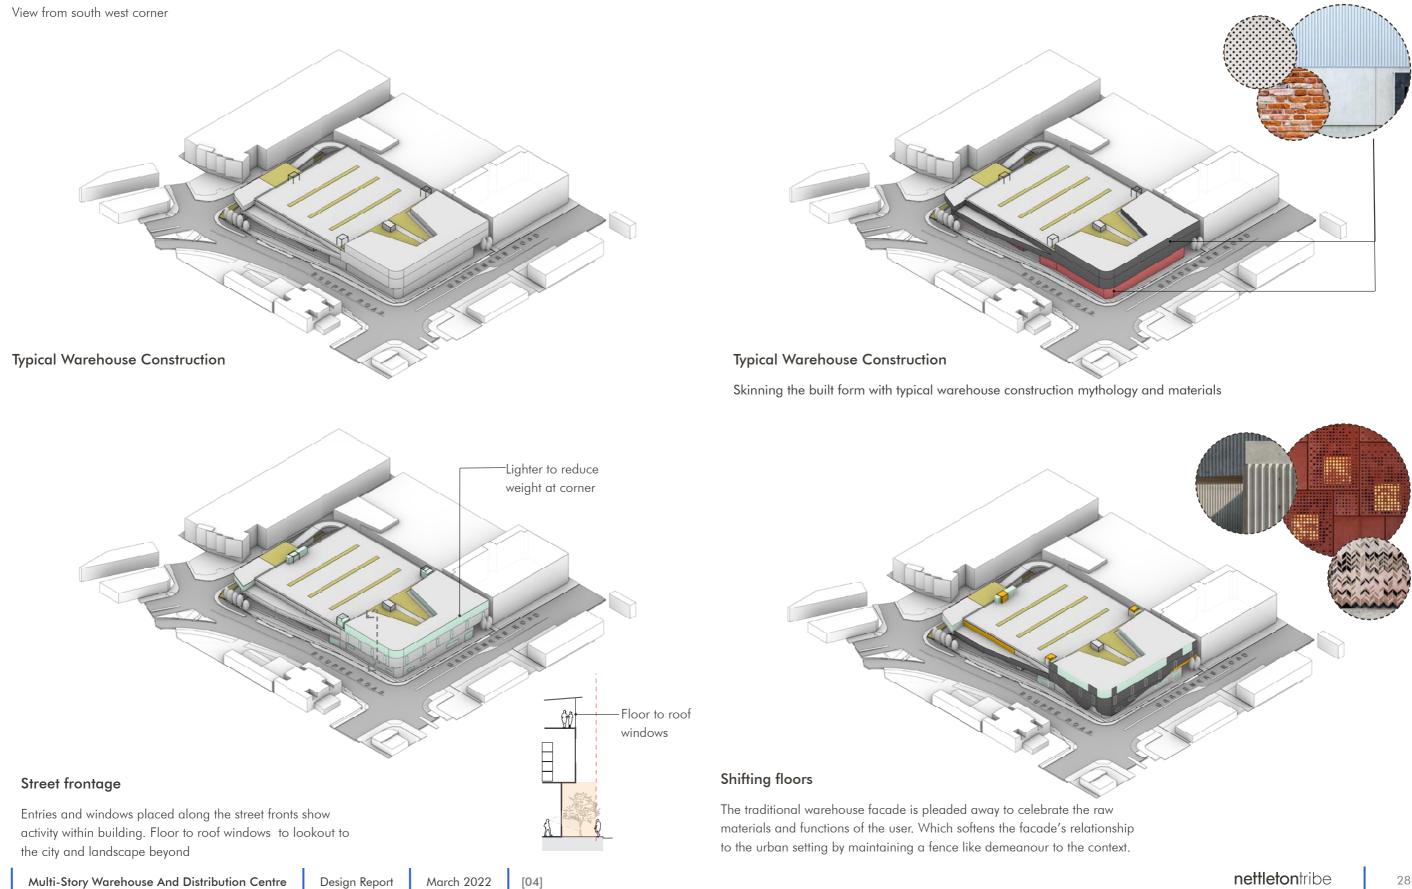

DESIGN PROPOSAL Facade Process

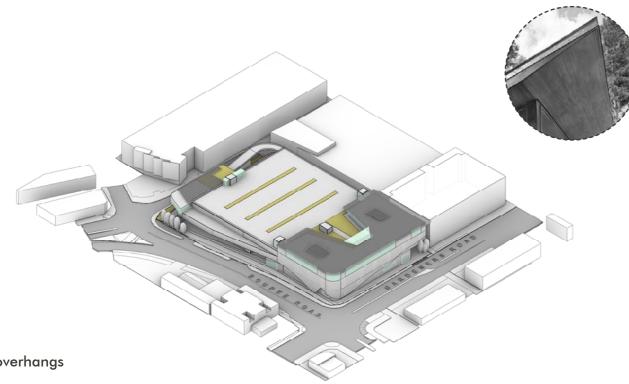


Roof overhangs


Adding shading devices and creating dynamic forms and create warm and light filled spaces

User Branding and Identification

Layering an physical identifier of the end users function to create building ownership and importance

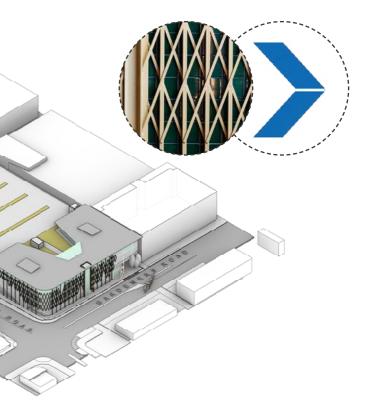


DESIGN PROPOSAL Facade Process

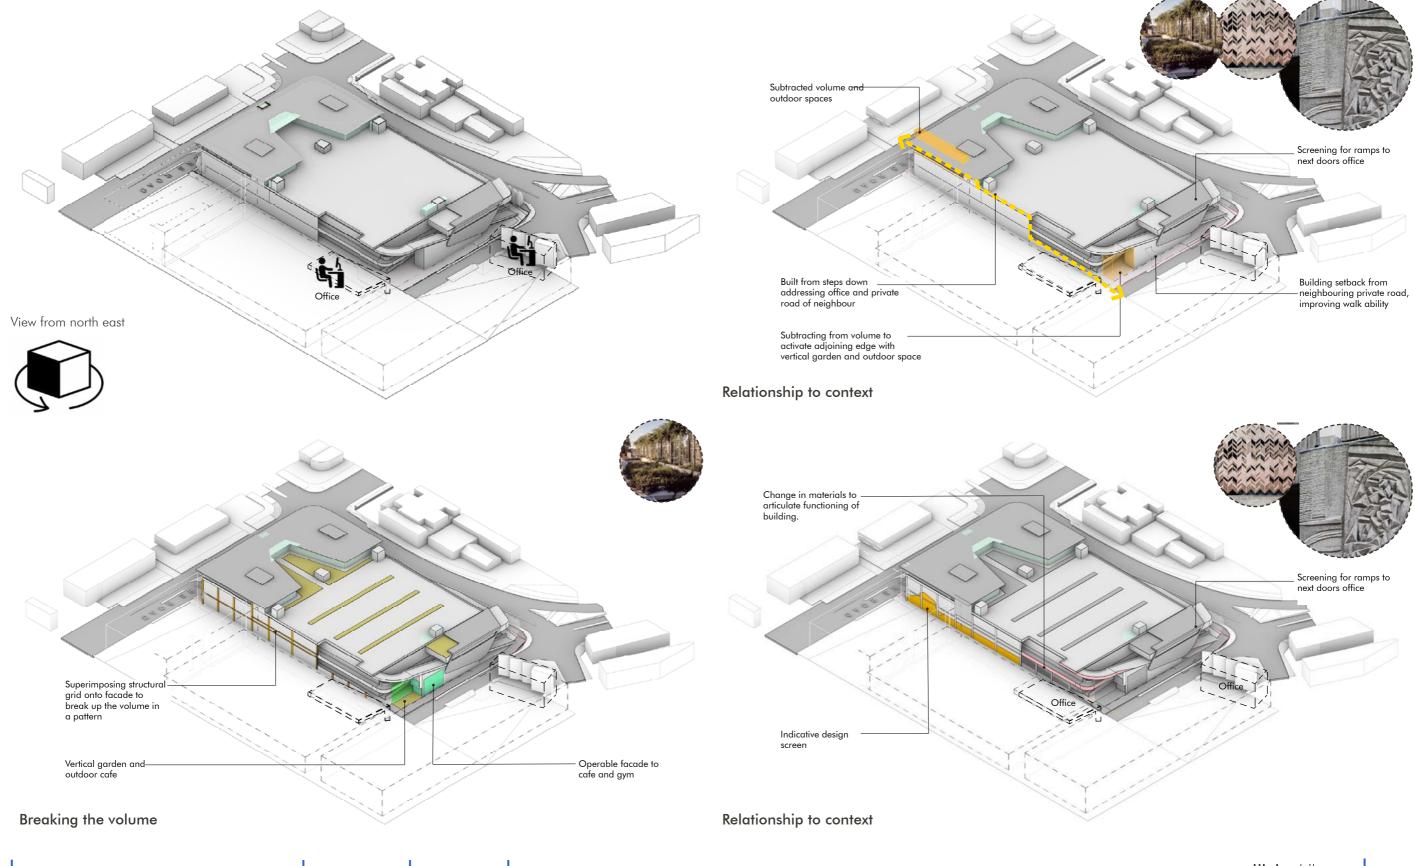

DESIGN PROPOSAL Height Blanket Diagrams

The building design has looked to maximise the efficiency and effectiveness of the intended program of distribution and storage. This is in line with the principles of the 'better working-functionality & quality' objectives outlined in this report.

To explain this in practical terms, in warehouse construction the floor to floor is based on pallet racking height (Typically pallets are 1395mm high). We have allowed for a 2000mm services and structure zone, Thus provide the end user with 5 high bay pallet racking option (Overall height racking will be circa 7000mm). Reducing the height by 500mm to 600mm (to accommodate the level 2 floor). The proposal will only be able to accommodate 4 high bay pallets racking a reduction of about 20% of storage area.

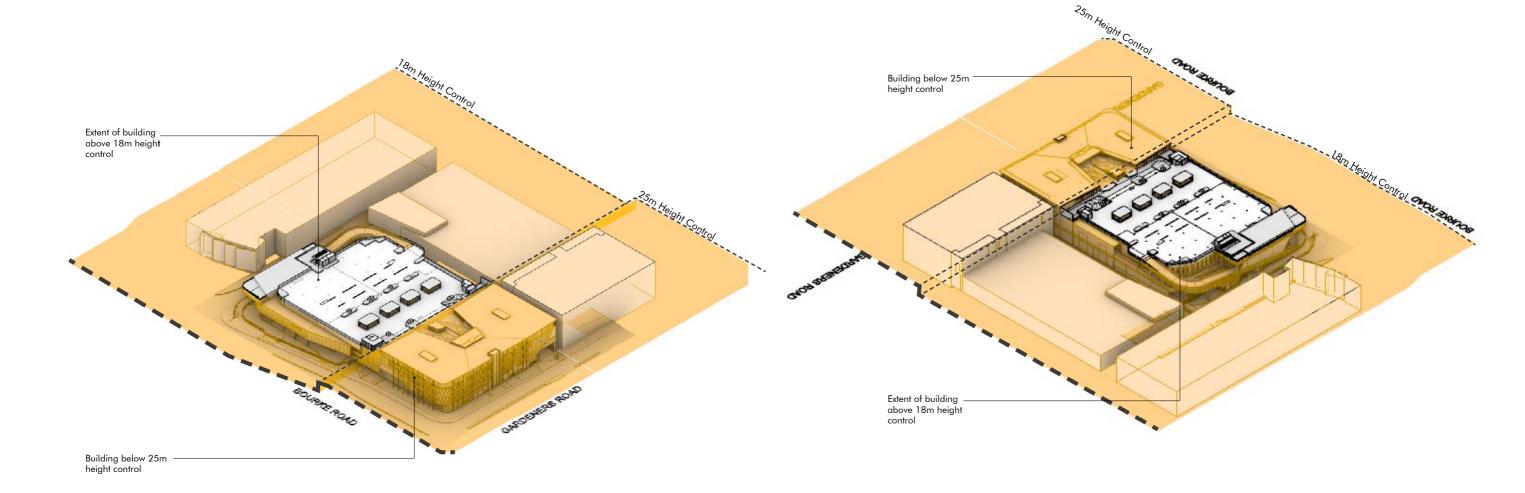

View from south west corner

View from north east corner



Architectural Precedents

Architectural precedents below have demonstrated desired characters derived from the concept and they have been adopted in the proposed design. Floating office with light soffit



Textured precast wall with brick walls

Textured banding with transparencies

Perforated brick batter type screen to soften façade







Universidad de Nevarra

Sports hall . Chitenay



Paramount House Hotel

Diagonal bracing at corner to create layers




Publishing house for taz newspaper

DESIGN PROPOSAL Warehouse Component - Materiality



View From South East On Gardeners Road

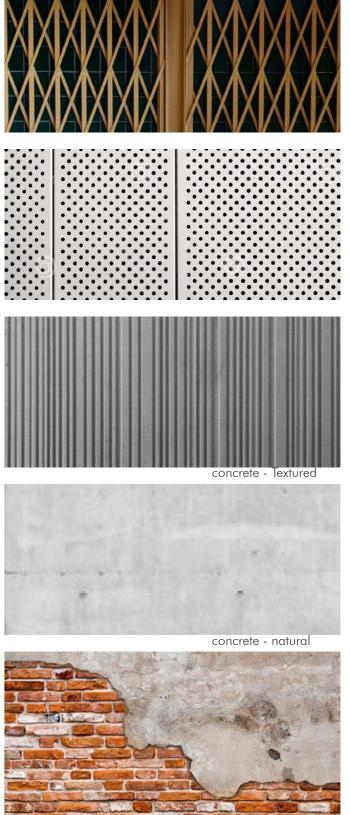


Brick

DESIGN PROPOSAL Ancillary Office - Materiality



View From North West On Bourke Road

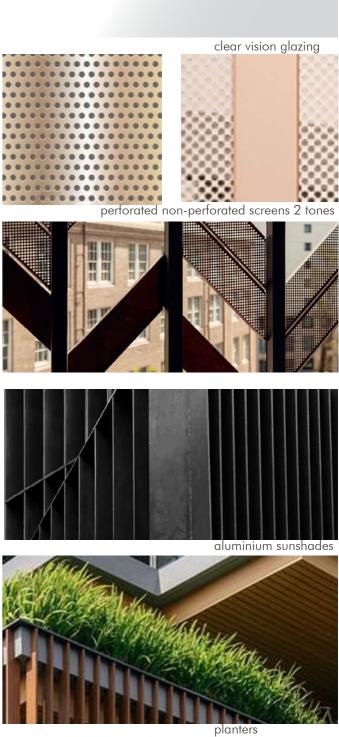


DESIGN PROPOSAL Ancillary Office - Daylight Analysis

Workplace - Access to natural light

According to Green Star Rating, depth of space is a measure that reflects the ability to locate near to natural light and views; the flexibility of the space to support a range of space planning; & having sufficient 'deep' space to accommodate support spaces.

Type A space is within 6m of perimeter glazing, Type B is between 6-12m from perimeter glazing, and Type C is greater than 12m. TypeA & B space is ideal for locating people in primary work points with access to daylight and views. Type C is suited to storage and utility spaces.

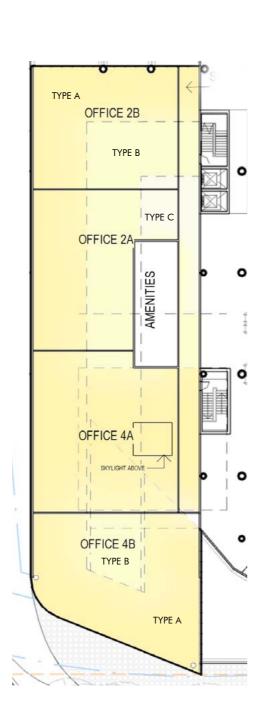



DESIGN PROPOSAL Indicative Perspectives



DESIGN PROPOSAL Indicative Perspectives



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DESIGN PROPOSAL Indicative Perspectives





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DESIGN PROPOSAL Indicative Perspectives



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O4 APPENDIX -ARCHITECTURAL DRAWINGS



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SHEET	
DA-001	
DA-005	
DA-010	
DA-011	
DA-012	
DA-013	
DA-014	
DA-031	
DA-032	
DA-041	
DA-080	
DA-081	
DA-091	
DA-093	
DA-095	
DA-097	

NA	ME	

Site Analysis and Context Plan
Site and Roof Plan
Ground Floor Plan
Ground Floor Plan - Mezzanine
Level 01
Level 01 - Mezzanine
Level 2 and Car Park
Elevation - North and South
Elevation - East and West
Section - Sheet 01
Signage Strategy Plan
Signage Details
Area Plans
Shadow Diagarms
Landscape Area
Perspective - Sheet 01

ISSUE DATE

Charter Hall - Alexandria

11596 FOR INFORMATION 18.03.22



Issue	Description	Date
1	For information	15.12.21
	1	

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Key Plan

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ISSUED FOR SSDA



Project Name Charter Hall -Alexandria


Builder

Project Address 520 Gardeners Rd. Alexandria, NSW 2015

Site Analysis and Context Plan

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Issue Description Date 4 For Information 15.03.22 3 For Information 25.01.22	work or of This draw	nd/or subcontractors shall verify all project dir ff-site fabrication. Figured dimensions shall ta ing is copyright and cannot be reproduced in e written permission of Nettleton Tribe Partne	ake precedence over s whole or in part or by	caled dimensions.
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	3	For Information		25.01.22
2 For Information 14.12.21				
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Project Name Charter Hall -Alexandria

Client

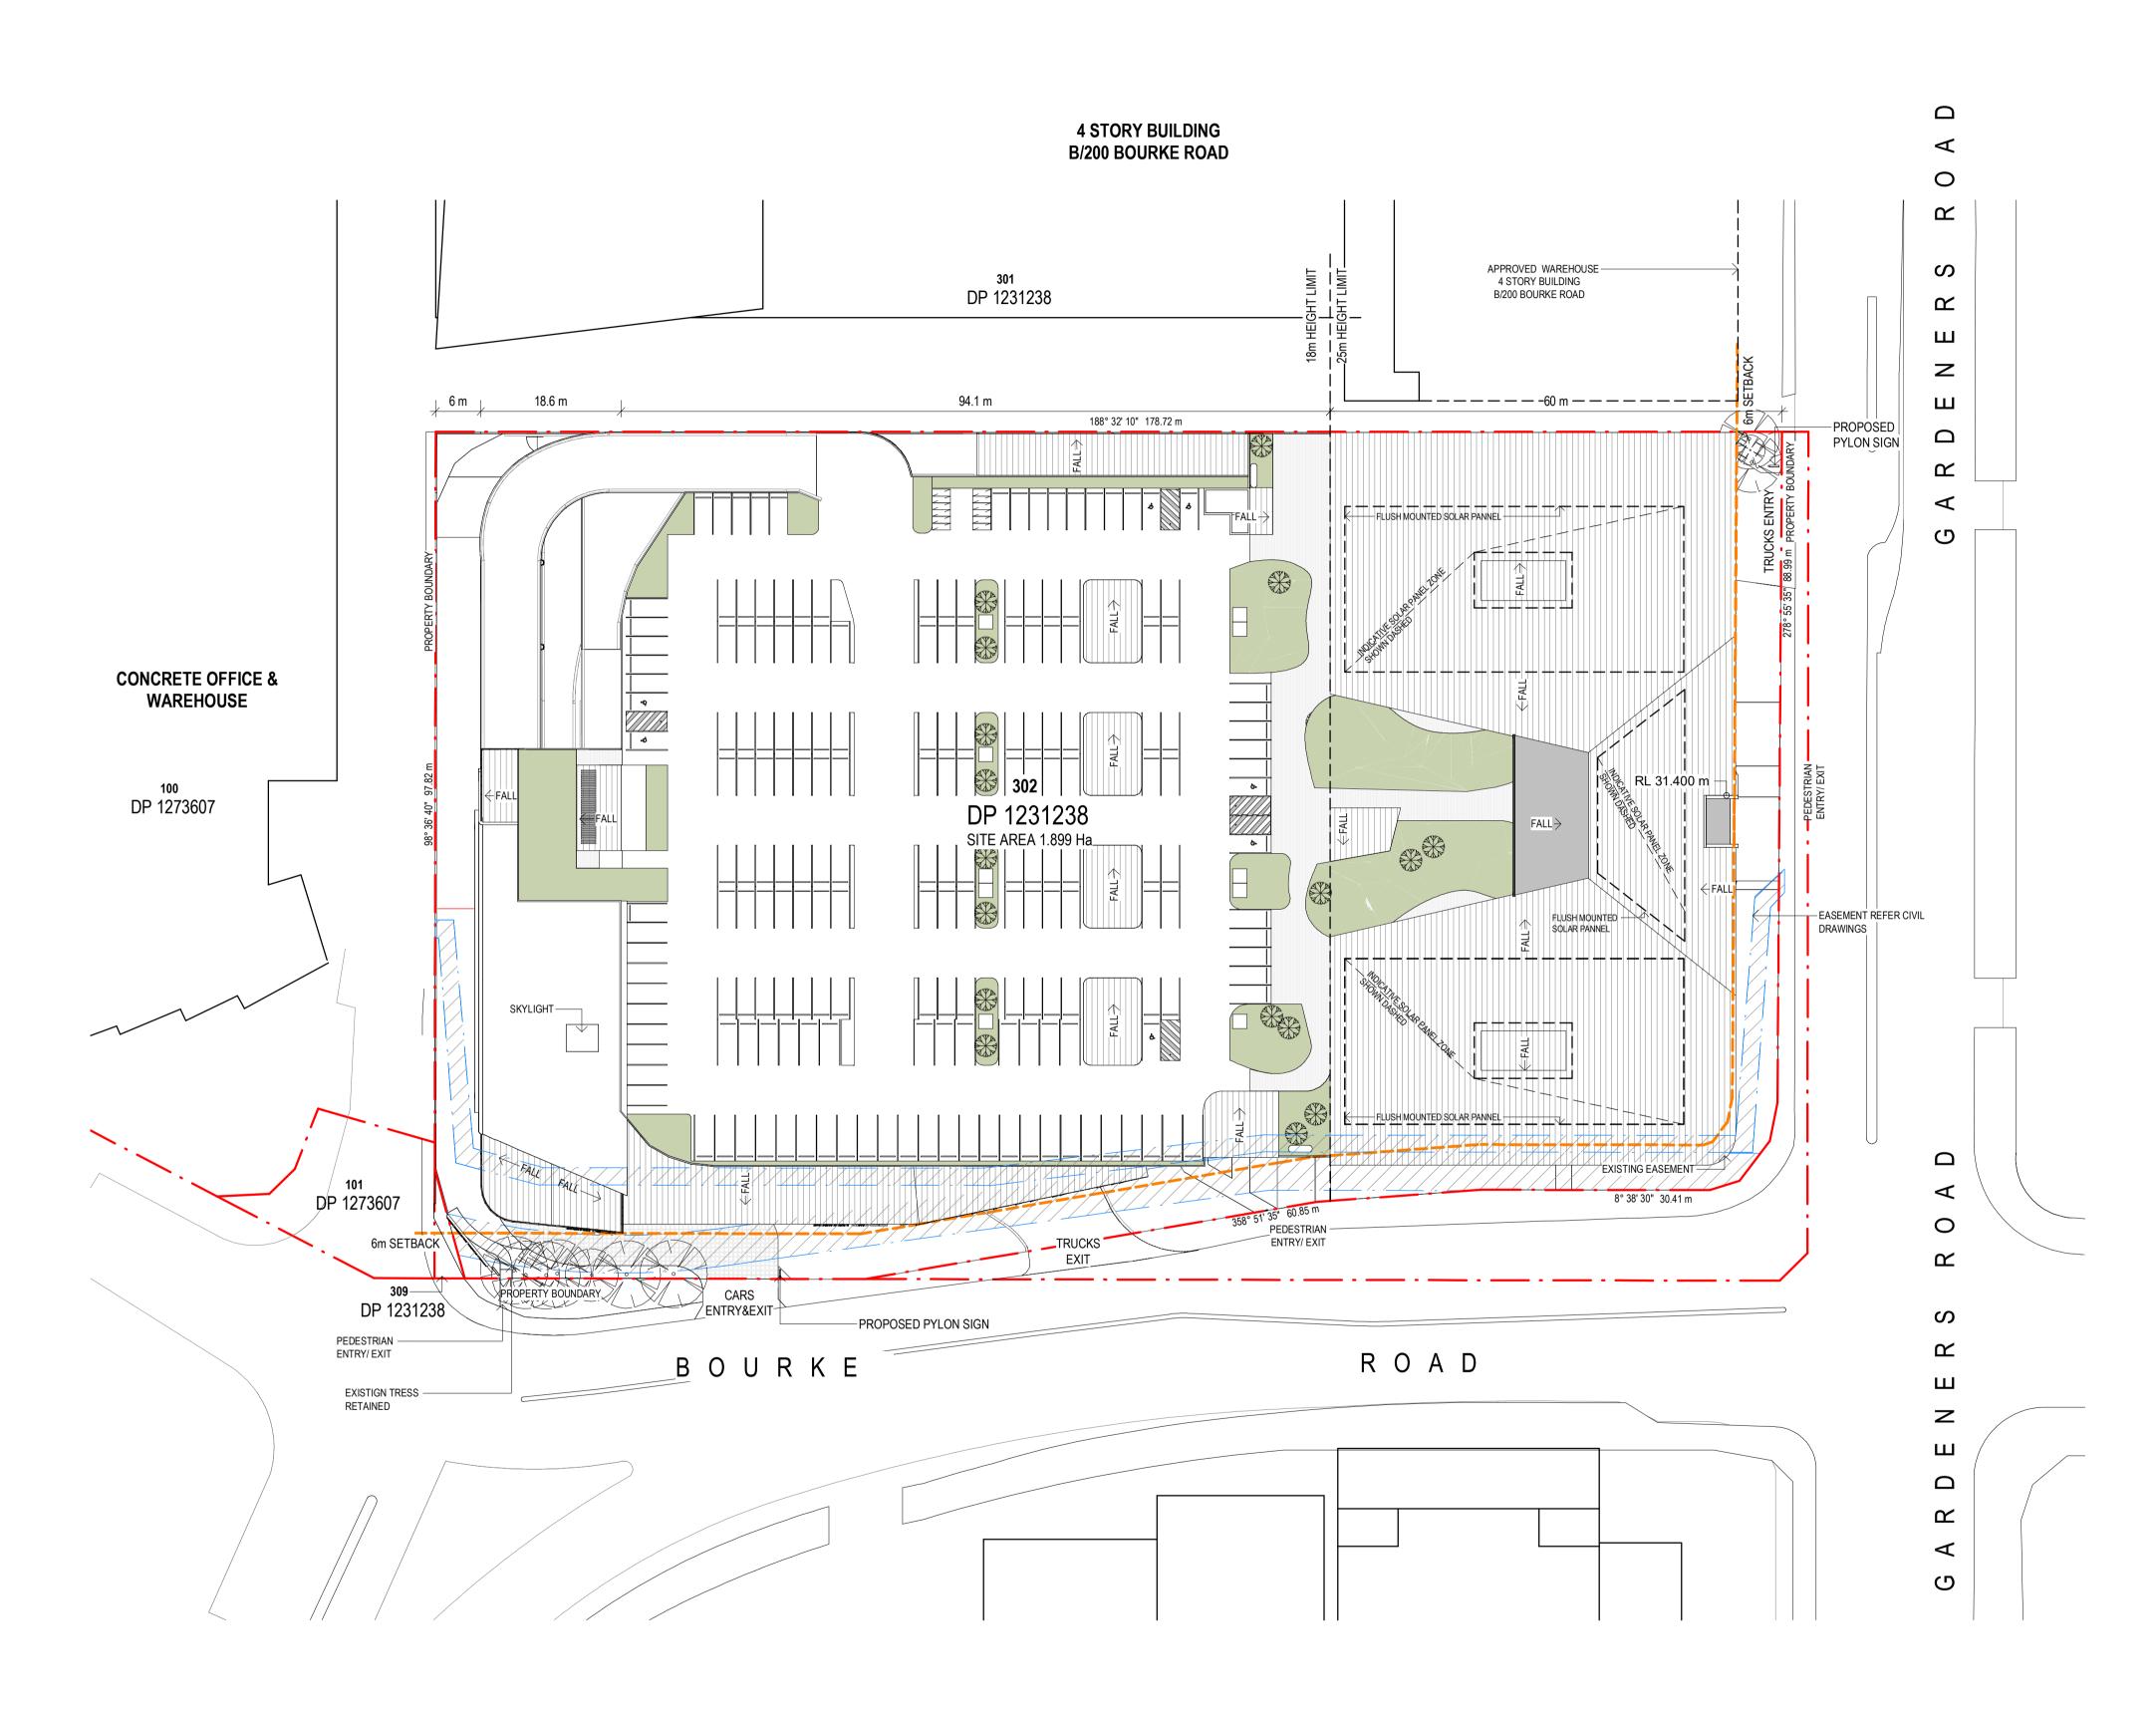
Builder

Project Address 520 Gardeners Rd. Alexandria, NSW 2015

Drawing Title Site and Roof Plan

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8	For Information	07.12.21
7	For Information	26.11.21
6	For information	17.11.21
5	For Information	11.11.21
4	For Information	29.10.21
3	For Information	08.10.21
2	For Information	14.09.21
1	For Information	07.09.21

RACKING LAYOUT SHOWN INDICATIVELY FOR COORDINATION ONLY - FINAL LAYOUT TO BE CONFIRMED BY SUPPLIER/TENANT

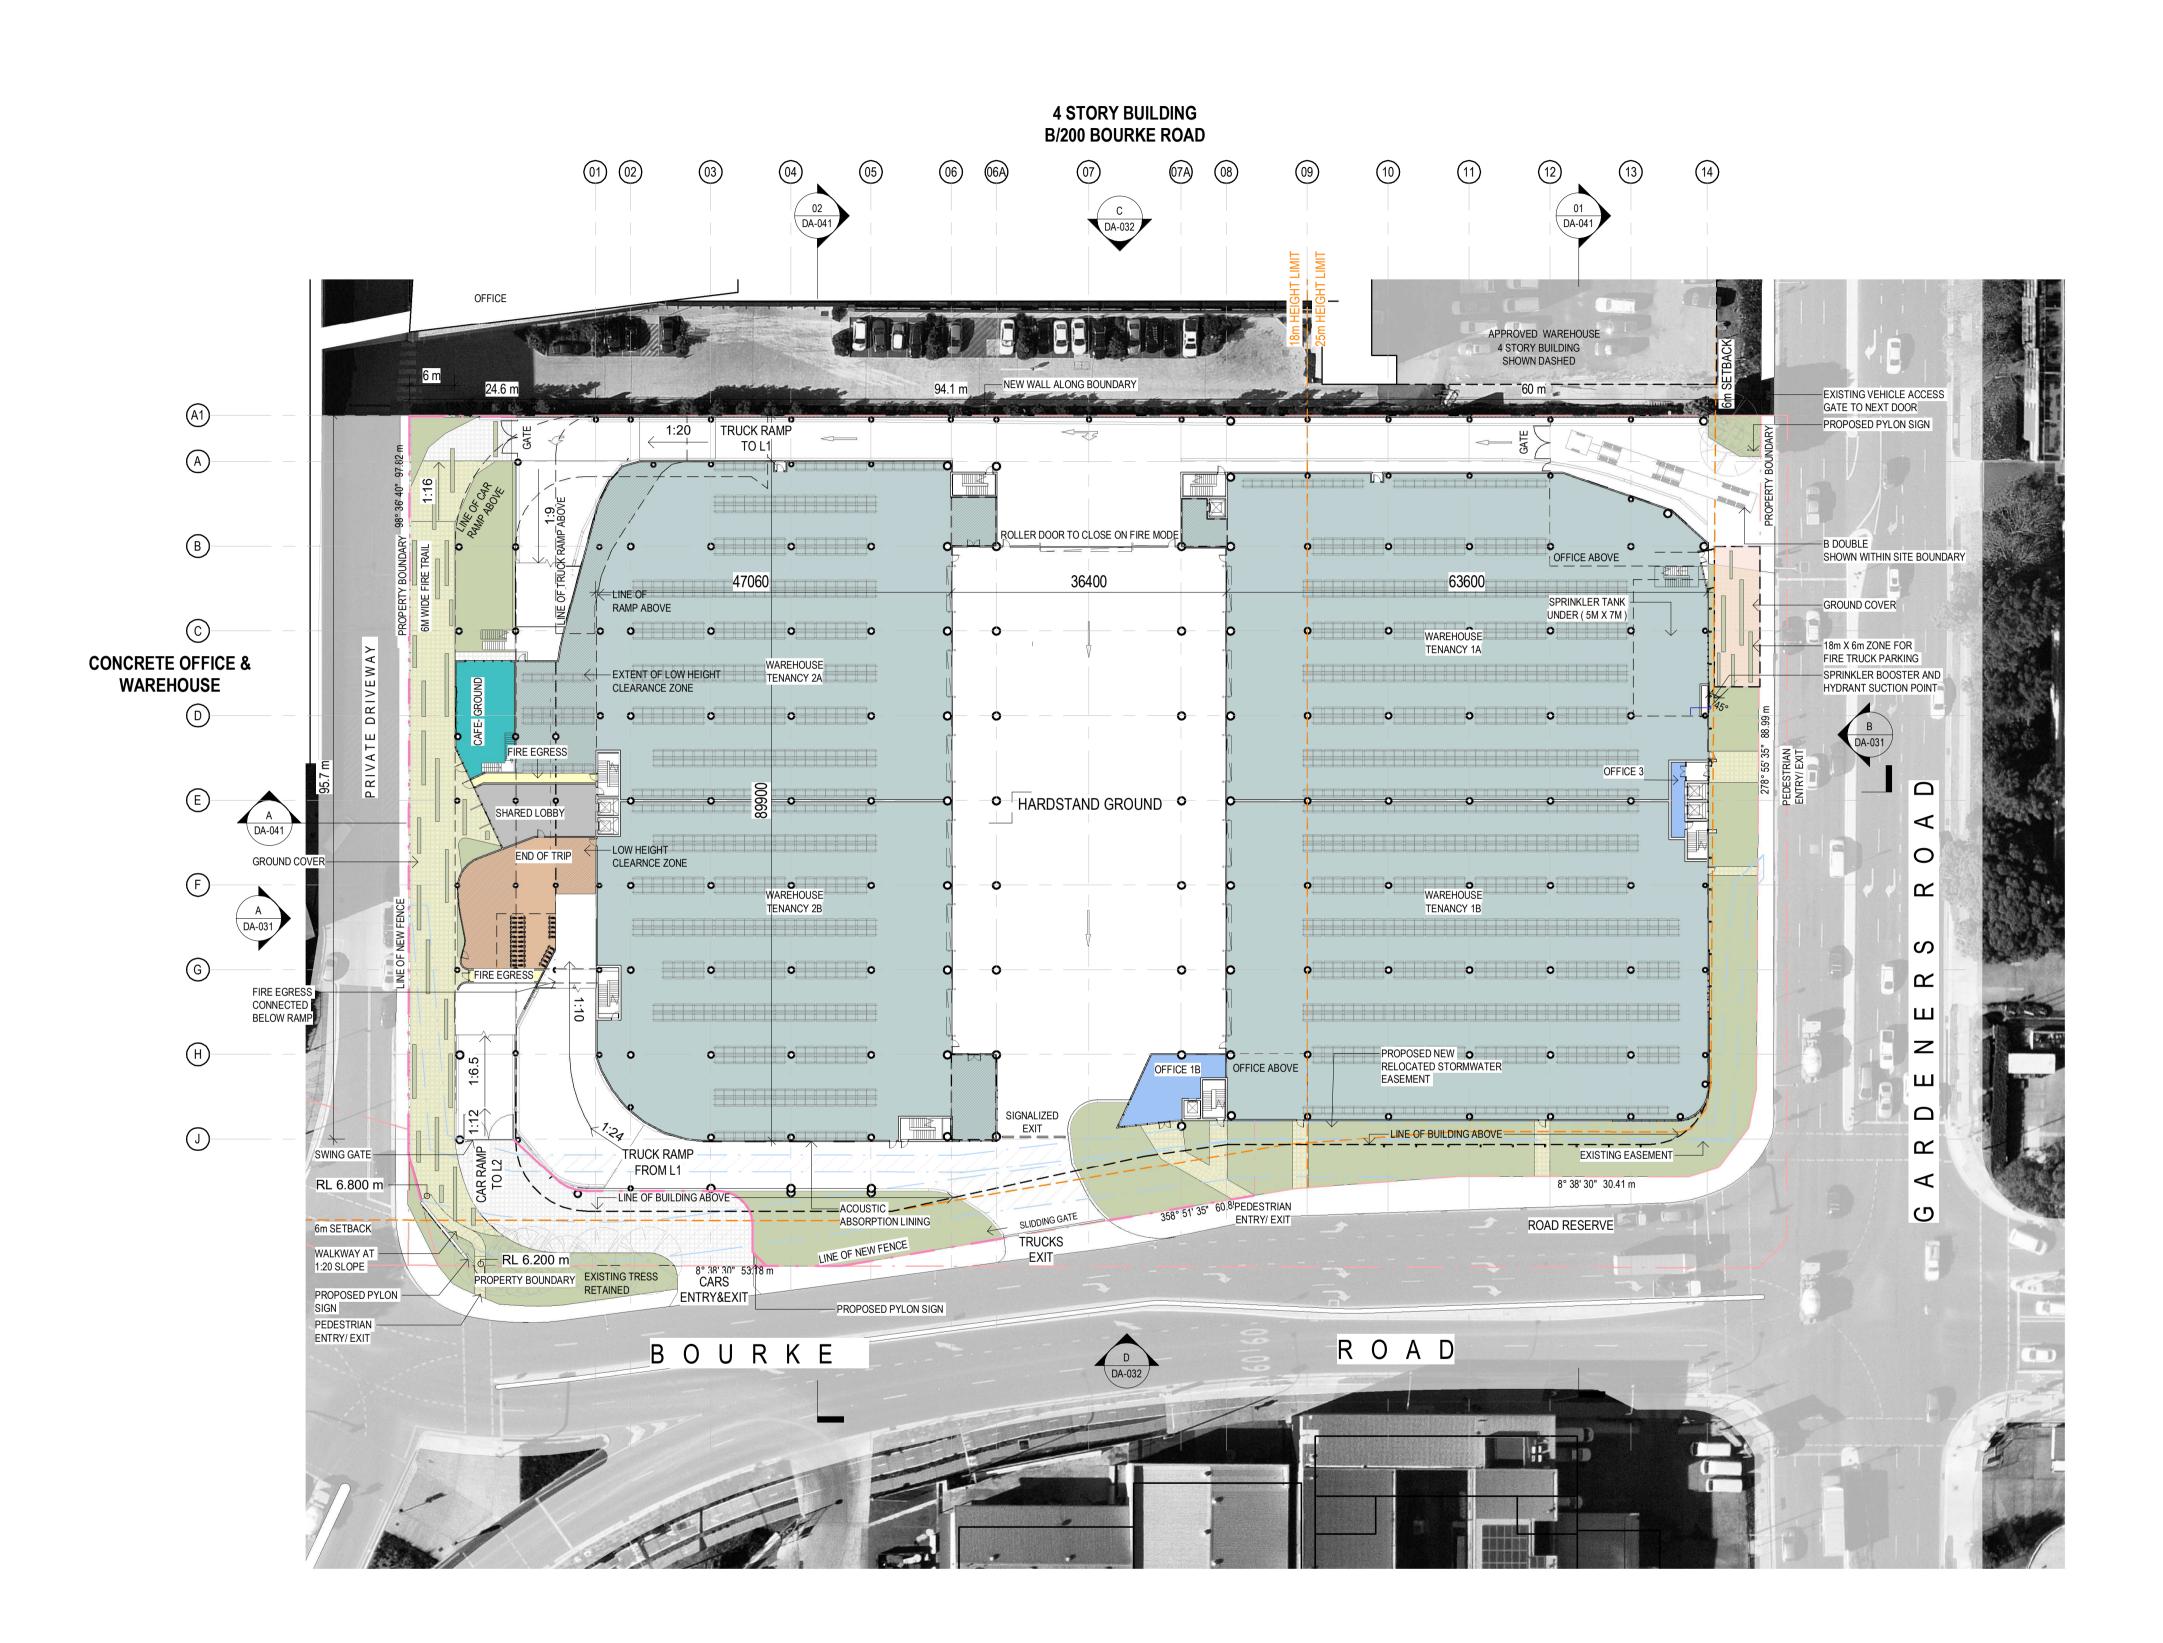ISSUED FOR SSDA



Project Name Charter Hall -Alexandria

Client


Builder

Project Address 520 Gardeners Rd. Alexandria, NSW 2015

Drawing Title Ground Floor Plan

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5 4 3	For Information For Information For Information	25.01.22 26.11.21 11.11.21	
5 4 3 2	For Information For Information For Information For Information	25.01.22 26.11.21 11.11.21 29.10.21	
5 4 3 2	For Information For Information For Information For Information	25.01.22 26.11.21 11.11.21 29.10.21	

RACKING LAYOUT SHOWN INDICATIVELY FOR COORDINATION ONLY - FINAL LAYOUT TO BE CONFIRMED BY SUPPLIER/TENANT

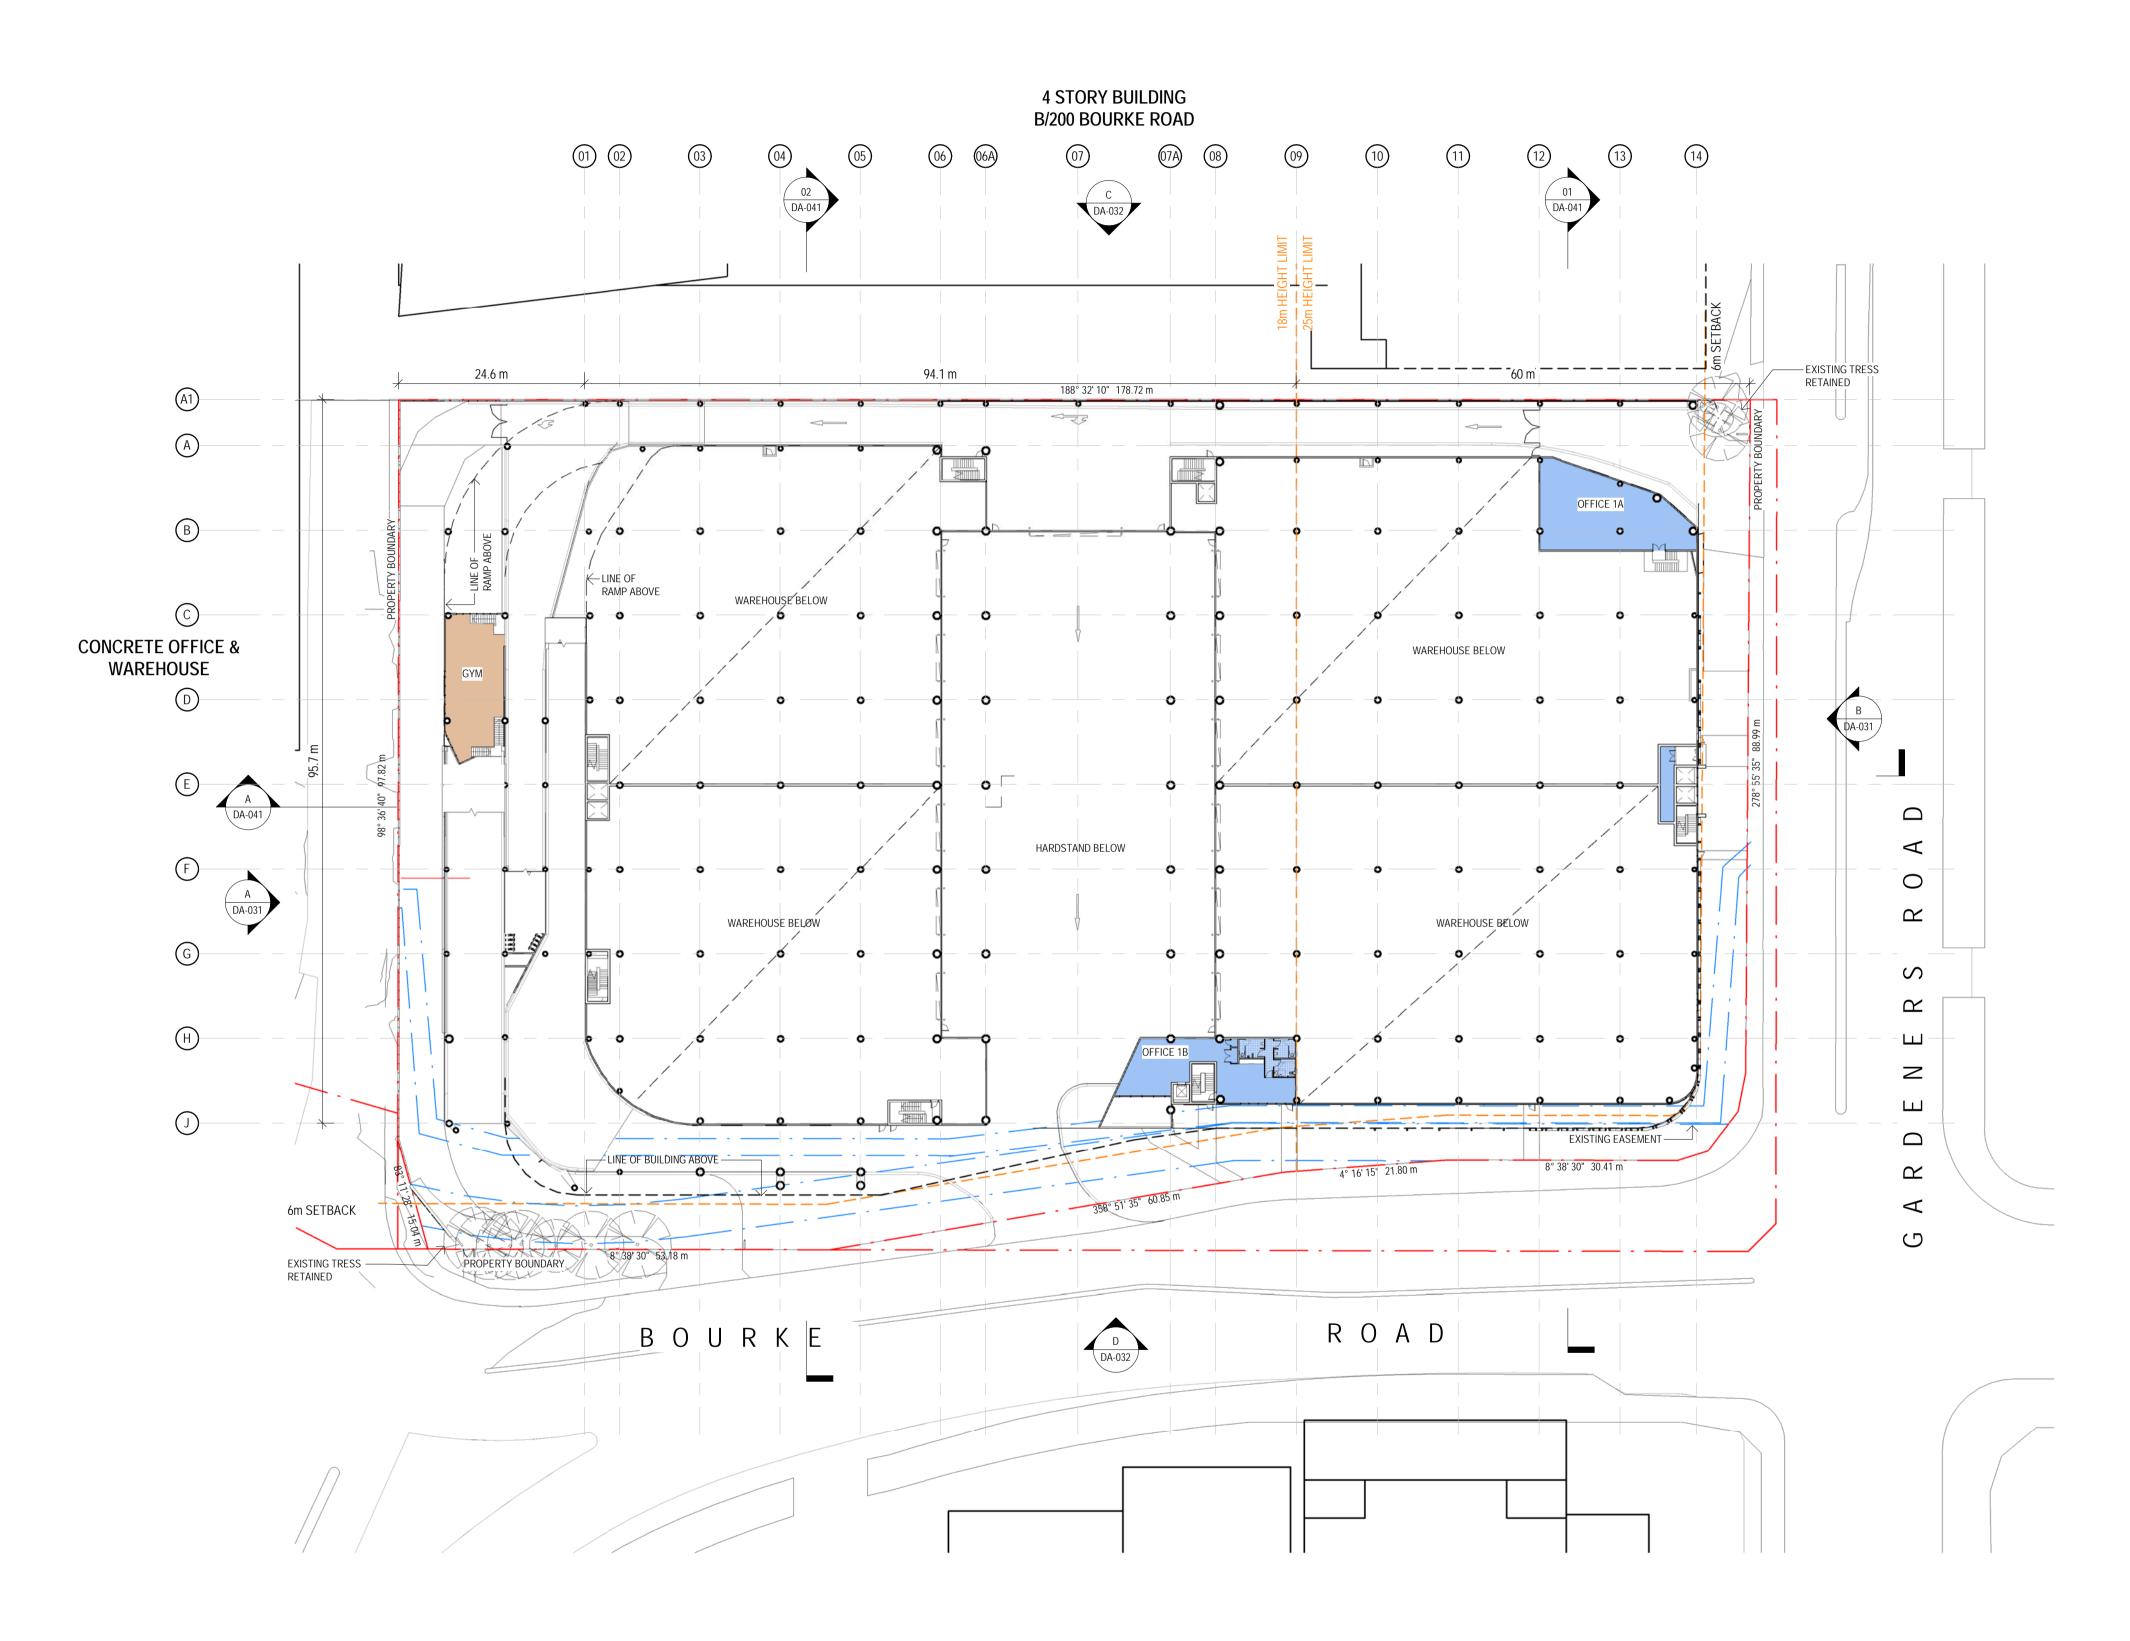ISSUED FOR SSDA



Project Name Charter Hall -Alexandria

Client


Builder

Project Address 520 Gardeners Rd. Alexandria, NSW 2015

Drawing Title Ground Floor Plan - Mezzanine

Drawing Numbe	96_DA	-011	lssue: 5
Author:	Checker:	Sheet Size:	^{Scale:} 1:500 @ A1

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Key Plan	
0 10000 25000	

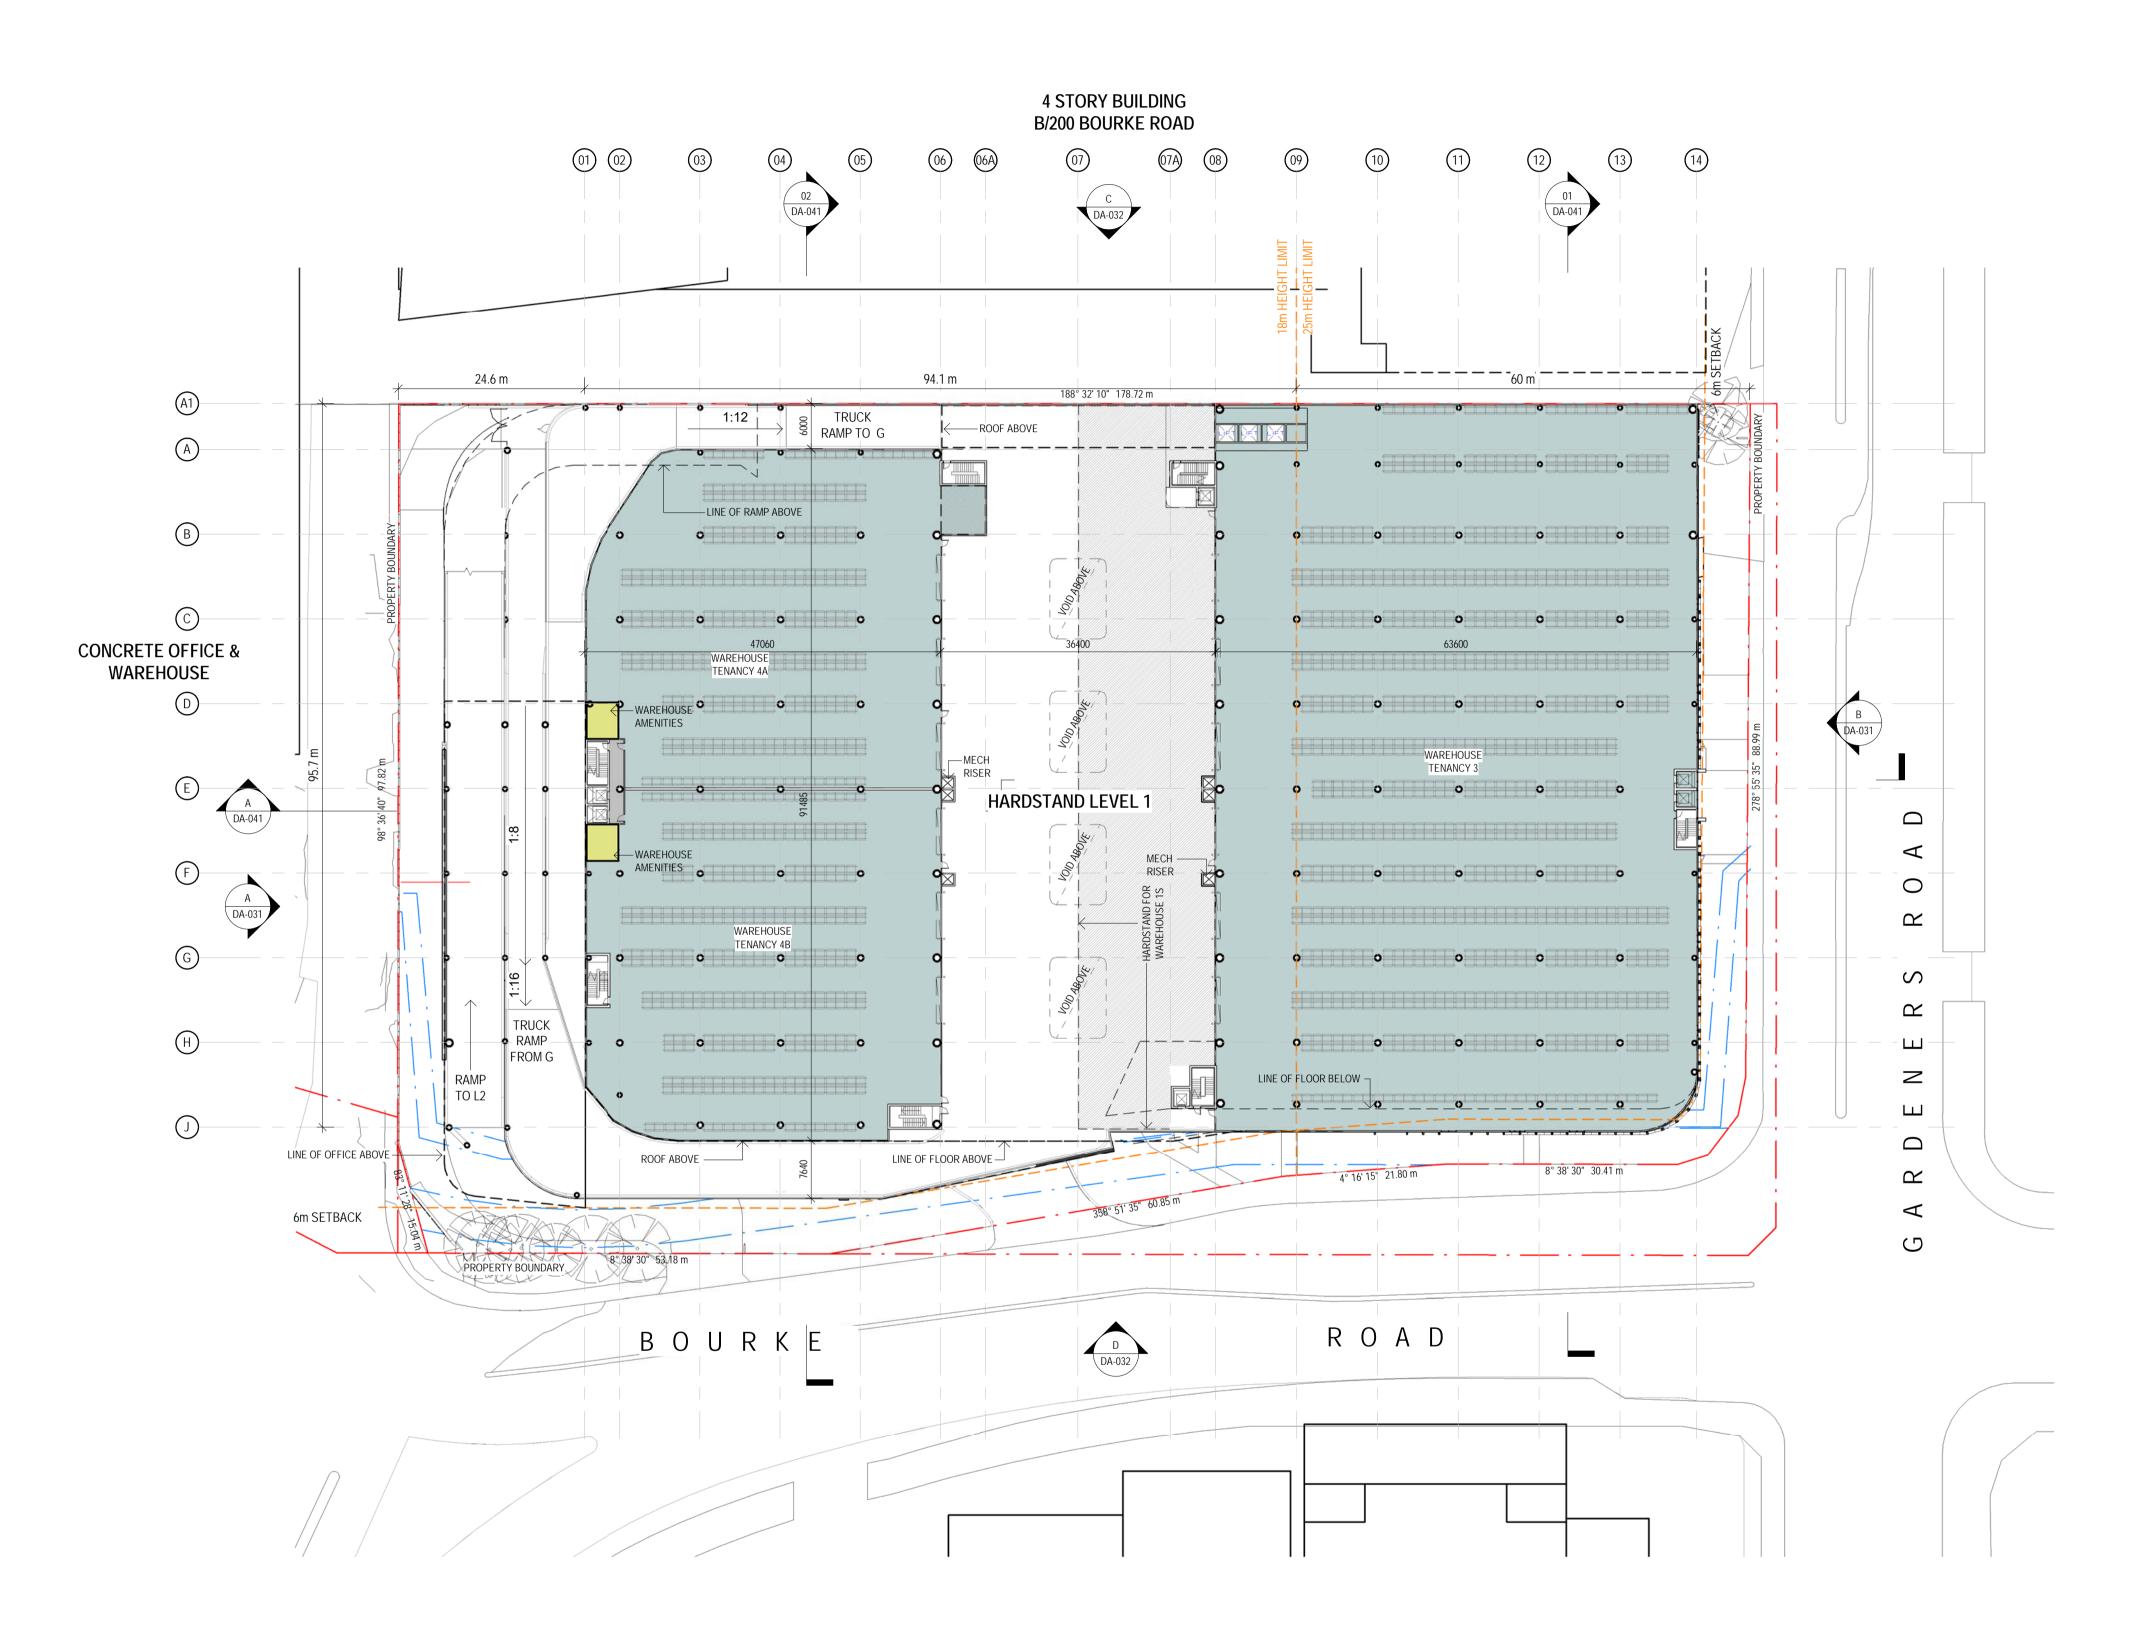lssue	Description	Date
9	For Information	25.01.22
8	For Information	26.11.21
7	For information	17.11.21
6	For Information	11.11.21
5	For Information	29.10.21
4	For Information	08.10.21
3	For Information	16.09.21
2	For Information	14.09.21
1	For Information	07.09.21

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ISSUED FOR SSDA



Project Name Charter Hall -Alexandria

Project Address 520 Gardeners Rd. Alexandria, NSW 2015


Drawing Title

Client

Builder

Author:	Checker:	Sheet Size:	^{scale:} 1:500 @ A1
Drawing Number: 11596_DA-012			Issue: 9

nettletontribe

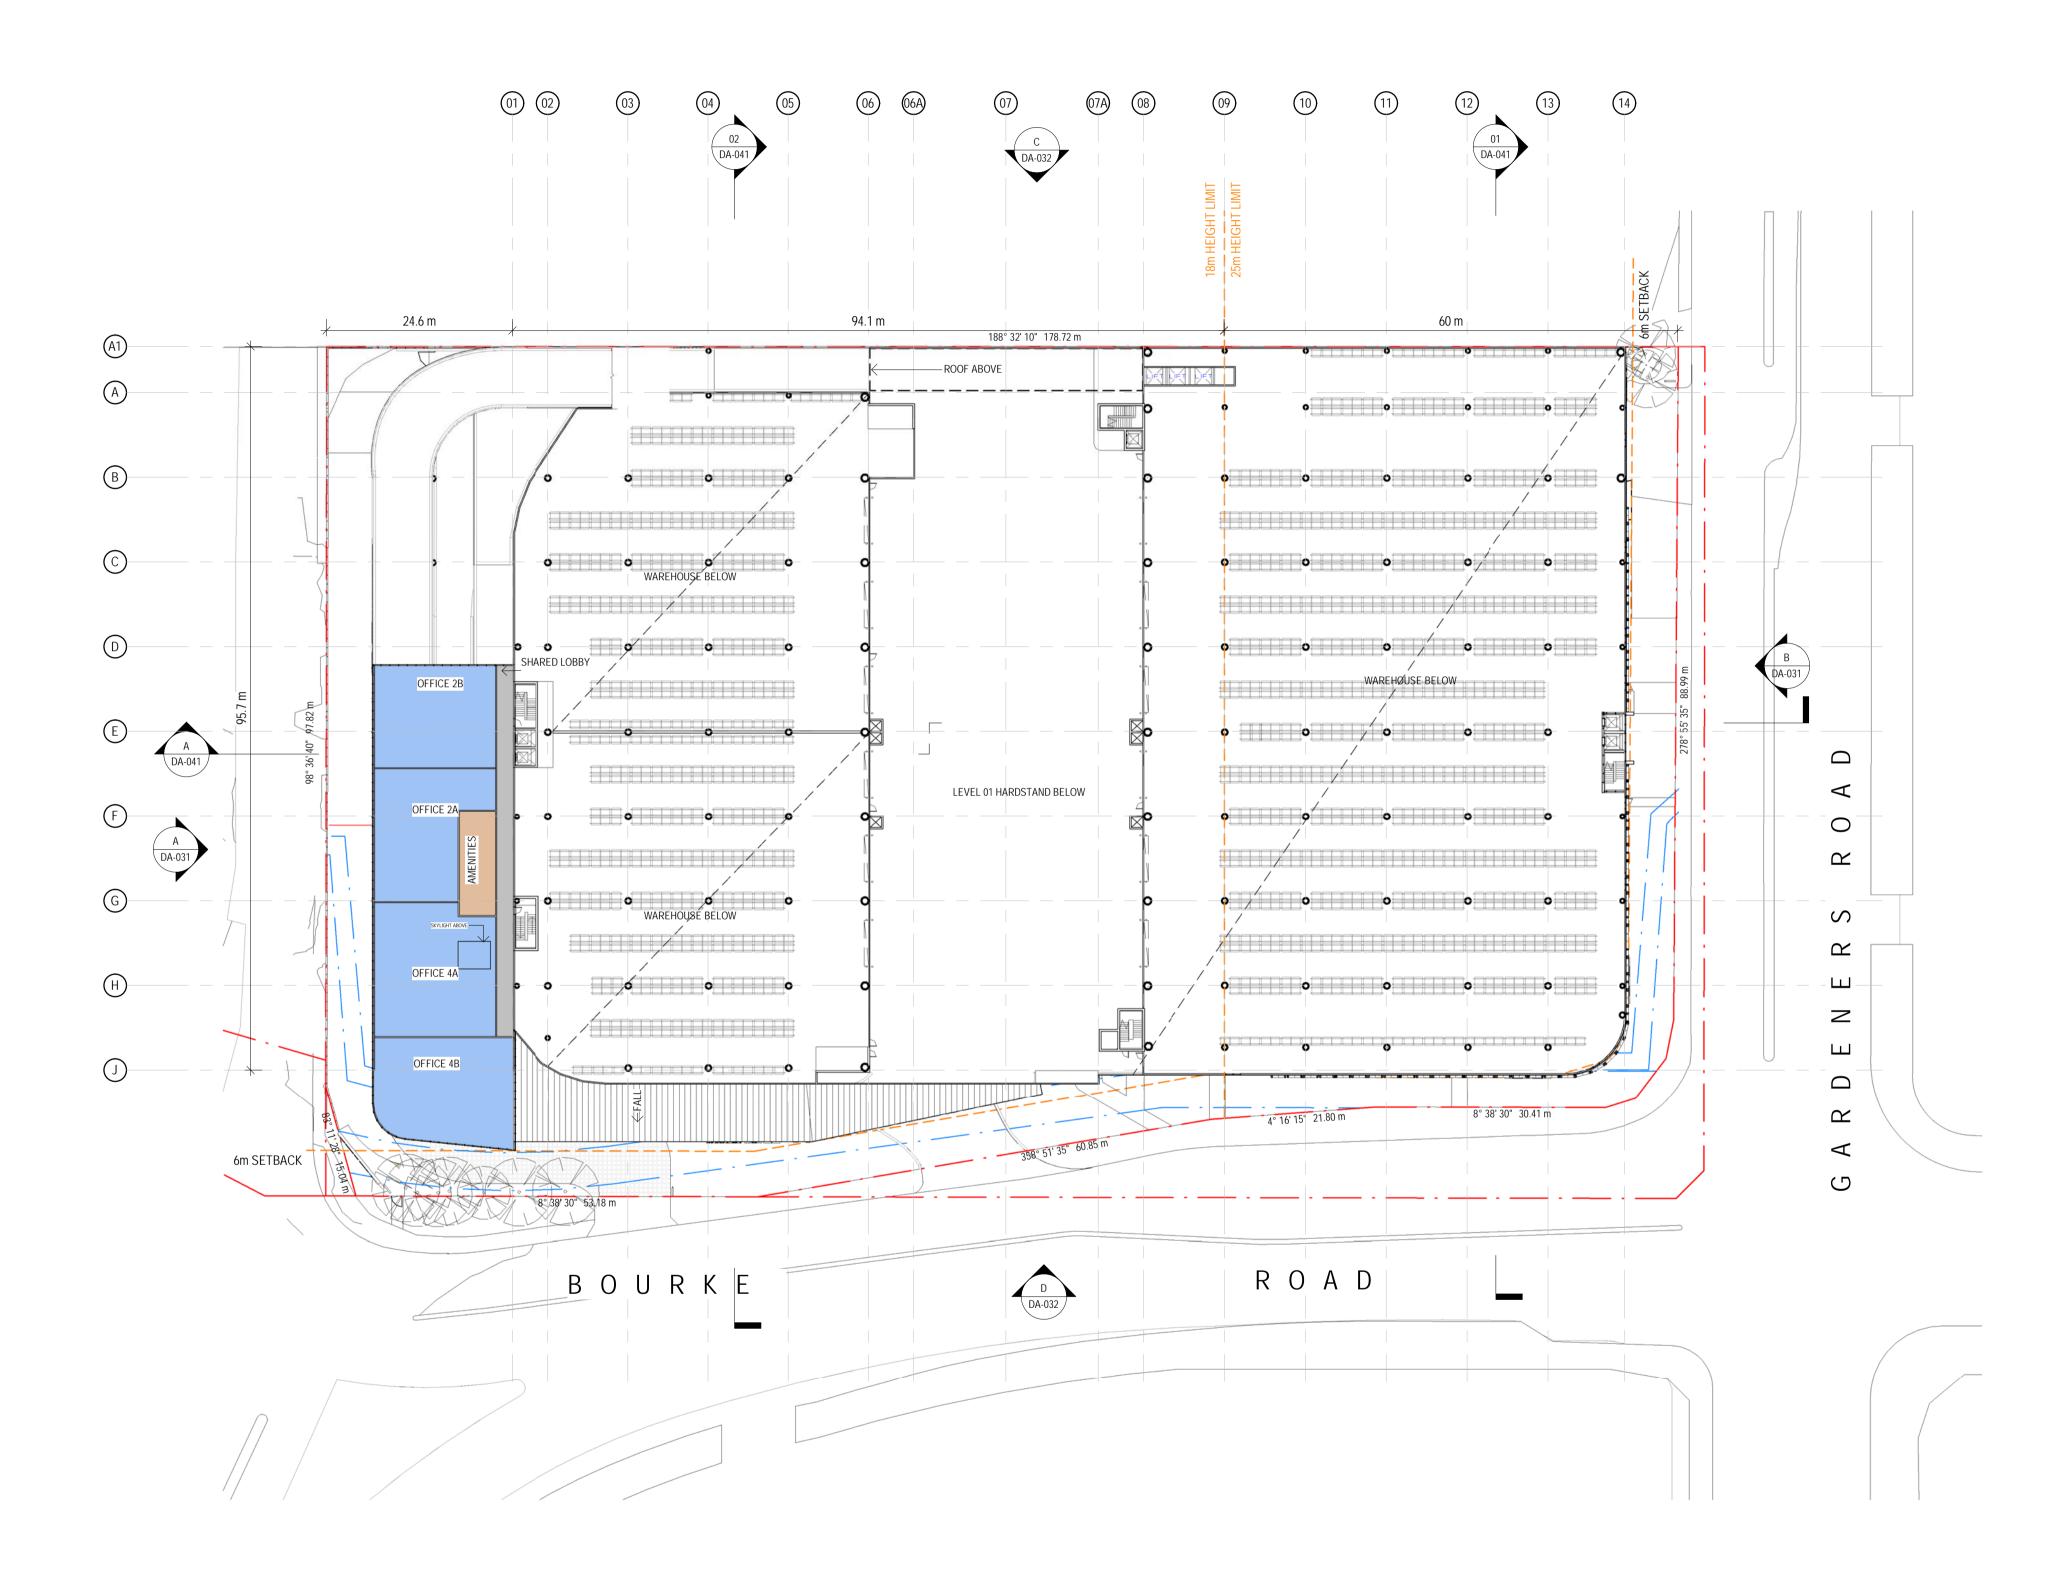

Issue Description Date 5 For Information 25.01.22 4 For Information 26.11.21 3 For Information 11.1.121 2 For Information 11.1.21 1 For Information 08.10.21	work or o This draw without t	and/or subcontractors shall verify all project di off-site fabrication. Figured dimensions shall t wing is copyright and cannot be reproduced in he written permission of Nettleton Tribe Partn V Plan	ake precedence over sca n whole or in part or by a	aled dimensions.
5 For Information 25.01.22 4 For Information 26.11.21 3 For Information 11.11.21 2 For Information 29.10.21	0	1000	2500	
5 For Information 25.01.22 4 For Information 26.11.21 3 For Information 11.11.21 2 For Information 29.10.21				
5 For Information 25.01.22 4 For Information 26.11.21 3 For Information 11.11.21 2 For Information 29.10.21				
5 For Information 25.01.22 4 For Information 26.11.21 3 For Information 11.11.21 2 For Information 29.10.21				
5 For Information 25.01.22 4 For Information 26.11.21 3 For Information 11.11.21 2 For Information 29.10.21				
5 For Information 25.01.22 4 For Information 26.11.21 3 For Information 11.11.21 2 For Information 29.10.21				
5 For Information 25.01.22 4 For Information 26.11.21 3 For Information 11.11.21 2 For Information 29.10.21				
4 For Information 26.11.21 3 For Information 11.11.21 2 For Information 29.10.21				
3 For Information 11.11.21 2 For Information 29.10.21	lssue	Description		Date
2 For Information 29.10.21				
	5	For Information		25.01.22
1 For Information 08.10.21	5 4	For Information For Information		25.01.22 26.11.21
	5 4 3	For Information For Information For Information		25.01.22 26.11.21 11.11.21
	5 4 3 2	For Information For Information For Information For Information		25.01.22 26.11.21 11.11.21 29.10.21
	5 4 3 2	For Information For Information For Information For Information		25.01.22 26.11.21 11.11.21 29.10.21

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ISSUED FOR SSDA



Project Name Charter Hall -Alexandria

Client


Builder

Project Address 520 Gardeners Rd. Alexandria, NSW 2015

Drawing Title Level 01 - Mezzanine

Author:	Checker:	Sheet Size:	^{scale:} 1:500 @ A1
Drawing Number	96_DA	-013	Issue: 5

nettletontribe

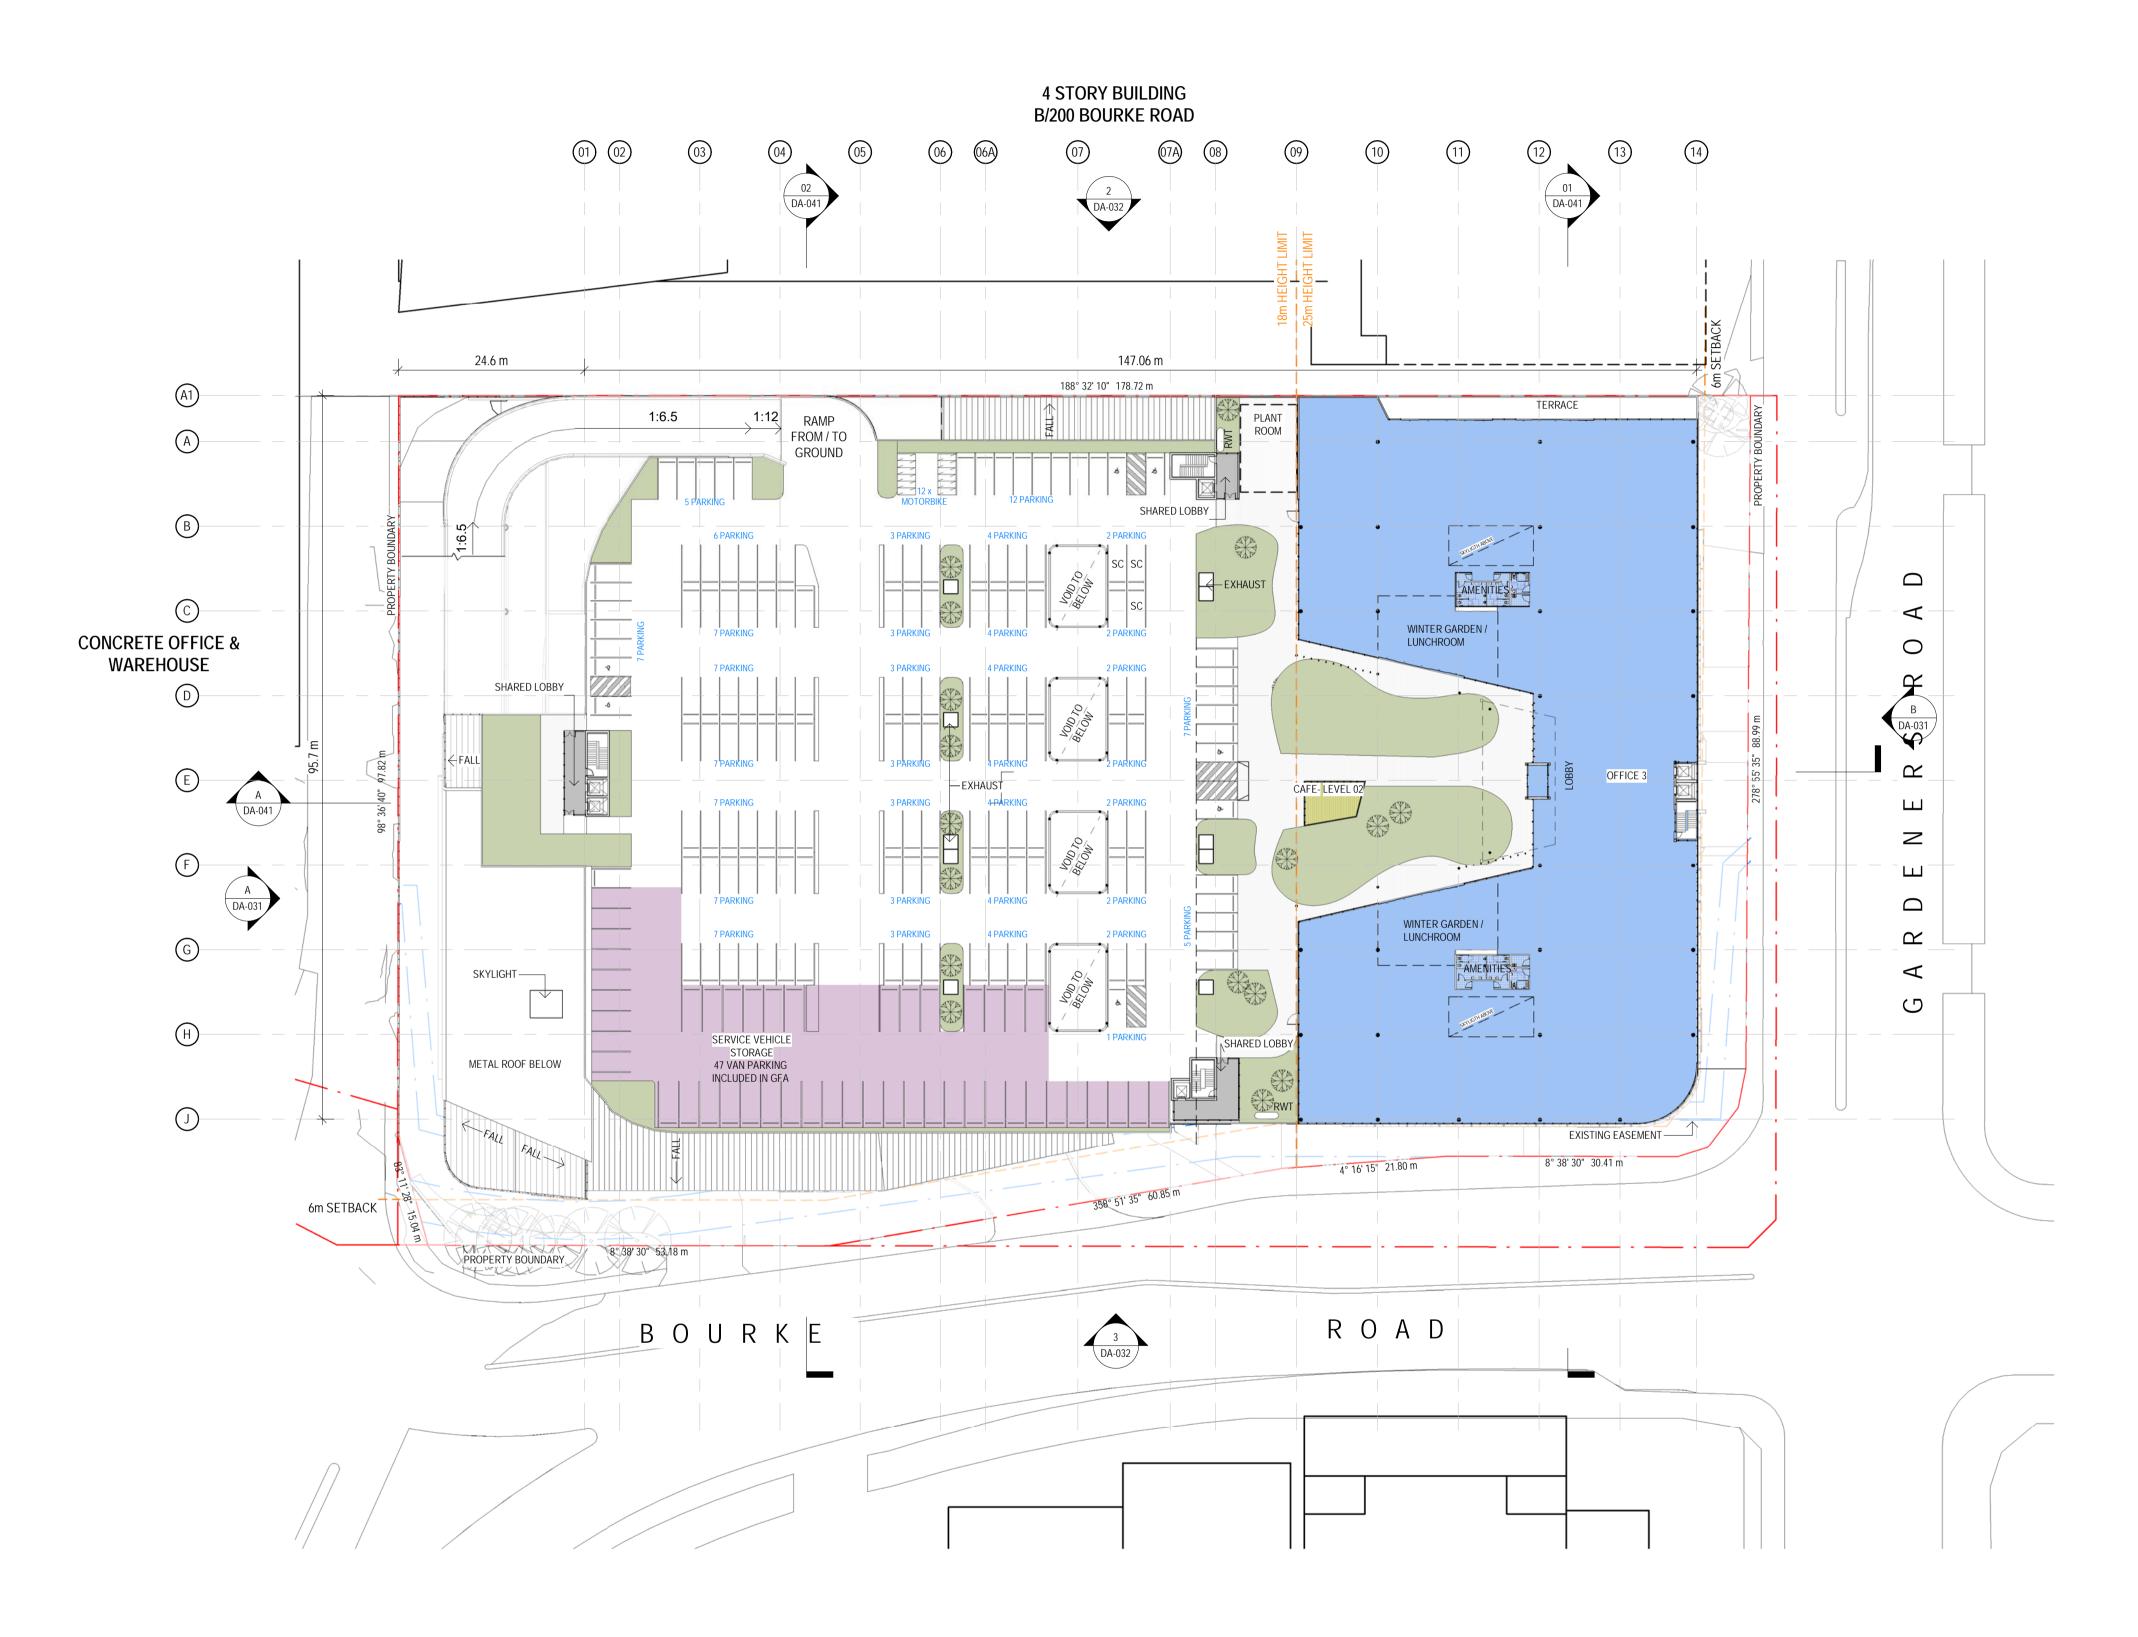

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Key Plan	
0 1000 2500	

lssue	Description	Date
8	For Information	25.01.22
7	For Information	07.12.21
6	For Information	26.11.21
5	For Information	11.11.21
4	For Information	29.10.21
3	For Information	08.10.21
2	For Information	14.09.21
1	For Information	07.09.21

FOR INFORMATION



Project Name Charter Hall -Alexandria

Client

Builder


Project Address 520 Gardeners Rd. Alexandria, NSW 2015

Drawing Title Level 2 and Car Park

Drawing Number		A1	1:500 @ A1 Issue: 8
11596_DA-014			ŏ

nettletontribe



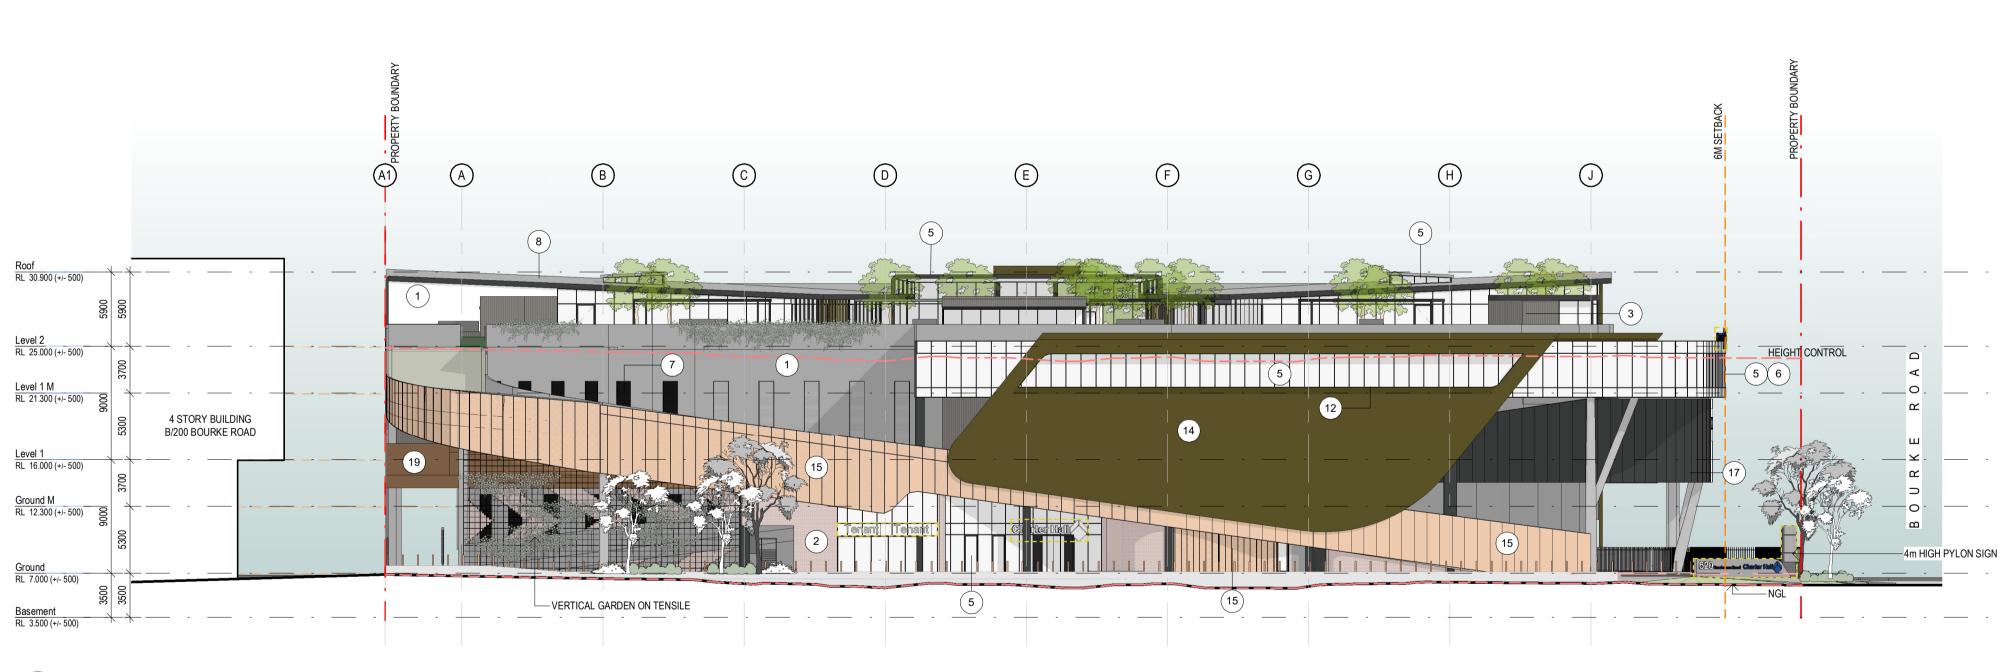

A ELEVATION NORTH DA-010 1:300

EXTERNAL	_ FINISHES LEGEND
	PRECAST CONCRETE WALL - NATURAL
2	PRECAST CONCRET WALL - TYPE 01 - " BRICK EFFECT"
3	PRECAST CONCRETE WALL - TEXTURED TYPE 02 - "Woodland Grey®",or similar
4	STRUCTURAL COLUMNS - NATURAL Colour to match adjoent precast walls
5	GLASS - Vision
6	GLASS - Backpan Glazing
7	POWDERCOATED WINDOW FRAMES "Monument®", or similar
8	COLORBOND METAL ROOF SHEETING TYPE 1 - "Shale Grey™", or similar
9	FASCIA, DOWNPIPE, FLASHING & CAPPING "Woodland Grey®", or similar
10	SOFFIT - PREFINISHED METAL PANELS - Colour to match Fascia
11	ROLLER DOORS AND DOORS "Woodland Grey®", or similar
12	METAL BOX EXTRUSIONS $$ - Colour 01 $$ - "Woodland Grey®", or similar
13	FEATURE METAL BOX EXTRUSIONS - Colour 02 - Colour to match "Nordic Brass", or similar
14	METAL MESH SCREEN - Colour 03 - Colour to match "Nordic Bronze", or similar
15	METAL CLADDING - SOLID & PERFORATED - Colour - Colour to match "Nordic Brown Light", or similar
	METAL CLADDING - SOLID & PERFORATED - Colour - Colour to match "Mannex White", or similar
17	METAL CLADDING - SOLID - Colour 01 - "Woodland Grey®", or similar
18	PRECAST CONCRETE WALL - TEXTURED TYPE 03 - INDICATIVE DESIGN SCREEN
19	PRECAST CONCRETE WALL - PAINTED - Colour to match "Nordic Brown Light", or similar
20	METAL SCREEN - INDICATIVE PUBLIC ART WORK
21	METAL CLADDING - LONGLINE 305 - Colour 05 - Colour to match "Nordic Brown Light", or similar

7
2500

lssue	Description	Date
10	For Information	18.03.22
9	For Information	15.03.22
8	For Information	25.01.22
7	For information	15.12.21
6	For Information	26.11.21
5	For Information	11.11.21
4	For Information	29.10.21
3	For Information	08.10.21
2	For Information	14.09.21
1	For Information	07.09.21

ISSUED FOR SSDA



Project Name Charter Hall -Alexandria

Builder

Project Address 520 Gardeners Rd. Alexandria, NSW 2015

Drawing Title Elevation - North and South

Drawing Number	96 DA	-031	lssue: 10
Author:	Checker:	Sheet Size:	^{scale:} 1:300@A1

nettletontribe



D ELEVATION WEST

lssue	Description	Date
8	For Information	18.03.22
7	For Information	15.03.22
6	For Information	25.01.22
5	For information	15.12.21
4	For Information	09.12.21
3	For Information	26.11.21
2	For Information	11.11.21
1	For Information	29.10.21

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Key Plan

1000

EXTERNAL	L FINISHES LEGEND
	PRECAST CONCRETE WALL - NATURAL
2	PRECAST CONCRET WALL - TYPE 01 - "BRICK EFFECT"
3	PRECAST CONCRETE WALL - TEXTURED TYPE 02 - "Woodland Grey®",or similar
4	STRUCTURAL COLUMNS - NATURAL Colour to match adjcent precast walls
5	GLASS - Vision
6	GLASS - Backpan Glazing
7	POWDERCOATED WINDOW FRAMES "Monument⊚", or similar
8	COLORBOND METAL ROOF SHEETING TYPE 1 - "Shale Grey™", or similar
9	FASCIA, DOWNPIPE, FLASHING & CAPPING "Woodland Grey®", or similar
10	SOFFIT - PREFINISHED METAL PANELS - Colour to match Fascia
	ROLLER DOORS AND DOORS "Woodland Grey®", or similar
12	METAL BOX EXTRUSIONS - Colour 01 - "Woodland Grey®", or similar
	FEATURE METAL BOX EXTRUSIONS - Colour 02 - Colour to match "Nordic Brass", or similar
	METAL MESH SCREEN - Colour 03 - Colour to match "Nordic Bronze", or similar
15	METAL CLADDING - SOLID & PERFORATED - Colour 04 - Colour to match "Nordic Brown Light", or similar
	METAL CLADDING - SOLID & PERFORATED - Colour 05 - Colour to match "Mannex White", or similar
17	METAL CLADDING - SOLID - Colour 01 - "Woodland Grey®", or similar
	PRECAST CONCRETE WALL - TEXTURED TYPE 03 - INDICATIVE DESIGN SCREEN
19	PRECAST CONCRETE WALL - PAINTED - Colour to match "Nordic Brown Light", or similar
	METAL SCREEN - INDICATIVE PUBLIC ART WORK
21	METAL CLADDING - LONGLINE 305 - Colour 05 - Colour to match "Nordic Brown Light", or similar

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Project Name	
Charter Hall	-
Alexandria	

Builder

Project Address 520 Gardeners Rd. Alexandria, NSW 2015

Drawing Title Elevation - East and West

Author:	Checker:	Sheet Size:	^{scale:} 1:300@A1
Drawing Numbe	96_DA	-032	Issue:





work or of This draw	nd/or subcontractors shall verify all project dimensions before com f-site fabrication. Figured dimensions shall take precedence over ing is copyright and cannot be reproduced in whole or in part or b e written permission of Nettleton Tribe Partnership Pty Ltd.	scaled dimensions.
Key	Plan	
0	1000 2500	
Issue	Description	Date
8	For Information	25.01.22
7	For Information	26.11.21
6	For Information	11.11.21
5	For Information	05.11.21
4	For Information	29.10.21
3	For Information	16.09.21
2	For Information	14.09.21
1	For Information	07.09.21

FOR INFORMATION



Project Name Charter Hall -Alexandria

Client

Builder

Project Address 520 Gardeners Rd. Alexandria, NSW 2015

Drawing Title Section - Sheet 01

Drawing Number: 11596 DA-041			Issue:
Author:	Checker:	Sheet Size:	^{scale:}
RA	DC/IG		1:300 @ A1

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Key Plan	
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2500

0 1000

Date 25.01.22 09.12.21
 Issue

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 For Informatio
 _____ _____ _____ _____ _____ _____ -----_____ _____

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Project Name Charter Hall -Alexandria


Builder

Project Address 520 Gardeners Rd. Alexandria, NSW 2015

Drawing Title Signage Strategy Plan


Author:	Checker:	Sheet Size:	scale: NTS
Drawing Number	96_DA	-080	Issue:


nettletontribe

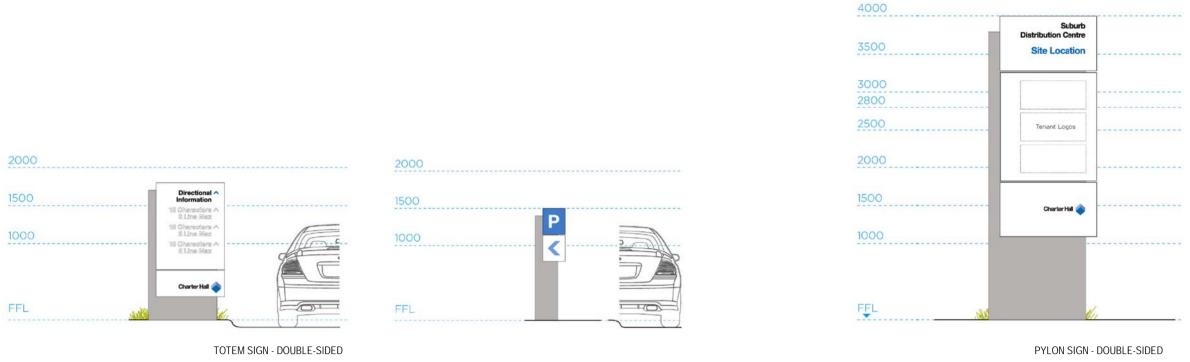






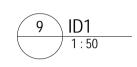


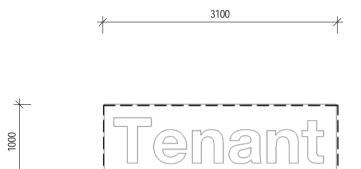




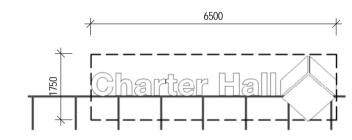

6 Signage - "Chater hall" - Type 01

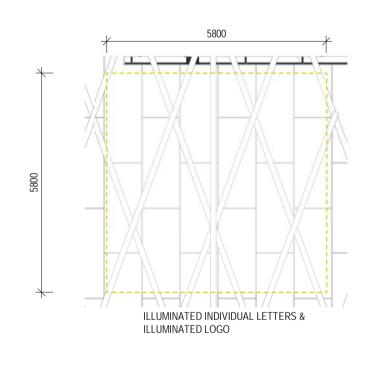




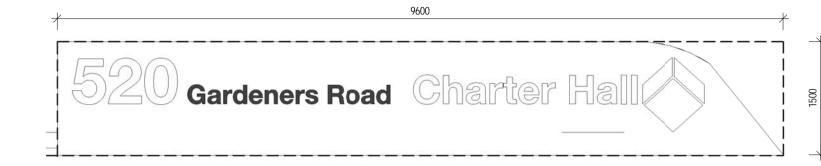


ILLUMINATED INDIVIDUAL LETTERS & ILLUMINATED LOGO

5 ID2 1:50

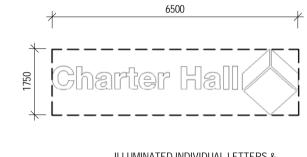

ILLUMINATED INDIVIDUAL LETTERS & ILLUMINATED LOGO


1 Signage - "Chater hall" - Backlight

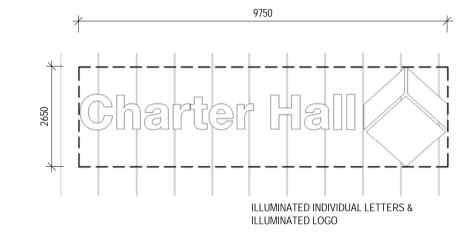



	7 2500		

lssue	Description	Date
2	For Information	25.01.22
1	For Information	09.12.21

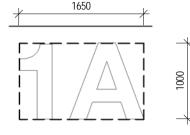

10 Warehouse Numbering 1:50

ISSUED FOR SSDA



Project Name Charter Hall -Alexandria


Builder


Project Address 520 Gardeners Rd. Alexandria, NSW 2015

Drawing Title Signage Details

Drawing Number: 11596_DA-081			Issue:
Author: RA	Checker:	Sheet Size:	scale: NTS




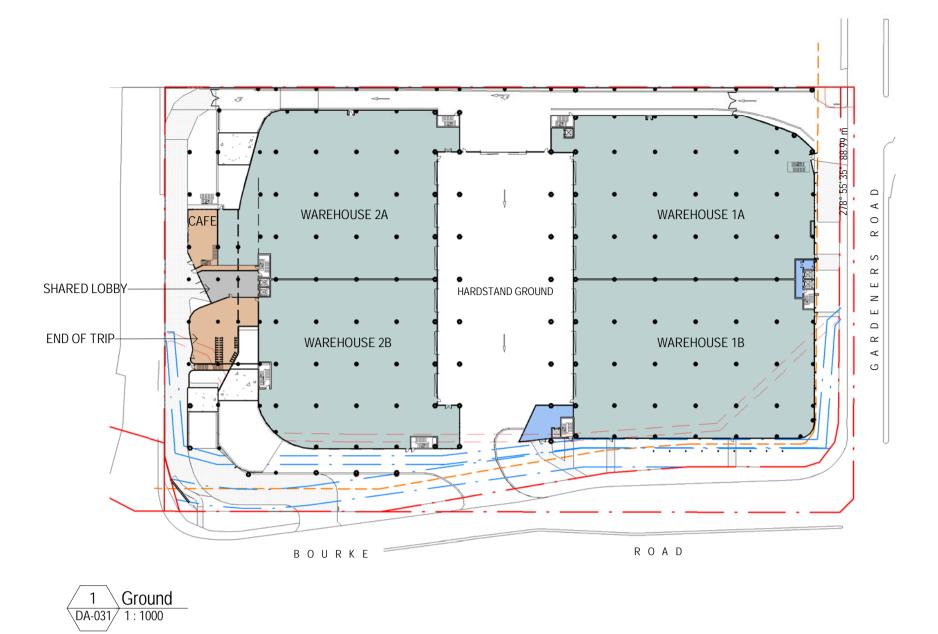


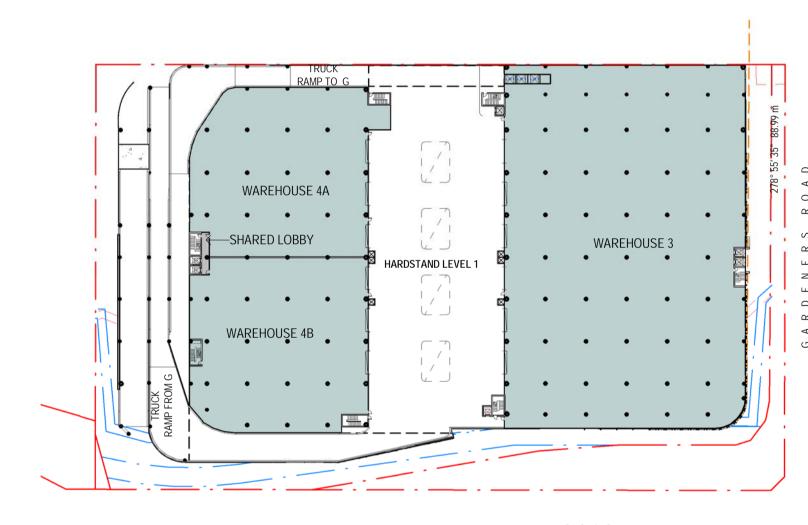







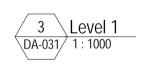

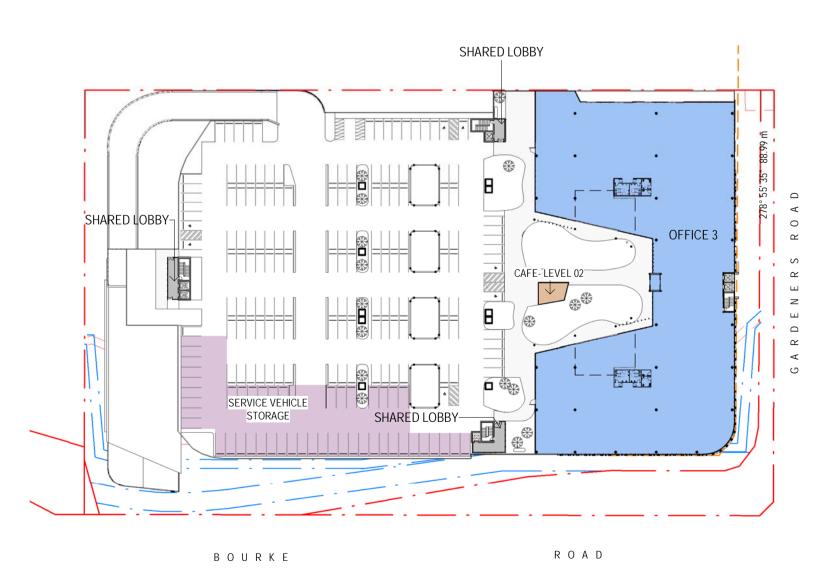


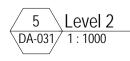

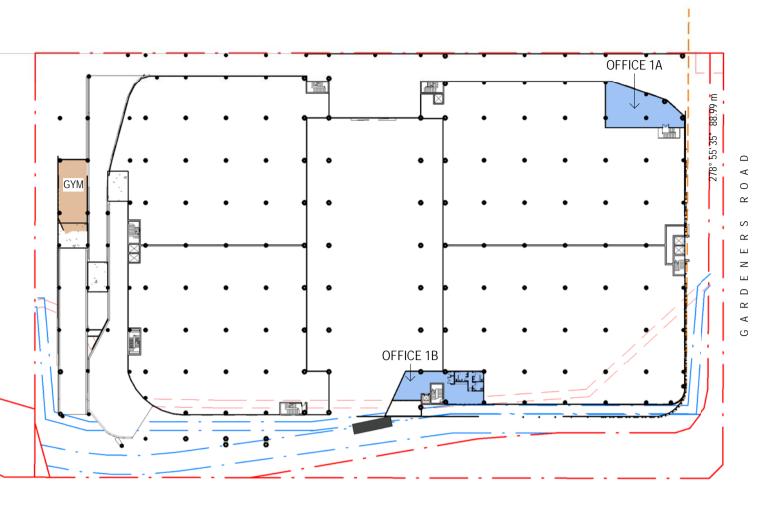

BOURKE

2 Ground M DA-031 1 : 1000

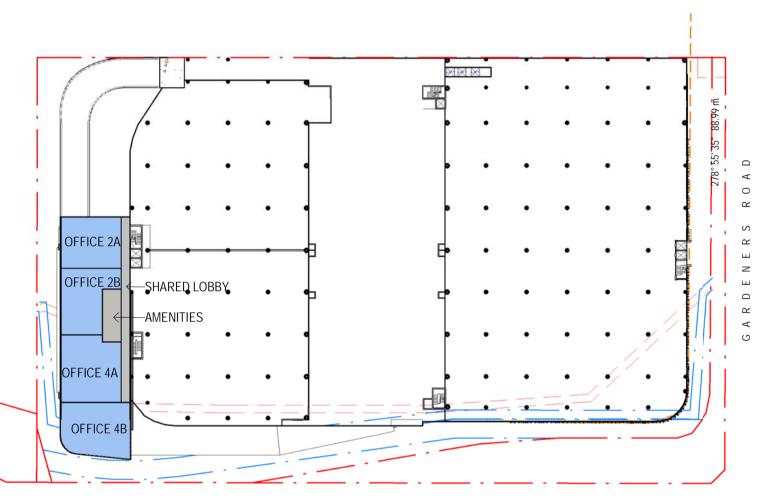

BOURKE

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Total GFA(m²) FSR ACHEIVED

SITE AREA: FSR MAX: MAX GFA:

Parking Schedule			
Level	Description	Count	
Level 2	Carpark Bay -5500x2500	137	
Level 2	Motorbike bay	12	
Level 2	PWD Carpark Bay5500x2500	7	
Level 2	Shared Carpark Bay - 5500x2500	3	
Ground	Bicycle Storage	64	

ROAD

ROAD

4 Level 1 M DA-031 1 : 1000

Area Schedule (GFA)	
Name	Area (m²)
OFFICE 1A	183
OFFICE 1B	239
OFFICE 2A	264
OFFICE 2B	300
OFFICE 3	3967
OFFICE 4A	300
OFFICE 4B	305
sive of lobbies and Amenities)	5557
SERVICE VEHICLE STORAGE	1278
HICLE STORAGE	1278
WAREHOUSE TENANCY 1A	2693
WAREHOUSE TENANCY 1B	2662
WAREHOUSE TENANCY 2A	2372
WAREHOUSE TENANCY 2B	2117
WAREHOUSE TENANCY 3	6085
WAREHOUSE TENANCY 4A	2073
WAREHOUSE TENANCY 4B	2141
E (Inclusive of lobbies)	20144
ANCILLARY	531
Inclusive of end of trip, Gym and café)	531
HOUSE AREA	21952
· · · · · · · · · · · · · · · · · · ·	27509
	27509
VED:	1.45
	18,988 m²
	1.50

1.50 28,482 m²

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Key Plan	2500	

lssue	Description	Date
3	For Information	25.01.22
2	For Information	14.12.21
1	For Information	26.11.21

FOR INFORMATION



Project Name Charter Hall -Alexandria


Project Address 520 Gardeners Rd. Alexandria, NSW 2015

Drawing Title Area Plans


Builder


11596_DA-091		3	
Drawing Number:			Issue:
RA	-	A1	1:1000@A1
Author:	Checker:	Sheet Size:	Scale:




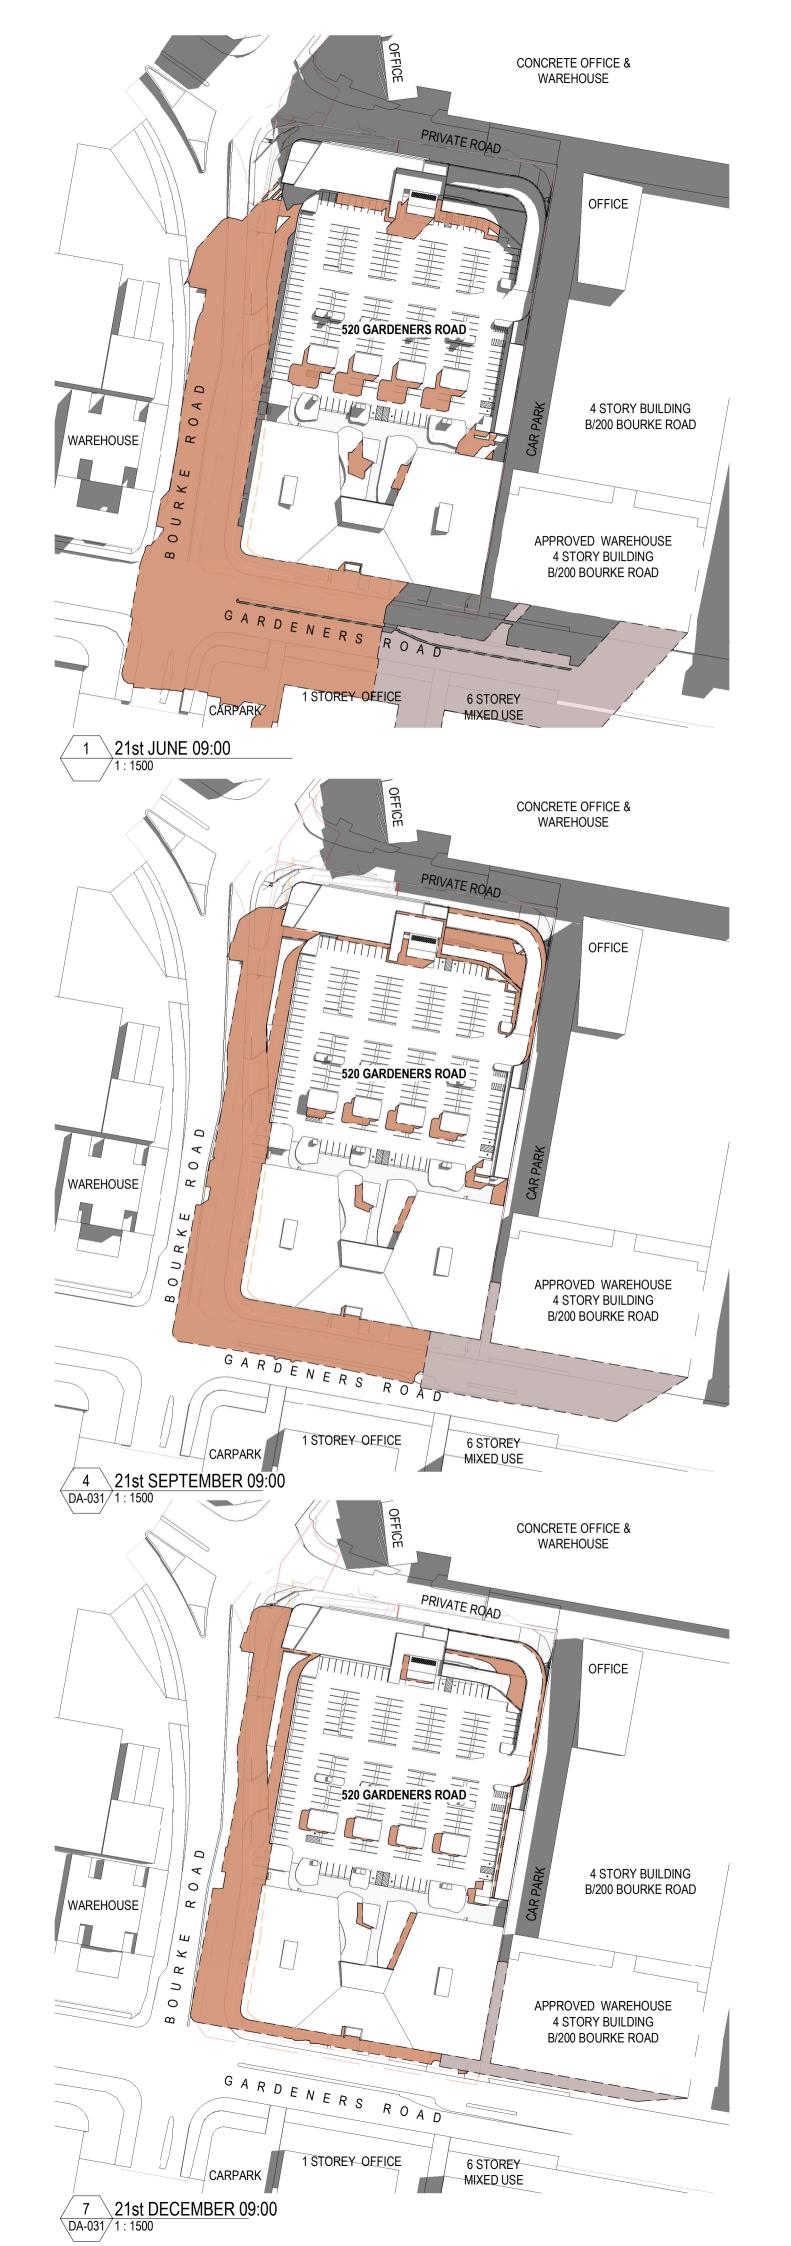


WAREHOUSE

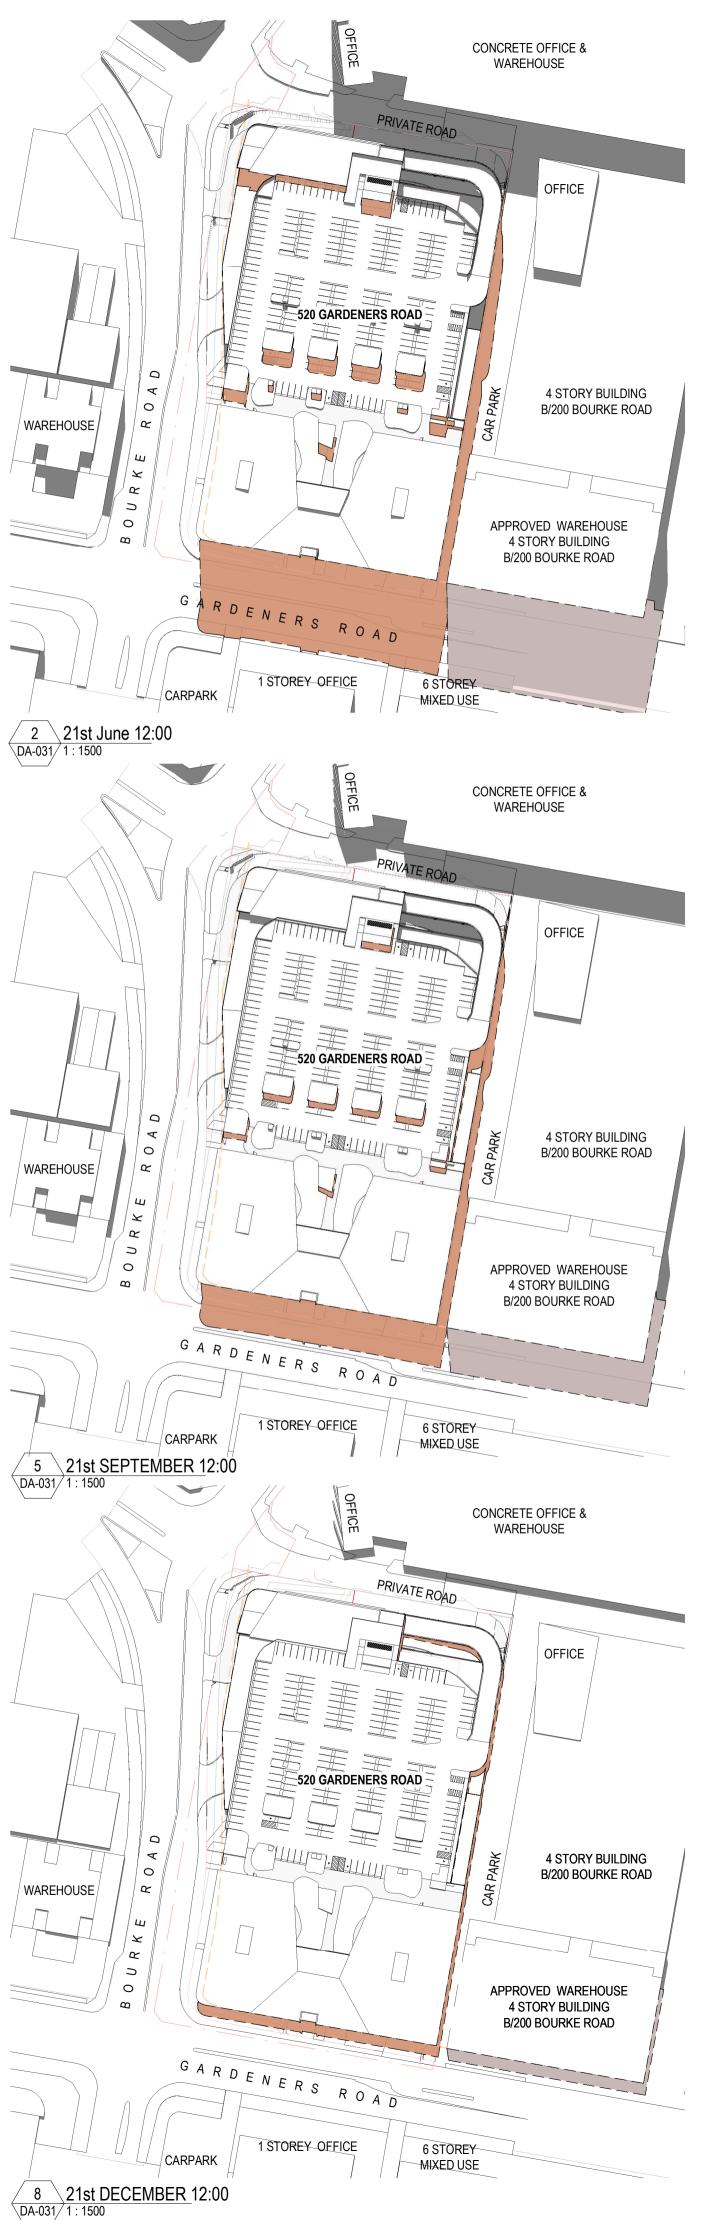

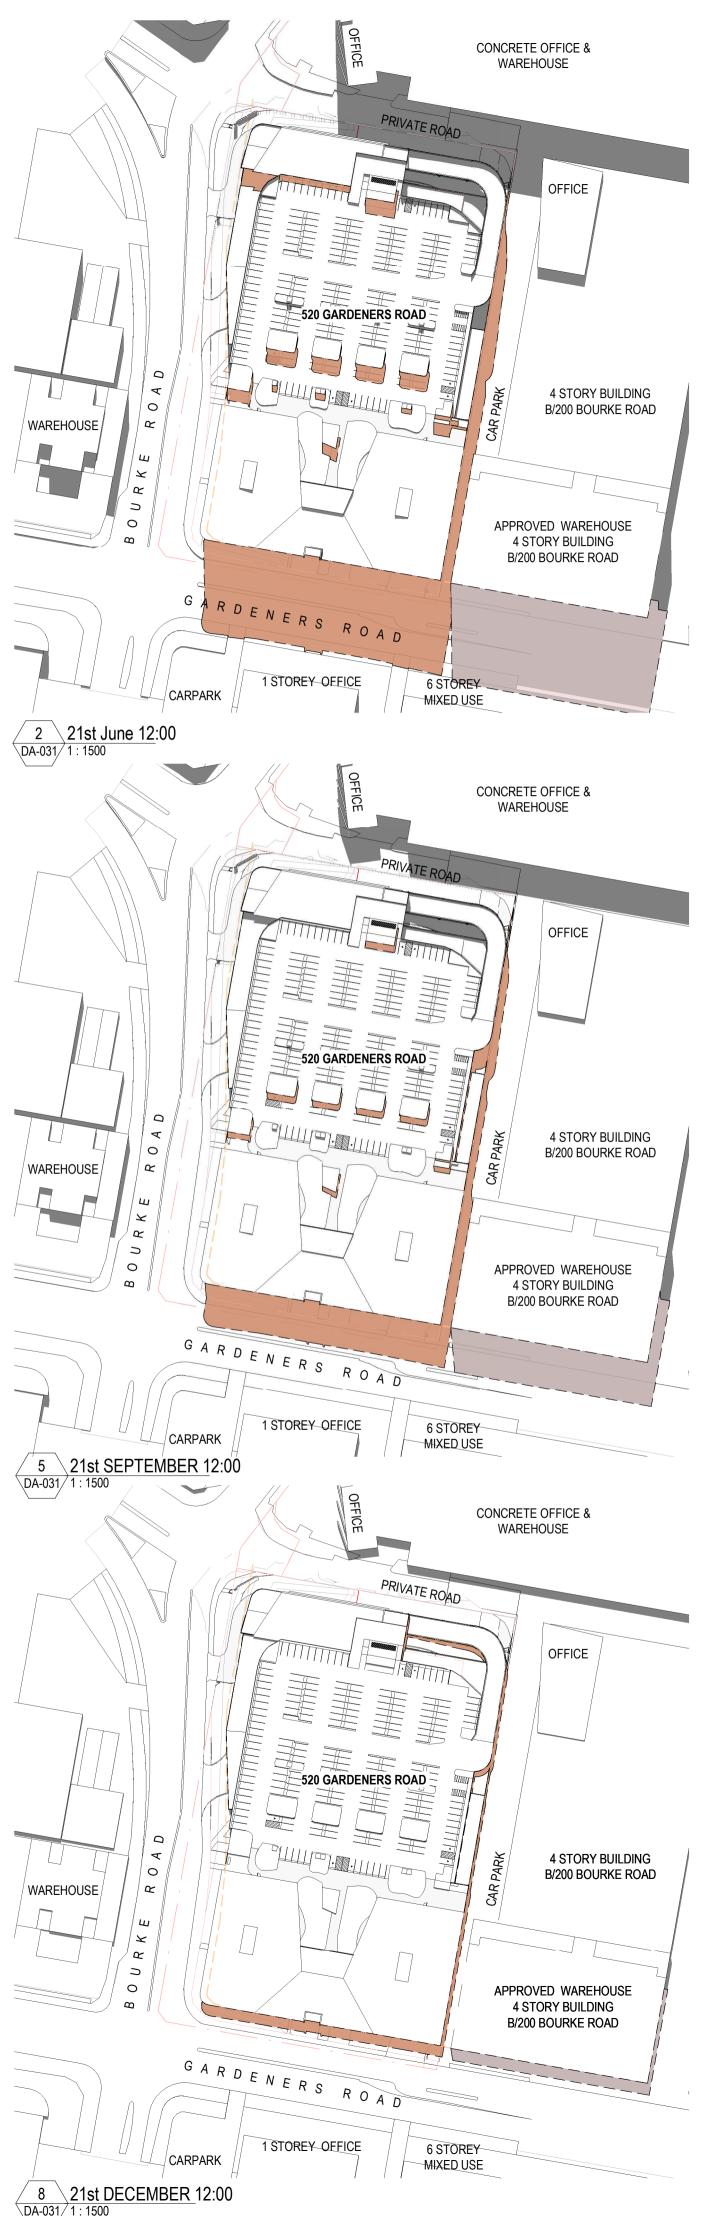

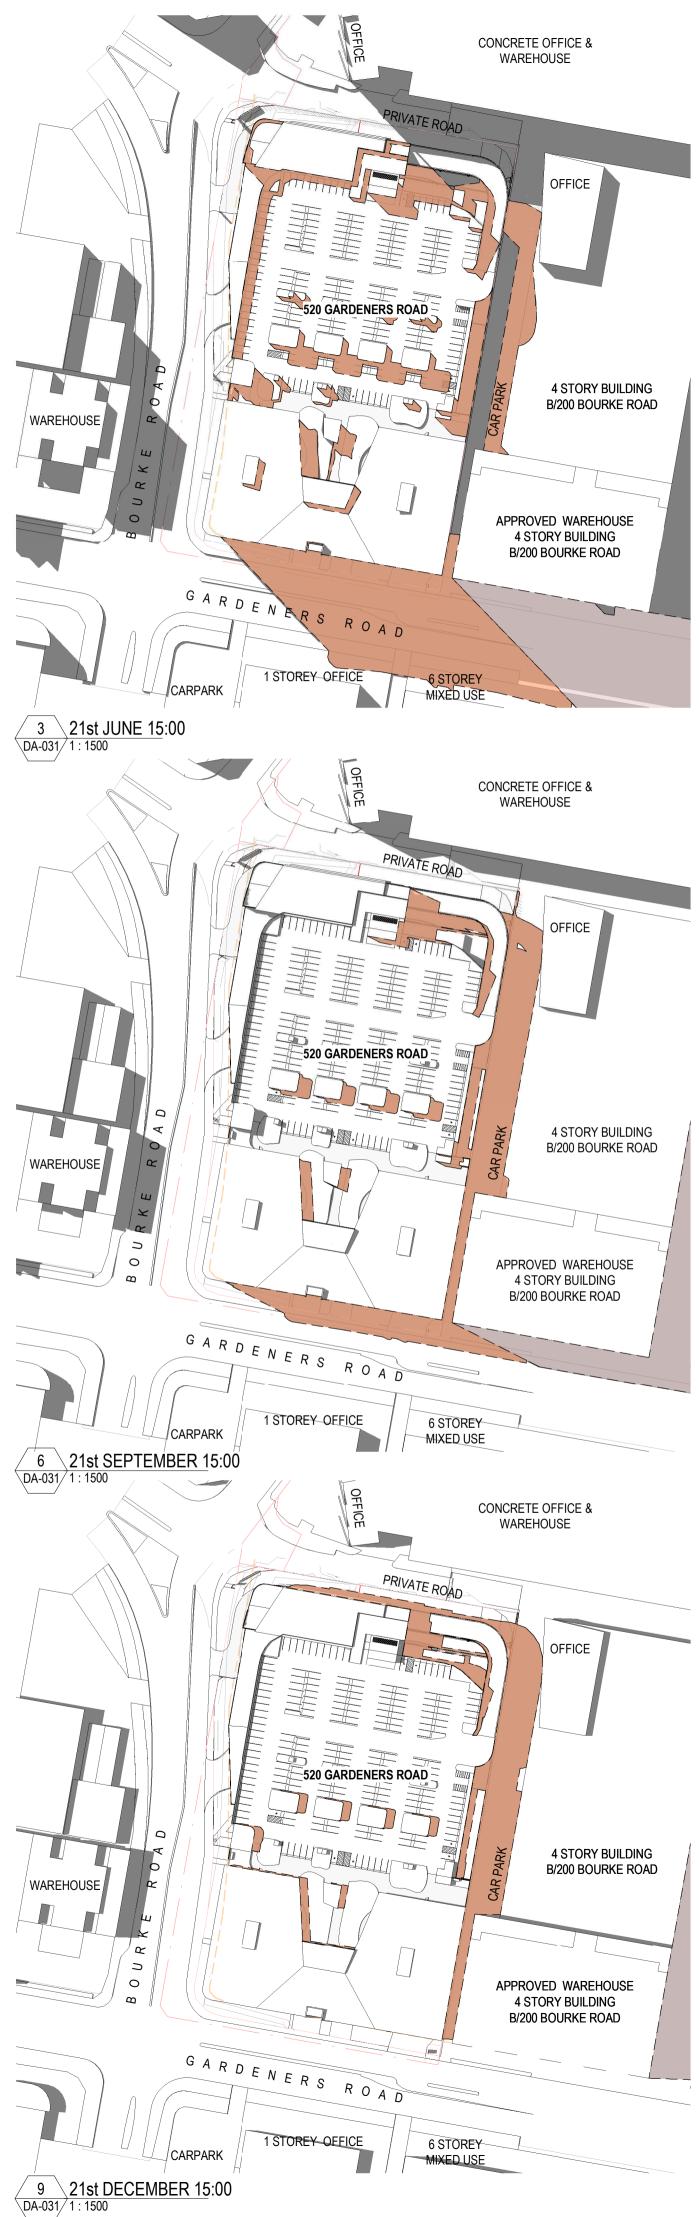

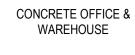

	Plan	
0		75000
Issue	Description	Date
2	For Information For Information	15.03.2
•		
	-	
LEG	END - SHADOW TYPES	
LEG	END - SHADOW TYPES	
LEG	END - SHADOW TYPES SHADOWS - EXISTING	
LEG		
LEG		WAREHOSUE AT R/200

Builder and/or subcontractors shall verify all project dimensions before commencing on-site

ISSUED FOR SSDA



Project Name **Charter Hall -**Alexandria


Builder

Project Address 520 Gardeners Rd. Alexandria, NSW 2015

Drawing Title Shadow Diagarms

Author:	Checker:	Sheet Size:	scale: NTS
Drawing Number:		Issue:	
11596_DA-093		2	

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LANDSCAPE CALCULATIONS

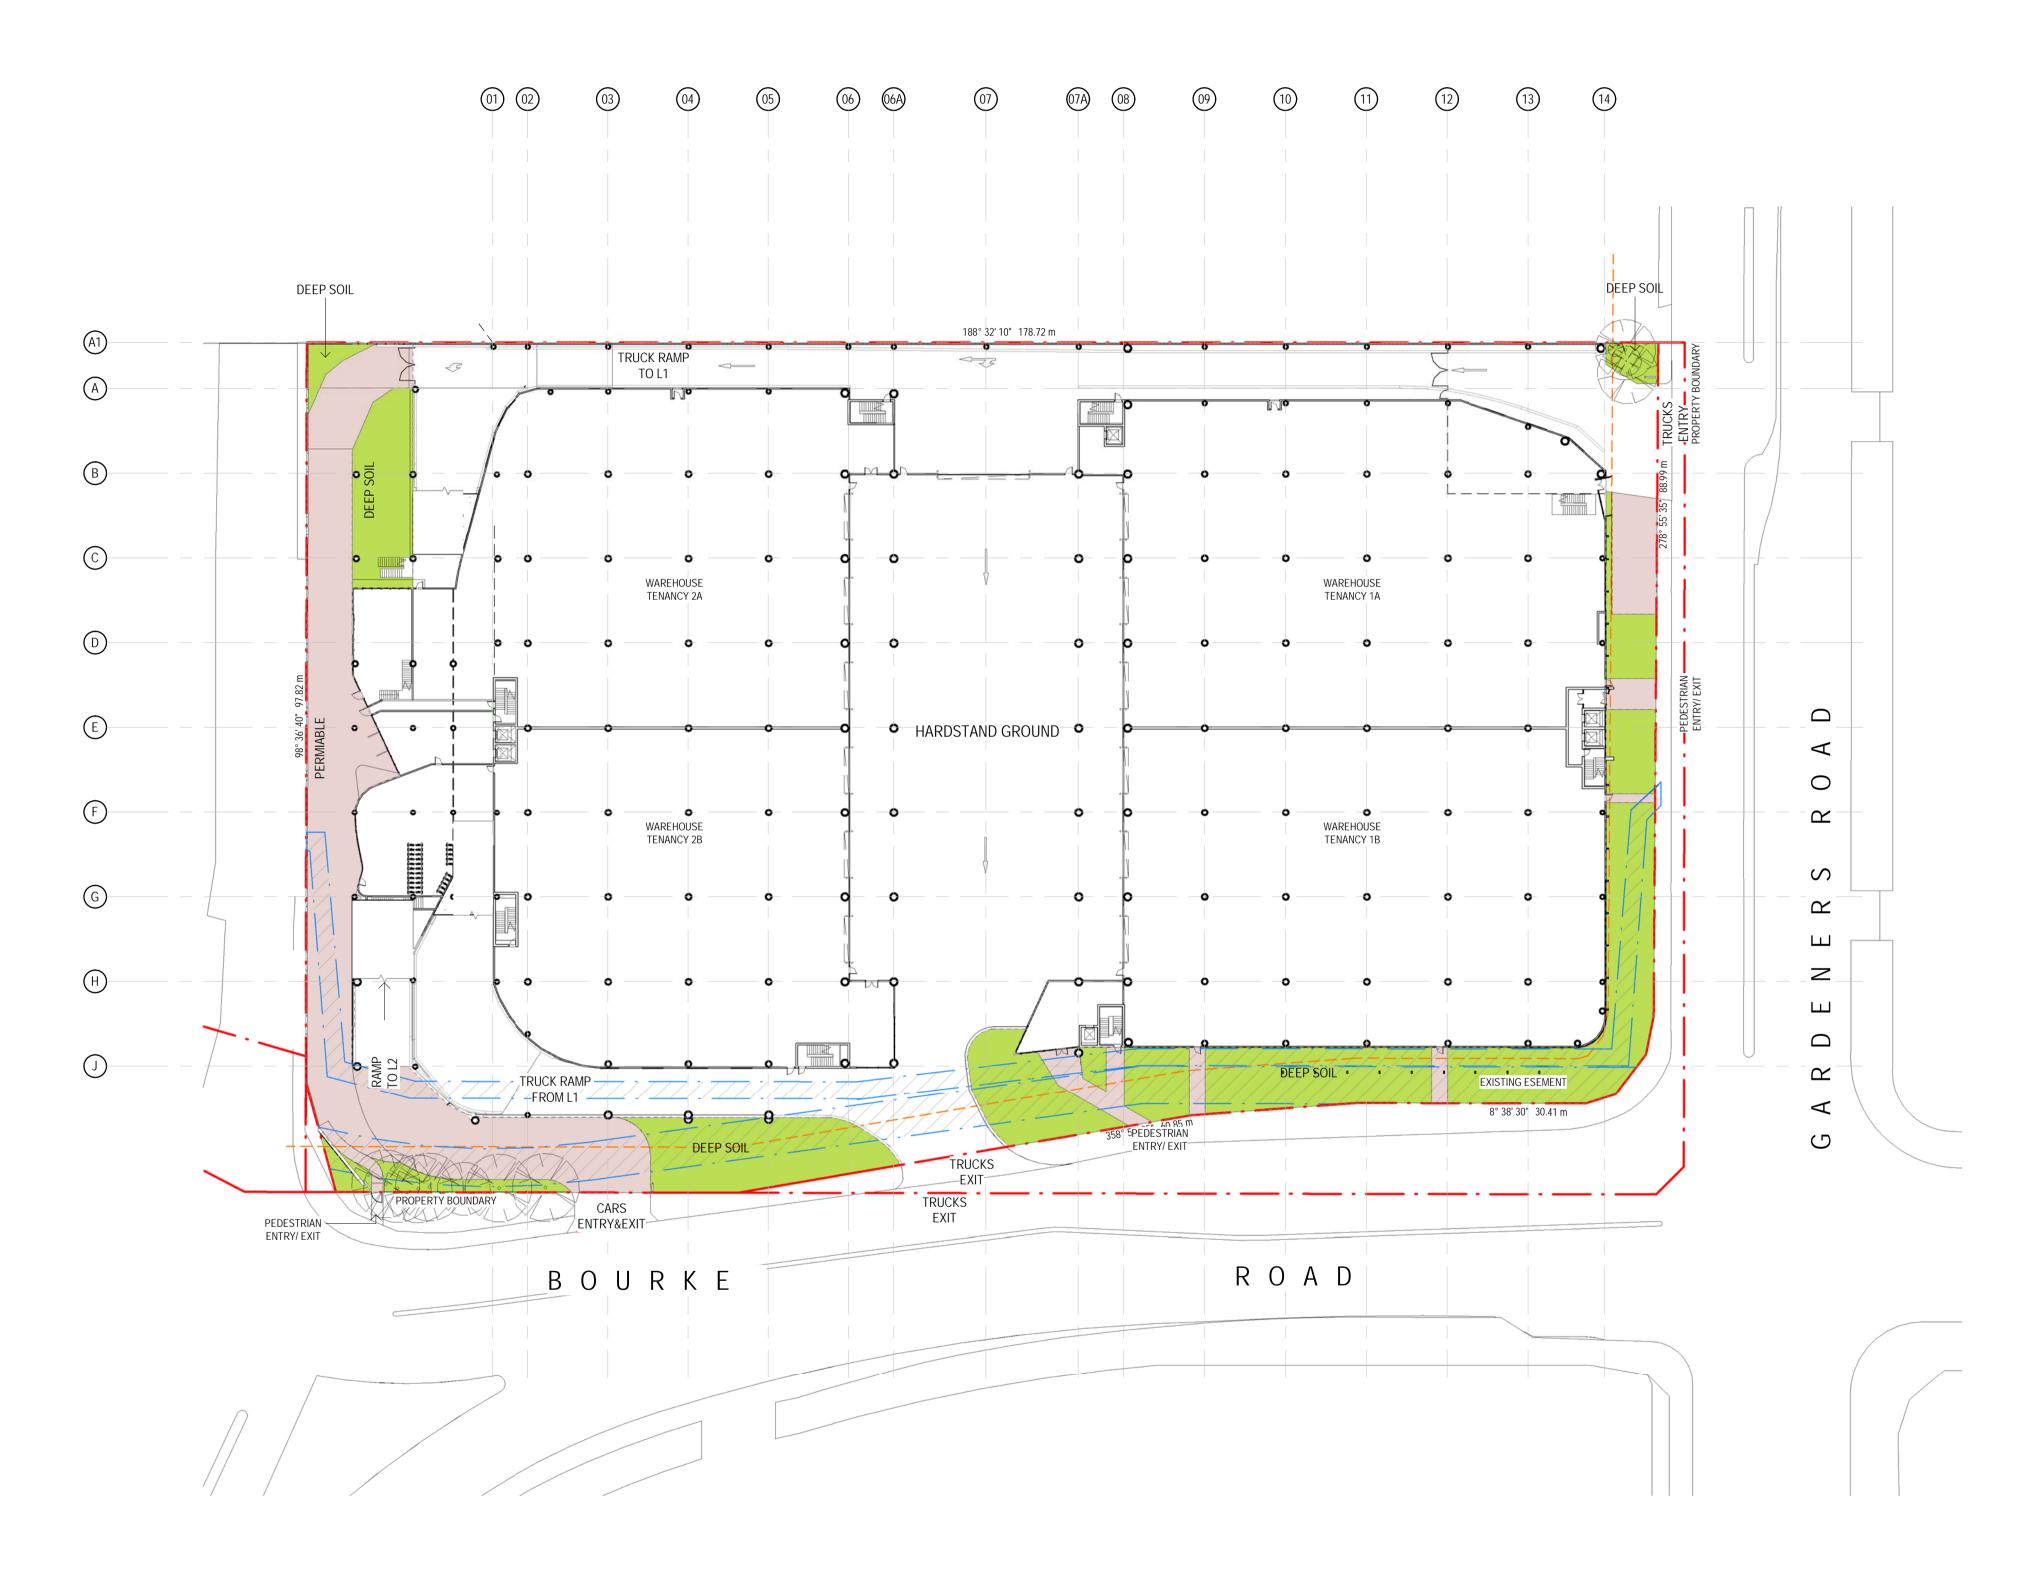EXISTING SITE AREA:

TOTAL % OF DEEP SOIL ACHIVED : LANDSCAPE CALCULATIONS DEEP SOIL PERMIABLE TOTAL AREA OF DEEP SOIL

REQUIRED MIN 15% OF SITE AREA TOTAL AREA OF DEEP SOIL REQUIRED : 18,988m² 2,848m² 15.8%

1644.75 m² 3001.36 m²

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Key Plan	
0 1000 2500	

lssue	Description	Date
2	For Information	14.12.21
1	For Information	26.11.21
	-	

FOR INFORMATION



Project Name Charter Hall -Alexandria

Client

Builder

Project Address 520 Gardeners Rd. Alexandria, NSW 2015

Drawing Title Landscape Area

Drawing Number: 11596_DA-095		2	
Author: RA	Checker:	Sheet Size: A1	scale: 1:500@A1 Issue:

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Key Plan
0 1000 2500

lssue	Description	Date
3	For Information	15.03.22
2	For Information	25.01.22
1	For Information	26.11.21

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Project Name Charter Hall -Alexandria

Builder

Project Address 520 Gardeners Rd. Alexandria, NSW 2015

Drawing Title Perspective - Sheet 01

Author:	Checker:	Sheet Size:	scale: NTS
Drawing Number:			Issue:
11596_DA-097			3

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