

BARKERCOLLEGE 91 Pacific Hwy Hornsby NSW

LANDSCAPE DOCUMENTATION STAGE 1 DA - NORTHERN PRECINCT

SSDA

DRAWING REGISTER


Dwg No.	Drawing Title	Scale	Size
LA-DA-00	Cover Page & Drawing Schedule	N/A	A1
LA-DA-01	Introduction & Design Statement		
LA-DA-02	Landscape Precincts - Stage 1		
LA-DA-03	Existing and Proposed Landscape Precincts		
LA-DA-04	Landscape Nodes Diagram		
LA-DA-05	Key Plan - Northern Precinct	1:100	A1
LA-DA-06	Northern Precinct - Circulation Plan - Stage 1	1:100	A1
LA-DA-07	Northern Precinct - Tree Removal Plan	NTS	A1
LA-DA-08	C Block Landscape Plan	1:100	A1
LA-DA-09	The Avenue - Circulation Routes	1:250	A1
LA-DA-10	The Avenue Landscape Plan	1:250	A1
LA-DA-11	Phipps Taylor & Rosewood Landscape Plan	1:500	A1
LA-DA-12	Planting Palette	NTS	A1
LA-DA-13	SRDP Response	NTS	A1
LA-DA-14	SRDP Response	NTS	A1

GENERAL NOTES


- * FOR SSDA ONLY
- * All tree dimensions and RLs in metres. All other dimensions in mm unless stated otherwise.
- * Do not scale from drawings. Use figured dimensions only. Larger scale drawings and written dimensions take preference.
- * All work shall be carried out in accordance with current versions of Australian Standards, BCA and Local Government Regulations.
- * Structural Details are indicative only and are subject to Structural Engineer's Details and Specifications.
- * Drainage details are subject to Hydraulic / Civil Engineer's Detail and Specification.
- * Subbase details including compaction are to Civil and Structural Engineer's Specification.
- * Lighting Plans are subject to detailed design by a qualified Lighting Consultant or Electrical Contractor.
- * Water Feature Details are indicative only and are subject to detailed design by a specialist Water Feature designer.
- * Service location on plans are indicative only. 360 Degrees Landscape Architects Pty Ltd accepts no responsibility for the accuracy of service locations shown or for services not shown. It is the responsibility of the contractor to determine service locations prior to the commencement of work, including contacting *Dial Before* You Dig and performing on site service locations. Locate and protect all services on site and in adjacent public domain. Any damages to services and associated damages remains the responsibility of the contractor and shall be rectified at no cost to the client or any other party.
- *All adjoining property elements including but not limited to buildings, walls, trees and paving to be protected. Damaged elements remain the responsibility of the contractor and shall be rectified at no cost to the client or any other party. Existing trees to be retained are to be protected to Council and Project Arborist's requirements. No vehicular traffic, stockpiling or storage of materials within Tree Protection Zones (TPZs).
- * No responsibility will be taken by 360 Degrees Landscape Architects Pty Ltd for any variations in design, construction method, materials specified and general specifications without permission from the Project Landscape Architect.
- * This Drawing is copyright to 360 Degrees Landscape Architects Pty Ltd.

LEGEND

EXISTING TREES TO BE RETAINED

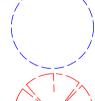

TREE PROTECTION ZONE (TPZ)

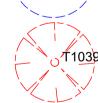

EXISTING TREES TO BE REMOVED



TURF



GARDEN BEDS

CONCRETE PATH - EXPOSED AGGREGATE

PAVERS



TIMBER DECKING

ACRYLIC SPORTS SURFACE

Rev	Amendment	Date	Ву	
Α	Draft SSDA	27/04/22	GD	
В	Draft SSDA	13/05/22	GD	
С	SSDA	02/08/22	GD	
D	SSDA Resubmission	09/09/22	GD	

	IMPORTANT NOTES: Do not scale from drawings All discrepancies to be brought to the attention of the Project Landscape Architect Larger scale drawings and written dimensions take preference. All dimensions in mm unless otherwise stated. All tree dimensions and RLs in metres.	CLIENT Barker College		
	Use figured dimensions only. Verify all dimensions on site before the commencement of any works. Contractors shall locate and protect all services prior to construction. All work shall be carried out in accordance with ASA_BCA and Local Government Regulations. Structural Details shall be subject to Engineer's Specifications. Drainage & Walter Feature Details shall be subject to Hydraulic Engineer's Specifications. All work shall be carried out in a professional manner by Qualified Tradesman according to Landscape Drawings and Engineer's Specifications. No responsibility will be taken by 360 Degrees Landscape Architects Pty Ltd for any variations in design, construction method, materials specified, and general specifications without permission from the Project Engineer or Landscape Architect.	ARCHITECT Neeson Murcutt + Neille		
		SCALE N/A	SIZE A1	

CHECKED GD	DWG. TITLE Cover Page & D
DRAWN KR	PROJECT
STAGE SSDA	Barker College

Drawing List

360° Level 1, 1 Mary's Place Surry Hills, 2010 **P** 02 9332 3601 **W** 360.net.au

INTRODUCTION

360 Degrees Landscape Architects have been enagaged by Barker College to prepare a Staged Landscape Masterplan to correspond with the Staged Architectural Masterplan by Neeson Murcutt + Neille. The SSDA project consists of Stage 1 and future masterplan stages across various precincts within the school.

Stage 1 as outlined on L-DA-02 consists of :

- Block C Walkway
- RB Finlay Walk & The Avenue

- Pedestrian Upgrades to Phipps Taylor and Rosewood Fields

Future Stages as outlined on L-DA-12 to L-DA-15 consists of the Landscape Masterplan for:

- Aquatics and Tennis Courts

- Recital Hall

Block C Walkway

The landscape upgrade to Block C includes new marker trees to the east and west of Block C, with new concrete paving, and seating opportunities for social gathering and spectating the sports field.

RB Finlay Walk & The Avenue

The redevelopment of The Avenue is a significant landscape proposal and follows the purchase of the land by Barker College. The objective is to pedestrianise the former street into a shared zone predominantly for students and teachers whilst allowing for maintenance and emergency vehicular access to new and existing buildings. The character of the landscape will extend the language of the recently constructed landscape to the northern facade of Rosewood Sports Centre, tying together new and old buildings along RB Finlay Walk. The resurfaced shared path will extend along RB Finlay Walk to Chapel Drive where it will meet the Block C works, providing a strong east west connection from Block C to the new entrance at Unwins Road.

Pedestrian Upgrades to Phipps Taylor and Rosewood Fields

The pedestrian upgrades to Phipps Taylor and Rosewood Fields involve new paths, stairs, and seating opportunities to improve circulation on a north south axis and provide passive areas for socialisation and spectating sports on Rosewood Field. The path design in Stage 1 is proposed to be extended in the Future Stages to provide pedestrian connections to Aquatics and Tennis, and Recital Hall.

Existing and Proposed Precincts

The planting design will enhance the existing character of the school. As outlined on L-DA-03, the existing plantings create three distinct precints which intersect:


- Heritage Landscape to the Upper Campus
- Parklands Landscape to the Western Campus
- Bluegum Forest Landscape to the Lower/Eastern Campus

These precincts intersect forming an axis and bicultural landscape through the centre of the school. The use of mixed exotic and native species will enhance this bicultural intersection and strengthen the central campus precincts and spines.

Connecting with Country

A series of nodes has been identified across the campus landscape to be developed for place-based, narrative-driven, visualised learning. These nodes provide settings for the integration of First Nation story-telling in support of Aboriginal ways of learning within a broader curriculum. Refer L-DA-04 and the Architectural Design Report by Neeson Murcutt + Neille.

MASTERPLAN PRINCIPLES

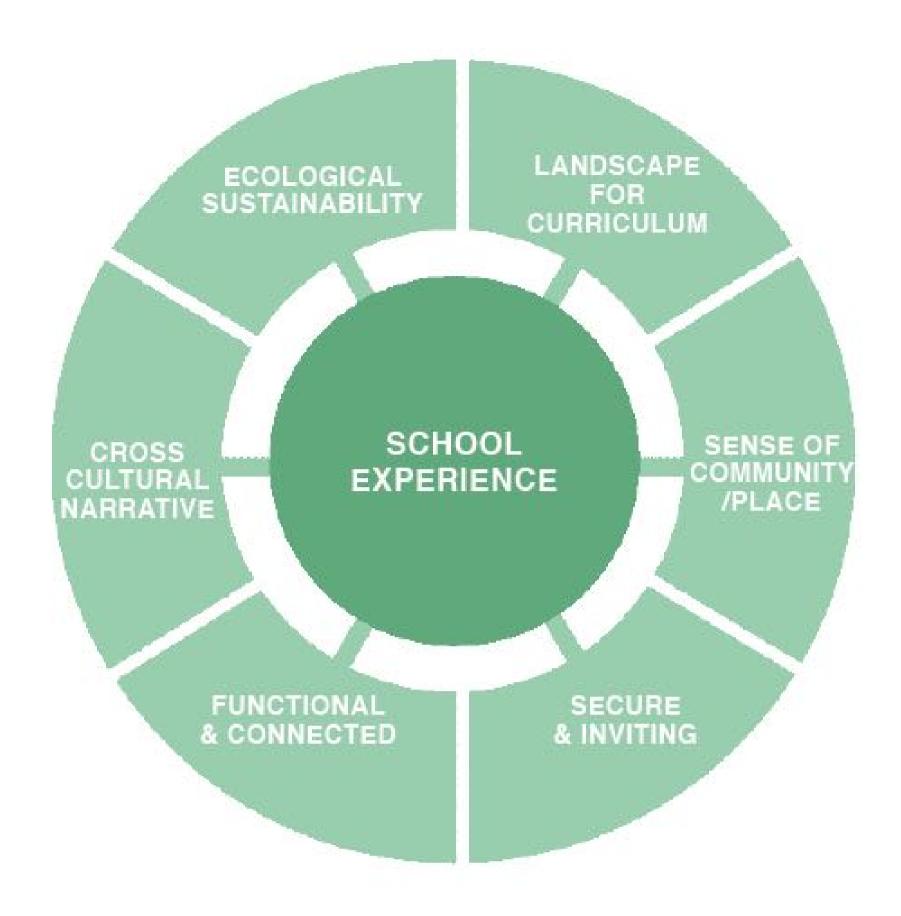

MASTERPLAN STRATEGIES

Enhance campus connections by prioritising pedestrian movement and improve wayfinding through activated landscape spines

Create adaptive landscape spaces to provide opportunities for learning, social & recreation activities to support building functions and enhance campus facilities

Unify existing campus planting characters through the establishment of landscape precincts that respond to campus heritage, endemic vegetation communities & site microclimates

Establish sustainable & resilient landscapes while providing learning opportunities within the landscape

Respect & enhance campus heritage & First Nations narratives throughout the campus' landscape spaces













Rev	Amendment	Date	Ву	
Α	Draft SSDA	27/04/22	GD	ı
В	Draft SSDA	13/05/22	GD	ı
С	SSDA	02/08/22	GD	ı
D	SSDA Resubmission	09/09/22	GD	ı

IMPORTANT NOTES: Do not scale from drawings All discrepanics to be brought to the attention of the Project Landscape Architect Larger scale drawings and written dimensions take preference. All dimensions in mm unless otherwise stated. All tree dimensions and RLs in microsions and Rus
Structural Details shall be subject to Engineer's Specifications. Drainage & Water Feature Details shall be subject to Hydraulic Engineer's Specifications. All work shall be carried out in a professional manner by Qualified Tradesman according to Landscape Drawings: Engineer's Specifications.
No responsibility will be taken by 360 Degrees Landscape Architects Pty Ltd for any variations in design, construct method, materials specified, and general specifications without permission from the Project Engineer or Landscap Architect. Architect.

				_
	CLIENT Barker College	CHECKED GD		
	ARCHITECT Neeson Murcutt	DRAWN KR		
n	SCALE N/A	SIZE A1	STAGE SSDA	

DWG. TITLE **Introduction & Design Statement** PROJECT **Barker College**

Landscape Precincts

Landscape Stage 1

Block C Walkway

- Strengthen East-West campus connections
- Improve visual connection to Bowman Field
- Provide equitable access (DDA compliant)



Vehicle & Pedestrian Upgrades


- Strengthen North-South campus connections
- Improve Vehicle Drop off/Pick up from College Cres
- Extend connections to Maths Building forecourt





RB Finlay Walk

- Strengthen East-West campus connections
- Provide equitable access (DDA compliant)
- Create usable landscape spaces for the

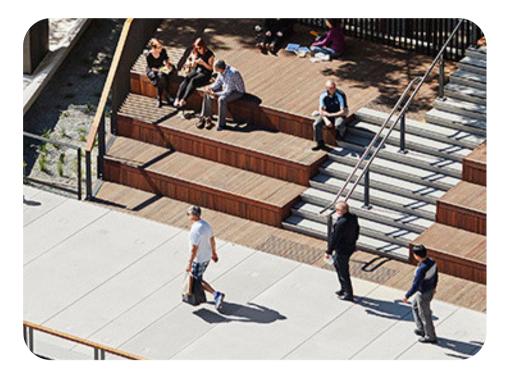

The Avenue

- Pedestrian prioritised shared street
- Enhance Campus entry from Unwin Rd
- Create usable landscape spaces for the
- Provide equitable access (DDA compliant)



Rev	Amendment	Date	Ву	
Α	Draft SSDA	27/04/22	GD	
В	Draft SSDA	13/05/22	GD	
С	SSDA	02/08/22	GD	
D	SSDA Resubmission	09/09/22	GD	
				1


IMPORTANT NOTES: Do not scale from drawings All discrepancies to be brought to the attention of the Project Landscape Architect Larger scale drawings and written dimensions take preference. All dimensions in mm unless otherwise stated. All tree dimensions and RLs in metres.	CLIENT Barker College		
Use figured dimensions only. Verify all dimensions on site before the commencement of any works. Contractors shall locate and protect all services prior to construction. All work shall be carried out in accordance with ASA, RCA and Local Government Regulations. Structural Details shall be subject to Engineer's Specifications. Structural Details shall be subject to Hydraulic Engineer's Specifications. All work shall be aread to Potalis shall be subject to Hydraulic Engineer's Specifications. All wore shall be all the shall be subject to Hydraulic Engineer's Specifications. Engineer's Specifications. No responsibility will be taken by 300 Degrees Landacape Architects Pty Ltd for any variations in design, construction method, materials specified, and general specifications without permission from the Project Engineer or Landscape Architect.	ARCHITECT Neeson Murcutt	+ Neille	DRAWN KR
	SCALE N/A	SIZE A1	STAGE SSD/

Existing Landscape Precincts Proposed Landscape Precinct



HERITAGE LANDSCAPE

- Upper Campus
- Primarily exotic species, planted in a heritage style consistent with surrounding building age
- Key species: Camellia's, Roses, Azaleas, Rhododendrons, Buxus

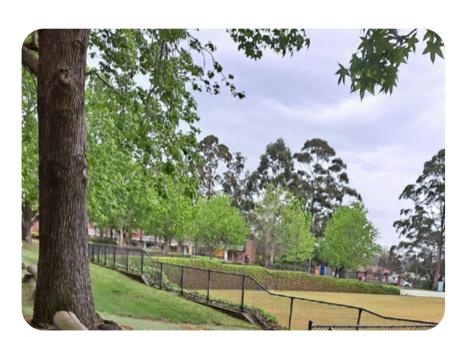

PARKLAND LANDSCAPE

- Western Campus/Barker Oval
- Trees in parkland style landscape. Avenue plantings
- Key species: Deciduous trees such as Maples, Liquid Ambers, Oaks



BLUEGUM FOREST LANDSCAPE


- Lower / Eastern Campus
- Primarily endemic native species of Blue Gum High Forest community
- Key species: Blue Gums (Eucalyptus saligna) , Forest Oak (*Allocasuarina torulosa*) Lillypilly (Acmena smithii) Wonga Wong Vine (*Pandorea pandorana*), Lomandra



BICULTURAL LANDSCAPE

- Unification of existing landscape characters within the central campus precincts & spines
 - Mixed exotic & native species with cultural / educational opportunities for learning landscapes
- Key species: Banksias, Waratahs, Native Grasses, Grass Trees, Roses, Gingko, Lavender



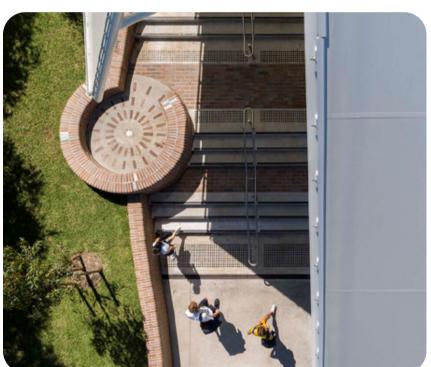



Rev	Amendment	Date	В
Α	Draft SSDA	27/04/22	G
В	Draft SSDA	13/05/22	G
С	SSDA	02/08/22	G
D	SSDA Resubmission	09/09/22	G


Do All e Lar	IMPORTANT NOTES: Do not scale from drawings All discrepancies to be brought to the attention of the Project Landscape Architect Larger scale drawings and written dimensions take preference. All dimensions in mm unless otherwise stated. All tree dimensions and RLs in metres.	CLIENT Barker College	CHECKED GD	
	Use figured dimensions only Vorify all dimensions on site before the commencement of any works. Contractors shall locate and protect all services prior to construction. All work shall be carried out in accordance with ASA, BCA and Local Government Regulations. Structural Details shall be subject to Engineer's Specifications. Drainage & Water Feature Details shall be subject to Hydraulic Engineer's Specifications.	ARCHITECT Neeson Murcutt + Neille		DRAWN KR
Engineer's Specifications. No responsibility will be taken by 360 Degrees Landscape Architects Pty Ltd for a	No responsibility will be taken by 360 Degrees Landscape Architects Pty Ltd for any variations in design, construction method, materials specified, and general specifications without permission from the Project Engineer or Landscape Architect.	scale N/A	SIZE A1	STAGE SSDA

Connecting With Country






- 1. Mint Gates primary Barker address on Pacific Highway: ancient Aboriginal track
- 2. Chapel forecourt: spiritual centre of Barker College
- 3. Eastern end of new C-Block walk: new landscape space at intersection of primary north-south + east-west pathways
- 4. Western end of new C-Block walk: new landscape space
- 5. The Soundstage: a loved school community meeting place
- 6. Front of Music: new landscape space
- 7. Front of Maths: new landscape space
- 8. The Avenue between main entries to Rosewood + Centenary Design Centre: top of the ridge
- 9. Rosewood Fields: new landscape space
- 10. Memorial Oval: a loved school community place
- 11. Chapel Drive south: within landscape looking north
- 12. Aquatics forecourt: on lower part of core campus
- 13. Recital forecourt: South of Clarke Road arrival space

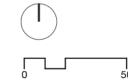

NEESON MURCUTT + NEILLE

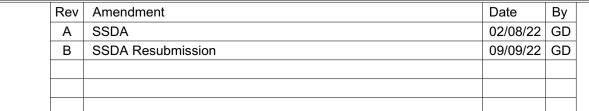




CLIENT
Barker College CHECKED GD DRAWN KR Neeson Murcutt + Neille STAGE SSDA

Landscape Nodes Diagram PROJECT
Barker College



P 02 9332 3601 W 360.net.au ABN 90 146 901 322

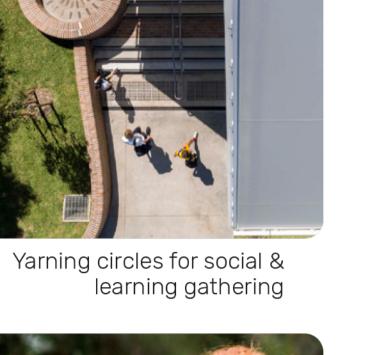



Landscapes for learning




Material & form expression



Places for ceremony or reflection

source: 360 DEGREES LANDSCAPE

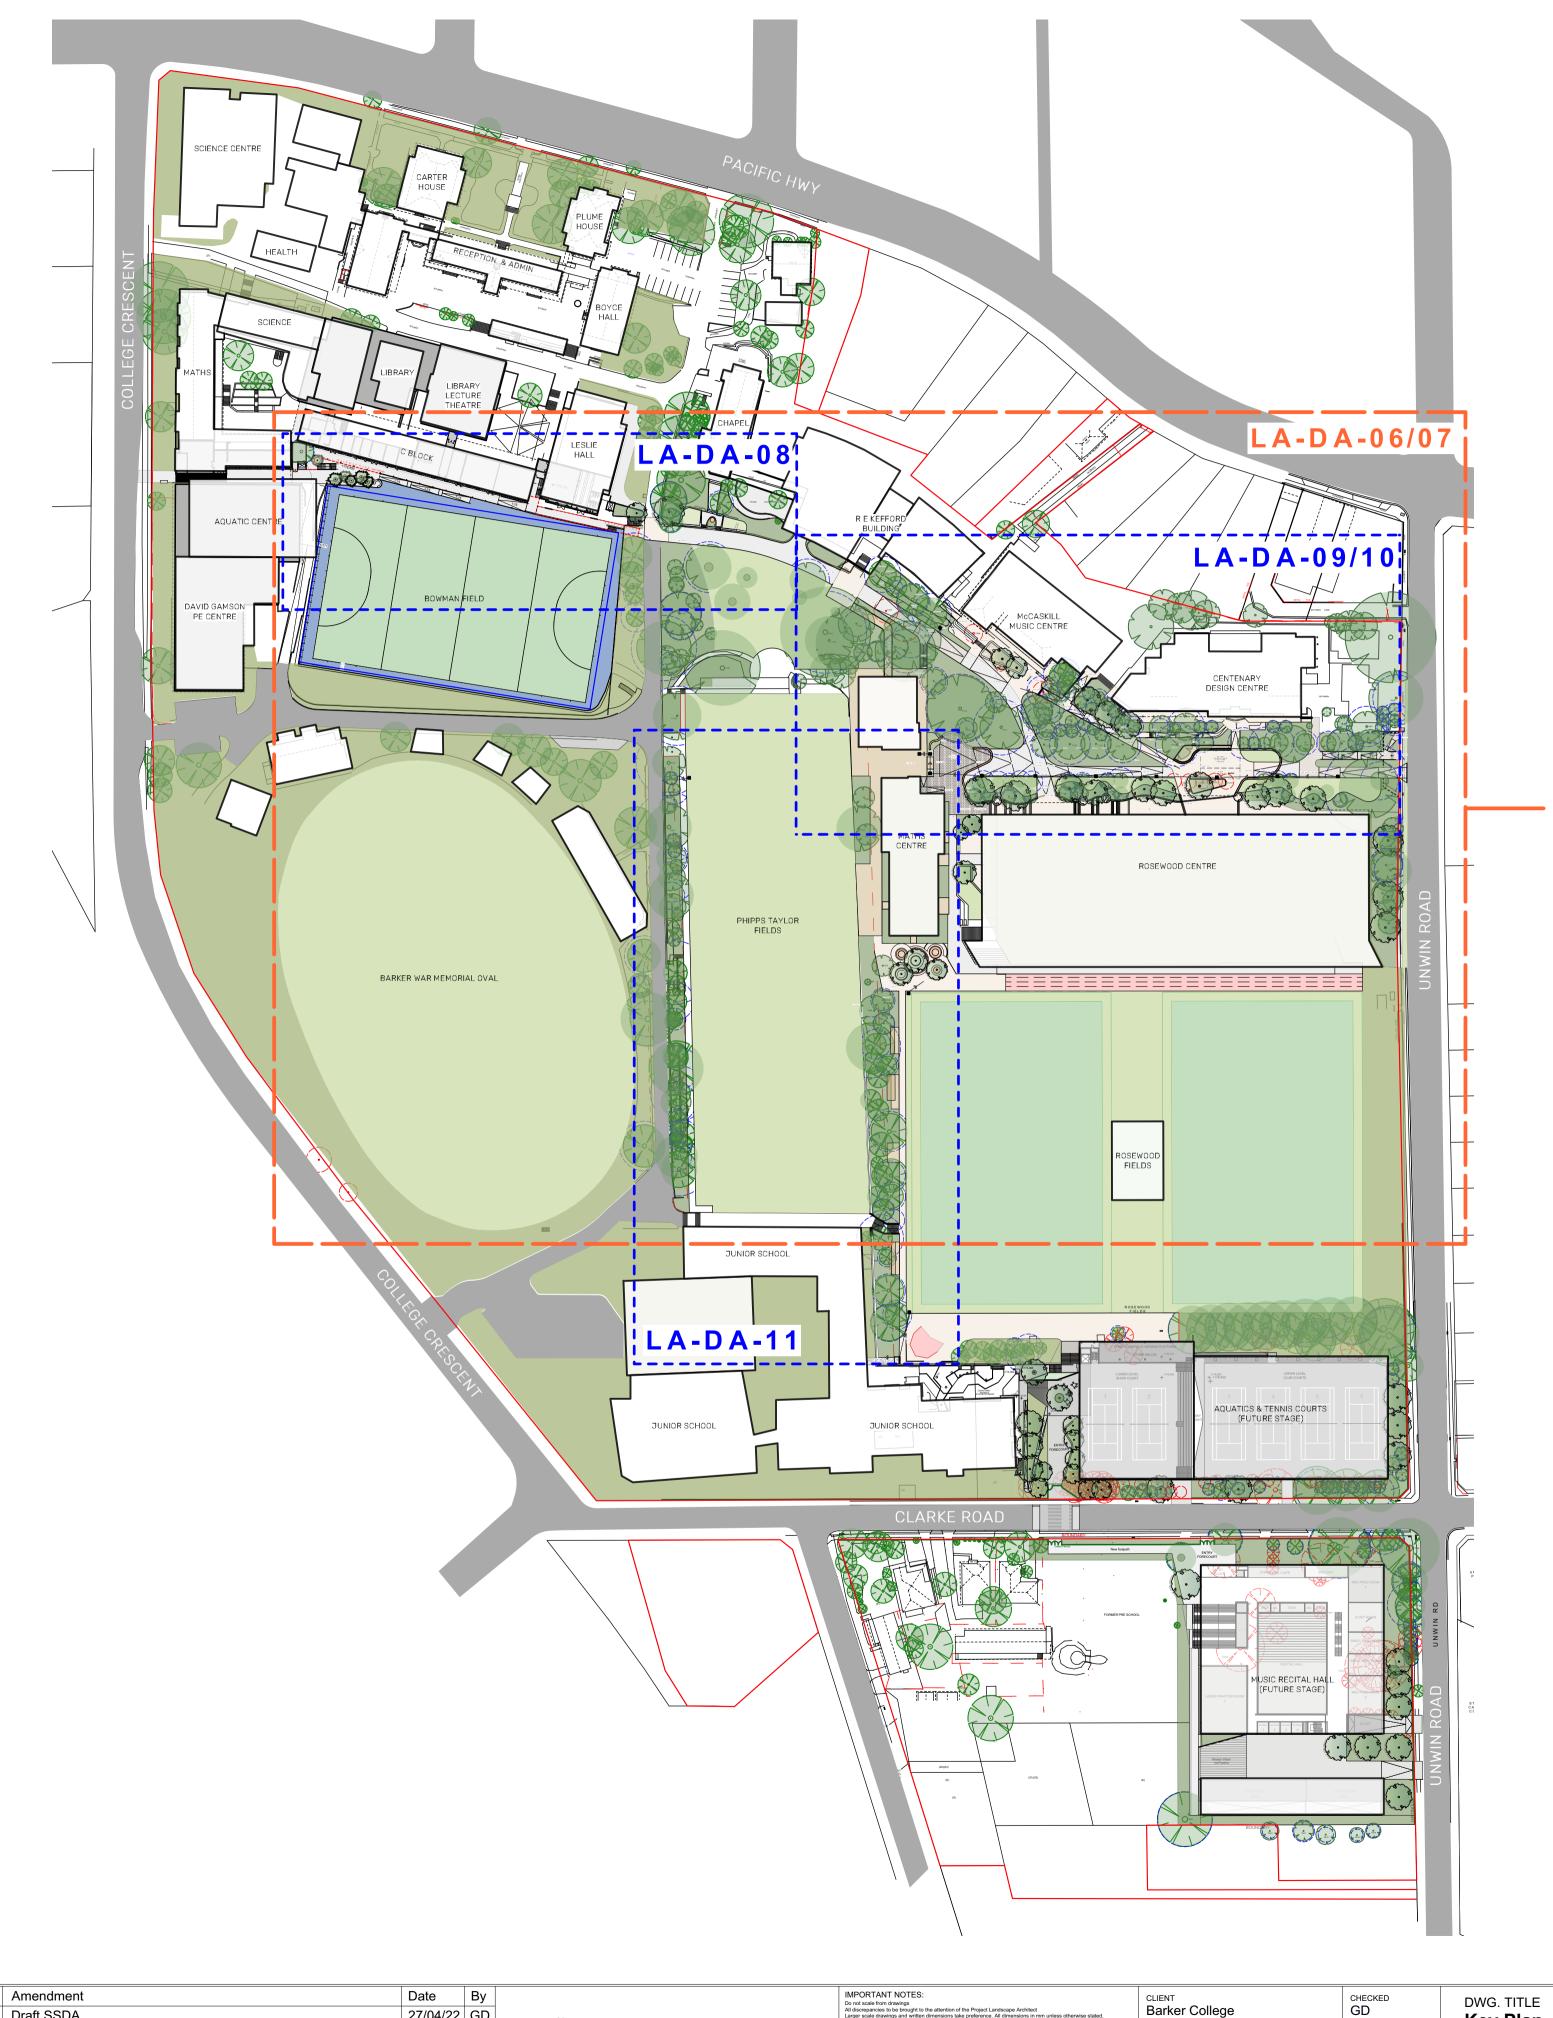

NORTHERN PRECINCT

SOUTHERN PRECINCT SHOWN FOR INFORMATION REFER SEPARATE PACKAGE LA-DA-20 to 25

 Rev
 Amendment
 Date
 By

 A
 Draft SSDA
 27/04/22 GD


 B
 Draft SSDA
 13/05/22 GD

 C
 SSDA
 02/08/22 GD


 D
 SSDA Resubmission
 09/09/22 GD

T

				_
PORTANT NOTES: not scale from drawings siscrepanices to be brought to the attention of the Project Landscape Architect per scale drawings and written dimensions take preference. All dimensions in mm unless otherwise stated. red idmensions and RLs in metres.	CLIENT Barker College		CHECKED GD	
figured dimensions only, y all dimensions on site before the commencement of any works, tractors shall locate and protect all services prior to construction, oxivis shall be cautied out in accordance with ASA, BCA and Local Government Regulations, ctural Details shall be subject to Engineer's Specifications, ange & Water Fauture Details shall be subject to Hydraulic Engineer's Specifications, oxivis shall be carried out in a professional manner by Qualified Tradesman according to Landscape Drawings and neer's Specifications. seponsibility will be taken by 360 Degrees Landscape Architects Pty Ltd for any variations in design, construction nod, materials specified, and general specifications without permission from the Project Engineer or Landscape Drawing is conviols to 360 Degrees Landscape Architects Pty Ltd.	ARCHITECT Neeson Murcutt	+ Neille	DRAWN KR	
	SCALE 1:1250	SIZE A1	STAGE SSDA	

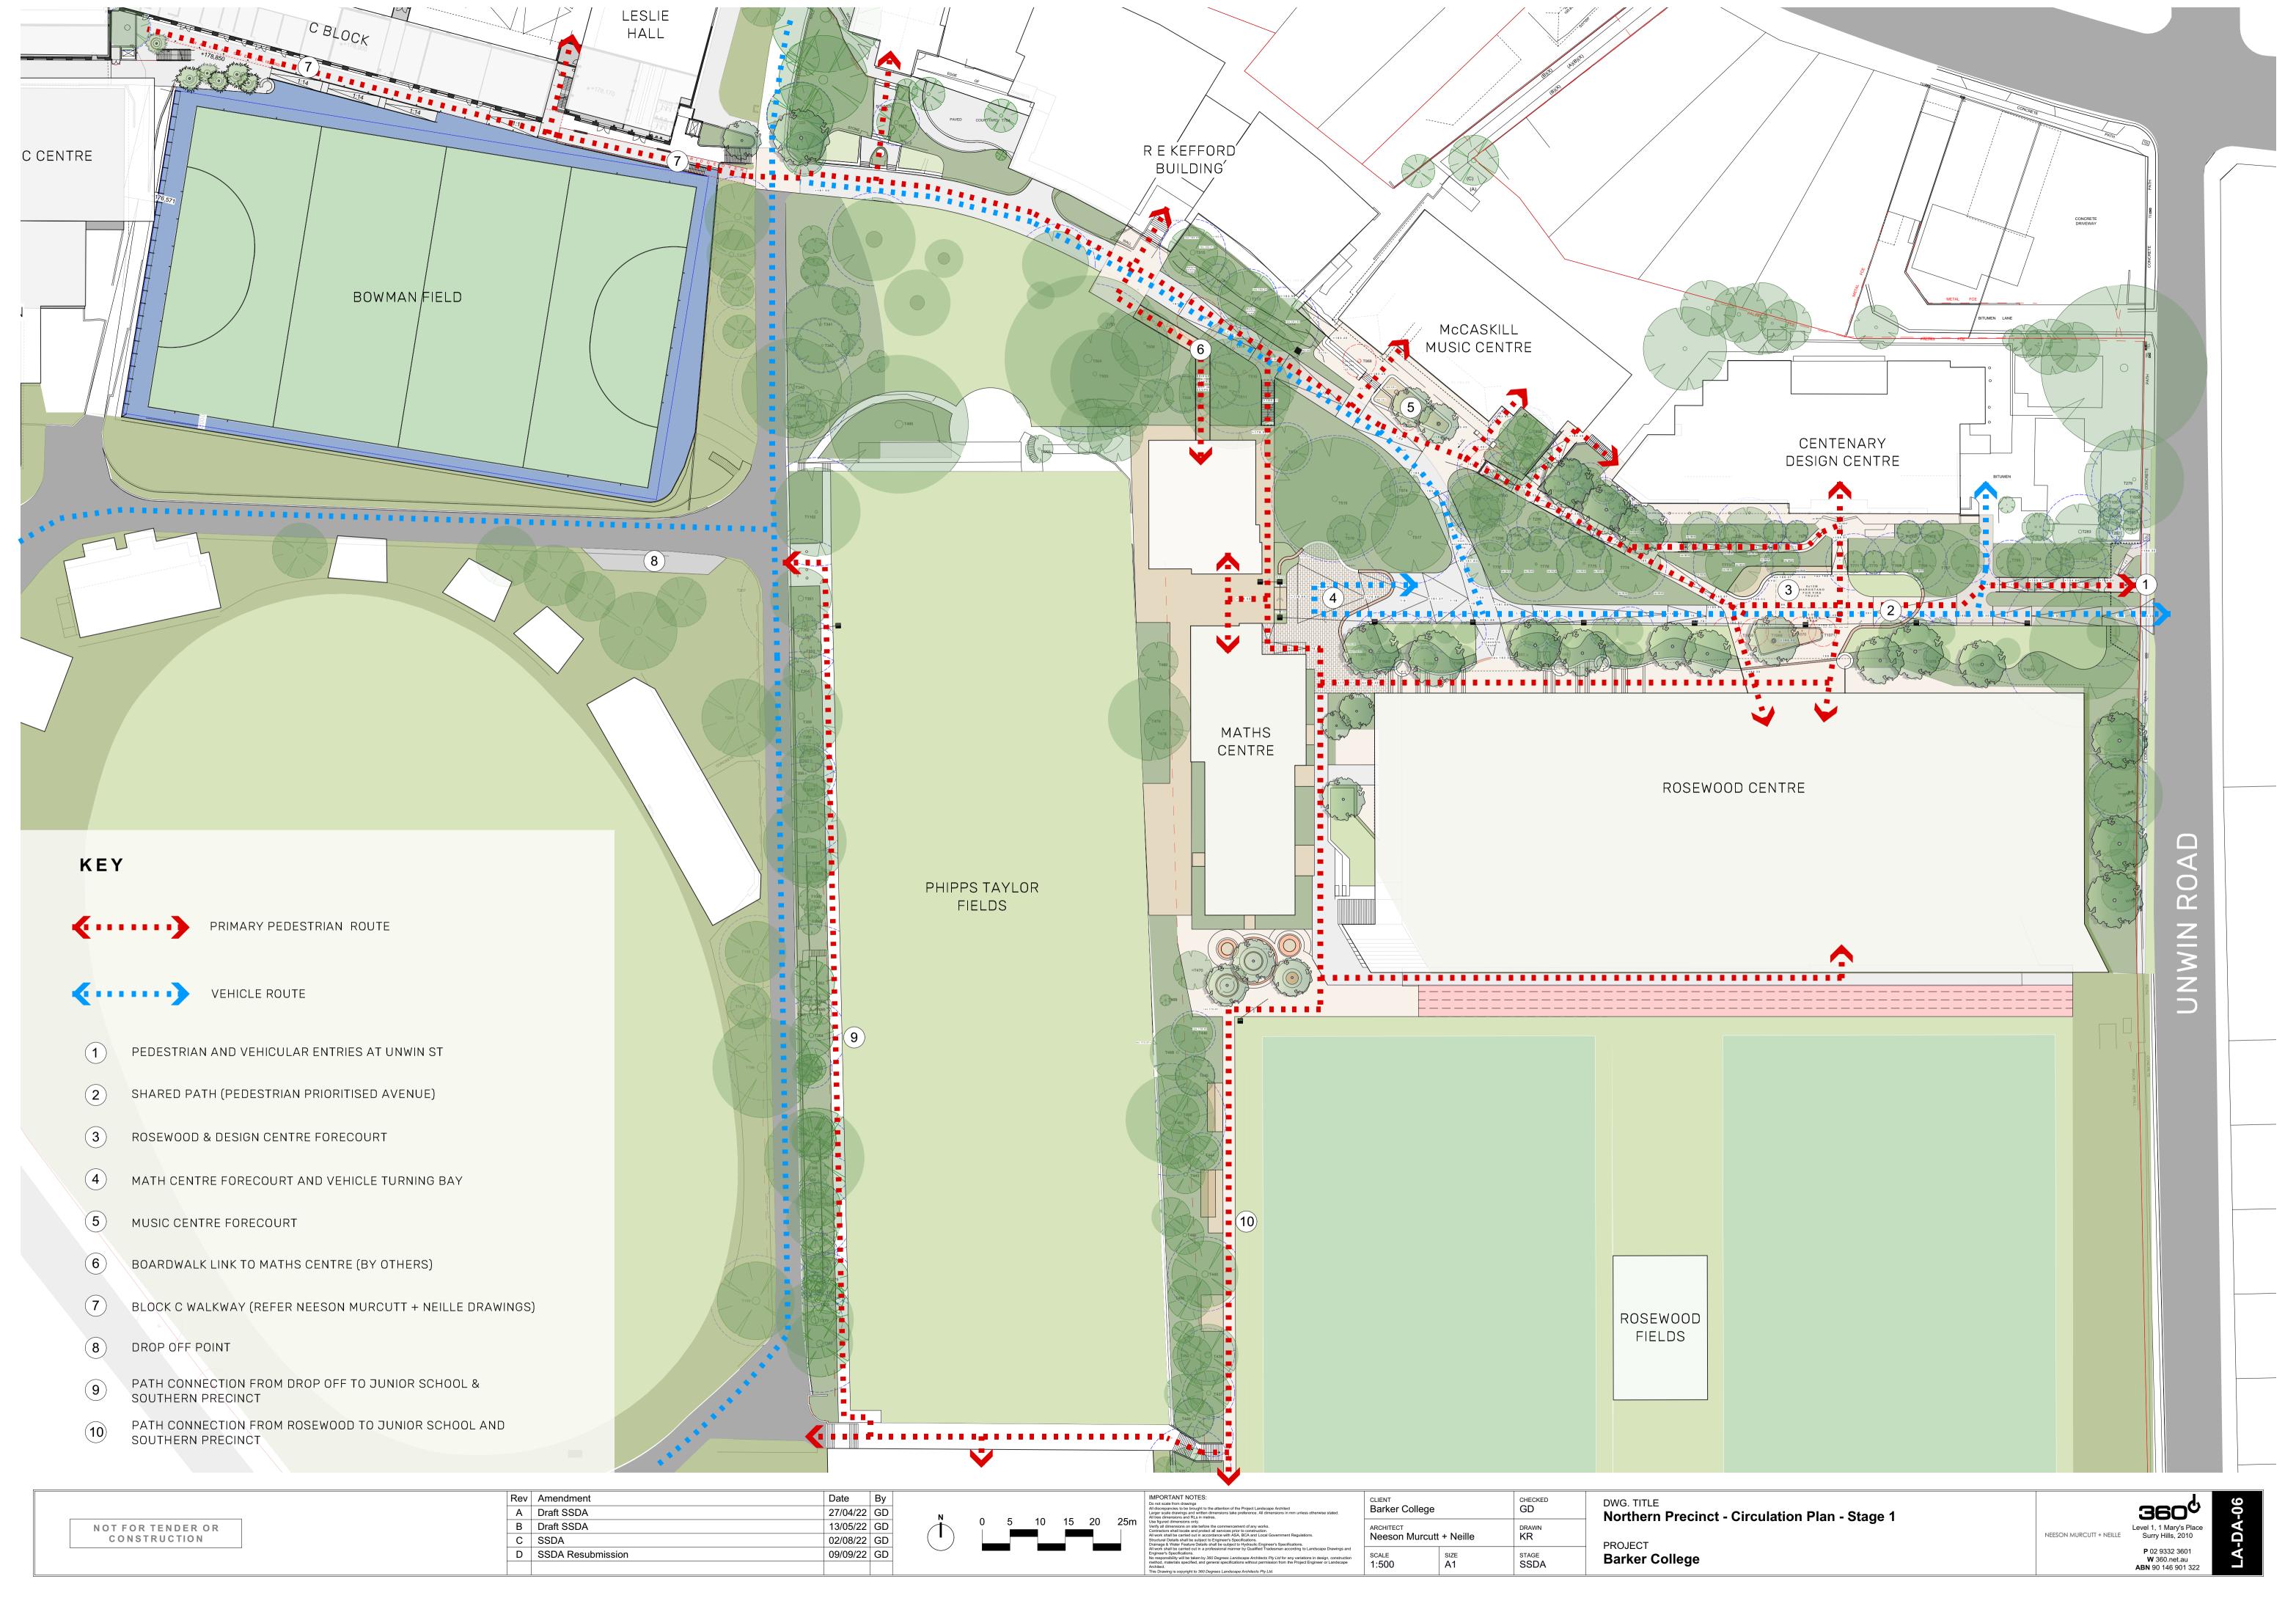



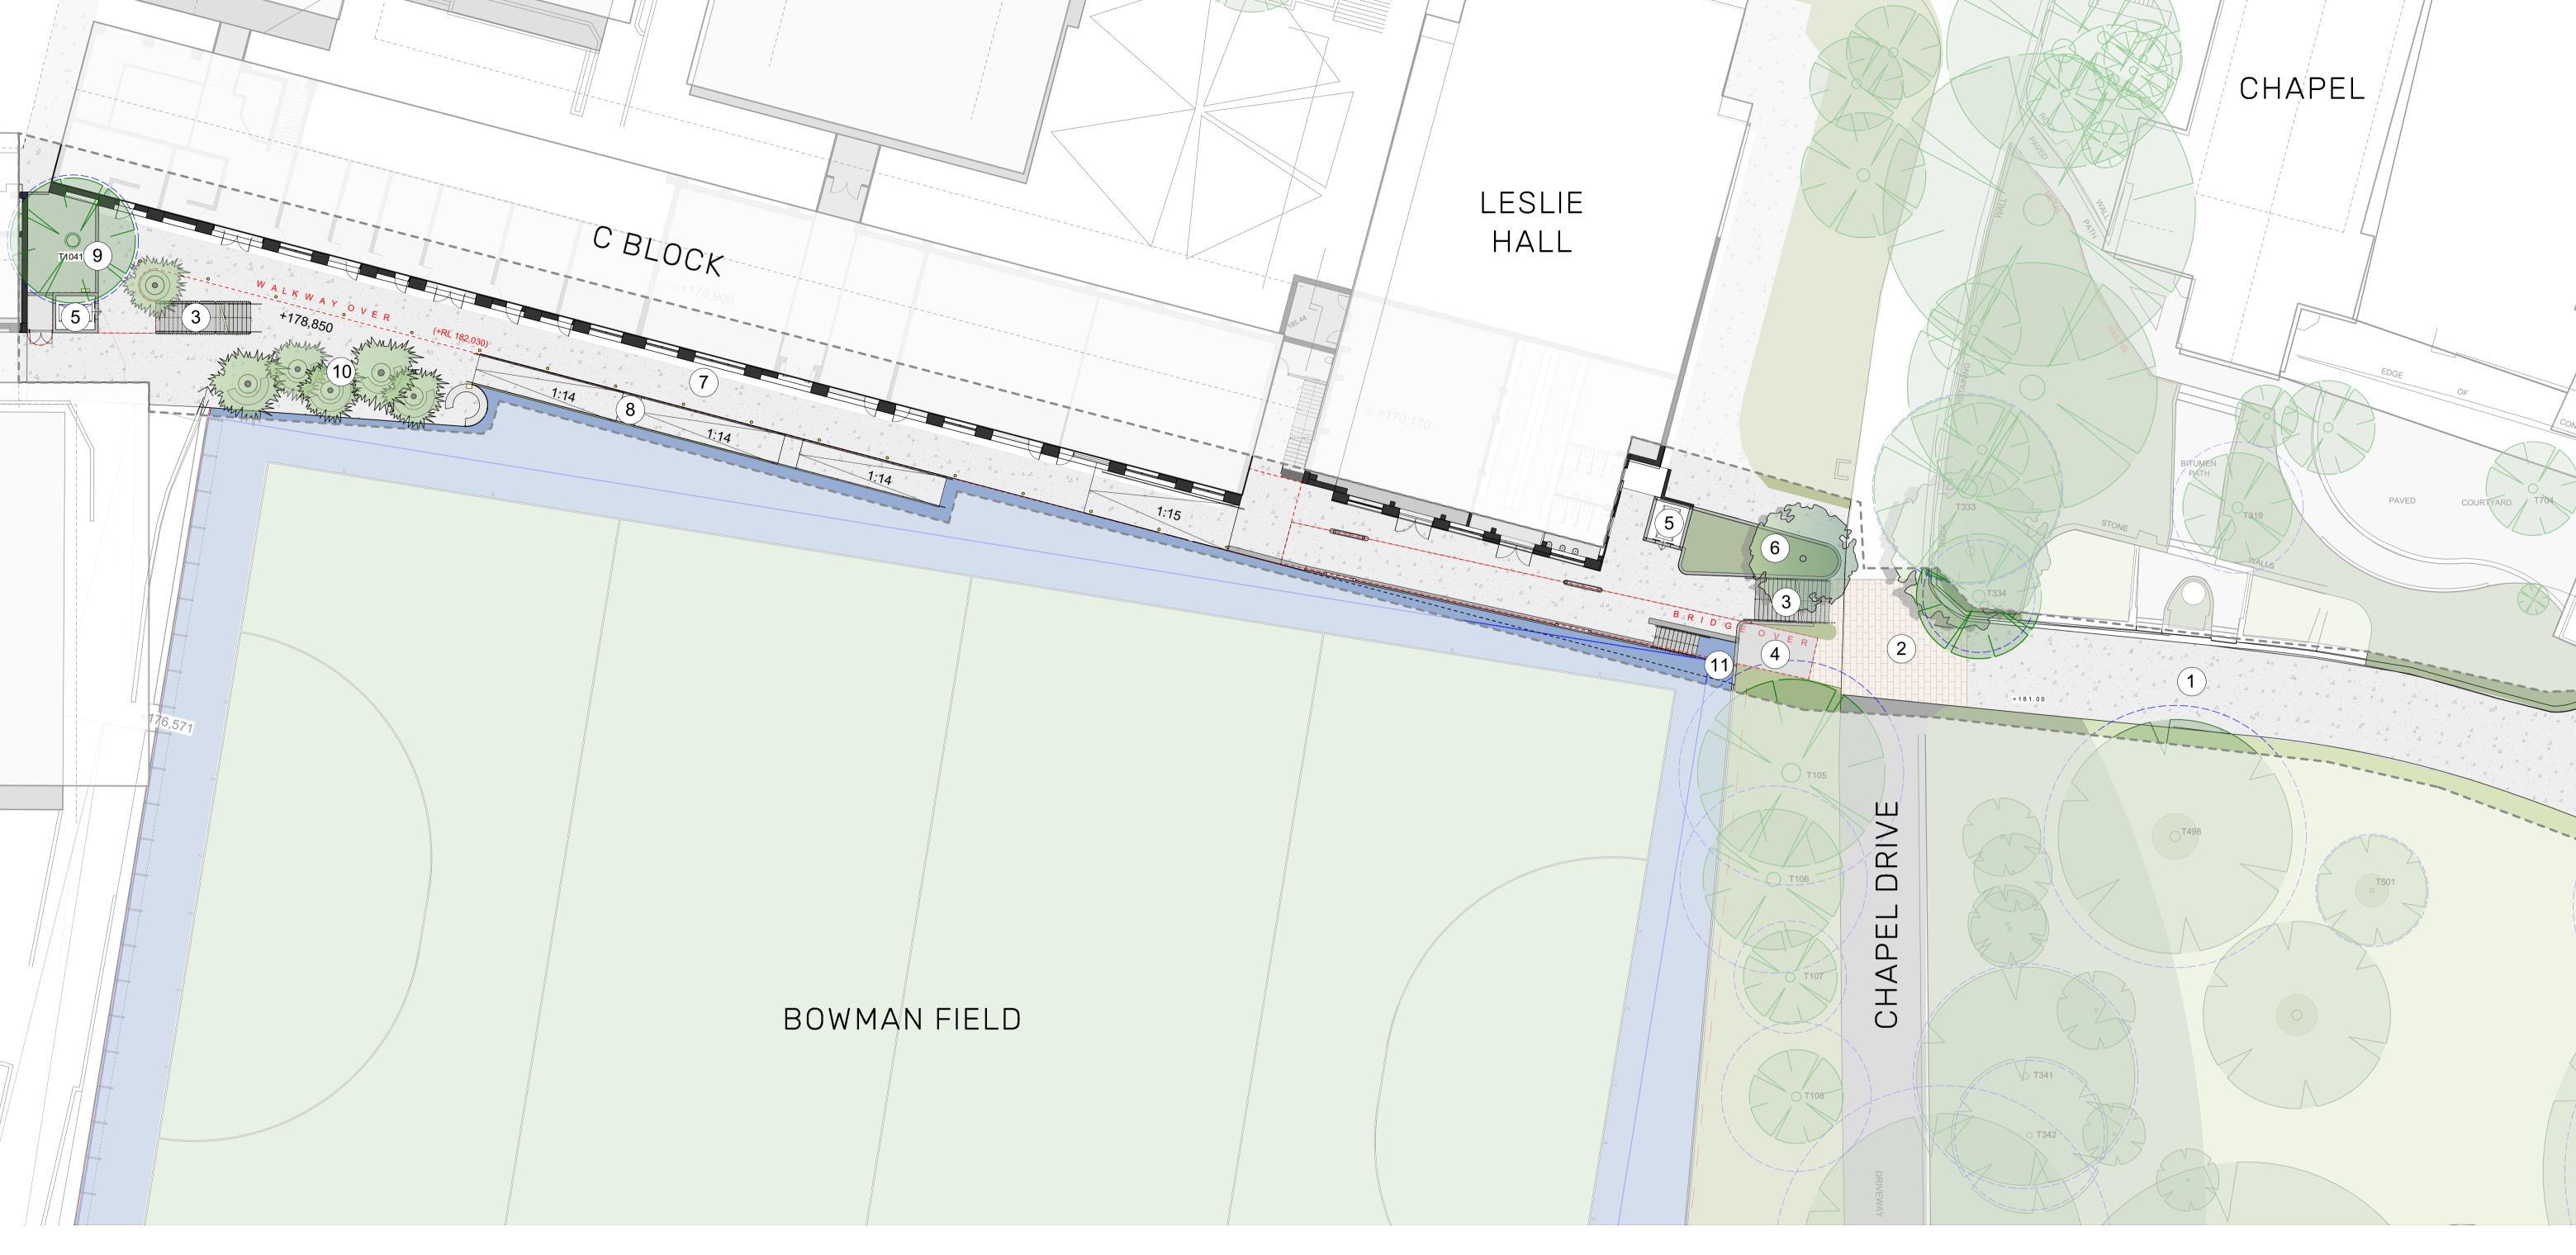






- (1) RB FINLAY WALK SHARED PATH RESURFACED WITH CONCRETE
- 2 PAVED PEDESTRIAN CONNECTION AT CHAPEL DR NODE
- 3 STAIR CONNECTION TO GROUND FLOOR & BOWMAN FIELD
- BRIDGE CONNECTION FOR ACCESSIBLE ACCESS (REFER ARCHITECT'S DRAWINGS)
- 5 LIFT CORE

NOTE: REFER NEESON MURCUTT + NEILLE DRAWINGS FOR WALKWAY, STAIRS AND LIFT

- 6 BANKED GARDEN WITH MARKER TREE (E.G. ULMUS GLABRA 'LUTESCENS)
- LEVEL 1 ACCESSWAY & SPECTATOR VIEWING ALONG C BLOCK
- RAMP CONNECTION FROM GROUND FLOOR TO BOWMAN FIELD
- 9 EXISTING TREE RETAINED & CROWN LIFTED (CHAMAECYPARIS OBTUSA)
- MARKER TREES E.G. LIVISTONA AUSTRALIS
 WITH CIRCULAR SEATING FOR SOCIALISING AND SPECTATING SPORT
- 11) EXTEND SPORTS SURFACE TO MEET NEW WALL AND STAIRS

	Rev	ev	Amendment	Date	Ву
	A	4	Draft SSDA	27/04/22	GD
NOT FOR TENDER OR	В	В	Draft SSDA	13/05/22	GD
CONSTRUCTION	С	C	SSDA	02/08/22	GD
	D	D	SSDA Resubmission	09/09/22	GD

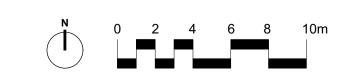

IMPORTANT NOTES: Do not scale from drawings All discrepancies to be brought to the attention of the Project Landscape Architect Larger scale drawings and written dimensions take preference. All dimensions in mm unless otherwise stated. All tree dimensions and RLs in metres.	
Use figured dimensions only. Verify all dimensions on site before the commencement of any works. Contractors shall locate and protect all services prior to construction. All work shall be carried out in accordance with ASA, BCA and Local Government Regulations. Structural Details shall be subject to Engineer's Specifications. Drainage & Water Feature Details shall be subject to Hydraulic Engineer's Specifications.	1
All work shall be carried out in a professional manner by Qualified Tradesman according to Landscape Drawings and Engineer's Specifications. No responsibility will be taken by 360 Degrees Landscape Architects Pty Ltd for any variations in design, construction method, materials specified, and general specifications without permission from the Project Engineer or Landscape Architect.	;


	CLIENT Barker College	CHECKED GD		
	ARCHITECT Neeson Murcutt + Neille		DRAWN KR	
and ction pe	SCALE 1:200	SIZE A1	STAGE SSDA	

DWG. TITLE
C Block Landscape Plan


PROJECT
Barker College

Level 1, 1 Mary's Place Surry Hills, 2010

P 02 9332 3601
W 360.net.au
ABN 90 146 901 322

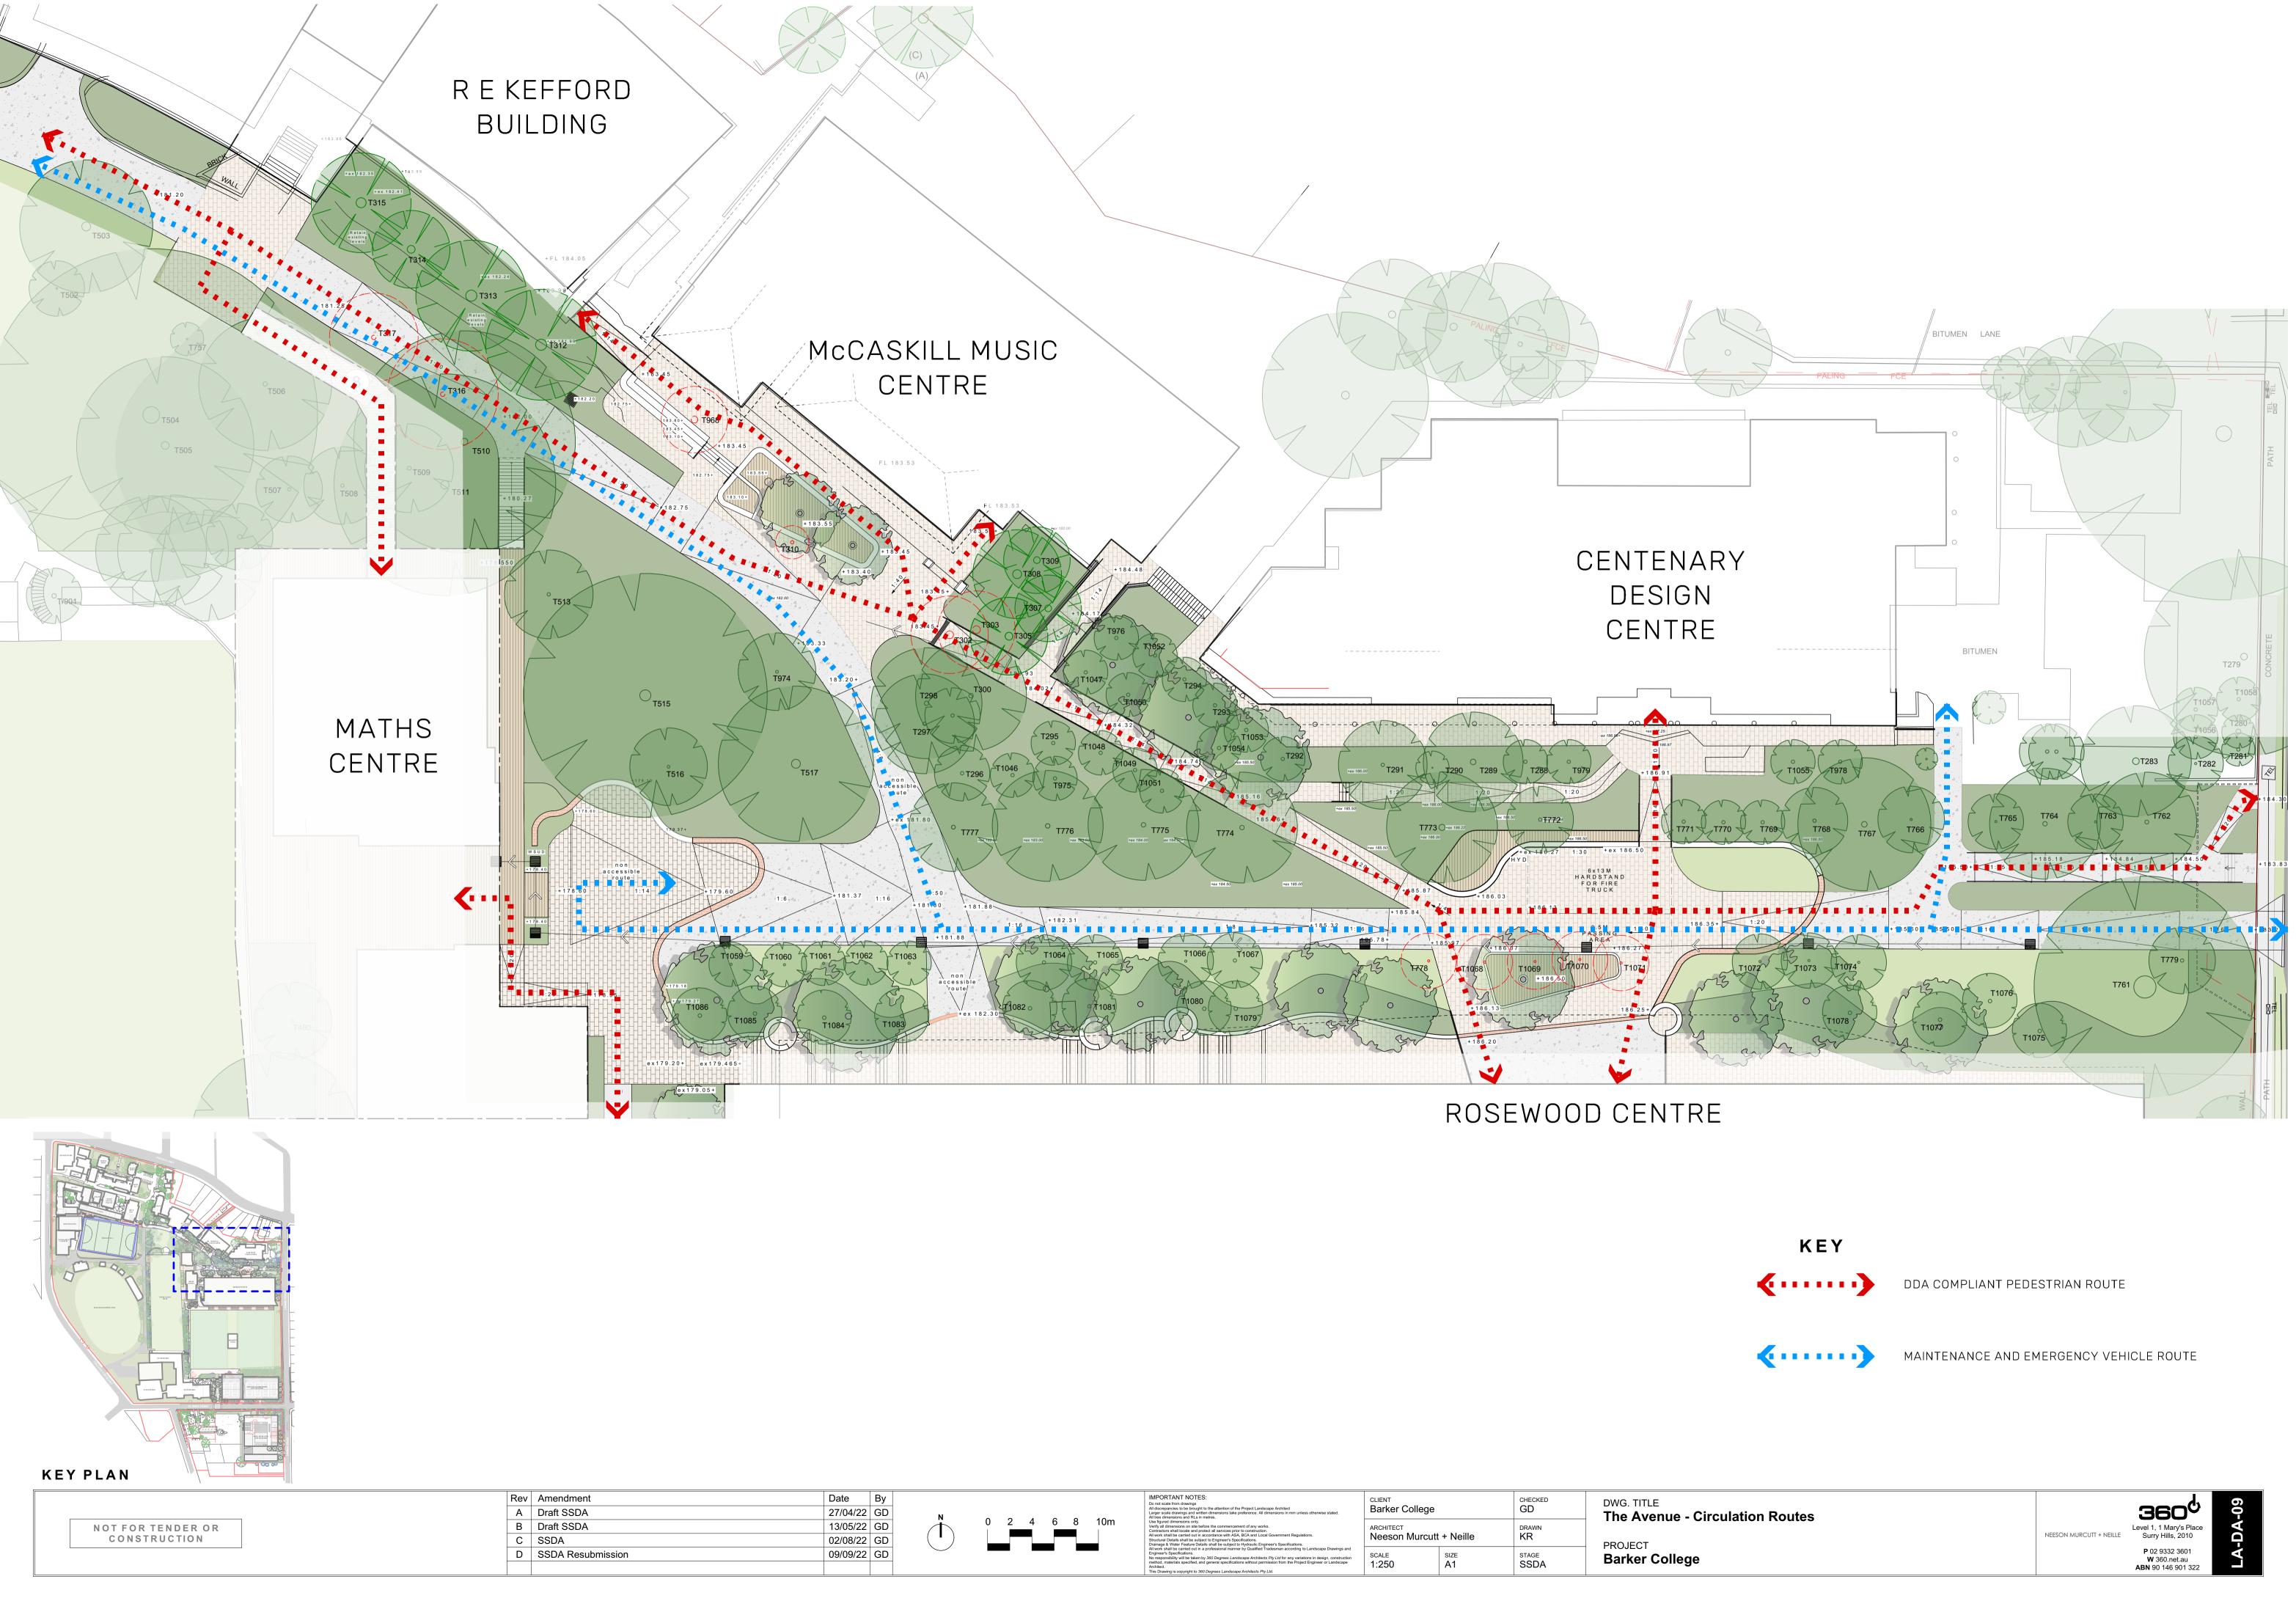



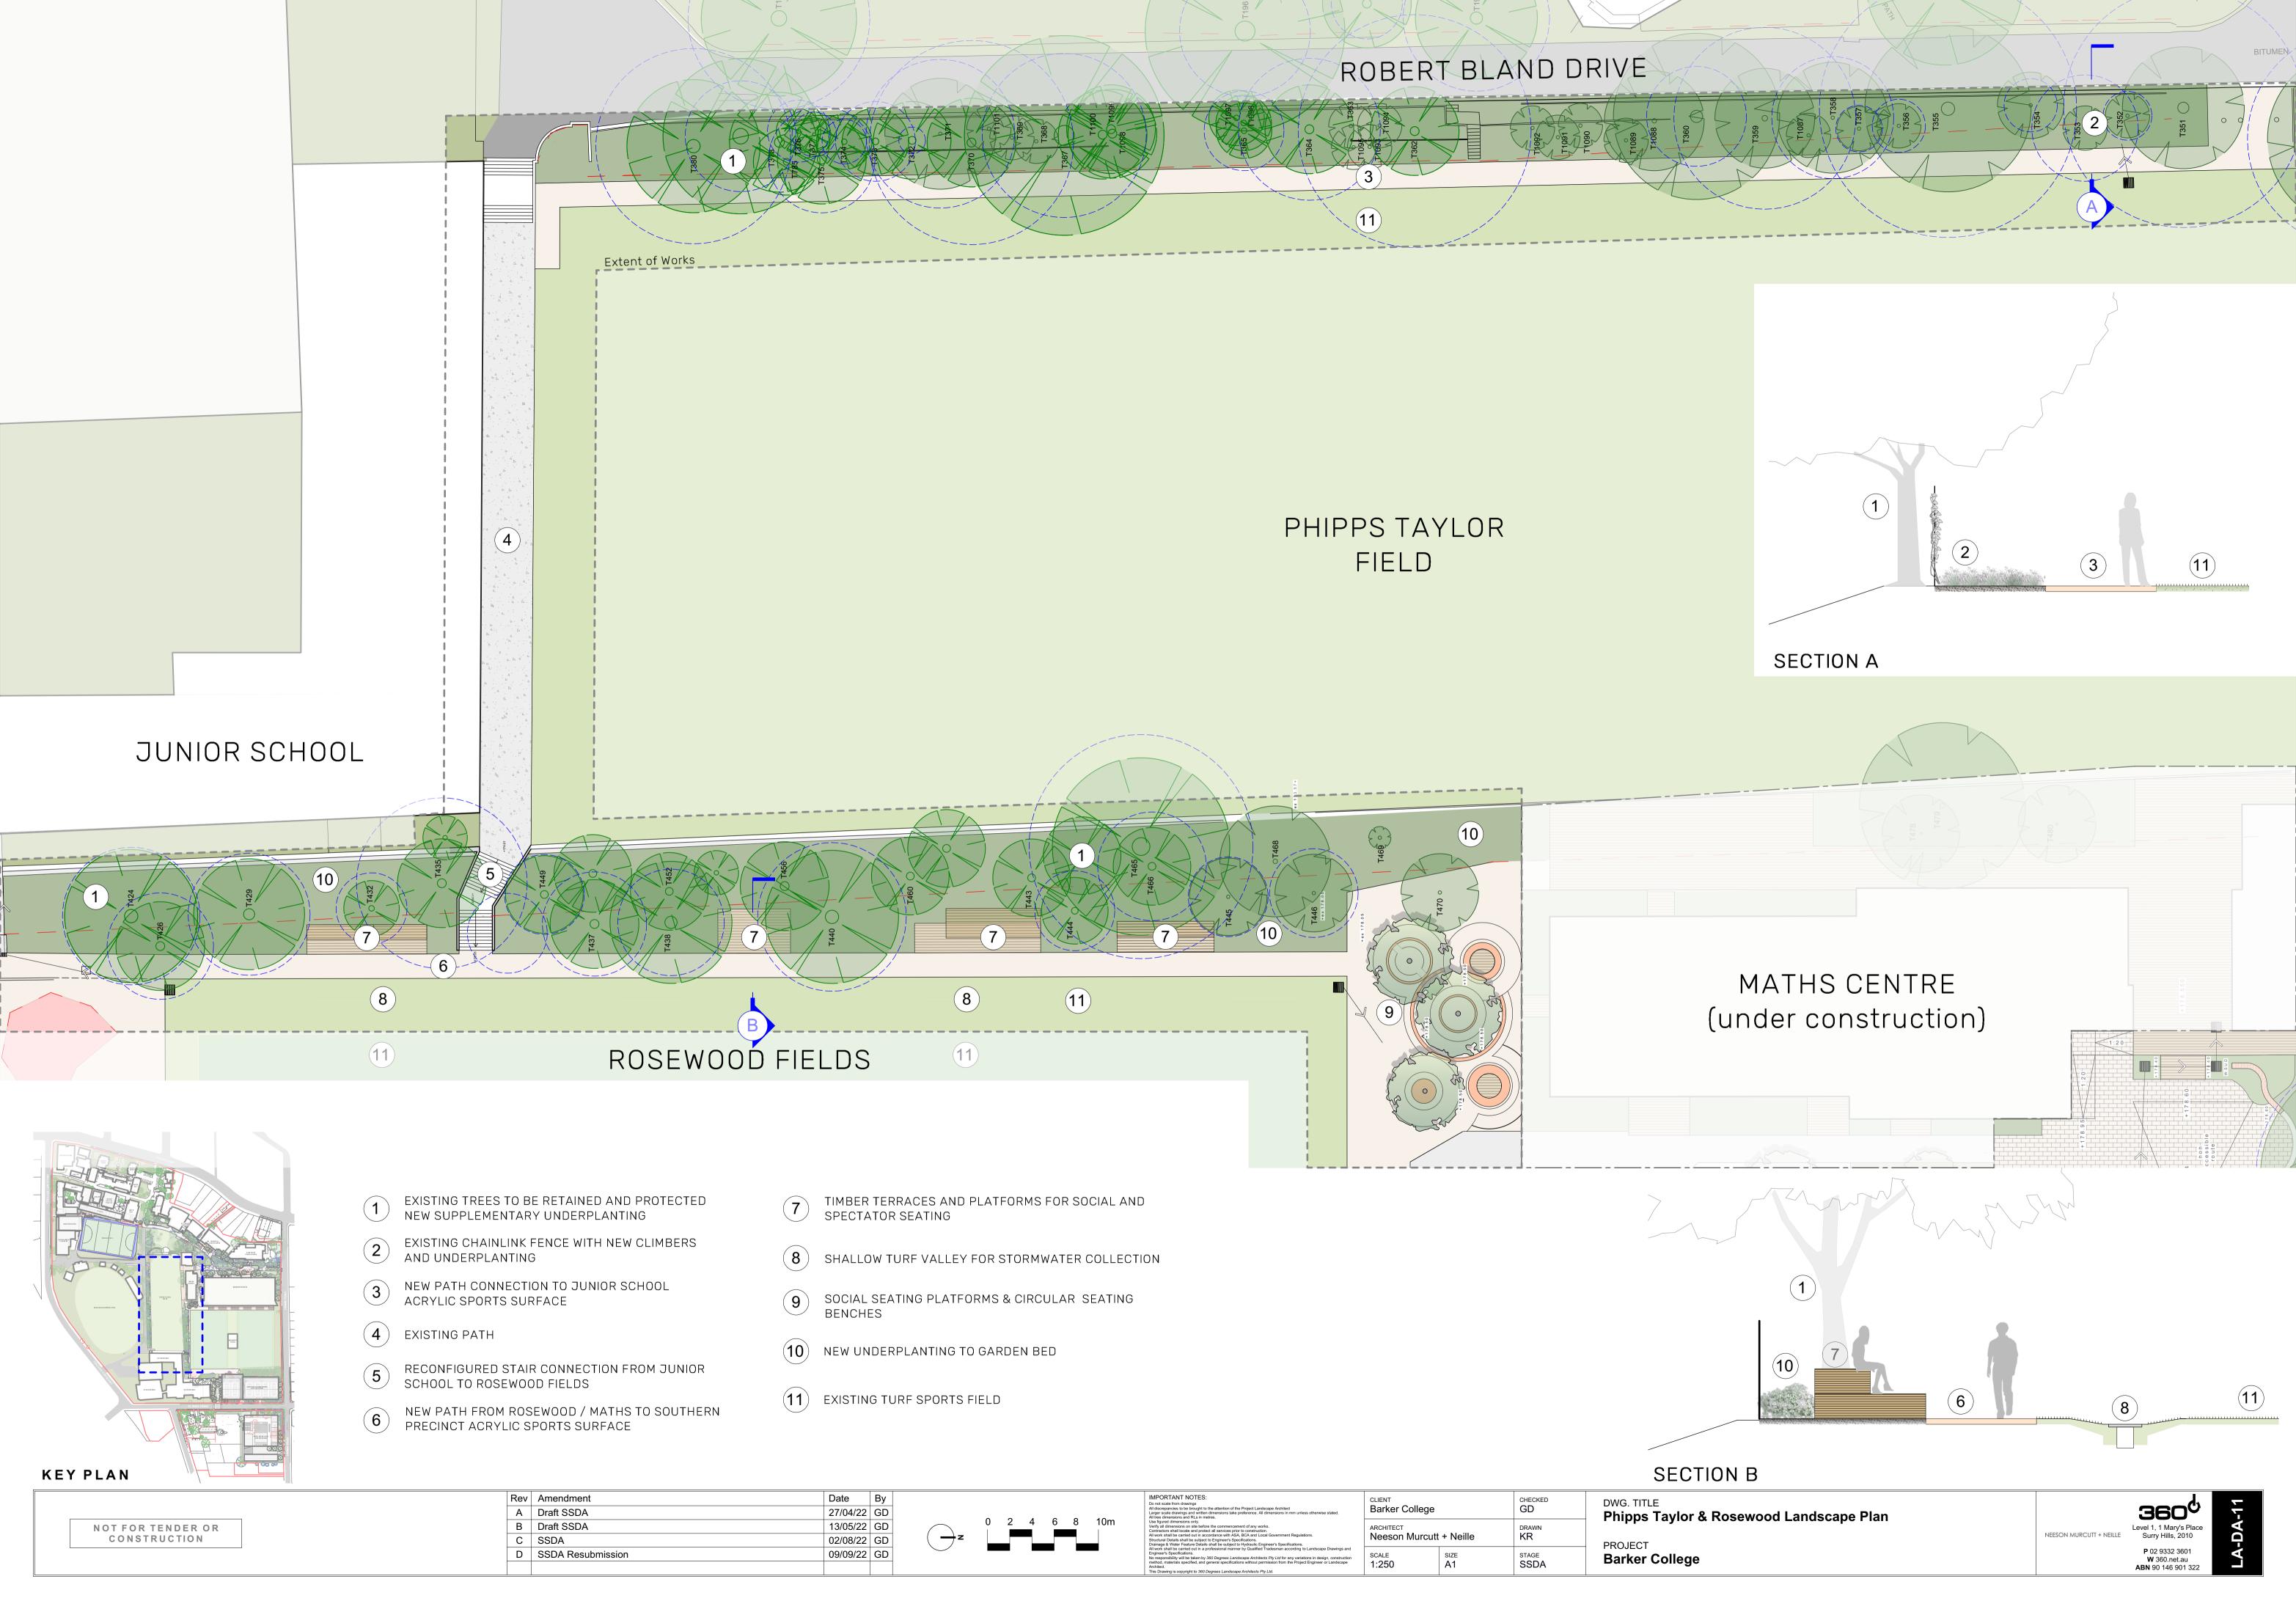

INDICATIVE PLANTING PALETTE







IMPORTANT NOTES:
Do not scale from drawings
All discrepancies to be brought to the


SDRP Comments:	Response
6. Further input from the Landscape Architect is required to illustrate the following:	
a. A whole of site landscape strategy with landscape principles in alignment with the core campus works	Refer L-DA-02, L-DA-03, L-DA-04
and future stage architectural strategy	
b. Collaboration with the Traditional Custrodians illustrating how the living history of the site can be	Refer L-DA-04 and Architectural Design Report
incorporated into the landscape design	
c. Treatment of the ground plane associated with the elevated C-Block walk	Refer L-DA-08
7. Provide details on the treatment of fencing along the eastern and western edges of the site	Refer L-DA-17
8. Demonstrate how the interface with the neighbouring streets and private allotments can be improved	Refer L-DA-18
9. Indicate measures to increase natural surveillence and minimize the use of electronic surveillence	Refer L-DA-17

Fencing & Passive Surveillance

Existing Site Conditions



Existing hedge in front of security fence to Clarke Rd creates a hard edge to the school boundary with limited passive surveillence

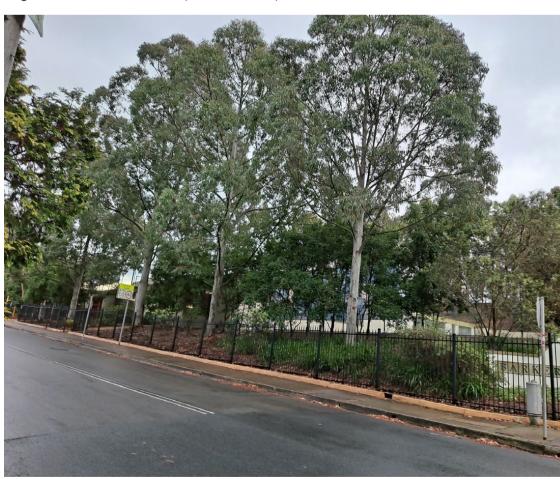


Existing native trees, grasses and sparse small shrubs to Clarke Road near Unwins Road reduces the perceived density of the built form



Existing boundary treatment on Clarke Road changes from hedges in front of the security fence to trees and underplanting behind the fence



Rosewood Centre (by NM+360). A 2.1m palisade school security fence on the Unwins Road boundary line with native Blue Gum Forest planting behind

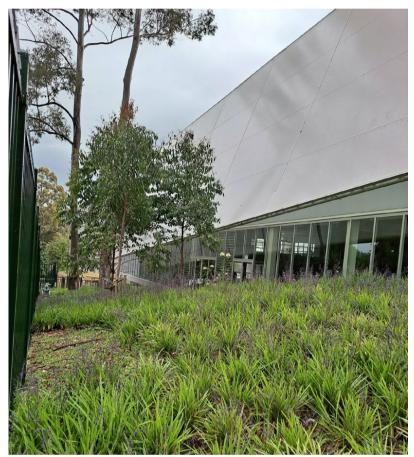

Rosewood Centre, Barker College: Existing and new native trees with mass grasses and clumps of shrubs maintains sightlines and improves passive surveillence. This planting typology softens the bulk form and provides an improved school frontage and interface with the street.



Fencing & Passive Surveillance

Landscape Strategies



- 1) Palisade school security fence to Clarke Road (typically 2.1m high)
- Existing Trees underplanted with low grasses and shrubs planted where required for screening but allowing sightlines and natural surveillance


Rev	Amendment	Date	В
Α	SSDA	02/08/22	G
В	SSDA Resubmission	09/09/22	G

IMPORTANT NOTES: Do not scale from drawings All discrepancies to be brought to the attention of the Project Landscape Architect Larger scale drawings and written dimensions take preference. All dimensions in mm unless otherwise stated. All tree dimensions and RLs in metres.	E
Use figured dimensions only. Verify all dimensions on site before the commencement of any works. Contractors shall locate and protect all services prior to construction. All work shall be carried out in accordance with ASA, BCA and Local Government Regulations. Structural Details shall be subject to Engineer's Specifications. Drainage & Water Feature Details shall be subject to thirdraulic Engineer's Specifications.	A 1
All work shall be carried out in a professional manner by Qualified Tradesman according to Landscape Drawings and Engineer's Specifications. No responsibility will be taken by 360 Degrees Landscape Architects Pty Ltd for any variations in design, construction method, materials specified, and general specifications without permission from the Project Engineer or Landscape Architect.	s 1

CLIENT Barker College			CHECKED GD	
	ARCHITECT Neeson Murcutt + Neille		DRAWN KR	
	SCALE N/A	SIZE A1	STAGE SSDA	

Site Interface - Recital Hall

Landscape Strategies

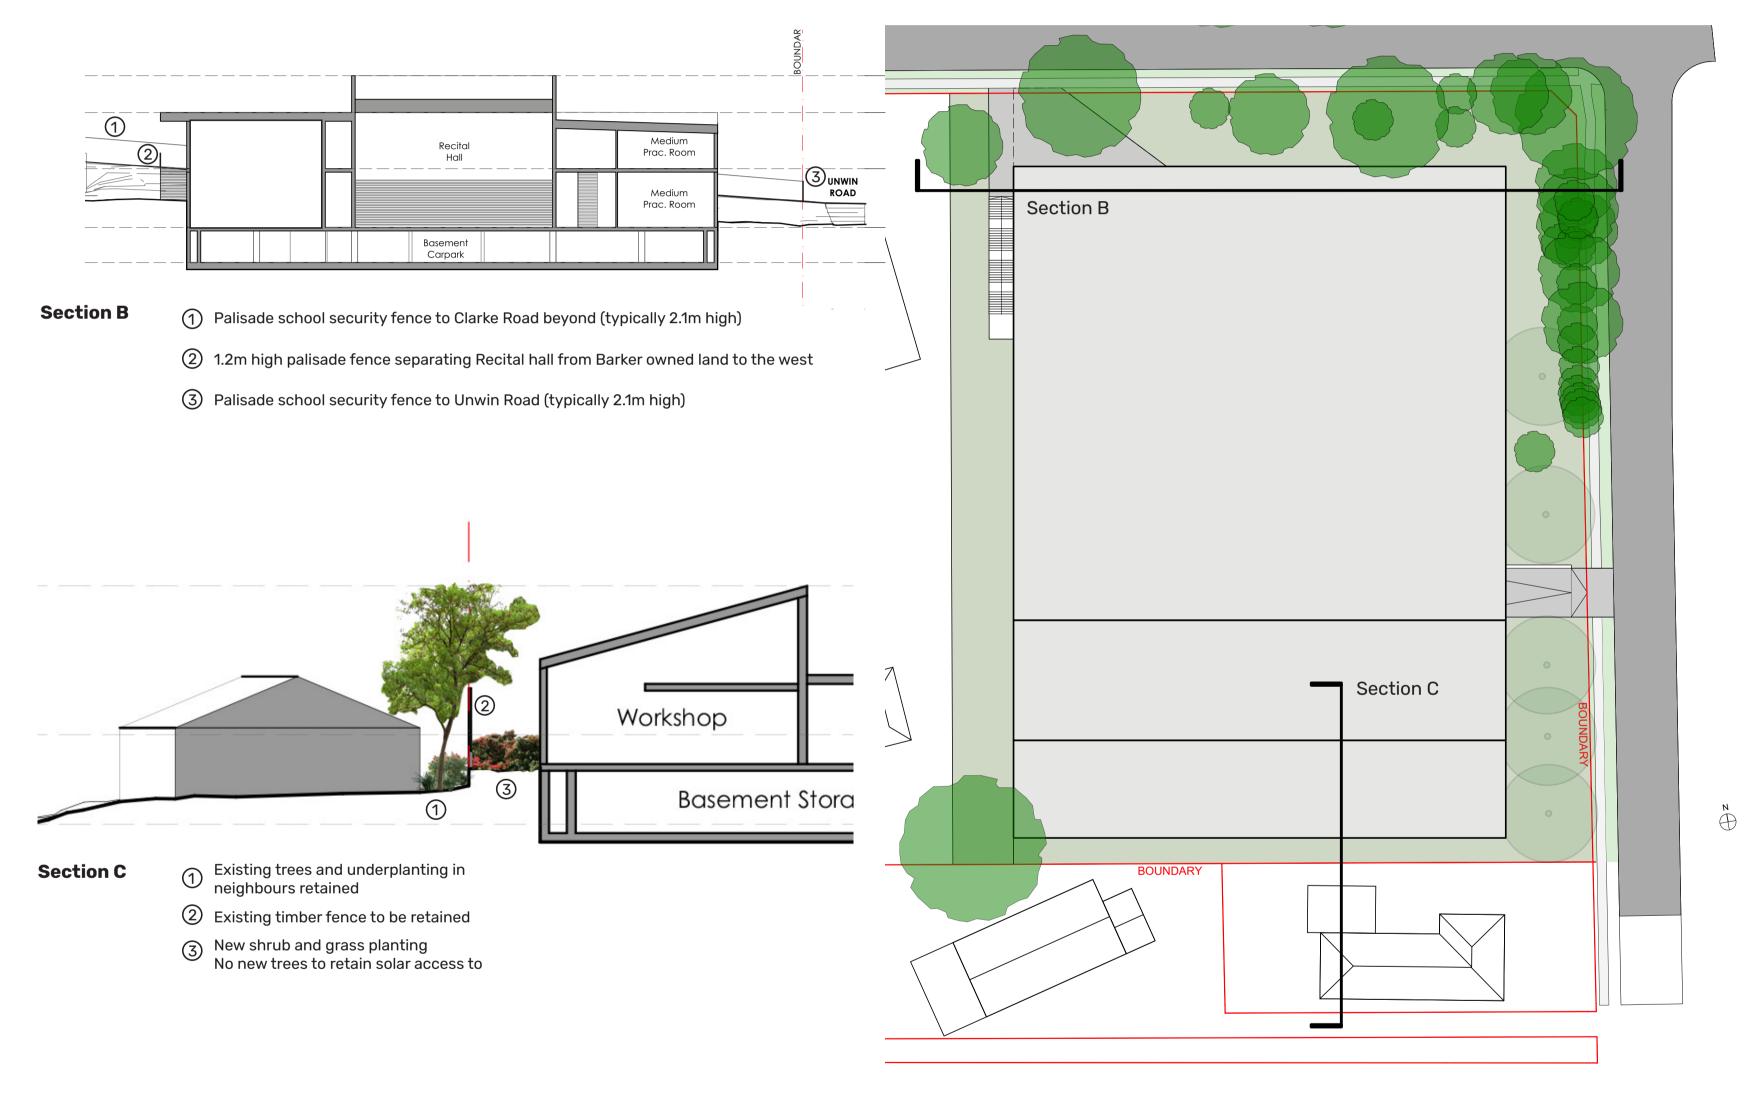

Rev	Amendment	Date	Ву
Α	SSDA	02/08/22	GD
В	SSDA Resubmission	09/09/22	GD

IMPORTANT NOTES:
Do not scale from drawings
All discrepancies to be brought to the attention of the Project Landscape Architect
Larger scale drawings and written dimensions take preference. All dimensions in mm unless otherwise stated.
All tree dimensions and RLs in metres.
Use figured dimensions only.
Verify all dimensions on site before the commencement of any works.
Contractors shall locate and protect all services prior to construction.
All work shall be carried out in accordance with ASA, BCA and Local Government Regulations.
Structural Details shall be subject to Engineer's Specifications.
Drainage & Water Feature Details shall be subject to Hydraulic Engineer's Specifications.
All work shall be carried out in a professional manner by Qualified Tradesman according to Landscape Drawings and
Engineer's Specifications.
No responsibility will be taken by 360 Degrees Landscape Architects Pty Ltd for any variations in design, construction method, materials specified, and general specifications without permission from the Project Engineer or Landscape
Architect

CLIENT Barker College	CHECKED GD	-		
ARCHITECT Neeson Murcutt	+ Neille	DRAWN KR		
SCALE N/A	SIZE A1	STAGE SSDA		