
805 MAMRE ROAD, KEMPS CREEK CIVIL WORKS PACKAGE

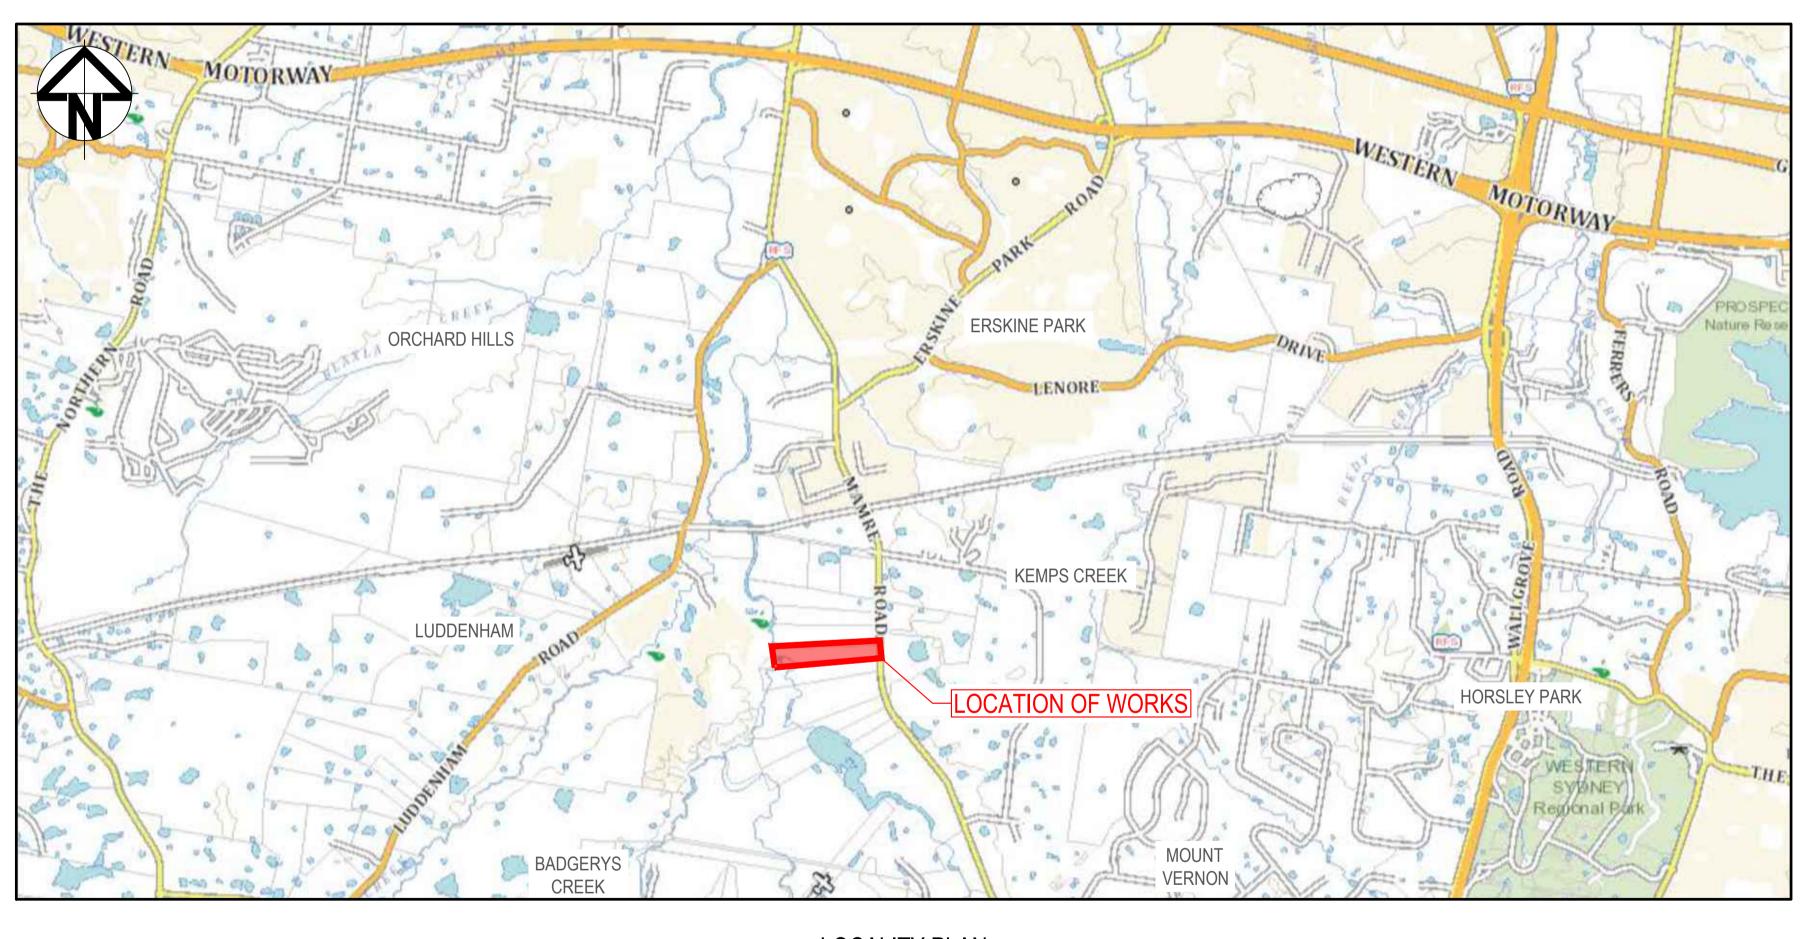

LOCALITY PLAN NOT TO SCALE

D C B Issue	RE-ISSUED FOR DA 04-11-22 RE-ISSUED FOR DA 09-08-22 RE-ISSUED FOR DA 08-08-22 Description Date		THAT ORIGINALLY INTENDED WITHOUT THE WRITTEN PERMISSION OF AT&L		GD	A2020
E	RE-ISSUED FOR DA 10-11-22	4	OTHER PURPOSE OTHER THAN	GibbGroup.	Height Datum AHD	
F	RE-ISSUED FOR DA 22-12-23		ANY FORM OR USED FOR ANY	CibbCroup	Height ALID	Approved
G	RE-ISSUED FOR DA 02-02-23		COPIED OR REPRODUCED IN		Grid GDA 2020	Checked MG
Н	RE-ISSUED FOR DA 02-03-2:		THIS DRAWING CANNOT BE			QD & T
1	RE-ISSUED FOR DA 21-04-23					Designed
J	RE-ISSUED FOR DA 30-08-23	Bar Scales		Client	Scales	Drawn NT

	Scales		Drawn	NT	Proje
			Designed	QD & TS	
	Grid	GDA 2020	Checked	MG	
	Height Datum	AHD	Approved		T:41 -
•			-		Title

805 MAMRE ROAD KEMPS CREEK


COVER SHEET


Level 7, 153 Walker Street North Sydney NSW 2060 P 02 9439 1777 E info@atl.net.au


Civil Engineers and Project Managers


www.atl.net.au ABN 96 130 882 405 FOR APPROVAL NOT FOR CONSTRUCTION Project - Drawing No. 21-894-C1000

DRAWING No.	DRAWING TITLE
GENERAL	
21-894-C1000	COVER SHEET
21-894-C1001	DRAWING LIST AND LEGENDS
21-894-C1002	GENERAL NOTES
21-894-C1003	GENERAL ARRANGEMENT PLAN
21-894-C1004	TYPICAL ROAD CROSS SECTIONS SHEET 1
21-894-C1005	TYPICAL ROAD CROSS SECTIONS SHEET 2
21-894-C1006	TYPICAL VERGE SECTIONS
21-894-C1007	TYPICAL SITE SECTIONS SHEET 1
21-894-C1008	TYPICAL SITE SECTIONS SHEET 2
21-894-C1009	TYPICAL SITE SECTIONS SHEET 3
21-894-C1010	TYPICAL SITE SECTIONS SHEET 4
BULK EARTHWORKS	
21-894-C1030	BULK EARTHWORKS PLAN
21-894-C1031	BULK EARTHWORKS SECTIONS
ROADWORKS AND DRAINAGE	
21-894-C1041	ROADWORKS AND DRAINAGE PLAN
21-894-C1042	CONTEXTUAL ROAD LAYOUT PLAN
ROAD LONGITUDINAL SECTIONS	
21-894-C1051	ROAD LONGITUDINAL SECTIONS
STORMWATER DRAINAGE	NOAD EGNOTIONINAL GEOTIONS
21-894-C1061	STORMWATER DRAINAGE CATCHMENT PLAN (PRE-DEVELOPED)
21-894-C1062	STORMWATER DRAINAGE CATCHMENT PLAN (POST-DEVELOPED)
RETAINING WALLS	STORWINATER BRAINAGE CATOLINENT FEAR (FOST-BEVELOFED)
	DETAINING WALLS DLAN
21-894-C1081	RETAINING WALLS PLAN
21-894-C1082	RETAINING WALLS PROFILES
VEHICLE TURN PATHS	TURN BATUS BLAN SUEET 4
21-894-C1090	TURN PATHS PLAN SHEET 1
21-894-C1091	TURN PATHS PLAN SHEET 2
21-894-C1092	TURN PATHS PLAN SHEET 3
21-894-C1093	TURN PATHS PLAN SHEET 4
SERVICES AND UTILITIES	
21-894-C1101	SERVICES AND UTILITIES COORDINATION PLAN SHEET 1
21-894-C1102	SERVICES AND UTILITIES COORDINATION PLAN SHEET 2
21-894-C1103	SERVICES AND UTILITIES COORDINATION PLAN SHEET 3
21-894-C1104	SERVICES AND UTILITIES COORDINATION PLAN SHEET 4
ROSION AND SEDIMENT CONTROL	
21-894-C1200	SEDIMENT AND EROSION CONTROL PLAN
21-894-C1210	SEDIMENT AND EROSION CONTROL DETAILS
ONLOT WORKS	
21-894-C1321	WAREHOUSE 1 SITEWORKS AND STORMWATER DRAINAGE PLAN SHEET 1
21-894-C1322	WAREHOUSE 1 SITEWORKS AND STORMWATER DRAINAGE PLAN SHEET 2
21-894-C1323	WAREHOUSE 1 SITEWORKS AND STORMWATER DRAINAGE PLAN SHEET 3
21-894-C1324	WAREHOUSE 1 SITEWORKS AND STORMWATER DRAINAGE PLAN SHEET 4
21-894-C1341	WAREHOUSE 2 SITEWORKS AND STORMWATER DRAINAGE PLAN SHEET 1
21-894-C1342	WAREHOUSE 2 SITEWORKS AND STORMWATER DRAINAGE PLAN SHEET 2
21-894-C1343	WAREHOUSE 2 SITEWORKS AND STORMWATER DRAINAGE PLAN SHEET 3
21-894-C1344	WAREHOUSE 2 SITEWORKS AND STORMWATER DRAINAGE PLAN SHEET 4
	The state of the s
	WAREHOUSE 2 SITEWORKS AND STORMWATER DRAINAGE PLAN SHEET 5
21-894-C1345 EXTERNAL WORKS	WAREHOUSE 2 SITEWORKS AND STORMWATER DRAINAGE PLAN SHEET 5

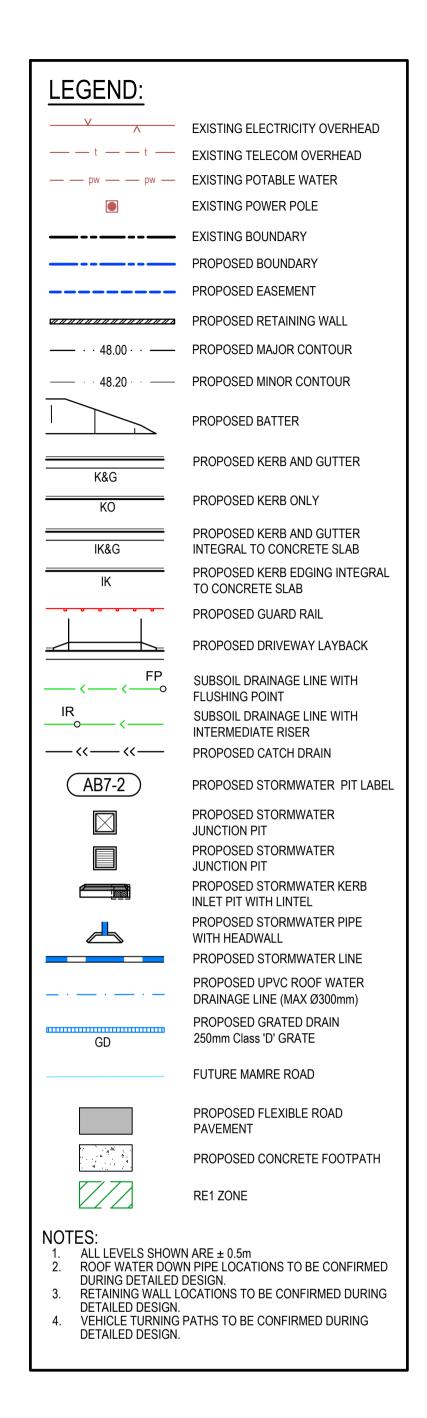

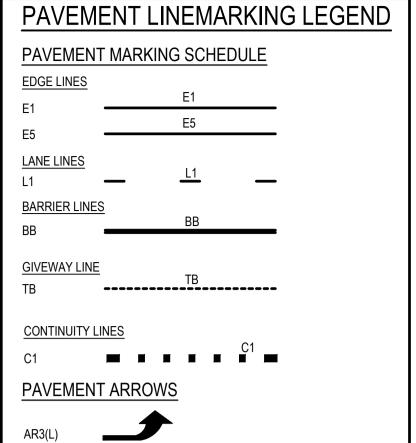

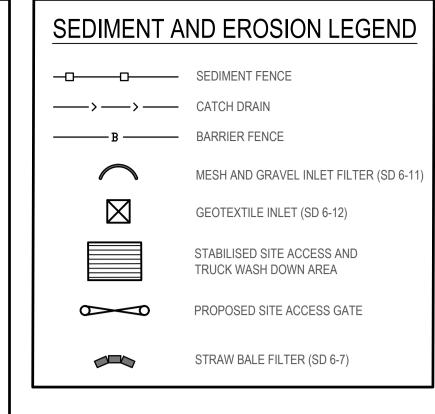

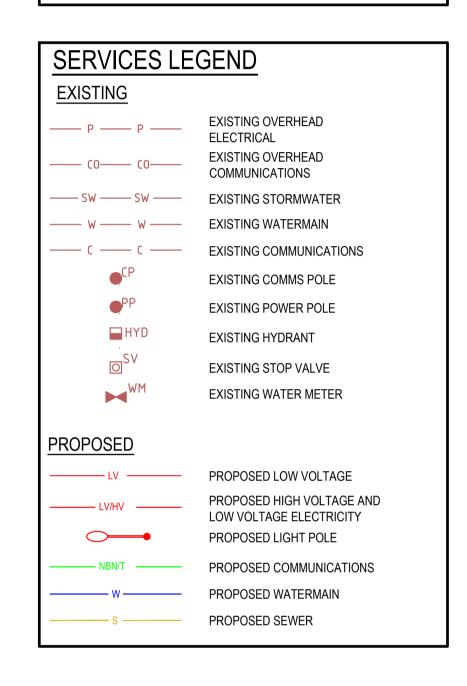

J	RE-ISSUED FOR DA	30-08-23	Bar Scales
1	RE-ISSUED FOR DA	21-04-23	
Н	RE-ISSUED FOR DA	02-03-23	
G	RE-ISSUED FOR DA	02-02-23	
F	RE-ISSUED FOR DA	22-12-22	
Е	RE-ISSUED FOR DA	10-11-22	
D	RE-ISSUED FOR DA	04-11-22	
С	RE-ISSUED FOR DA	09-08-22	
В	RE-ISSUED FOR DA	08-08-22	
Issue	Description	Date	

THIS DRAWING CANNOT BE
COPIED OR REPRODUCED IN
ANY FORM OR USED FOR ANY
OTHER PURPOSE OTHER THAN
THAT ORIGINALLY INTENDED
WITHOUT THE WRITTEN
PERMISSION OF AT&L



Client

Scales		Drawn	NT	Proje
		Designed	QD & TS	
Grid	GDA 2020	Checked	MG	
Height Datum	AHD	Approved		Title
	Grid Height	Grid GDA 2020 Height AHD	Designed Grid GDA 2020 Checked Approved	Designed QD & TS Grid GDA 2020 Checked MG Height AHD Approved

805 MAMRE ROAD KEMPS CREEK

DRAWING LIST

AND LEGENDS

Civil Engineers and Project	Managers
at&I	Level 7, 153 Walker Street North Sydney NSW 2060 P 02 9439 1777 E info@atl.net.au www.atl.net.au ABN 96 130 882 405

FOR APPROVAL A1
NOT FOR CONSTRUCTION

Project - Drawing No. Issue
21-894-C1001

J

SITEWORKS NOTES

- ORIGIN OF LEVELS:- REFER SURVEY NOTES
- CONTRACTOR MUST VERIFY ALL DIMENSIONS AND EXISTING LEVELS ON SITE PRIOR TO COMMENCEMENT OF WORK. ANY DISCREPANCIES TO BE REPORTED TO AT & L.
- MAKE SMOOTH CONNECTION WITH EXISTING WORKS.
- ALL TRENCH BACKFILL MATERIAL SHALL BE COMPACTED TO THE SAME DENSITY AS THE ADJACENT MATERIAL.
- ALL SERVICE TRENCHES UNDER VEHICULAR PAVEMENTS SHALL BE BACKFILLED WITH SAND TO 300mm ABOVE PIPE. WHERE PIPE IS UNDER PAVEMENTS BACKFILL REMAINDER OF TRENCH TO UNDERSIDE OF PAVEMENT WITH SAND OR APPROVED GRANULAR MATERIAL COMPACTED IN 150mm LAYERS TO MINIMUM 98% MODIFIED MAXIMUM DRY DENSITY IN ACCORDANCE WITH AS 1289 5.2.1(2017). (OR A DENSITY INDEX OF NOT LESS THAN 75)
- PROVIDE 10mm WIDE EXPANSION JOINTS BETWEEN BUILDINGS AND ALL CONCRETE OR UNIT PAVEMENTS.
- ASPHALTIC CONCRETE SHALL CONFORM TO RMS. SPECIFICATION R116.
- ALL BASECOURSE MATERIAL SHALL BE IGNEOUS ROCK QUARRIED MATERIAL TO COMPLY WITH RMS. FORM 3051 (UNBOUND), RMS. FORM ACCORDANCE WITH AS 1289 5.2.1(2017) FREQUENCY OF COMPACTION TESTING SHALL NOT BE LESS THAN 1 TEST PER 50m OF BASECOURSE MATERIAL PLACED.
- ALL SUB-BASE COURSE MATERIAL SHALL BE IGNEOUS ROCK QUARRIED MATERIAL TO COMPLY WITH RMS. FORM 3051, 3051.1 AND COMPACTED FREQUENCY OF COMPACTION TESTING SHALL NOT BE LESS THAN 1 TEST PER 50m OF SUB3BASE COURSE MATERIAL PLACED.
-). AS AN ALTERNATIVE TO THE USE OF IGNEOUS ROCK AS A SUB-BASE MATERIAL IN (9) A CERTIFIED RECYCLED CONCRETE MATERIAL COMPLYING WITH RMS. FORM 3051 AND 3051.1 WILL BE CONSIDERED. SUBJECT TO MATERIAL SAMPLES AND APPROPRIATE CERTIFICATIONS BEING PROVIDED TO THE SATISFACTION OF AT & L.
- SHOULD THE CONTRACTOR WISH TO USE A RECYCLED PRODUCT THIS SHALL BE CLEARLY INDICATED IN THEIR TENDER AND THE PRICE DIFFERENCE BETWEEN AN IGNEOUS PRODUCT AND A RECYCLED PRODUCT SHALL BE CLEARLY INDICATED.
- . WHERE NOTED ON THE DRAWINGS THAT WORKS ARE TO BE CARRIED BY OTHERS, (eg. ADJUSTMENT OF SERVICES), THE CONTRACTOR SHALL BE RESPONSIBLE FOR THE CO-ORDINATION OF THESE WORKS. 3052 (BOUND) COMPACTED TO MINIMUM 98% MODIFIED DENSITY IN TO MINIMUM 95% MODIFIED DENSITY IN ACCORDANCE WITH A.S 1289 5.2.1(2017)

SURVEY NOTES

THE EXISTING SITE CONDITIONS SHOWN ON THE FOLLOWING DRAWINGS 51426 001DT 06-08-21 HAVE BEEN INVESTIGATED BY LTS SURVEYORS, BEING REGISTERED SURVEYORS. THE INFORMATION IS SHOWN TO PROVIDE A BASIS FOR DESIGN. AT & L DOES NOT GUARANTEE THE ACCURACY OR COMPLETENESS OF THE SURVEY BASE OR ITS SUITABILITY AS A BASIS FOR CONSTRUCTION DRAWINGS.

SHOULD DISCREPANCIES BE ENCOUNTERED DURING CONSTRUCTION BETWEEN THE SURVEY DATA AND ACTUAL FIELD DATA, CONTACT AT & L.

THE FOLLOWING NOTES HAVE BEEN TAKEN DIRECTLY FROM THE ORIGINAL SURVEY DOCUMENTS.

NOTES

- 1. THE BOUNDARIES HAVE NOT BEEN MARKED ON GROUND
- 2. ALL AREAS AND DIMENSIONS HAVE BEEN COMPILED FROM PLANS MADE AVAILABLE BY NSW LAND REGISTRY SERVICES AND ARE SUBJECT TO FINAL SURVEY
- 3. ORIGIN OF LEVELS ON A.H.D. IS TAKEN FROM PM33566 R.L. 44.474 MAMRE ROAD (A.H.D.) IN
- 4. CONTOUR INTERVAL 0.5 m

RE-ISSUED FOR DA

RE-ISSUED FOR DA

- 5. CONTOURS ARE INDICATIVE ONLY. ONLY SPOT LEVELS SHOULD BE USED FOR CALCULATIONS OF QUANTITIES WITH CAUTION
- 6. ONLY SPOT LEVELS SHOULD BE USED FOR CALCULATIONS OF QUANTITIES WITH CAUTION
- KERB LEVELS ARE TO THE TOP OF KERB UNLESS SHOWN OTHERWISE 8. FLOOR LEVELS SHOWN ARE THRESHOLD LEVELS. NO INVESTIGATION
- OF INTERNAL FLOOR LEVELS HAS BEEN UNDERTAKEN NO INVESTIGATION OF UNDERGROUND SERVICES HAS BEEN MADE. SERVICES HAVE BEEN PLOTTED FROM RELEVANT AUTHORITIES INFORMATION AND HAVE NOT BEEN SURVEYED. ALL RELEVANT
- AUTHORITIES SHOULD BE NOTIFIED PRIOR TO ANY EXCAVATION ON OR NEAR THE SITE 10. 8/.4/7 DENOTES TREE SPREAD OF 8m. TRUNK DIAMETER OF 0.4m & APPROX HEIGHT OF 7m
- 11. SHOWS APPROXIMATE POSITION OF ROAD LINEMARKING AND IS INDICATIVE ONLY

Description

100mm on Original

12. BEARINGS SHOWN ARE MGA (MAP GRID OF AUSTRALIA) ADD APPROX. 1°00' FOR TRUE NORTH

CONCRETE NOTES

- 1. ALL WORKMANSHIP AND MATERIALS SHALL BE IN ACCORDANCE WITH AS 3600(2018) CURRENT EDITION WITH AMENDMENTS, EXCEPT WHERE VARIED BY THE CONTRACT DOCUMENTS.
- 2. CONCRETE QUALITY ALL REQUIREMENTS OF THE CURRENT ACSE CONCRETE SPECIFICATION DOCUMENT 1 SHALL APPLY TO THE FORMWORK, REINFORCEMENT AND CONCRETE UNLESS NOTED OTHERWISE.

ELEMENT	AS 3600 F'c MPa	SPECIFIED	NOMINAL
	AT 28 DAYS	SLUMP	AGG. SIZE
VEHICULAR BASE KERBS, PATHS, AND PITS	32 25	60 80	20 20

- CEMENT TYPE SHALL BE (ACSE SPECIFICATION) TYPE SL - PROJECT CONTROL TESTING SHALL BE CARRIED OUT IN ACCORDANCE WITH AS 1379.

- 3. NO ADMIXTURES SHALL BE USED IN CONCRETE UNLESS APPROVED IN WRITING BY AT & L.
- 4. CLEAR CONCRETE COVER TO ALL REINFORCEMENT FOR DURABILITY SHALL BE 40mm TOP AND 70mm FOR EXTERNAL EDGES UNLESS NOTED
- 5. ALL REINFORCEMENT SHALL BE FIRMLY SUPPORTED ON MILD STEEL PLASTIC TIPPED CHAIRS, PLASTIC CHAIRS OR CONCRETE CHAIRS AT NOT GREATER THAN 1m CENTRES BOTH WAYS. BARS SHALL BE TIED AT ALTERNATE INTERSECTIONS.
- 6. THE FINISHED CONCRETE SHALL BE A DENSE HOMOGENEOUS MASS. COMPLETELY FILLING THE FORMWORK, THOROUGHLY EMBEDDING THE REINFORCEMENT AND FREE OF STONE POCKETS. ALL CONCRETE INCLUDING SLABS ON GROUND AND FOOTINGS SHALL BE COMPACTED AND CURED IN ACCORDANCE WITH R.M.S. SPECIFICATION R83.
- . REINFORCEMENT SYMBOLS: N DENOTES GRADE 450 N BARS TO AS/NZS 4671 GRADE N
- R DENOTES 230 R HOT ROLLED PLAIN BARS TO AS/NZS 4671 SL DENOTES HARD-DRAWN WIRE REINFORCING FABRIC TO AS/NZS 4671

NUMBER OF BARS IN GROUP __ BAR GRADE AND TYPE

17 N 20 250

NOMINAL BAR SIZE IN mm SPACING IN mm

THE FIGURE FOLLOWING THE FABRIC SYMBOL SL IS THE REFERENCE NUMBER FOR FABRIC TO AS/NZS 4671.

8. FABRIC SHALL BE LAPPED IN ACCORDANCE WITH THE FOLLOWING DETAIL:

> 25 MIN LAP TWO WIRES

KERBING NOTES

- ALL CONCRETE TO HAVE A MINIMUM COMPRESSIVE STRENGTH OF MPa 25 U.N.O IN REINFORCED CONCRETE NOTES.
- 2. ALL KERBS, GUTTERS, DISH DRAINS AND CROSSINGS TO BE CONSTRUCTED ON 100mm GRANULAR BASECOURSE COMPACTED TO MINIMUM 95% MODIFIED DRY DENSITY (AS 1289 5.2.1).
- EXPANSION JOINTS (E.J) TO BE FORMED FROM 10mm COMPRESSIBLE CORK FILLER BOARD FOR THE FULL DEPTH OF THE SECTION AND CUT TO PROFILE. EXPANSION JOINTS TO BE LOCATED AT DRAINAGE PITS, ON TANGENT POINTS OF CURVES AND ELSEWHERE AT MAX 12m CENTRES EXCEPT FOR INTEGRAL KERBS WHERE THE EXPANSION JOINTS ARE TO MATCH THE JOINT LOCATIONS IN THE SLABS.
- WEAKENED PLANE JOINTS TO BE MIN 3mm WIDE AND LOCATED AT 3m CENTRES EXCEPT FOR INTEGRAL KERBS WHERE THE WEAKENED PLANE JOINTS ARE TO MATCH THE JOINT LOCATIONS IN THE SLABS.
- 5. BROOMED FINISH TO ALL RAMPED AND VEHICULAR CROSSINGS. ALL OTHER KERBING OR DISH DRAINS TO BE STEEL FLOAT FINISHED.
- 6. IN THE REPLACEMENT OF KERB AND GUTTER:- EXISTING ROAD PAVEMENT IS TO BE SAWCUT 900mm U.N.O FROM THE LIP OF GUTTER. UPON COMPLETION OF THE NEW KERB AND GUTTER NEW BASECOURSE AND SURFACE TO BE LAID 600mm WIDE U.N.O. EXISTING ALLOTMENT DRAINAGE PIPES ARE TO BE BUILT INTO THE NEW KERB AND GUTTER WITH 100mm DIA HOLE. EXISTING KERB AND GUTTER IS TO BE COMPLETELY REMOVED WHERE NEW KERB AND GUTTER IS SHOWN.

CONTRACTOR SHALL CALL; DIAL BEFORE YOU DIG 1100 PRIOR TO COMMENCEMENT OF WORK TO OBTAIN ALL CURRENT SERVICE AUTHORITY PLANS

30-08-23 Bar Scales

21-04-23

Date



STORMWATER DRAINAGE NOTES

- STORMWATER DESIGN CRITERIA: A) AVERAGE RECURRENCE INTERVAL 1:100 YEARS ROOFED AREAS TO SURCHARGE PIT 1:10 YEARS EXTERNAL PAVEMENTS
- 2. PIPES 300 DIA. AND LARGER TO BE REINFORCED CONCRETE CLASS '3' APPROVED SPIGOT AND SOCKET WITH RUBBER RING JOINTS. U.N.O.
- 3. PIPES UP TO 300 DIA SHALL BE SEWER GRADE uPVC WITH SOLVENT WELDED JOINTS.
- 4. EQUIVALENT STRENGTH VCP OR FRC PIPES MAY BE USED.
- ALL STORMWATER DRAINAGE LINES UNDER PROPOSED BUILDING SLABS TO BE uPVC PRESSURE PIPE GRADE 6. ENSURE ALL VERTICALS AND DOWNPIPES ARE uPVC PRESSURE PIPE, GRADE 6 FOR A MIN OF 3.0m IN
- . PIPES TO BE INSTALLED TO TYPE HS3 (ROAD) HS2 (LOTS) SUPPORT IN ACCORDANCE WITH AS 3725 (2007) IN ALL CASES BACKFILL TRENCH WITH SAND TO 300mm ABOVE PIPE. WHERE PIPE IS UNDER PAVEMENTS BACKFILL REMAINDER OF TRENCH TO UNDERSIDE OF PAVEMENT WITH SAND OR APPROVED GRANULAR MATERIAL COMPACTED IN 150mm LAYERS TO MINIMUM 98% STANDARD MAXIMUM DRY DENSITY IN ACCORDANCE WITH AS 1289 5.2.1. (OR A DENSITY INDEX OF NOT LESS THAN 75)
- ALL INTERNAL WORKS WITHIN PROPERTY BOUNDARIES ARE TO COMPLY WITH THE REQUIREMENTS OF AS 3500 3.1 (2021) AND AS/NZS 3500 3.2 (2021).
- PRECAST PITS MAY BE USED EXTERNAL TO THE BUILDING SUBJECT TO APPROVAL BY AT & L.
- 9. ENLARGERS, CONNECTIONS AND JUNCTIONS TO BE PREFABRICATED
- FITTINGS WHERE PIPES ARE LESS THAN 300 DIA. 10. WHERE SUBSOIL DRAINS PASS UNDER FLOOR SLABS AND VEHICULAR
- 11. CARE IS TO BE TAKEN WITH LEVELS OF STORMWATER LINES, GRADES

PAVEMENTS, UNSLOTTED uPVC SEWER GRADE PIPE IS TO BE USED.

12. GRATES AND COVERS SHALL CONFORM TO AS 3996.

SHOWN ARE NOT TO BE REDUCED WITHOUT APPROVAL.

- 13. ALL INTERNAL PIT DIMENSIONS TO CONFORM TO AS3500.3 TABLE 7.5.2.1
- 14. AT ALL TIMES DURING CONSTRUCTION OF STORMWATER PITS, ADEQUATE SAFETY PROCEDURES SHALL BE TAKEN TO ENSURE AGAINST THE POSSIBILITY OF PERSONNEL FALLING DOWN PITS.
- 15. ALL EXISTING STORMWATER DRAINAGE LINES AND PITS THAT ARE TO REMAIN ARE TO BE INSPECTED AND CLEANED. DURING THIS PROCESS ANY PART OF THE STORMWATER DRAINAGE SYSTEM THAT WARRANTS REPAIR SHALL BE REPORTED TO THE SUPERINTENDENT/ENGINEER FOR FURTHER DIRECTIONS.

EXISTING UNDERGROUND SERVICES NOTES

THE LOCATIONS OF UNDERGROUND SERVICES SHOWN IN THIS SET OF DRAWINGS HAVE BEEN PLOTTED FROM SURVEY INFORMATION AND SERVICE AUTHORITY INFORMATION. THE SERVICE INFORMATION HAS BEEN PREPARED ONLY TO SHOW THE APPROXIMATE POSITIONS OF ANY KNOWN SERVICES AND MAY NOT BE AS CONSTRUCTED OR ACCURATE. AT & L CAN NOT GUARANTEE THAT THE SERVICES INFORMATION SHOWN ON THESE DRAWINGS ACCURATELY INDICATES THE PRESENCE OR ABSENCE OF SERVICES OR THEIR LOCATION AND WILL ACCEPT NO LIABILITY FOR INACCURACIES IN THE SERVICES INFORMATION SHOWN FROM ANY CAUSE

CONTRACTORS SHALL TAKE DUE CARE WHEN EXCAVATING ONSITE INCLUDING HAND EXCAVATION WHERE NECESSARY.

CONTRACTORS ARE TO CONTACT THE RELEVANT SERVICE AUTHORITY PRIOR TO COMMENCEMENT OF EXCAVATION WORKS.

CONTRACTORS ARE TO UNDERTAKE A SERVICES SEARCH, PRIOR TO COMMENCEMENT OF WORKS ON SITE. SEARCH RESULTS ARE TO BE KEPT ON SITE AT ALL TIMES.

GENERAL NOTES

ALL CIVIL WORKS TO BE UNDERTAKEN AS PER PENRITH CITY COUNCIL ENGINEERING & CONSTRUCTION GUIDELINES.

EROSION AND SEDIMENT CONTROL NOTES

GENERAL INSTRUCTIONS

- THE SITE SUPERINTENDENT/ENGINEER WILL ENSURE THAT ALL SOIL AND WATER MANAGEMENT WORKS ARE LOCATED AS DOCUMENTED.
- . ALL WORK SHALL BE GENERALLY CARRIED OUT IN ACCORDANCE WITH
- a. LOCAL AUTHORITY REQUIREMENT b. EPA REQUIREMENTS
- c. NSW DEPARTMENT OF HOUSING MANUAL "MANAGING URBAN STORMWATER, SOILS AND CONSTRUCTION", 4th EDITION. MARCH 2004.
- MAINTAIN THE EROSION CONTROL DEVICES TO THE SATISFACTION OF
- THE SUPERINTENDENT AND THE LOCAL AUTHORITY. . WHEN STORMWATER PITS ARE CONSTRUCTED, PREVENT SITE RUNOFF
- ENTERING UNLESS SEDIMENT FENCES ARE ERECTED AROUND PITS. . CONTRACTOR IS TO ENSURE ALL EROSION & SEDIMENT CONTROL DEVICES ARE MAINTAINED IN GOOD WORKING ORDER AND OPERATE EFFECTIVELY. REPAIRS AND OR MAINTENANCE SHALL BE UNDERTAKEN AS REQUIRED, PARTICULARLY FOLLOWING STORM EVENTS.

LAND DISTURBANCE

- S. WHERE PRACTICAL. THE SOIL EROSION HAZARD ON THE SITE WILL BE KEPT AS LOW AS POSSIBLE. TO THIS END, WORKS SHOULD BE UNDERTAKEN IN THE FOLLOWING SEQUENCE:
- (A) INSTALL A WIND FENCE ALONG THE BOUNDARIES AS SHOWN ON PLAN. REFER DETAIL. (B) INSTALL A SEDIMENT FENCE ALONG THE BOUNDARIES AS SHOWN ON
- PLAN. REFER DETAIL. (C) CONSTRUCT STABILISED CONSTRUCTION ENTRANCE TO LOCATION AS DETERMINED BY SUPERINTENDENT/ENGINEER. REFER DETAIL. (D) INSTALL SEDIMENT BASIN AS SHOWN ON PLAN
- (E) INSTALL SEDIMENT TRAPS AS SHOWN ON PLAN. (F) UNDERTAKE SITE DEVELOPMENT WORKS IN ACCORDANCE WITH THE ENGINEERING PLANS. WHERE POSSIBLE, PHASE DEVELOPMENT SO THAT LAND DISTURBANCE IS CONFINED TO AREAS OF WORKABLE SIZE.

FROSION CONTROL

- DURING WINDY WEATHER, LARGE, UNPROTECTED AREAS WILL BE KEPT MOIST (NOT WET) BY SPRINKLING WITH WATER TO KEEP DUST UNDER CONTROL.
- B. FINAL SITE LANDSCAPING WILL BE UNDERTAKEN AS SOON AS POSSIBLE AND WITHIN 20 WORKING DAYS FROM COMPLETION OF CONSTRUCTION ACTIVITIES.
- STOCKPILES WILL NOT BE LOCATED WITHIN 2 METRES OF HAZARD AREAS, INCLUDING LIKELY AREAS OF CONCENTRATED OR HIGH VELOCITY FLOWS SUCH AS WATERWAYS. WHERE THEY ARE BETWEEN 2 AND 5 METRES FROM SUCH AREAS, SPECIAL SEDIMENT CONTROL MEASURES SHOULD BE TAKEN TO MINIMISE POSSIBLE POLLUTION TO DOWNSLOPE WATERS, E.G. THROUGH INSTALLATION OF SEDIMENT FENCING.
- D. ANY SAND USED IN THE CONCRETE CURING PROCESS (SPREAD OVER THE SURFACE) WILL BE REMOVED AS SOON AS POSSIBLE AND WITHIN 10 WORKING DAYS FROM PLACEMENT.
- 1. WATER WILL BE PREVENTED FROM ENTERING THE PERMANENT DRAINAGE SYSTEM UNLESS IT IS RELATIVELY SEDIMENT FREE. I.E. THE CATCHMENT AREA HAS BEEN PERMANENTLY LANDSCAPED AND/OR ANY LIKELY SEDIMENT HAS BEEN FILTERED THROUGH AN APPROVED
- 2. TEMPORARY SOIL AND WATER MANAGEMENT STRUCTURES WILL BE REMOVED ONLY AFTER THE LANDS THEY ARE PROTECTING ARE REHABILITATED.

OTHER MATTERS

- 13. ACCEPTABLE RECEPTORS WILL BE PROVIDED FOR CONCRETE AND MORTAR SLURRIES, PAINTS, ACID WASHINGS, LIGHT-WEIGHT WASTE
- MATERIALS AND LITTER. 4. ANY EXISTING TREES WHICH FORM PART OF THE FINAL LANDSCAPING PLAN WILL BE PROTECTED FROM CONSTRUCTION ACTIVITIES BY: (A) PROTECTING THEM WITH BARRIER FENCING OR SIMILAR
- MATERIALS INSTALLED OUTSIDE THE DRIP LINE (B) ENSURING THAT NOTHING IS NAILED TO THEM (C) PROHIBITING PAVING, GRADING, SEDIMENT WASH OR PLACING OF STOCKPILES WITHIN THE DRIP LINE EXCEPT UNDER THE
- FOLLOWING CONDITIONS. (I) ENCROACHMENT ONLY OCCURS ON ONE SIDE AND NO CLOSER TO THE TRUNK THAN EITHER 1.5 METRES OR HALF THE DISTANCE BETWEEN THE OUTER EDGE OF THE DRIP LINE AND
- THE TRUNK, WHICH EVER IS THE GREATER (II) A DRAINAGE SYSTEM THAT ALLOWS AIR AND WATER TO CIRCULATE THROUGH THE ROOT ZONE (E.G. A GRAVEL BED) IS PLACED UNDER ALL FILL LAYERS OF MORE THAN 300
- MILLIMETRES DEPTH (III) CARE IS TAKEN NOT TO CUT ROOTS UNNECESSARILY NOR TO COMPACT THE SOIL AROUND THEM.

EROSION AND SEDIMENT CONTROL

- THE SITE SUPERINTENDENT/ENGINEER WILL ENSURE THAT ALL SOIL
- AND WATER MANAGEMENT WORKS ARE LOCATED AS DOCUMENTED. 2. ALL WORK SHALL BE GENERALLY CARRIED OUT IN ACCORDANCE WITH
- a. LOCAL AUTHORITY REQUIREMENTS b. EPA REQUIREMENTS
- c. NSW DEPARTMENT OF HOUSING MANUAL "MANAGING URBAN STORMWATER, SOILS AND CONSTRUCTION", 4th EDITION, MARCH 2004.
- . MAINTAIN THE EROSION CONTROL DEVICES TO THE SATISFACTION OF THE SUPERINTENDENT AND THE LOCAL AUTHORITY.
- . WHEN STORMWATER PITS ARE CONSTRUCTED, PREVENT SITE RUNOFF
- ENTERING UNLESS SEDIMENT FENCES ARE ERECTED AROUND PITS. . CONTRACTOR IS TO ENSURE ALL EROSION & SEDIMENT CONTROL
- DEVICES ARE MAINTAINED IN GOOD WORKING ORDER AND OPERATE EFFECTIVELY, REPAIRS AND OR MAINTENANCE SHALL BE UNDERTAKEN AS REQUIRED, PARTICULARLY FOLLOWING STORM EVENTS.

THIS DRAWING CANNOT BE 02-03-23 RE-ISSUED FOR DA COPIED OR REPRODUCED IN 02-02-23 RE-ISSUED FOR DA ANY FORM OR USED FOR ANY 22-12-22 RE-ISSUED FOR DA OTHER PURPOSE OTHER THAN 10-11-22 RE-ISSUED FOR DA THAT ORIGINALLY INTENDED RE-ISSUED FOR DA 04-11-22 WITHOUT THE WRITTEN 09-08-22 RE-ISSUED FOR DA PERMISSION OF AT&L RE-ISSUED FOR DA 08-08-22

GibbGroup.

Client

GDA 2020

Scales NT QD & TS Checked MG Approved

KEMPS CREEK

805 MAMRE ROAD

Project


GENERAL NOTES


Level 7, 153 Walker Street North Sydney NSW 2060 P 02 9439 1777 E info@atl.net.au www.atl.net.au ABN 96 130 882 405

Civil Engineers and Project Managers

FOR APPROVAL NOT FOR CONSTRUCTION Project - Drawing No. 21-894-C1002

Issue

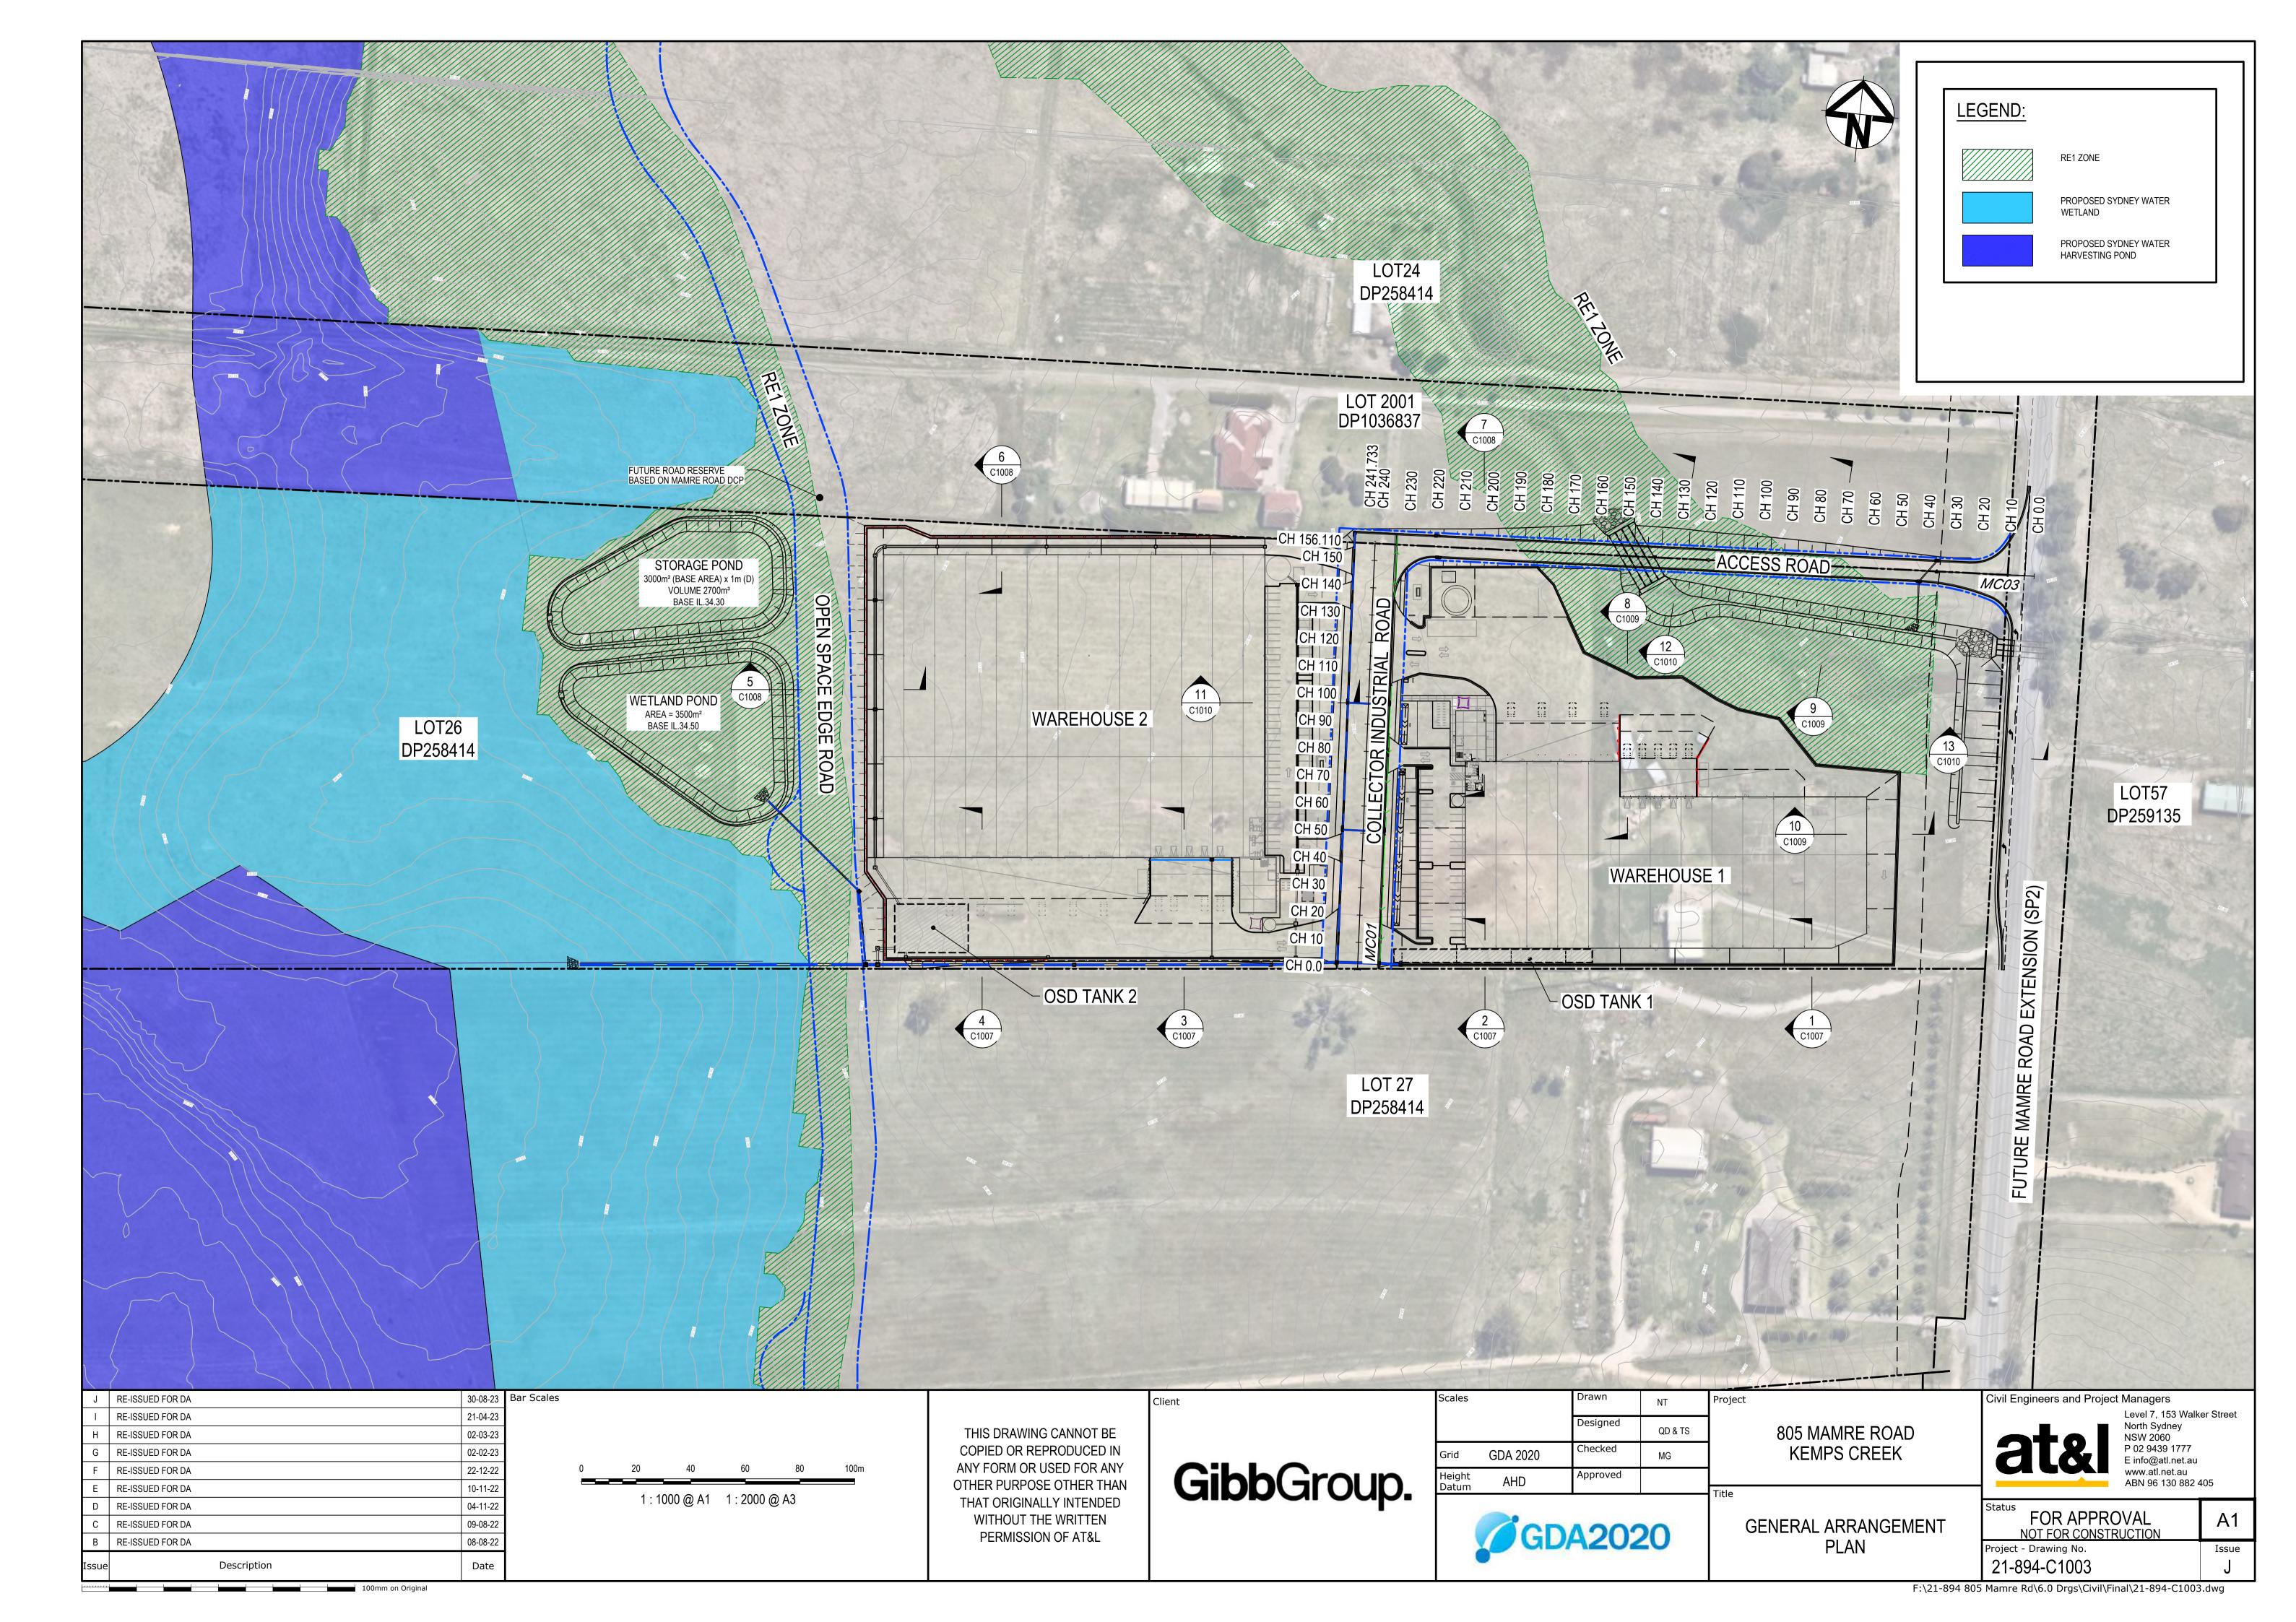

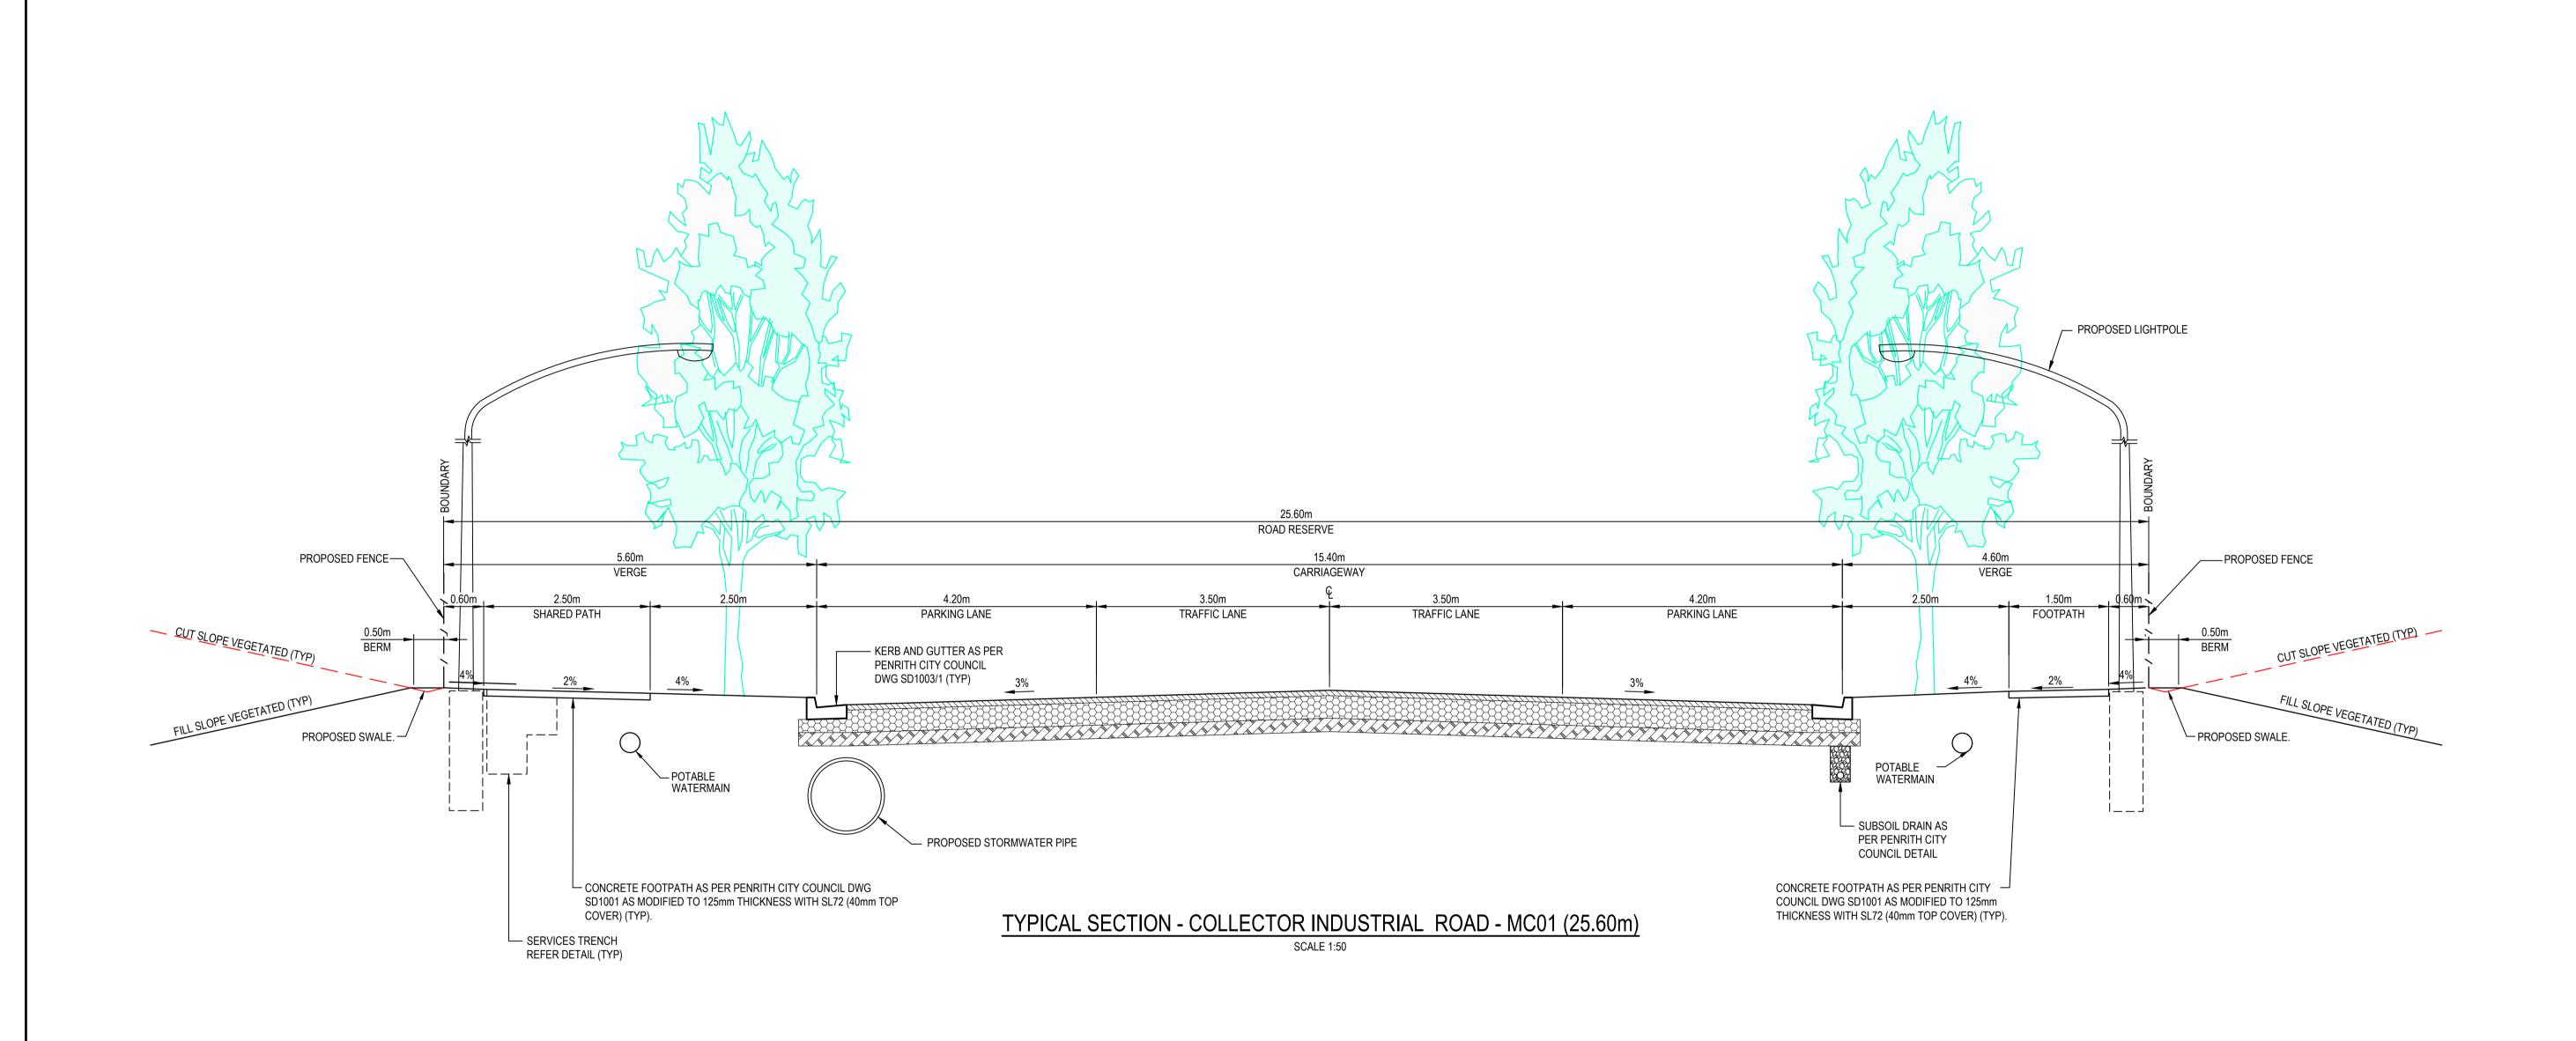

J	RE-ISSUED FOR DA	30-08-23	Bar Scales
I	RE-ISSUED FOR DA	21-04-23	
Н	RE-ISSUED FOR DA	02-03-23	
G	RE-ISSUED FOR DA	02-02-23	
F	RE-ISSUED FOR DA	22-12-22	
Е	RE-ISSUED FOR DA	10-11-22	
D	RE-ISSUED FOR DA	04-11-22	
С	RE-ISSUED FOR DA	09-08-22	
В	RE-ISSUED FOR DA	08-08-22	
Issue	Description	Date	

100mm on Original

1:50 @ A1 1:100 @ A3

THIS DRAWING CANNOT BE COPIED OR REPRODUCED IN ANY FORM OR USED FOR ANY OTHER PURPOSE OTHER THAN THAT ORIGINALLY INTENDED WITHOUT THE WRITTEN PERMISSION OF AT&L

GibbGroup.

Client


Scales	1 : 50	Drawn	NT	Proj
	1.50	Designed	QD & TS	
Grid	GDA 2020	Checked	MG	
Height Datum	AHD	Approved		<u> </u>
= 5:50.				Ti+l2


805 MAMRE ROAD KEMPS CREEK


Civil Engineers and Project Managers Level 7, 153 Walker Street North Sydney NSW 2060 P 02 9439 1777 E info@atl.net.au www.atl.net.au ABN 96 130 882 405


TYPICAL ROAD CROSS SECTIONS SHEET 1

FOR APPROVAL NOT FOR CONSTRUCTION	A1
roject - Drawing No.	Issue
21-894-C1004	J

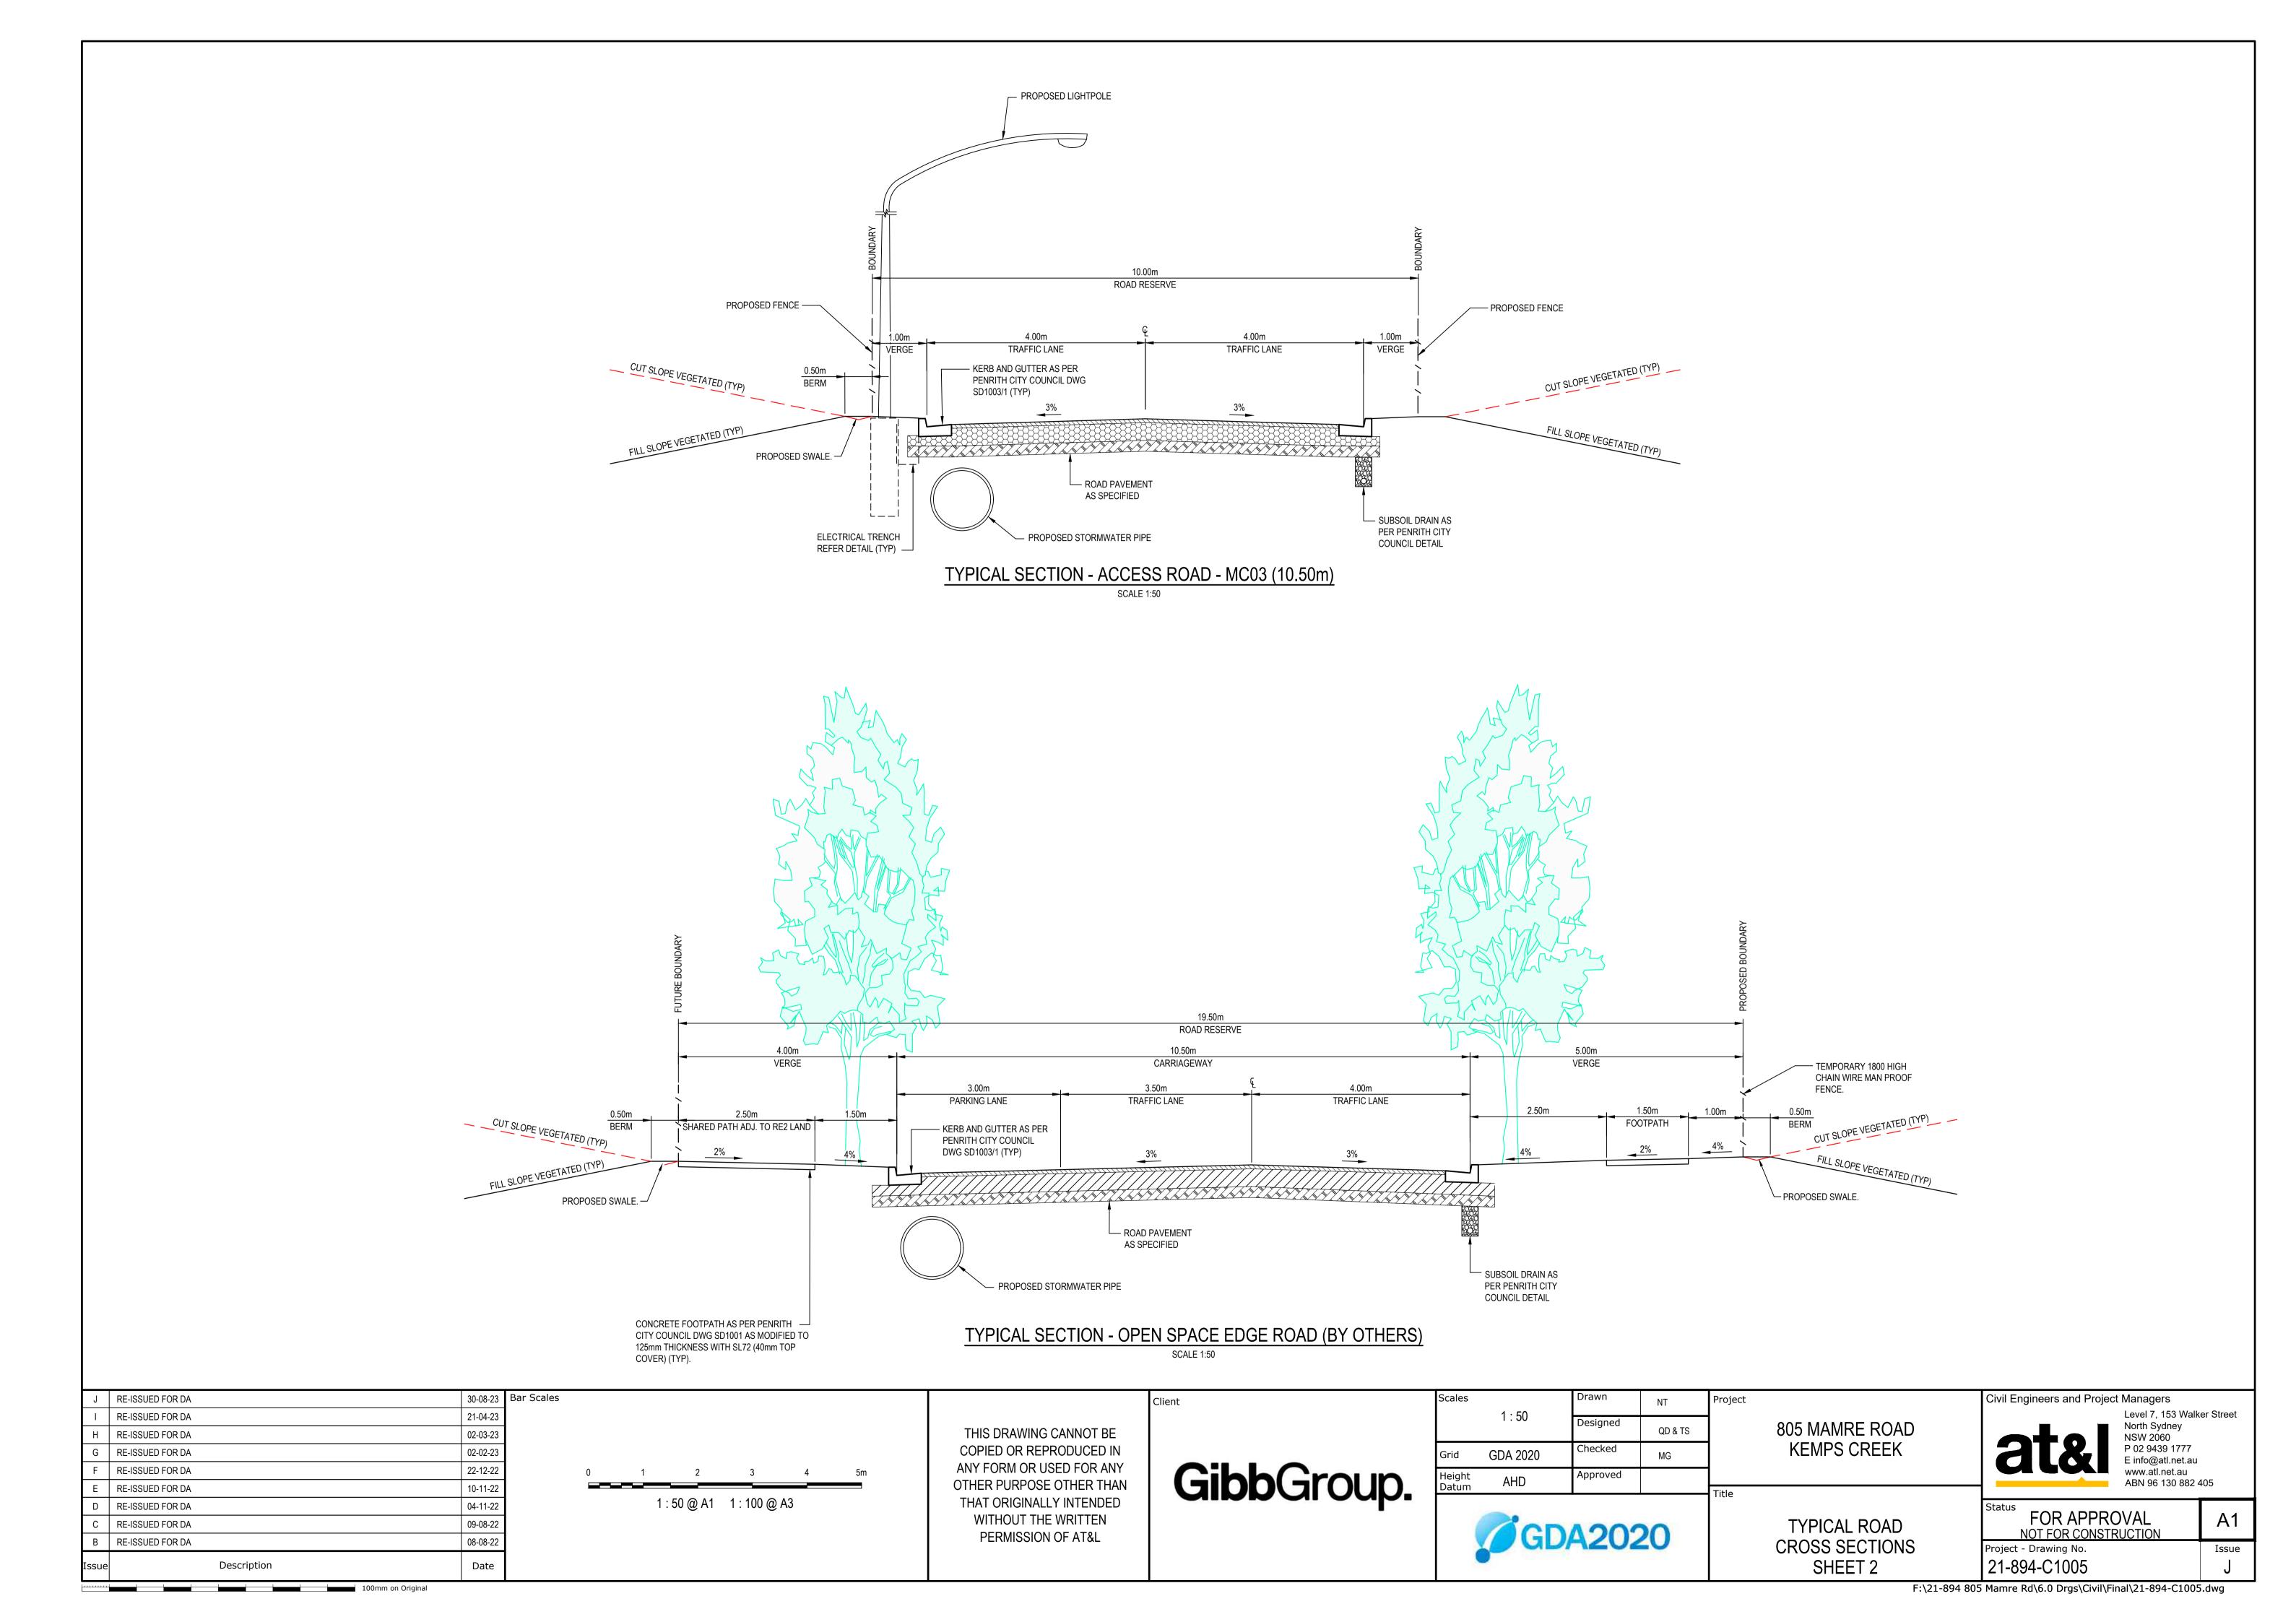

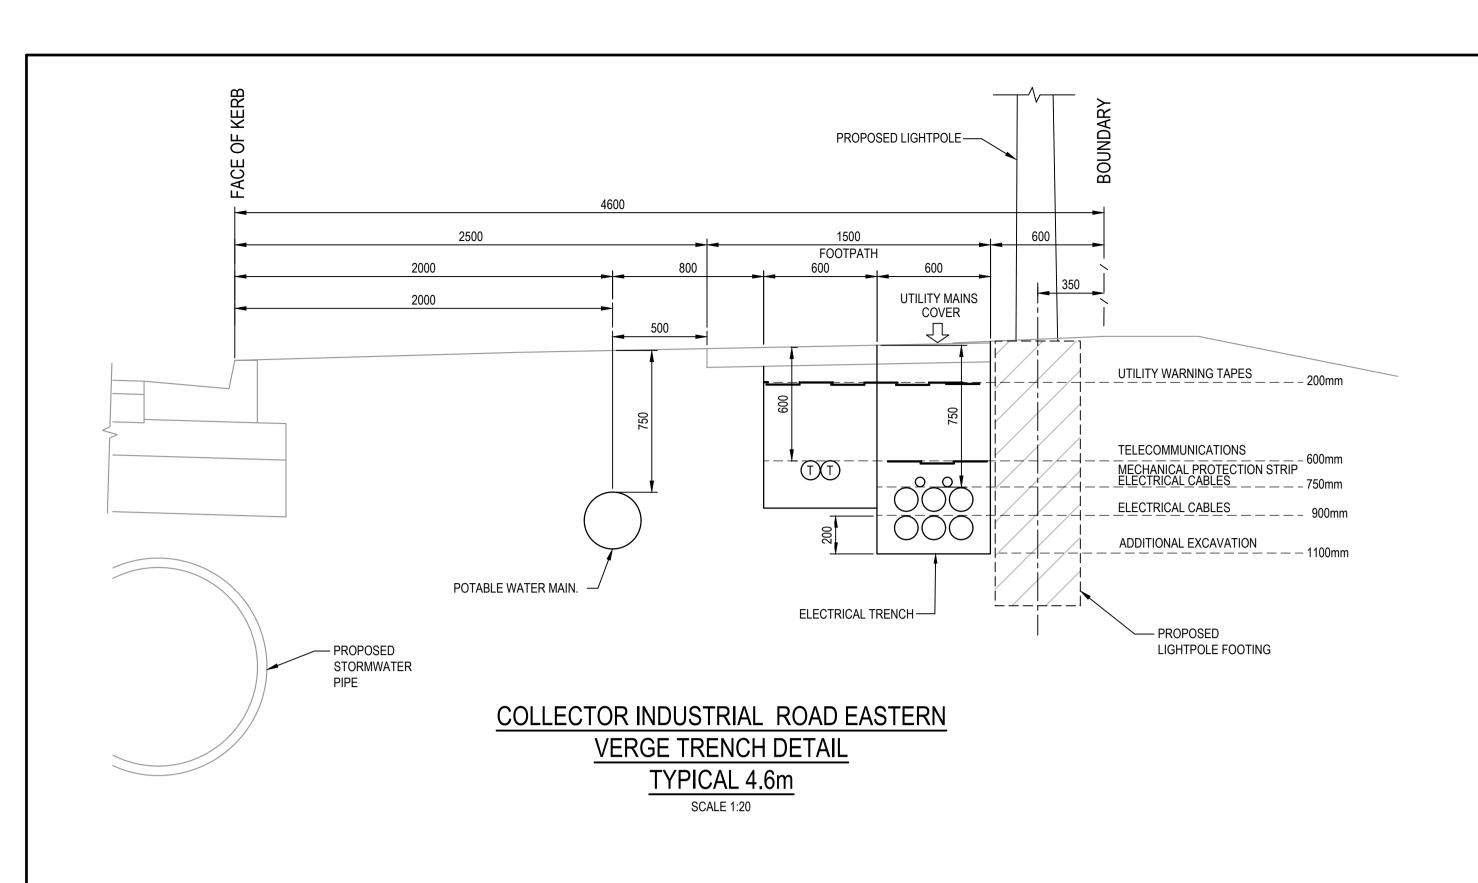

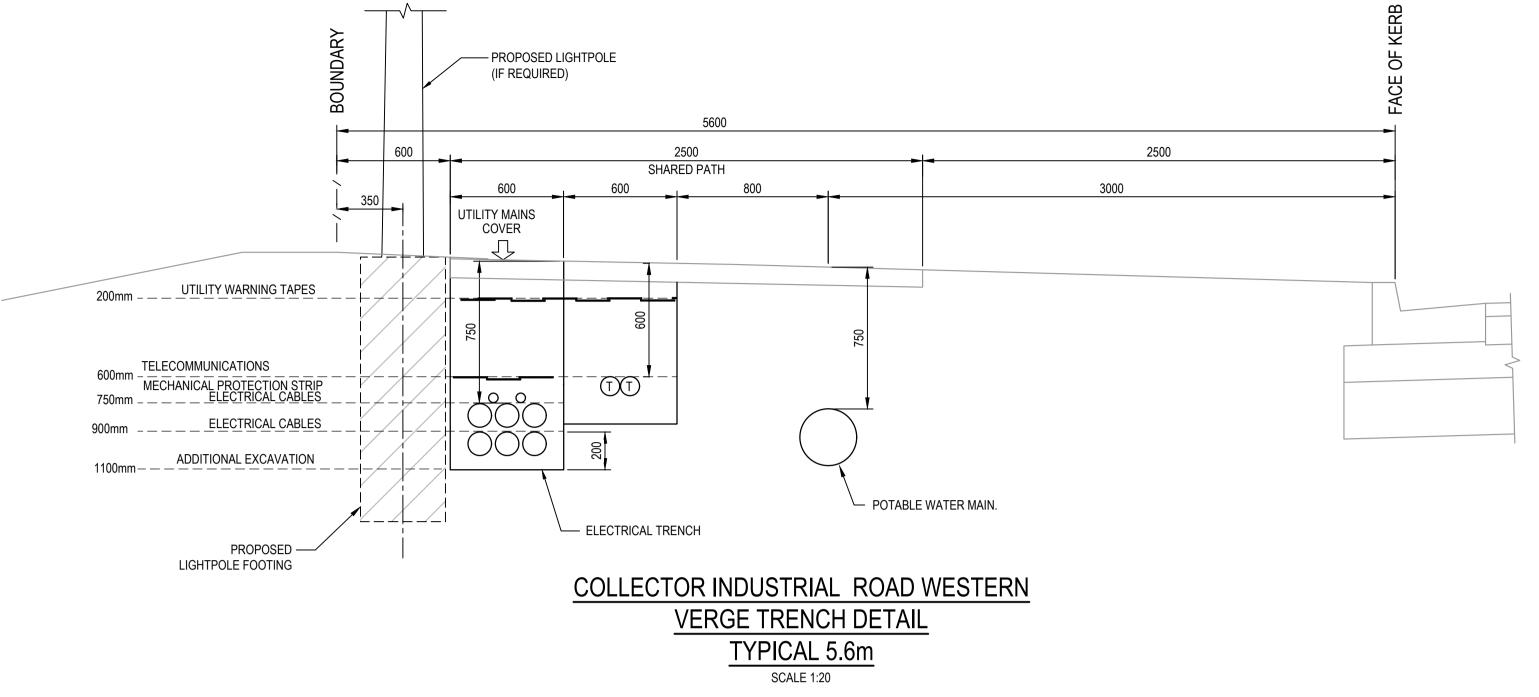

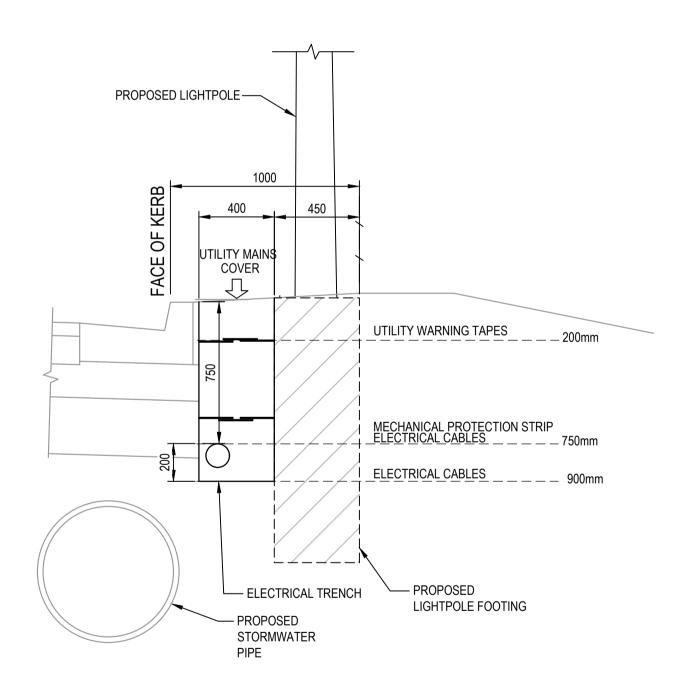

ACCESS ROAD TYPICAL 1.0m VERGE TRENCH DETAIL

Tssue	Description	Date	
В	RE-ISSUED FOR DA	08-08-22	
С	RE-ISSUED FOR DA	09-08-22	
D	RE-ISSUED FOR DA	04-11-22	
Е	RE-ISSUED FOR DA	10-11-22	
F	RE-ISSUED FOR DA	22-12-22	
G	RE-ISSUED FOR DA	02-02-23	
Н	RE-ISSUED FOR DA	02-03-23	
I	RE-ISSUED FOR DA	21-04-23	
J	RE-ISSUED FOR DA	30-08-23	Bar Scales

100mm on Original

1 : 20 @ A1 1 : 40 @ A3

THIS DRAWING CANNOT BE COPIED OR REPRODUCED IN ANY FORM OR USED FOR ANY OTHER PURPOSE OTHER THAN THAT ORIGINALLY INTENDED WITHOUT THE WRITTEN PERMISSION OF AT&L

GibbGroup.

Client

Scales	AS SHOWN	Drawn	NT	Proje
	AS SHOWN	Designed	QD & TS	
Grid	GDA 2020	Checked	MG	
Height	AHD	Approved		
Datum	· ·=			Title


805 MAMRE ROAD KEMPS CREEK


> TYPICAL VERGE SECTIONS


Civil Engineers and Project Managers


Level 7, 153 Walker Street North Sydney NSW 2060 P 02 9439 1777 E info@atl.net.au www.atl.net.au ABN 96 130 882 405


FOR APPROVAL **A**1 NOT FOR CONSTRUCTION Project - Drawing No. Issue 21-894-C1006

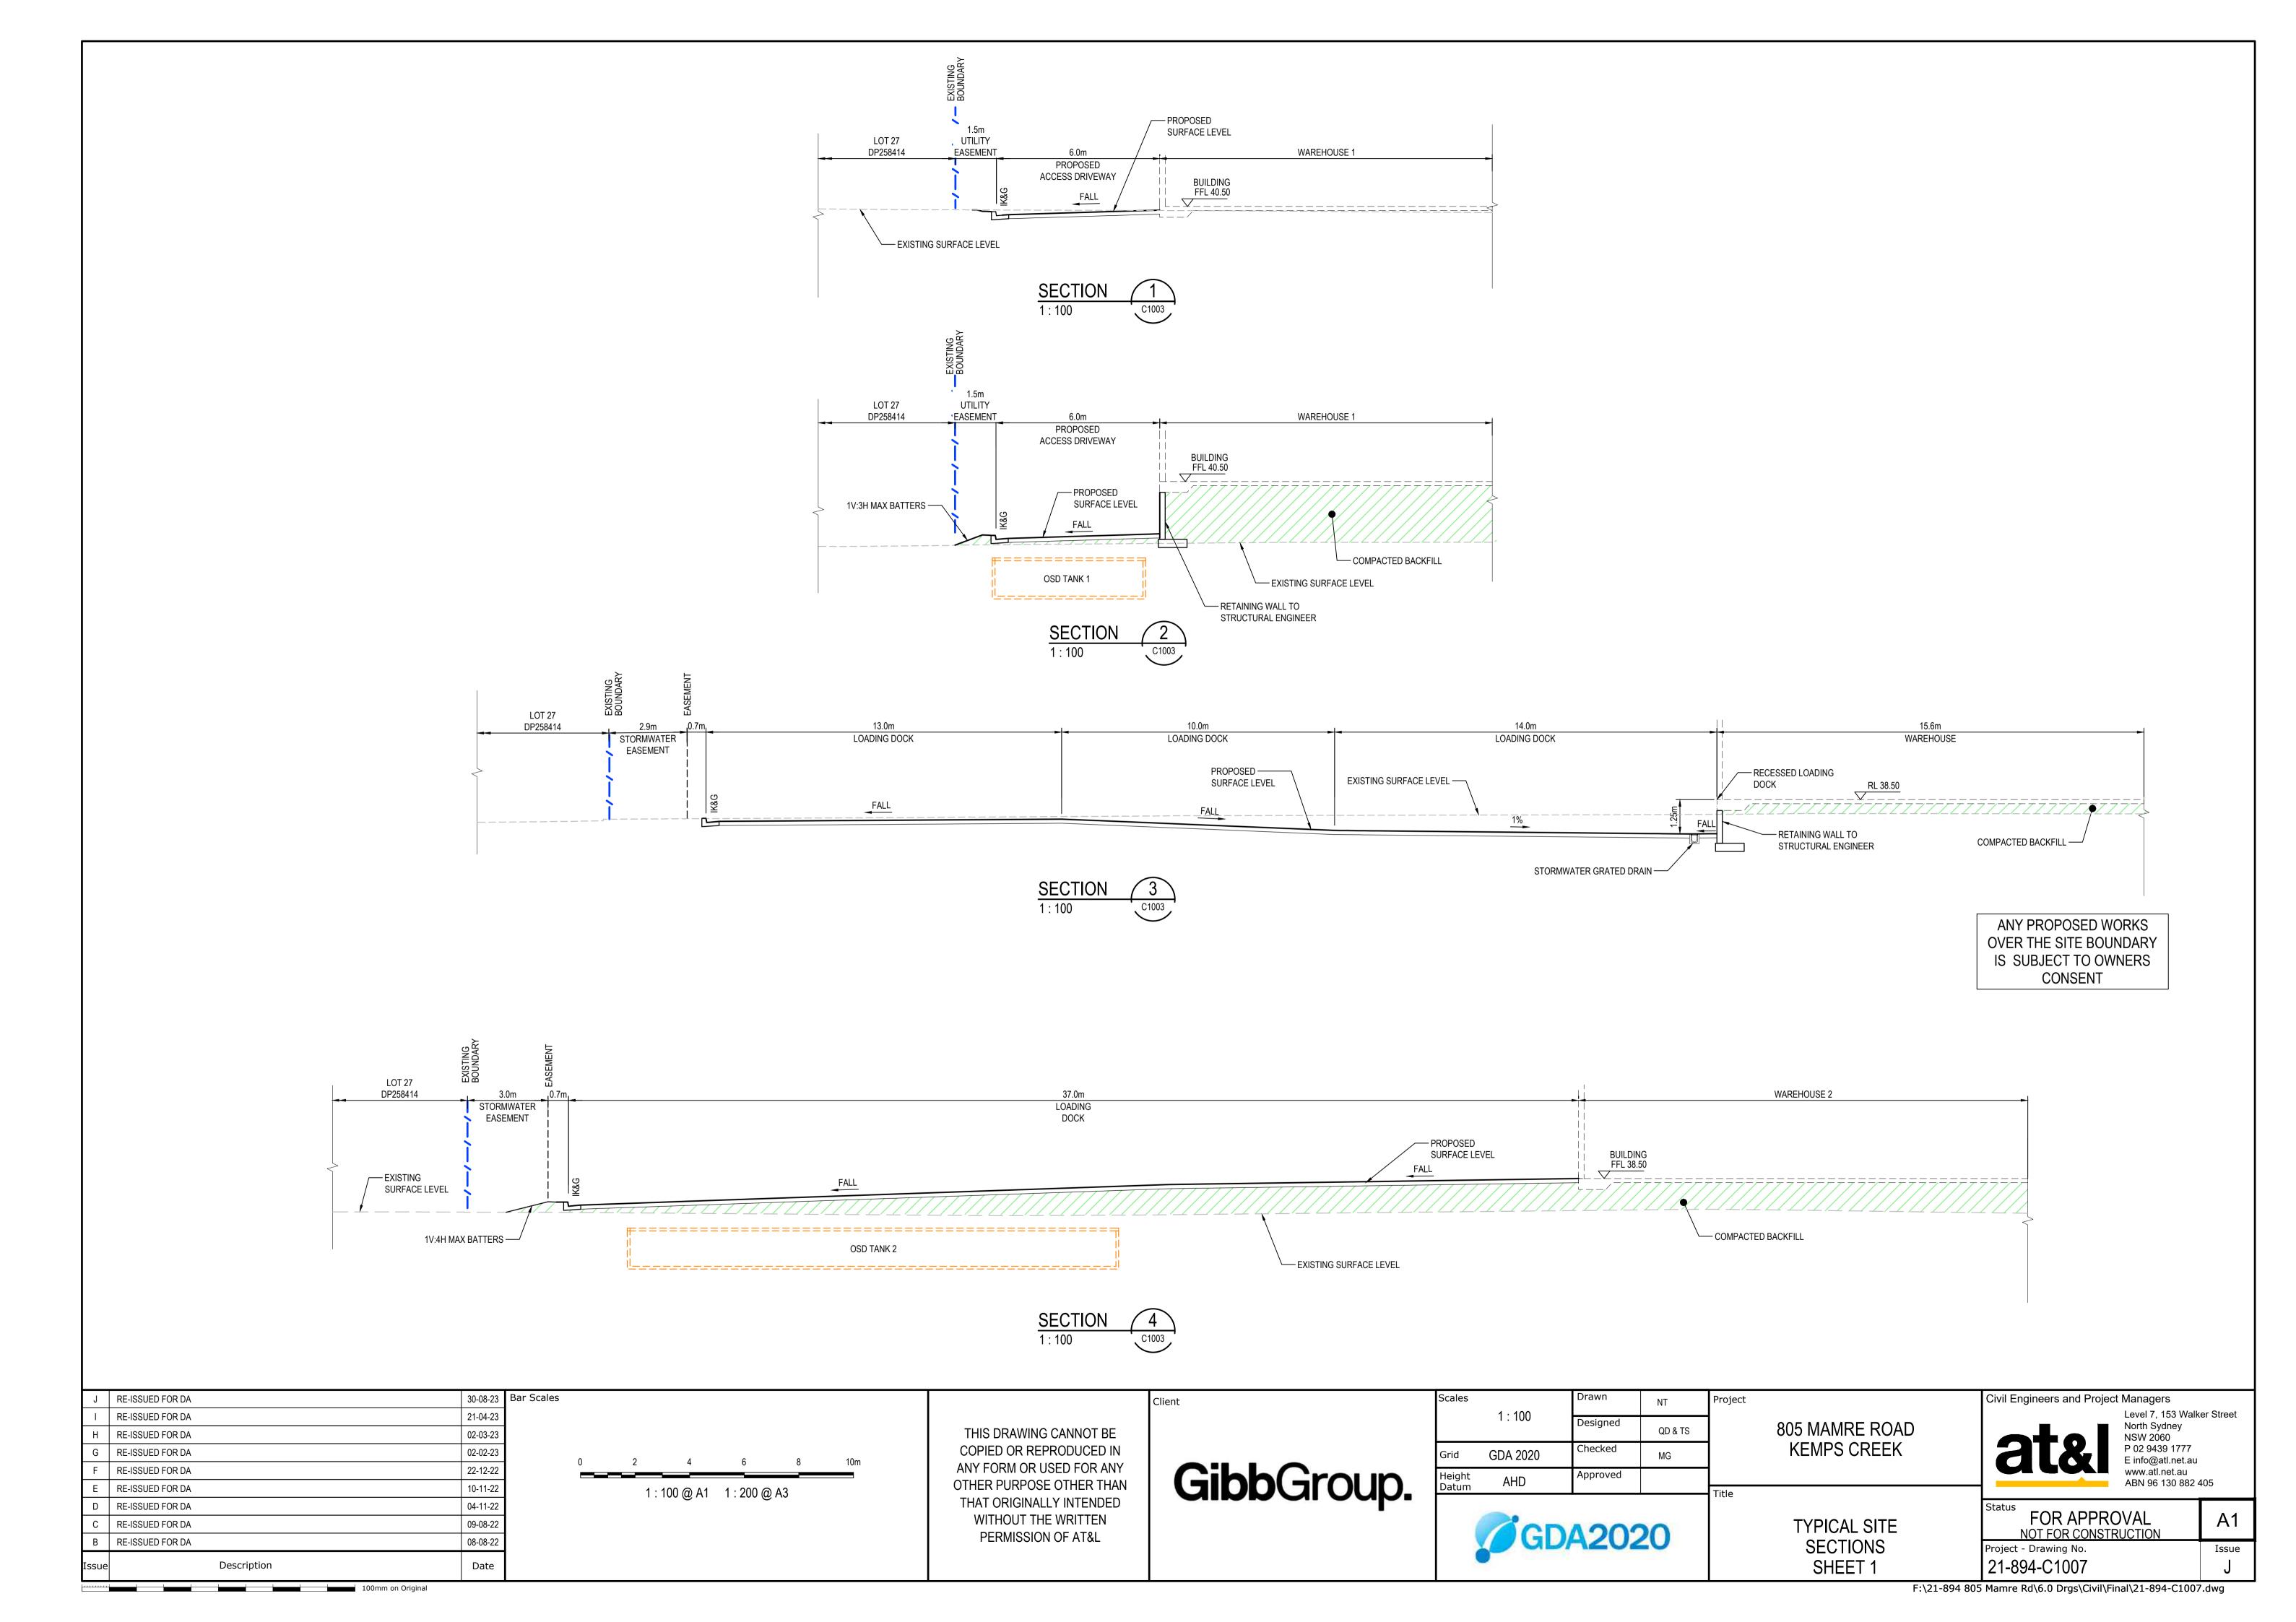

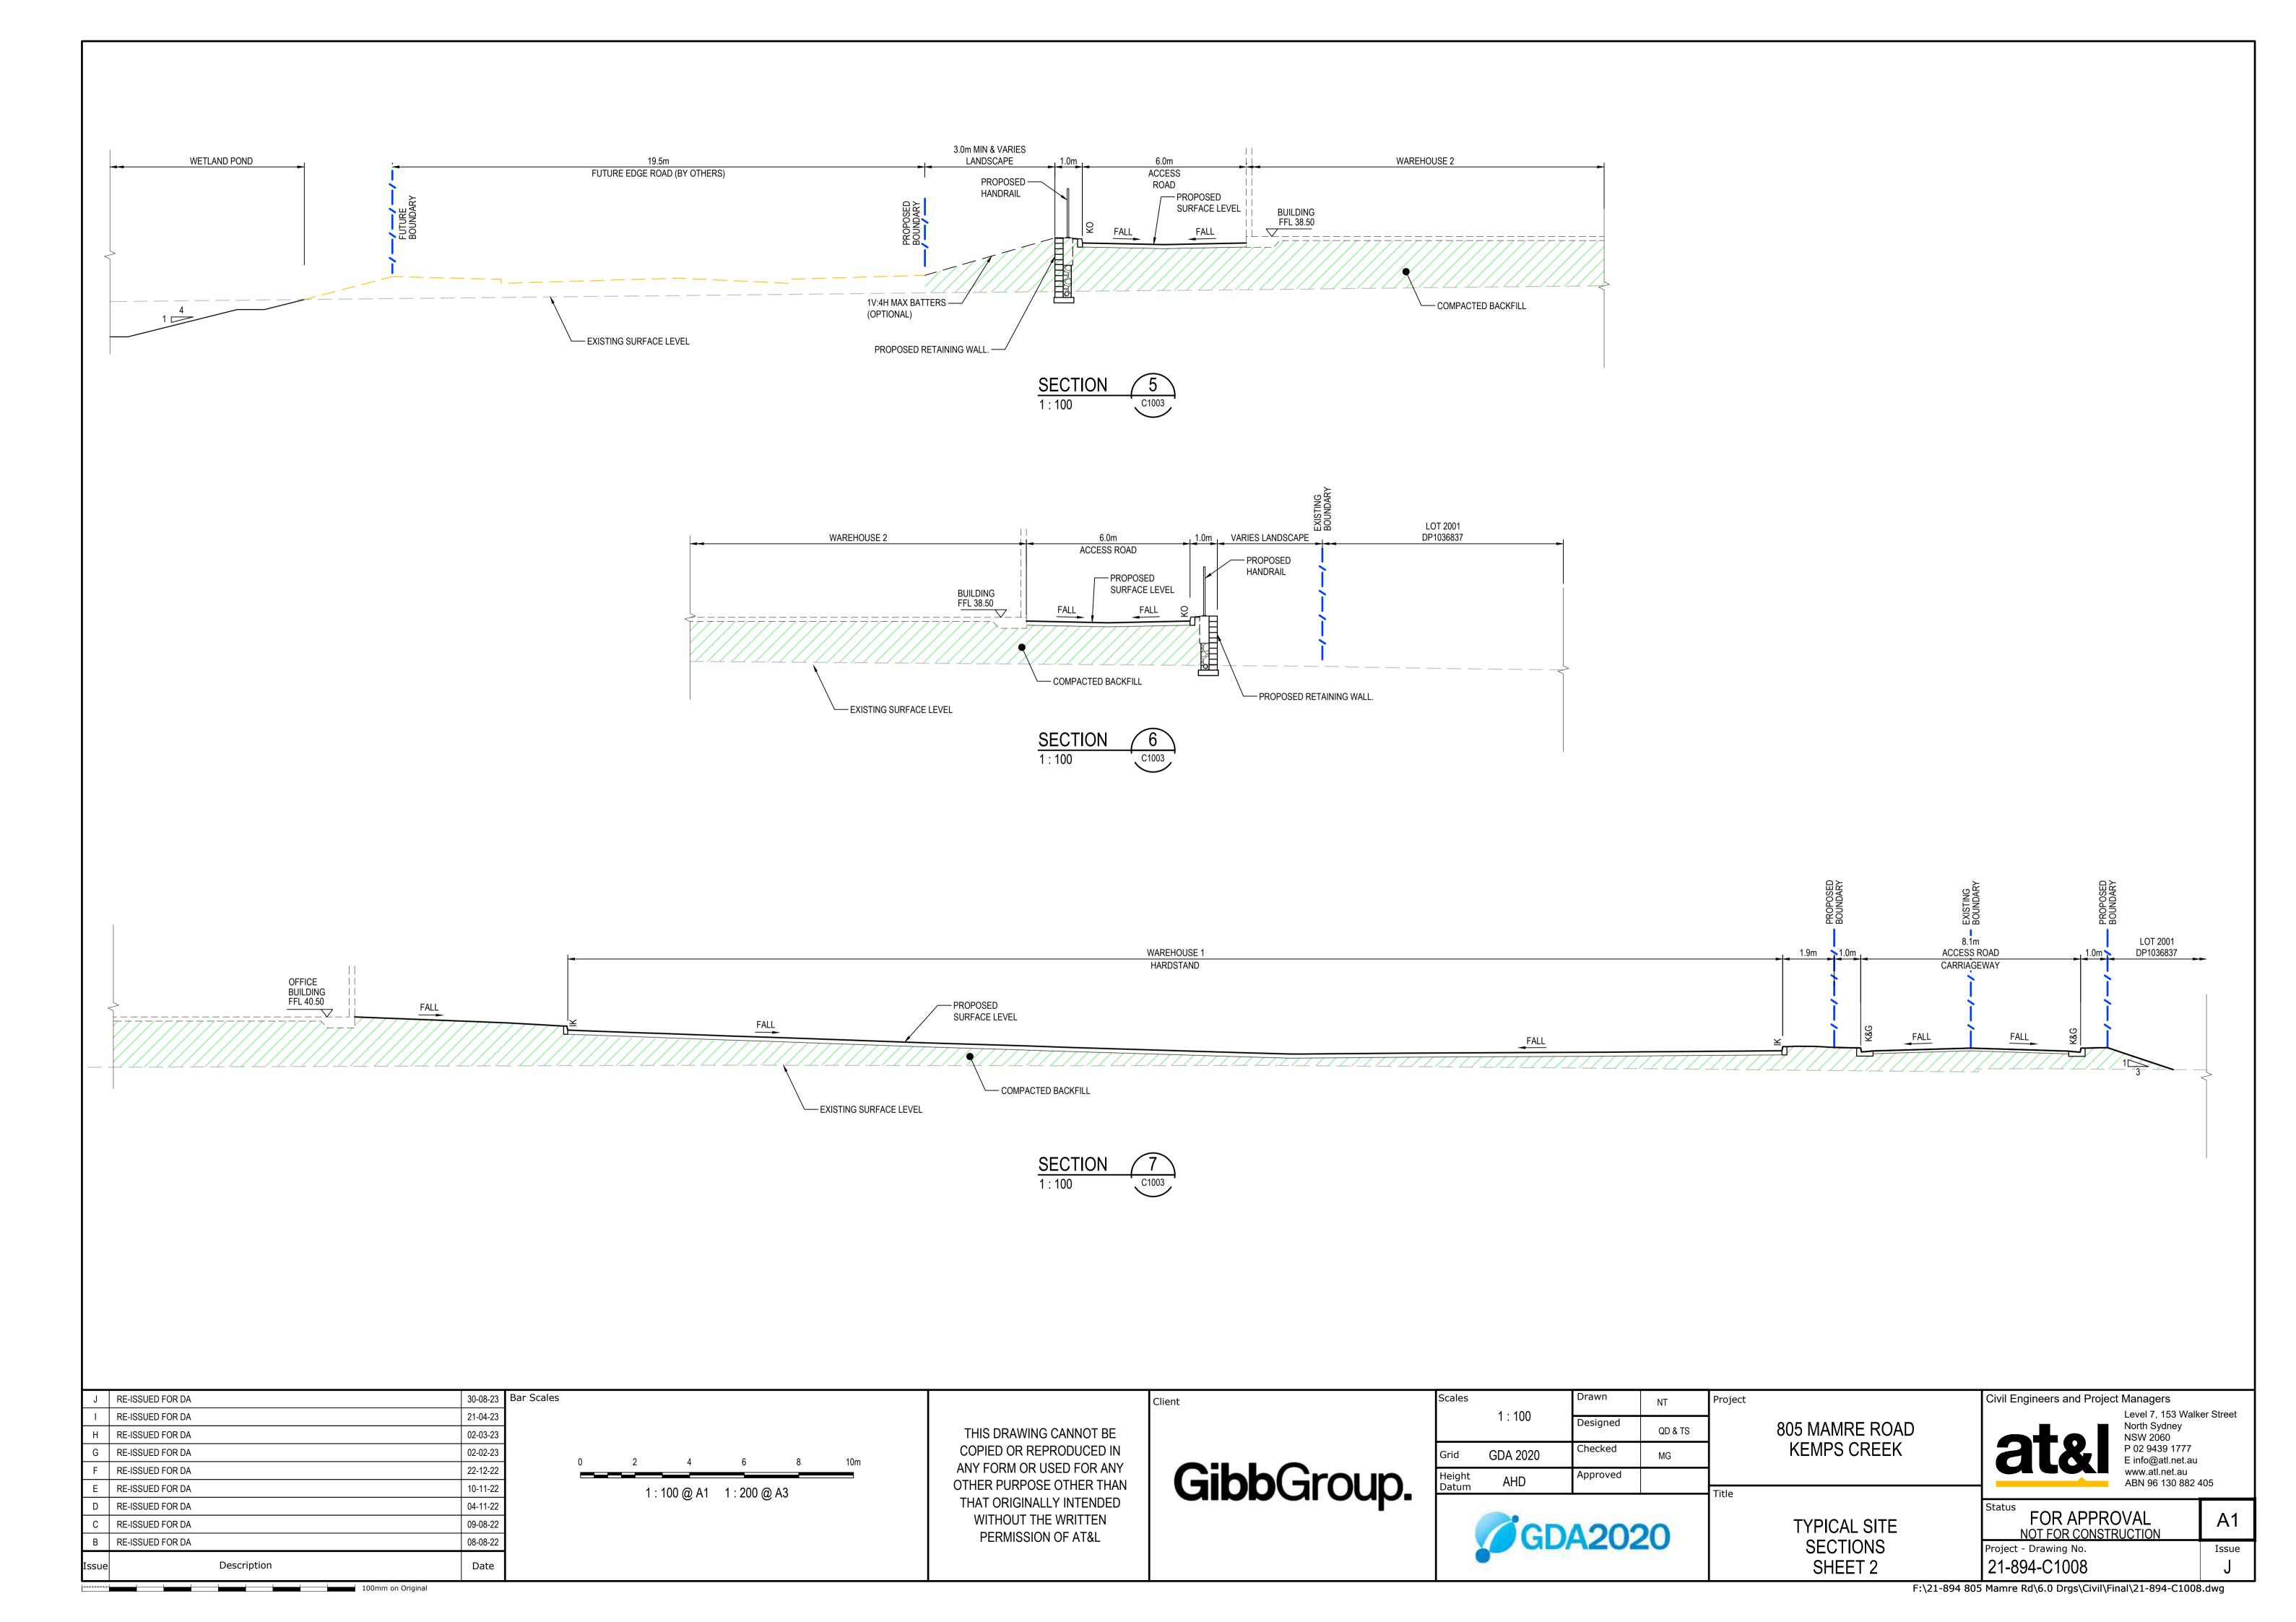


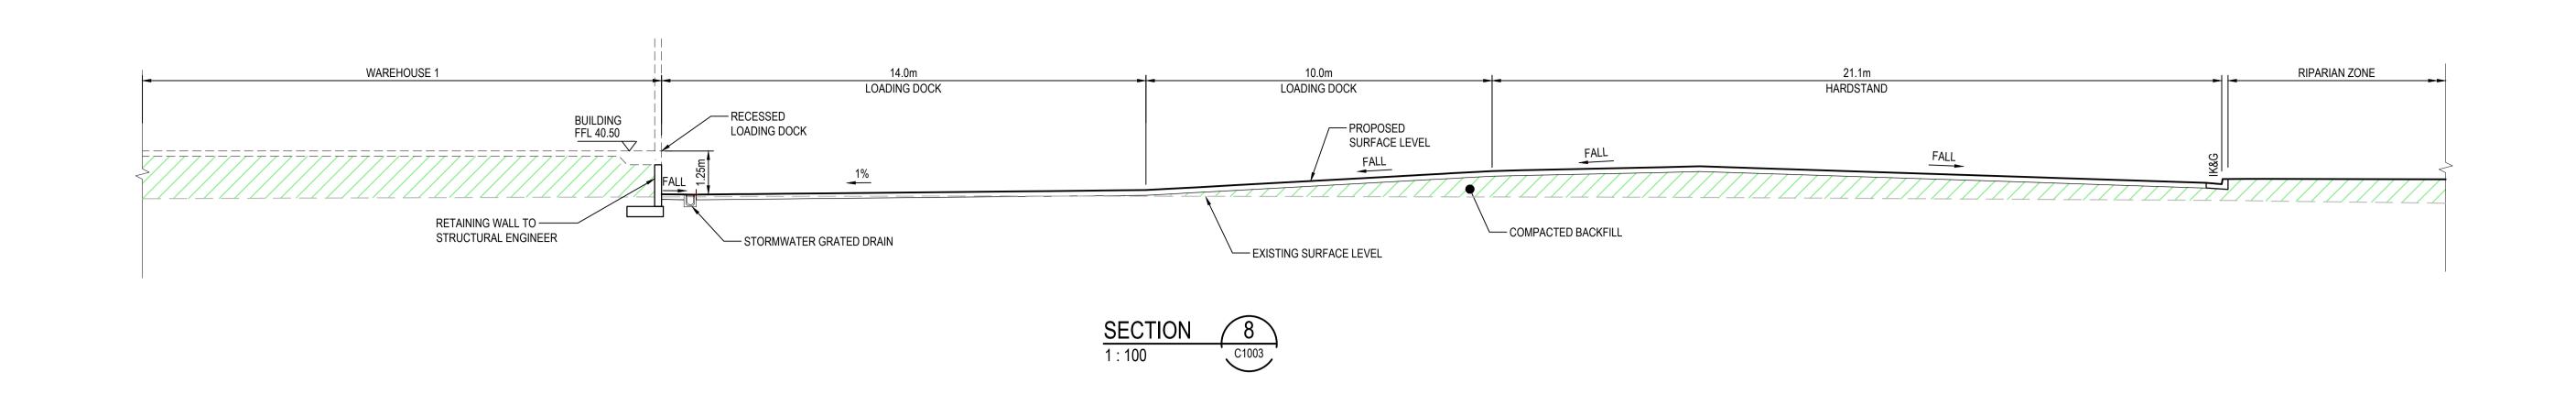


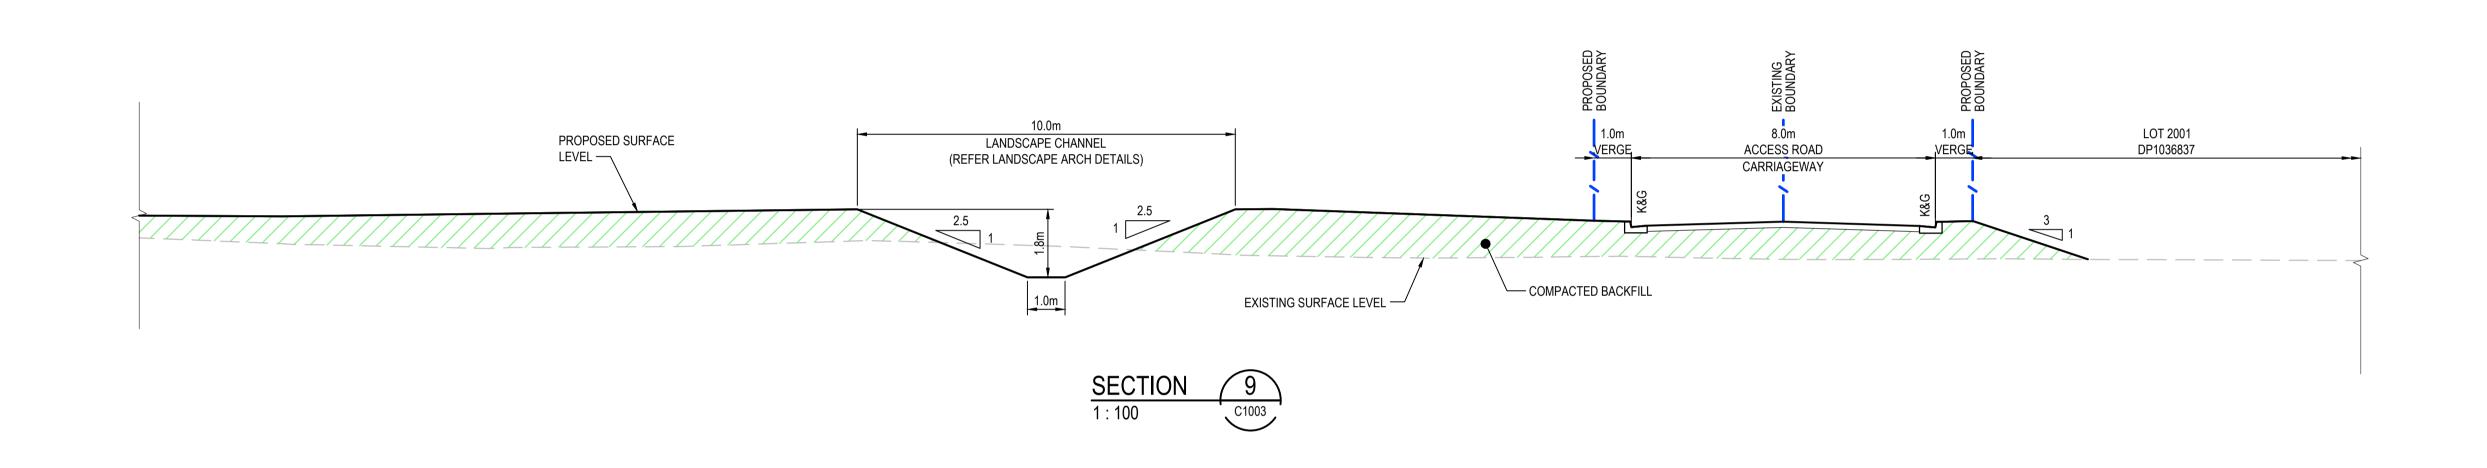


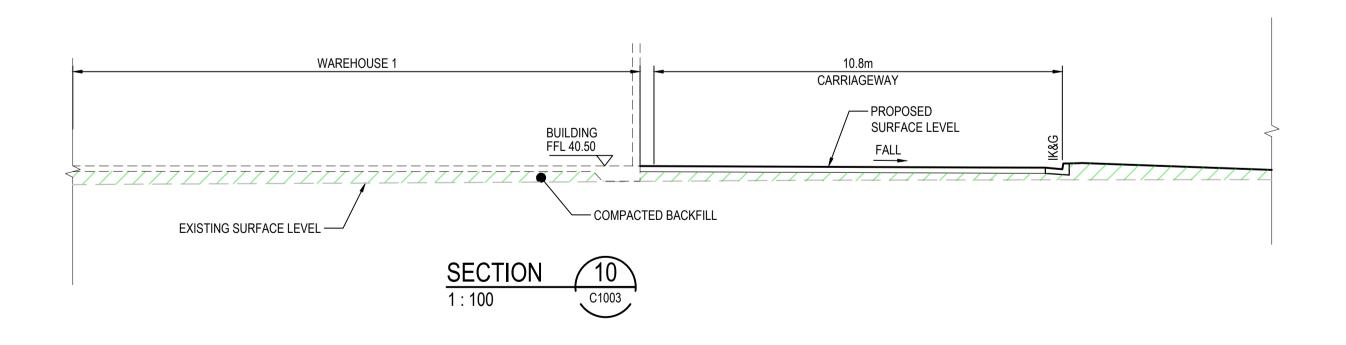

	SUED FOR DA		Bar Scales		Client	Scales	Scales 1 : 100	Drawn	NT	Project	Civil Engineers and Project Managers Level 7, 153 Walker Street	
	SUED FOR DA	21-04-23		THIS DRAWING CANNOT BE COPIED OR REPRODUCED IN	GibbGroup.			Designed	00.0.70	805 MAMRE ROAD	North Sydney	
H RE-ISSU	SUED FOR DA	02-03-23							QD & TS	KEMPS CREEK	NSW 2060	
G RE-ISSU	SUED FOR DA	02-02-23	0 2 4 6 8 10m			Grid	GDA 2020	Checked	MG		P 02 9439 1777 E info@atl.net.au www.atl.net.au ABN 96 130 882 405	
F RE-ISSU	SUED FOR DA	22-12-22		ANY FORM OR USED FOR ANY		Height	Height	Approved		7		
E RE-ISSU	SUED FOR DA	10-11-22		OTHER PURPOSE OTHER THAN THAT ORIGINALLY INTENDED WITHOUT THE WRITTEN PERMISSION OF AT&L		Height Datum AHD	AHD			Title		
D RE-ISSU	SUED FOR DA	04-11-22)20		Status FOR ARREDOVAL	
C RE-ISSU	SUED FOR DA	09-08-22					PA OF	14000		TYPICAL SITE	FOR APPROVAL A	
B RE-ISSU	SUED FOR DA	08-08-22					V GL	DA202		SECTIONS	NOT FOR CONSTRUCTION Project - Drawing No. Iss	
ssue	Description	Date								SHEET 3	21-894-C1009	
	100mm on Origin	nal		•		.				F:\21-894	805 Mamre Rd\6.0 Drgs\Civil\Final\21-894-C1009.dwg	

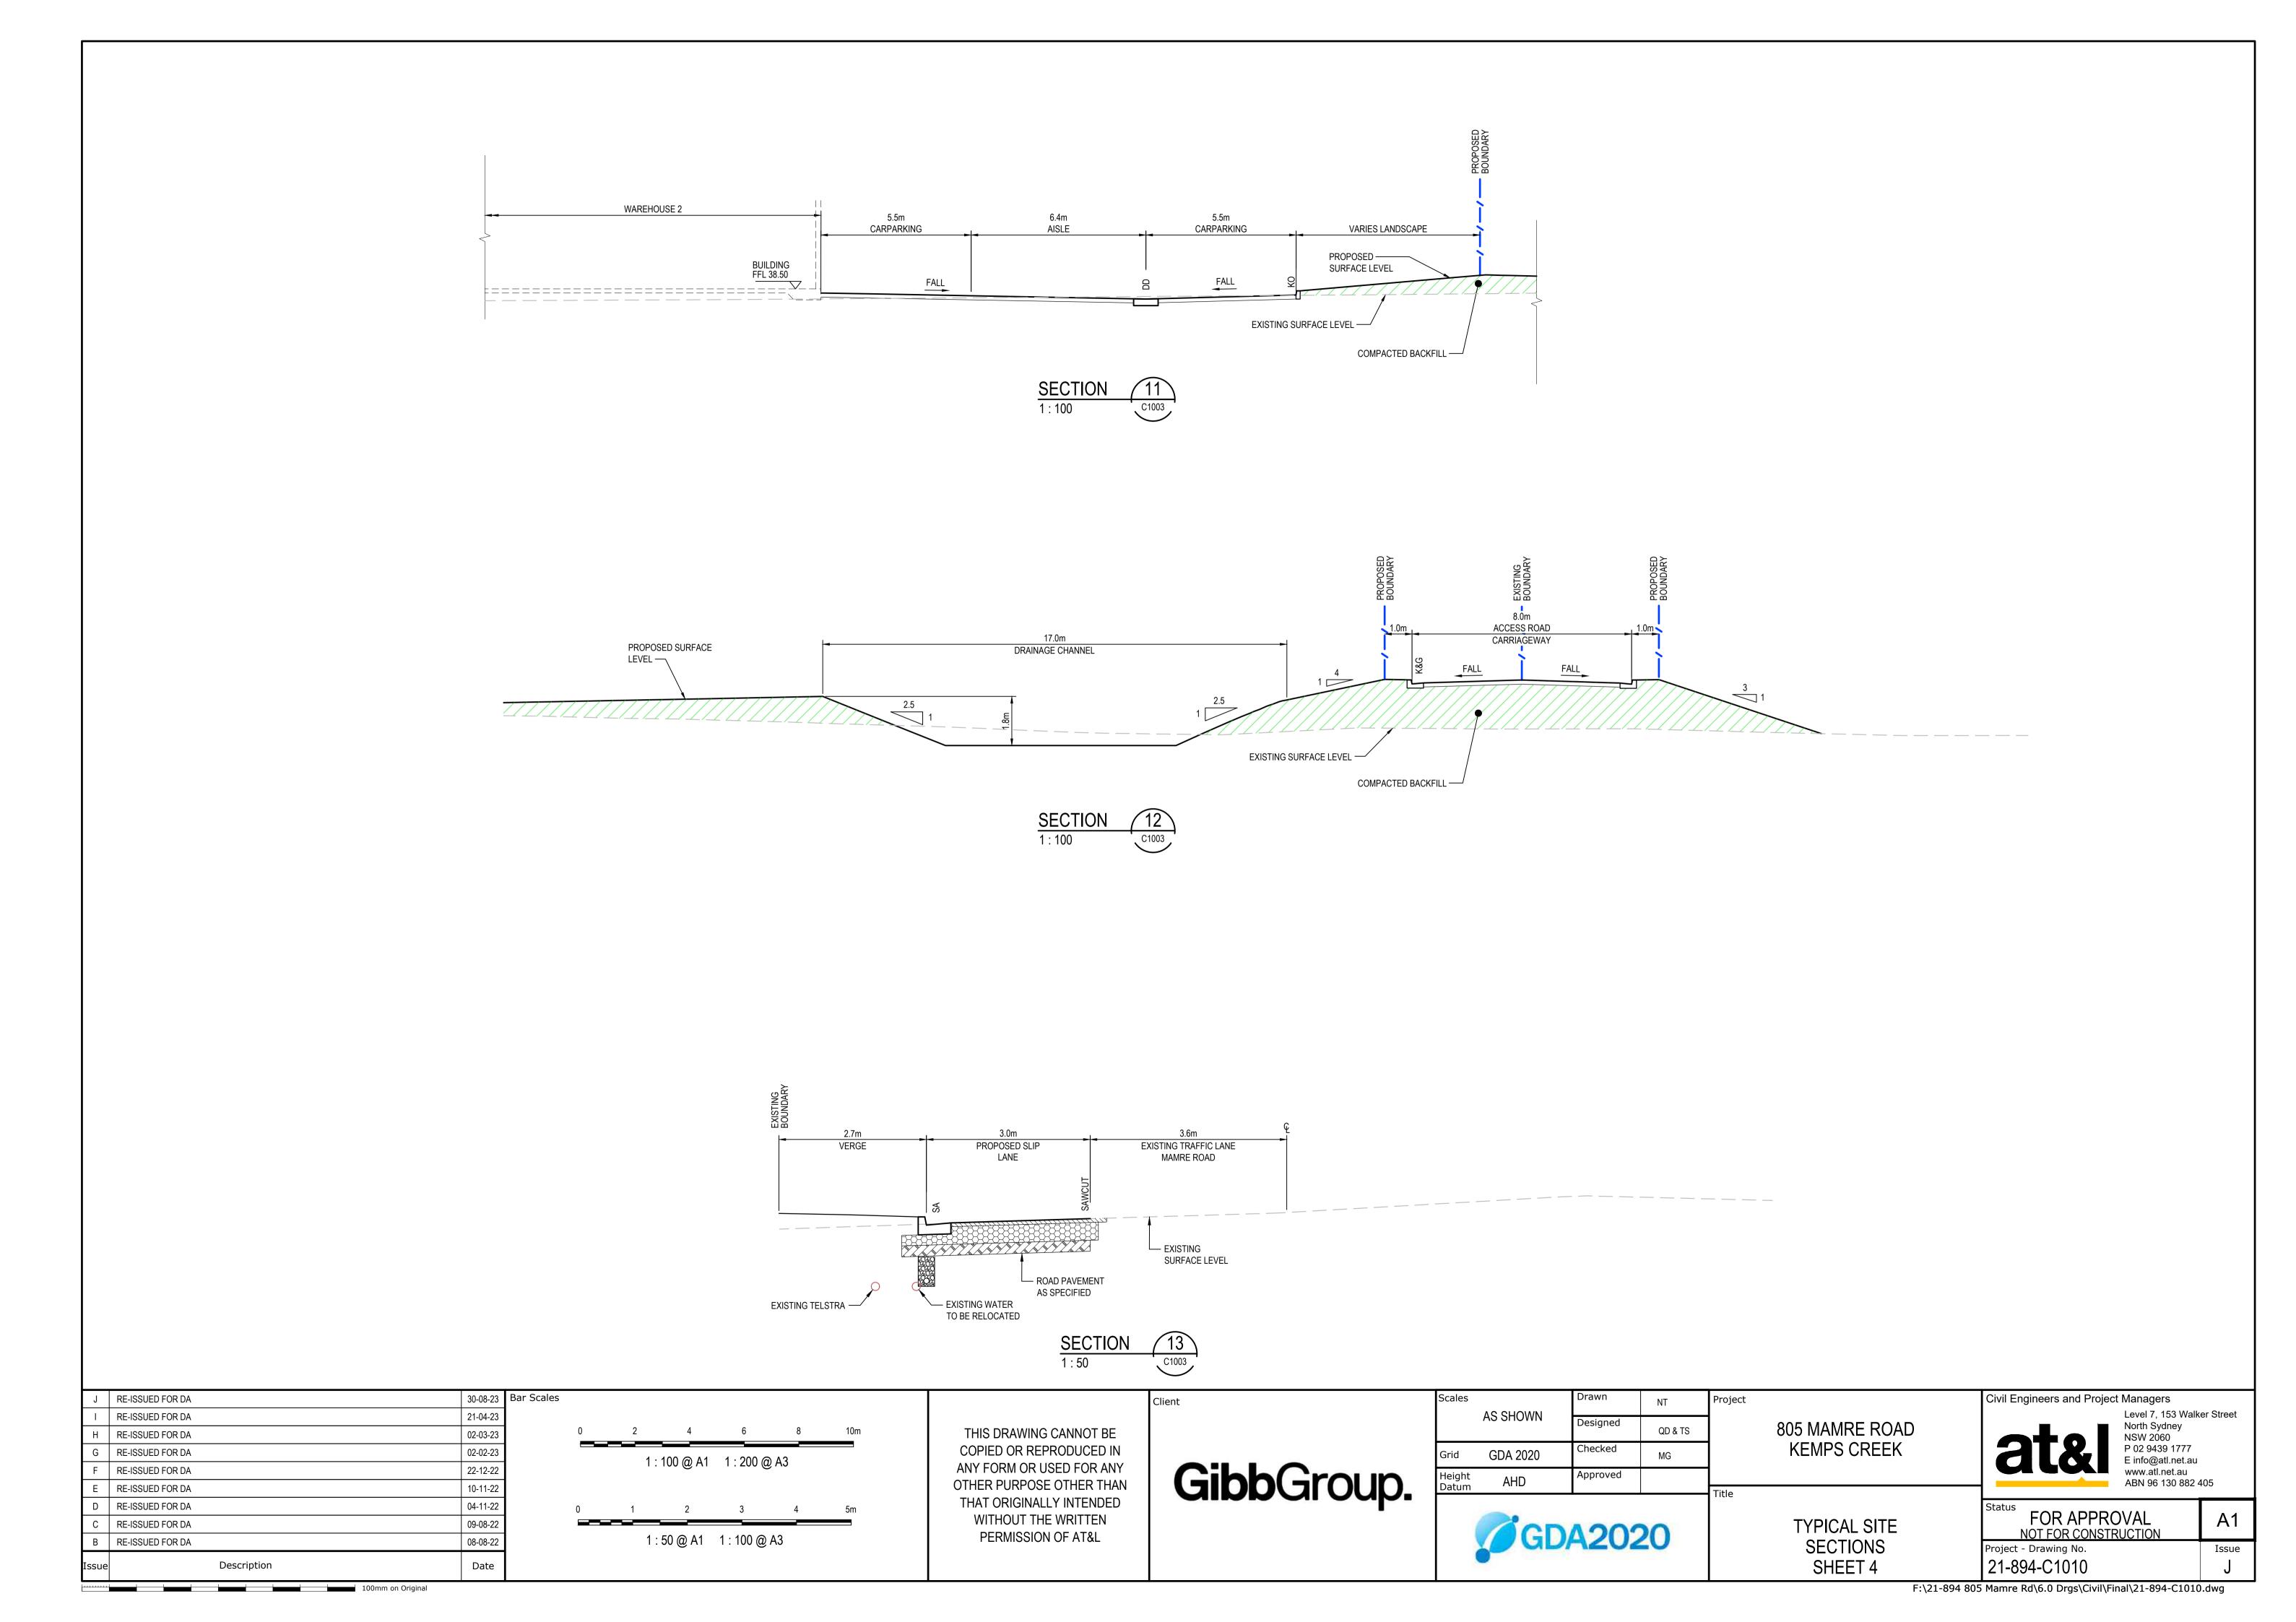


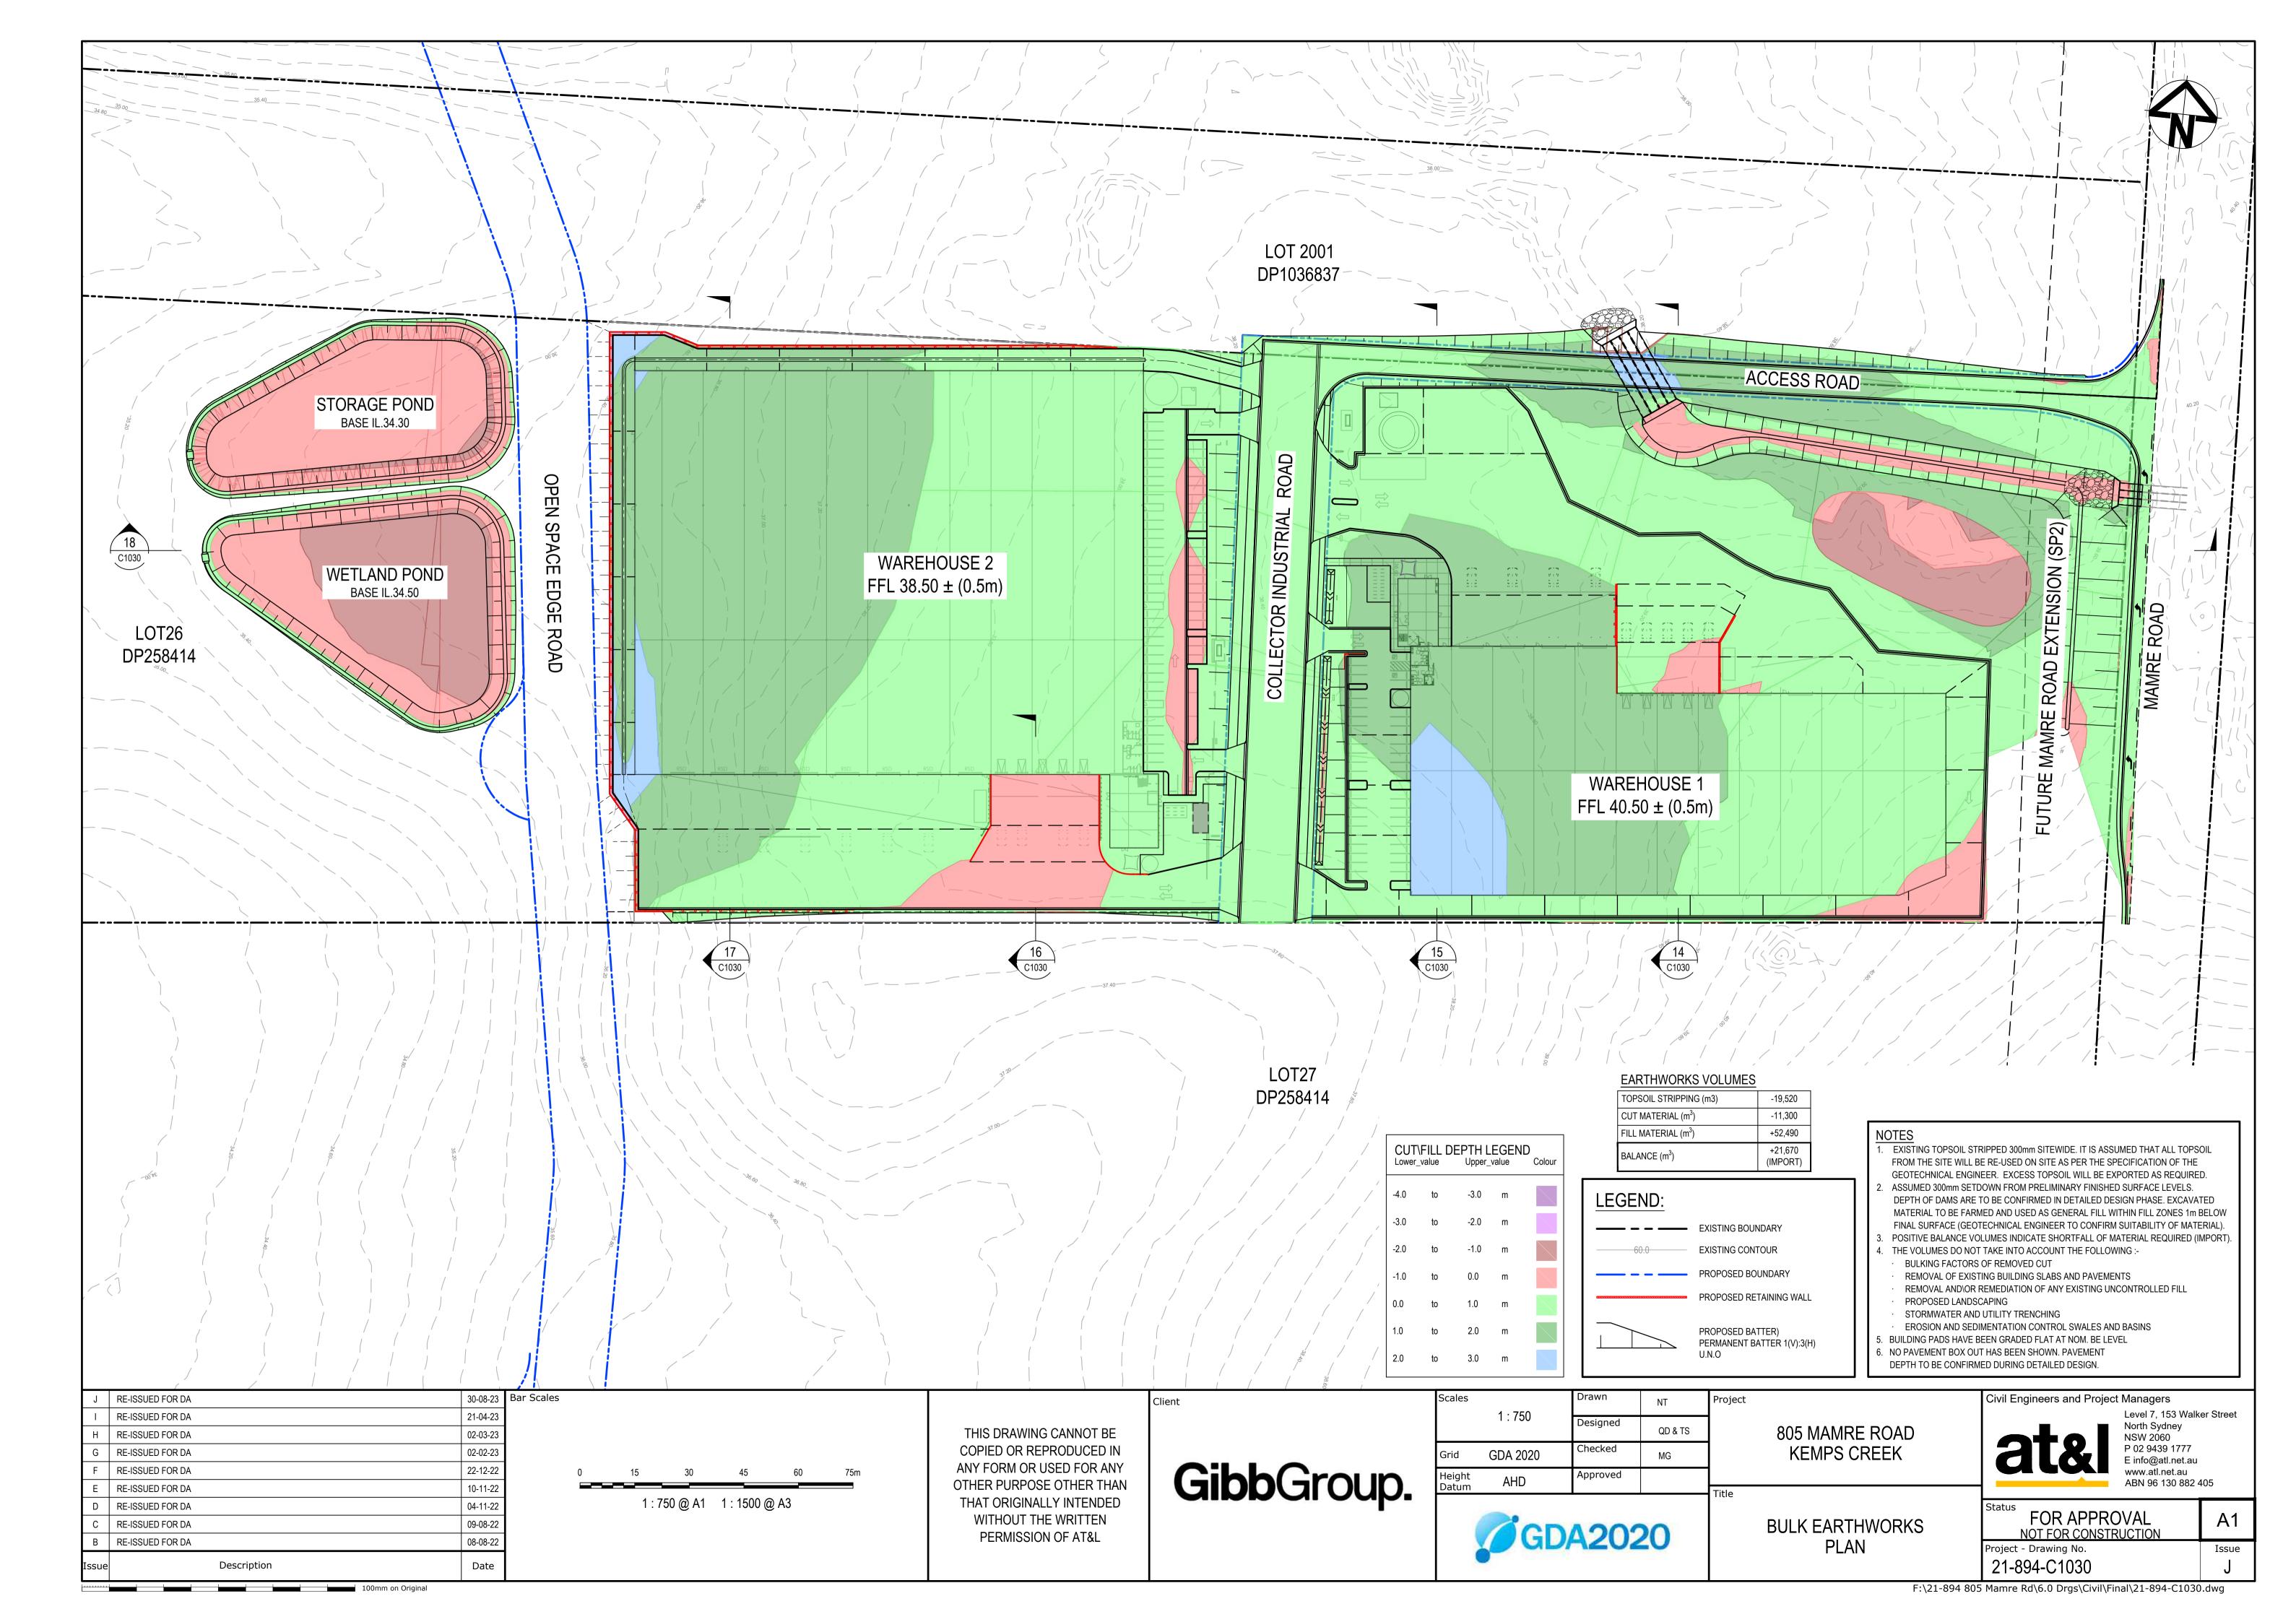


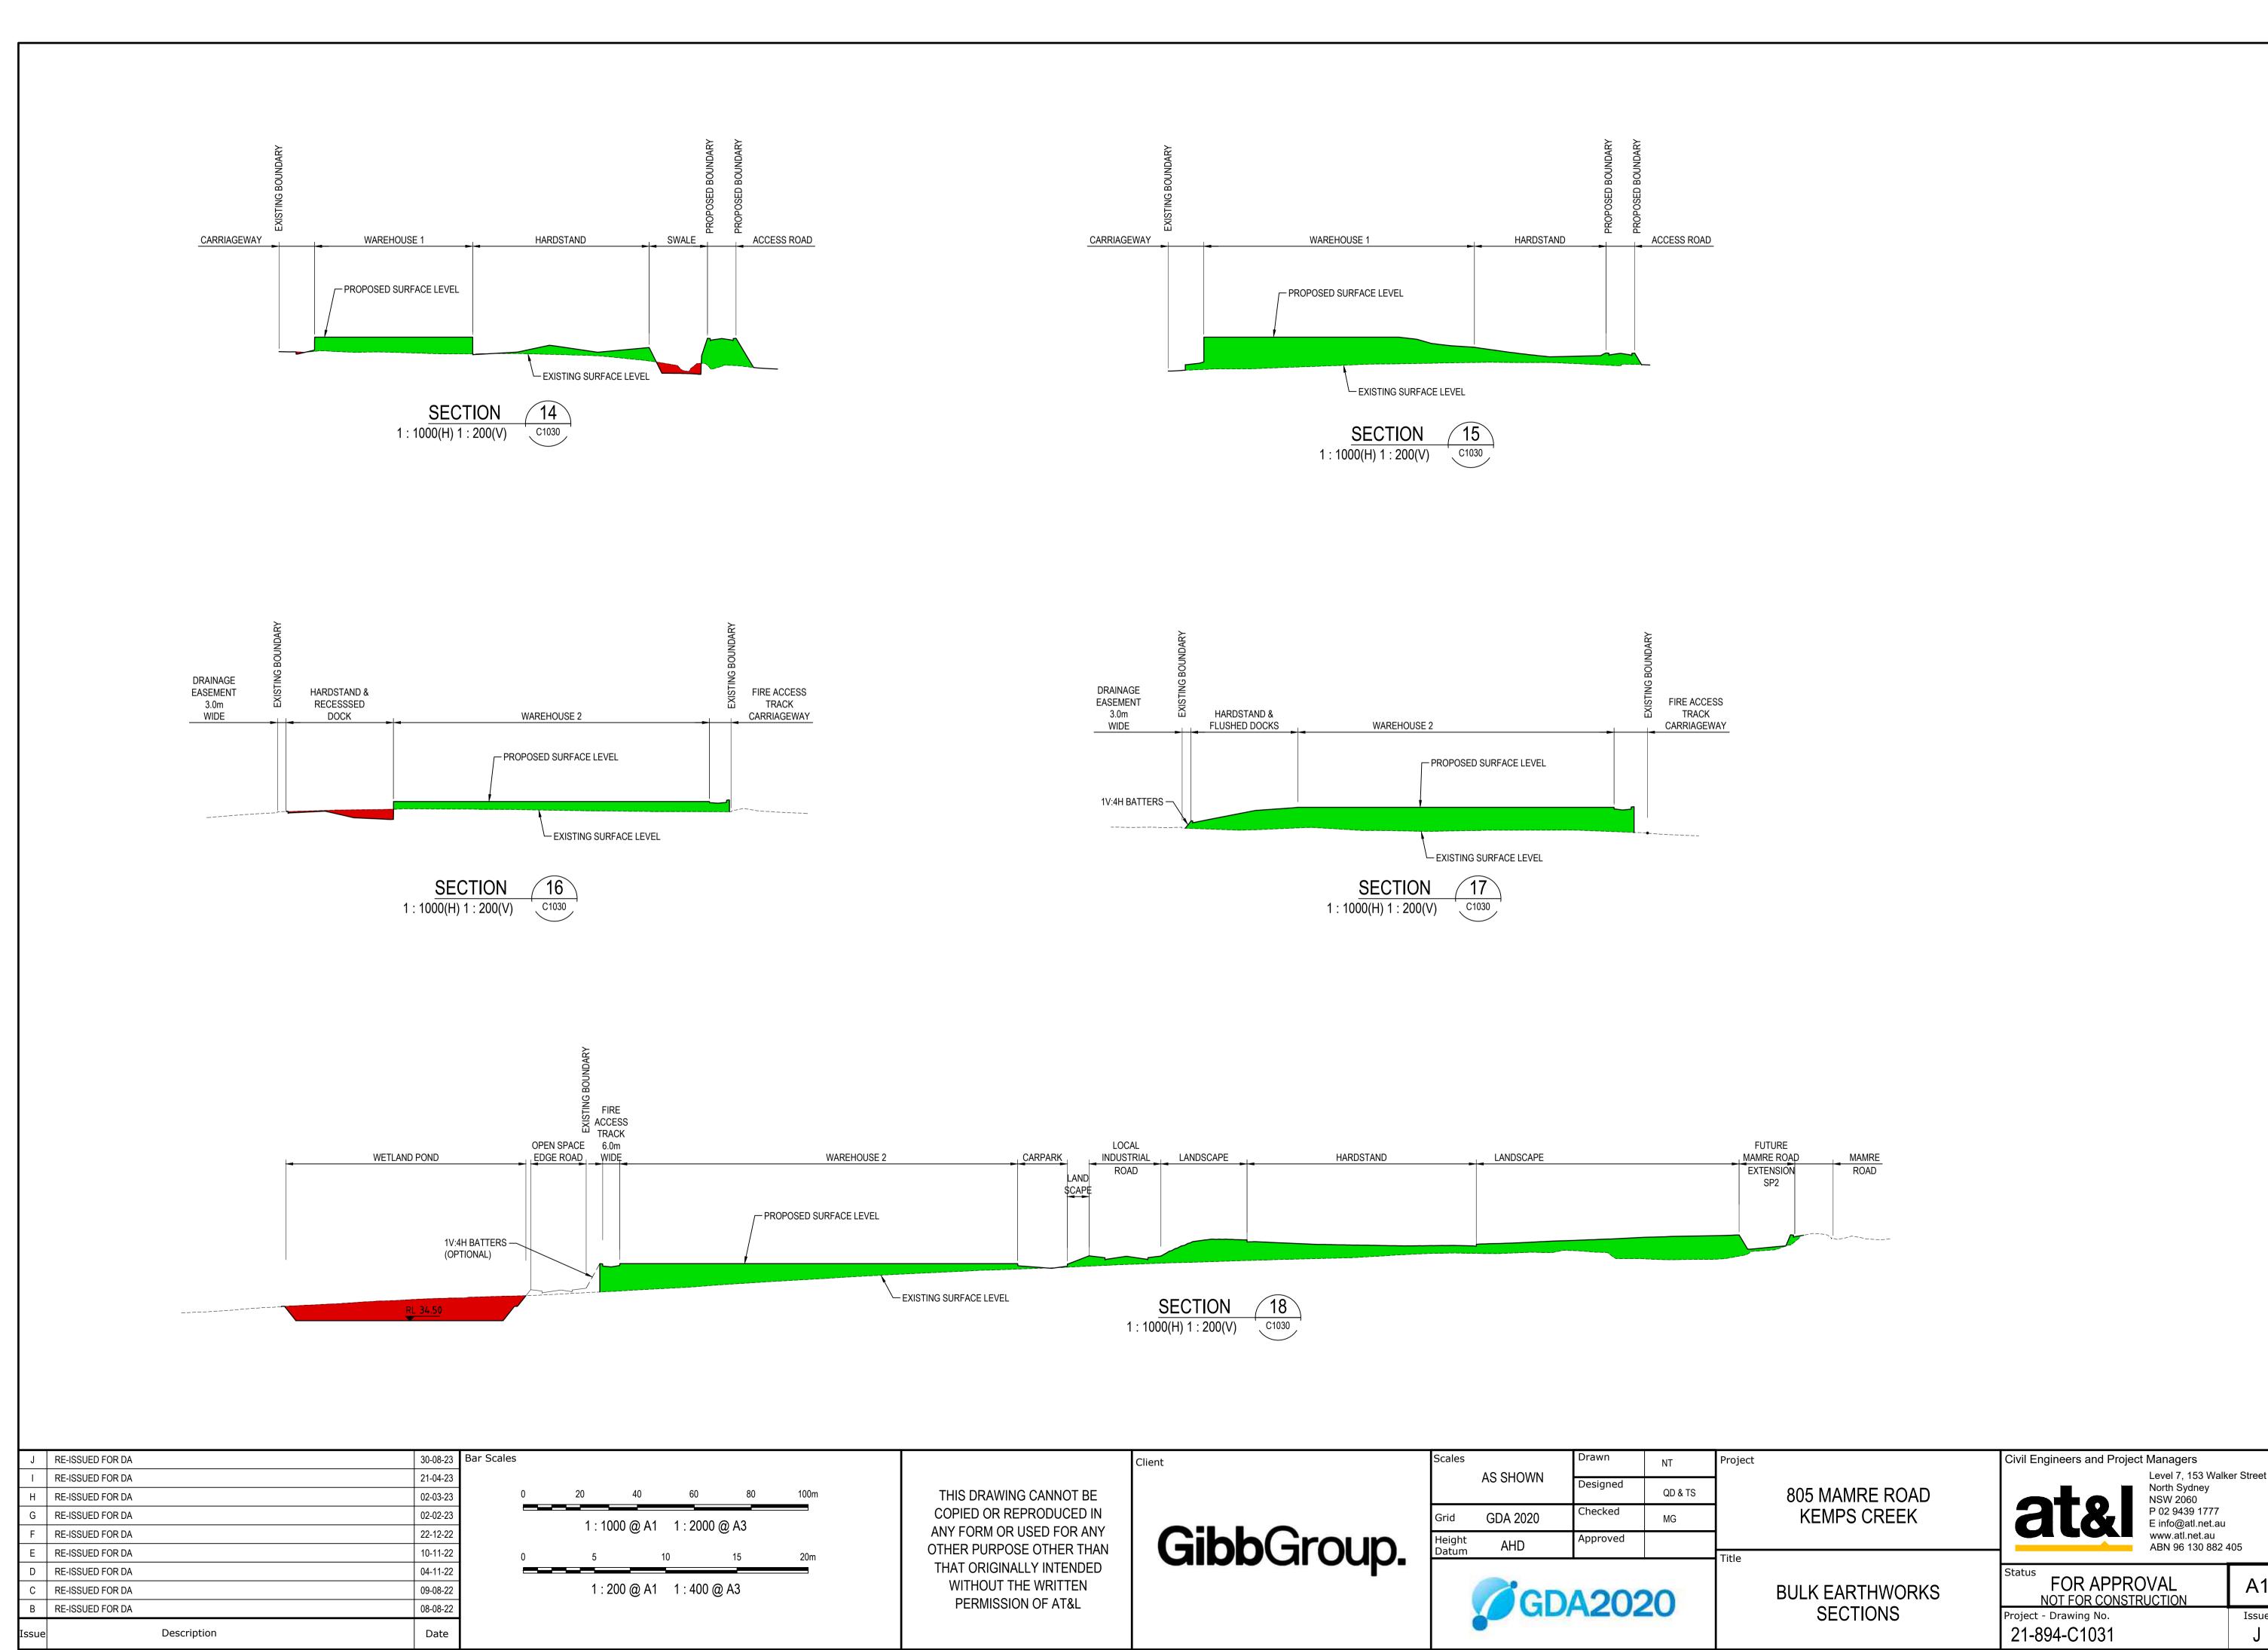


A1


Issue

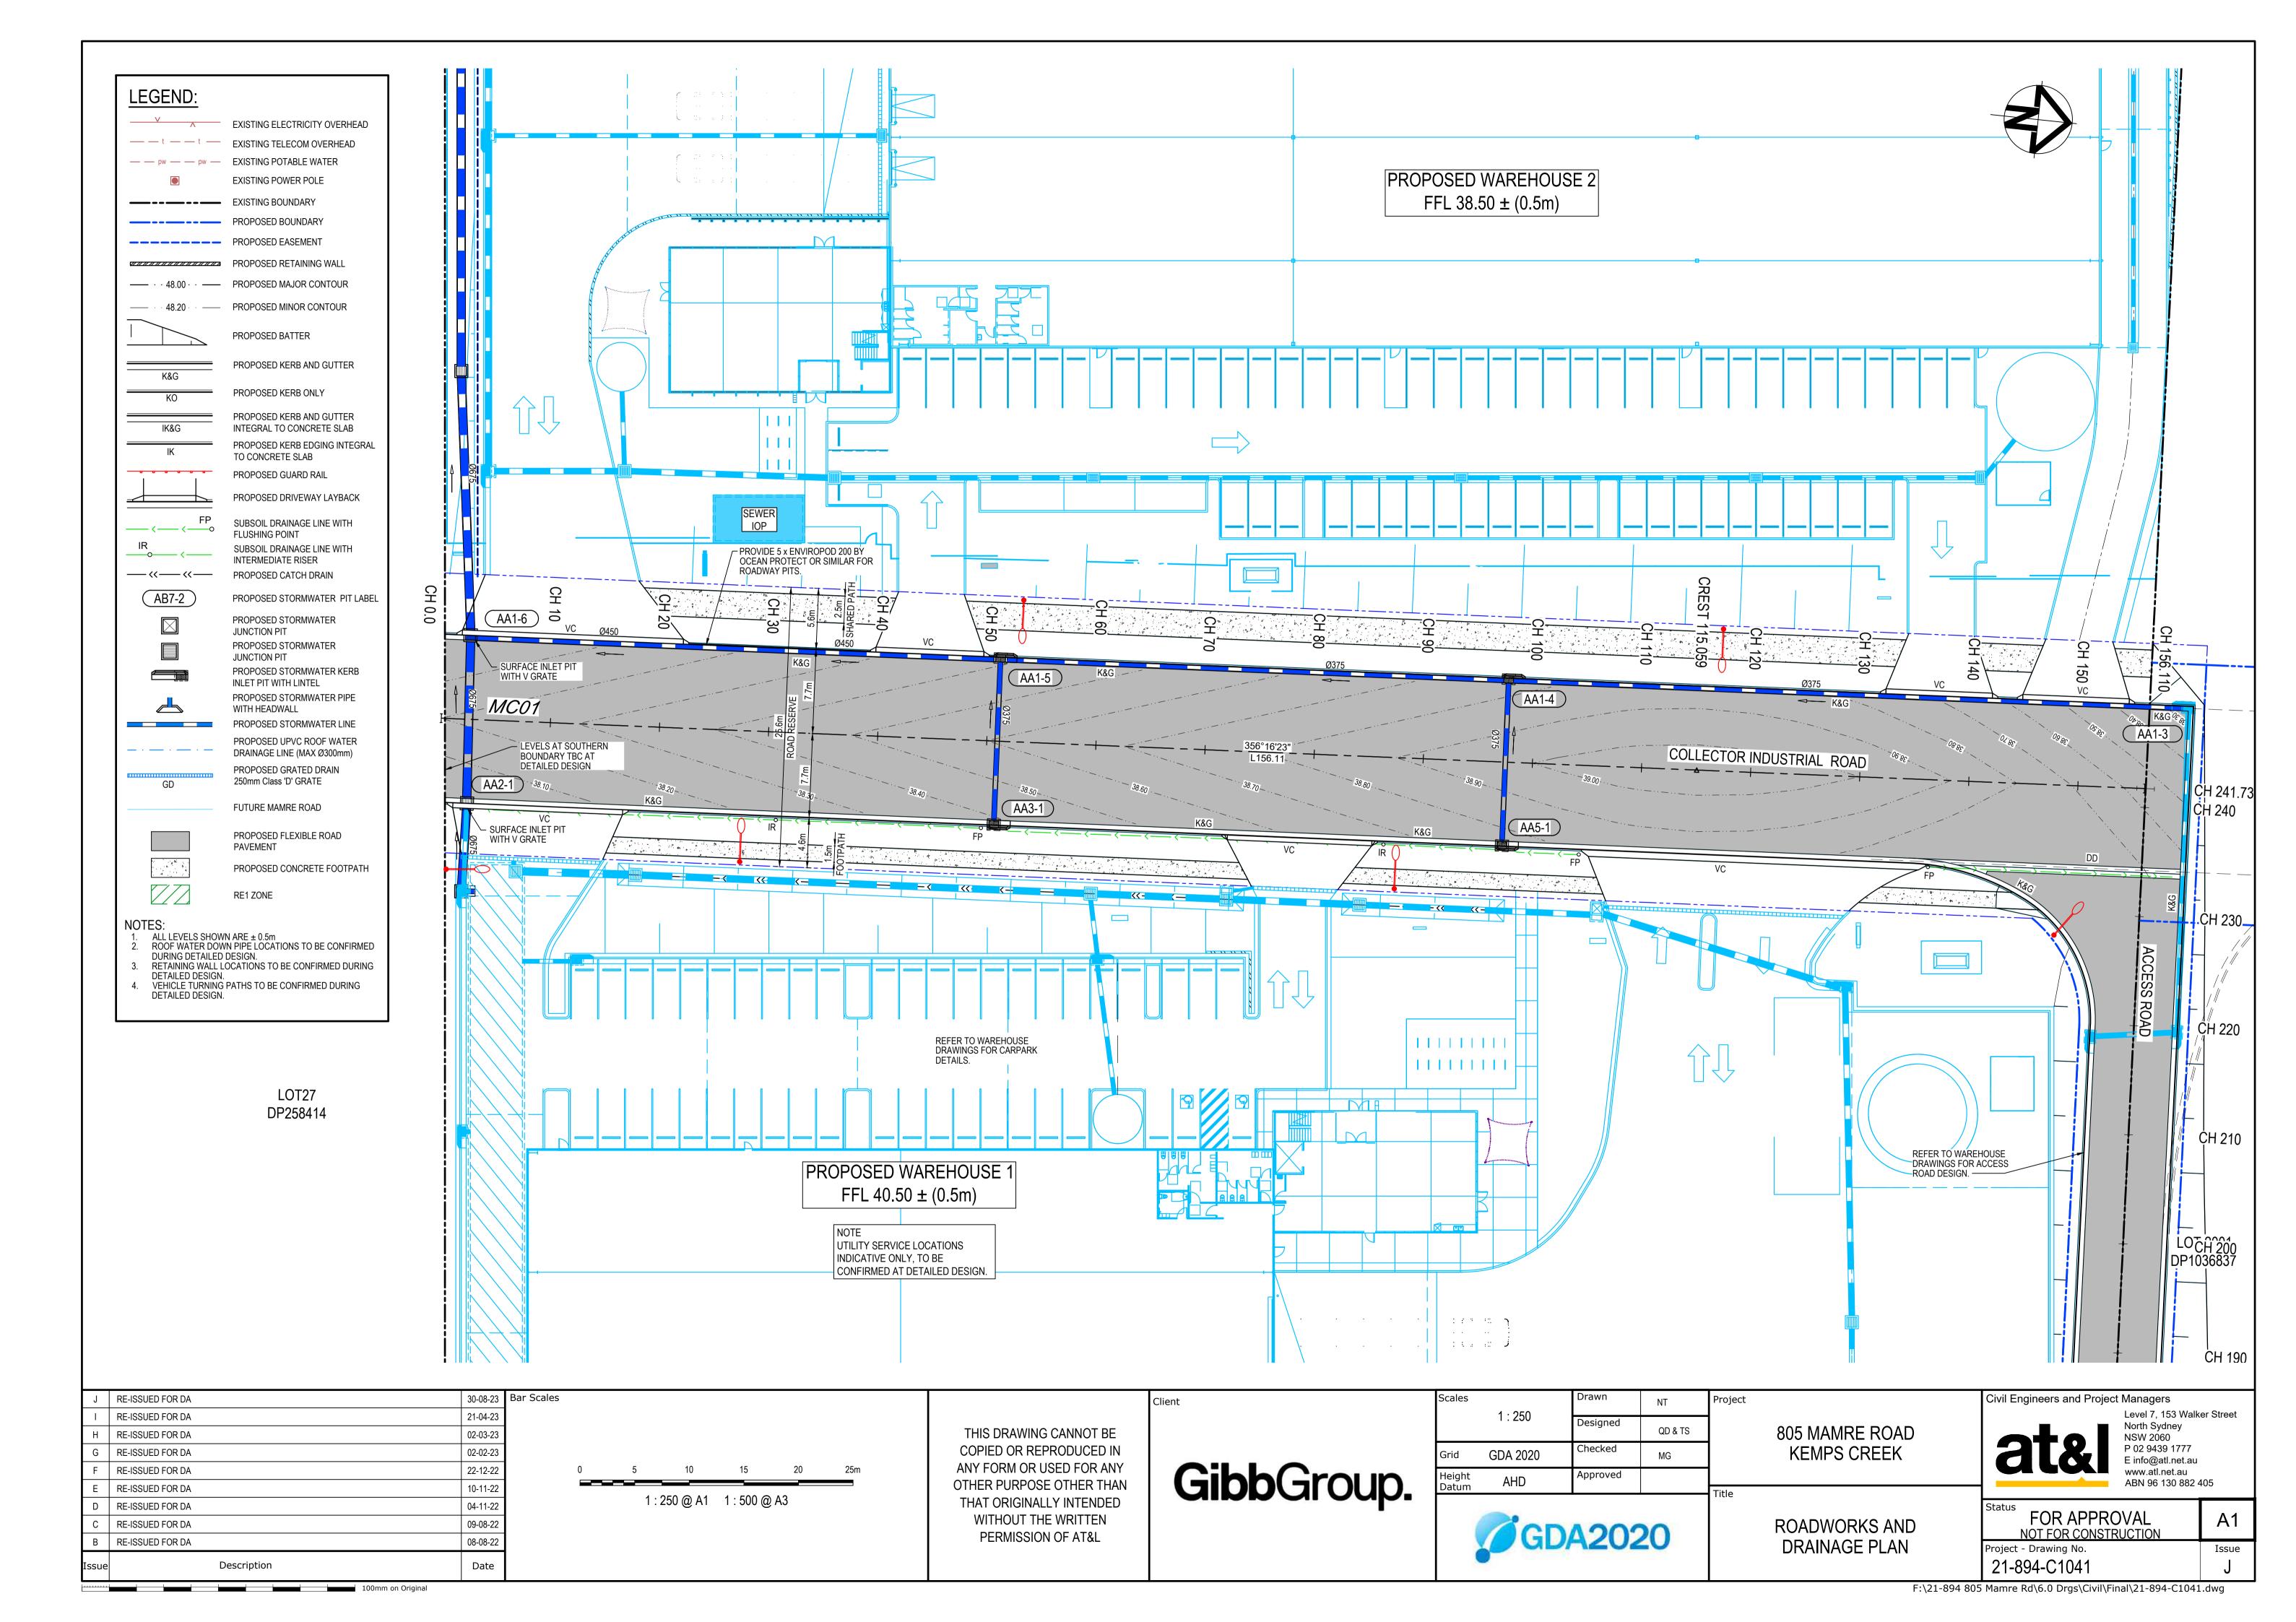

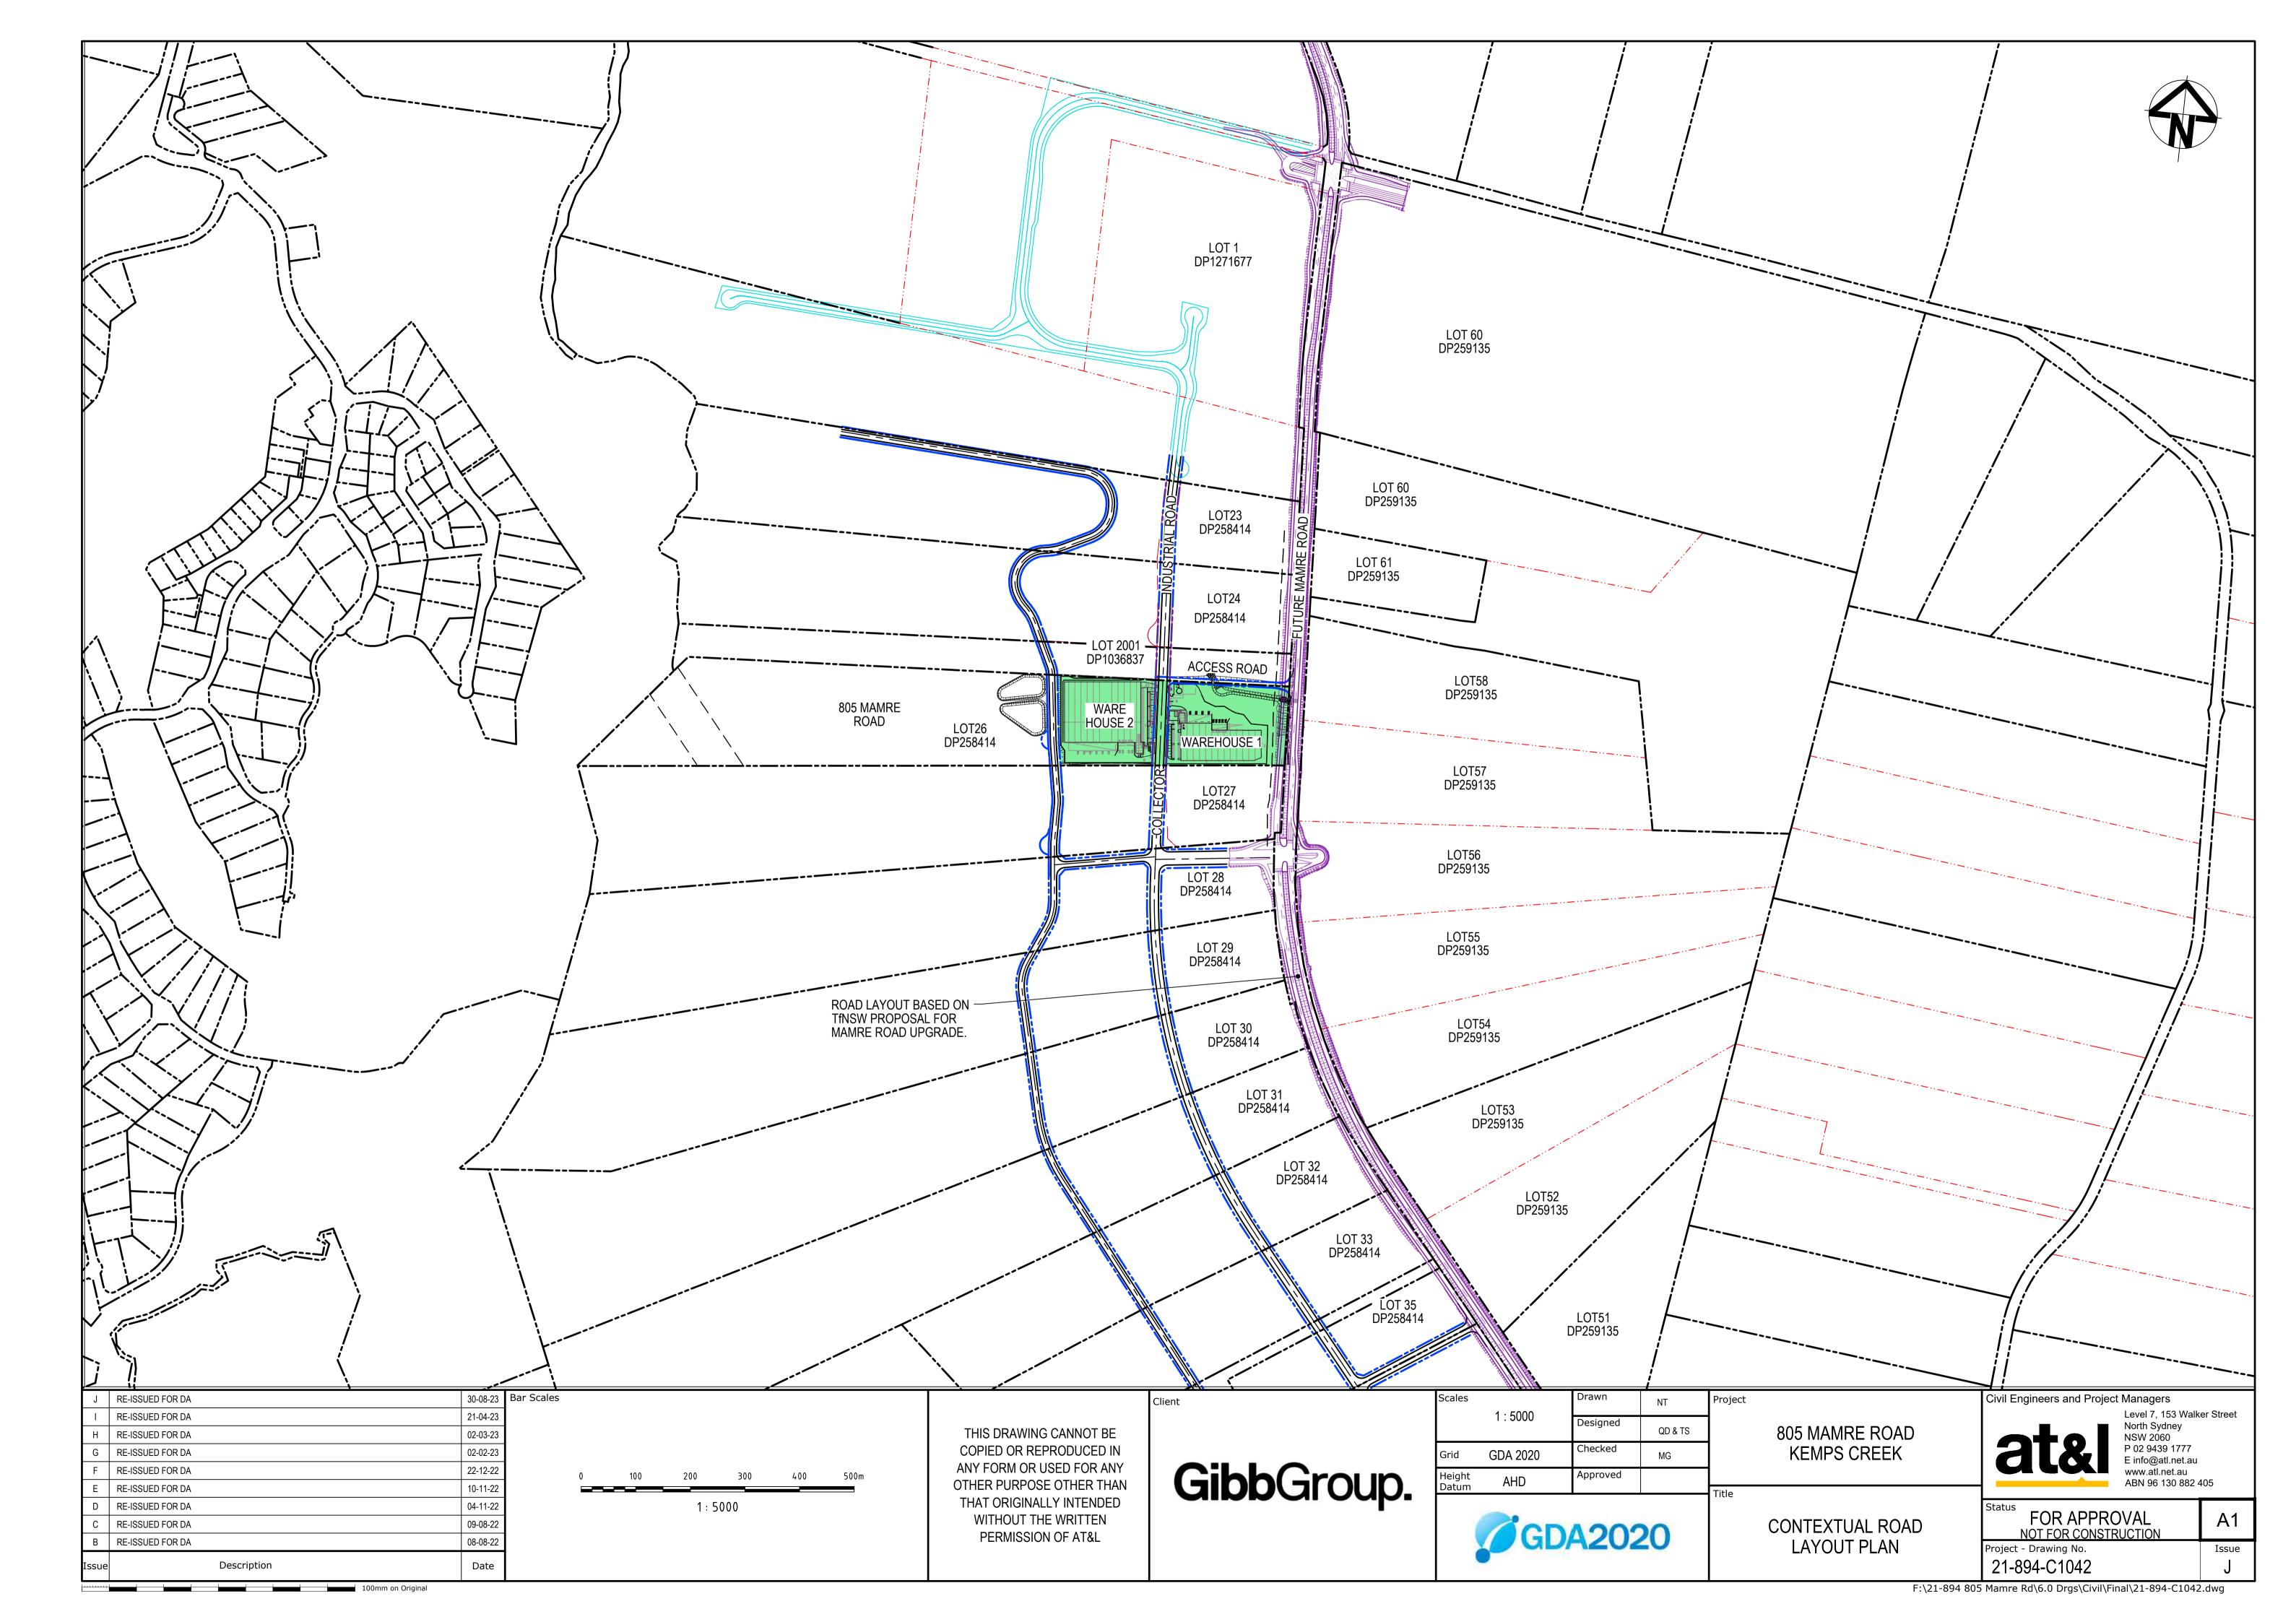

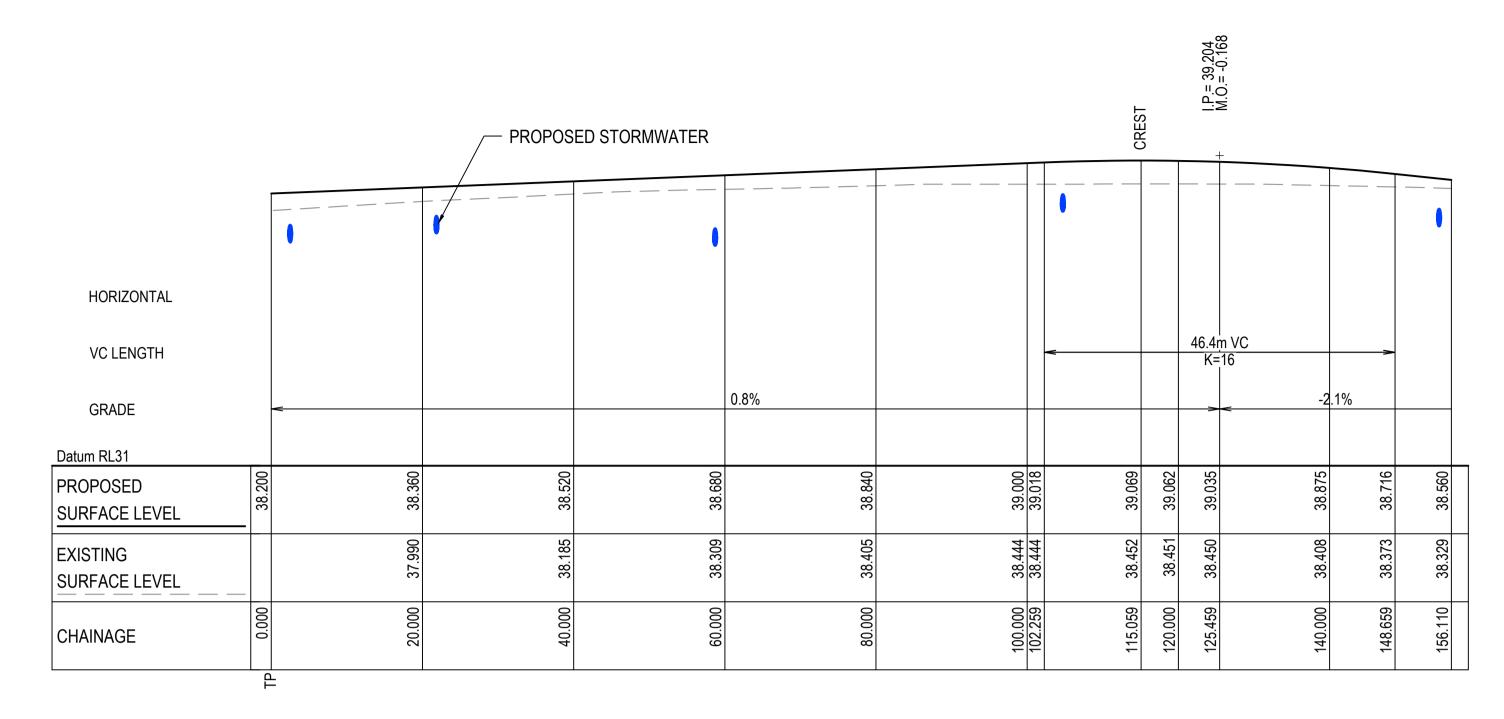

COLLECTOR INDUSTRIAL ROAD (MC01) LONGITUDINAL SECTION

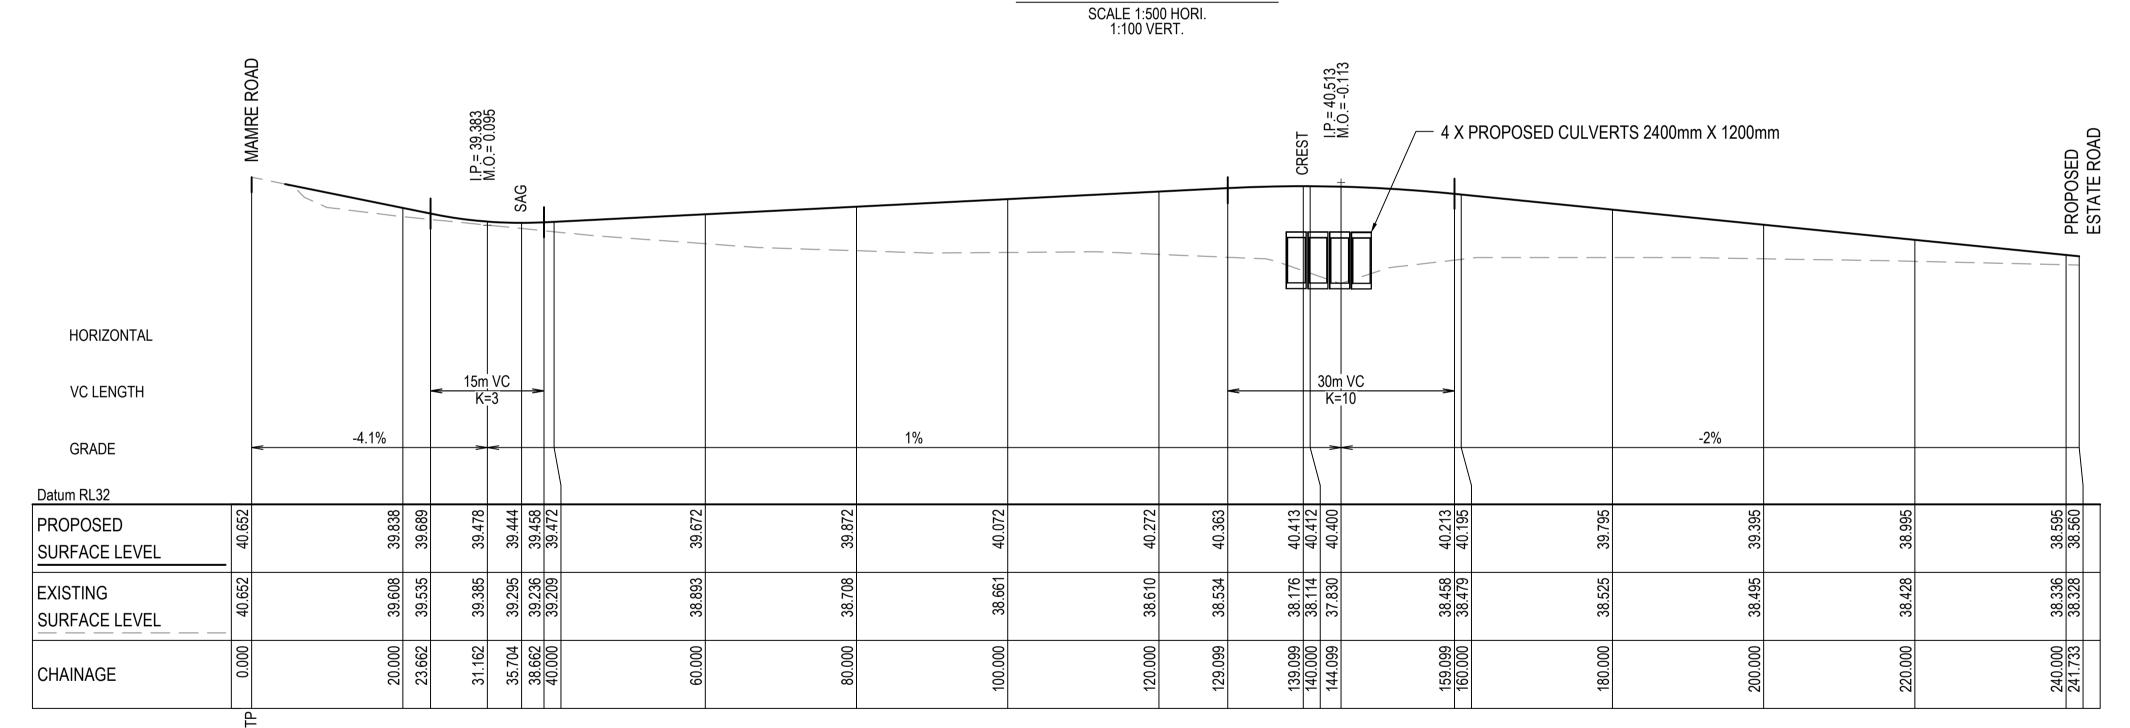

ACCESS ROAD (MC03) LONGITUDINAL SECTION SCALE 1:500 HORI. 1:100 VERT.

J	RE-ISSUED FOR DA	30-08-23	Bar Scales								Client
ı	RE-ISSUED FOR DA	21-04-23									
Н	RE-ISSUED FOR DA	02-03-23		0	10	20	30	40	50m	THIS DRAWING CANNOT BE	
G	RE-ISSUED FOR DA	02-02-23			4 /	-00 0 14	4 4000	2.40		COPIED OR REPRODUCED IN	
F	RE-ISSUED FOR DA	22-12-22			1:5	500 @ A1	1 : 1000 (2) A3		ANY FORM OR USED FOR ANY	1
Е	RE-ISSUED FOR DA	10-11-22								OTHER PURPOSE OTHER THAN	
D	RE-ISSUED FOR DA	04-11-22		0	2	4	6	8	10m	THAT ORIGINALLY INTENDED	
С	RE-ISSUED FOR DA	09-08-22								WITHOUT THE WRITTEN	
В	RE-ISSUED FOR DA	08-08-22			1:	100 @ A1	1 : 200 @) A3		PERMISSION OF AT&L	
ssue	Description	Date									

100mm on Original

		AGGIOWN					
	Grid	GDA 2020					
b Group	Height Datum	AHD					
L Cil Capi							

Scales	VC CHO/WN	Drawn	NT	Project
	AS SHOWN	Designed	QD & TS	
Grid	GDA 2020	Checked	MG	
Height	AHD	Approved		
Datum				T:Ha

805 MAMRE ROAD KEMPS CREEK


Level 7, 153 Walker Street


Civil Engineers and Project Managers


North Sydney
NSW 2060
P 02 9439 1777
E info@atl.net.au
www.atl.net.au ABN 96 130 882 405 **A**1

FOR APPROVAL NOT FOR CONSTRUCTION Project - Drawing No. 21-894-C1051


Issue

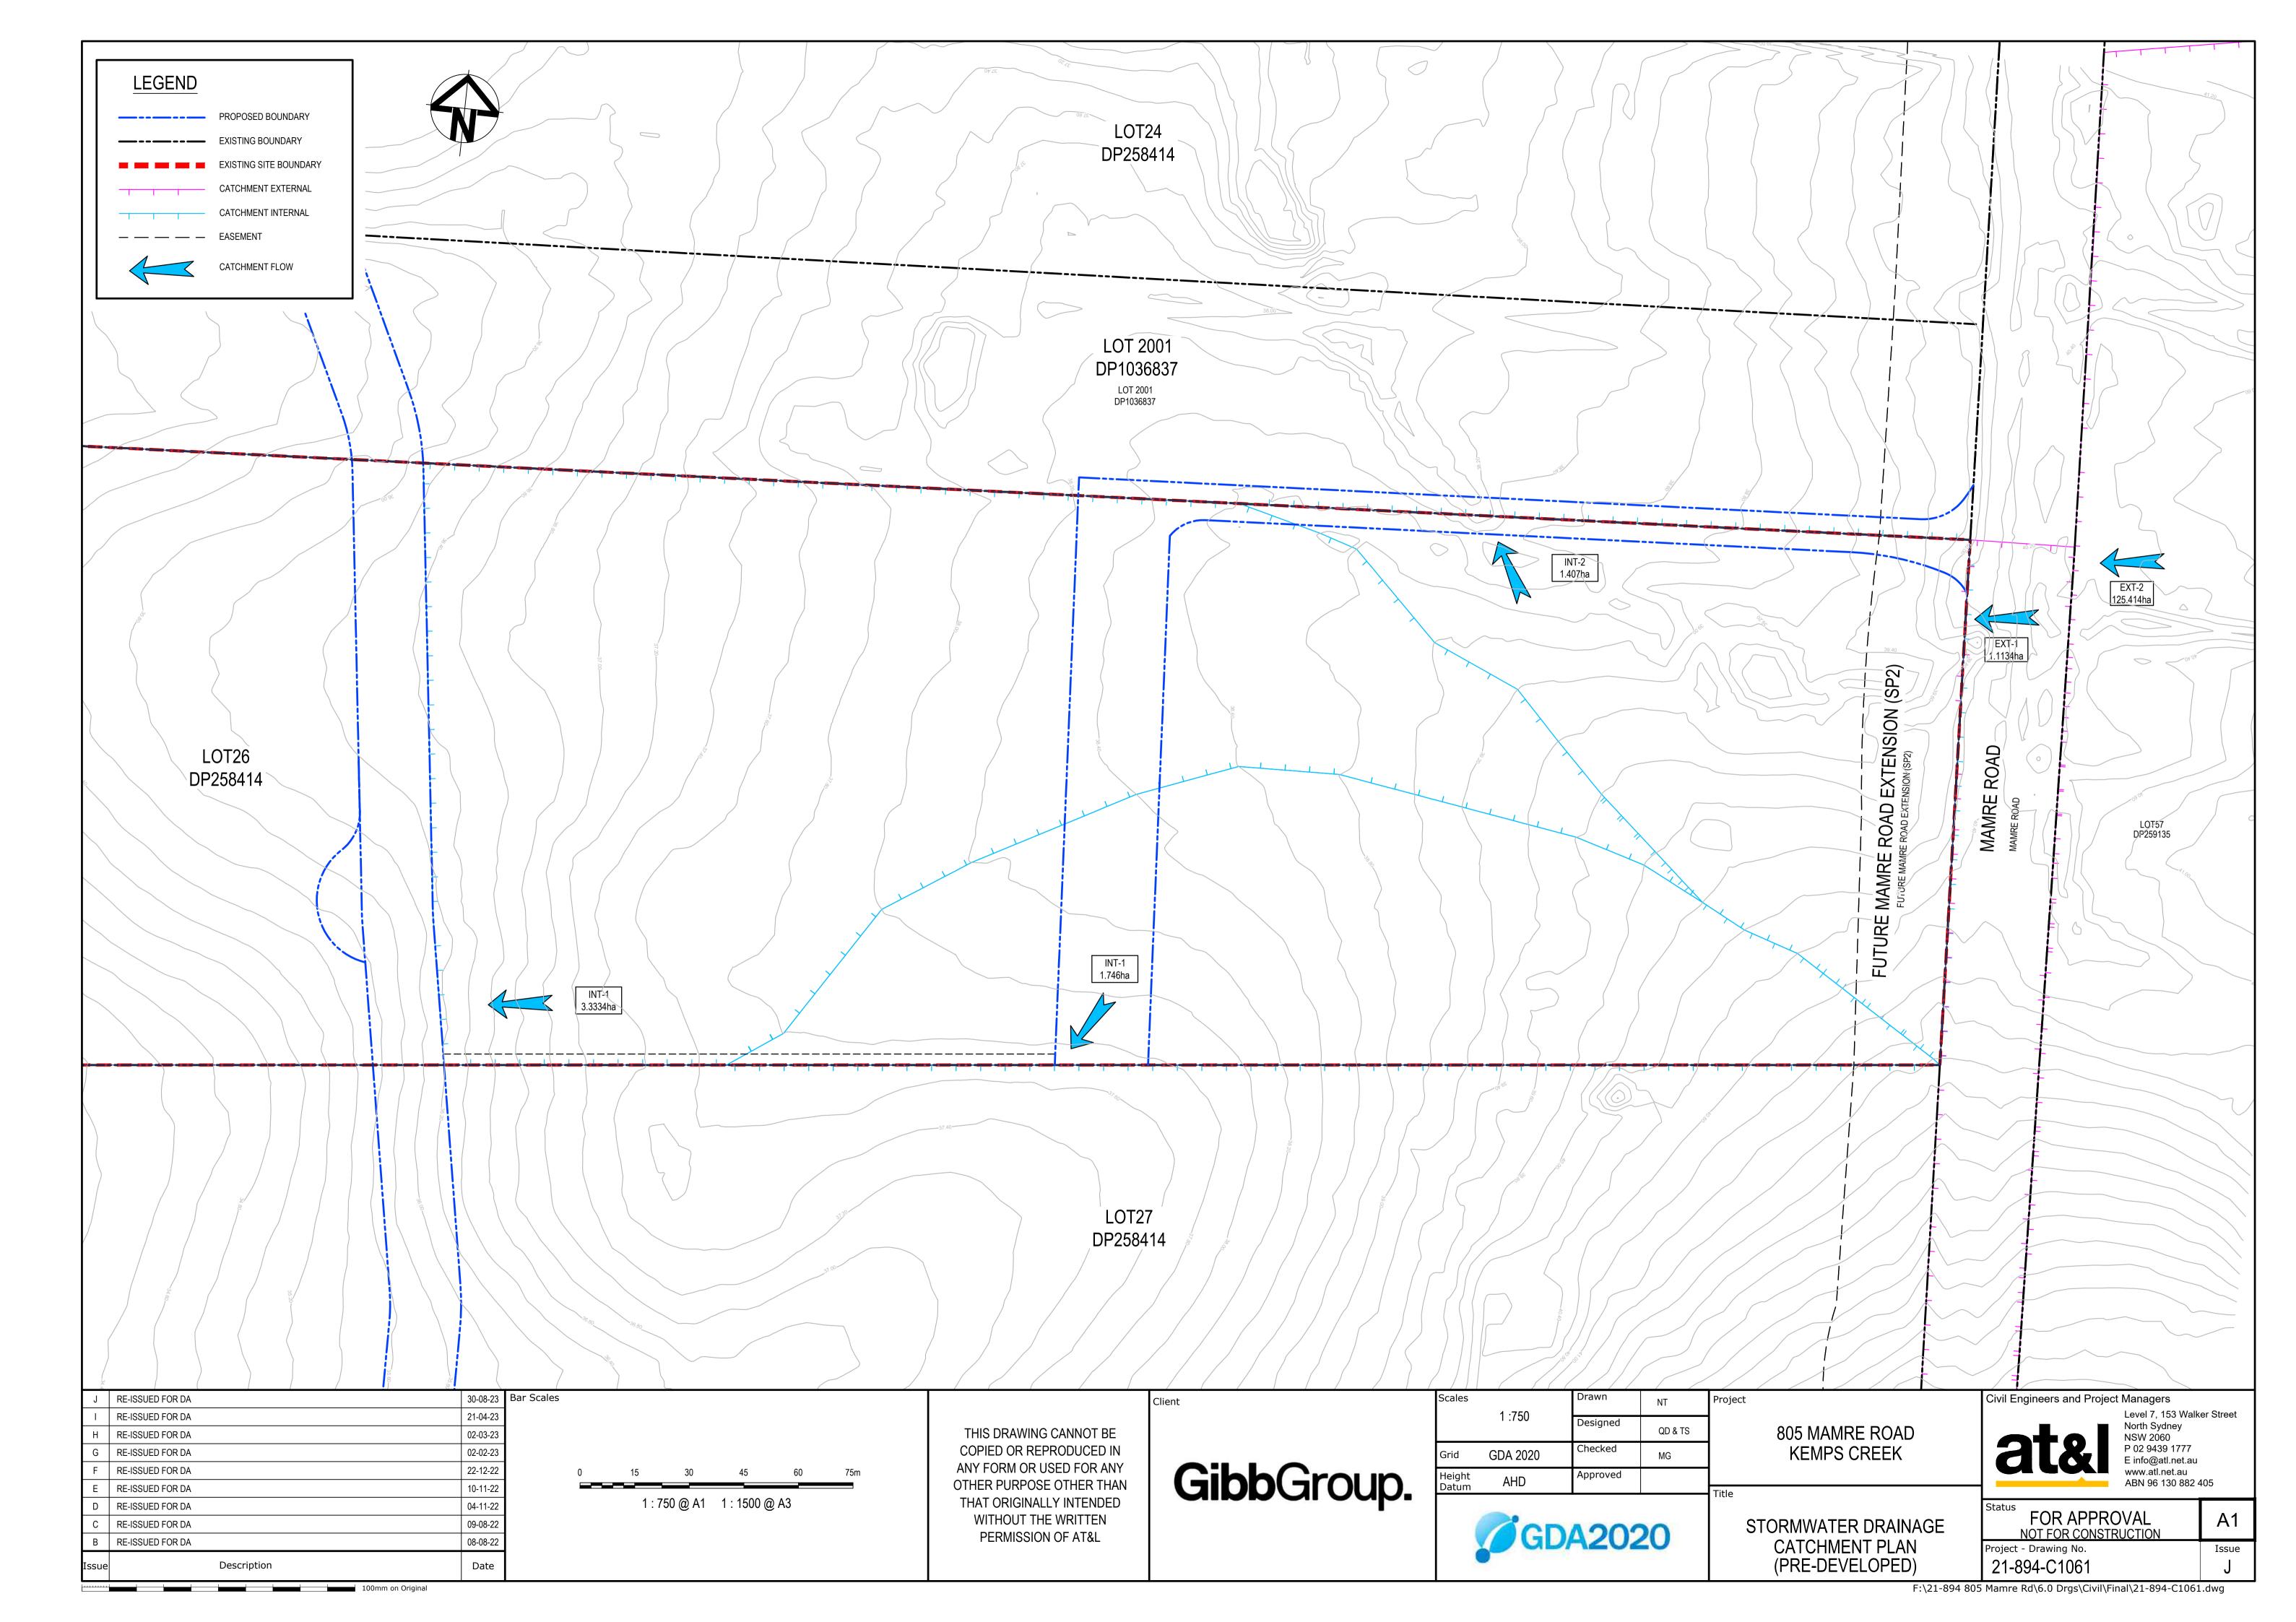

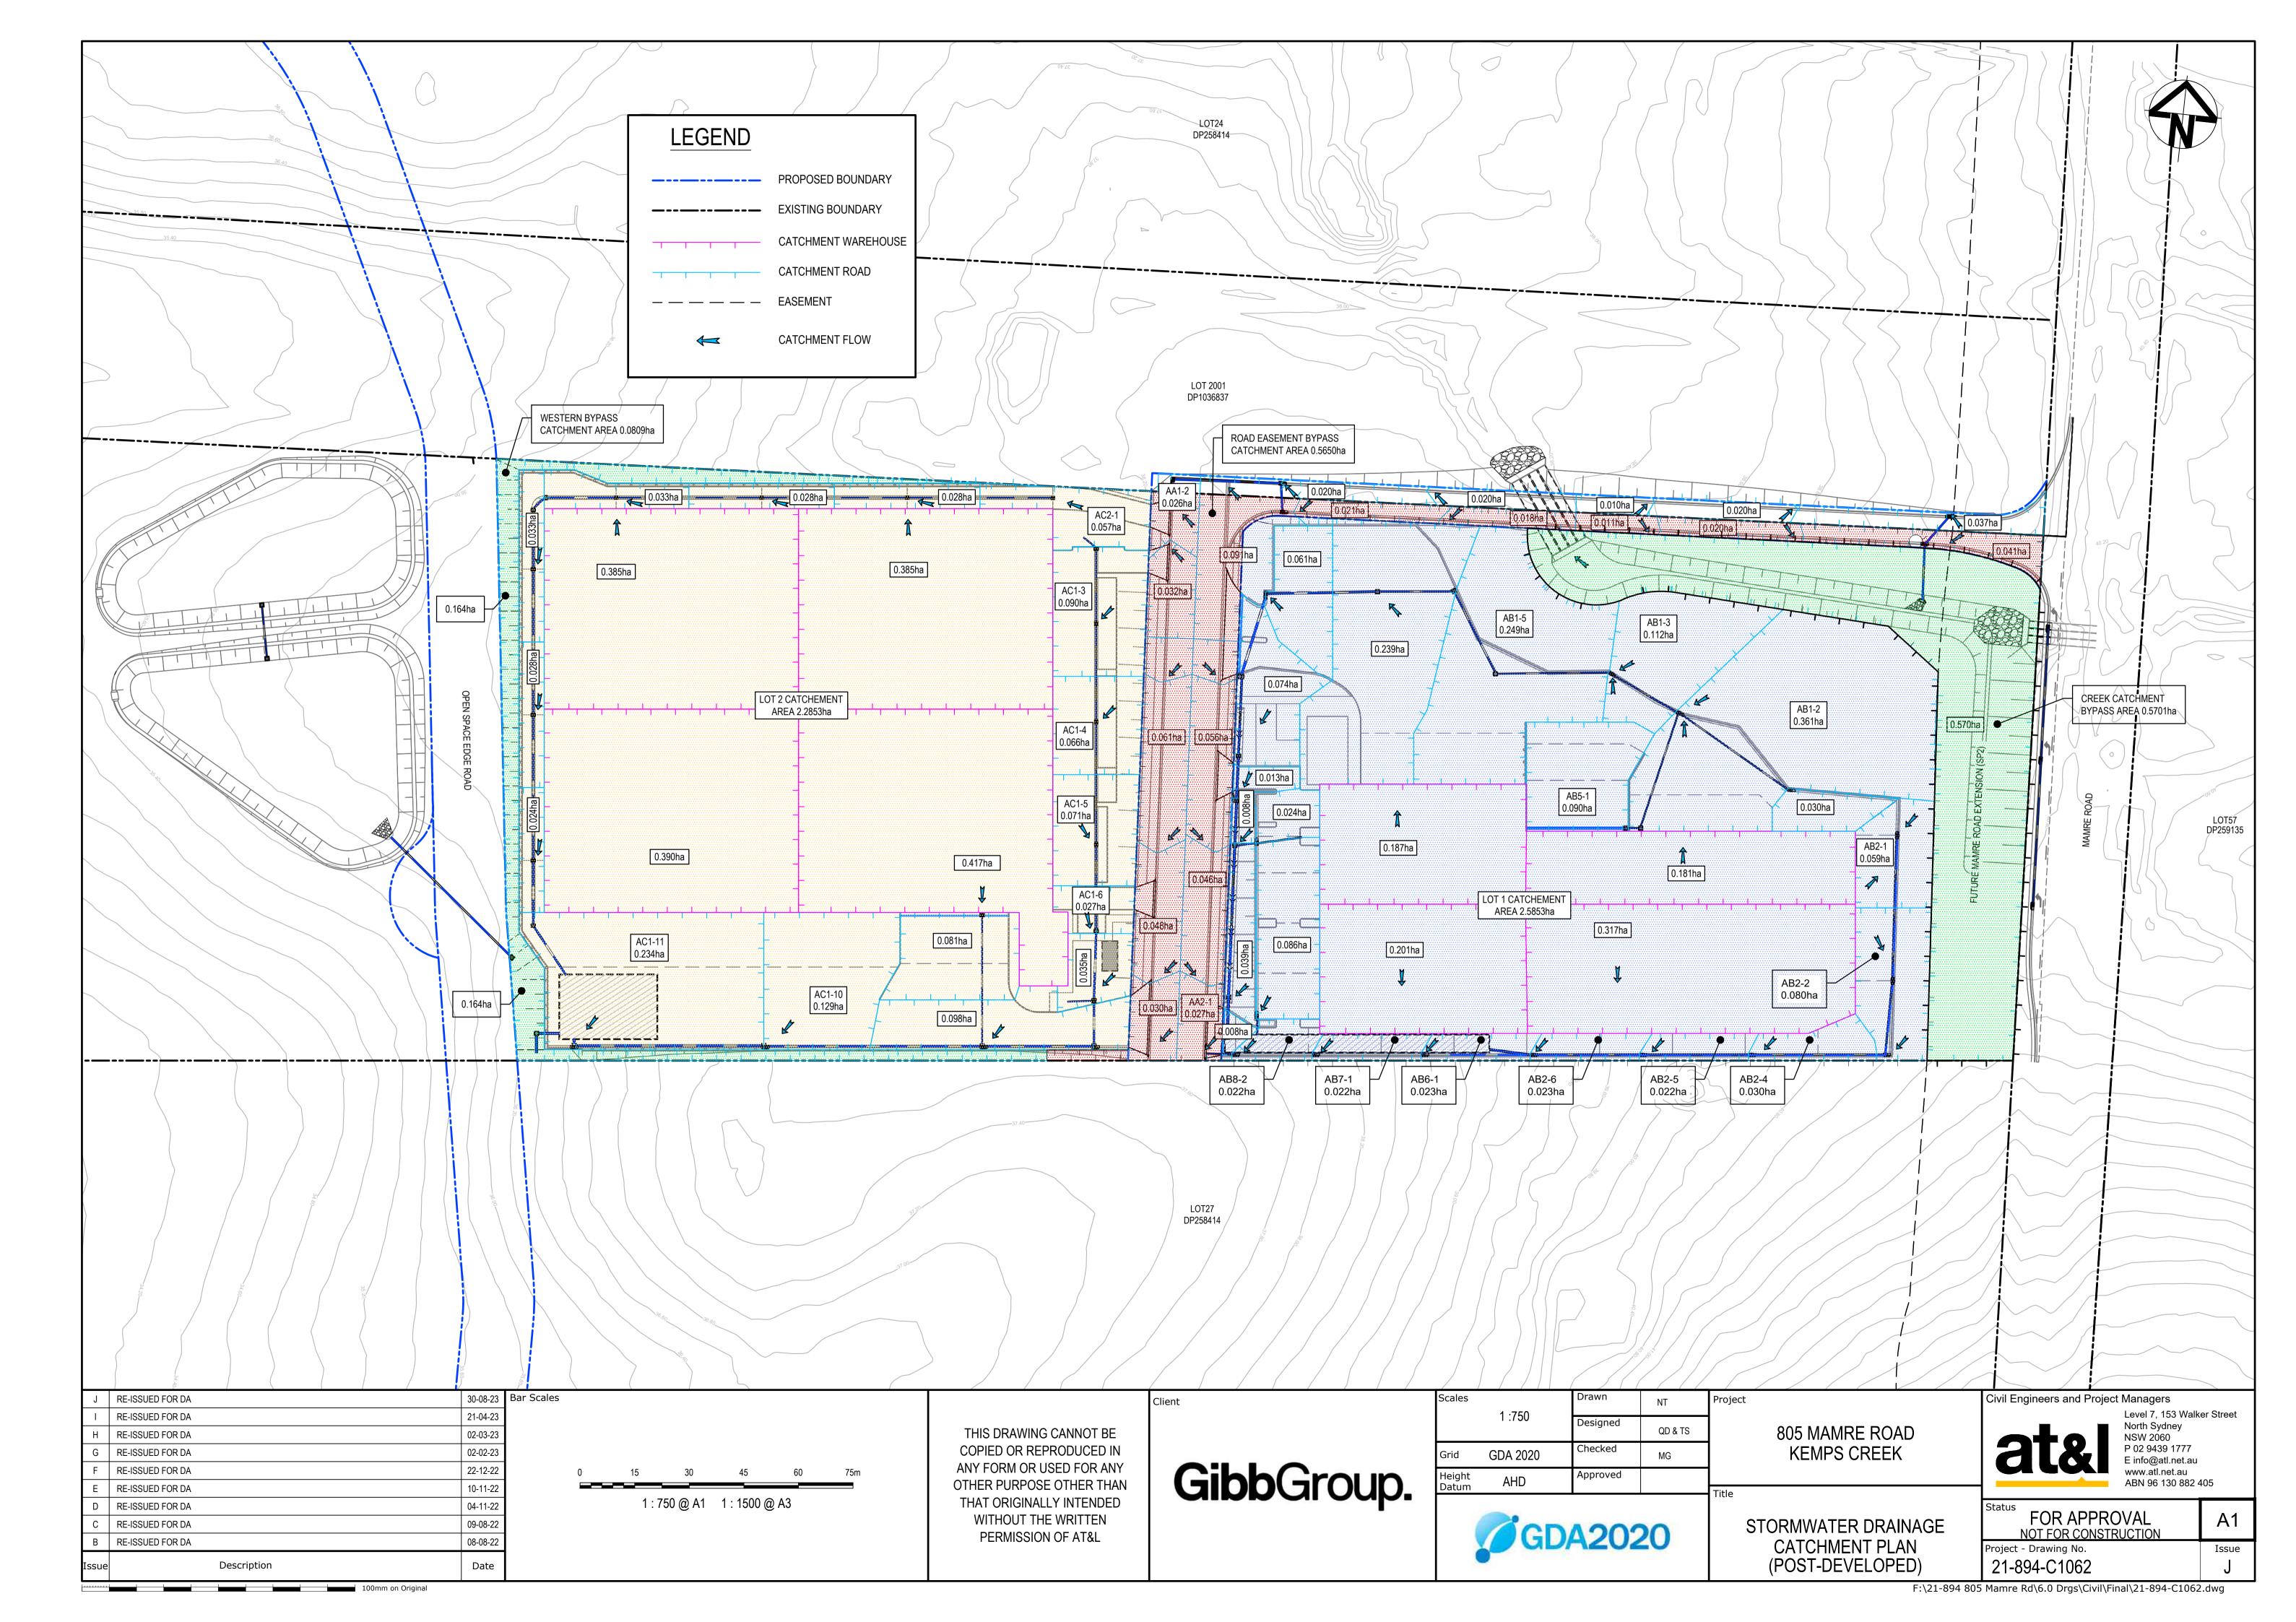


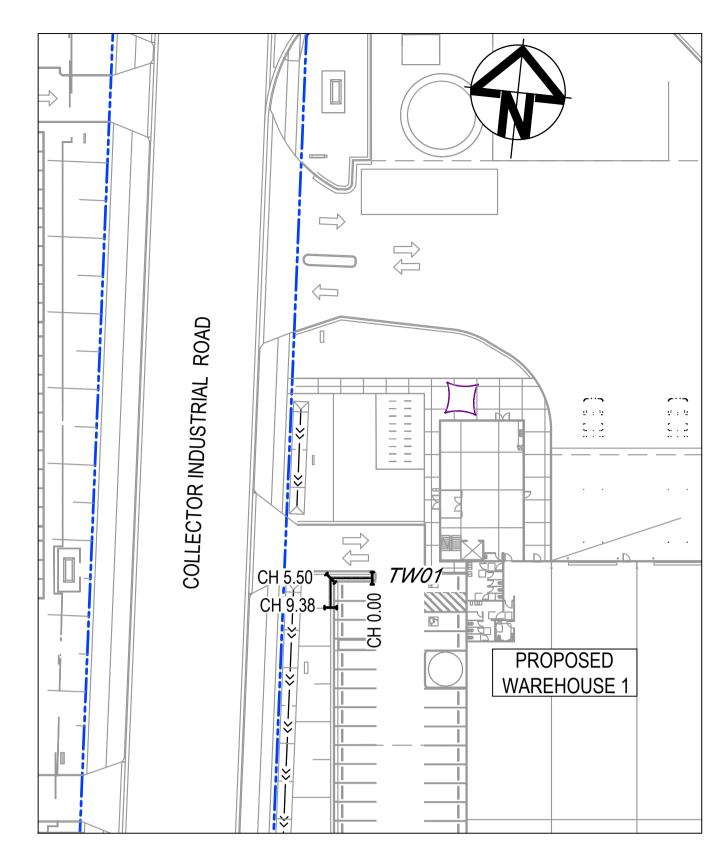


PROPOSED RETAINING WALL PLAN - TW01

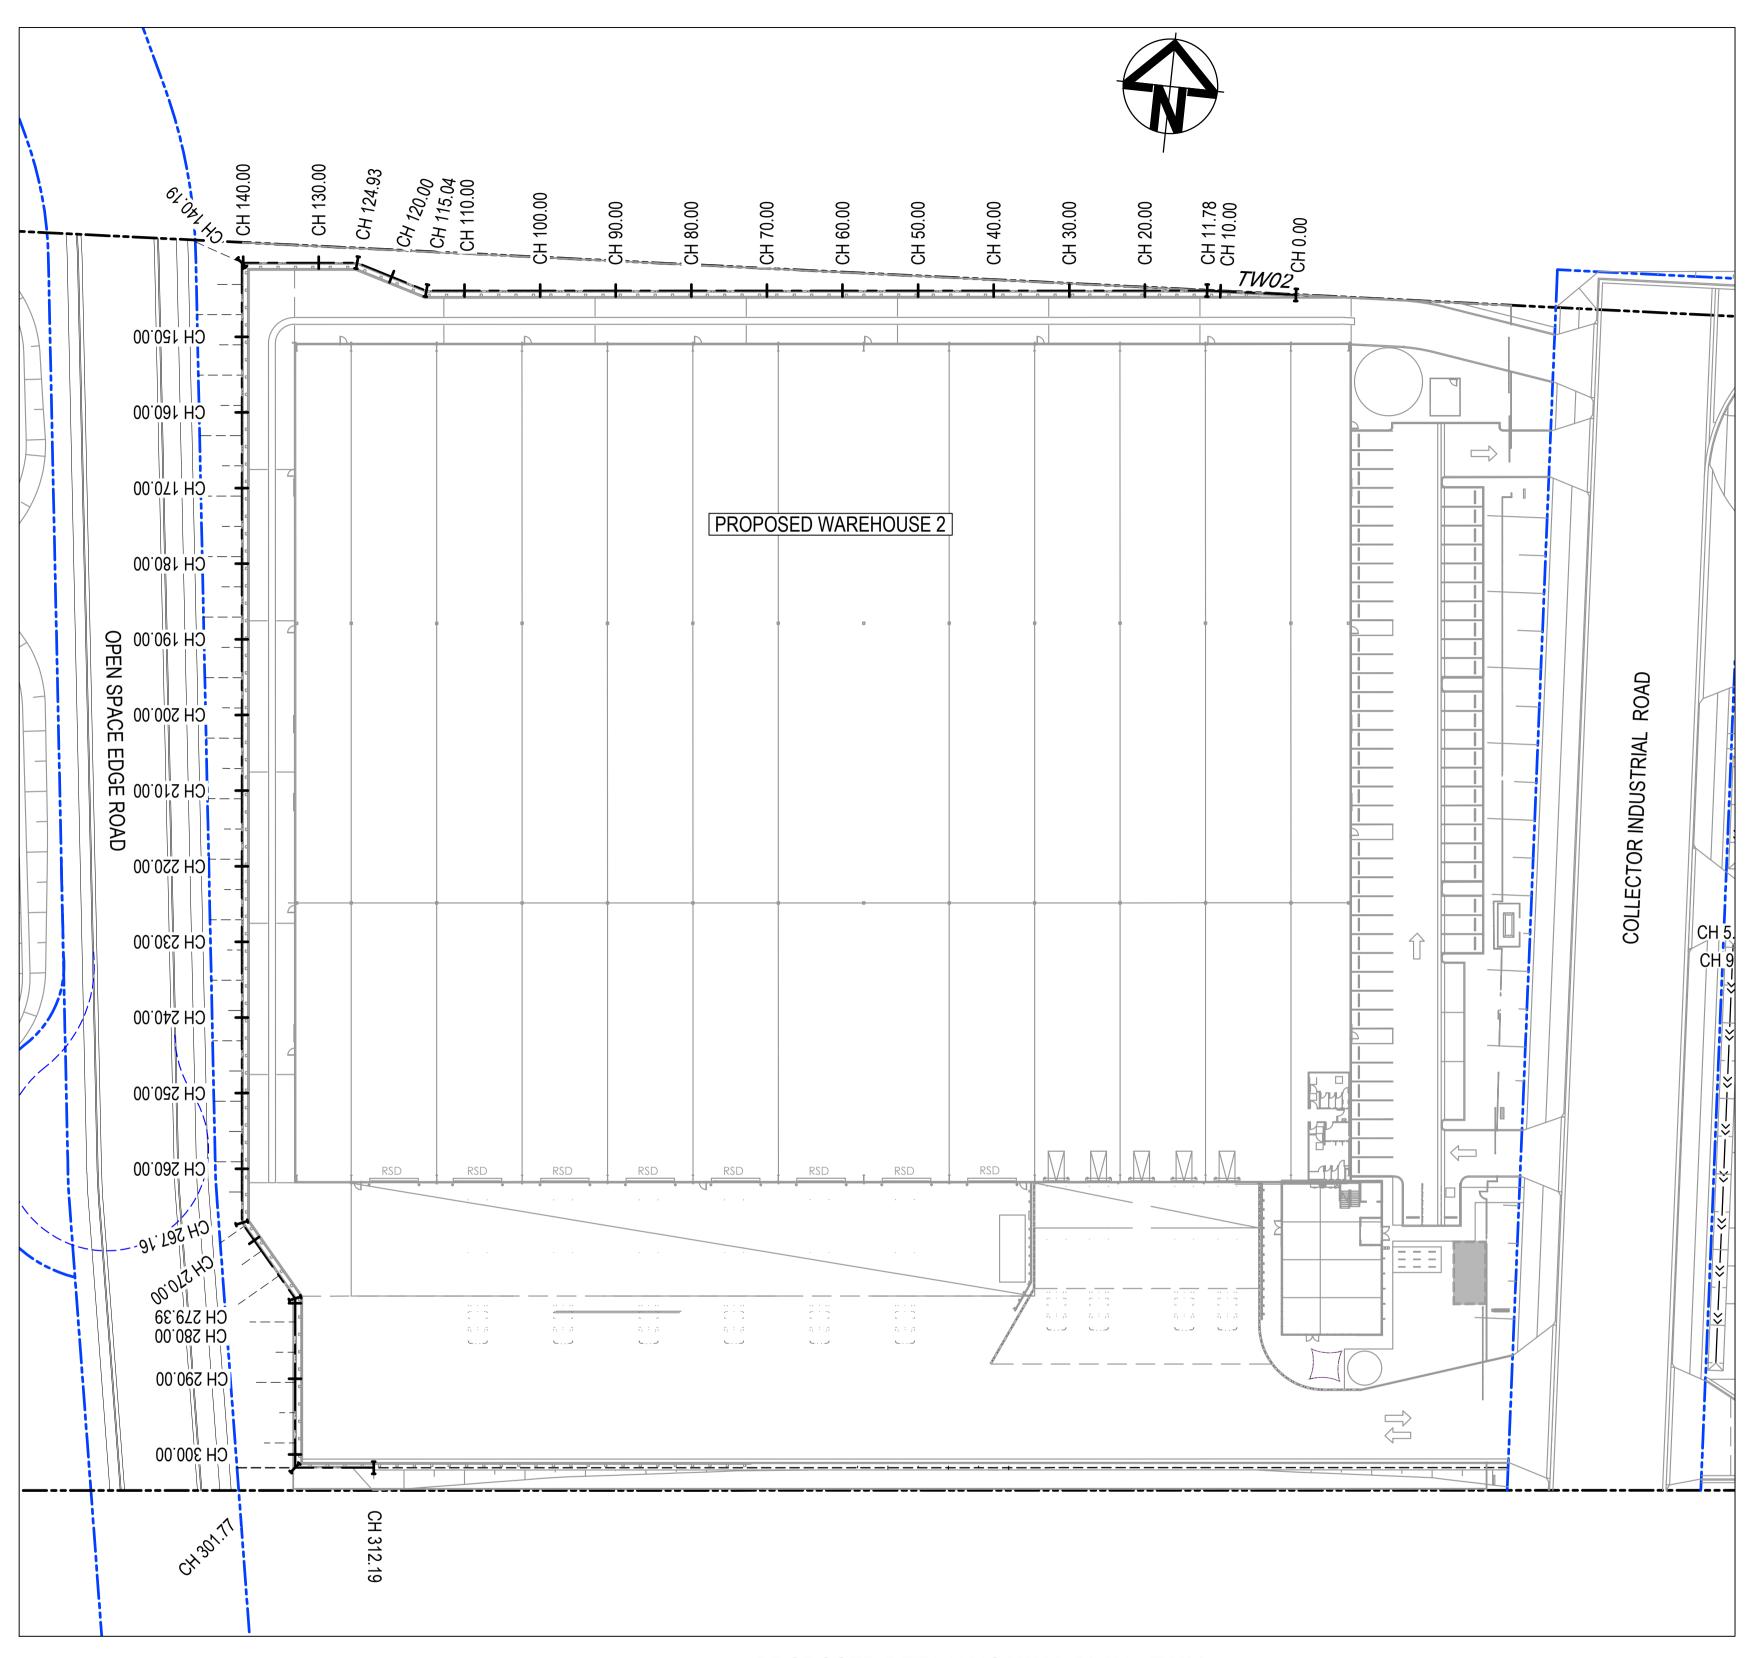


PROPOSED RETAINING WALL PLAN - TW02

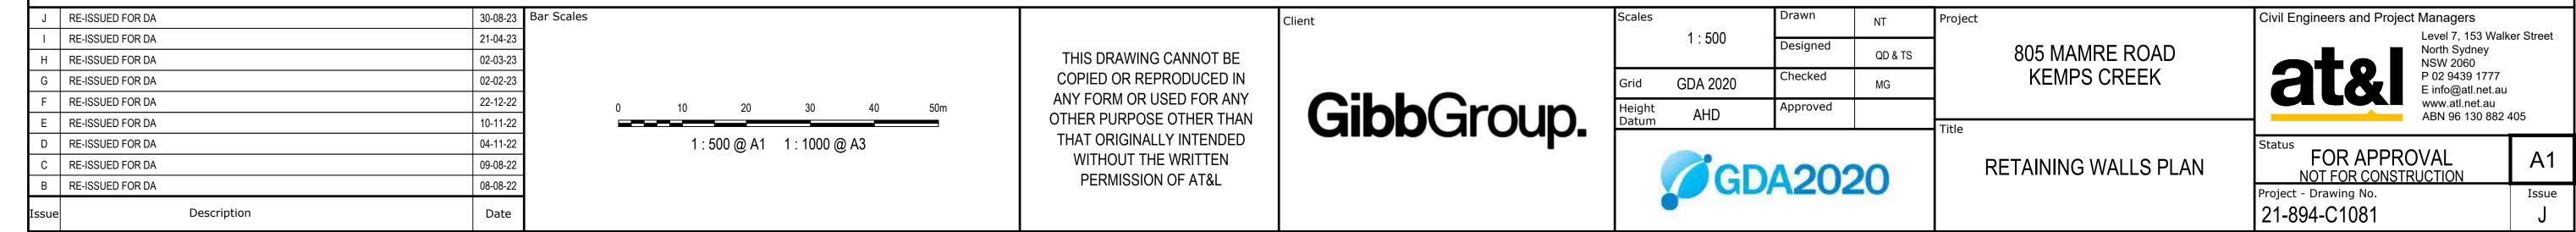

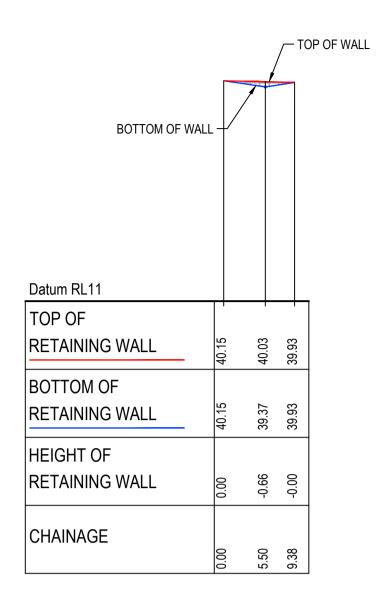

RETAINING WALL TW01 PROFILE

SCALE 1:500 HORI.
1:500 VERT.

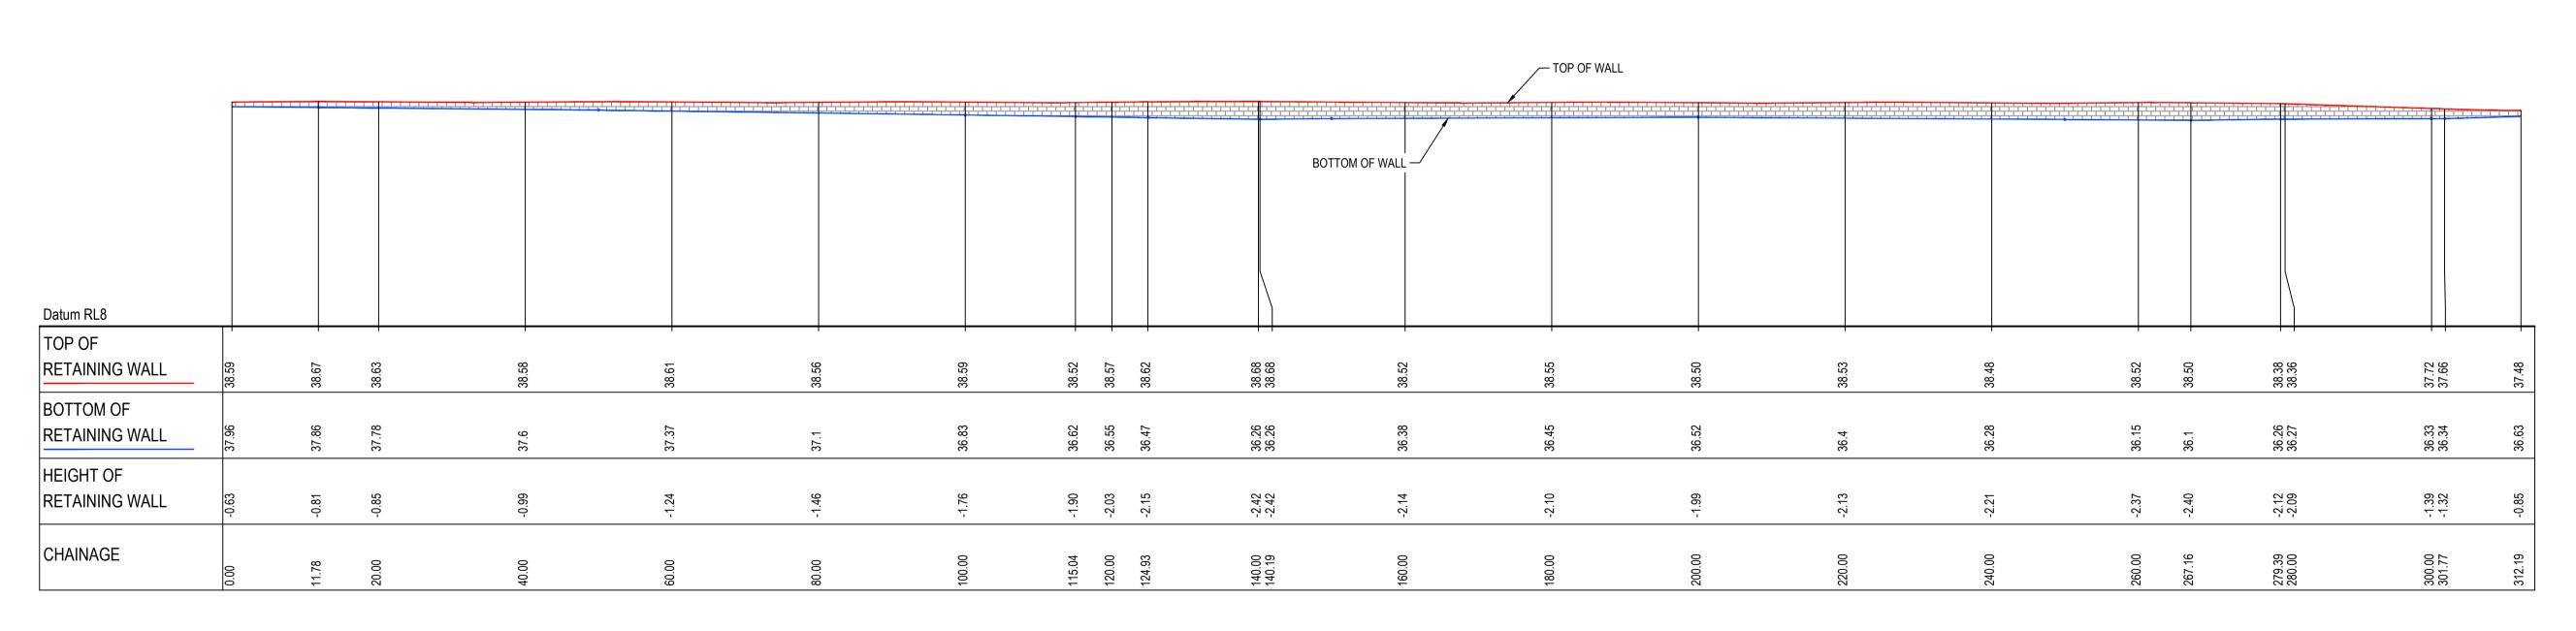

RETAINING WALL TW02 PROFILE

SCALE 1:500 HORI.
1:500 VERT.

	J F	RE-ISSUED FOR DA 30-08-23	Bar Scales		Client	Scales		Drawn	NT	Project		Civil Engineers and Project Manag	gers
	I F	RE-ISSUED FOR DA 21-04-23	3 3 2 0 10 20 30 40 50m 2 2 2 1 : 500 @ A1 1 : 1000 @ A3 2 2	THIS DRAWING CANNOT BE COPIED OR REPRODUCED IN ANY FORM OR USED FOR ANY OTHER PURPOSE OTHER THAN THAT ORIGINALLY INTENDED WITHOUT THE WRITTEN PERMISSION OF AT&L	GibbGroup.		1:500 Grid GDA 2020 Height ALID	Designed			805 MAMRE ROAD KEMPS CREEK		7, 153 Walker Street
H	H F	RE-ISSUED FOR DA 02-03-23						Designed	QD & TS			North Sydney NSW 2060 P 02 9439 1777 E info@atl.net.au www.atl.net.au	
(G F	RE-ISSUED FOR DA 02-02-23				Grid		Checked	MG				
F	F F	RE-ISSUED FOR DA 22-12-22				Height		Approved					
E	E F	RE-ISSUED FOR DA 10-11-22				Datum AHD	AHD			Title		ABN 9	6 130 882 405
	D F	RE-ISSUED FOR DA 04-11-22										Status FOR A DDD OV (AL	
(C F	RE-ISSUED FOR DA 09-08-22				GE		CDACOO			RETAINING WALLS	FOR APPROVAL	, A1
E	B F	RE-ISSUED FOR DA 08-08-22						DA202	20		PROFILES	NOT FOR CONSTRUCTION Project - Drawing No.	Issue
Iss	sue	Description Date									TROTILLO	21-894-C1082	J
	F:\21-894 805 Mamre Rd\6.0 Drgs\Civil\Final\21-894-C1082.dwg												

