# 706-752 Mamre Road, Kemps Creek, NSW, 2178

# Landscape Documentation for State Significant Development Application (SSD - 30628110)



# **Drawing Register**

Drawing Name

Dwg No.

IMAGE TAKEN FROM NEARMAP 2022 (\*)

SSD-00	Cover Sheet	SSD-14	Mamre Road Intersection Concept I
SSD-01	Landscape Masterplan	SSD-15	Estate Entry Road Concept Illustrati
SSD-02	Concept Approval Masterplan	SSD-16	<b>Specifications &amp; Details</b>
SSD-03	Stage 1 Masterplan	SSD-17	Trunk Drainage Details
SSD-04	Stage 1 Detail Plan 1	SSD-18	Plant Schedule & Imagery
SSD-05	Stage 1 Detail Plan 2		
SSD-06	Stage 1 Detail Plan 3		
SSD-07	Stage 1 Detail Plan 4		
SSD-08	Stage 1 Detail Plan 5		
SSD-09	Stage 1 Detail Plan 6		
SSD-10	Landscape Streetscape Plan		
SSD-11	Landscape Tree Canopy Coverage and Bushfire Compliance		
SSD-12	Sections AA, BB & CC		
SSD-13	Sections DD, EE & FF		

Drawing Title:

**Cover Sheet** 

DWG No:



**Client**:

ot Illustration ation



# SITE PLAN



Architect: Watson youn

Scale:	Date:
N/A	27.11.23
Project:	706-752

Job Number: N	lorth:	Revision			FOR SSD (NOT FOR	R CONST	RUCTION)
011100		Rev	Date	Description		Drawn	Checked
211123	$\bigcirc$	C	01.09.22	FOR SSD		RJ	BG
		D	13.09.22	FOR SSD		RJ	BG
Mamre Road		Ε	19.09.22	FOR SSD		RJ	BG
Kemps Creek, NS'	W 2178	F	27.11.23	FOR SSD		KC	BG



Drawing Title: **Landscape Masterplan** DWG No:

**SSD-01** 



**Client**:

Architect:



Scale:	<b>Date</b> :
1:1500 @ A1 1:3000 @ A3	27.11.2
Project:	

27.11.23

Job Number: North:	Revis	ion	FOR SSD (NOT FO	R CONSI	RUCTION)
011100	Rev	Date	Description	Drawn	Checked
211123	C	01.09.22	FOR SSD	RJ	BG
Mamra Dood	D	13.09.22	FOR SSD	RJ	BG
? Mamre Road	E	19.09.22	FOR SSD	RJ	BG
Kemps Creek, NSW 2178	F	27.11.23	FOR SSD	KC	BG
•					



Kemps Creek, NSW 2178 F 27.11.23 FOR SSD

KC


BG

DWG No:

**Suite 303, 8 Help St, Chatswood NSW 2067 Ph. (02) 9411 1485** www.geoscapes.com.au ABN 84 620 205 781 ACN 620 205 781



FOR SSD (NOT FOR CONSTRUCTION) Drawn Checked BG RJ RJ BG BG RJ Kemps Creek, NSW 2178 F 27.11.23 FOR SSD KC BG

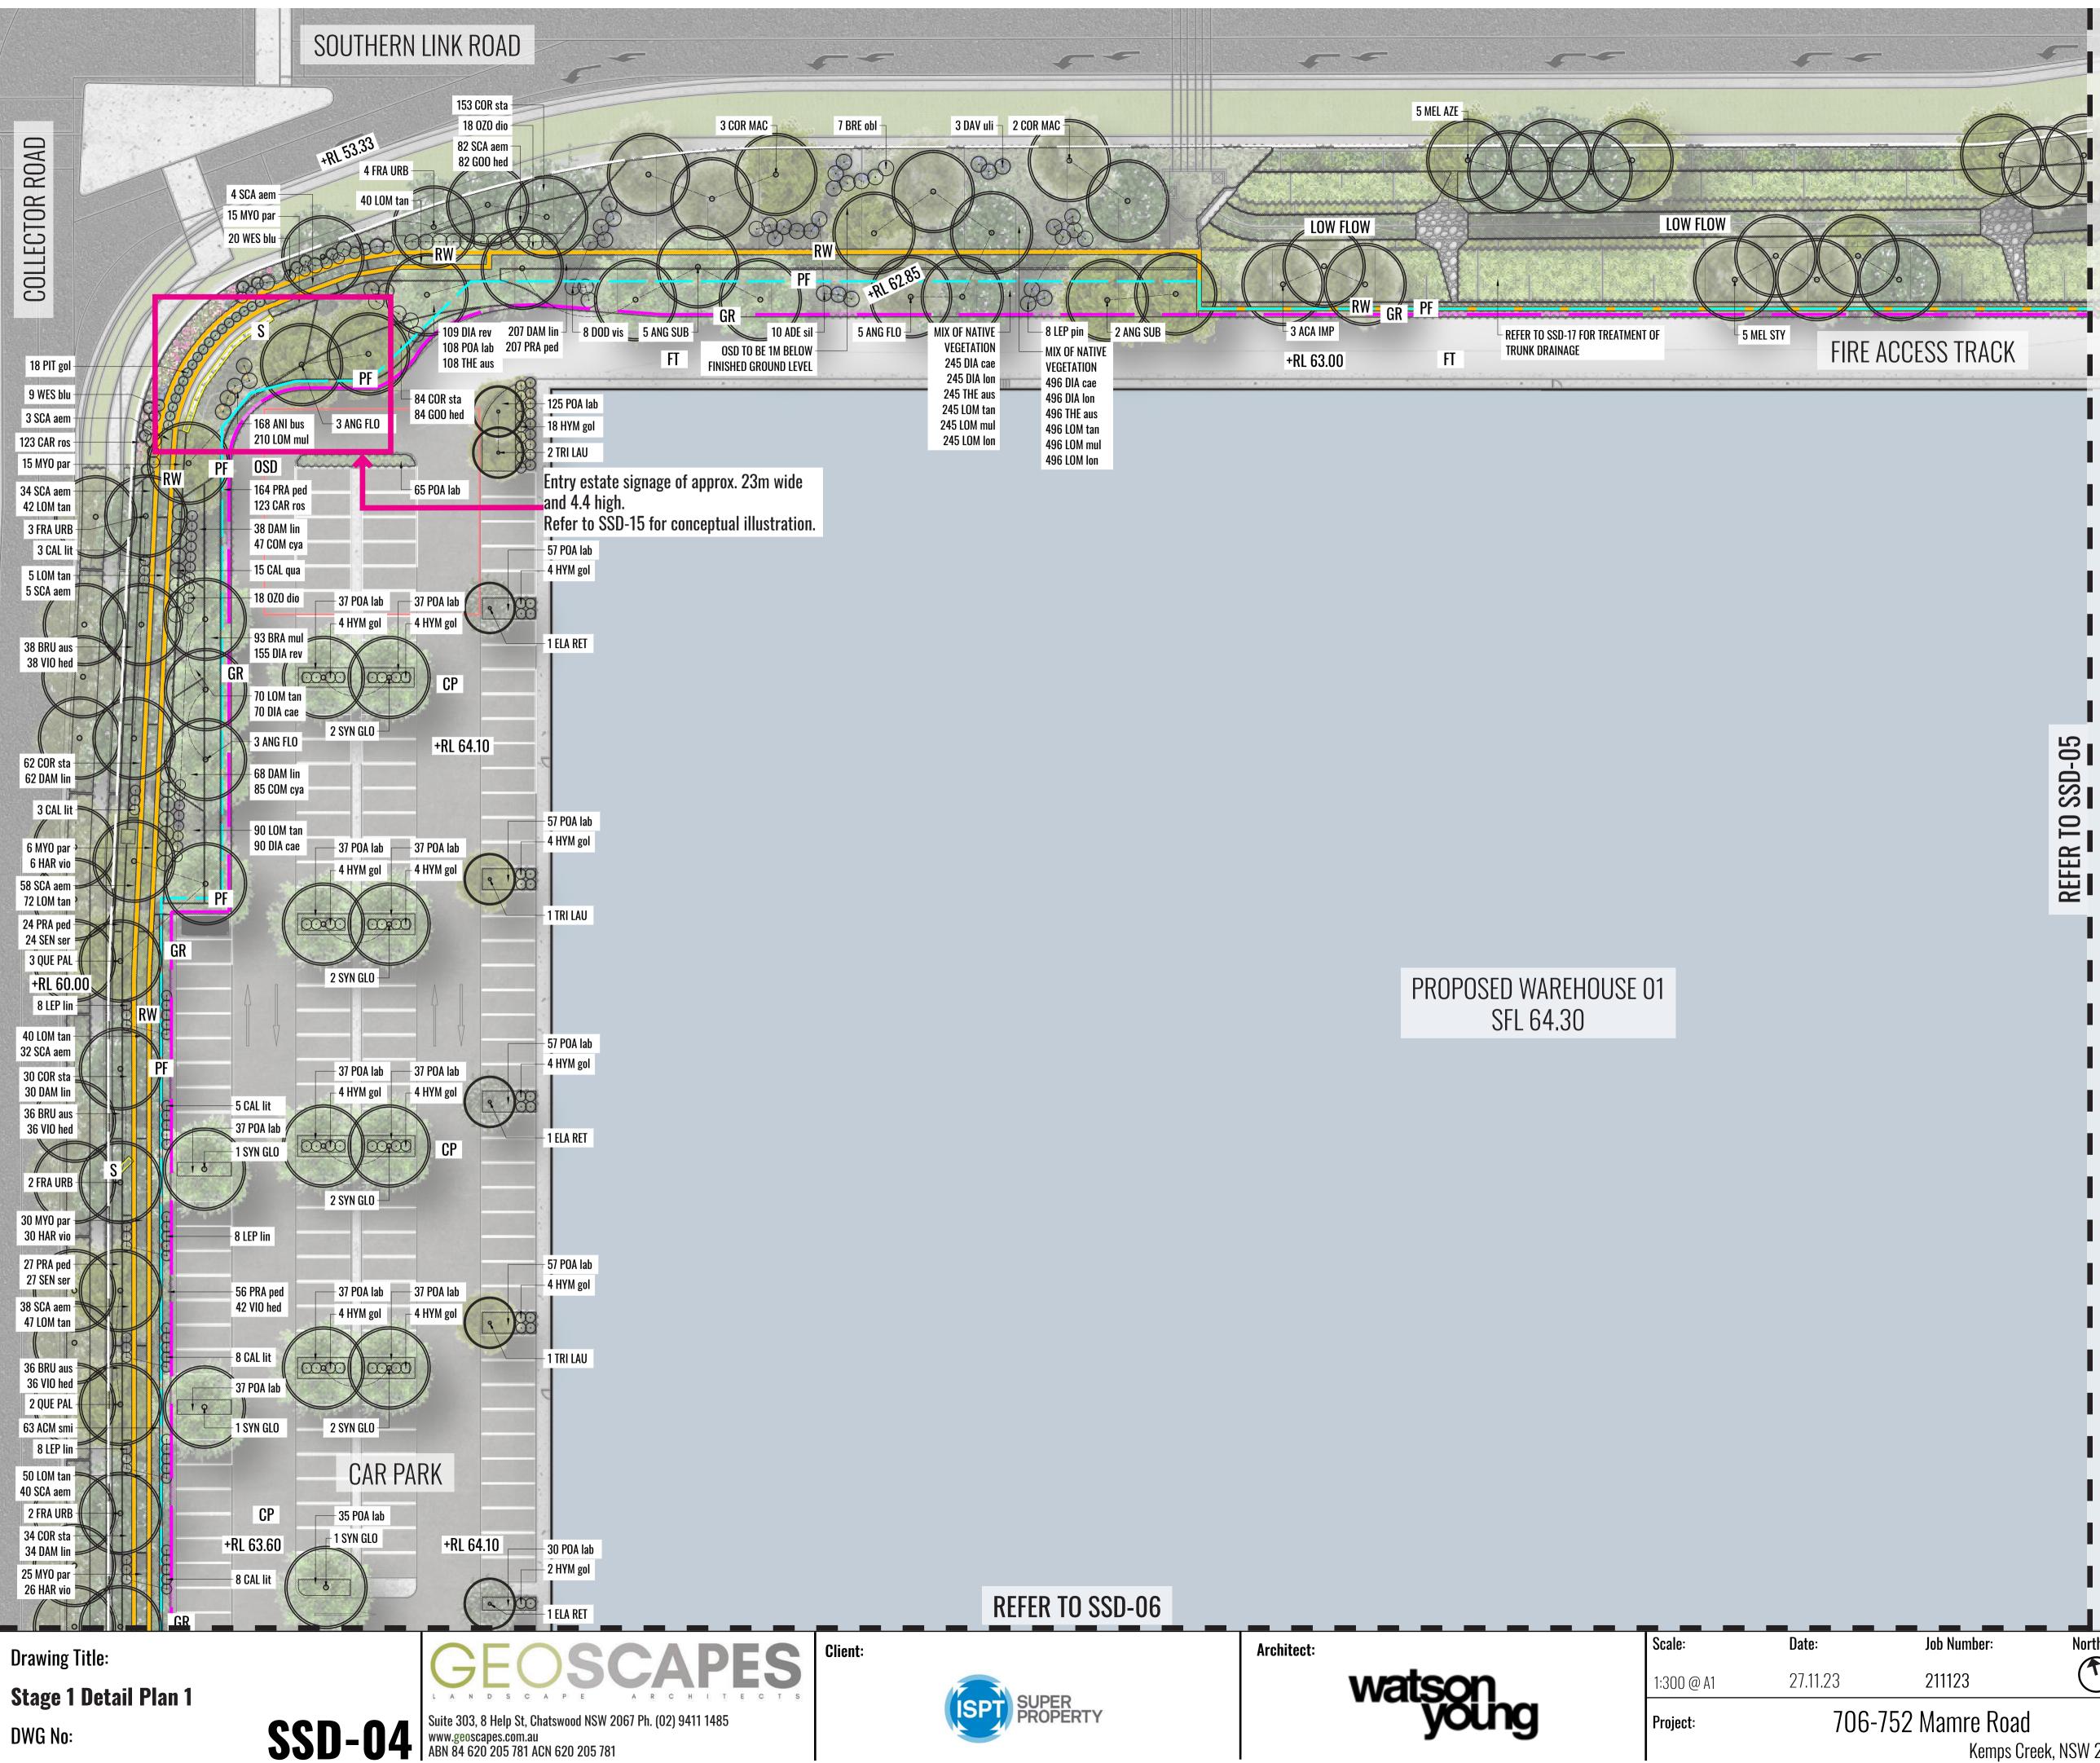

LEGEND


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	ESTATE SITE BOUNDARY
	SITE BOUNDARY
	PROPOSED GROUNDCOVER Planting
	PROPOSED SHRUB Planting
+RL 71.10	PROPOSED LEVELS
	PROPOSED HEDGE PLANTING
RW -	RETAINING WALL (REFER TO CIVIL Documentation for heights)
S.	PROPOSED TREE PLANTING
Ø	PROPOSED STREET TREE PLANTING
H	HARDSTAND
CP	CARPARK (SEMI-PERMEABLE)
FT	FIRE ACCESS TRACK (PERMEABLE)
<u> </u>	SIGNAGE LOCATIONS
TBS	TABLE AND CHAIR SETTINGS
PF	PALISADE FENCE
F	CHAIN WIRE FENCE
WF	WOODEN FENCE
— · GR - —	GUARD RAIL
SB	SUBSTATION
RWT	RAIN WATER TANKS
— OSD—	ONSITE STORMWATER DETENTION TANKS
SA	STAFF OUTDOOR AREA (SEMI-PERMEABLE)
SG	AUTO SLIDING GATE

# **KEY PLAN**



Job Number:	North:	Revision			FOR SSD (NOT FOR CONSTRUCTION		
011100		Rev	Date	Description		Drawn	Checked
211123	$\bigcirc$	C	01.09.22	FOR SSD		RJ	BG
Mamre Road Kemps Creek, NSW 2178		D	13.09.22	FOR SSD		RJ	BG
		Ε	19.09.22	FOR SSD		RJ	BG
		F	27.11.23	FOR SSD		KC	BG

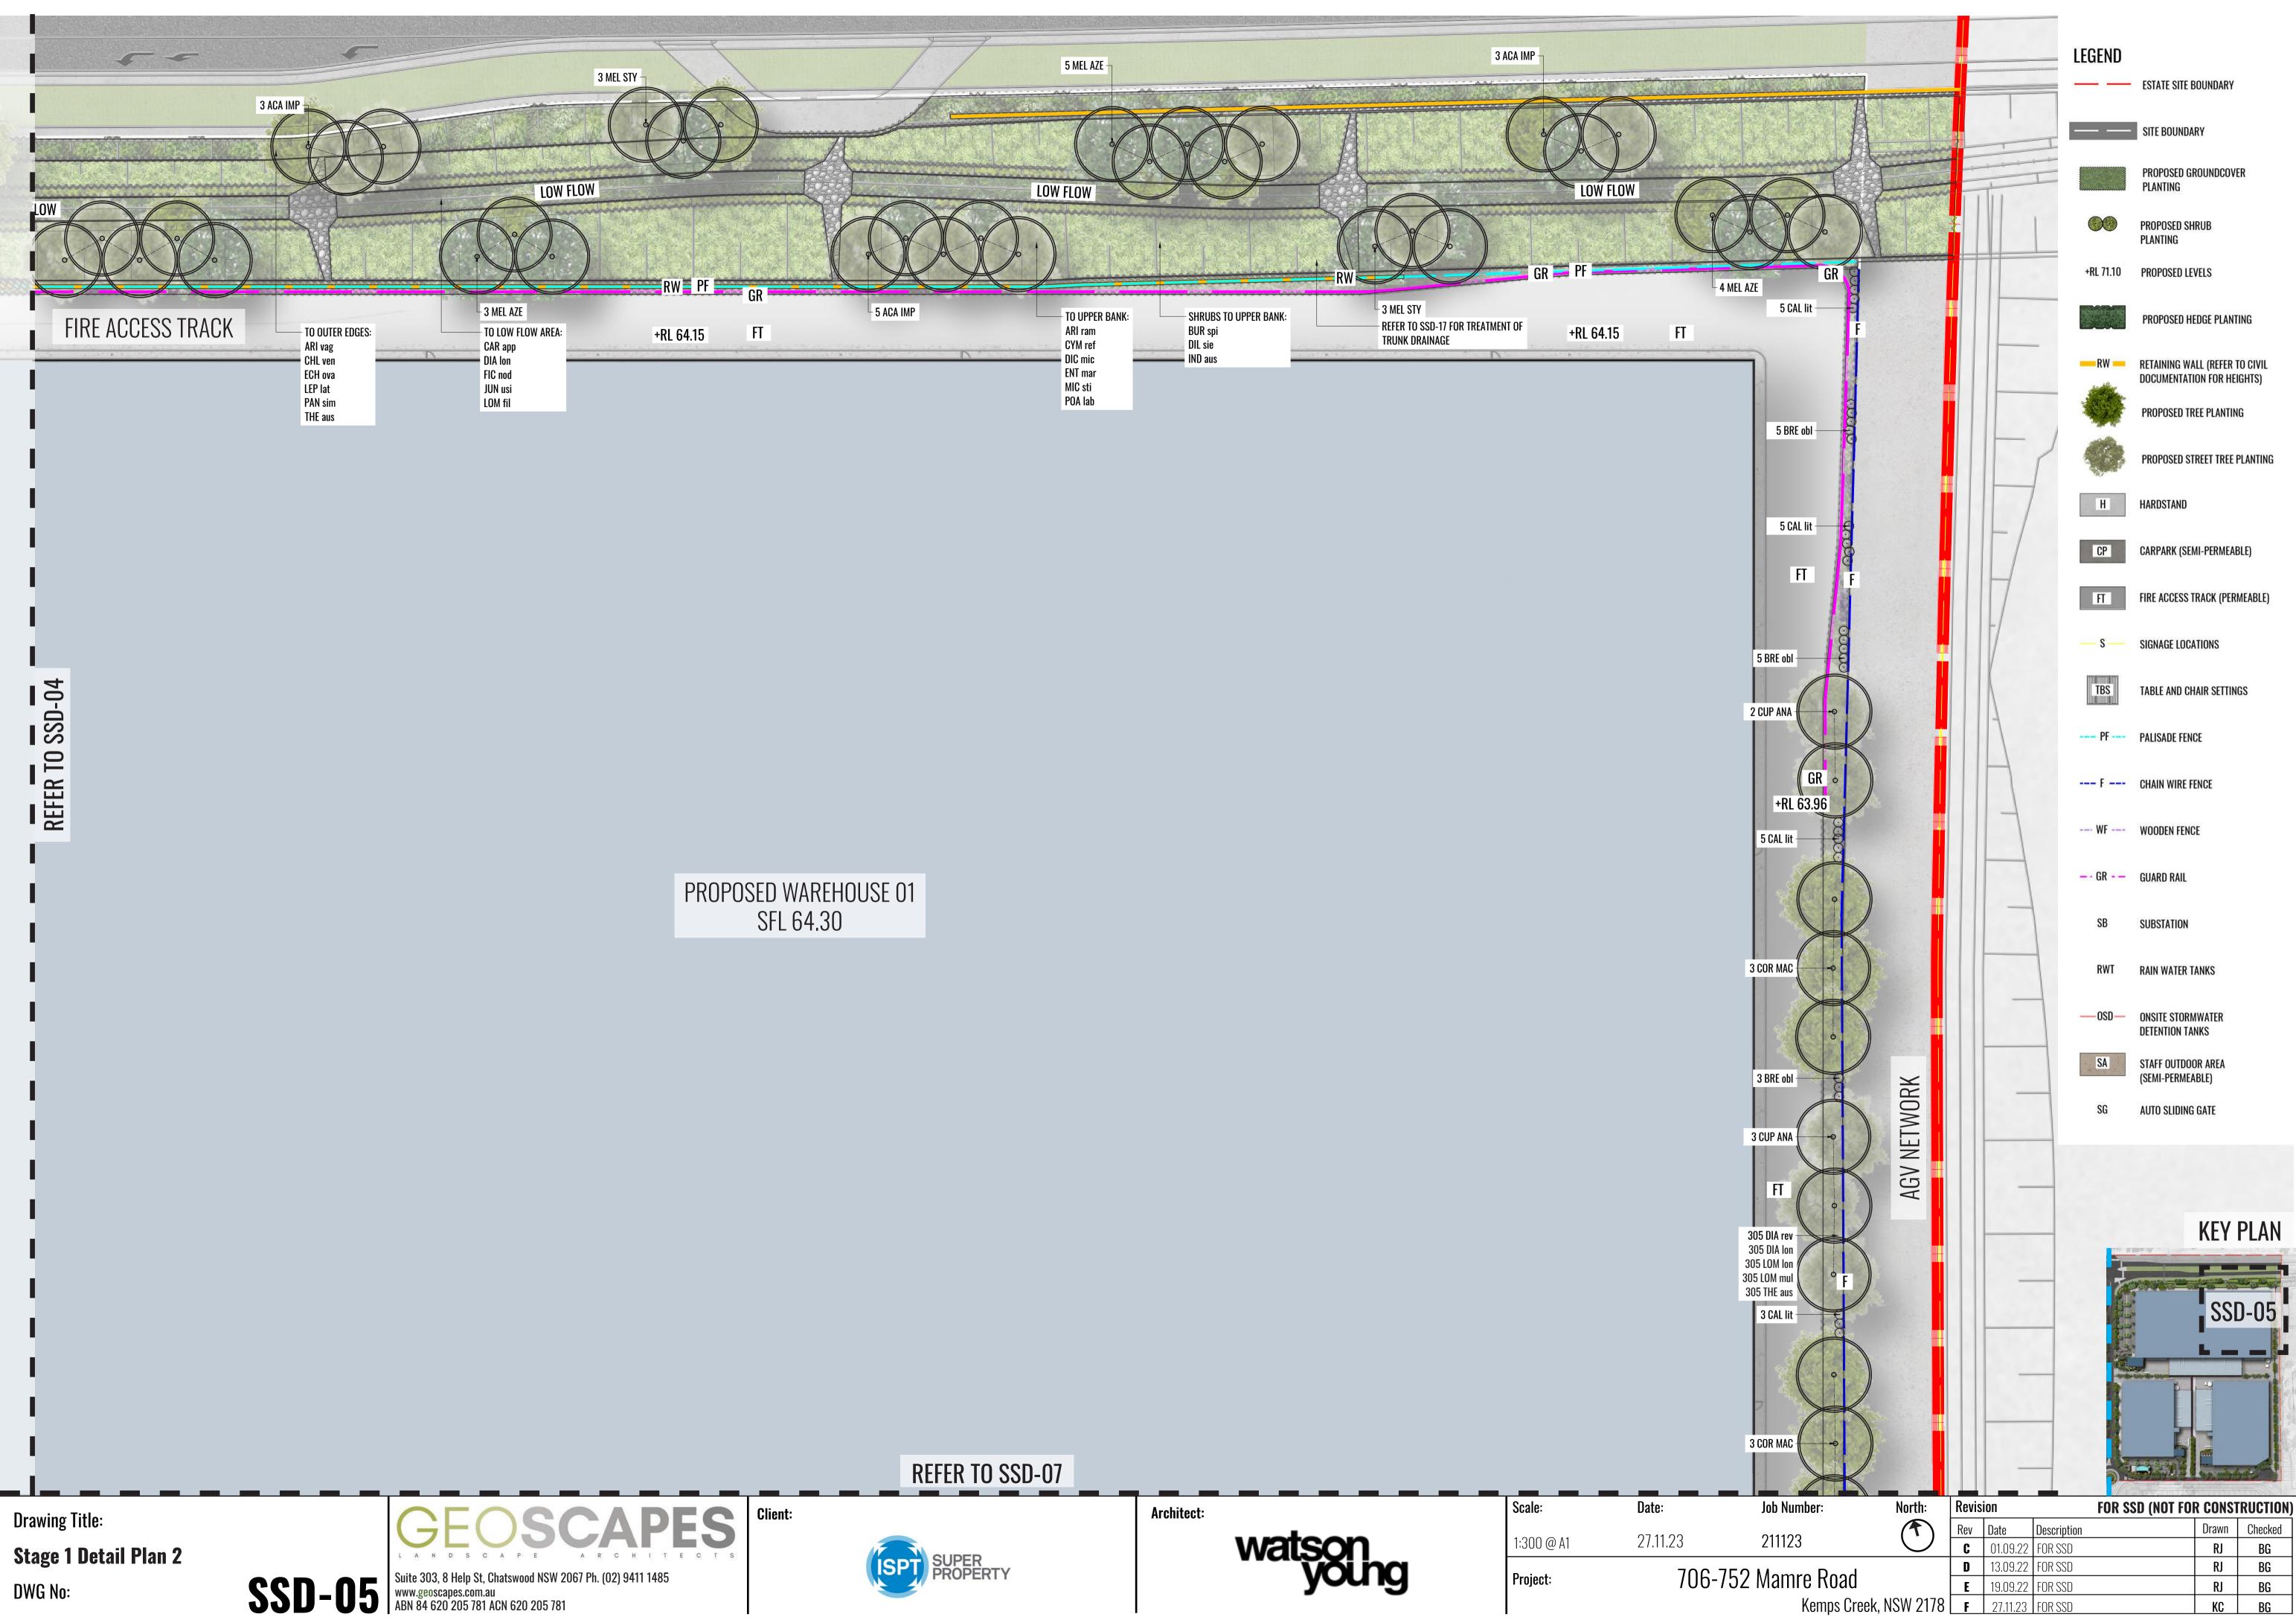


DWG No:

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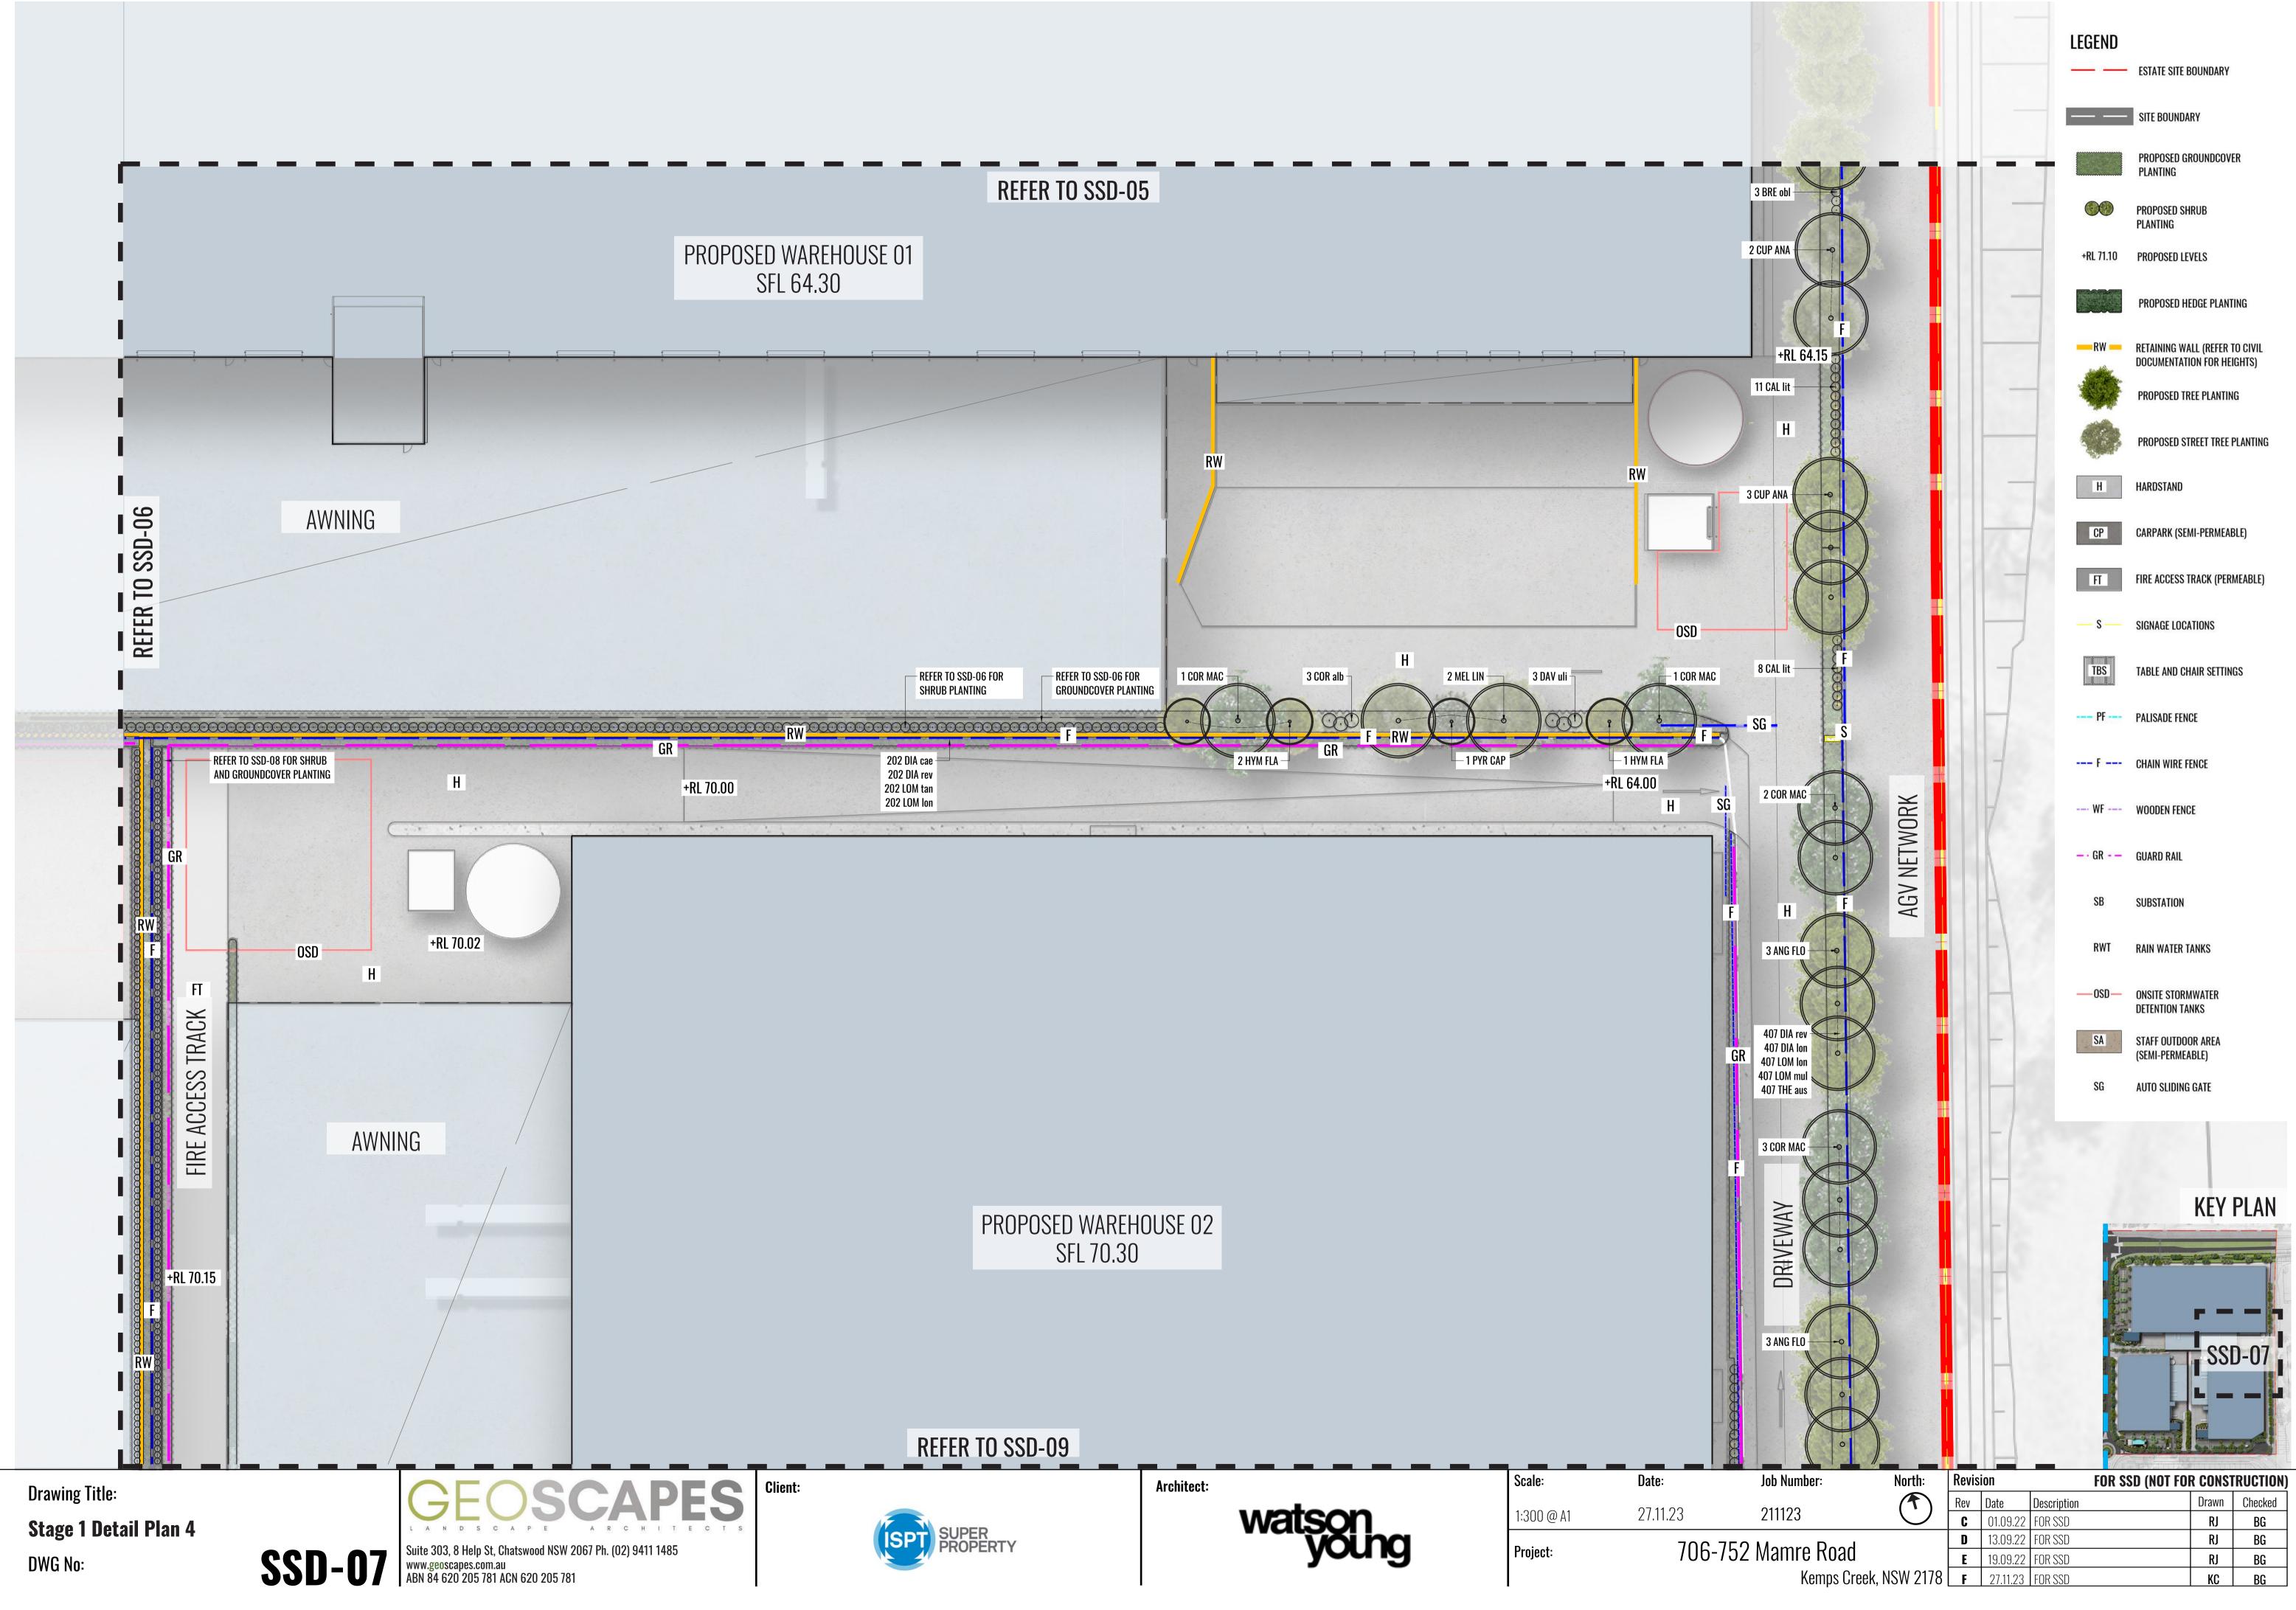



KC BG



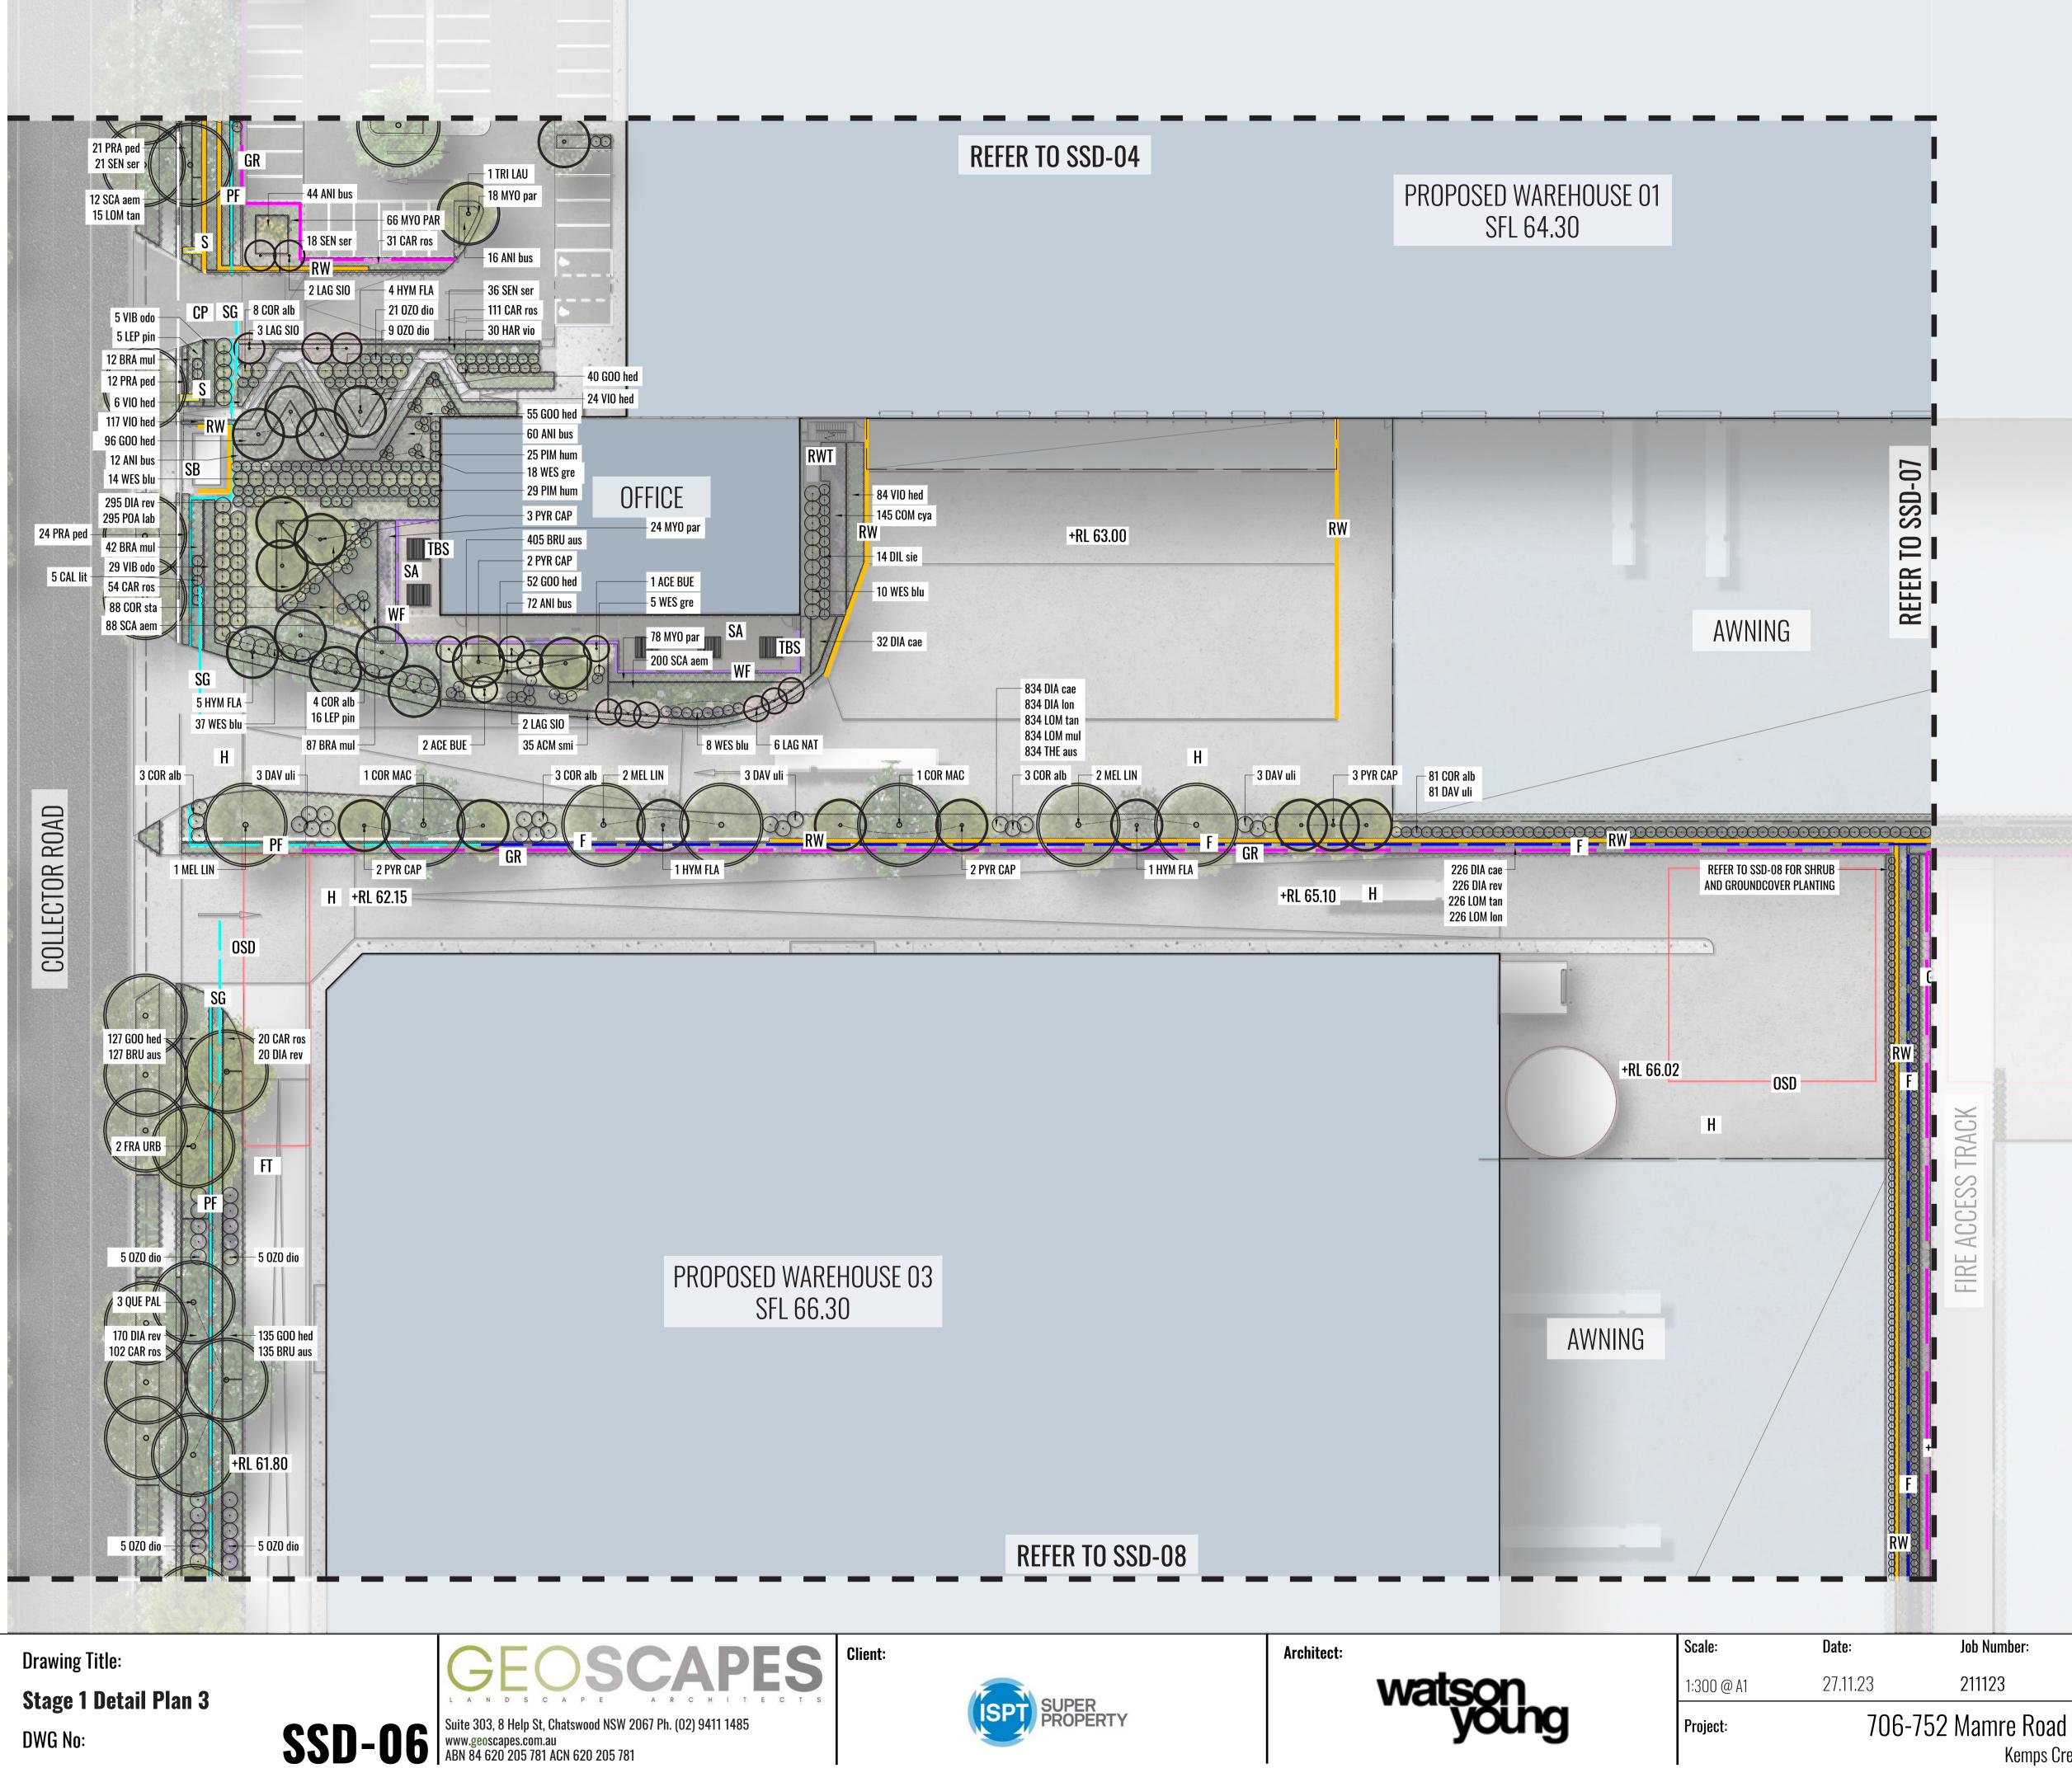

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AWN	ING				KEY PLAN
				SG	AUTO SLIDING GATE
				SA	STAFF OUTDOOR AREA (SEMI-PERMEABLE)
				<u> </u>	ONSITE STORMWATER DETENTION TANKS
				RWT	RAIN WATER TANKS
				SB	SUBSTATION
		e		— · GR - —	GUARD RAIL
				WF	WOODEN FENCE
				F	CHAIN WIRE FENCE
				PF	PALISADE FENCE
				TBS	TABLE AND CHAIR SETTINGS
				— S —	SIGNAGE LOCATIONS
				FT	FIRE ACCESS TRACK (PERMEABLE)
				CP	CARPARK (SEMI-PERMEABLE)
				Η	HARDSTAND
				Ø	PROPOSED STREET TREE PLANTING
					PROPOSED TREE PLANTING
				-RW -	RETAINING WALL (REFER TO CIVIL DOCUMENTATION FOR HEIGHTS)
					PROPOSED HEDGE PLANTING
				+RL 71.10	PROPOSED LEVELS
					PROPOSED SHRUB Planting
					PROPOSED GROUNDCOVER Planting
			Ľ		SITE BOUNDARY
			ž		ESTATE SITE BOUNDARY
	Awn	AWNING			+RL 71.10



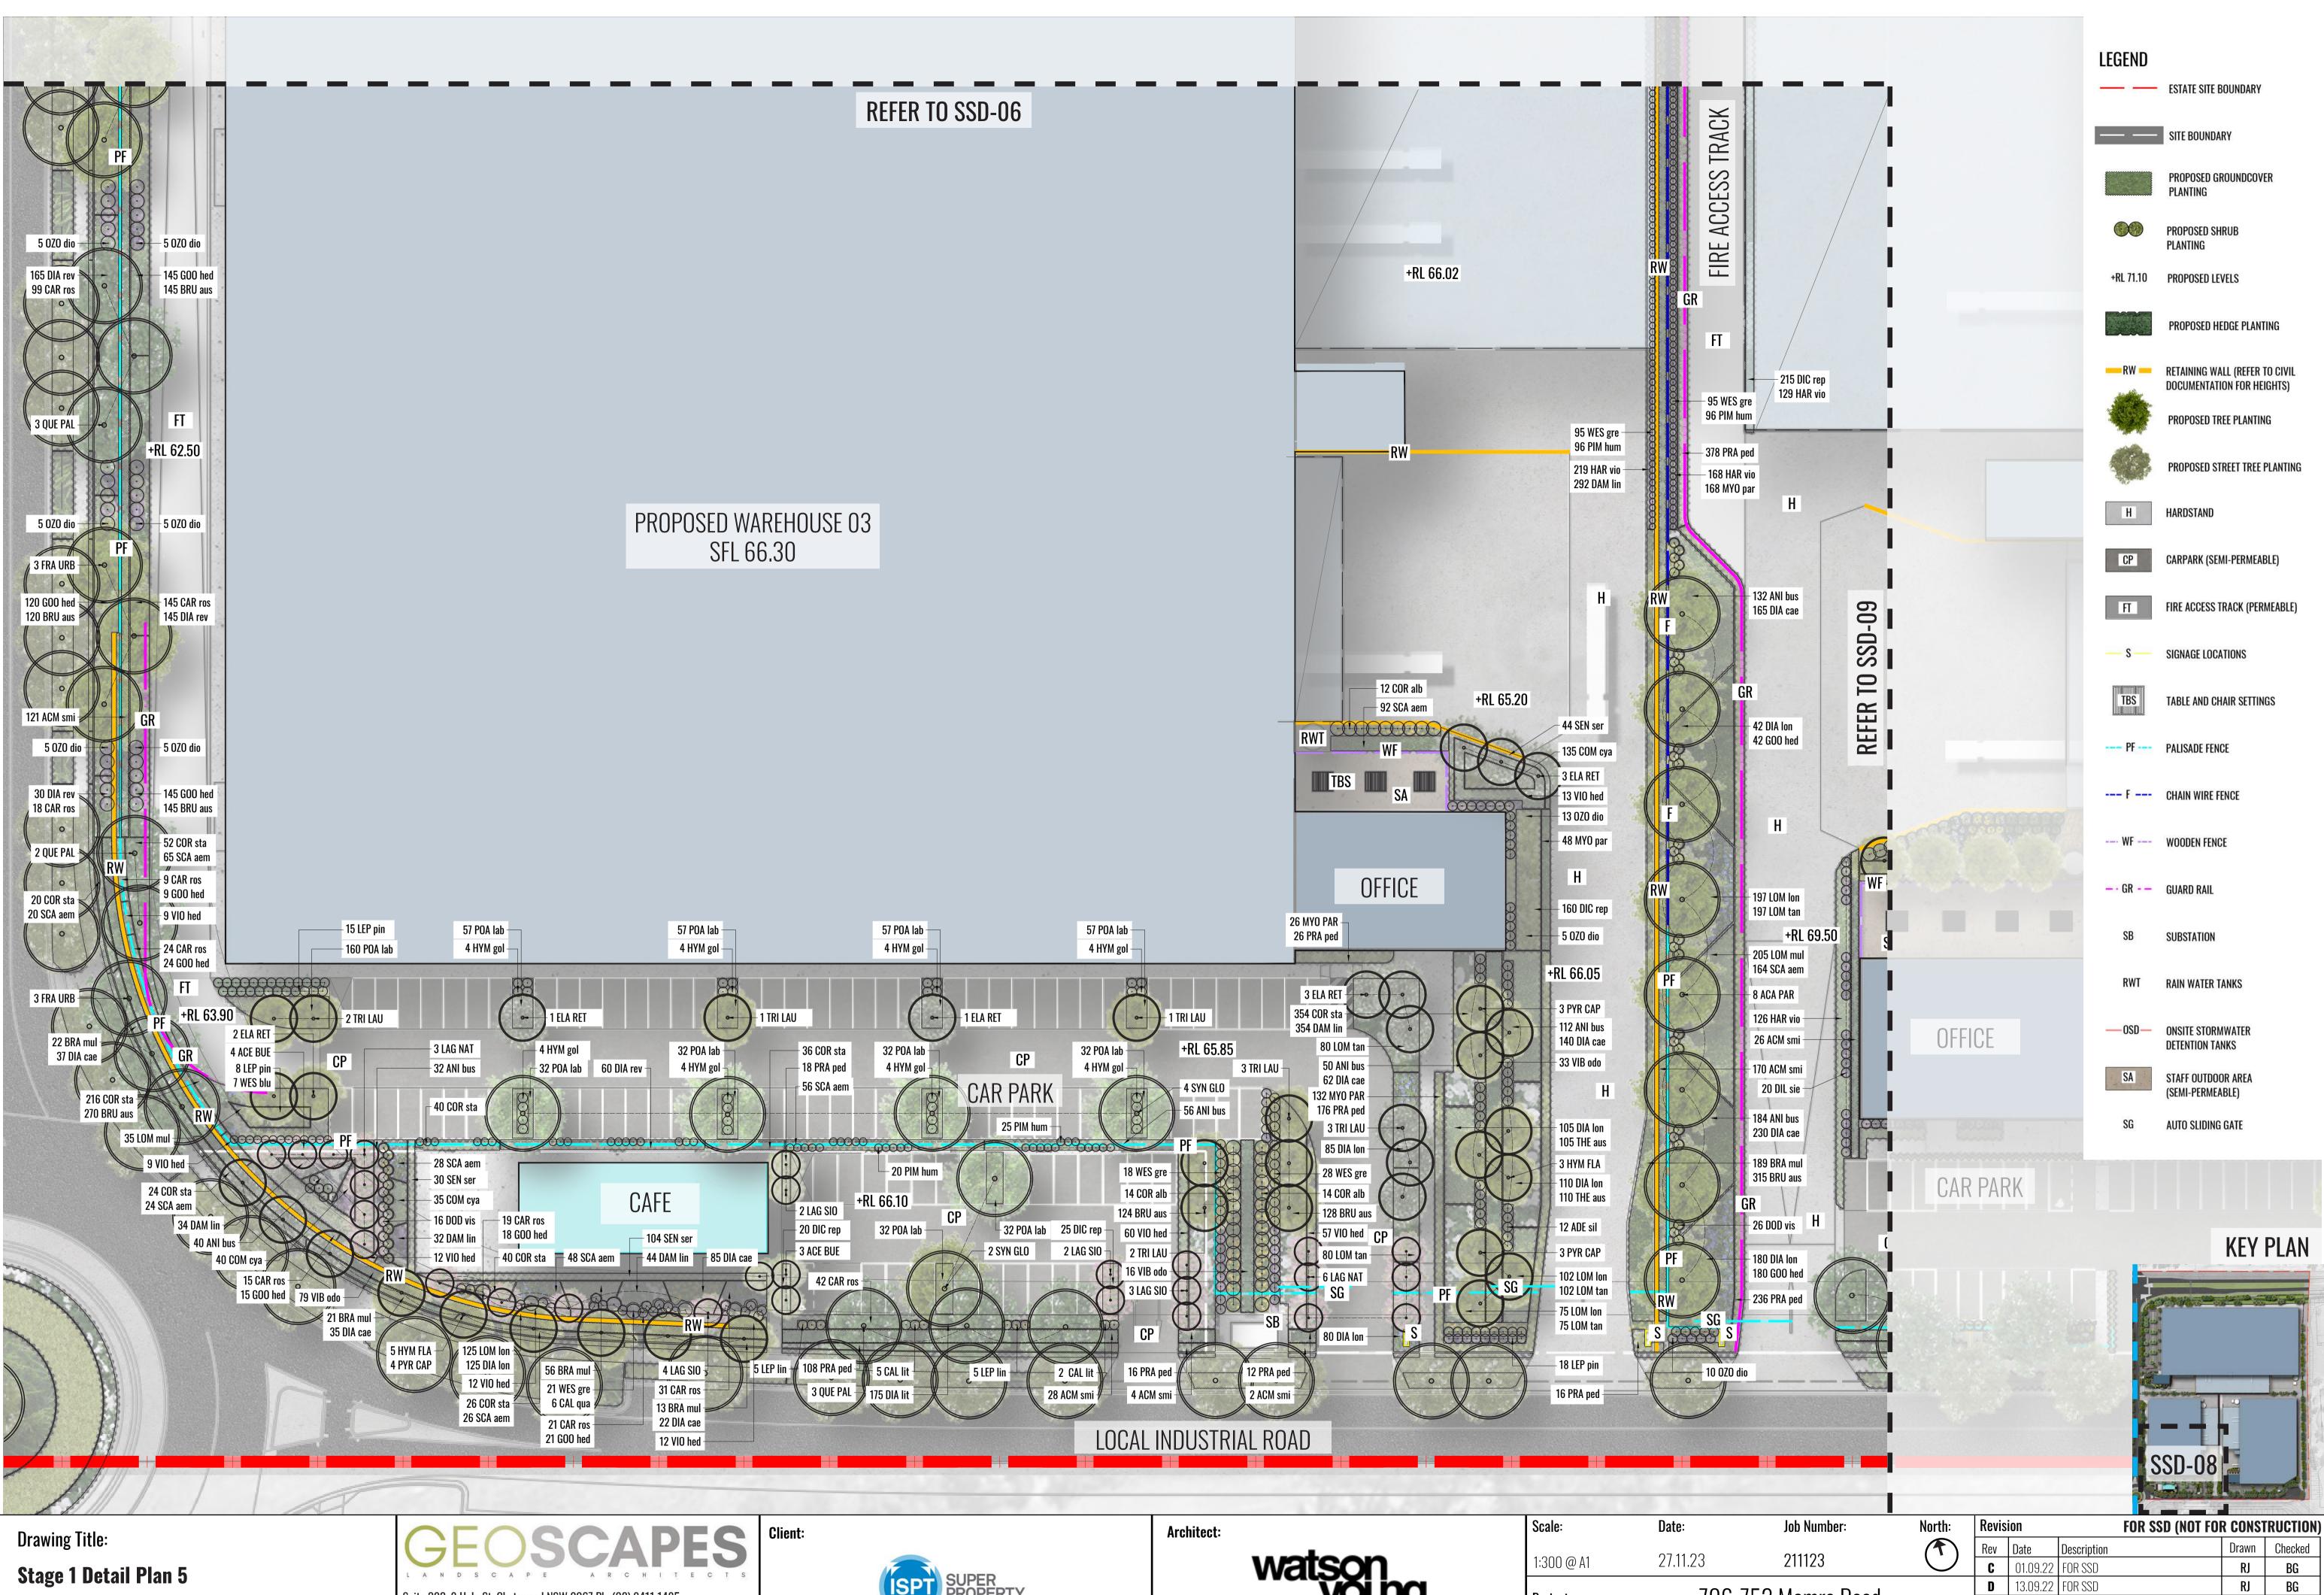

DWG No:

Suite 303, 8 Help St, Chatswood NSW 2067 Ph. (02) 9411 1485 www.geoscapes.com.au ABN 84 620 205 781 ACN 620 205 781 **SSD-08** 




706-752 Mamre Road Project:

Kemps Creek, NSW 2178 F 27.11.23 FOR SSD

**E** 19.09.22 FOR SSD RJ KC

BG


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Job Number:	North:	Revision			FOR SSD (NOT FOR CONSTRUCTION)		
011100		Rev	Date	Description		Drawn	Checked
211123	$\bigcirc$	C	01.09.22	FOR SSD		RJ	BG
Manara Daad		D	13.09.22	FOR SSD		RJ	BG
Mamre Road Kemps Creek, NSW 2178		E	19.09.22	FOR SSD		RJ	BG
		F	27.11.23	FOR SSD		KC	BG
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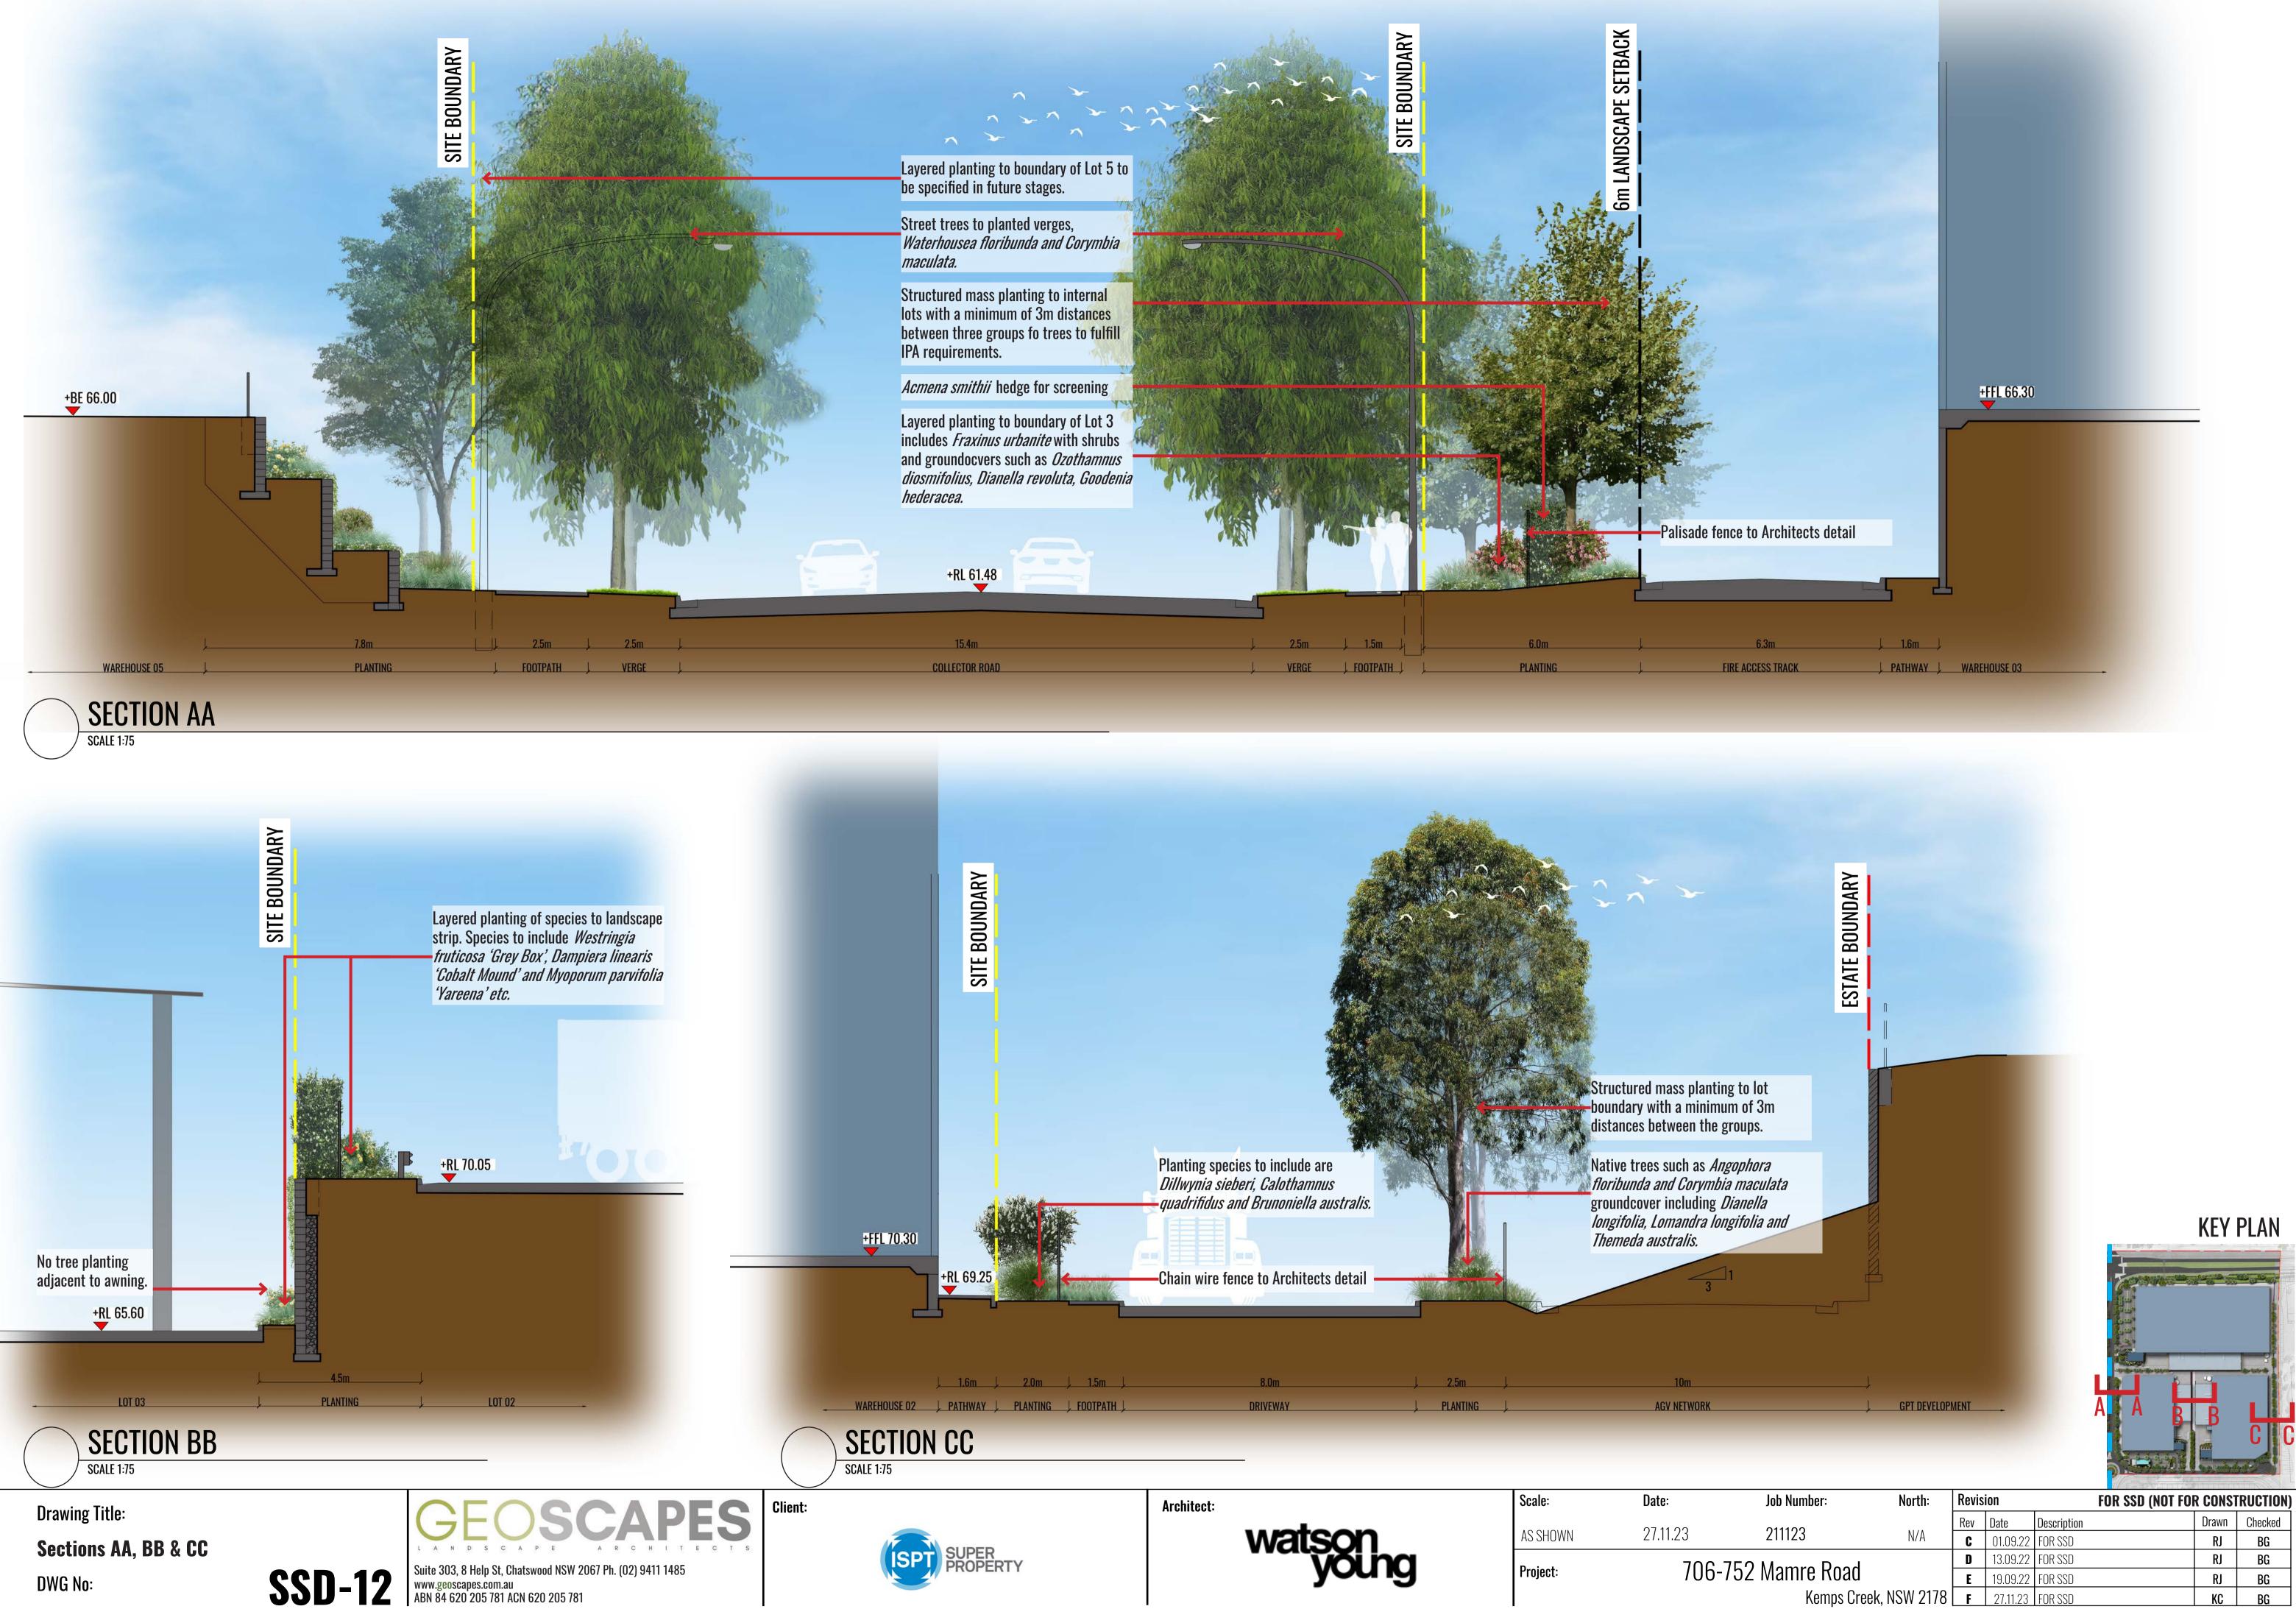

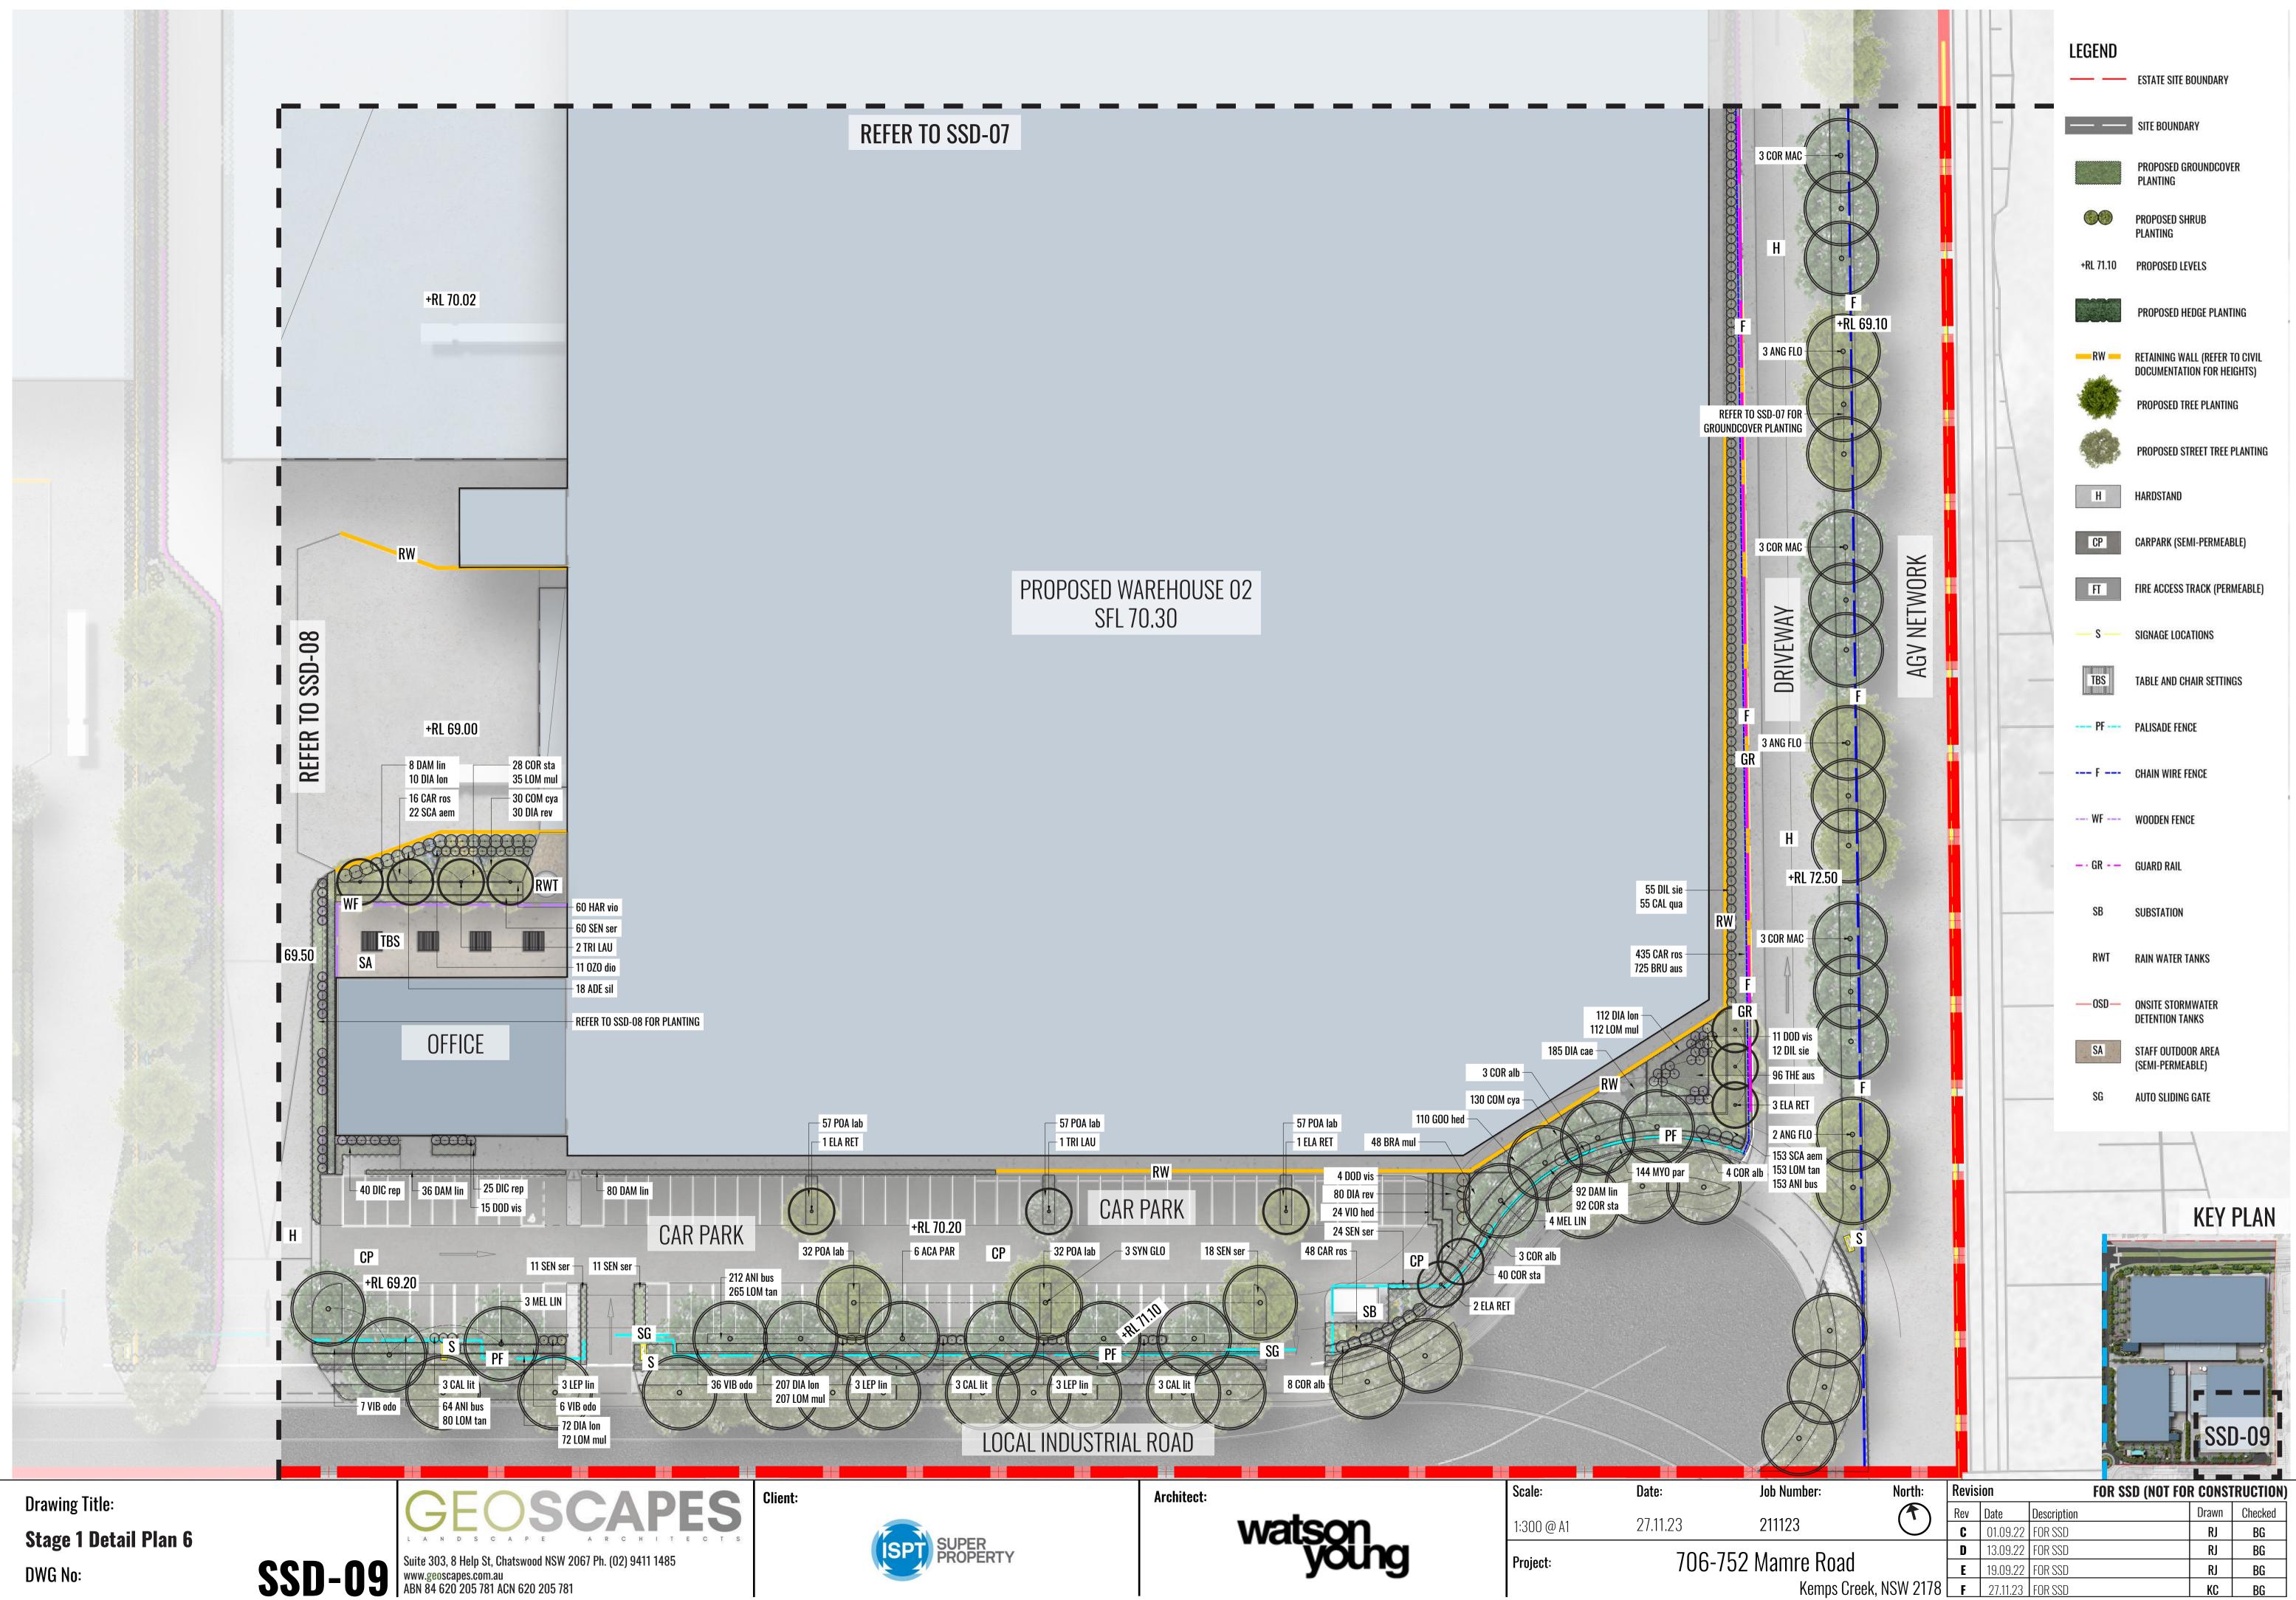
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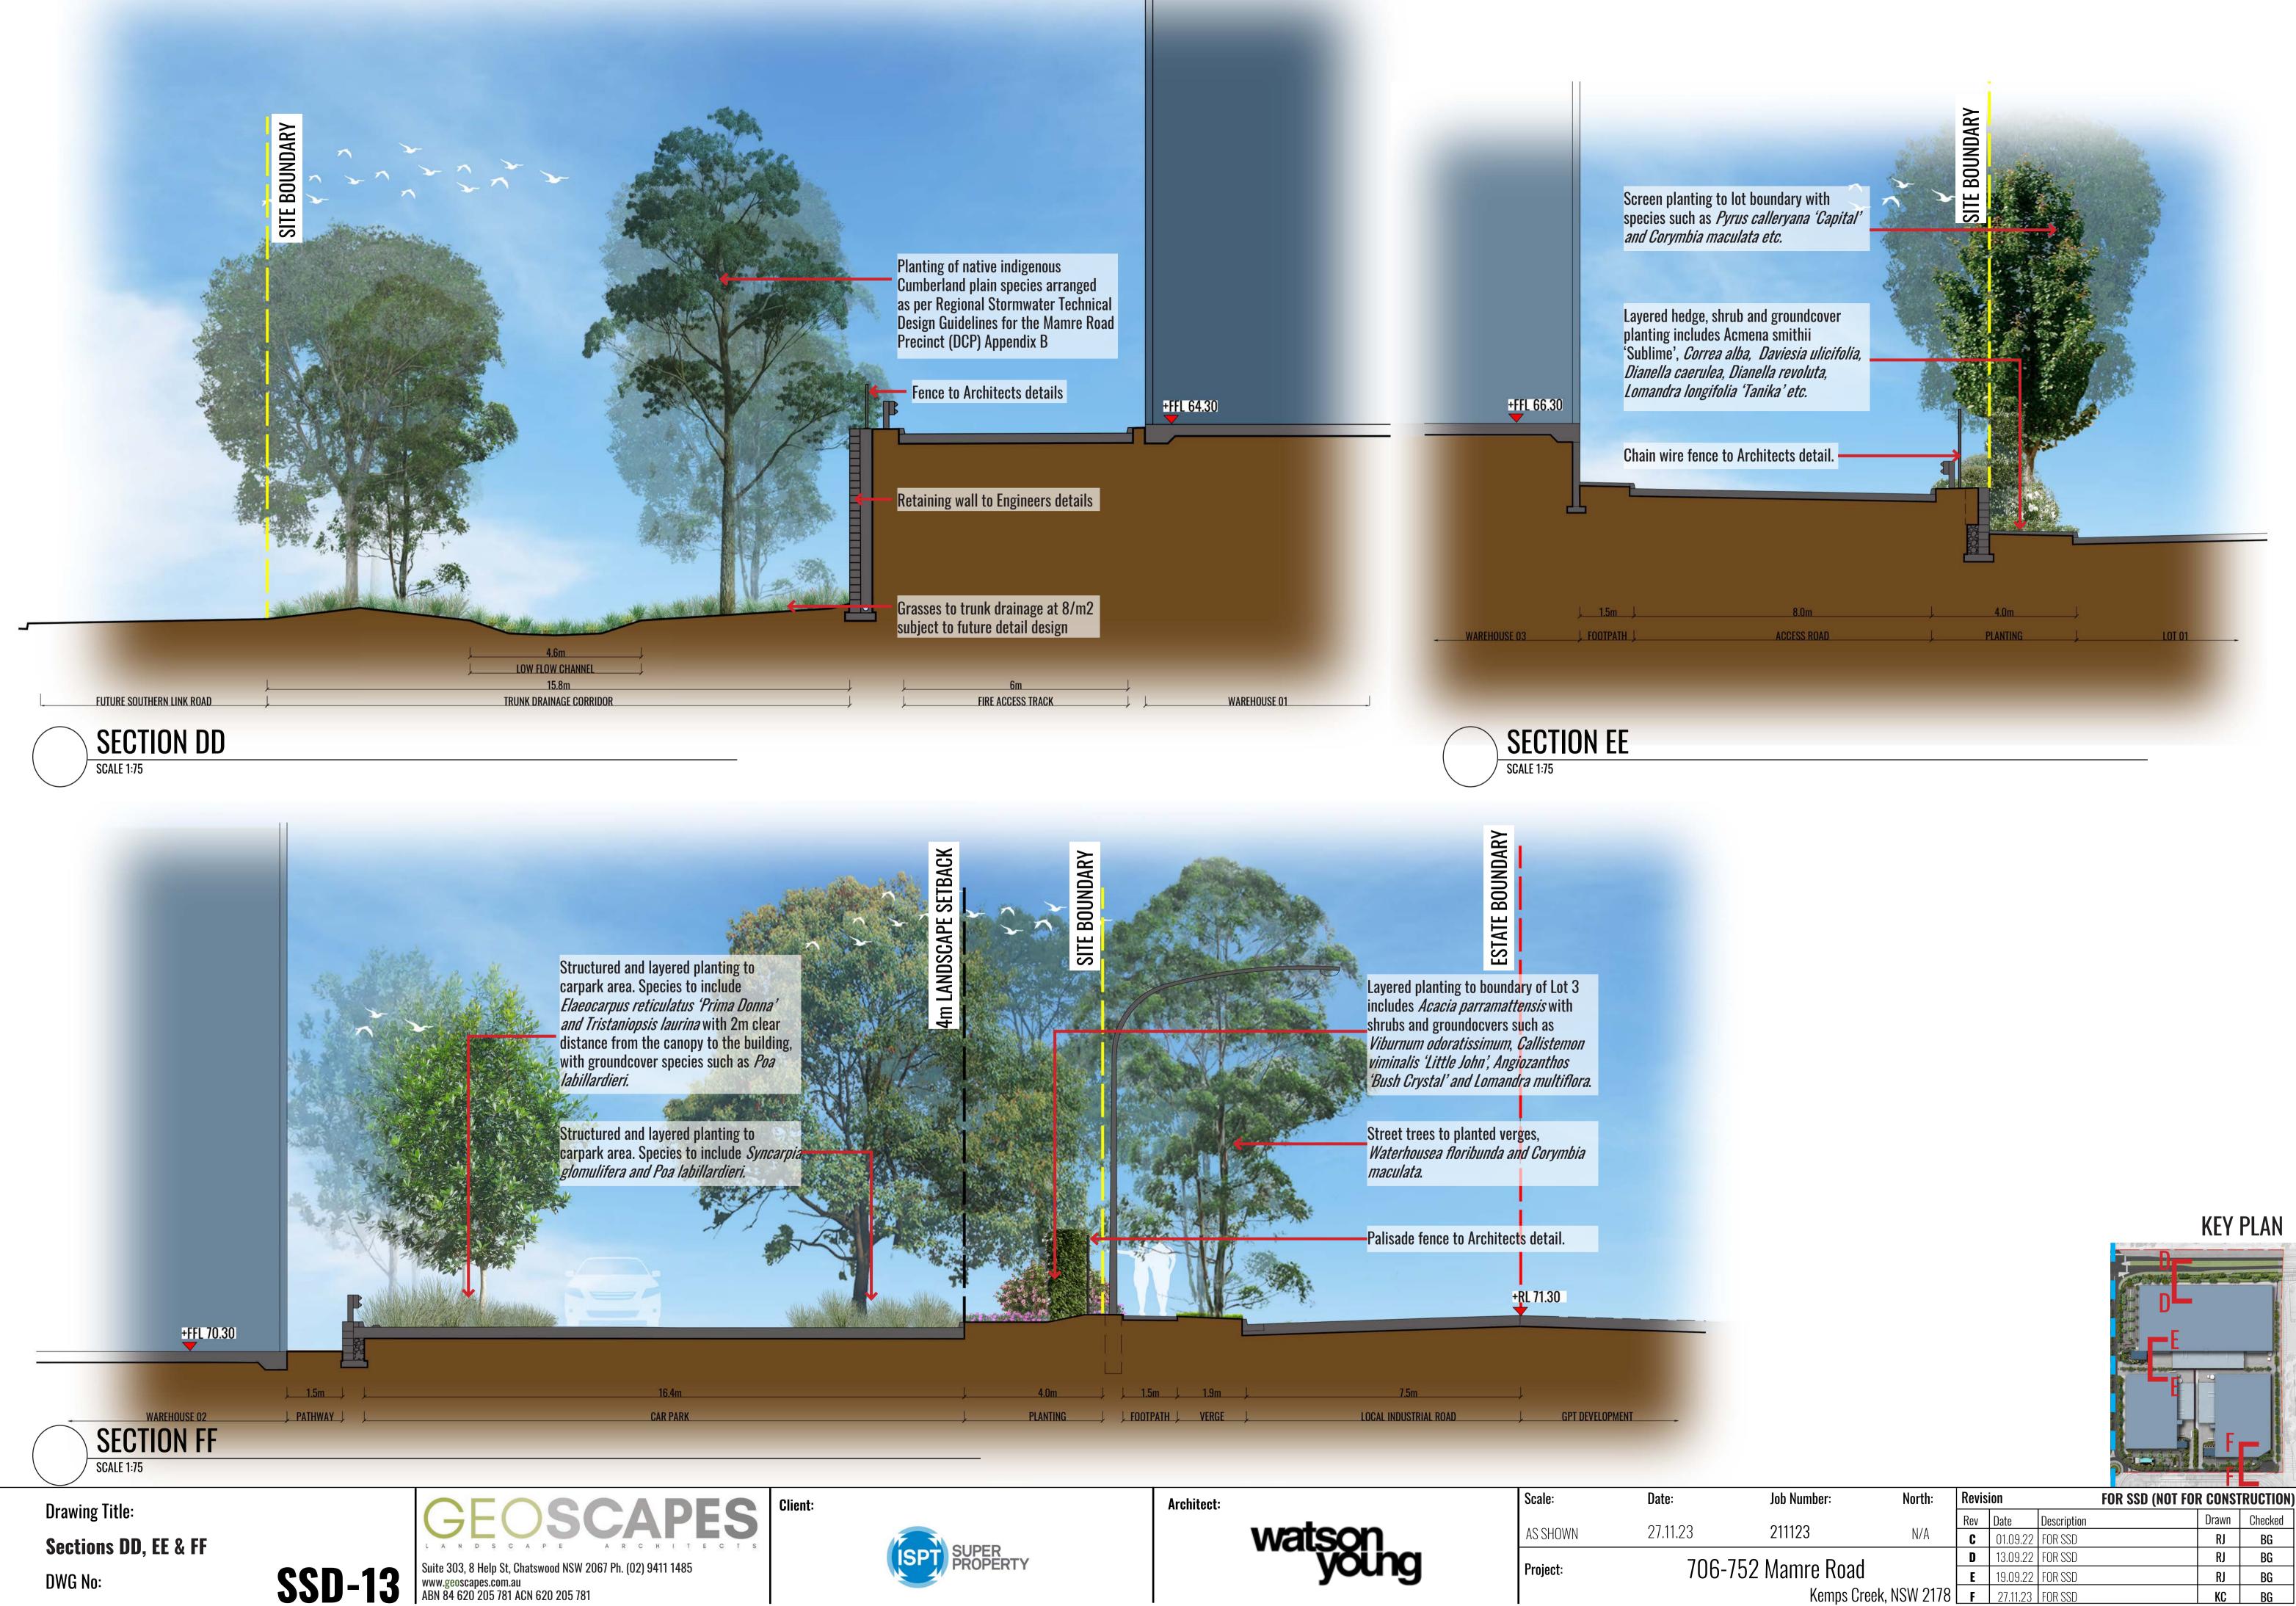





Job Number: North:	Revis	Revision FOR SSD (NOT FOR CONS				
011100	Rev	Date	Description	Drawn	Checked	
211123	C	01.09.22	FOR SSD	RJ	BG	
Maraka Daad	D	13.09.22	FOR SSD	RJ	BG	
? Mamre Road	Ε	19.09.22	FOR SSD	RJ	BG	
Kemps Creek, NSW 2178	3 <b>F</b>	27.11.23	FOR SSD	KC	BG	
·						

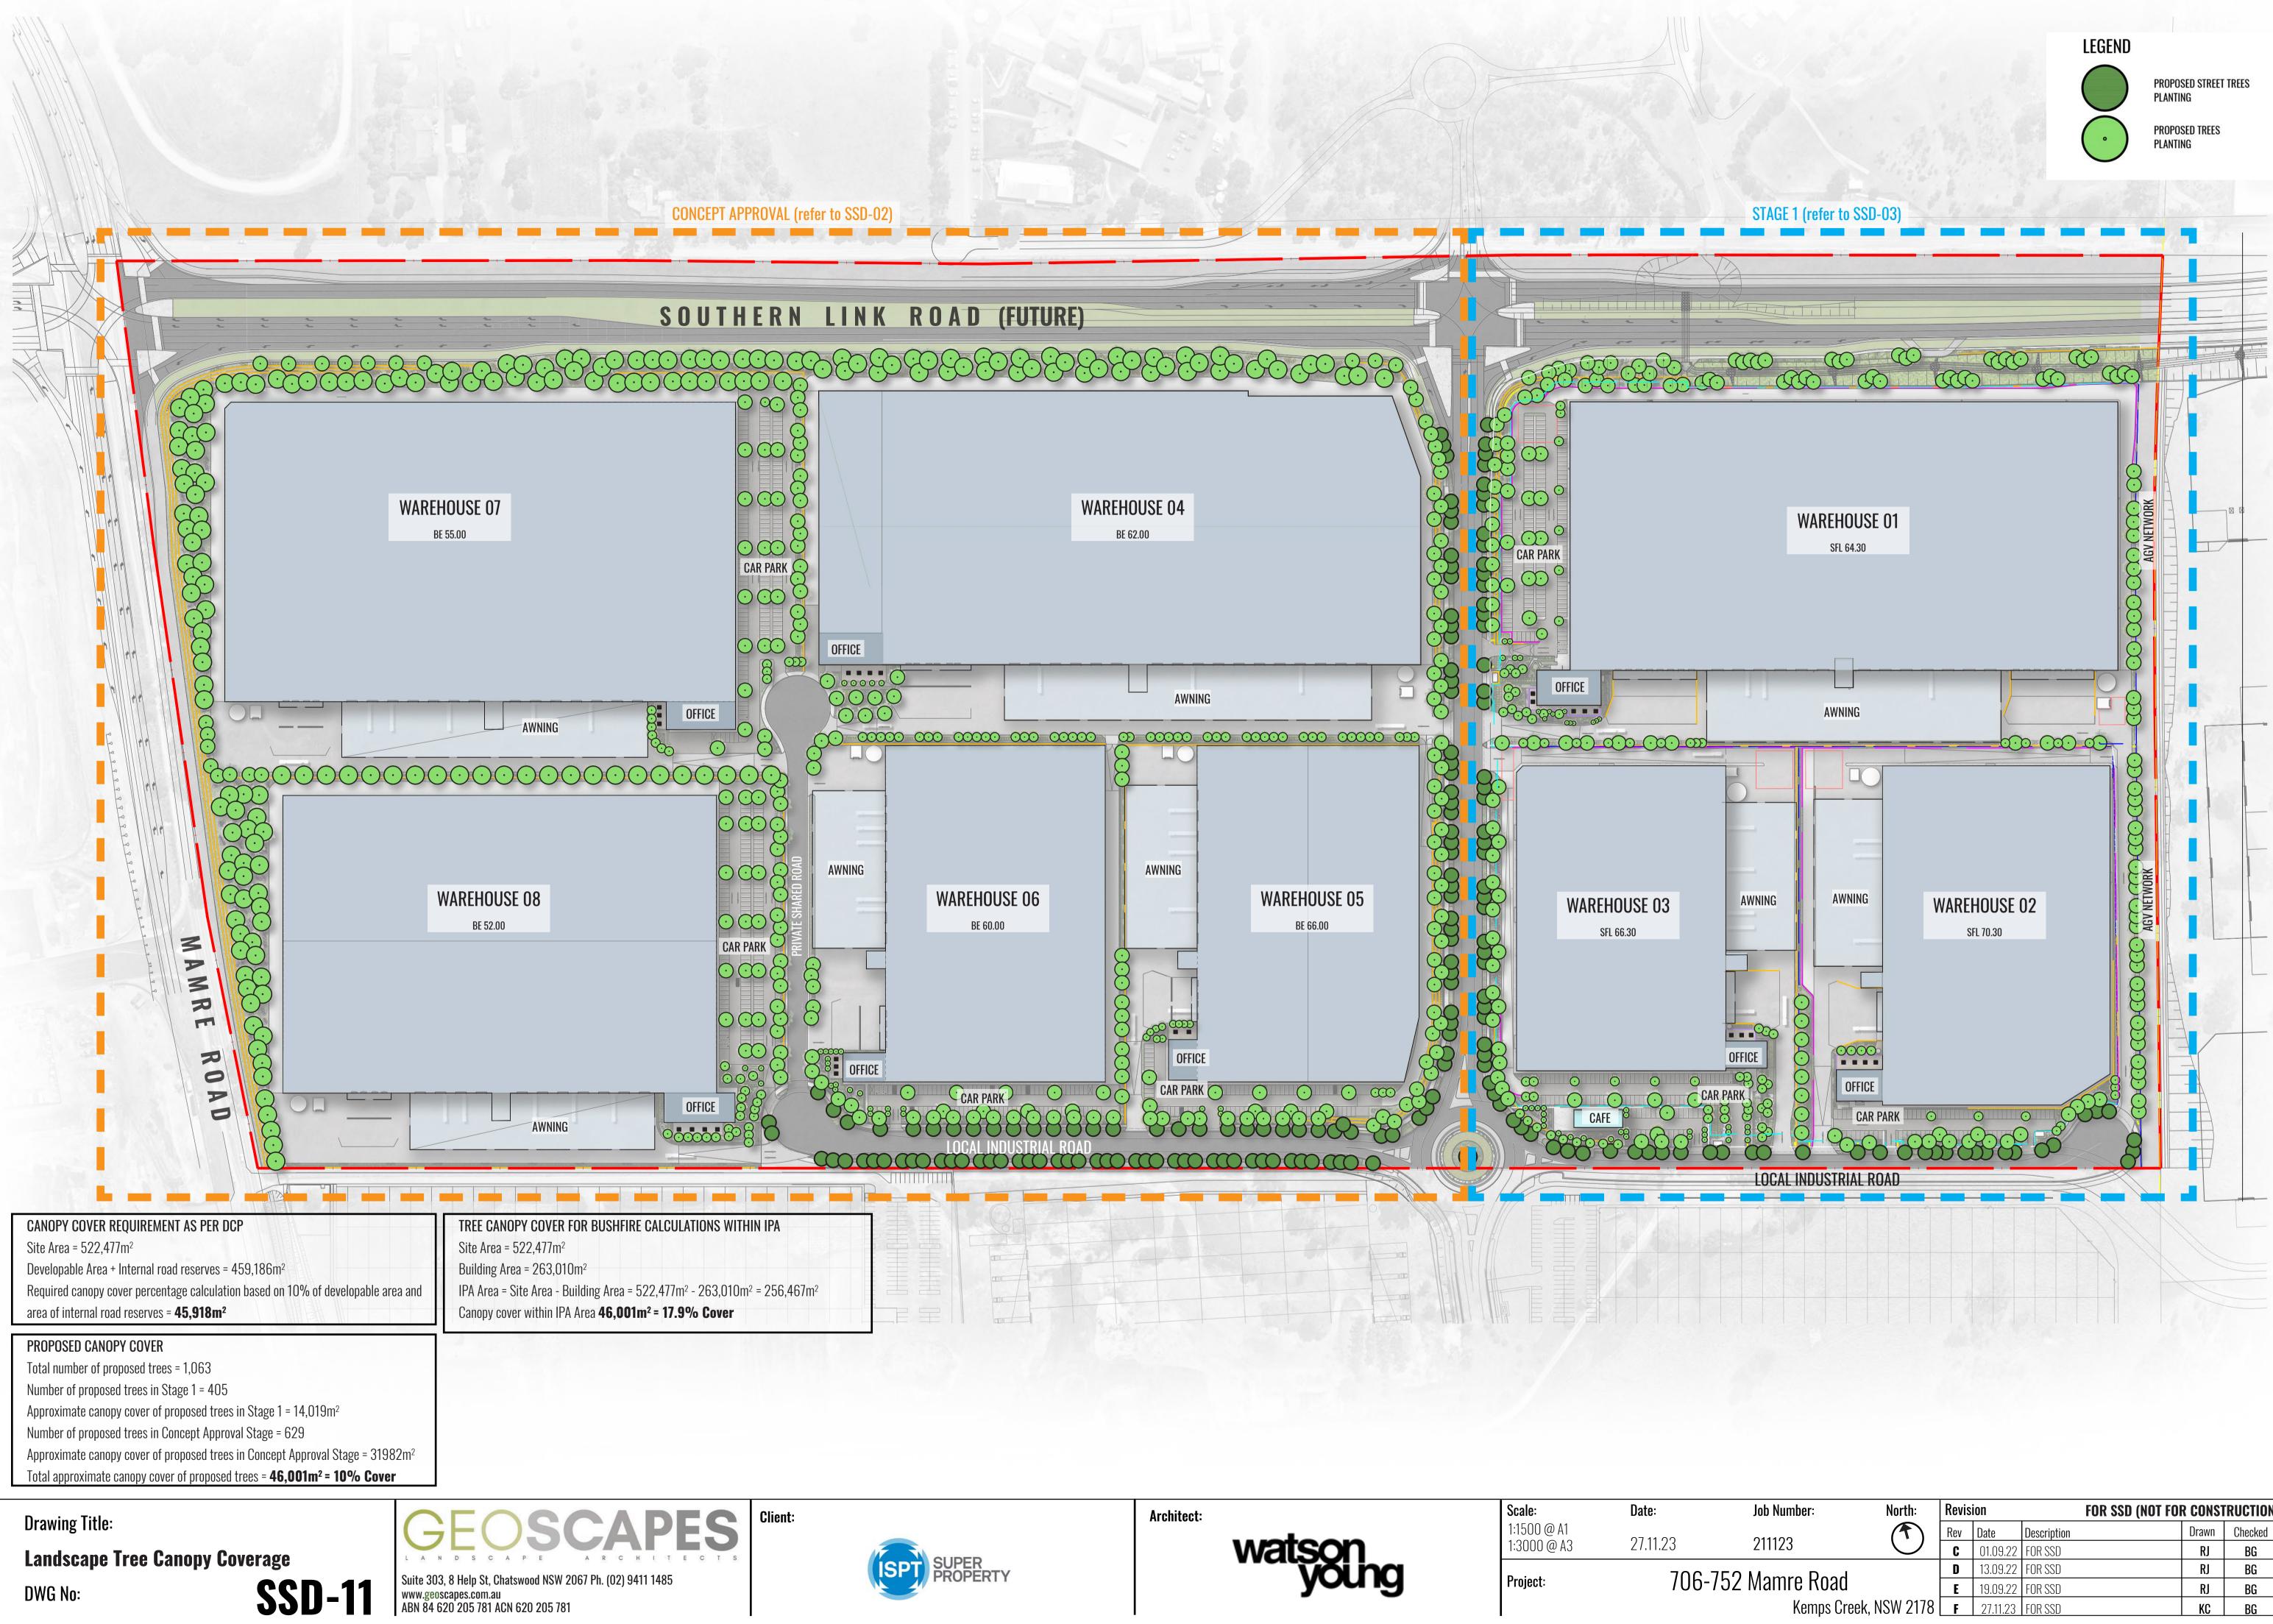

Job Number:	North:	Revis	ion		FOR SSD (NOT FO	R CONST	RUCTION)
011100		Rev	Date	Description		Drawn	Checked
211123	N/A	C	01.09.22	FOR SSD		RJ	BG
Manara Daad	D	13.09.22	FOR SSD		RJ	BG	
Mamre Road		Ε	19.09.22	FOR SSD		RJ	BG
Kemps Creek	, NSW 2178	F	27.11.23	FOR SSD		KC	BG
•							



Job Number:	North:	Revis	ion		FOR SSD (NOT FOI	R CONST	RUCTION)
011100		Rev	Date	Description		Drawn	Checked
211123	N/A	C	01.09.22	FOR SSD		RJ	BG
Manara Daad		D	13.09.22	FOR SSD		RJ	BG
? Mamre Road		Ε	19.09.22	FOR SSD		RJ	BG
Kemps Creek,	NSW 2178	F	27.11.23	FOR SSD		KC	BG
•							

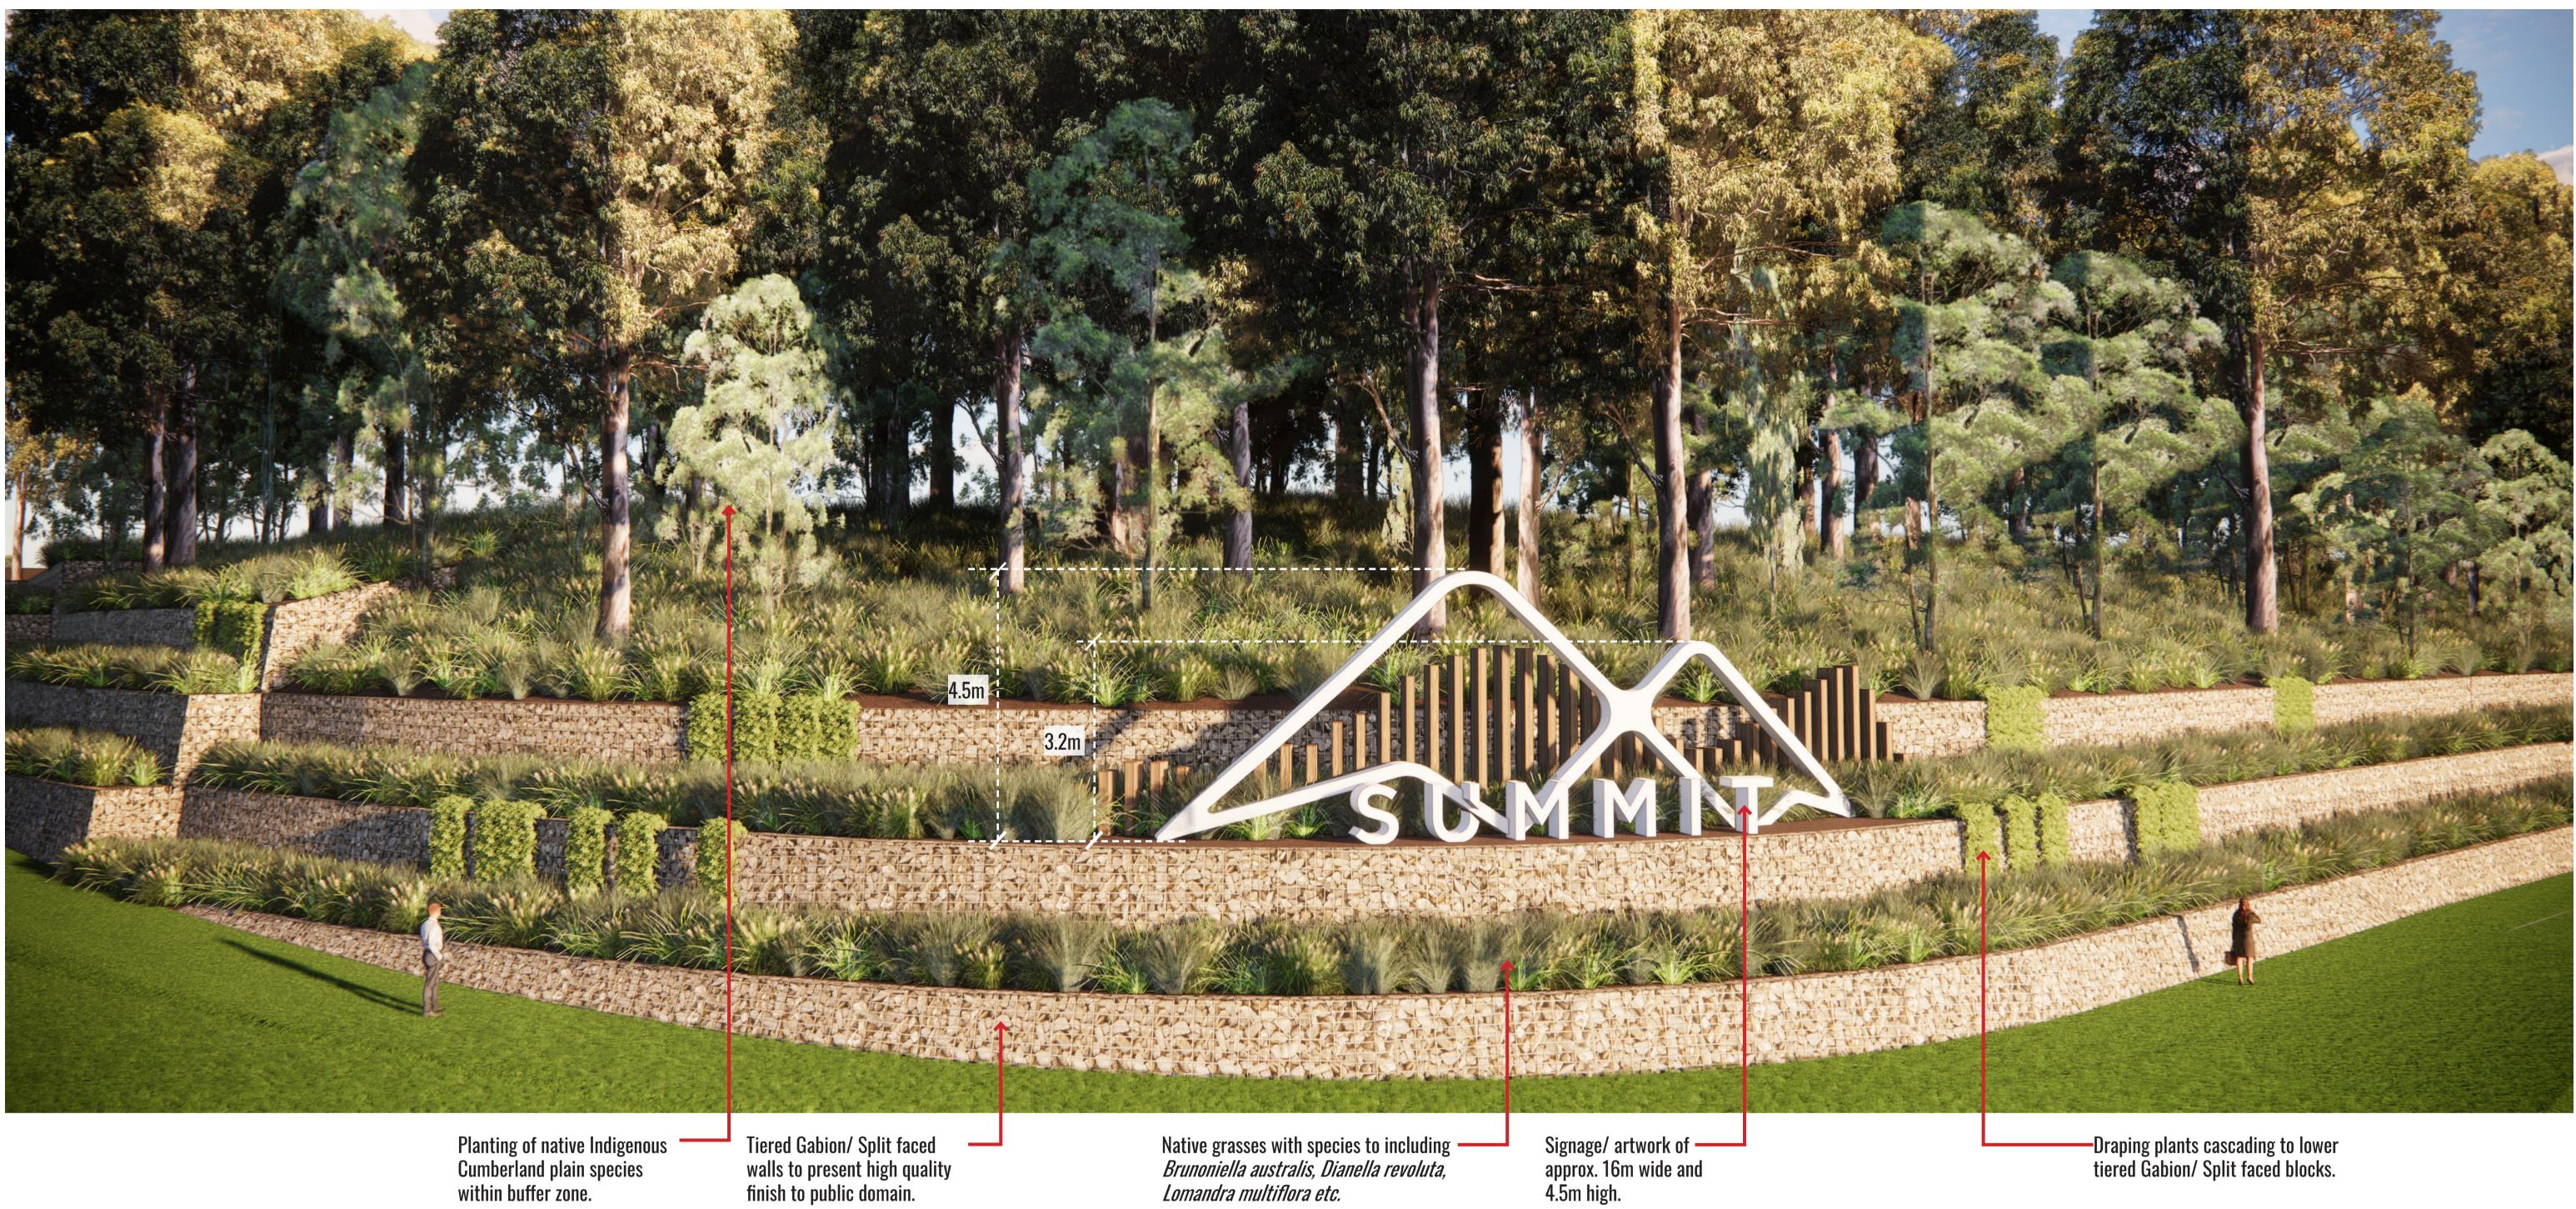

Lomandra multiflora etc.

Planting of native Indigenous Cumberland plain species within buffer zone.

walls to present high quality finish to public domain.

# ENTRY FEATURE CONCEPT VIEW - MAMRE ROAD AND SOUTHERN LINK ROAD

Tiered Gabion/ Split faced blocks with planting

**PRECEDENT IMAGERY** 

Drawing Title:

Mamre Road Intersection Concept Illustration DWG No:



Signage





Architect:



								KEY	PLAN
Scale:	Date:	Job Number:	North:	Revis	ion	FC	DR SSD (NOT FOR	CONST	RUCTION)
N/A	27.11.23	211123	N/A	Rev C	<b>Date</b> 01.09.22	Description FOR SSD		Drawn <b>RJ</b>	Checked BG
Project:	706-7	752 Mamre Road		D E	13.09.22 19.09.22	FOR SSD		RJ RJ	BG BG
		Kemps Cro	eek, NSW 2178			FOR SSD		KC	BG



Signage

# ENTRY FEATURE CONCEPT VIEW - COLLECTOR ROAD AND SOUTHERN LINK ROAD 2

Tiered Gabion/ Split faced blocks with planting

**PRECEDENT IMAGERY** 

Drawing Title:

**Estate Entry Road Concept Illustration SSD-15** DWG No:








Architect:



			and the second			VIEW 2	KEY	PLAN
Scale:	Date:	Job Number:	North:	Revis	ion	FOR SSD (NO	T FOR CONS	(RUCTION)
	27.11.23	211123	N1 / A	Rev		Description	Drawn	Checked
N/A	Z1.11.ZJ	ΖΠΙΖΟ	N/A	C	01.09.22		RJ	BG
Project:	70G_ <sup>-</sup>	757 Mamra Road		D		FOR SSD	RJ	BG
	706-752 Mamre Road			E	19.09.22	FOR SSD	RJ	BG
		Kemps Cr	eek, NSW 2178	F	27.11.23	FOR SSD	KC	BG

# **TYPICAL LANDSCAPE DETAILS**

[REE/SHRUB SIZE AND OUALITY TO BE TO NATSPEC STANDARD. SPECIES IS TO BE AS PER PLAN AND PLANT SCHEDULE. ENSURE ONL' /IGOROUS, DISEASE FREE, WELL MAINTAINED PLANTS ARE USED FAKE CARE TO ENSURE FOLIAGE. BRANCHES. TRUNKS AND ROOT CROWNS ARE NOT DAMAGED BEFORE. DURING AND AFTER PLANTING INSURE OPTIMUM MAINTENANCE AND ESTABLISHMENT OF TREES/SHRUBS OCCURS AS SOON AS THEY ARE AT SITE

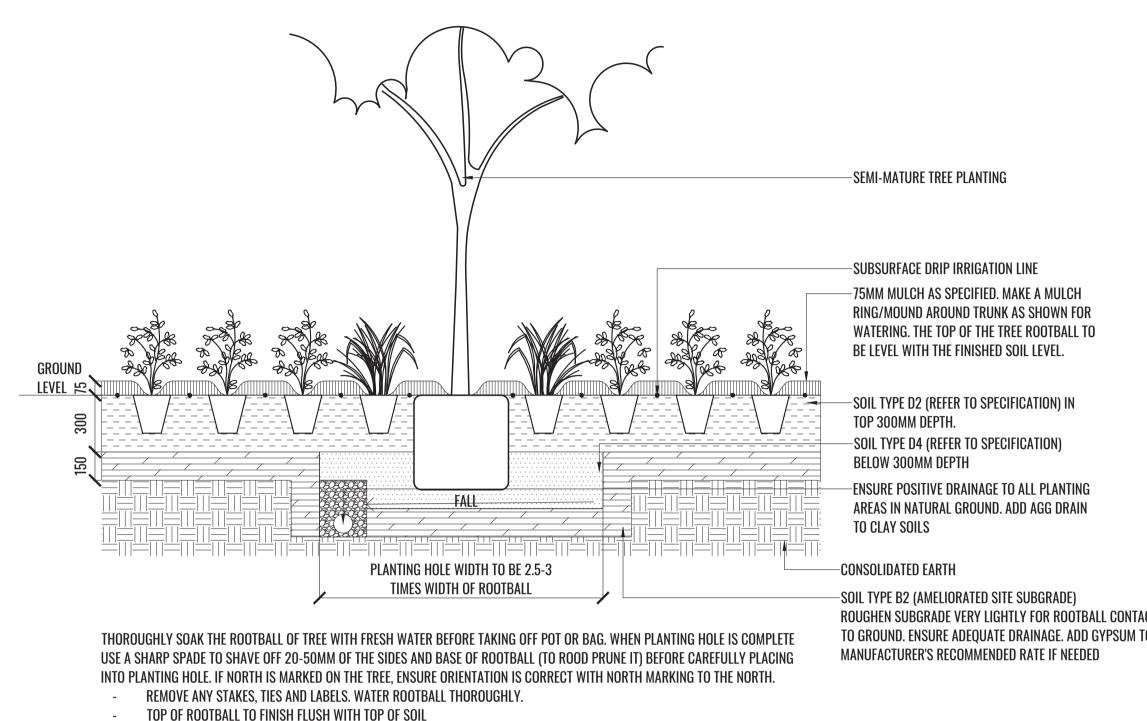

### MASS PLANTING AND TREE DETAIL

# TYPICAL SECTION

# 50mm HESSIAN WEBBING STAPLED TO **OUTSIDE OF STAKES** 50mm x 50mm x 1800mm HWD STAKES DRIVEN SECURELY IN TO THE SUBGRADE **CLEAR OF ROOT BALL OF TREE** THE ROOT ZONE 75mm ORGANIC MULCH FOOTPATH BY OTHERS 300mm DEPTH. PLANTING HOLE 3 x WIDER THAN ROOT BALL. SCARIFY SIDES TO 150mm TO ENCOURAGE ROOT PENETRATION MAXIMUM ROOT SPREAD 100mm SUBSOIL DRAINAGE LINE SURROUNDED WITH GRAVEL AND CONNECTED TO STORMWATER DRAINAGE YPICAL DETAIL OF STREET TREE PLANTING WITH GROUNDCOVERS IN VERGE SCALE 1:20 TYPICAL SECTION **Client**: **Drawing Title: Specifications & Details**

DWG No:

Suite 303, 8 Help St, Chatswood NSW 2067 Ph. (02) 9411 1485 www.geoscapes.com.au ABN 84 620 205 781 ACN 620 205 781 **SSD-16** 

# TYPICAL MAINTENANCE PLAN

Maintenance shall mean the care and maintenance of the landscape works by accepted horticultural practice as rectifying any defects that become apparent in the landscape works under normal use. The landscape contractor shall attend the site on a **weekly basis** to maintain the landscape works commencing from practical completion.

# **Rubbish Removal**

The Landscape Contractor shall undertake rubbish removal from the site on a **weekly basis** to ensure the site remains in tidy condition.

## **Weed Eradication**

Weed growth that may occur in grassed, planted or mulched areas is to be removed using environmentally acceptable methods i.e. non-residual glyphosate herbicide (e.g. 'Roundup', applied in accordance with the manufacturer's direction. **Tree Replacement** 

Trees shall show signs of healthy vigorous growth and be free from disease and not exhibit signs of stress prior to handover to the client. Any trees or plant that die or fail to thrive, or are damaged or stolen will be replaced. Replacement material shall have the initial maintenance period extended in accordance with the landscape contract conditions. Trees and plant materials shall be equal to the minimum requirements of species specified and approved material delivered to site. Should the condition decline from the approved sample the Superintendent reserves the right to reject the tree / plants. Frequency: as required.

## **Stakes**

Adjust and/or replace stakes and ties where required. Remove staking and guying when instructed by the Superintendent

## Pruning

Selective pruning may be required during the establishment period to promote a balanced canopy structure. These activities shall be carried out to the best horticultural and industry practice. All pruned material is to be removed from site. **Mulched Surfaces** 

All planter beds and garden areas shall have a minimum depth of 75mm organic mulch. All mulch is to be free of deleterious matter such as soil, weeds, sticks and should conform to AS 4454. Mulched surfaces are to be kept clean and tidy and free of any deleterious material and foreign matter. Reinstate depths to a uniform level of 75mm with mulch as specified, mulch to be free of any wood material impregnated with CCA or similar toxic treatment. Top up mulch levels prior to handover to client & estate management.

Organic mulch is not to be used within 1m of a building. Use pebble mulch in these areas instead.

### **Soil In Natural Ground**

Non-Australian native garden beds to have soil installed consisting of 50% existing site topsoil (if available) and 50% new topsoil equal or equivalent to 'Greenlife Garden Mix' as supplied by Australian Native Landscapes. Australian native garden beds to have soil installed consisting of 50% existing site topsoil and 50% new topsoil equal or equivalent to 'Native Low 'P' Mix' as supplied by Australian Native Landscapes. Soil to conform to AS4419 refer to typical detail.

# **Pest and Disease Control**

The Landscape Contractor shall spray for pests and disease infestations when the pest and fungal attack has been positively identified and when their populations have increased to a point that will become detrimental to plant growth. Apply all pesticides to manufacturer's directions.

### Frequency: weekly inspection

### **Fertilising**


Generally check for signs of nutrient deficiencies (yellowing of leaves, failure to thrive), and adapt fertiliser regime to suit. Fertiliser should be applied at the beginning and the end of the (summer) growing season. Irrigation

A sub surface dripper style, electrically automated self timed irrigation system is recommended to be supplied to all garden bed areas within the estate. Regular checks are to be made to ensure continued successful operation. The Landscape Contractor shall be responsible for coordination and engagement of a specialist irrigation designer and installation contractor to design, supply and install an automatic subterranean drip irrigation system to all landscape areas. The irrigation system will need to provide designated landscaped areas with enough water for vigorous healthy plant growth. As a general rule landscaped areas will need 20-25mm, species dependant, of water per week. The landscape Contractor will need to monitor natural rainfall using a rain switch in order to set irrigation flow rates accordingly on a monthly basis.


### **Standards**

SCALE 1:20

All grown or purchased plant stock must conform to all the conditions and requirements given in NATSPEC Guide: Specifying Trees. Soils to be in accordance with AS4419, mulching composts and conditioners to be in accordance with AS4454. Soils should conform to best practice specifications as listed in the Landscape Soils Handbook (Simon Leake & Elke Haege 2017).

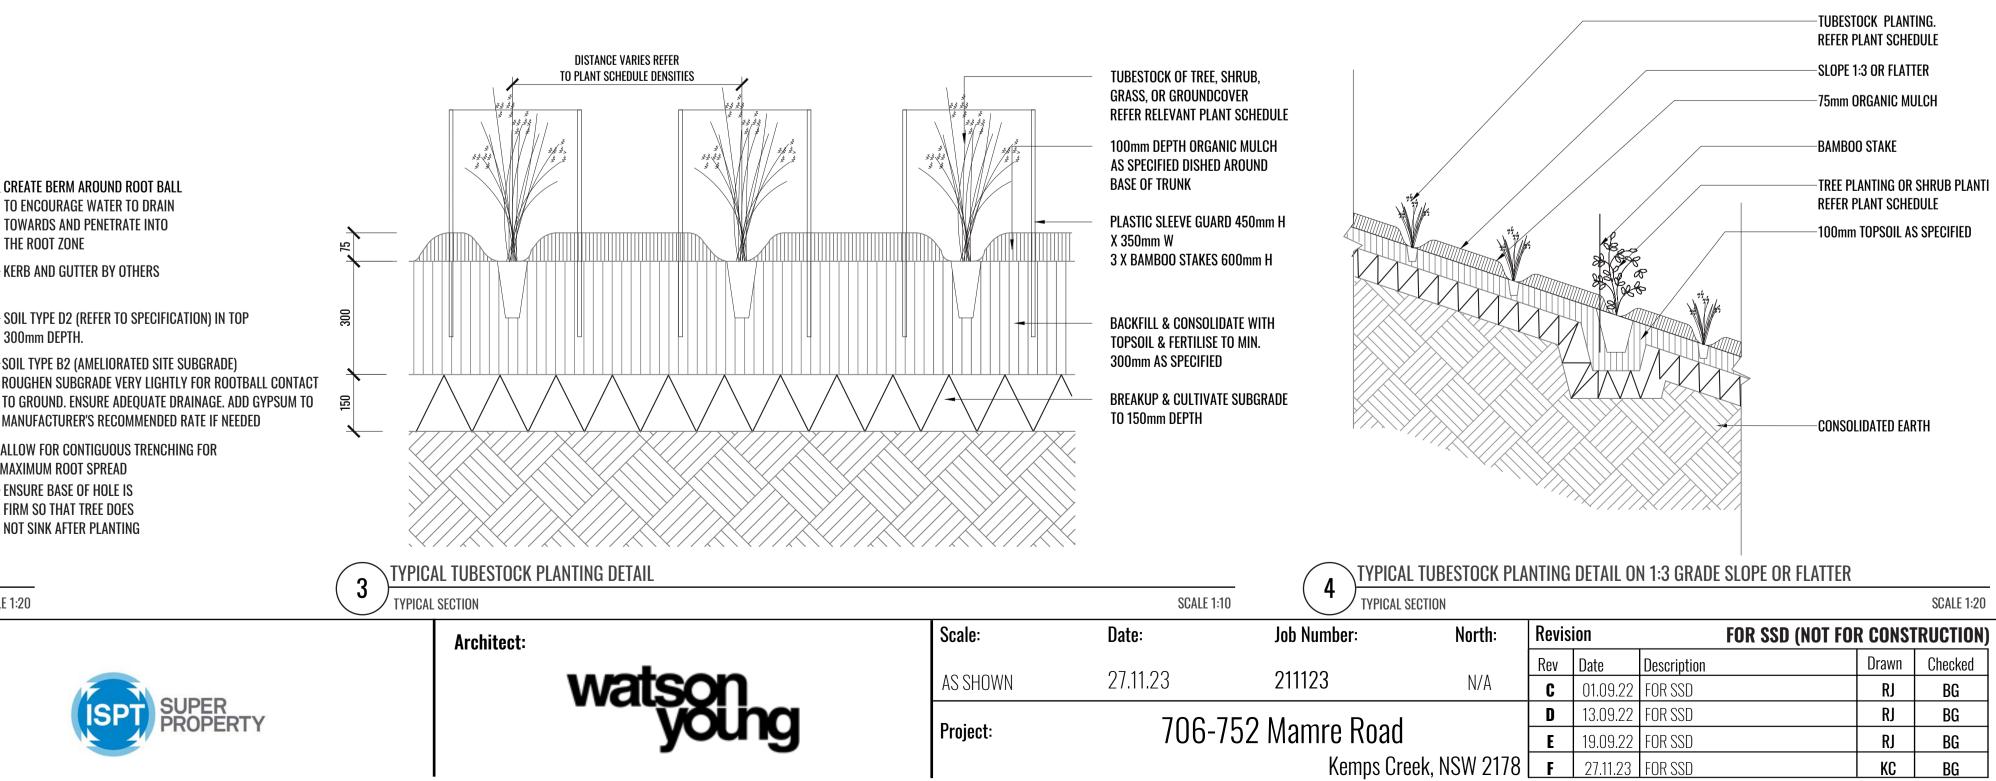

TYPICAL SECTION	UN						30ALE 1:20
Job Number:	North:	Revision FOR SSD (NOT FOR CONSTRU					RUCTION)
011100		Rev	Date	Description		Drawn	Checked
211123	N/A	C	01.09.22	FOR SSD		RJ	BG
Mamra Daad		D	13.09.22	FOR SSD		RJ	BG
? Mamre Road		Ε	19.09.22	FOR SSD		RJ	BG
Kemps Creek,	NSW 2178	F	27.11.23	FOR SSD		KC	BG

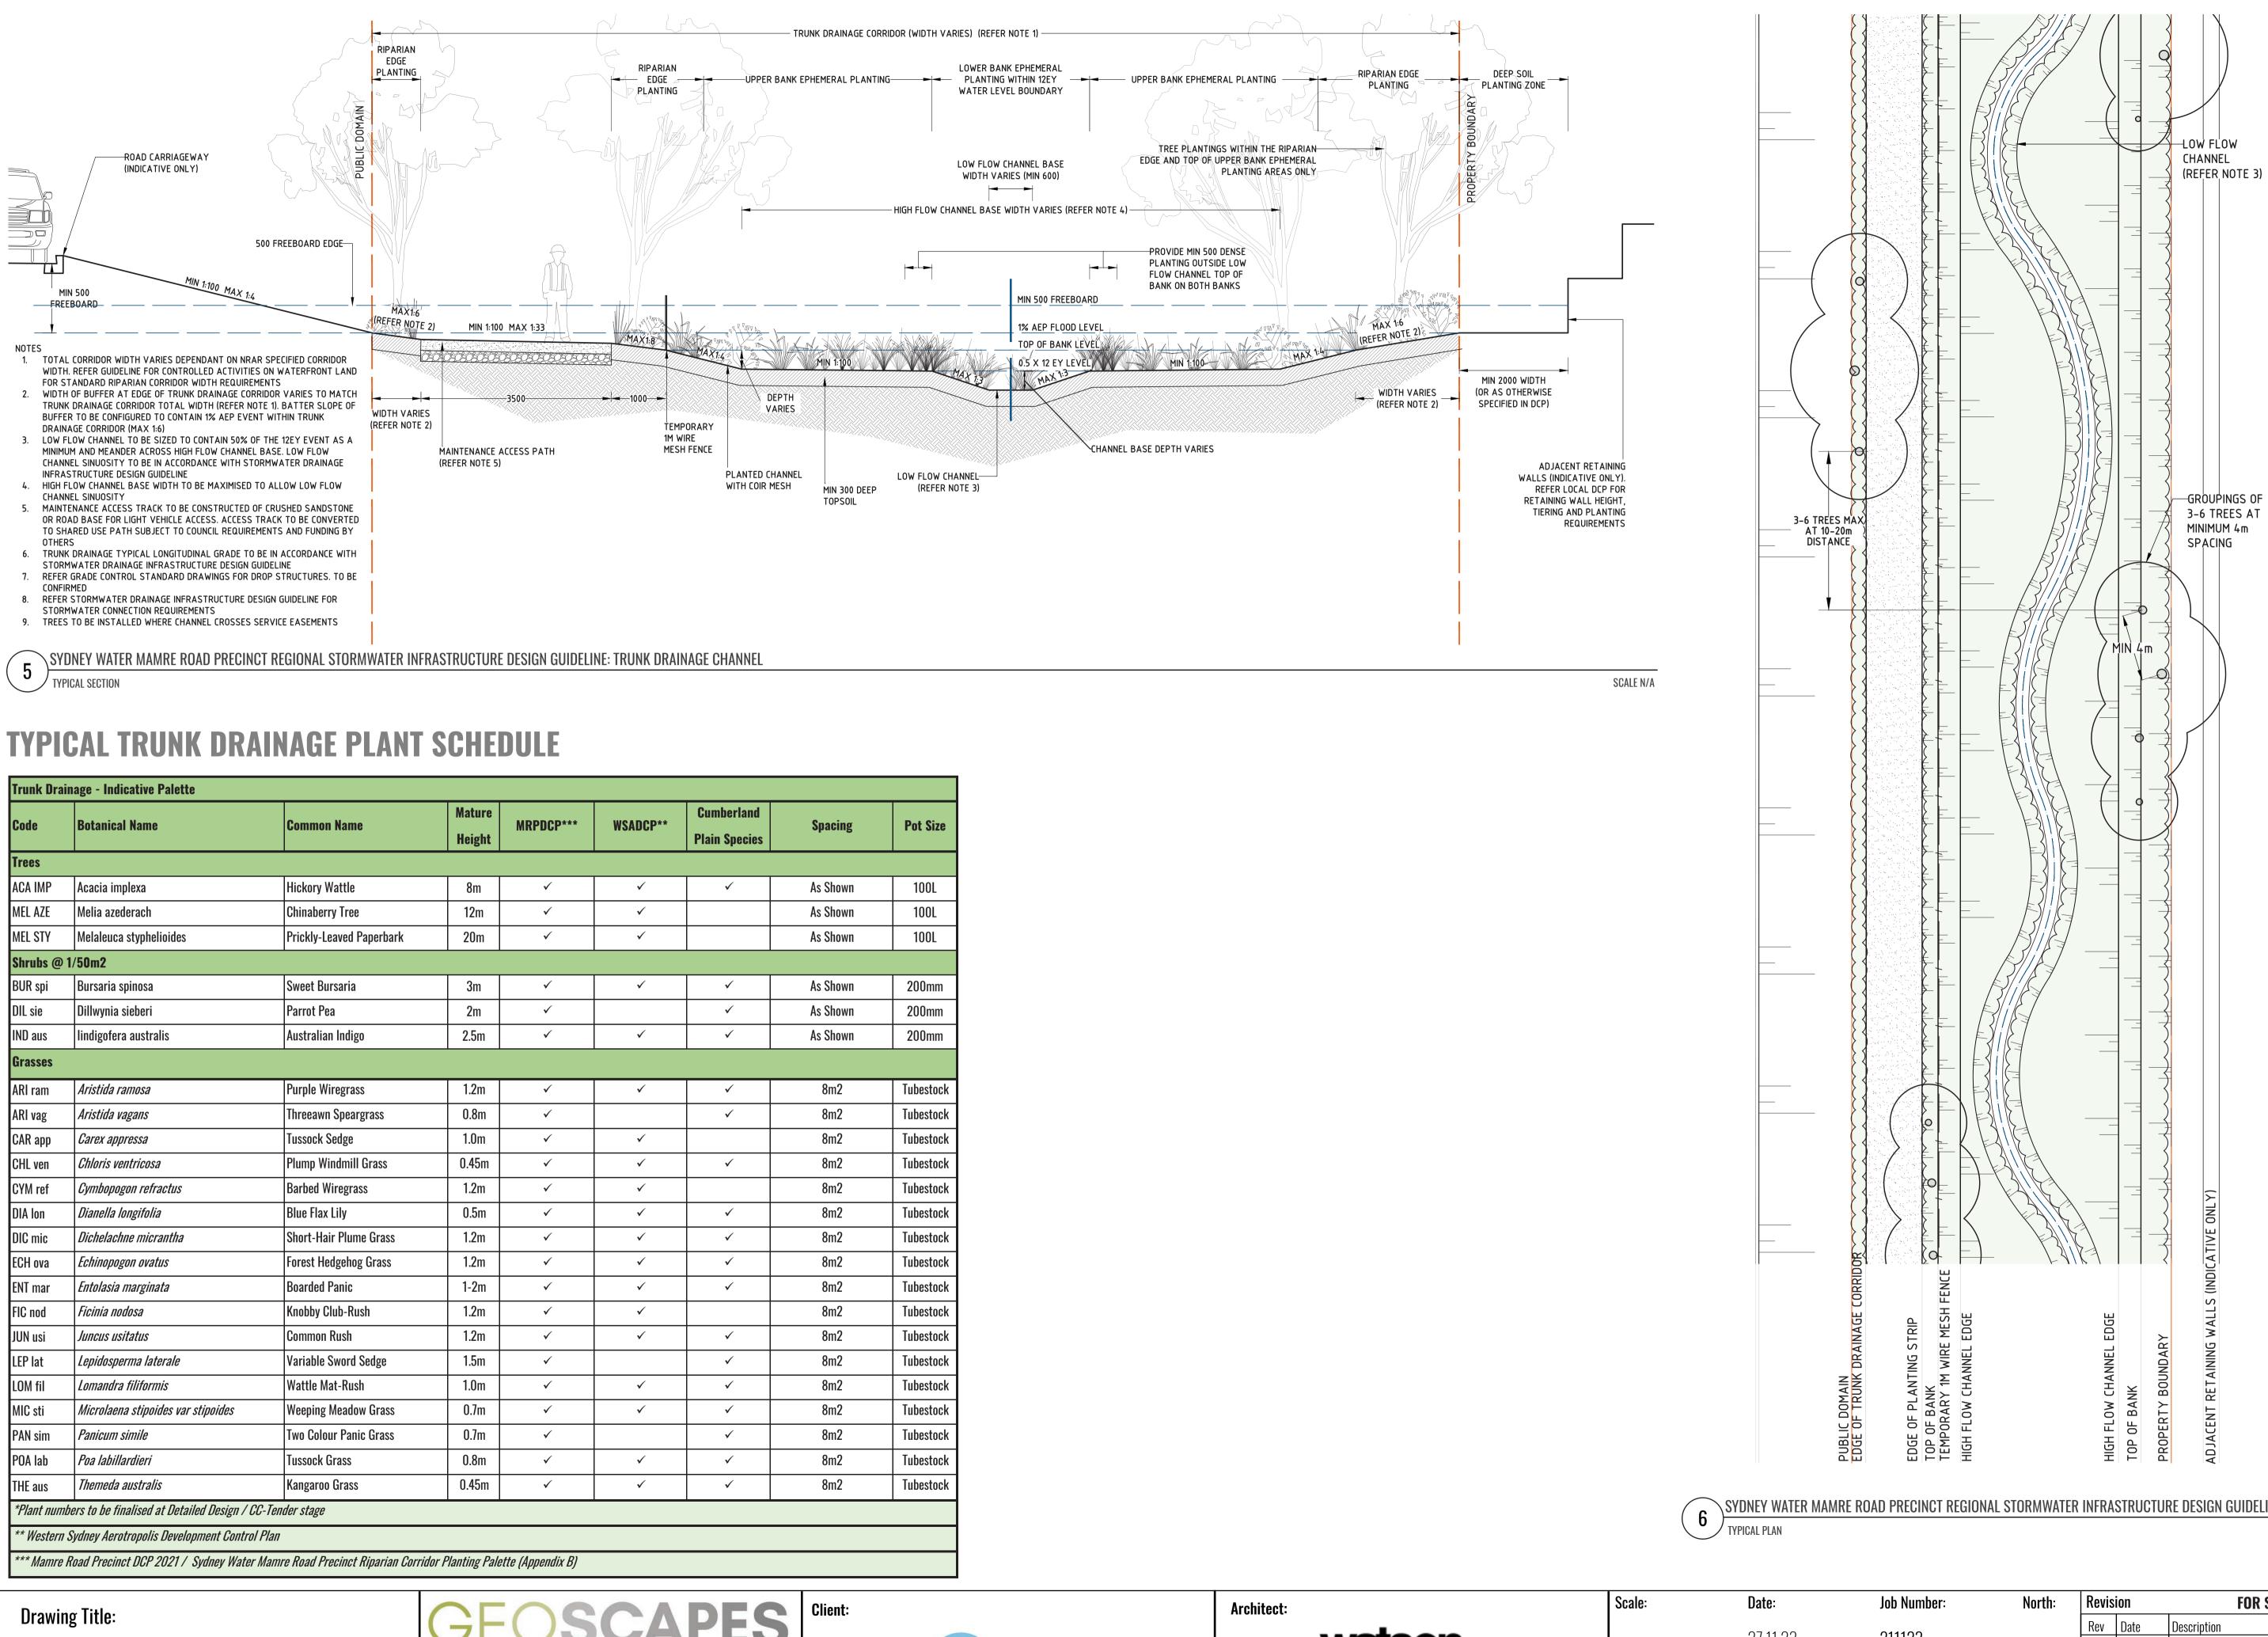

			Mature			0 militari la sel		
Code	Botanical Name	Common Name	Mature	MRPDCP***	WSADCP**	Cumberland	Spacing	Pot
Trees			Height			Plain Species		
Trees	<b>.</b>							
ACA IMP	Acacia implexa	Hickory Wattle	8m	$\checkmark$	✓	✓	As Shown	100
MEL AZE	Melia azederach	Chinaberry Tree	12m	$\checkmark$	✓		As Shown	100
MEL STY	Melaleuca styphelioides	Prickly-Leaved Paperbark	20m	✓	✓		As Shown	100
Shrubs @	1/50m2					-		
BUR spi	Bursaria spinosa	Sweet Bursaria	3m	$\checkmark$	$\checkmark$	~	As Shown	200
DIL sie	Dillwynia sieberi	Parrot Pea	2m	$\checkmark$		~	As Shown	200
IND aus	lindigofera australis	Australian Indigo	2.5m	$\checkmark$	$\checkmark$	✓	As Shown	200
Grasses								
ARI ram	Aristida ramosa	Purple Wiregrass	1.2m	$\checkmark$	✓	✓	8m2	Tubes
ARI vag	Aristida vagans	Threeawn Speargrass	0.8m	$\checkmark$		~	8m2	Tubes
CAR app	Carex appressa	Tussock Sedge	1.0m	$\checkmark$	$\checkmark$		8m2	Tubes
CHL ven	Chloris ventricosa	Plump Windmill Grass	0.45m	$\checkmark$	$\checkmark$	~	8m2	Tubes
CYM ref	Cymbopogon refractus	Barbed Wiregrass	1.2m	$\checkmark$	$\checkmark$		8m2	Tubes
DIA lon	Dianella longifolia	Blue Flax Lily	0.5m	$\checkmark$	$\checkmark$	~	8m2	Tubes
DIC mic	Dichelachne micrantha	Short-Hair Plume Grass	1.2m	$\checkmark$	$\checkmark$	~	8m2	Tubes
ECH ova	Echinopogon ovatus	Forest Hedgehog Grass	1.2m	$\checkmark$	$\checkmark$	~	8m2	Tubes
ENT mar	Entolasia marginata	Boarded Panic	1-2m	$\checkmark$	$\checkmark$	✓	8m2	Tubes
FIC nod	Ficinia nodosa	Knobby Club-Rush	1.2m	$\checkmark$	$\checkmark$		8m2	Tubes
JUN usi	Juncus usitatus	Common Rush	1.2m	$\checkmark$	$\checkmark$	✓	8m2	Tubes
LEP lat	Lepidosperma laterale	Variable Sword Sedge	1.5m	$\checkmark$		✓	8m2	Tubes
LOM fil	Lomandra filiformis	Wattle Mat-Rush	1.0m	$\checkmark$	$\checkmark$	✓	8m2	Tubes
MIC sti	Microlaena stipoides var stipoides	Weeping Meadow Grass	0.7m	$\checkmark$	√	✓	8m2	Tubes
PAN sim	Panicum simile	Two Colour Panic Grass	0.7m	$\checkmark$		✓	8m2	Tubes
POA lab	Poa labillardieri	Tussock Grass	0.8m	$\checkmark$	✓	✓	8m2	Tubes
THE aus	Themeda australis	Kangaroo Grass	0.45m	$\checkmark$	√	✓	8m2	Tubes
*Plant num	bers to be finalised at Detailed Design / Cl	G-Tender stage			l	1 1		

**SSD-17** 

**Trunk Drainage Details** DWG No:

A N D S C A P E A R Suite 303, 8 Help St, Chatswood NSW 2067 Ph. (02) 9411 1485 www.geoscapes.com.au ABN 84 620 205 781 ACN 620 205 781





27.11.23 706-752 **Project**:

# $\searrow$ SYDNEY WATER MAMRE ROAD PRECINCT REGIONAL STORMWATER INFRASTRUCTURE DESIGN GUIDELINE: TRUNK DRAINAGE CHANNEL

SCALE N/A

Job Number: Nor	th:	Revision FOR SSD (NOT FOR CONSTRUC					
011100		Rev	Date	Description		Drawn	Checked
211123		C	01.09.22	FOR SSD		RJ	BG
O Marara Daad		D	13.09.22	FOR SSD		RJ	BG
2 Mamre Road		Ε	19.09.22	FOR SSD		RJ	BG
Kemps Creek, NSW	2178	F	27.11.23	FOR SSD		KC	BG

# **PLANT SCHEDULE**

Code	Botanical Name	Common Name	Mature Height	Spacing / Density	Pot Size	Quantity	Native species	Cumberland Plain (PCT849)/River-flat	<b>Street Ve</b> DAM lin GAZ tom	erge G Da Ga
Street Tree								Forest (PCT835)	LOM tan	Lo
COR MAC	S Corymbia maculata	Spotted Gum	20m	As shown	100L	36	✓	✓	MYO par	Мј
ANG FLO	Angophora floribunda	Rough-barked apple	20m	As shown	100L	1	$\checkmark$	✓	PEN naf	Pe
WAT FLO	Waterhousea floribunda	Weeping Lilly Pilly	15m	As shown	100L	39	~		SCA aem VIO hed	Sc Vit
r <mark>unk D</mark> rain	nage Trees					-			WES num	W
CA IMP	Acacia implexa	Hickory Wattle	8m	As shown	100L	14	~	✓	*Plant num	
MEL AZE	Melia azederach	Chinaberry Tree	12m	As shown	100L	17	✓		**To be tri	
AEL STY	Melaleuca styphelioides	Prickly-Leaved Paperbark	20m	As shown	100L	11	$\checkmark$			
	Annais normantettanais	Developmenta Green Wettle	15m	As shown	100L	14	√	✓		
ACA PAR	Acacia parramattensis Acer buergerianum	Parramatta Green Wattle Trident Maple	15m 8m	As shown	100L	14	•	v		
ANG FLO	Angophora floribunda	Rough-barked apple	20m	As shown	100L	25	~	✓		
NG SUB	Angophora subvelutina	Broad-Leaved Apple	17-25m	As shown	100L	7	~	✓		
COR MAC	Corymbia maculata	Spotted Gum	20m	As shown	100L	29	~	$\checkmark$		
CUP ANA	Cupaniopsis anacardioides	Tuckeroo	10m	As shown	100L	10	$\checkmark$			
ELA RET	Elaeocarpus reticulatus 'Prima Donna'	Blueberry Ash	8m	As shown	100L	20	~		and and a start and	PARTIE NO
FRA URB	Fraxinus pennsylvanica 'Urbanite'	Fraxinus (Ash)	12m	As shown	100L	22			natorine	
HYM FLA	Hymenosporum flavum	Native Frangipani	8m	As shown	100L	22	~	ļ]	A ST	E
LAG NAT	Lagerstoemia indica 'Natchez'	White Crepe Myrtle	6m Em	As shown	100L	15		<u>                                     </u>		K
LAG SIO	Lagerstroemia indica x fauriei 'Sioux' Melaleuca linariifolia	Hot Musk Pink Crepe Myrtle Flax Leaf Paperbark	5m 10m	As shown As shown	100L 100L	18 14	√	✓		de a
PYR CAP	Pyrus calleryana 'Capital'	Ornamental Pear	6m	As shown	100L	23	•	v		
QUE PAL	Quercus palustris 'Pringreen' Green Pillar	Fastigiated Pin Oak	14m	As shown	100L	16				
SYN GLO	Syncarpia glomulifera	Turpentine Tree	20m	As shown	100L	20	✓			
TRI LAU	Tristaniopsis laurina	Water Gum	12m	As shown	100L	20	✓			
Shrubs										
ACM smi	Acmena smithii 'Sublime'	Lily Pilly	2-3m	1.25M Ctrs	200mm	449	✓			
ADE sil	Adenanthos sericeus 'Silver Steak'	Dwarf Woolly Bush	1.5-3m	As shown	200mm	40	~			
BRE obl	Breynia oblongifolia	Coffee Bush	3m	As shown	200mm	23	~			
CAL lit	Callistemon viminalis 'Little John'	Little John Bottlebrush	0.8m	As shown	200mm	85	✓			
CAL qua	Calothamnus quadrifidus	One-sided Botlebrush	1.5-2.5m	As shown	50mm	76	~		the second	
COR alb	Correa alba	Native Fuschia	1.5m	As shown	200mm	163	✓ 			
DAV uli	Daviesia ulicifolia Dillwynia sieberi	Gorse Bitter-Pea Prickly- Parrot Pea	2m 0.5-2.5m	As shown As shown	50mm	96	✓ ✓	✓ ✓	(8)	
DIL sie DOD vis	Dodonaea viscosa subsp. cuneata	Wedge Leaf Hop Bush	1.5-2.5m	As shown	200mm 50mm	101 80	✓ ✓	v √	a state	A
HYM gol	Hymenosporum flavum 'Gold Nugget'	Dwarf Native Fragnipani	0.5-0.75m	As shown	200mm	100	✓		1. Pro	25
LEP pin	Leptospermum 'Pink Cascade'	Pink Cascade Tea Tree	0.5-0.8m	As shown	200mm	70	✓			
OZO dio	Ozothamnus diosmifolius	Rice Flower	1.5m	As shown	50mm	155	$\checkmark$		1000	24
PIM hum	Pimelea humilis 'White Jewel'	Dwarf Rice Flower	0.5m	As shown	50mm	291	$\checkmark$			
VIB odo	Viburnum odoratissimum	Sweet viburnum	3m**	1.75M Ctrs	200mm	211				
WES blu	Westringia 'Blue Gem' [WESO3]	Native Rosemary	1-1.5m	As shown	200mm	105	~			
WES gre	Westringia fruticosa 'Grey Box' [WESO4]	Westringia Grey Box	0.3-0.45m	As shown	200mm	280	~		LANT D	PR
	roundcover				1				THE REAL	
ANI bus	Angiozanthos 'Bush Crystal'	Kangaroo Paw	0.8m	4/m2	140mm	1407	✓			
BRA mul BRU aus	Brachyscome multifidia 'Break O Day'	Rock Daisy Blue Trumpet	0.2-0.3m 0.2m	3/m2	140mm	583	~			
CAR ros	Brunoniella australis Carpobrotus rossii 'White hot'	Native Pig Face	0.2-0.4m	5/m2 3/m2	Tubestock 140mm	2877 1624	✓ ✓	✓		
COM cya	Commelina cyanea	Scuvy Weed	0.2-0.4m	5/m2	Tubestock	647	 ✓	✓		No.
COR sta	Correa alba 'Star Showers'	Native Fuchsia	0.4m	4/m2	Tubestock	1419	✓ ✓	v		
DAM lin	Dampiera linearis 'Cobalt Mound'	Dampiera	0.3m	4/m2	140mm	1411	 ✓			
DIA cae	Dianella caerulea	Blue flax-lily	0.7m	5/m2	Tubestock	3156	$\checkmark$			
DIA lon	Dianella longifolia	Flax Lilly	0.8m	5/m2	Tubestock	3414	$\checkmark$	$\checkmark$		
DIA rev	Dianella revoluta	Native Flax	0.3m	5/m2	Tubestock	2537	$\checkmark$	$\checkmark$	A CAN	
DIC rep	Dichondra repens	Kidney Weed	0.3m	5/m2	Tubestock	485	$\checkmark$	$\checkmark$	and the second of the	Ani
GOO hed	Goodenia hederacea	Forest goodenia	0.5m	4/m2	140mm	1628	~	✓	and the second second	9111/2
HAR vio	Hardenbergia violacea	Purple Coral Pea	0.5m	3/m2	140mm	794	✓	✓		
LOM Ion	Lomandra longifolia	Matrush Mat Duch	1.0m	5/m2	Tubestock	2380	✓ 	<u> </u>		8. S.S.
LOM tan	Lomandra longifolia 'Tanika'	Mat Rush	0.5m	5/m2	Tubestock	3506	√ √	✓	1	- the
LOM mul MYO par	Lomandra multiflora Myoporum parvifolia 'Yareena' [PARV01]	Mat Rush Creeping Boobialla	0.5-0.6m 0.1-0.2m	5/m2	Tubestock 140mm	3163 795	✓ ✓	×		
POA lab	Poa labillardieri	Tussock Grass	0.1-0.2m 0.5m	3/m2 5/m2	Tubestock	2071			An-	
PRA ped	Pratia purpurascens	Whiteroot	0.1-0.2m	5/m2 4/m2	Tubestock	1521	✓ ✓	√	A HI	
SEN ser	Senecio serpens	Blue Chalksticks	0.3m	3/m2	140mm	428	• •	· ·		
SCA aem	Scaevola aemula	Fan Flower	0.5m	4/m2	140mm	1304	~			
	There do another line	Kangaroo Grass	0.8m	5/m2	Tubestock	2706	✓	$\checkmark$		
THE aus	Themeda australis	Naligat ou cit ass	0.011	JIIIZ						and the second s


Drawing Title: **Plant Schedule and Imagery** DWG No:

A R C H I T E C T S **Suite 303, 8 Help St, Chatswood NSW 2067 Ph. (02) 9411 1485** www.geoscapes.com.au ABN 84 620 205 781 ACN 620 205 781

**Client**:

|--|

Street Ver	ge Grasses + Groundcover							
DAM lin	Dampiera linearis 'Cobalt Mound'	Dampiera	0.3m	4/m2	Tubestock	1248	~	
GAZ tom	Gazania tomentosa	Silver Leaf Gazania	0.3m	4/m2	Tubestock	632		
LOM tan	Lomandra longifolia 'Tanika'	Mat Rush	0.4m	5/m2	Tubestock	1698	~	
MYO par	Myoporum parvifolia 'Yareena' [PARVO1]	Creeping Boobialla	0.2m	3/m2	Tubestock	966	✓	
PEN naf	Pennisetum 'Nafray'	Foxtail Fountain Grass	0.7m	5/m2	Tubestock	540	~	
SCA aem	Scaevola aemula	Fan Flower	0.4m	4/m2	Tubestock	928	✓	
VIO hed	Viola hederacea	Native Violet	0.3m	4/m2	Tubestock	1248	✓	
WES num	Westringia fruticosa 'Mundi'	Native Rosemary	0.4m	6/m2	200mm	2010	✓	
*Plant num	bers to be finalised at Detailed Design / CC-Te	nder stage			·			•
**To be trin	nmed to 3m height							

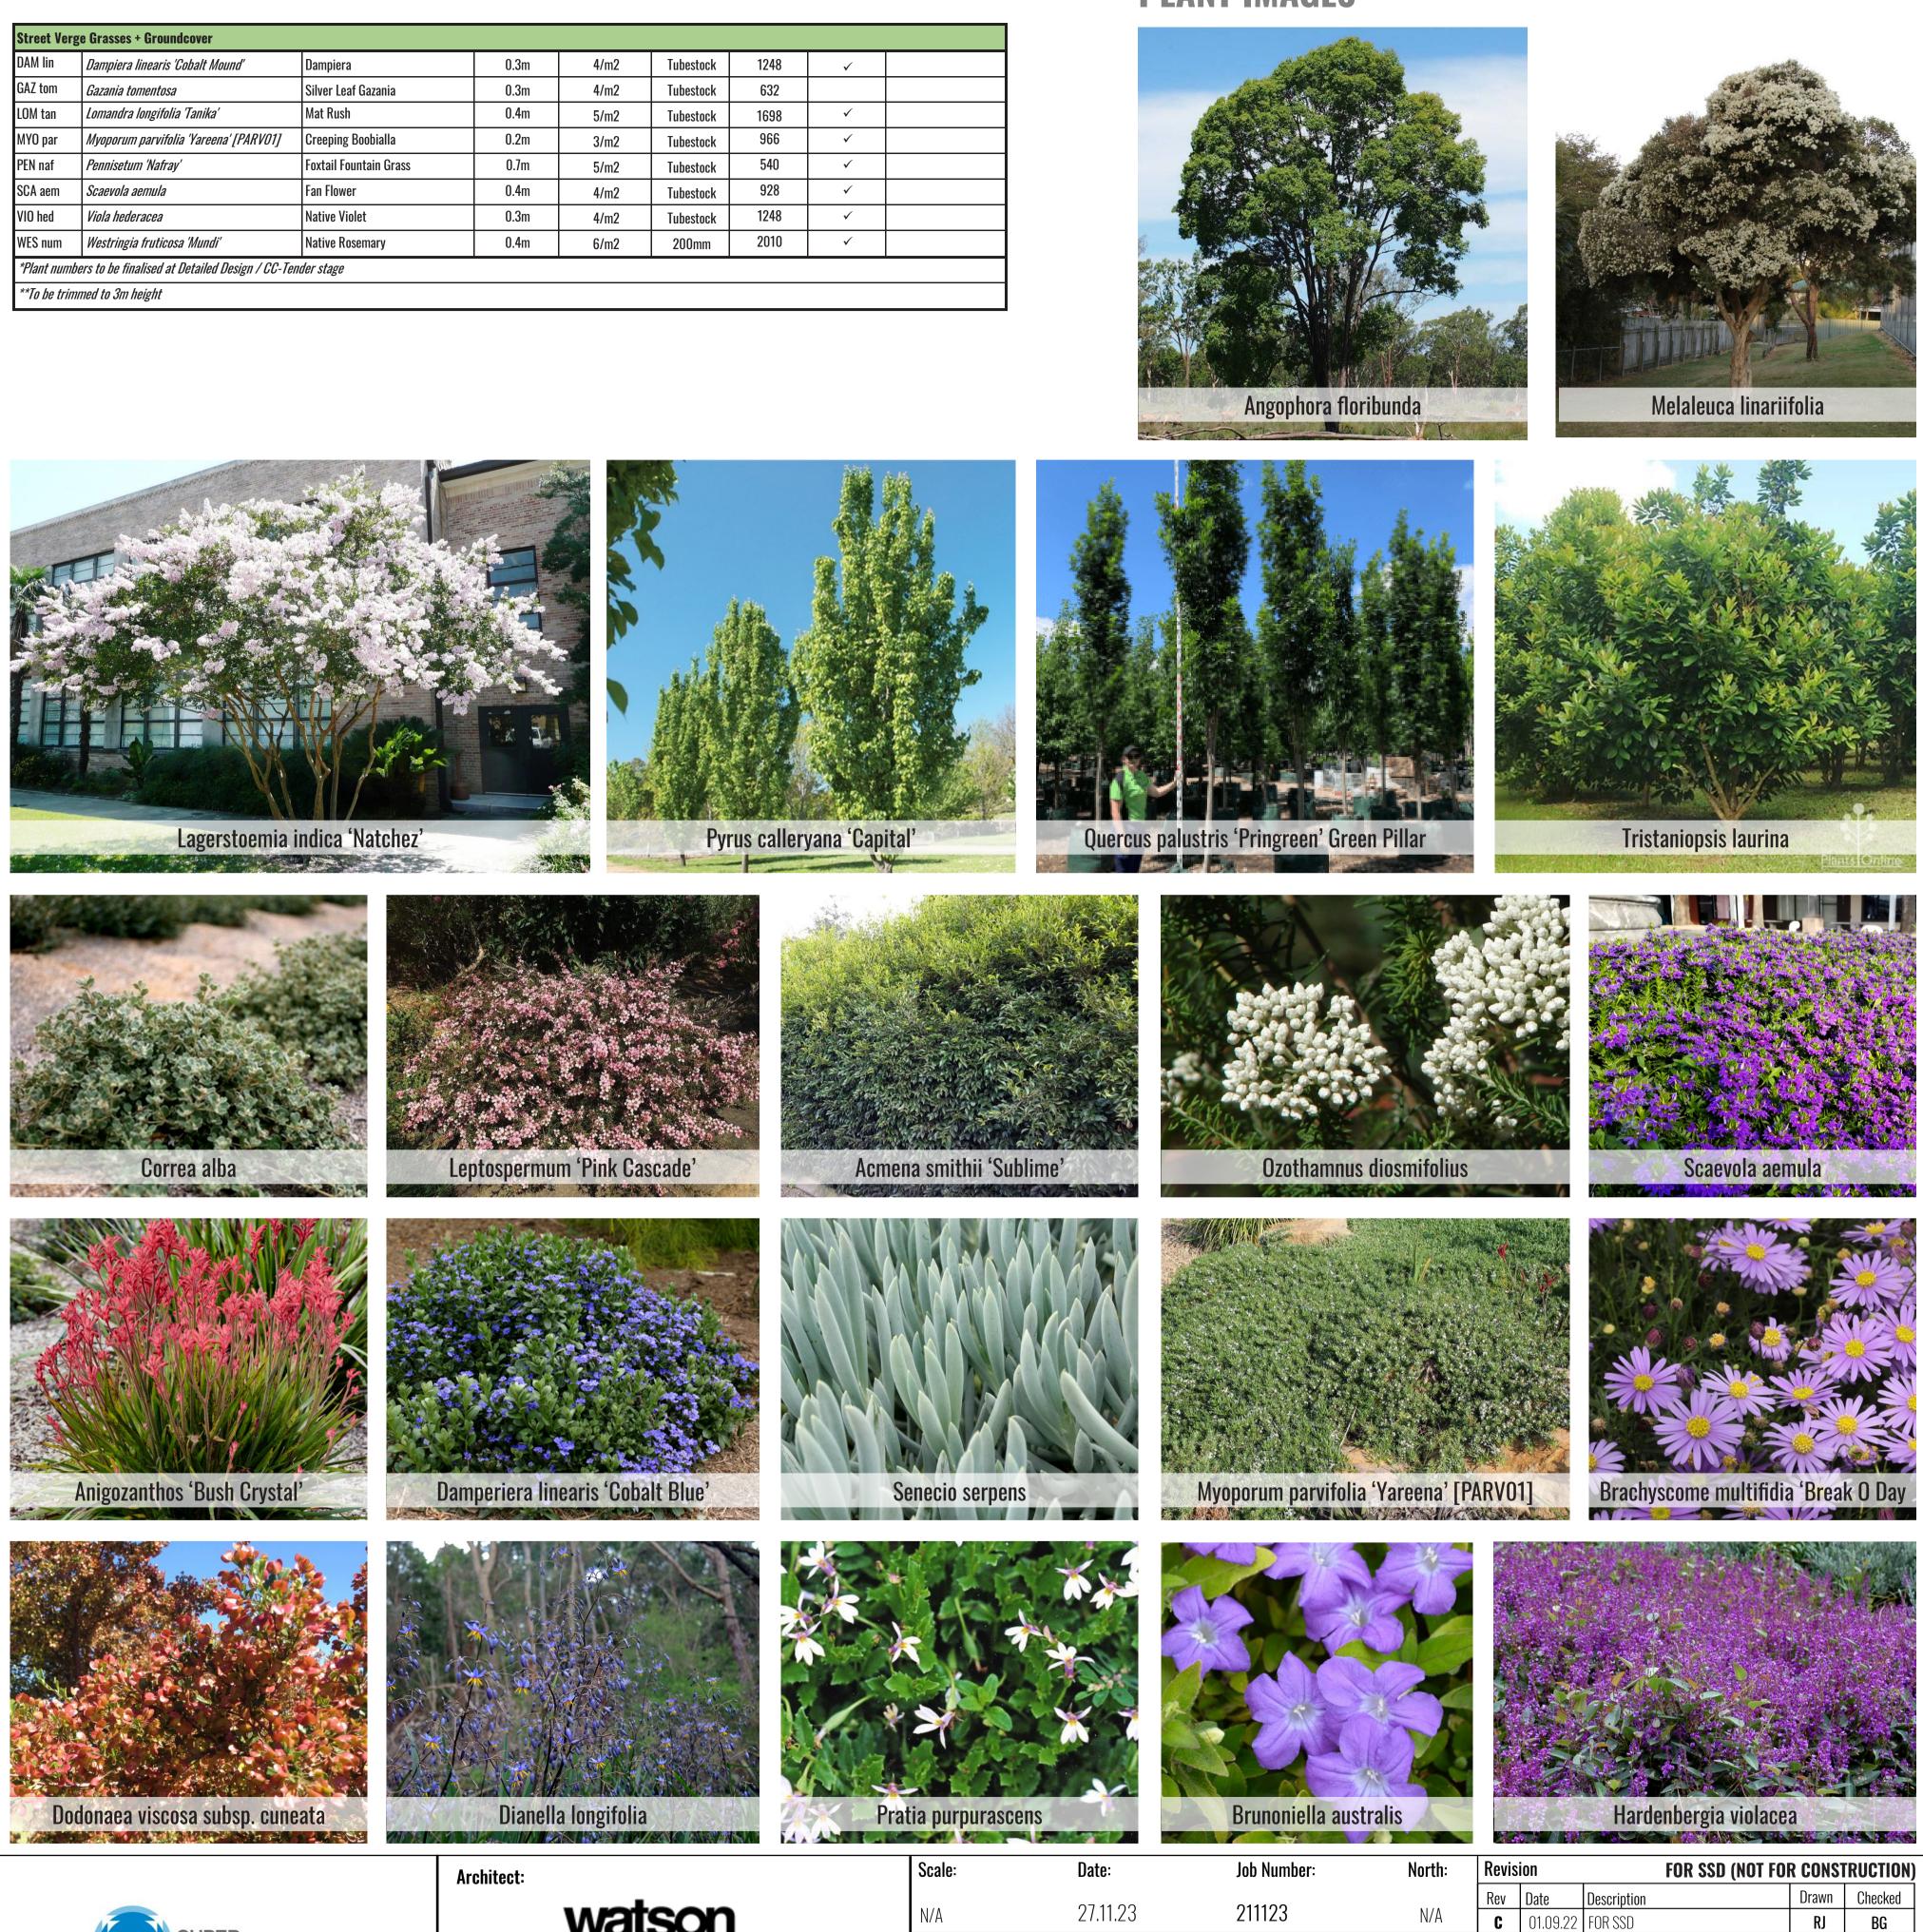





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Project:



52 Mamre Road Kemps Creek, NSW 2178 F 27.11.23 FOR SSD

**D** 13.09.22 FOR SSD

**E** 19.09.22 FOR SSD

BG

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BG

RJ

RJ

KC