20009DA - 104-116 REGENT STREET, REDFERN

Development Application

WEE HUR

DECEMBER 2021

City of Sydney DP 1026349 Council Lot & DP ВЗ Zoning 1366m² Site Area

Drawing Schedule

Sheet Number	Sheet Name	Revision	Rev Date
		_	
DA1.00	Cover Page	В	13.12.2021
DA1.01	Site Analysis	В	13.12.2021
DA1.03	Setbacks - Site Plan	В	13.12.2021
DA1.04	Setbacks - Levels	В	13.12.2021
DA2.01	Demolition Plan - Ground Floor	В	13.12.2021
DA3.01	Site Plan	С	13.12.2021
DA3.02	Level 01/Level 02	С	13.12.2021
DA3.03	Level 03/ Level 04	С	13.12.2021
DA3.04	Level 05 to 08/ Level 09 to 15	С	13.12.2021
DA3.05	Level 16/Level 17 to 18	С	13.12.2021
DA3.06	Roof Level / Plant Level	С	13.12.2021
DA4.01	Long Section + Short Section	В	13.12.2021
DA5.01	Regent St - Elevation	С	13.12.2021
DA5.02	Northern Elevation + Southern Elevation	С	13.12.2021
DA5.03	William Ln - Elevation	С	13.12.2021
DA6.01	Project Data Schedule	Е	13.12.2021
DA6.02	Shadow Diagrams - 21 JUNE 2021	В	13.12.2021
DA6.05	Gross Building Area Calculation	Α	13.12.2021
DA7.01	CGIs	Α	13.12.2021
DA7.02	Material Board	С	13.12.2021
DA7.03	Signage Details	В	13.12.2021
DA8.01	Notification Plan	Α	13.12.2021
Total: 22			



BASIX Commitments

	COMMITMENTS FOR COMMON AREAS AND CENTRAL SYSTEMS/FACILITIES FOR THE DEVELOPMENT (NON-BUILDING SPECIFIC)					
DWELLINGS			COMMON AREAS AND CENTRAL SYSTEMS/FACILITIES		COMMON AREAS AND CENTRAL SYSTEMS/FACILITIES	
WATER	ENERGY	THERMAL COMFORT	WATER	ENERGY	WATER COMMITMENTS	ENERGY COMMITMENTS
The applicant must comply with the commitments listed below in carrying out the development of a dwelling listed in the BASIX certificate. The applicant must plant indigenous or low water use species of vegetation throughout the area of land specified for the dwelling in the "Indigenous species" column of the table below, as private landscaping for that dwelling. (This area of indigenous vegetation is to be contained within the "Area of garden and lawn" for the dwelling specified in the "Description of Project" table). The applicant must not install a private swimming pool or spa for the dwelling, with a volume exceeding that specified for it in the BASIX certificate. The applicant must install, for the dwelling, each alternative water supply system, with the specified size, listed for that dwelling in the table of the BASIX certificate Each system must be configured to collect run-off from the areas specified (excluding any area which supplies any other alternative water supply system), and to divert overflow as specified.	The applicant must install each hot water system specified for the dwelling in the table of the BASIX certificate, so that the dwelling is not water is supplied by that system. If the table specifies a central hot water system for the dwelling, then the applicant must connect that central system to the dwelling, so that the dwelling's hot water is supplied by that central system. This commitment applies to each room or area of the dwelling which is referred to in a heading to the "Natural lighting" column of the table in the BASIX certificate, (but only to the extent specified for that room or area). The applicant must ensure that each such room or area is fitted with a window and/or skylight.	- The development will be a Class 3 building. The applicant must include in the documentation accompanying the application for a construction certificate (or complying development certificate, if applicable), a report demonstrating that the development will meet Section J of the National Construction Code - Volume 1.	The applicant must install (or ensure that the development is serviced by) the alternative water supply system(s) specified in the "Central systems" column of the table in the BASIX certificate. In each case, the system must be sized, be configured, and be connected, as specified in the table. A swimming pool or spa listed in the table must not have a volume (in kLs) greater than that specified for the pool or spa in the table.	The applicant must install the systems and fixtures specified in the "Central energy systems" column of the table in the BASIX certificate. In each case, the system or fixture must be of the type, and meet the specifications, listed for it in the table.	The applicant must install (or ensure that the development is serviced by) the alternative water supply system(s) specified in the "Central systems" column of the table of the BASIX certificate. In each case, the system must be sized, be configured, and be connected, as specified in the table. A swimming pool or spa listed in the table must not have a volume (in kLs) greater than that specified for the pool or spa in the table.	The applicant must install the systems and fixtures specified in the "Central energy systems" column of the table in the BASIX certificate. In each case, the system or fixture must be of the type, and meet the specifications, listed for it in the table.

Refer to BASIX certificate for more information

NOT FOR CONSTRUCTION

ANTONIADES ARCHITECTS

DEVELOPMENT APPLICATION

PROJECT NO. 20009DA REGENT STREET ADDRESS 104-116 REGENT STREET


Overall Plans

Cover Page

DA1.00

FOR SUBMISSION

SCALE NTS

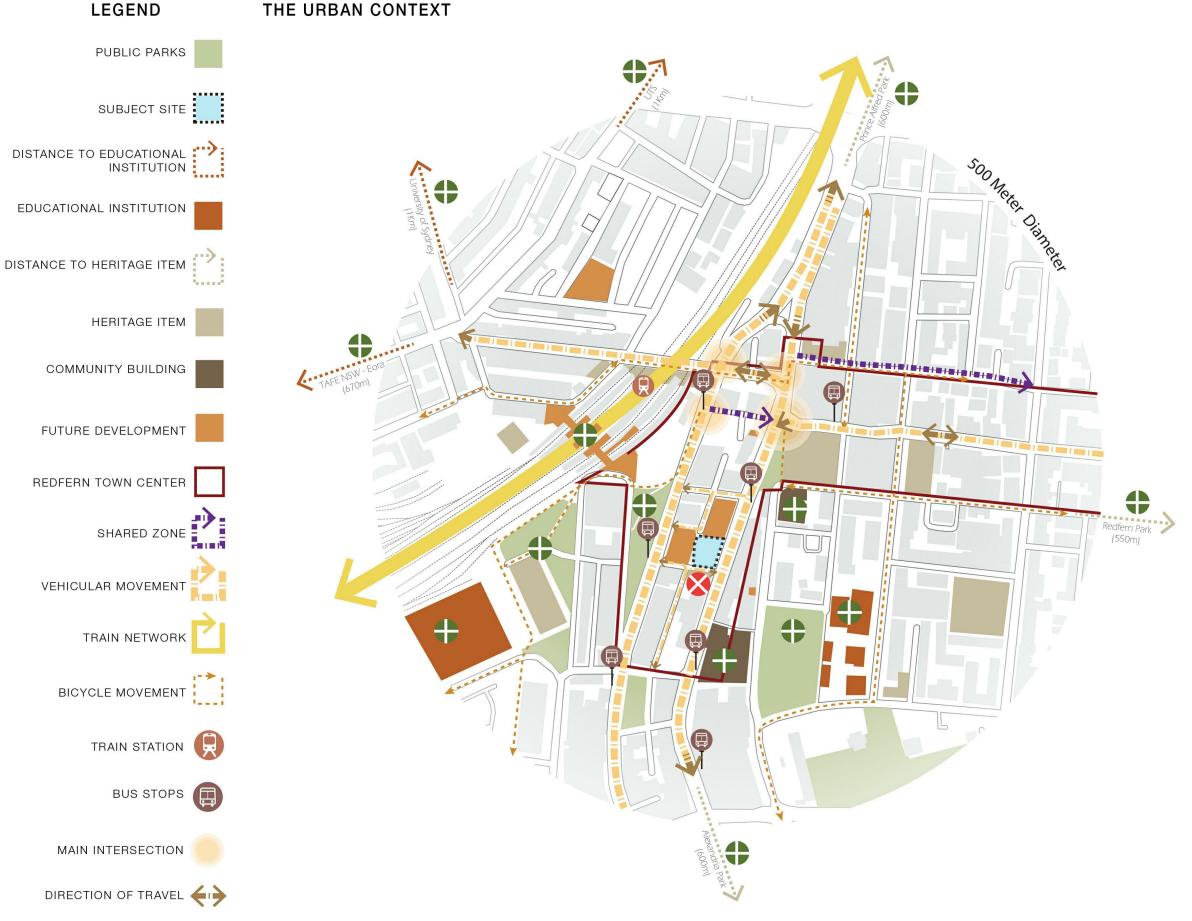



- Close to community amenities (eg. Aboriginal legal Services located in Redfern town centre which is a prime location to attract
- Access to main roads like Gibbons and Regent St with Bus lines close to Redfern train station and new connection line to be implemented
- Close to cycling roads
- No stopping zone on Regent Street in front of site
- Margaret st is a quiet street better for pedestrians
- chances to proposed public amenities for students and for the
- Close to parks
- Good natural air circulation
- Views and access to Redfern Park (East)
- Views and access to Alexandria Park (South)
- Views and access to Heritage buildings
- Townhouses rythm can inspire treatment of the proposed

- Close to the church (heritage) + 2 storey
- Proposed and approved neighbouring buildaccess
- Student rooms orientation need to work with
- Neighbouring buildings overshadowing the site

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PROJECT PHASE DEVELOPMENT APPLICATION

FOR SUBMISSION

PROJECT NO. 20009DA REGENT STREET ADDRESS 104-116 REGENT STREET

Site Information


Site Analysis

DA1.01 SCALE NTS

• 18 Storey height limit allows for more occupants and thus more

• Height of proposal will correspond to height of 90-102 Regent st / 13-23 Gibbons St/11 Gibbons st/90-98 Regent St

- ings will impact sun
- Gibbons St and Regent St very noisy
- the other 18 storey buildings orientation
- Wind tunneling effect on Regent St
- Transitional site / Precinct

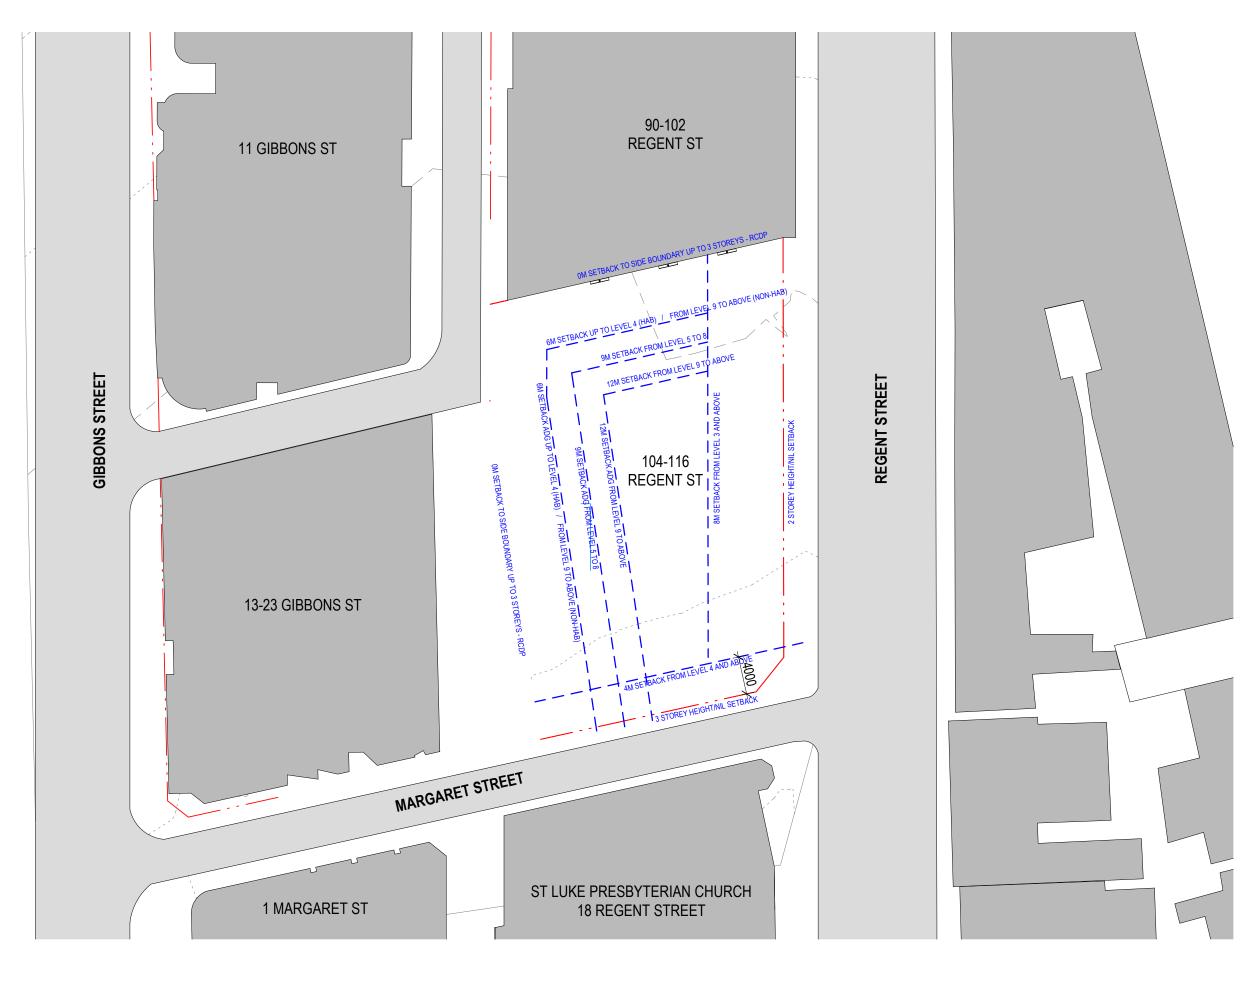

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DEVELOPMENT APPLICATION FOR SUBMISSION


PROJECT NO.

20009DA
PROJECT
REGENT STREET ADDRESS 104-116 REGENT STREET

Site Information


Setbacks - Site Plan

DA1.03 SCALE 1:400 @AS 0m 3.2 6.4 8 Scale 1:400

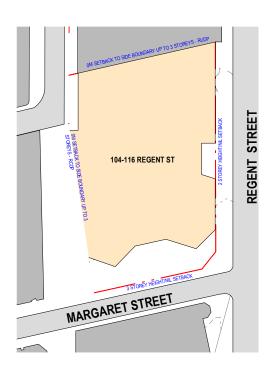




Floor Plan 1:800

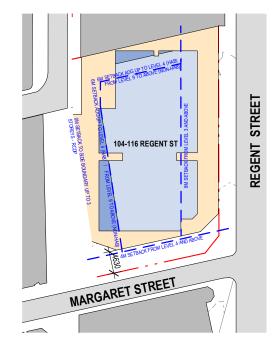


Setbacks- Level 02 to 04

Floor Plan 1:800

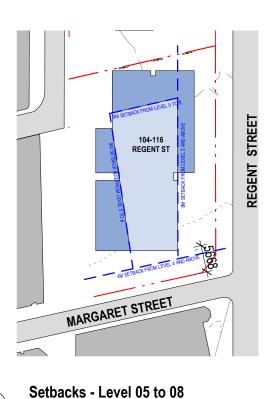

REGENT STREET 104-116 REGENT ST MARGARET STREET

Setbacks - Level 09 to 16 Floor Plan

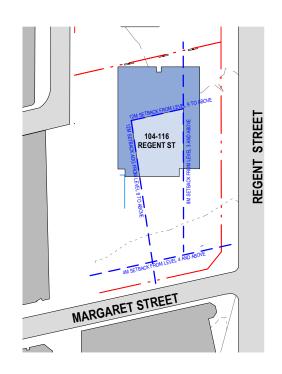

Setbacks - Level 17 and Above

SETBACKS LEGEND PODIUM OVER SETBACKS TOWER TOWER OVER SETBACKS

NOT FOR CONSTRUCTION

Floor Plan

DESCRIPTION Issued for coordination Issued for DA Submission

1:800

DATE 25.11.2021 13.12.2021

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PROJECT PHASE

DEVELOPMENT APPLICATION


FOR SUBMISSION

PROJECT NO. 20009DA PROJECT
REGENT STREET ADDRESS 104-116 REGENT STREET CLIENT WEE HUR

DRAWING SERIES Site Information

Setbacks - Levels

DA1.04 SCALE As indicated 0m 6.4 Scale 1:800

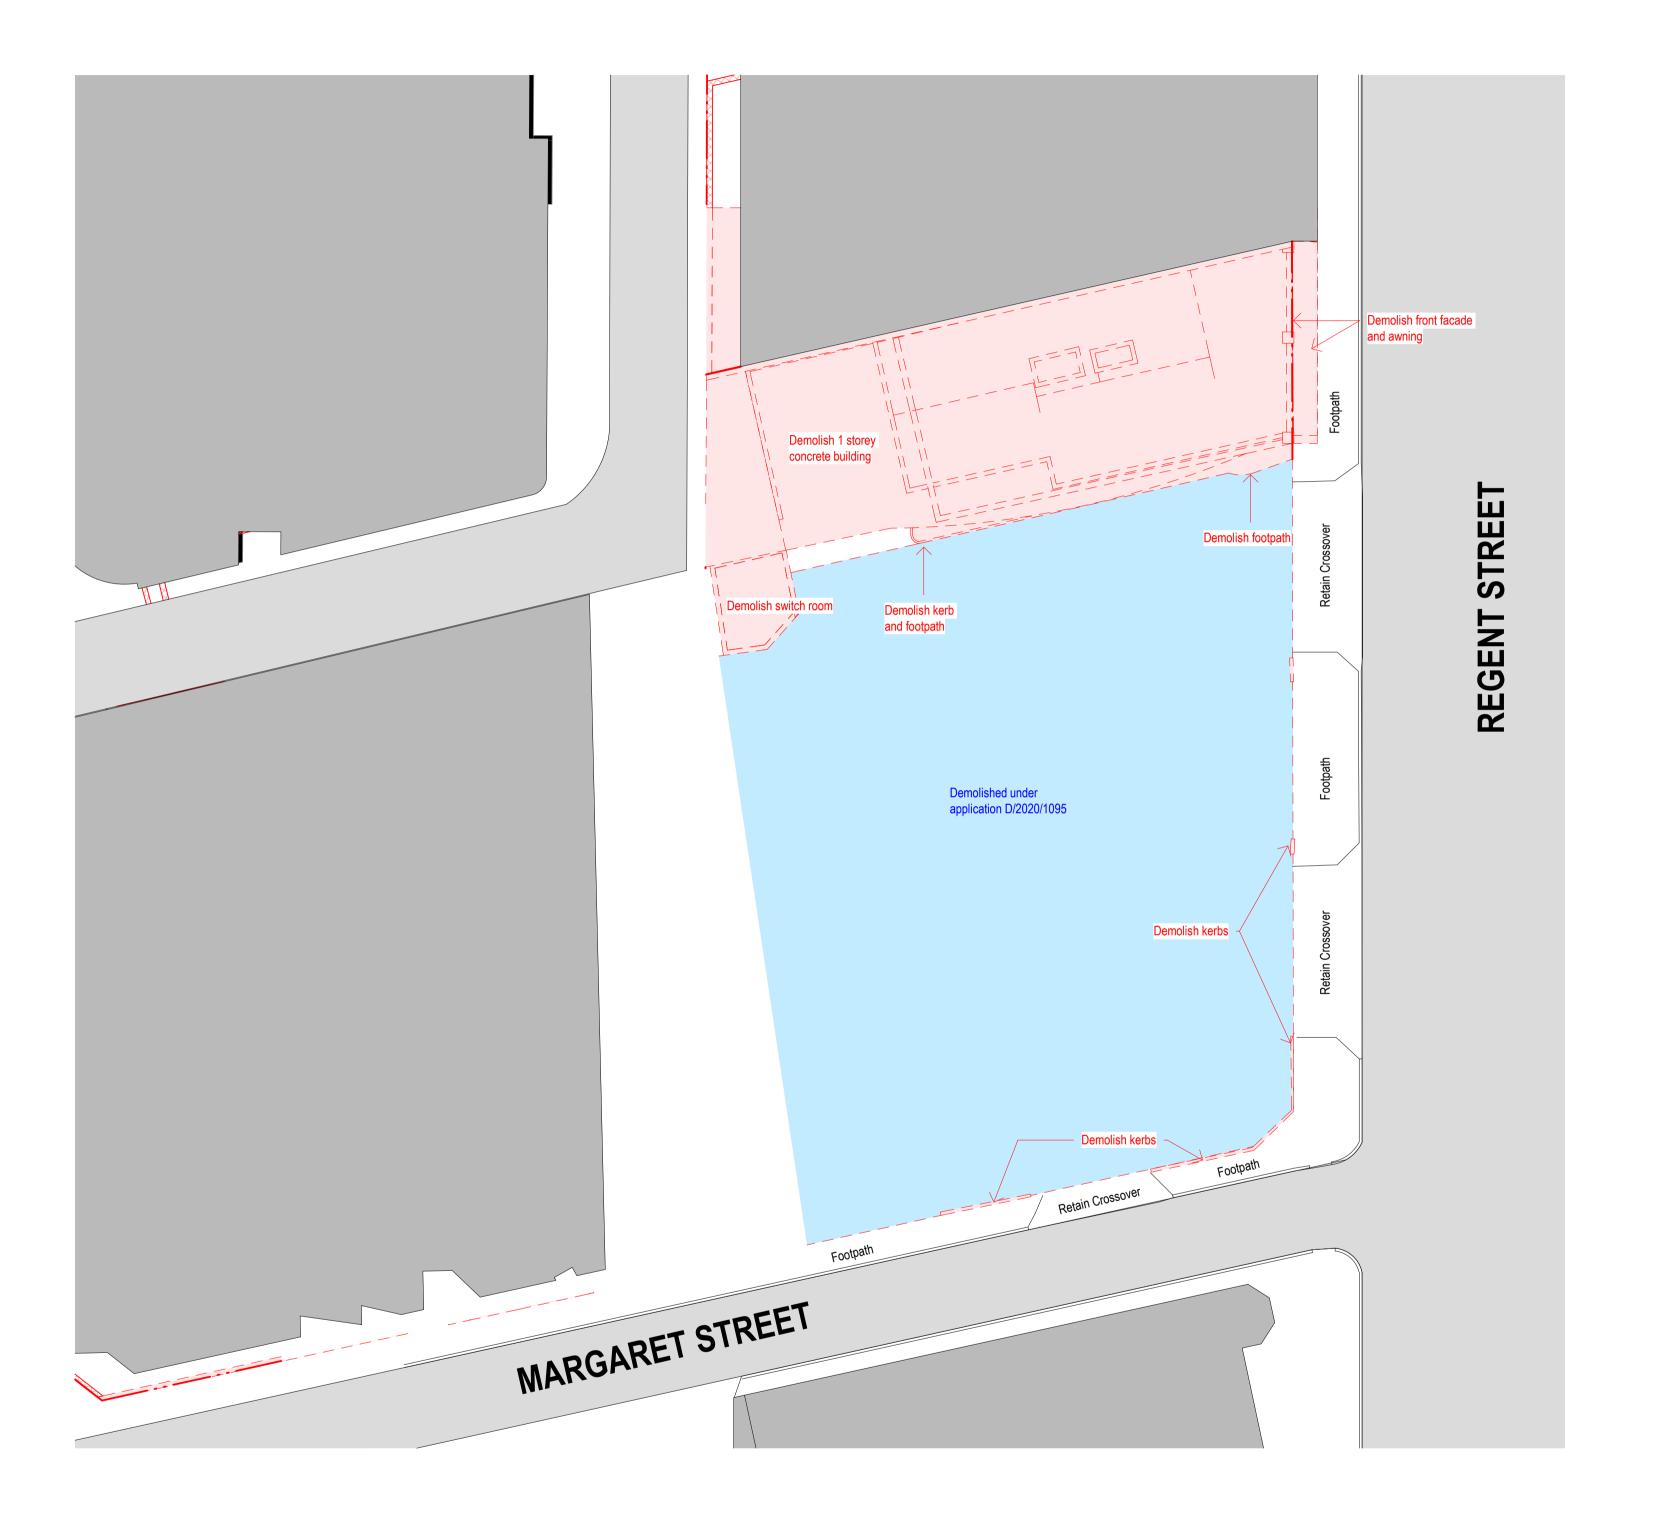

<u>PLEASE NOTE</u>: This demolition plan only concerns structures above ground and do not include any fuel tanks or services located below ground.

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DESCRIPTION BY DATE
Issued for Information AA 23.10.2020
Issued for DA Submission 13.12.2021

ANTONIADES ARCHITECTS

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ACN 129 731 559

Nominated Architect: Andreas Antoniades

NSW Registration 7954

PROJECT PHASE
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APPLICATION
STATUS
FOR SUBMISSION

PROJECT NO.
20009DA

PROJECT

REGENT STREET

ADDRESS
104-116 REGENT STREET

CLIENT
WEE HUR

DRAWING SERIES
Existing Plans

DRAWING TITLE
Demolition Plan - Ground Floor

DA2.01

SCALE
1:200

Om
4
8
10m

Scale 1:200

REVISION
DRAWN BY
ZD
CHECKED BY
AA

NORTH



ABBREVIATIONS LEGEND

Accessible
Comms Cupboard/Riser
Garbage Chute
Communication Services
Electrical Cupboard/Riser ACC. = C = CH = E = FB = FCR = Fire Brigade Booster Assembly
Fire Control Room
Fire Pump Room
Fire Sprinkler Riser
Hydraulic Riser
Kitchen Exhaust
Stair Pressurisation Relief Shaft FPR = FR = KE = LR = Mechanical Condenser Plant MSB Room = Main SwitchBoard Room
O/SE = Oil Separator
OSD = On-Site Detention (Tank)
RF = Mechanical Refrigerant Riser
SP = Stair Pressurisation Shaft
TH = Tower Main Hydraulic Riser
WC = Water Closet

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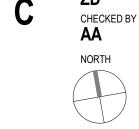
ACN 129 731 559

PROJECT PHASE DEVELOPMENT **APPLICATION** STATUS FOR SUBMISSION

PROJECT NO. 20009DA PROJECT REGENT STREET ADDRESS 104-116 REGENT STREET CLIENT WEE HUR

DRAWING SERIES **Overall Plans** DRAWING TITLE Site Plan

DRAWING NO. DA3.01 REVISION DRAWN BY







ABBREVIATIONS LEGEND

ACC. = Comms Cupboard/Riser Garbage Chute C = CH = Communication Services Electrical Cupboard/Riser E = FB = Fire Brigade Booster Assembly Fire Control Room FPR = FR = Fire Pump Room Fire Sprinkler Riser Hydraulic Riser Kitchen Exhaust KE = LR = Stair Pressurisation Relief Shaft Mechanical Condenser Plant MSB Room = Main SwitchBoard Room O/SE = Oil Separator OSD = On-Site Detention (Tank) RF = Mechanical Refrigerant Riser Stair Pressurisation Shaft SP = Tower Main Hydraulic Riser Water Closet TH =

> ROOMS LEGEND: Studio A Unit

Ensuite Unit 2 Bedroom Unit DDA Unit

Communal Bicycle Parking

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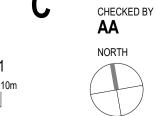
PROJECT NO. 20009DA REGENT STREET ADDRESS 104-116 REGENT STREET

WEE HUR

DRAWING SERIES **Overall Plans**

Level 01/Level 02

DRAWING NO. **DA3.02** REVISION DRAWN BY




WILLIAM 4000 Building Separation DA|5.03 1 DA5.01 03.02 03.16 03.25 ROPOSED T.S.I MARGARET STREET Level 03 Floor Plan 1:200

29.10.2021

25.11.2021

13.12.2021

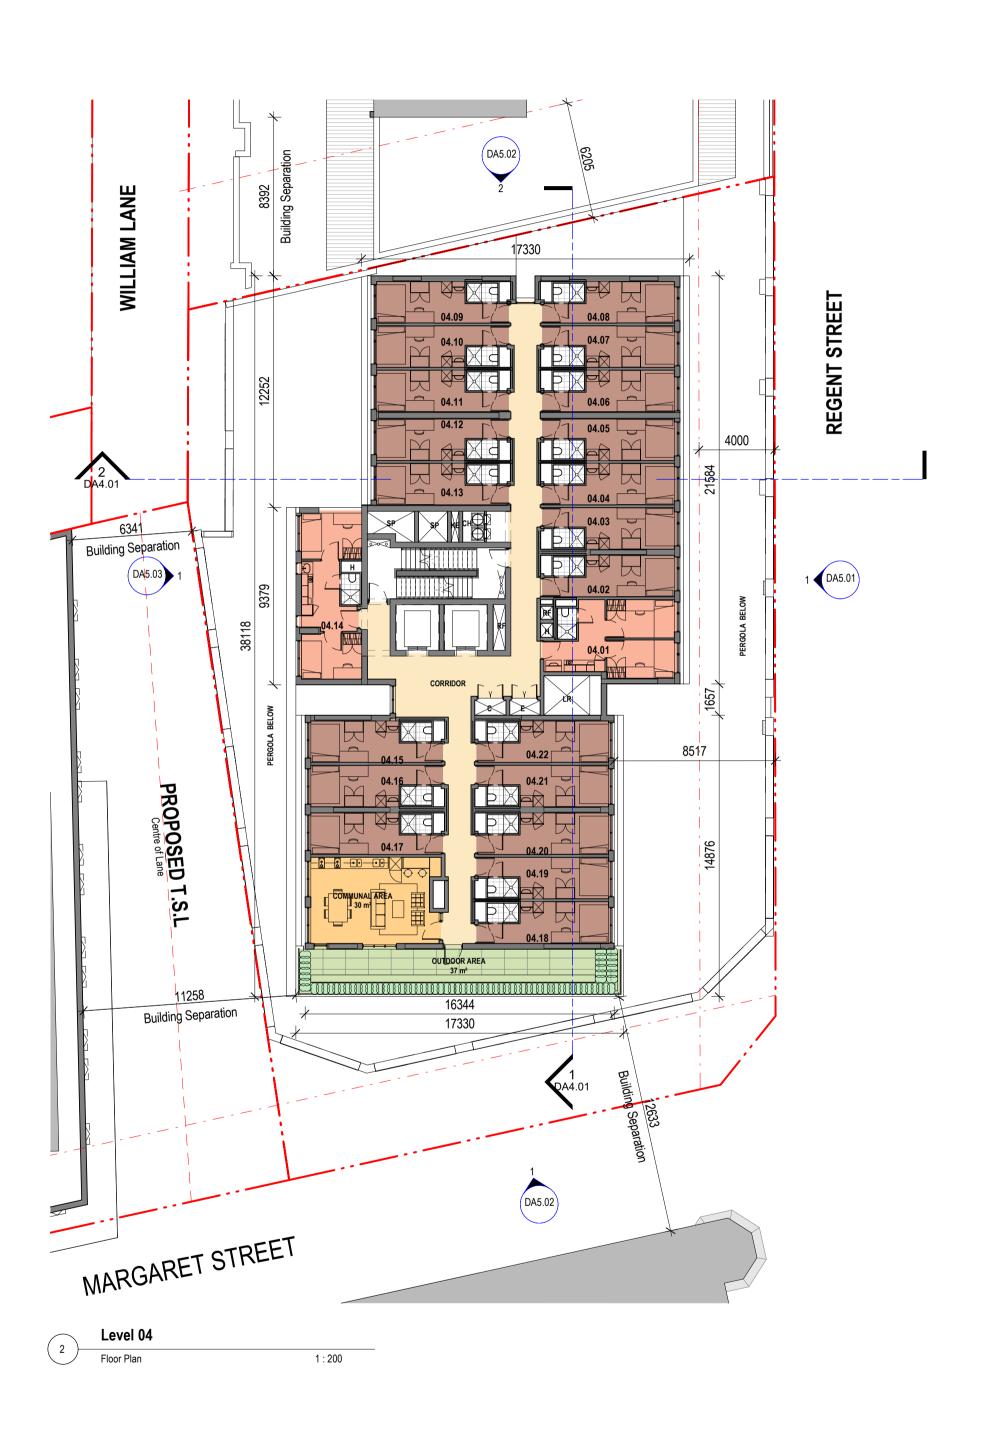

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PROJECT PHASE DEVELOPMENT **APPLICATION** STATUS

FOR SUBMISSION

PROJECT NO. 20009DA REGENT STREET

DRAWING SERIES **Overall Plans**

Level 03/ Level 04

DRAWING NO. **DA3.03** REVISION DRAWN BY CHECKED BY

ABBREVIATIONS LEGEND

Comms Cupboard/Riser Garbage Chute

Communication Services Electrical Cupboard/Riser

Fire Control Room

Fire Pump Room Fire Sprinkler Riser

Hydraulic Riser Kitchen Exhaust

Fire Brigade Booster Assembly

Stair Pressurisation Relief Shaft Mechanical Condenser Plant

On-Site Detention (Tank)

Stair Pressurisation Shaft

ROOMS LEGEND:

Studio A Unit

Ensuite Unit

DDA Unit

Communal

Bicycle Parking

2 Bedroom Unit

Tower Main Hydraulic Riser Water Closet

Mechanical Refrigerant Riser

MSB Room = Main SwitchBoard Room O/SE = Oil Separator

ACC. =

C = CH =

E = FB =

FPR =

KE = LR =

OSD =


RF =

SP =

TH =

Nominated Architect: Andreas Antoniades www.antoniades.com.au ACN 129 731 559 NSW Registration 7954 ADDRESS 104-116 REGENT STREET WEE HUR

OUTDOOR AREAS ONLY ON LEVELS ROPOSED T.S.L 05.22 7 05.21 ₩₩ ↓ Building Separation MARGARET STREET Level 05 - 08 1:200

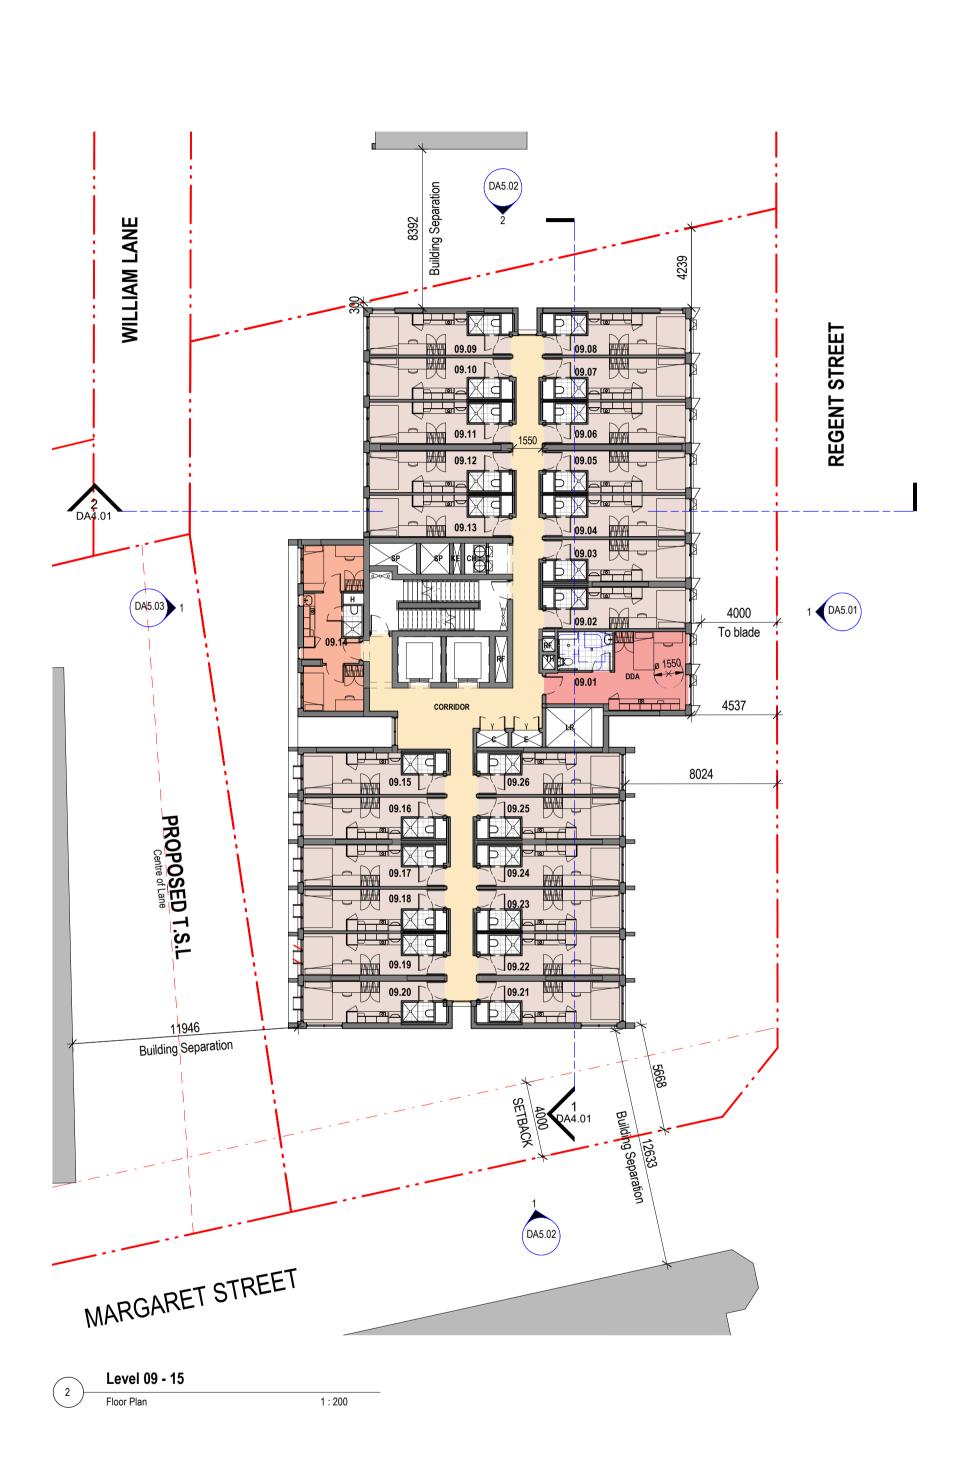

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PROJECT PHASE DEVELOPMENT **APPLICATION** STATUS

FOR SUBMISSION

PROJECT NO. 20009DA REGENT STREET ADDRESS 104-116 REGENT STREET WEE HUR

DRAWING SERIES **Overall Plans**

Level 05 to 08/ Level 09 to 15

DRAWING NO. **DA3.04**

REVISION

ABBREVIATIONS LEGEND

Comms Cupboard/Riser

Communication Services

Electrical Cupboard/Riser

Fire Brigade Booster Assembly

Stair Pressurisation Relief Shaft

MSB Room = Main SwitchBoard Room O/SE = Oil Separator

Mechanical Condenser Plant

On-Site Detention (Tank)

Stair Pressurisation Shaft Tower Main Hydraulic Riser

Water Closet

ROOMS LEGEND:

Studio A Unit

Ensuite Unit

Communal

Bicycle Parking

2 Bedroom Unit

Mechanical Refrigerant Riser

Garbage Chute

Fire Control Room

Fire Pump Room Fire Sprinkler Riser . Hydraulic Riser Kitchen Exhaust

ACC. =

C = CH =

E =

FB =

FPR =

KE =


LR =

OSD =

RF =

SP =

TH =

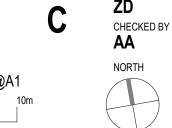

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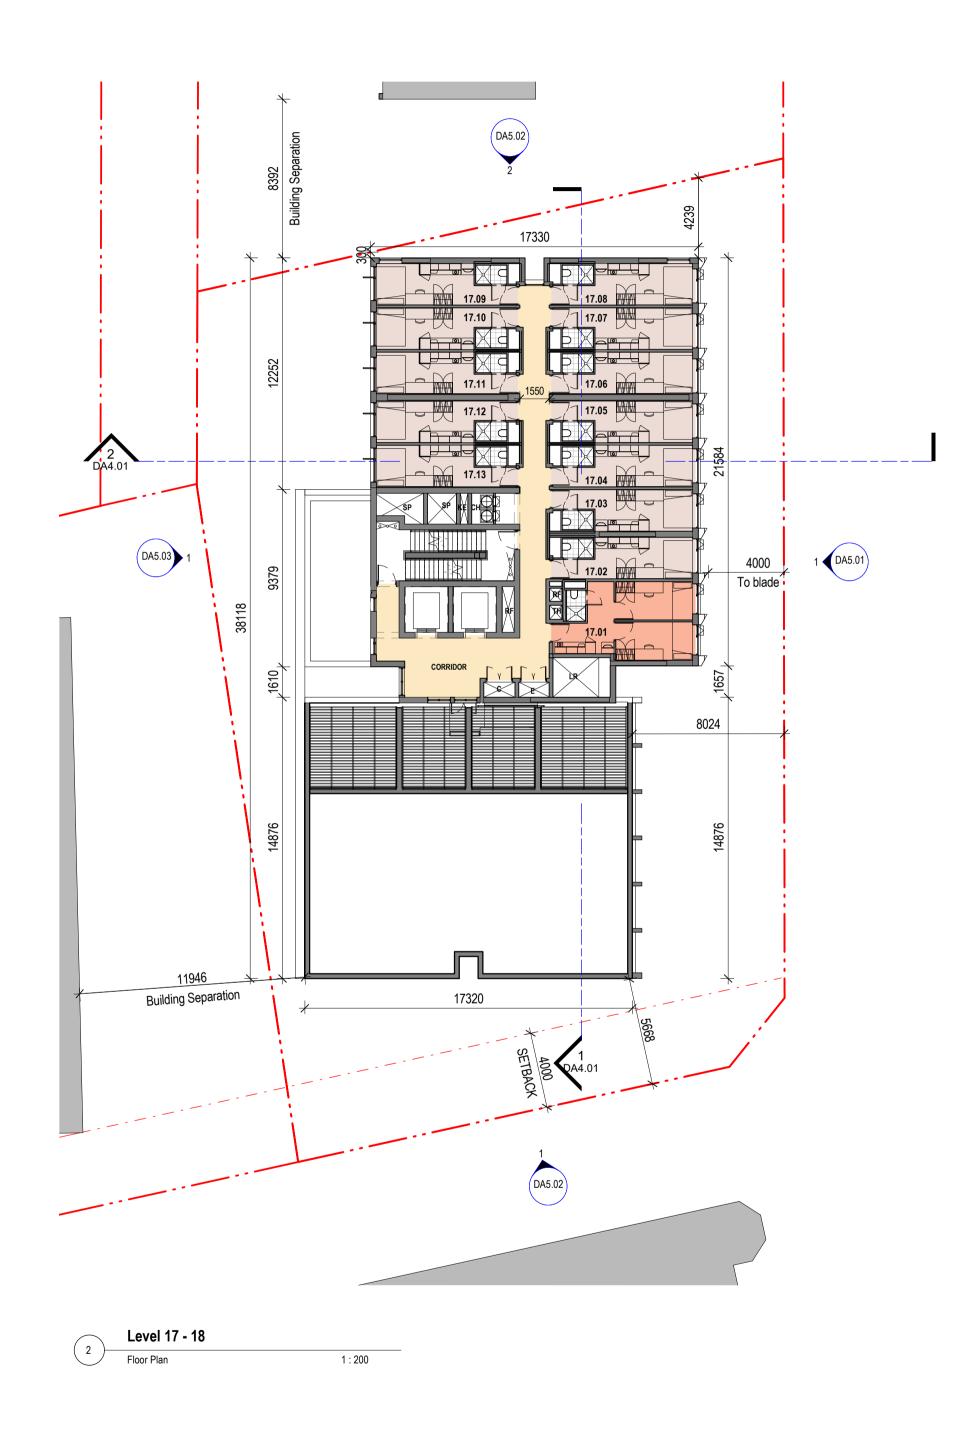
DA5.03 1 8024 Building Separation Level 16 1:200

BY DATE

22.10.2021

25.11.2021

13.12.2021



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PROJECT PHASE

DEVELOPMENT
APPLICATION

STATUS

FOR SUBMISSION

PROJECT NO.
20009DA

PROJECT
REGENT STREET

ADDRESS
104-116 REGENT STREET

WEE HUR

Overall Plans

DRAWING TITLE
Level 16/Level 17 to 18

DI S

DRAWING NO. REVISION

DA3.05

SCALE
1:200

@A1

8 10m

C ZD CHECKED BY AA NORTH

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ABBREVIATIONS LEGEND

Comms Cupboard/Riser

Communication Services Electrical Cupboard/Riser

Fire Brigade Booster Assembly

Stair Pressurisation Relief Shaft Mechanical Condenser Plant

On-Site Detention (Tank)

Stair Pressurisation Shaft Tower Main Hydraulic Riser

Water Closet

ROOMS LEGEND:

Studio A Unit

Ensuite Unit

DDA Unit

Communal

Bicycle Parking

2 Bedroom Unit

Mechanical Refrigerant Riser

MSB Room = Main SwitchBoard Room O/SE = Oil Separator

Garbage Chute

Fire Control Room
Fire Pump Room

Fire Sprinkler Riser Hydraulic Riser Kitchen Exhaust

ACC. =

C = CH =

E = FB =

FPR =

KE = LR =


OSD =

RF =

SP =

TH =

17330 HOT WATER PLANT FIRE TANK DA5.03 1 1 **(**DA5.01) Building Separation FIXED LOUVRES 11468 Roof Level Floor Plan 1:200

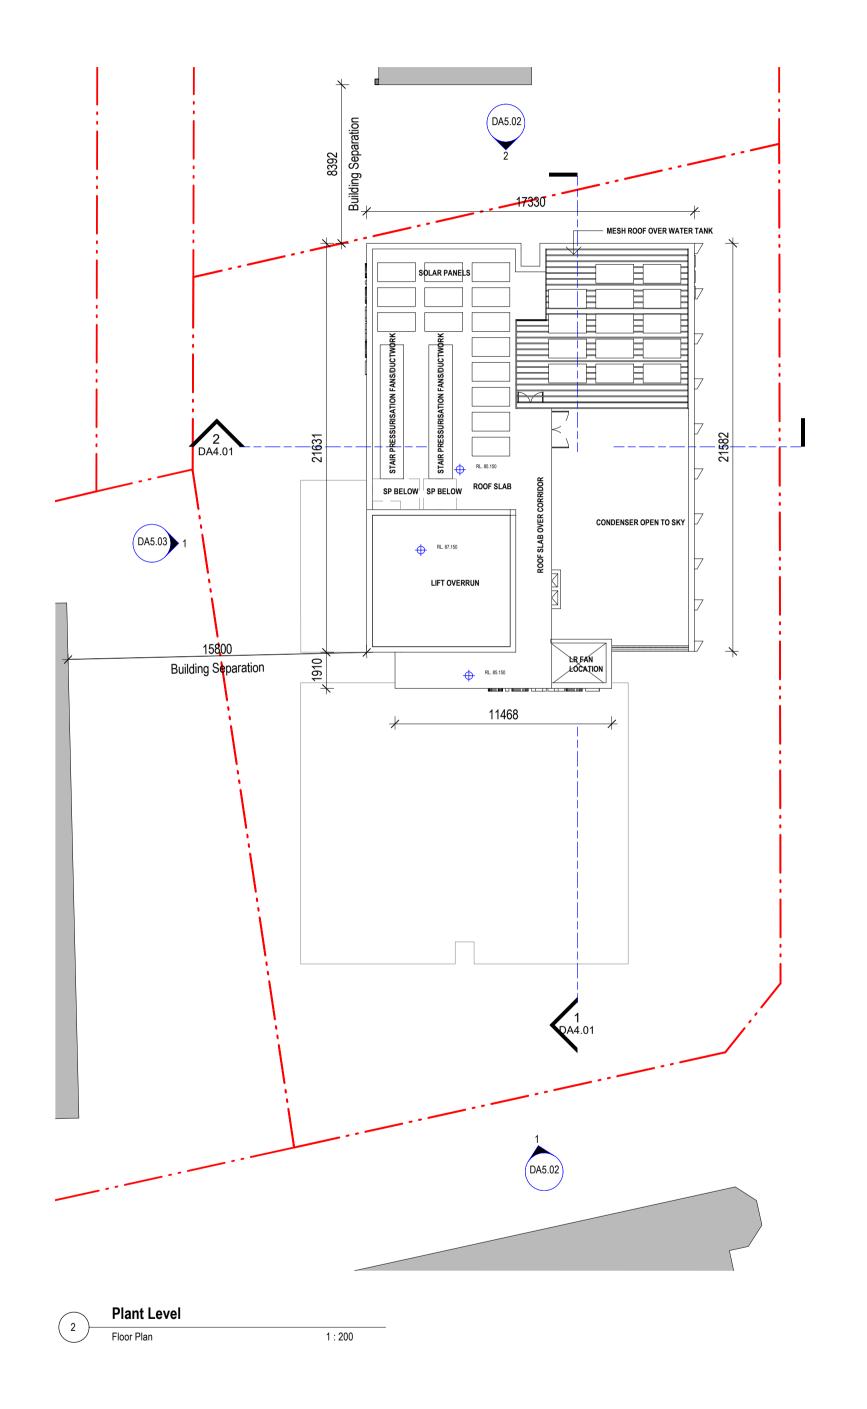

ABBREVIATIONS LEGEND

ACC. = Comms Cupboard/Riser
Garbage Chute
Communication Services C = CH = E = FB = FCR = Electrical Cupboard/Riser Fire Brigade Booster Assembly Fire Control Room Fire Pump Room
Fire Sprinkler Riser
Hydraulic Riser
Kitchen Exhaust FPR = FR = KE = LR = Stair Pressurisation Relief Shaft Mechanical Condenser Plant MSB Room = Main SwitchBoard Room
O/SE = Oil Separator
OSD = On-Site Detention (Tank)
RF = Mechanical Refrigerant Riser Stair Pressurisation Shaft Tower Main Hydraulic Riser Water Closet SP = TH =

ROOMS LEGEND:

Studio A Unit
Ensuite Unit
2 Bedroom Unit
DDA Unit
Communal

Bicycle Parking

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PROJECT PHASE
DEVELOPMENT
APPLICATION
STATUS

FOR SUBMISSION

PROJECT NO.
20009DA
PROJECT
REGENT STREET

ADDRESS
104-116 REGENT STREET

CLIENT
WEE HUR

Overall Plans

DRAWING TITLE

Roof Level / Plant Level

DA3.06

SCALE
1:200

REVISION DRAWN BY

ZD
CHECKED BY
AA

NORTH



ABBREVIATIONS LEGEND

Comms Cupboard/Riser

Communication Services

Fire Control Room

Fire Pump Room Fire Sprinkler Riser Hydraulic Riser Kitchen Exhaust

Studio A Unit

Ensuite Unit

Communal


Bicycle Parking

2 Bedroom Unit


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Margaret St Elevation 1:200

North Elevation 1:200

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NSW Registration 7954

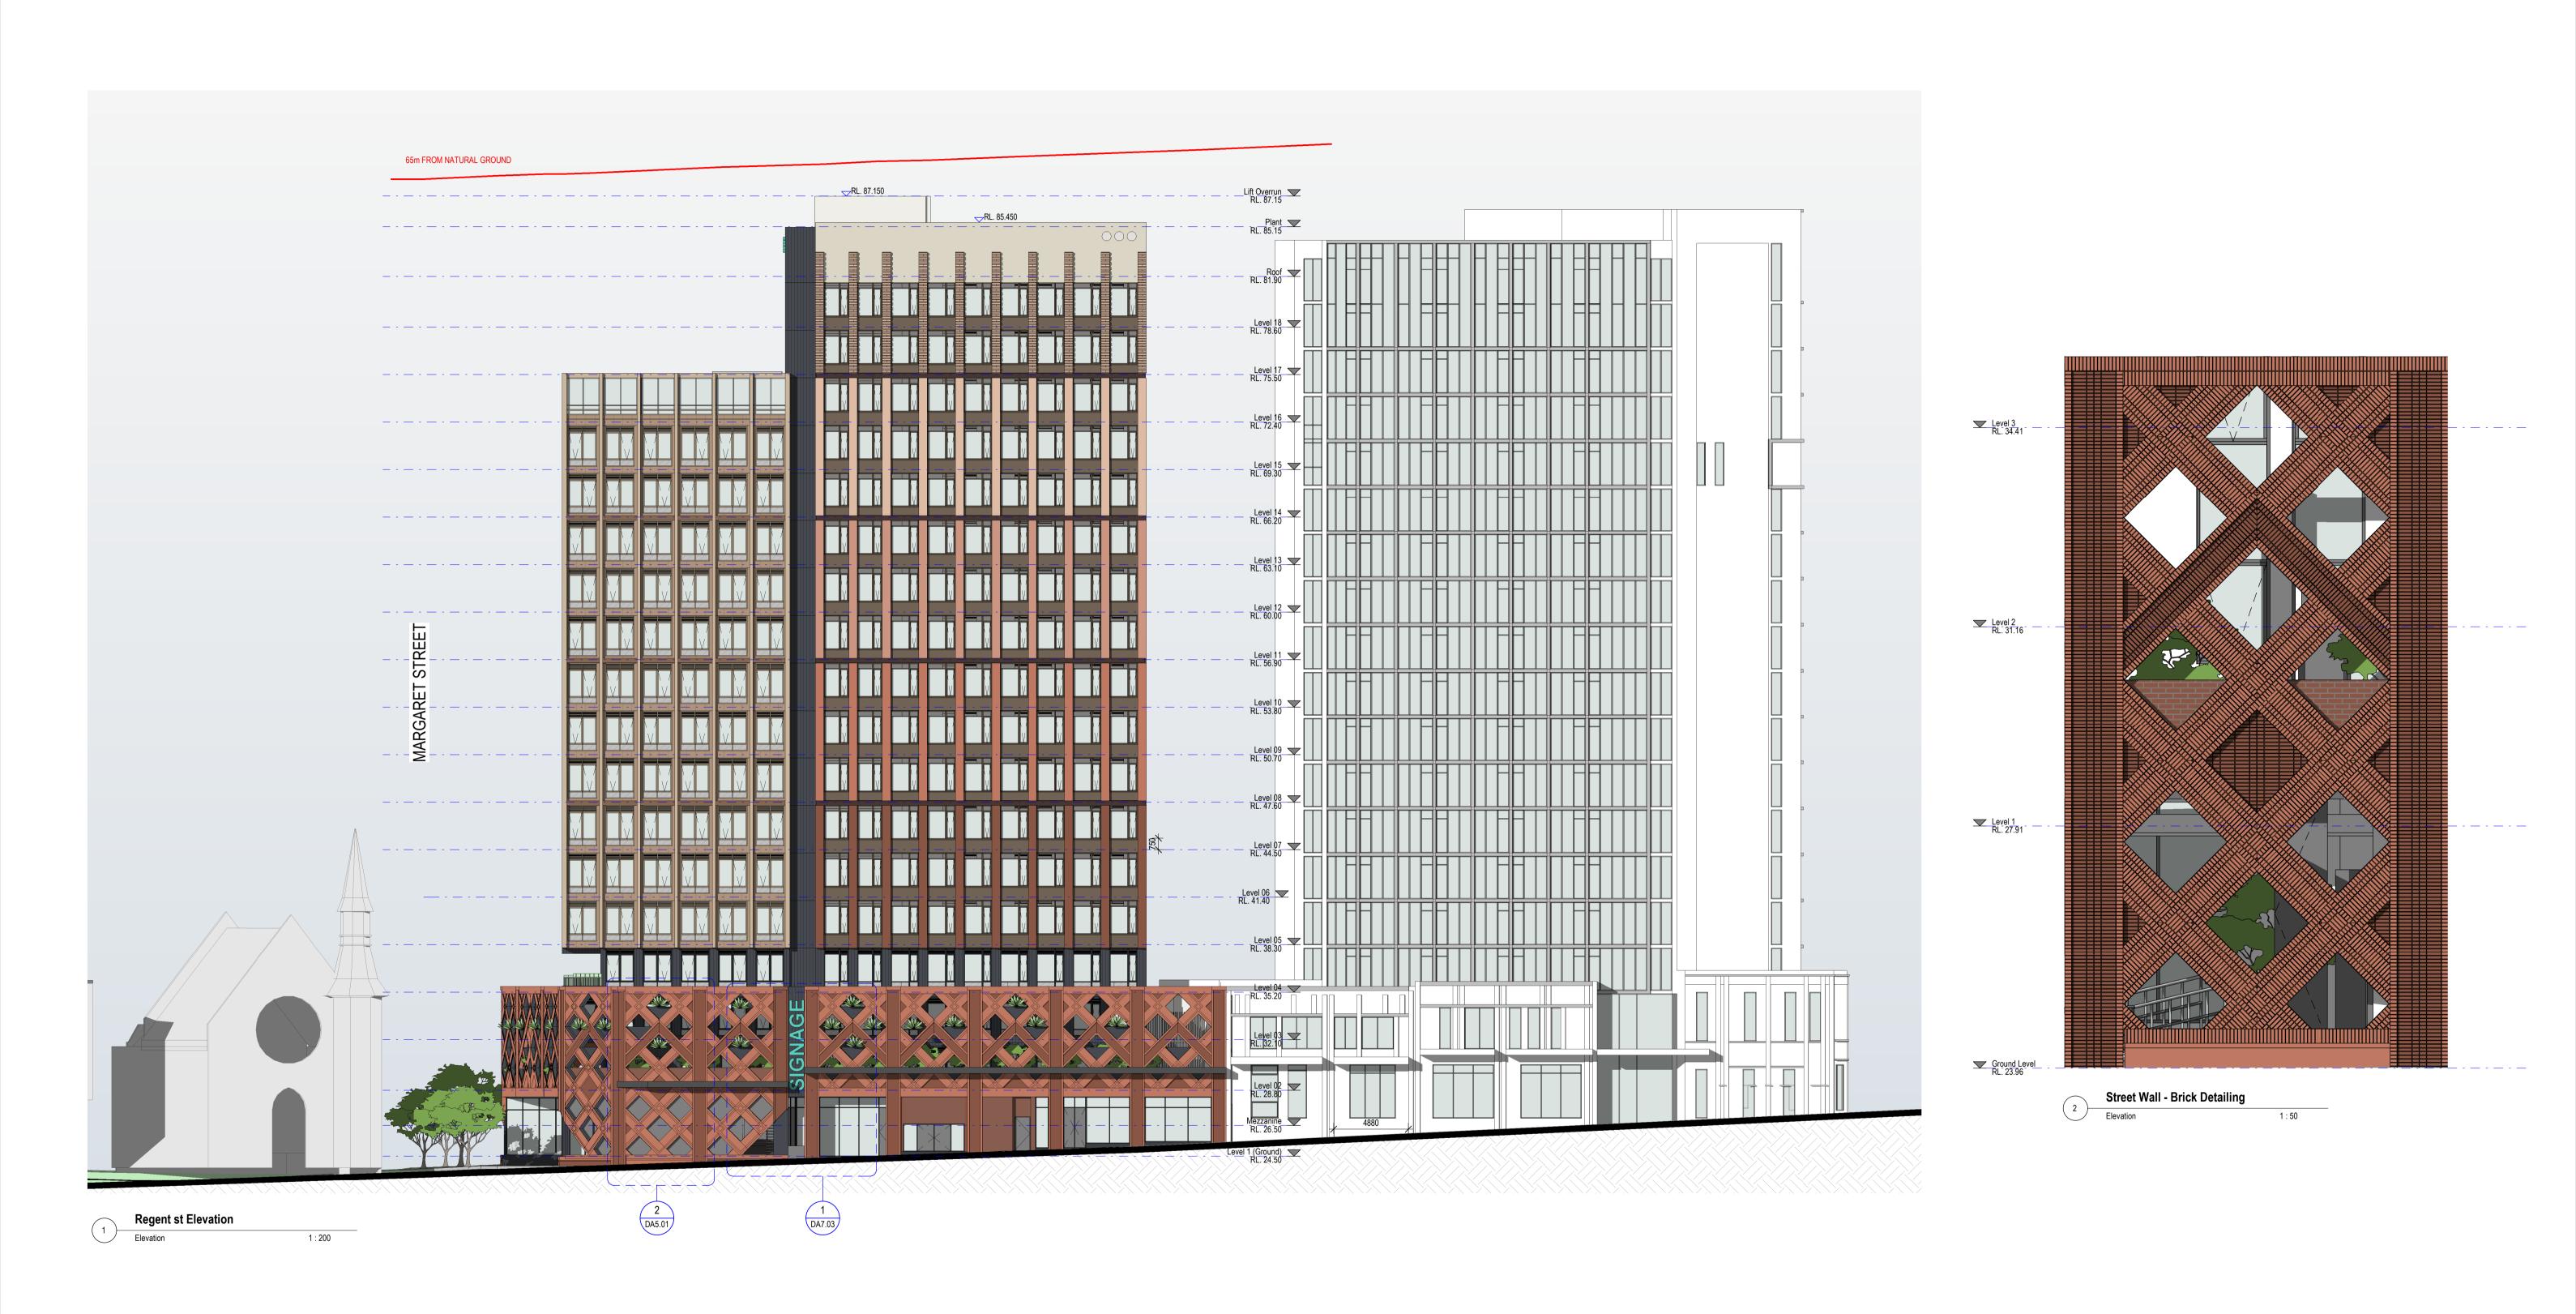PROJECT PHASE DEVELOPMENT **APPLICATION** STATUS

FOR SUBMISSION

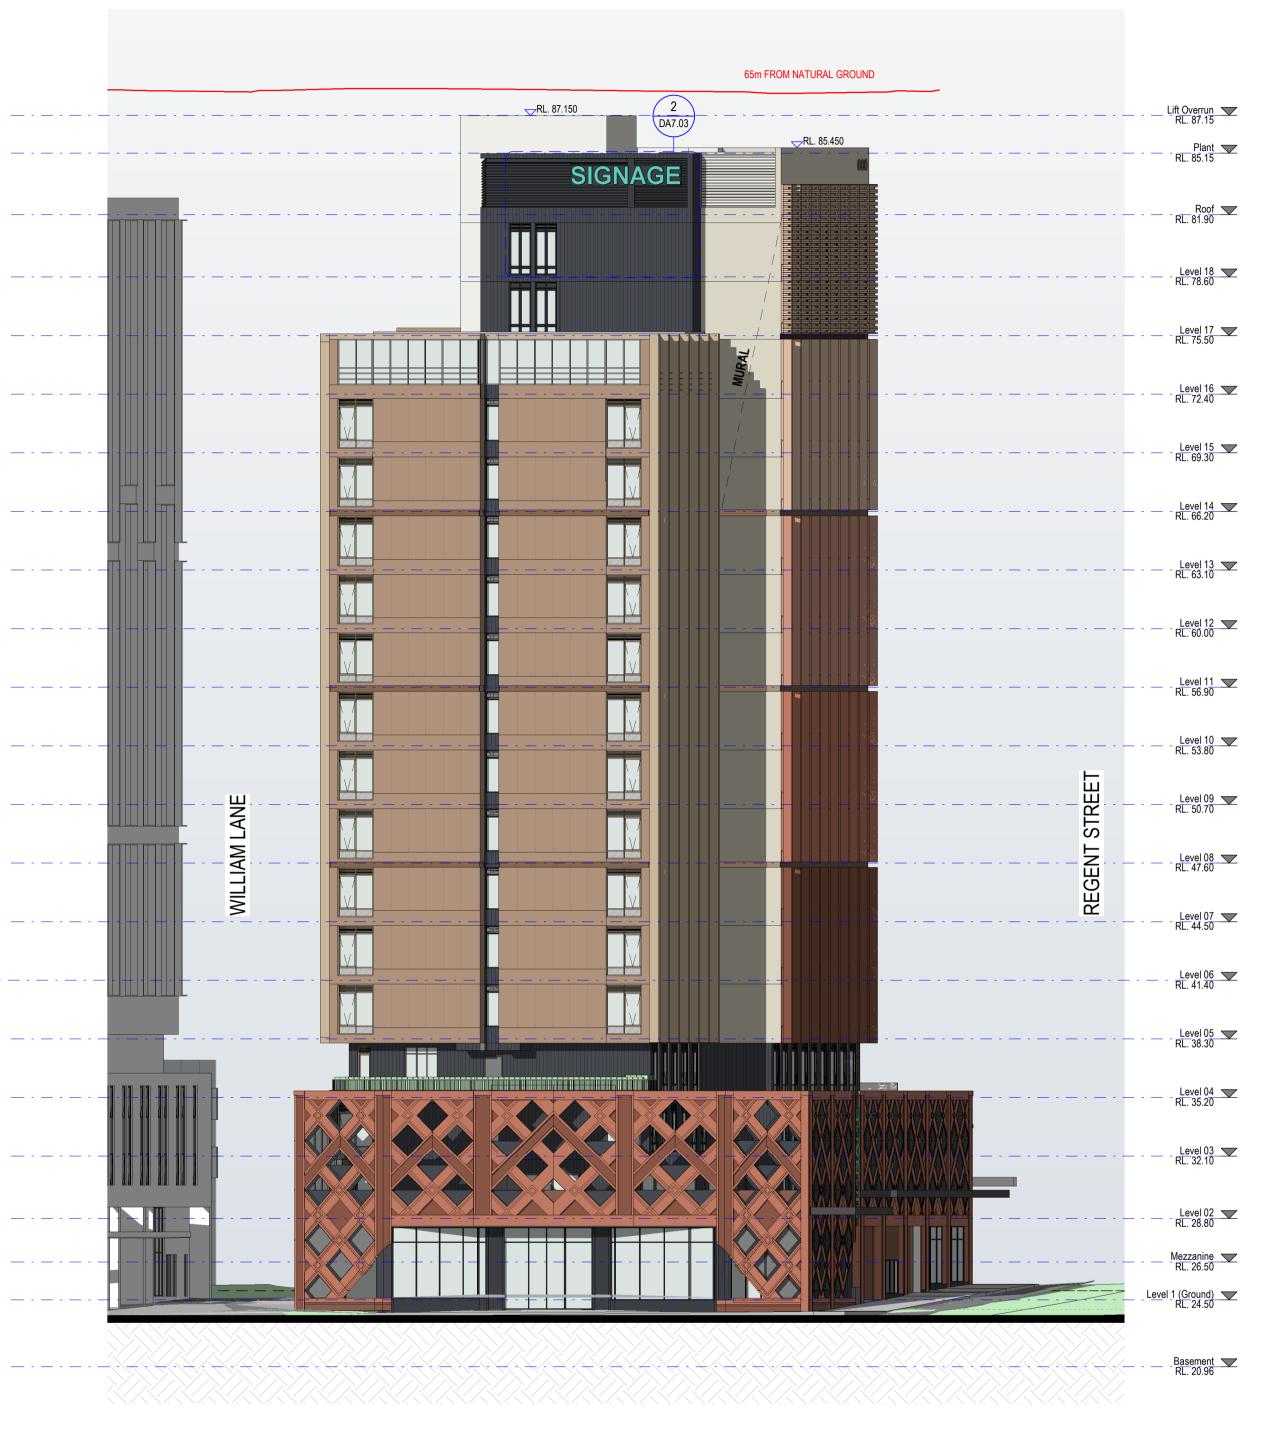PROJECT NO. 20009DA REGENT STREET ADDRESS 104-116 REGENT STREET WEE HUR

DRAWING SERIES **Elevations**

Elevation


Northern Elevation + Southern

DRAWING NO. **DA5.02** SCALE 1:200

REVISION

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Nominated Architect: Andreas Antoniades

NSW Registration 7954

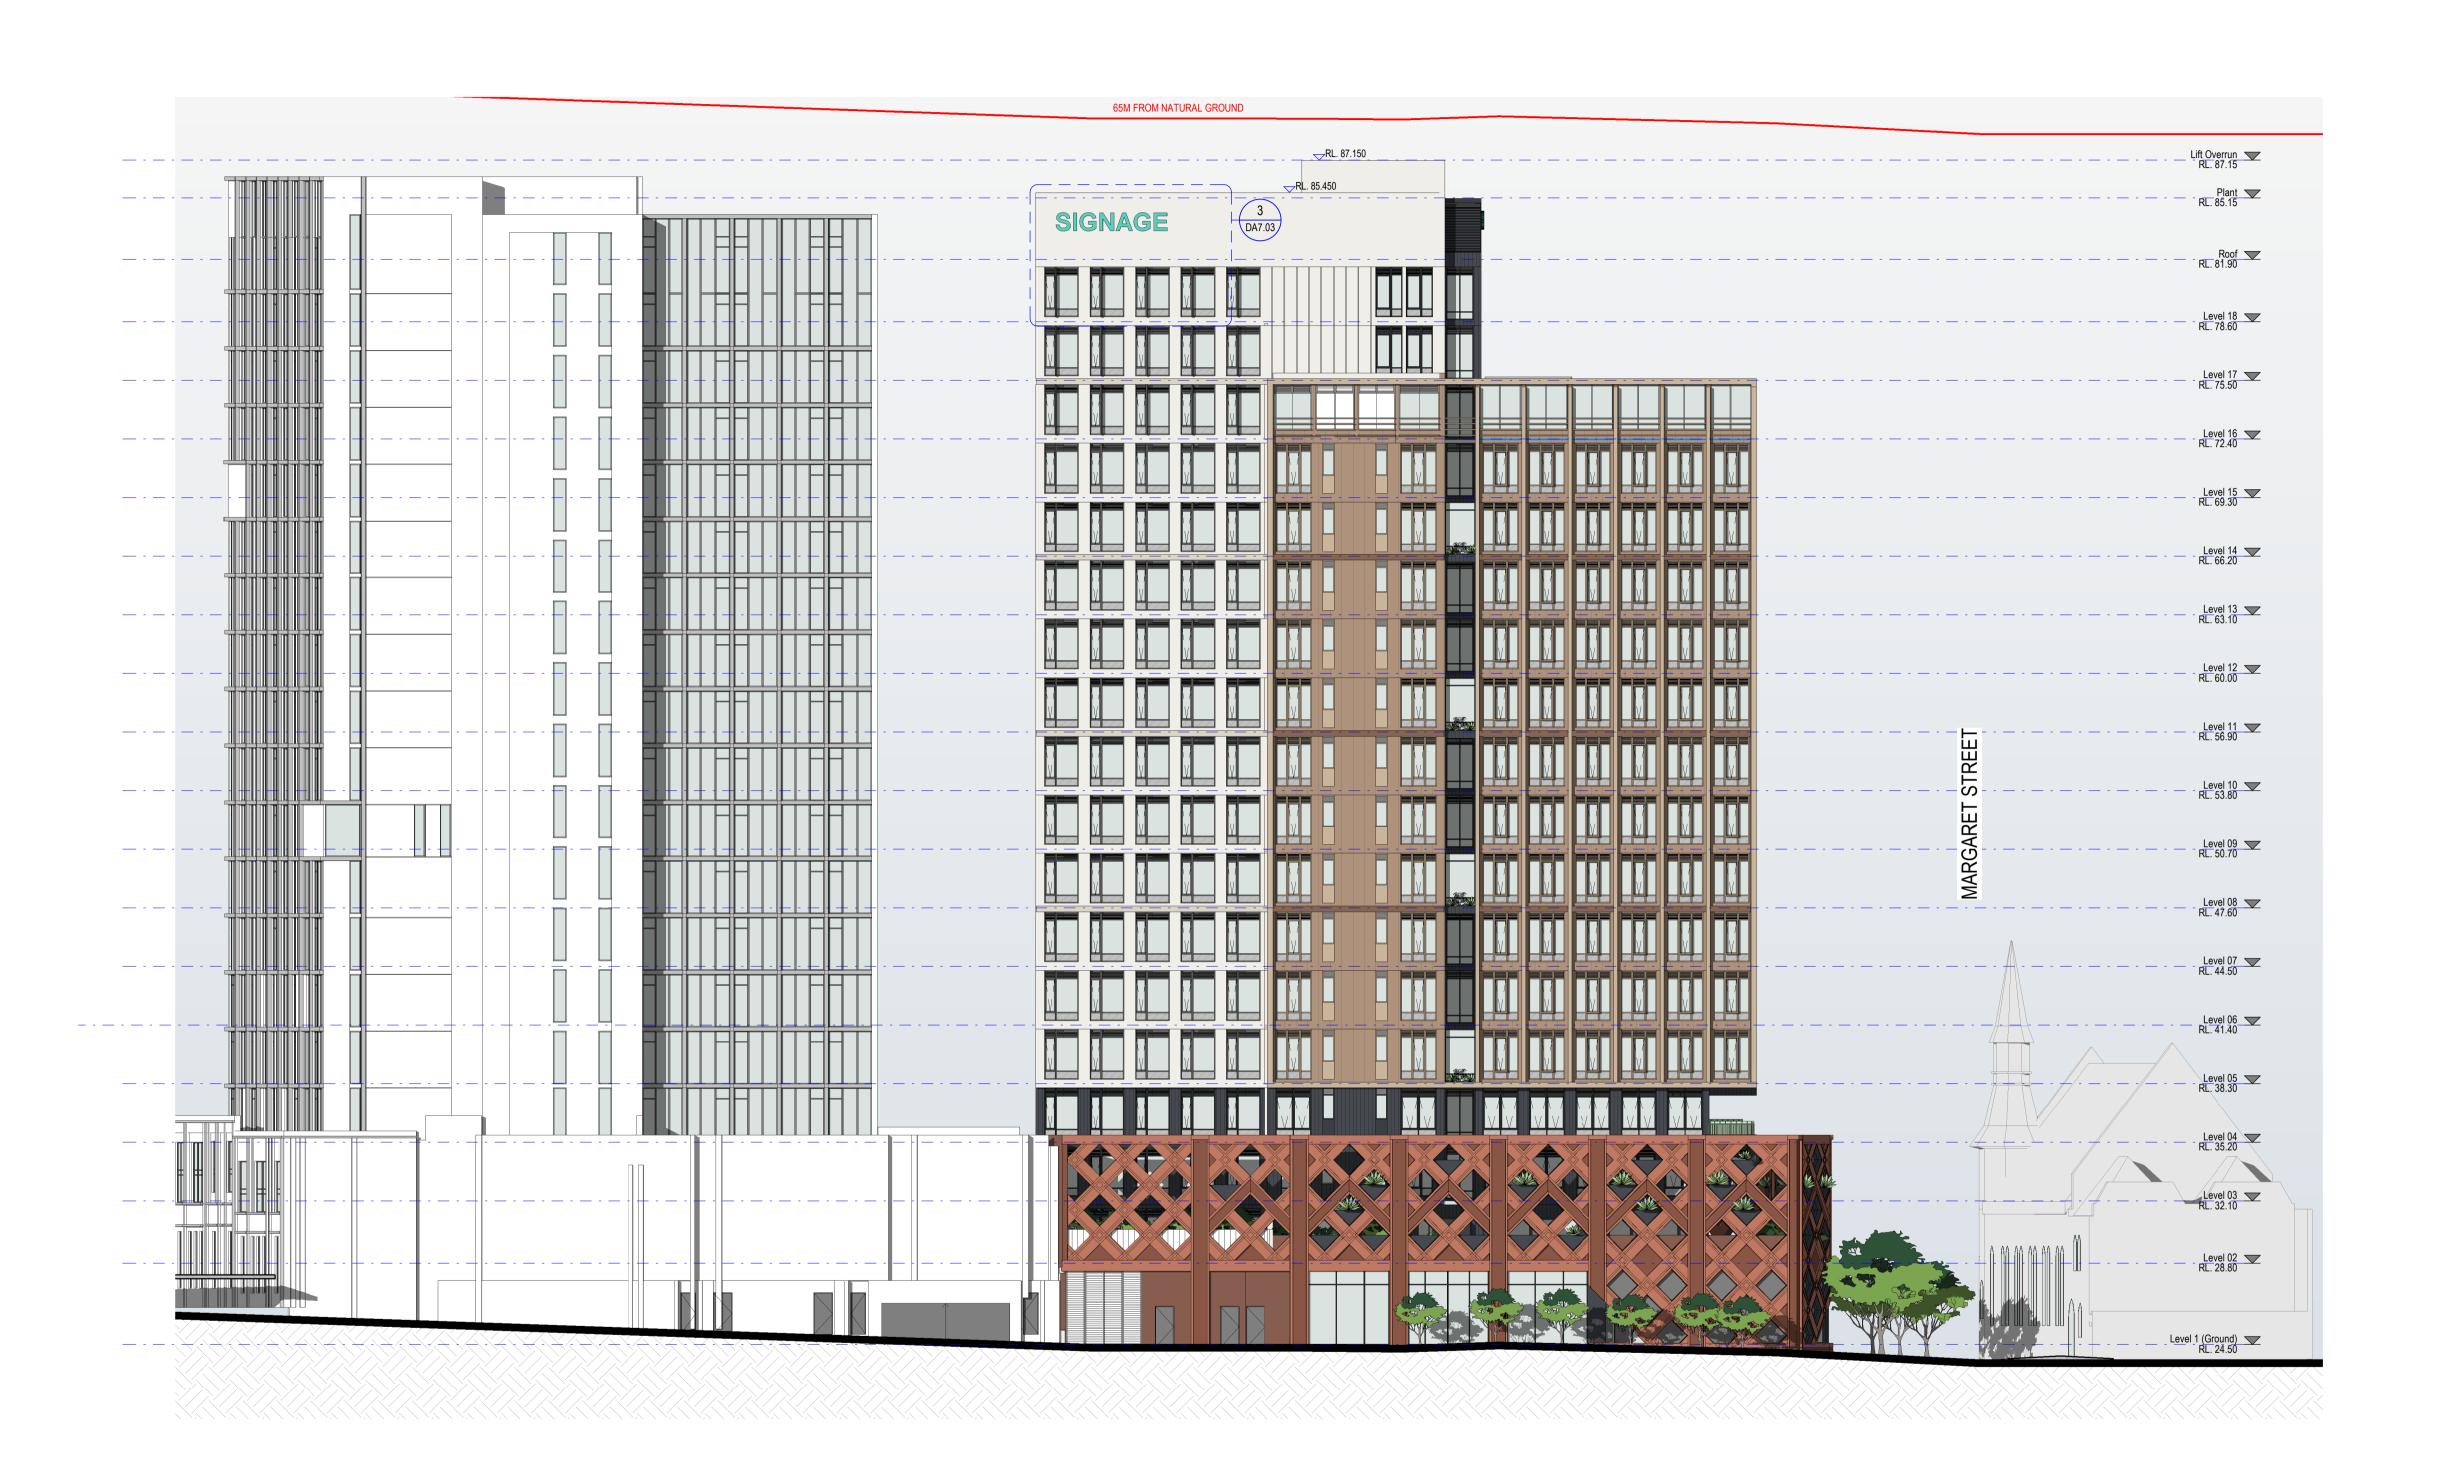PROJECT PHASE
DEVELOPMENT
APPLICATION
STATUS
FOR SUBMISSION

PROJECT NO.
20009DA

PROJECT

REGENT STREET

ADDRESS
104-116 REGENT STREET

CLIENT
WEE HUR

DRAWING SERIES
Elevations


DRAWING TITLE
William Ln - Elevation


DRAWING NO.

DA5.03


REVISION DRAWN BY
ZD
CHECKED BY
AA

SCALE
1: 200
0m
4
8
10m

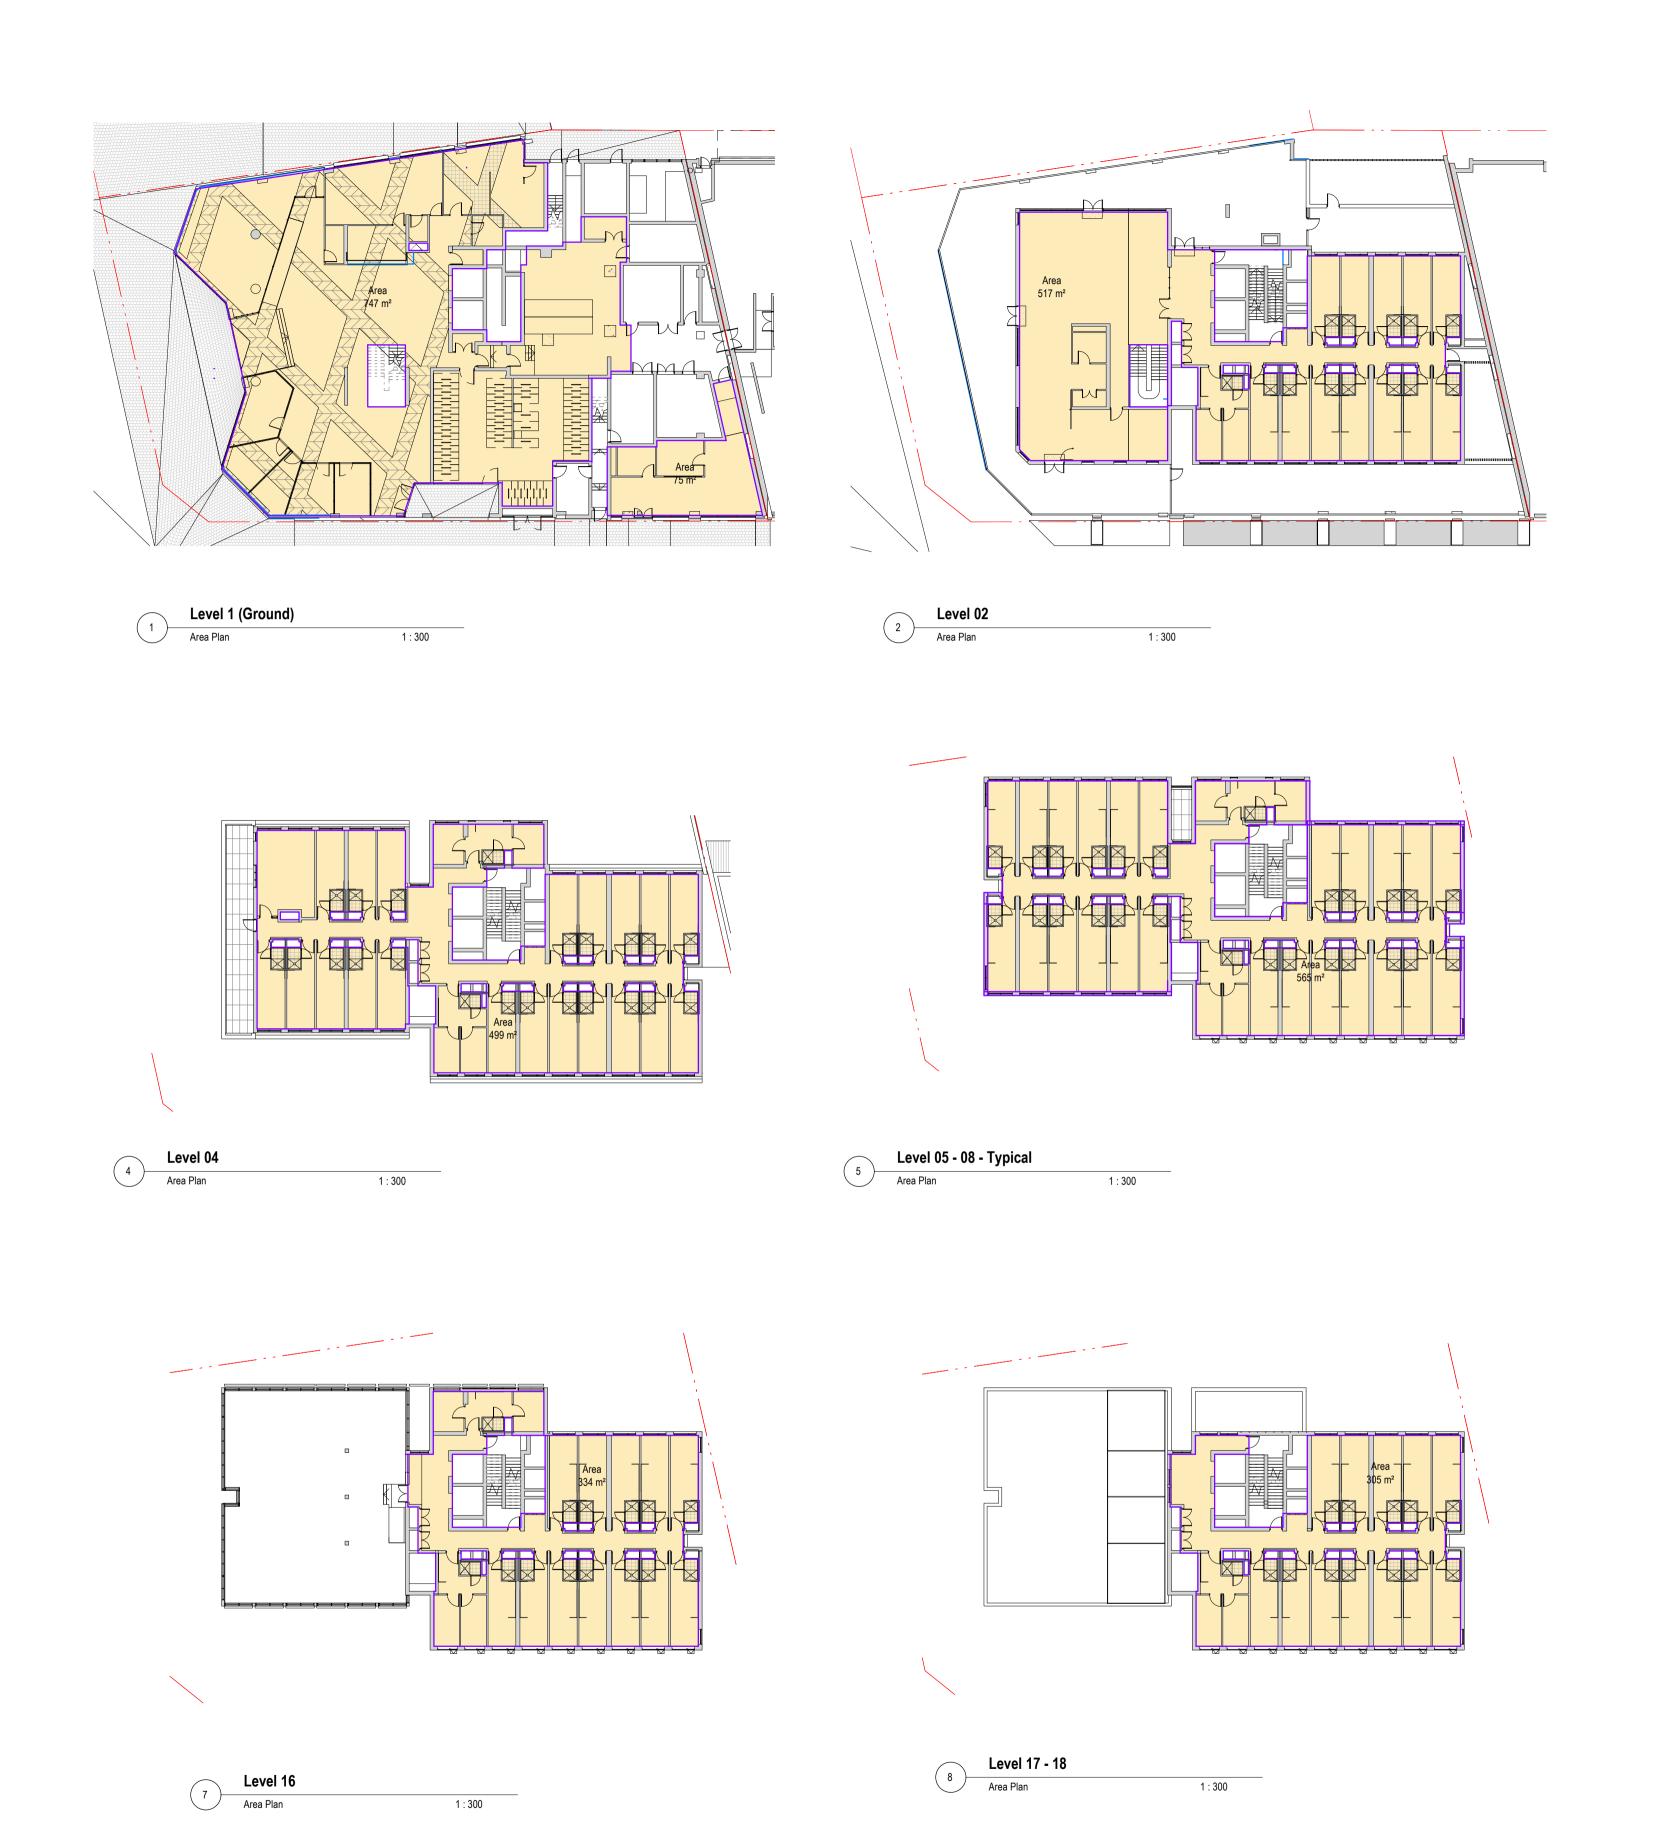

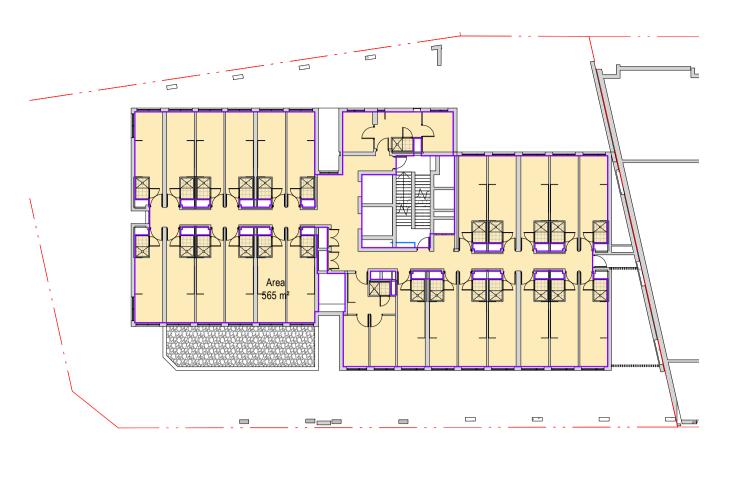



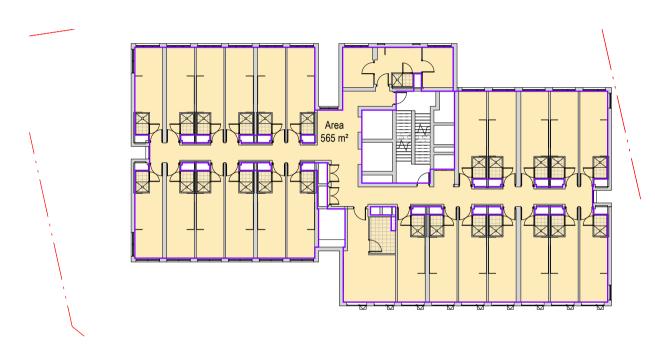

Level 09 -15 Typical

Т		I 1					Com.	Com.	ien ien	Maintenance
LEVELS	GFA	Studio A	Ensuite	2 Bed	Acc	Total Beds	Indoor Area*	Outdoor Area*	Landscaped Area*	Outdoor Area*
Level GF	822						394			
Level 02	517	7	5	1	0	14	186	237	424	15
Level 03	565	24	0	2	0	28				
Level 04	499	0	20	2	0	24	30		37	
Level 05	565	24	0	2	0	28			6	
Level 06	565	24	0	2	0	28				
Level 07	565	24	0	2	0	28				
Level 08	565	24	0	2	0	28			6	
Level 09	565	24	0	1	1	27				
Level 10	565	24	0	1	1	27				
Level 11	565	24	0	1	1	27			6	
Level 12	565	24	0	1	1	27				
Level 13	565	24	0	1	1	27				
Level 14	565	24	0	1	1	27			6	
Level 15	565	24	0	1	1	27				
Level 16	334	12	0	2	0	16		240	240	
Level 17	305	12	0	1	0	14				
Level 18	305	12	0	1	0	14				
						Total	610	477	725	15
Total R	ooms	331	25	24	7	1				
Bed	İs	331	25	48	7	1				
Total B	eds %	81%	6%	12%	2%	1				
Total Beds 41			11							
Total pe	er bed						1.5			
Propo	sed		Con	itrol						
GFA 9562		GFA	9562							
FSR 7			FSR	7						

- * Com. Indoor Area refers to all Indoor communal areas with minimum dimensions of 3m x 3m (as per the SEPP Housing 2021 Definition)
- * Landscaped Area refers to all outdoor areas with pavings, vegetation, outdoor furniture
- * Com. Outdoor Area refers to all outdoor communal areas with minimum dimensions of 3m x 3m (as per the SEPP Housing 2021 Definition) * Maintenance Outdoor Area refers to all outdoor landscaped areas that are not accessible by students (these areas will be accessed for maintenance only)

WORK IN PROGRESS

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DESCRIPTION BY DATE 19.05.2021 Issued for coordination 25.06.2021 Issued for information Issued for coordination 12.07.2021 Issued for information 22.10.2021 13.12.2021 Issued for DA Submission



www.antoniades.com.au

ACN 129 731 559

Nominated Architect: Andreas Antoniades

NSW Registration 7954

PROJECT PHASE DEVELOPMENT **APPLICATION** STATUS

ADDRESS 104-116 REGENT STREET FOR SUBMISSION

Site Area 1366


PROJECT NO. 20009DA REGENT STREET

WEE HUR

General Information

Project Data Schedule

DRAWING NO. **DA6.01**

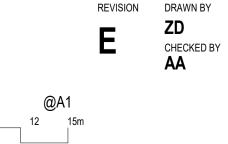







SD-JUNE 01PM












SD-JUNE 11AM
Floor Plan

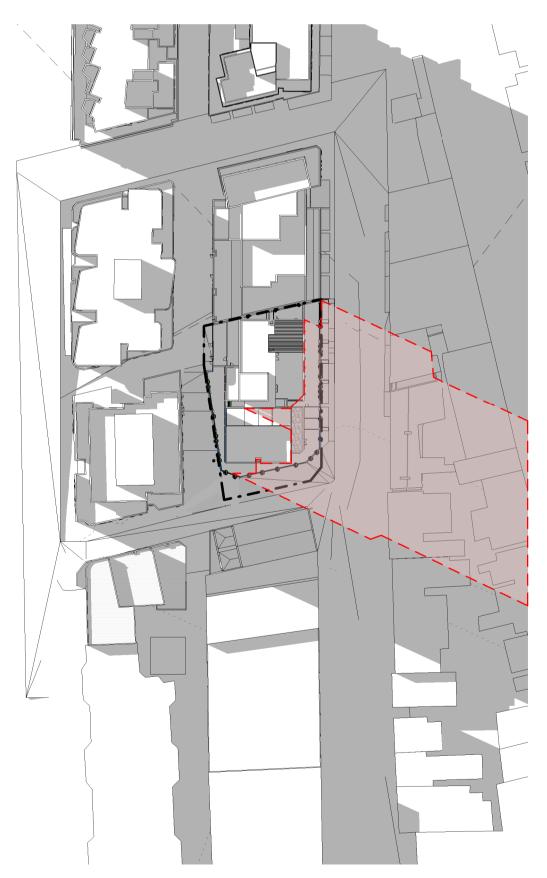

SD-JUNE 12PM
Floor Plan

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DESCRIPTION Issued for coordination Issued for DA Submission

BY DATE 25.11.2021 13.12.2021

ANTONIADES ARCHITECTS

SD-JUNE 03PM

Nominated Architect: Andreas Antoniades NSW Registration 7954 www.antoniades.com.au ACN 129 731 559

PROJECT PHASE DEVELOPMENT **APPLICATION**

FOR SUBMISSION

PROJECT NO. 2009DA PROJECT
REGENT STREET ADDRESS 104-116 REGENT STREET


WEE HUR

Design Analysis


Shadow Diagrams - 21 JUNE 2021

DRAWING NO. **DA6.02**


REVISION

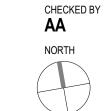

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DESCRIPTION Issued for DA Submission

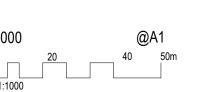BY DATE 13.12.2021 ANTONIADES ARCHITECTS

Nominated Architect: Andreas Antoniades NSW Registration 7954 www.antoniades.com.au ACN 129 731 559

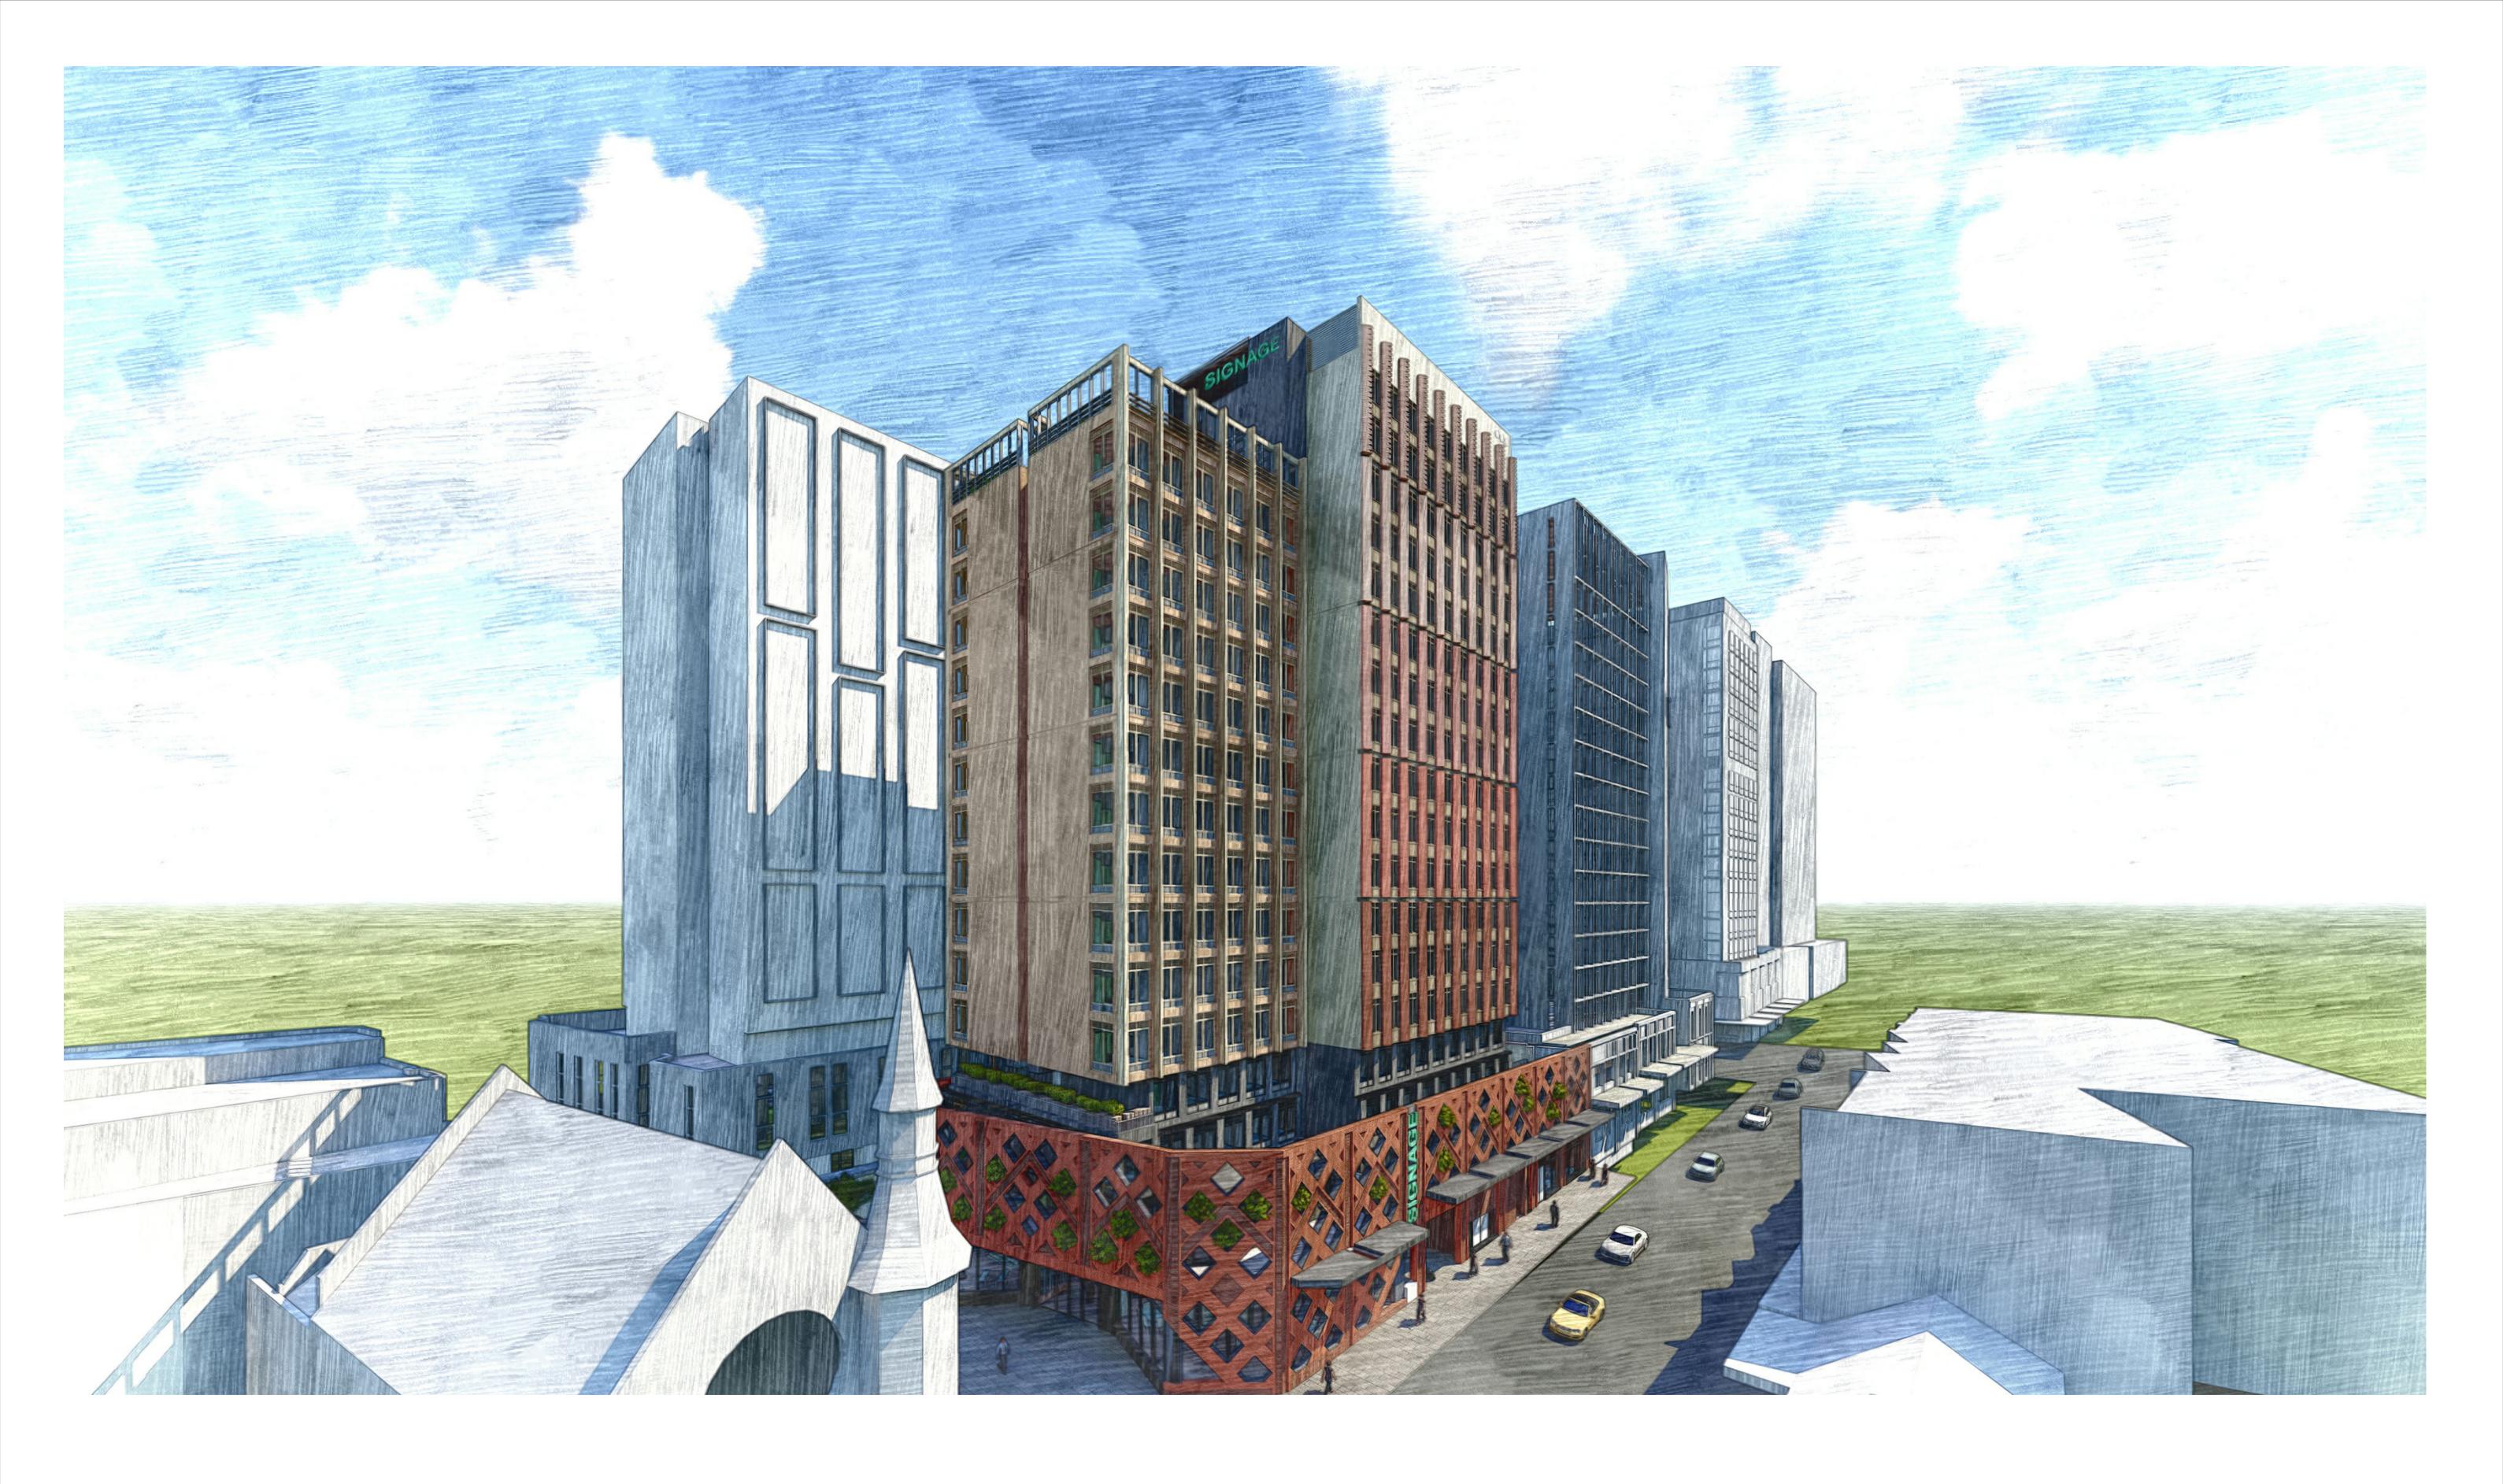PROJECT PHASE DEVELOPMENT APPLICATION STATUS

FOR SUBMISSION

PROJECT NO. 20009DA PROJECT
REGENT STREET ADDRESS 104-116 REGENT STREET


WEE HUR


DRAWING SERIES **Photomontage** CGIS

DRAWING NO. DA7.01

REVISION DRAWN BY



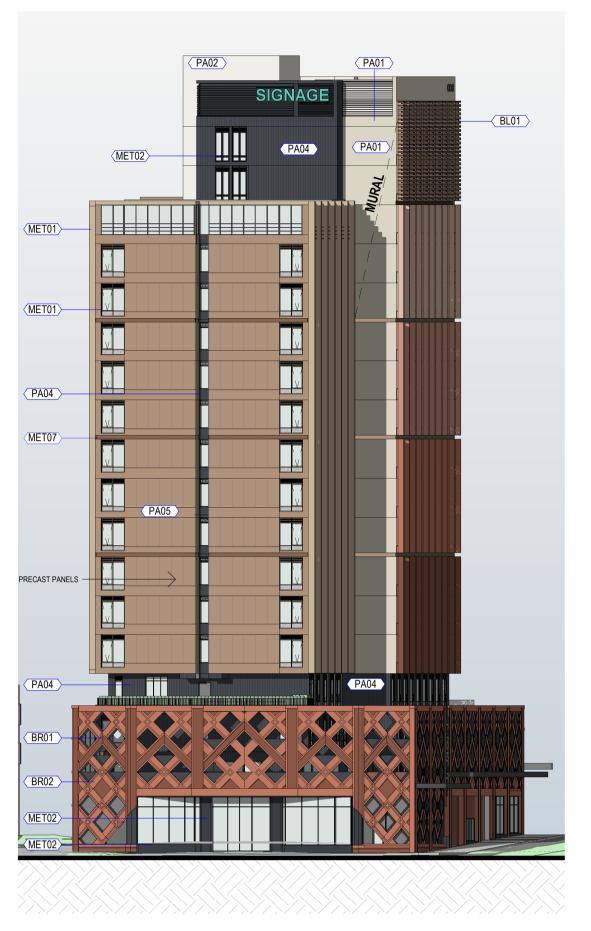

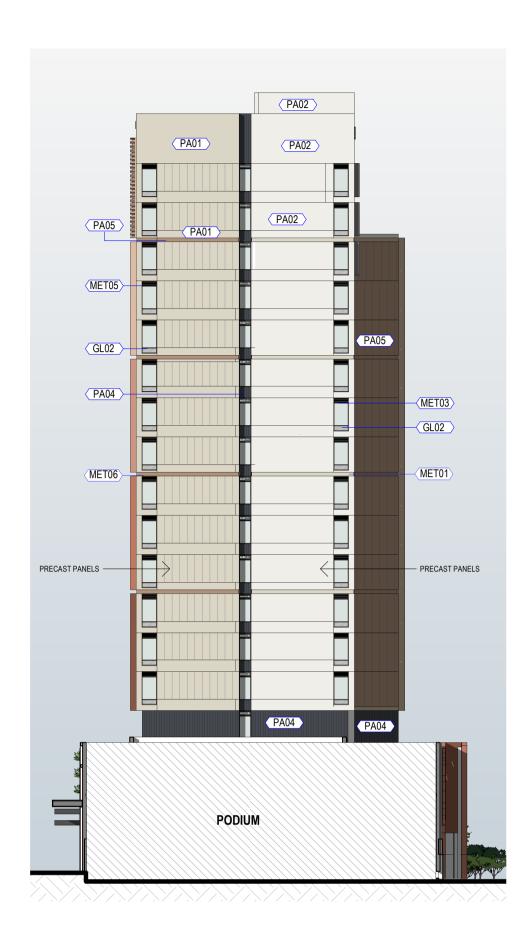



FINISHES SCHEDULE



BR - 01 PODIUM BRICKS:DRY **PRESSED MACARTHUR MIX**



BR - 02 PODIUM BRICKS :DRY PRESSED MCKINLAY **BROWN**



MET - 01 WINDOW/ DOOR FRAME/BLADES/RECESS **DULUX POWDERCOAT** PAPERBARK SATIN 2723088S



MET - 02 WINDOW/ DOOR FRAME/AWNING **DULUX POWDERCOAT MONUMENT SATIN**

2729067S




MET - 03 WINDOW/ DOOR FRAME/BLADES : DULUX **POWDERCOAT** STONE GREY SATIN 27278126



MET - 04 RECESS 01: DULUX **POWDERCOAT ANOTEC MID BRONZE MATT** 27251014



MET - 05 WINDOW/ DOOR FRAME/BLADES : **DULUX POWDERCOAT JASPER MATT** 2608252M

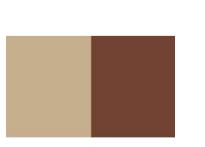

BL - 01 **BLADES GRADIENT: DULUX POWDERCOAT** FROM TERRAIN_MATT_ 2608234M **TO STONE** BEIGE_MATT_7232538



MET - 06 RECESS 02: **DULUX POWDERCOAT** STONE BEIGE MATT 27232538



MET - 07 RECESS 03: **DULUX POWDERCOAT** TERRAIN_MATT_ 2608234M



PA - 01 **WALL PAINT:** DULUX **GRAND PIANO** A204



PA - 02 WALL PAINT: DULUX ANTIQUE WHITE USA 16W



PA - 03 **WALL PAINT: DULUX HAROLD** A191 (WALL COLOR TO MATCH MET - 05)




PA - 04 **WALL PAINT: DULUX DOMINO** SG6G8



PA - 05 **WALL PAINT: DULUX SMOOTH CARAMEL S11D5**



PA - 06 SIGN COLOR: **DULUX PEPPERMINT FRESH** S26G5 (TBC BY WEEHUR)

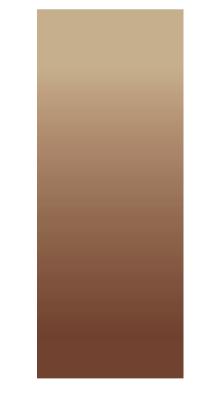

BL - 01 BLADES GRADIENT: DULUX POWDERCOAT FROM TERRAIN_MATT_2608234M TO STONE BEIGE_MATT_7232538

GL - 01 **WINDOW GLASS: CLEAR** GL - 02

WINDOW GLASS : COLORBACK

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DESCRIPTION Issued for information Issued for coordination Issued for DA Submission

DATE 22.10.2021 25.11.2021 13.12.2021 ANTONIADES ARCHITECTS

PROJECT PHASE DEVELOPMENT **APPLICATION** STATUS FOR SUBMISSION

PROJECT NO. 20009DA PROJECT REGENT STREET CLIENT WEE HUR

ADDRESS 104-116 REGENT STREET

DRAWING SERIES **Materials & Finishes**

Material Board


DRAWING TITLE

DRAWING NO. REVISION **DA7.02** As indicated


DRAWN BY

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DESCRIPTION BY DATE Issued for coordination 25.11.2021 Issued for DA Submission 13.12.2021

ANTONIADES ARCHITECTS

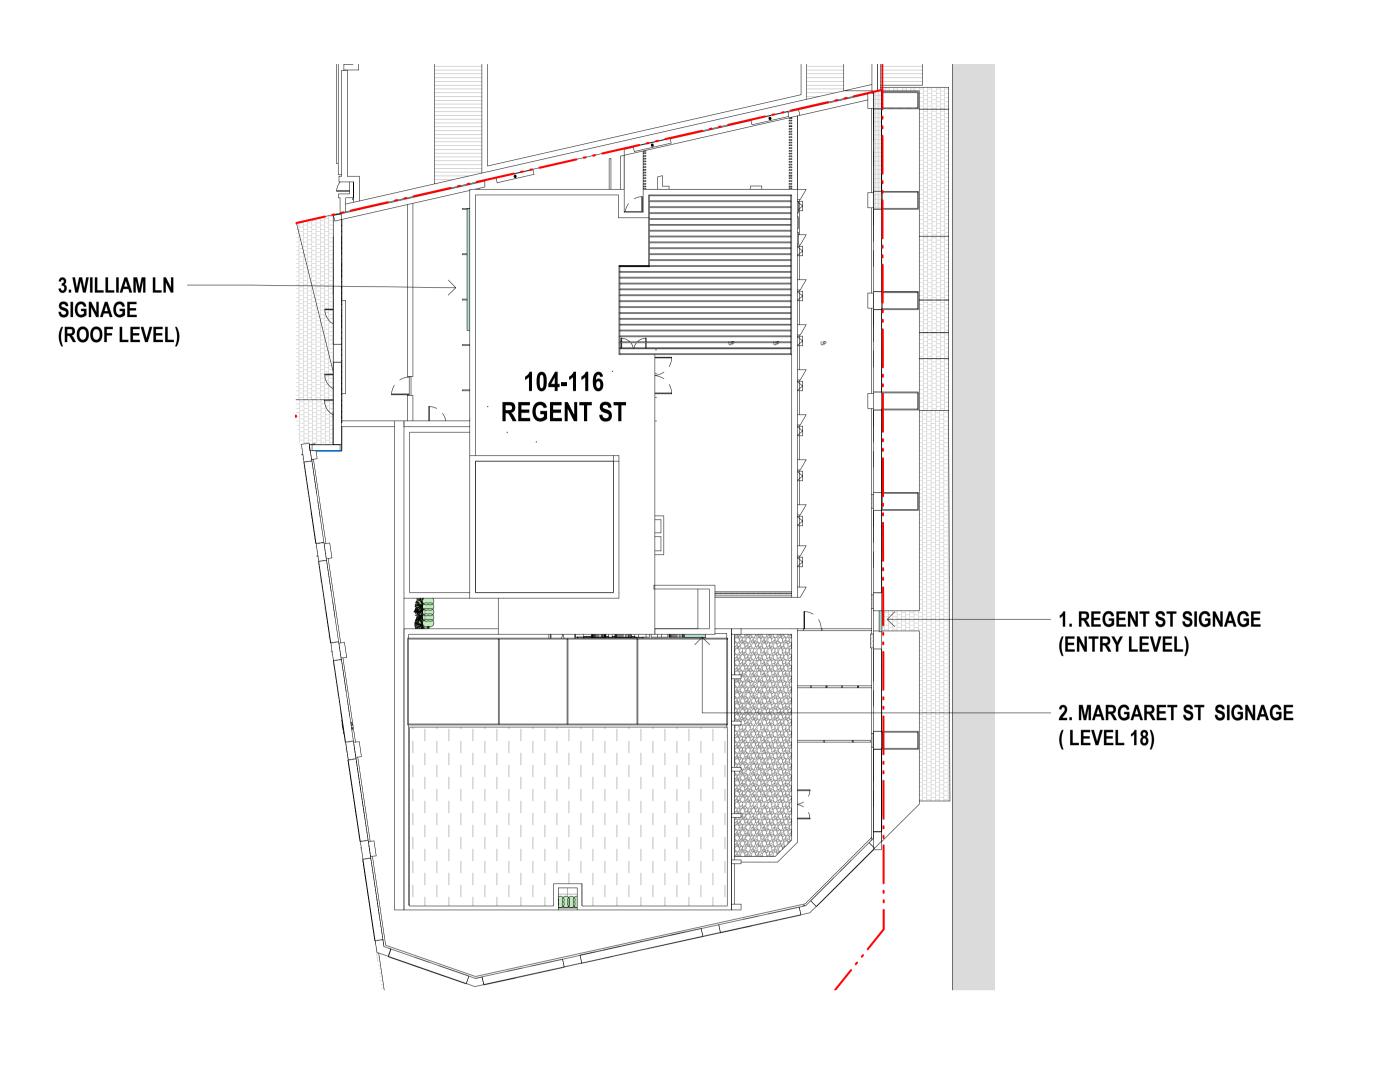www.antoniades.com.au

ACN 129 731 559

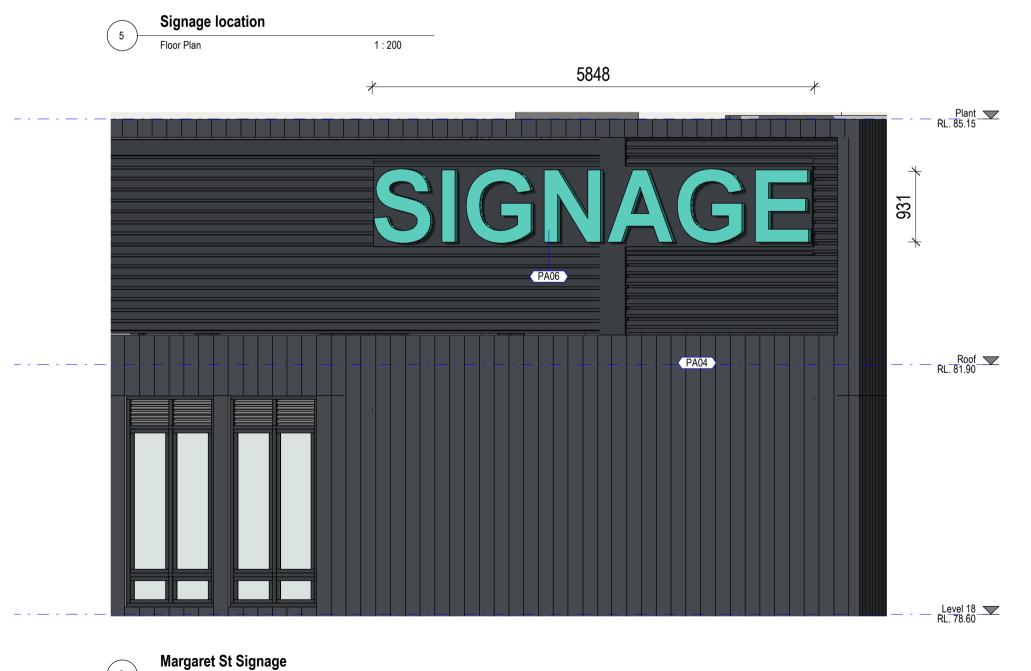Nominated Architect: Andreas Antoniades

NSW Registration 7954

PROJECT PHASE

DEVELOPMENT
APPLICATION

STATUS

FOR SUBMISSION

PROJECT NO.
20009DA

PROJECT
REGENT STREET

ADDRESS
104-116 REGENT STREET

CLIENT
WEE HUR

DRAWING SERIES
Photomontage

NT STREET

B REGENT STREET

DRAWING TITLE

Signage Details

DRAWING NO.


DA7.03


SCALE
As indicated

B CHECKED BY AA NORTH

REVISION


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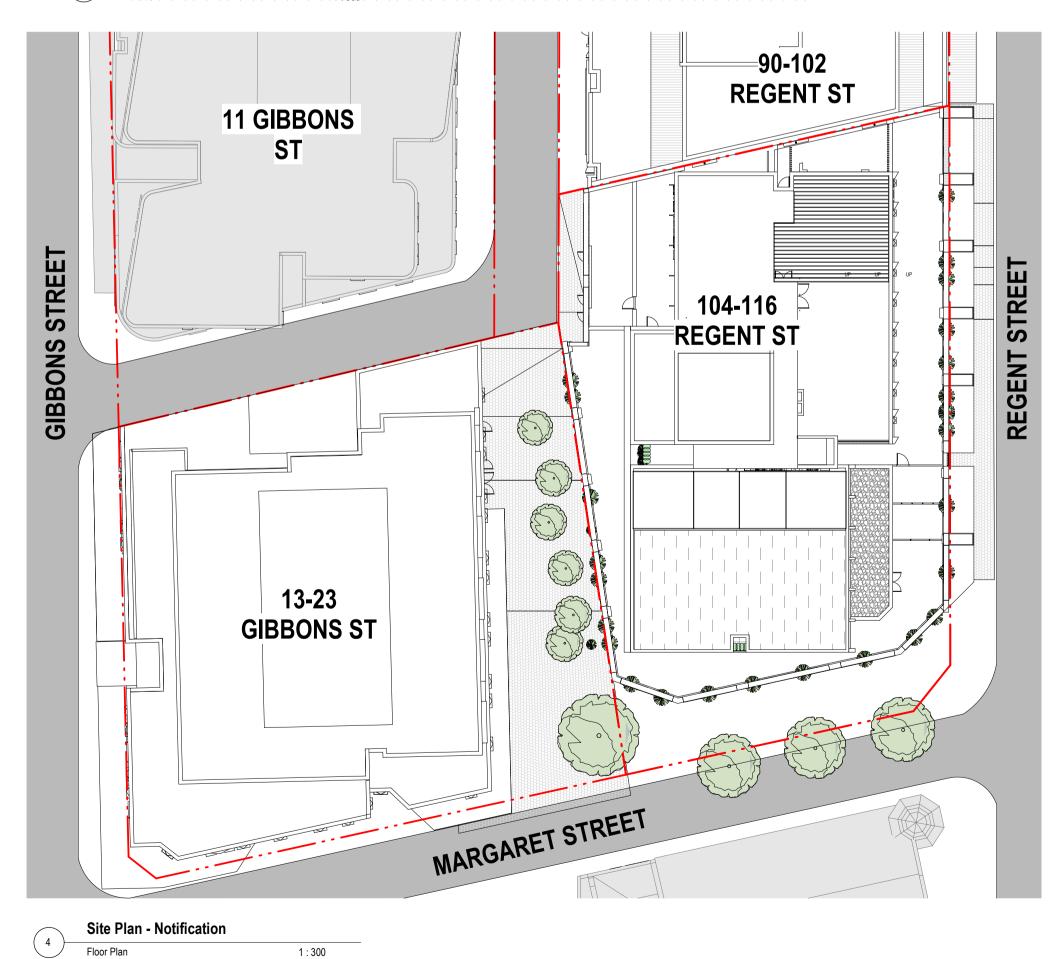


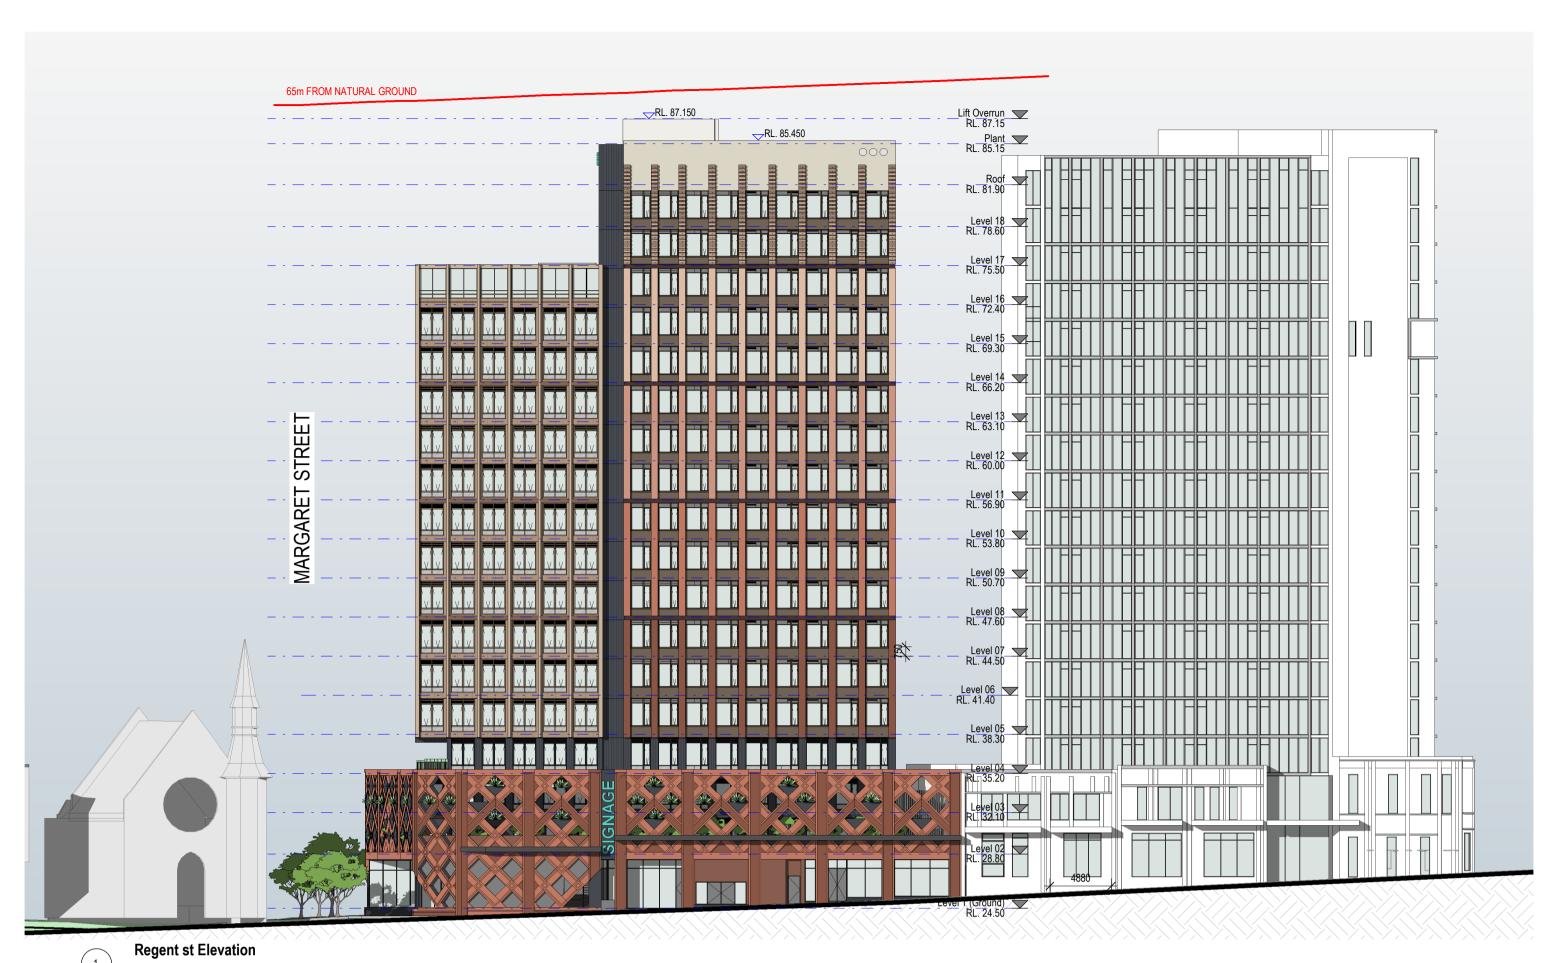

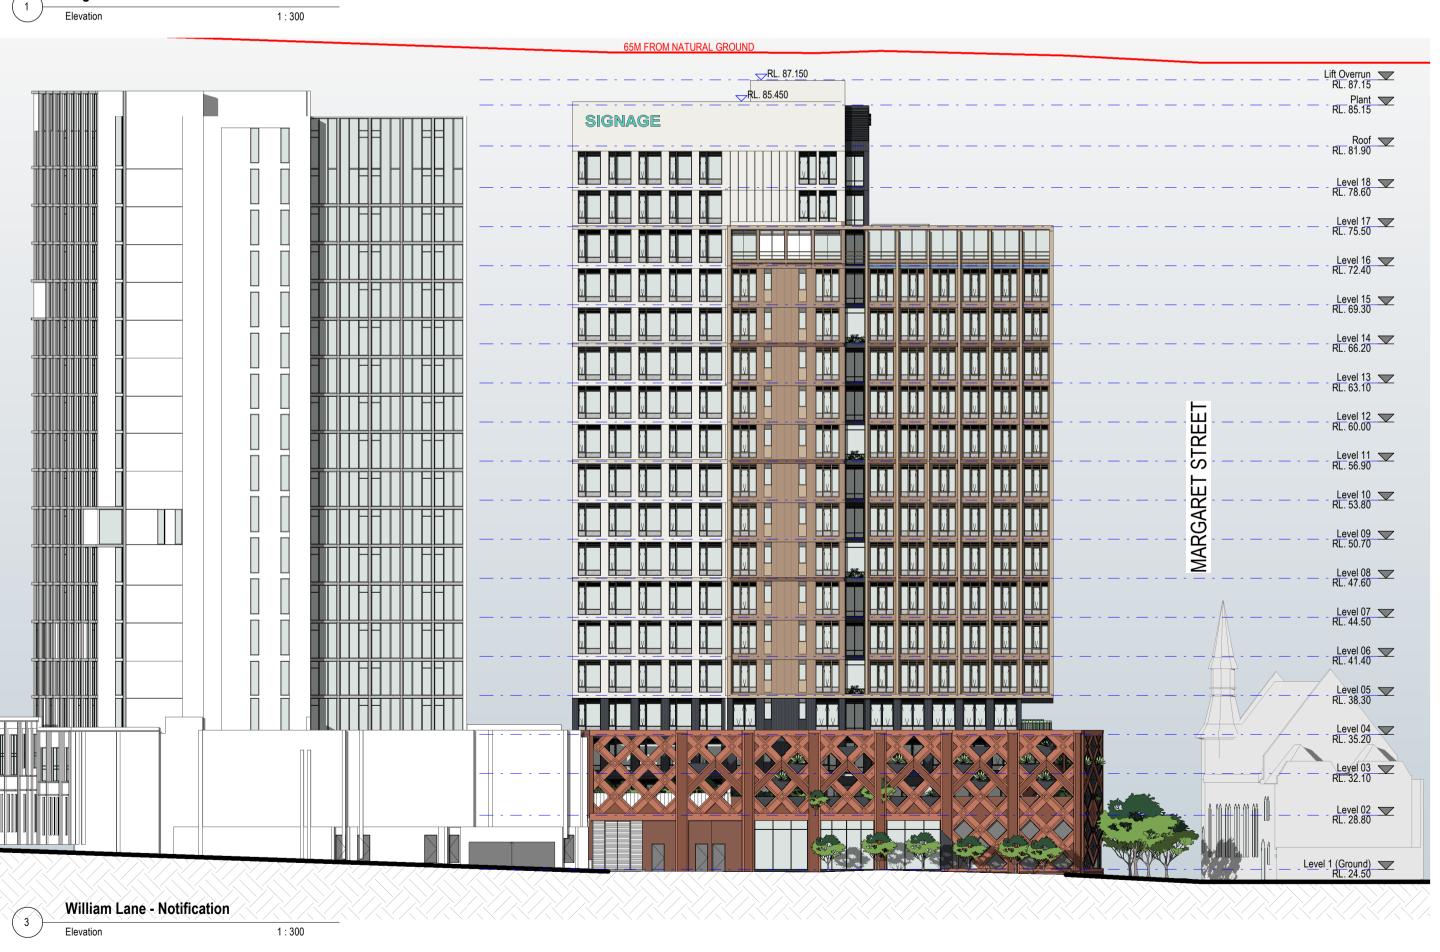DATE

13.12.2021



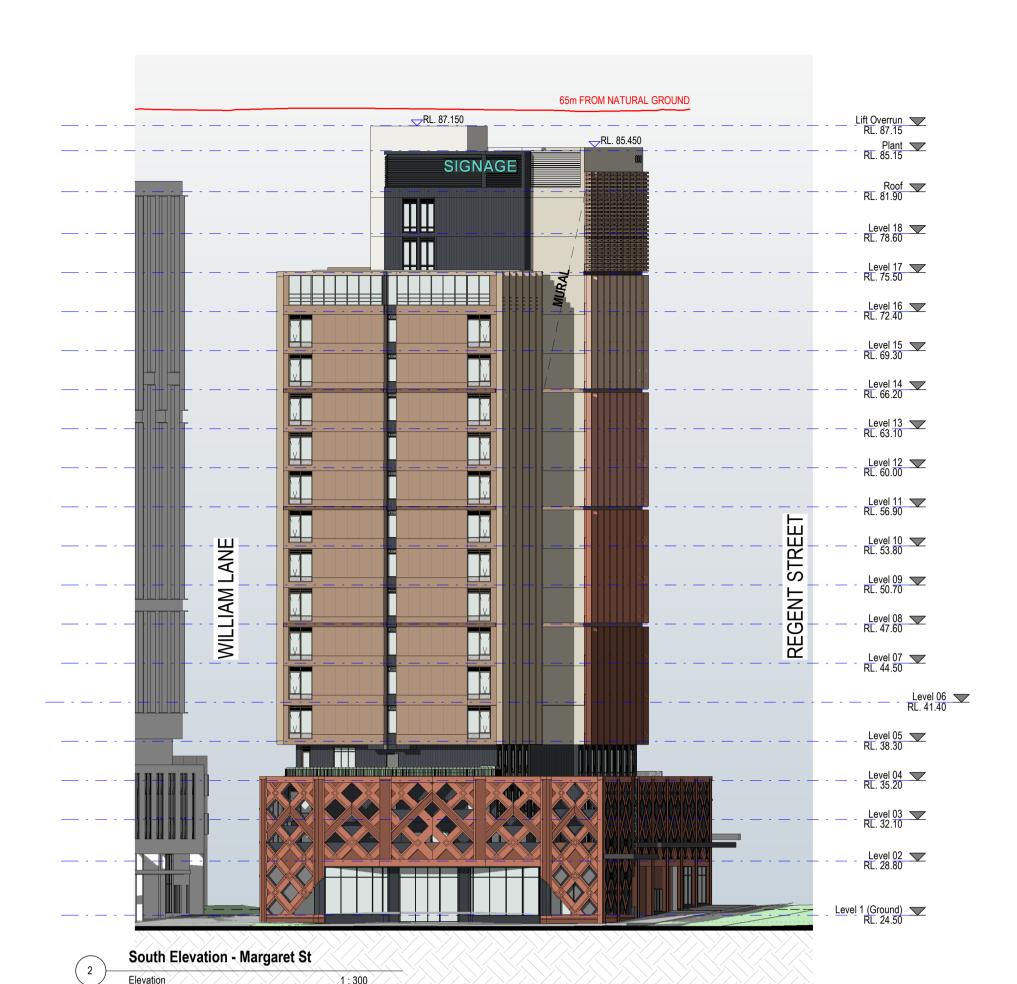

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ANTONIADES ARCHITECTS

PROJECT PHASE DEVELOPMENT **APPLICATION** STATUS


FOR SUBMISSION

PROJECT NO. 20009DA REGENT STREET ADDRESS 104-116 REGENT STREET WEE HUR

DRAWING SERIES **Notification Plans**

Notification Plan

DRAWING NO. **DA8.01** SCALE 1:300

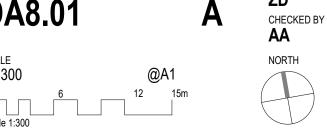

REVISION

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