# HARRIS PAGE & ASSOCIATES STORMWATER CONCEPT PLAN FOR DEVELOPMENT APPLICATION OF NEW LEARNING CENTRE 6A WATSFORD ROAD, CAMPBELLTOWN


# STORMWATER SERVICES LEGEND

## DRAWING SCHEDULE

DWG No.	Scale	Drawing Title
SW-00	NTS	STORMWATER SERVICES COVER SHEET, LEGEND & DRAWING SCHEDULE
SW-01	1:200	STORMWATER SERVICES- SITE PLAN
SW-02	1:100	STORMWATER SERVICES- ROOF
SW-03	NTS	STORMWATER SERVICES- DETAIL SHEET
SW-04	NTS	STORMWATER SERVICES- SEDIMENT CONTROL PLAN

ABBREVIATIONS, SYMBOLS AND LINETYPES IN THE LEGEND MAY NOT APPEAR ELSEWHERE ON THE DRAWINGS. THIS LEGEND SHOULD BE USED AS A GUIDE ONLY

SYMBOLS	
0	RISER
С	DROPPER
C	TEE DROPPER
3	PIPEWORK CAP
-	DIRECTION ARROW
$\vdash$	NEW CONNECTION
ightharpoons	CONTINUATION
//	TERMINATOR 1
7	TERMINATOR 2
$\bowtie$	STOP VALVE
DDI	DOUBLE CHECK VALVE
7	REFLUX VALVE
$\bowtie$	CHECK VALVE
N	OVERFLOW
RWO 🚳	RAIN WATER OUTLET
	GRATED TRENCH DRAIN
	GRATED STW PIT
	SEALED STW PIT
ш	SPREADER

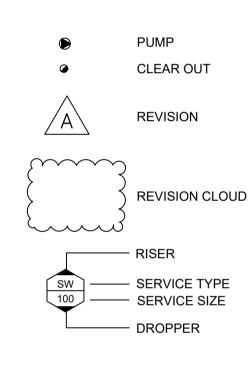

A/B	ABOVE	m	METRES
@	AT	MAX	MAXIMUM
во	BALCONY OUTLET	MIN	MINIMUM
ВТ	BOUNDARY TRAP	MM	MILLIMETERS
CIS	CAST IN SLAB	N.T.S	NOT TO SCALE
СО	CLEAROUT	O/F	OVER FLOW
CONT	CONTINUATION	%	PERCENTAGE
CV	CHECK VALVE	RL	REDUCED LEVEL
DCV	DOUBLE CHECK VALVE	RWH	RAIN WATER HEAD
DIA	DIAMETER	RWR	RAINWATER REUSE
DP	DOWNPIPE	RWO	RAINWATER OUTLET
е	EXISTING	RV	REFLUX VALVE
EL	ELECTRICAL CONDUIT	S	SEWER
FW	FLOOR WASTE	SMH	SEWER MANHOLE
GA	GREASE ARRESTOR	SS	SUB SOIL DRAINAGE
HDPE	HIGH DENSITY POLYETHYLENE	S/STEEL	STAINLESS STEEL
H/L	HIGH LEVEL	STW	STORMWATER
HP	HIGH POINT	SV	STOP VALVE
H.S.A.S	HEEL SAFE ANTI-SLIP	SWP	STORMWATER PIT
IL	INVERT LEVEL	TD	TUNDISH
KIP	KERB INLET PIT	U/S	UNDERSIDE
L	LITRE	UV	ULTRA-VIOLET
L/L	LOW LEVEL		
1.7-	LITREO DED OFOCNID		

**ABBREVIATIONS** 

COPYRIGHT OF HARRIS PAGE & ASSOCIATES Pty Ltd. All rights reserved. This drawing may not be re-produced or transmitted in any form, or by any means in part or in whole without permission from HARRIS PAGE & ASSOCIATES Pty Ltd. Figured dimensions shall be taken in preference to scaling. The contractor shall check all dimensions on drawings and site before commencing work.

P3	DRAFT DA SUBMISSION - FOR APPROVAL	25.10.19
P2	DRAFT DA SUBMISSION	17.10.19
P1	DRAFT DA SUBMISSION	01.10.19
ISSUE	AMENDMENT	DATE








NEW LEARNING CENTRE 6A WATSFORD ROAD, CAMPBELLTOWN


LITRES PER SECOND

1	DRA	WING TITLE
	H	YDRAULIC SERVICES
	C	OVER SHEET, LEGEND

& DRAWING SCHEDULE

	6444	9	SW-0	0	P3	
	PROJECT No.	D	RAWING No.	•	REVISION	
S	SEP. 2019	KJ/KP	DP	1 OF 5	NTS @ A1	
	DATE	DRAWN	CHECKED	No IN SET	SCALE	

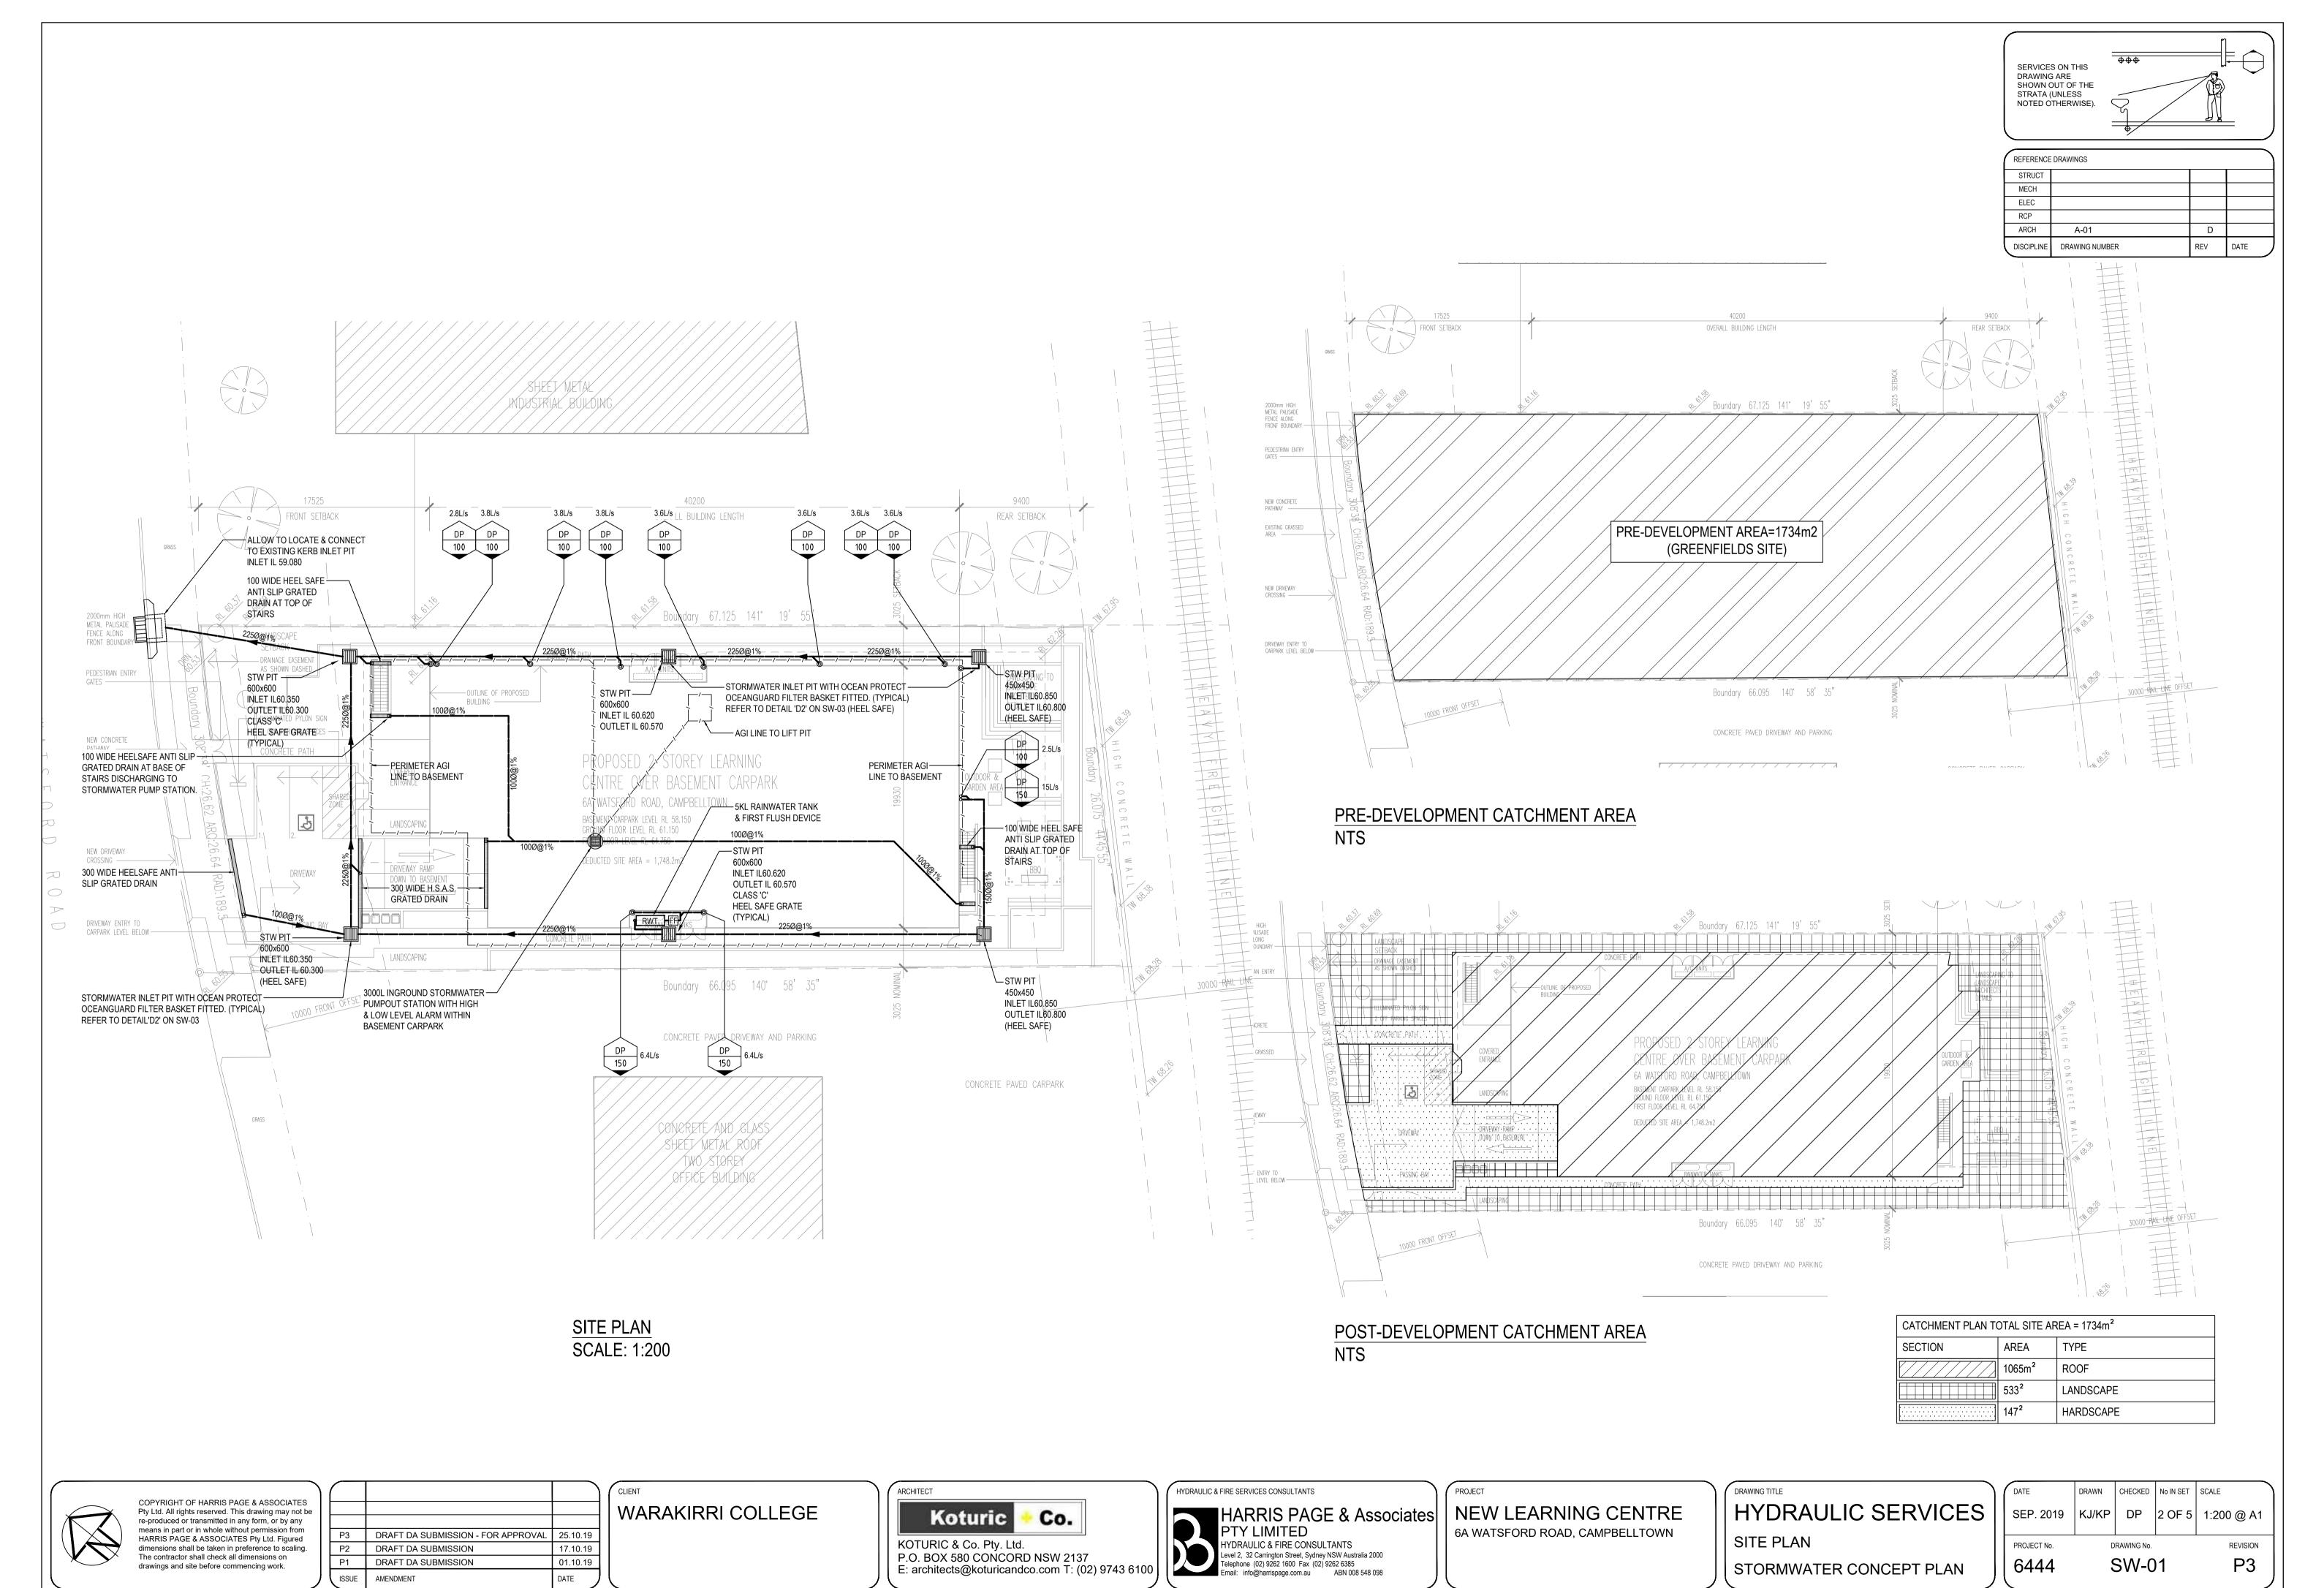


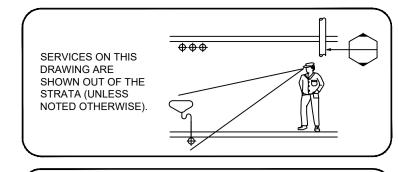


1	REFERENCE	DRAWINGS		
	STRUCT			
	MECH			
	ELEC			
	RCP			
	ARCH	A-05	С	
(	DISCIPLINE	DRAWING NUMBER	REV	DATE

#### NOTES:

1. TERMINATE OVERFLOW PIPES ABOVE FINISHED FLOOR LEVEL AND DIRECTED AWAY FROM BUILDING.

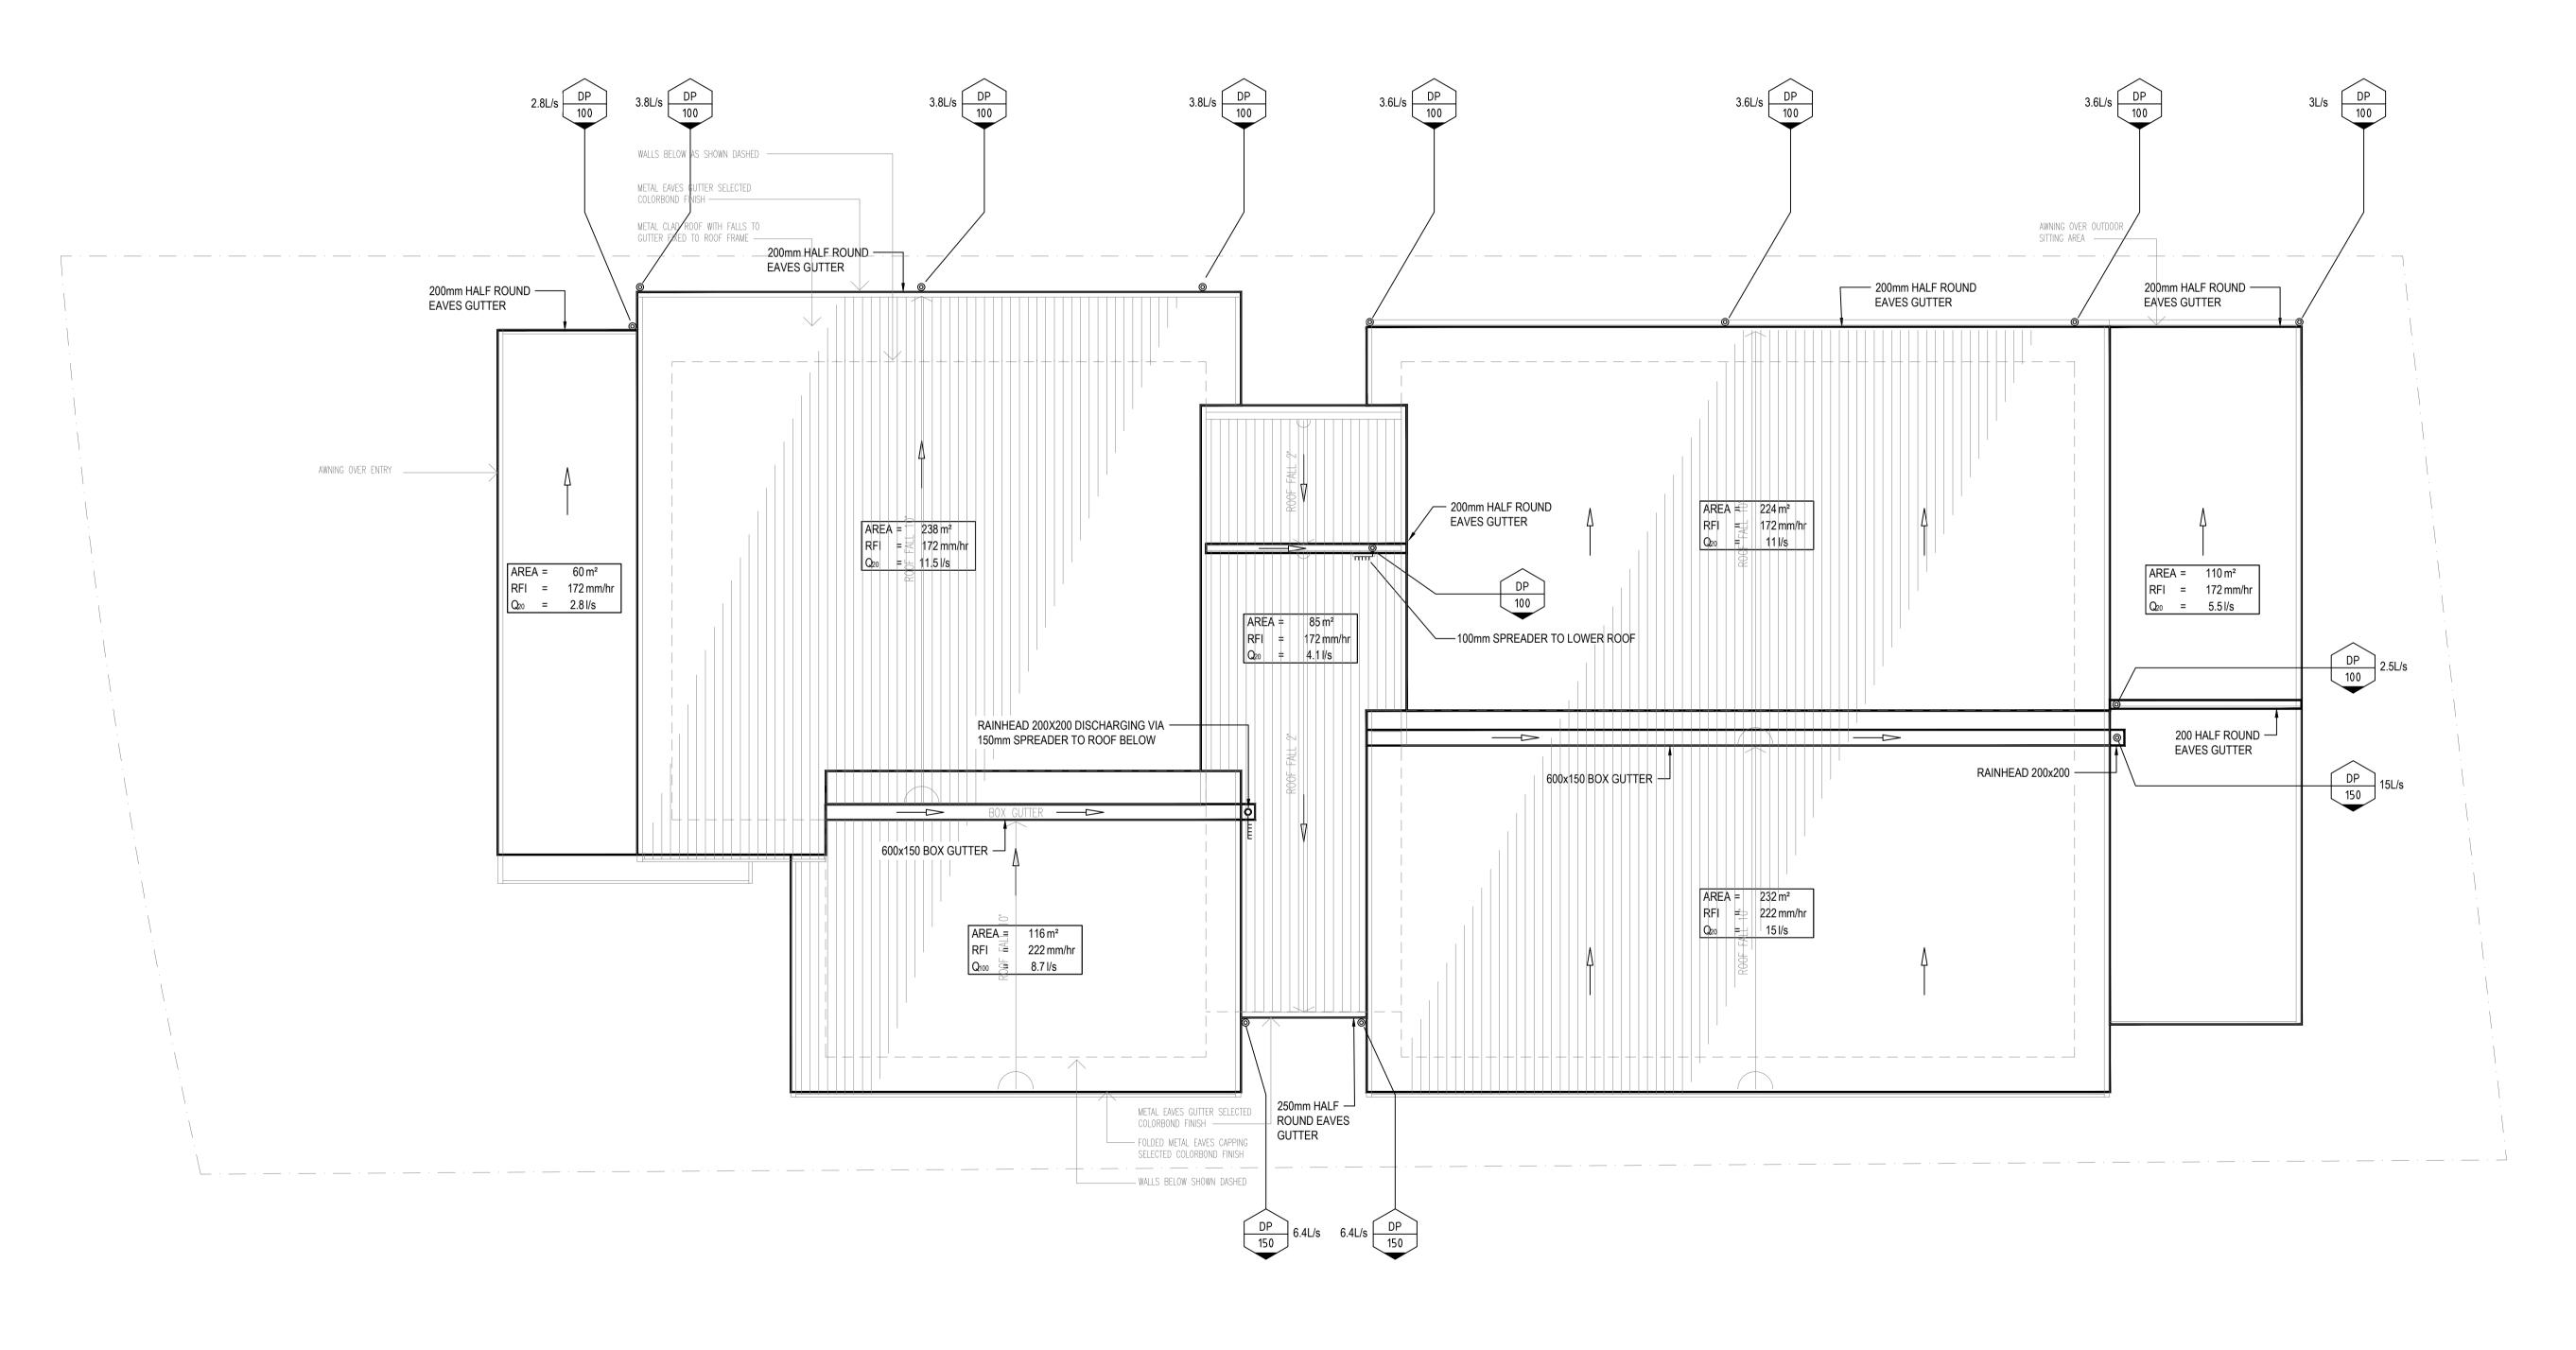

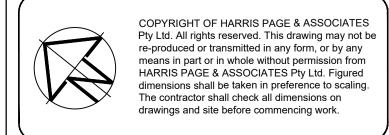

			(0
			l۱
			١ '
P3	DRAFT DA SUBMISSION - FOR APPROVAL	25.10.19	
P2	DRAFT DA SUBMISSION	17.10.19	
P1	DRAFT DA SUBMISSION	01.10.19	
ISSUE	AMENDMENT	DATE	

WARAKIRRI COLLEGE







NEW LEARNING CENTRE 6A WATSFORD ROAD, CAMPBELLTOWN

1	DRAWING TITLE
	HYDRAULIC SERVICES
	ROOF PLAN
	STORMWATER CONCEPT PLAN

	DATE	DRAWN	CHECKED	No IN SET	SCALE
ES	SEP. 2019	KJ/KP	DP	3 OF 5	1:100 @ A1
	PROJECT No.	D	RAWING No.		REVISION
	6444	SW-02		P3	

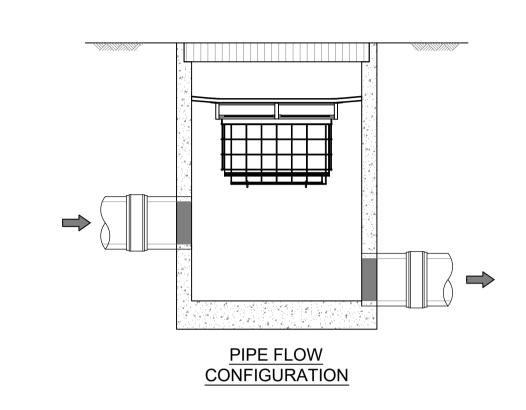

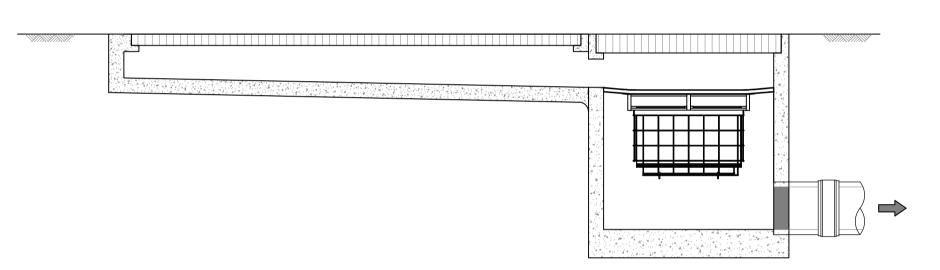



)	۱			)
Э				
		P3	DRAFT DA SUBMISSION - FOR APPROVAL	25.10.19
		P2	DRAFT DA SUBMISSION	17.10.19
		P1	DRAFT DA SUBMISSION	01.10.19
J		ISSUE	AMENDMENT	DATE

WARAKIRRI COLLEGE






S NEW LEARNING CENTRE
6A WATSFORD ROAD, CAMPBELLTOWN

HYDRAULIC SERVICES
DETAIL SHEET

DATE	DRAWN	CHECKED	No IN SET	SCALE
SEP. 2019	KJ/KP	DP	4 OF 5	NTS @ A
PROJECT No.			REVISIO	
6444			P3	

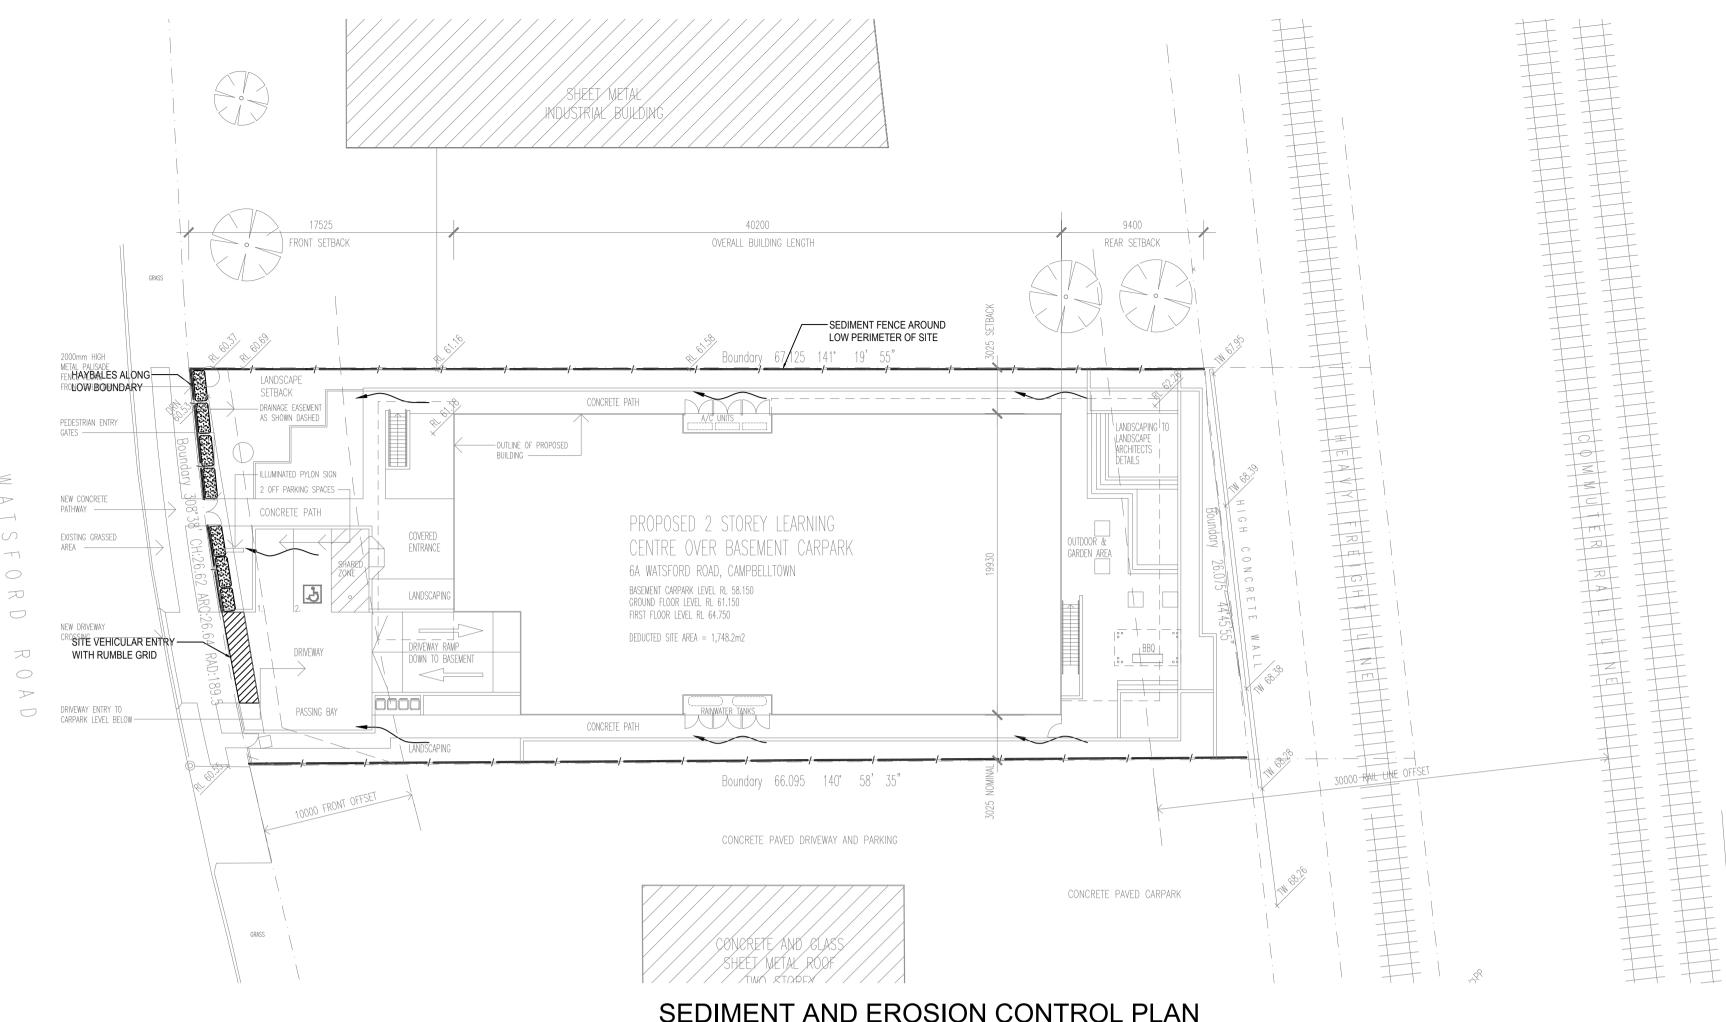

### SEDIMENT & EROSION CONTROL NOTES

FILTERED THROUGH AN APPROVED STRUCTURE.

PROTECTING ARE REHABILITATED.

3) REMEDIAL WORKS

HARRIS PAGE & ASSOCIATES Pty Ltd. Figured

The contractor shall check all dimensions on

drawings and site before commencing work.

dimensions shall be taken in preference to scaling.

- 1. THIS PLAN SHALL BE READ IN CONJUNCTION WITH THE ARCHITECTURAL AND ENGINEERING PLANS AND ANY OTHER PLANS OR WRITTEN INSTRUCTIONS THAT MAY BE ISSUED.
- THE CONTRACTOR SHALL ENSURE THAT ALL SOIL AND WATER MANAGEMENT WORKS ARE LOCATED AS SHOWN ON
- 3 PROTECT ALL NEW PITS FROM SEDIMENT INFILTRATION PROGRESSIVELY, AS THEY ARE CONSTRUCTED.
- 4. ALL DOWNSTREAM STORMWATER PITS ARE TO BE PROTECTED FROM SEDIMENT INFILTRATION DURING
- ALL SUB-CONTRACTORS ON SITE SHALL BE MADE AWARE OF THEIR RESPONSIBILITIES IN MINIMISING THE POTENTIAL FOR SOIL EROSION AND POLLUTION TO WATER COURSES AND WHERE PRACTICAL, THE SOIL EROSION HAZARD ON THE SITE SHALL BE KEPT AS LOW AS POSSIBLE. TO ACHIEVE, WORKS SHOULD BE CARRIED OUT AS
- 1) INSTALL ANY NECESSARY SECURITY/BOUNDARY FENCES FOR THE SITE 2) CONSTRUCT "SILT" FENCING AS DETAILED ALONG BOTH DOWNSLOPE BOUNDARIES.
- DURING WINDY WEATHER, LARGE UNPROTECTED AREAS SHALL BE KEPT MOIST (NOT WET) BY SPRINKLING WITH WATER TO KEEP DUST UNDER CONTROL.
- 8. FINAL SITE LANDSCAPING SHALL BE UNDERTAKEN AS SOON AS POSSIBLE, AND WITHIN TWENTY WORKING DAYS FROM COMPLETION OF CONSTRUCTION ACTIVITIES.
- SAND USED IN THE CONCRETE CURING PROCESS SHALL BE REMOVED ASAP, AND WITHIN TEN WORKING DAYS FROM
- 10. WATER SHALL BE PREVENTED FROM ENTERING THE PERMANENT DRAINAGE SYSTEM, UNLESS IT IS RELATIVELY SEDIMENT-FREE:ie, THE CATCHMENT AREA HAS BEEN LANDSCAPED AND/ORANY LIKELY SEDIMENT HAS BEEN
- 11. TEMPORARY SOIL AND WATER MANAGEMENT STRUCTURES SHALL BE REMOVED ONLY AFTER THE LANDS THEY ARE
- 12. THE CONTRACTOR SHALL PROVIDE ACCEPTABLE RECEPTORS FOR CONCRETE & MORTAR SLURRIES, PAINTS, ACID WASHINGS, LIGHT-WEIGHT WASTE MATERIALS AND LITTER.
- 13. RECEPTORS FOR CONCRETE AND MORTAR SLURRIES, PAINTS, ACID WASHINGS, LIGHT-WEIGHT WASTE MATERIALS AND LITTER, ARE TO BE EMPTIED AS NECESSARY. DISPOSAL OF WASTE SHALL BE IN A MANNER APPROVED BY THE
- 14. EVERY WEEK, FOR THE DURATION OF WORKS THE CONTRACTOR SHALL INSPECT THE SITE FOR THE FOLLOWING ITEMS: -ENSURE DRAINS OPERATE EFFECTIVELY, AND INITIATE REPAIR OR MAINTENANCE AS REQUIRED -REMOVE SPILLED SAND (OR OTHER MATERIALS) FROM HAZARD AREAS, INCLUDING LANDS CLOSER THAN 2 METRES FROM AREAS OF CONCENTRATED OR HIGH-VELOCITY FLOWS SUCH AS WATERCOURSES, OVERLAND FLOW PATHS, GUTTERS, PAVED AREAS, DRIVEWAYS AND ROADS.
- 15. CONSTRUCT ADDITIONAL EROSION AND/OR SEDIMENT WORKS IS NECESSARY TO ENSURE THE DESIRED PROTECTION IS GIVEN TO DOWNSLOPE LANDS AND WATERWAYS, ie. MAKE ONGOING CHANGES TO THE PLAN.
- 16. MAINTAIN EROSION AND SEDIMENT CONTROL MEASURES IN A FUNCTIONING CONDITION UNTIL ALL EARTHWORK ACTIVITIES ARE COMPLETED AND THE SITE REHABILITATED
- 17. REMOVE TEMPORARY SOIL CONSERVATION STRUCTURES ASA LAST ACTIVITY IN THE REHABILITATION PROGRAMME
- THE CONTRACTOR SHALL KEEP A LOG BOOK, MAKING ENTRIES ATLEAST WEEKLY, AND AFTER RAINFALL AND/OR 18. SITE CLOSURE. RECORD: 1) THE VOLUME OF ANY RAINFALL EVENTS (CHECK WEATHER BUREAU)
  2) THE CONDITION OF ANY SOIL AND WATER MANAGEMENT WORKS

COPYRIGHT OF HARRIS PAGE & ASSOCIATES Pty Ltd. All rights reserved. This drawing may not be re-produced or transmitted in any form, or by any means in part or in whole without permission from

ISSUE

DRAFT DA SUBMISSION

AMENDMENT

WARAKIRRI COLLEGE DRAFT DA SUBMISSION - FOR APPROVAL 25.10.19 DRAFT DA SUBMISSION 17.10.19

01.10.19

DATE

STORMWATER PIT

DETAIL 'D'-

STRAW BALES STAKED WITH

TWO STAKES

STRAW BALES—

RUN OFF WATER-

COMPACTED SOIL
TO PREVENT
EROSION UNDER
STRAW BALES

WITH SEDIMENT

800x400x300 DEEP

PLAN VIEW

ED SOIL STEEL

WATER-

**SECTION A-A** 

STORMWATER PIT WITH STRAW

BALE SEDIMENT BARRIER

N.T.S.

PER BALE—

AND GRATE AS PER



E: architects@koturicandco.com T: (02) 9743 6100

-OVERLAP STRAW **BALES AT CORNERS** 

—CONCRETE PIT WALL



TYPICAL HAY

**BALE SECTION** 

N.T.S.

— STAKED AND ENTRENCHED

STRAW BALE - 2 STAKES PER BALE

UNDISTURBED AREA

**BUFFER ZONE** 

(GRASSED AREA)

**FILTERED** 

NEW LEARNING CENTRE 6A WATSFORD ROAD, CAMPBELLTOWN

DRAWING TITLE **HYDRAUL** SEDIMENT & E CONTROL PLA

REFERENCE DRAWINGS STRUCT ELEC RCP ARCH DATE DISCIPLINE DRAWING NUMBER

**LEGEND** 

**HAY BALES** 

**FLOW ARROW** 

SEDIMENT FENCE


SEDIMENT AND EROSION CONTROL PLAN SCALE: 1:250

DISTURBED AREA

DIRECTION

SOIL COMPACTED TO-

PREVENT PIPING

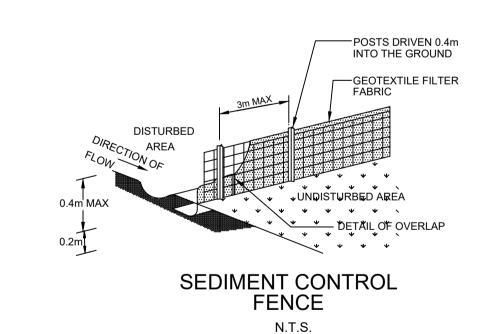

-4mx2.15m SECTIONS -ENGINEER DESIGNED TO OPEN THE TREADS ON TRUCK TYRES, ALLOWING FOR REMOVAL MUD/ROAD BASE ETC.

> RUMBLE GRIDS TEMPORARY CONSTRUCTION VEHICLE EXIT N.T.S.

)				
AN	6444	SW-04		4
EROSION	PROJECT No.	DRAWING No.		
LIC SERVICES	SEP. 2019	KJ/KP	DP	5 C
)	DATE	DRAWN	CHECKED	No IN

	6444	SW-04			Р	3
	PROJECT No.	DRAWING N			REVISIO	
	SEP. 2019	KJ/KP	DP	5 OF 5	NTS @ A	7
Ì	DATE	DRAWN	CHECKED	No IN SET	SCALE	