
Demolish portion of existing heritage wall Image: Image	

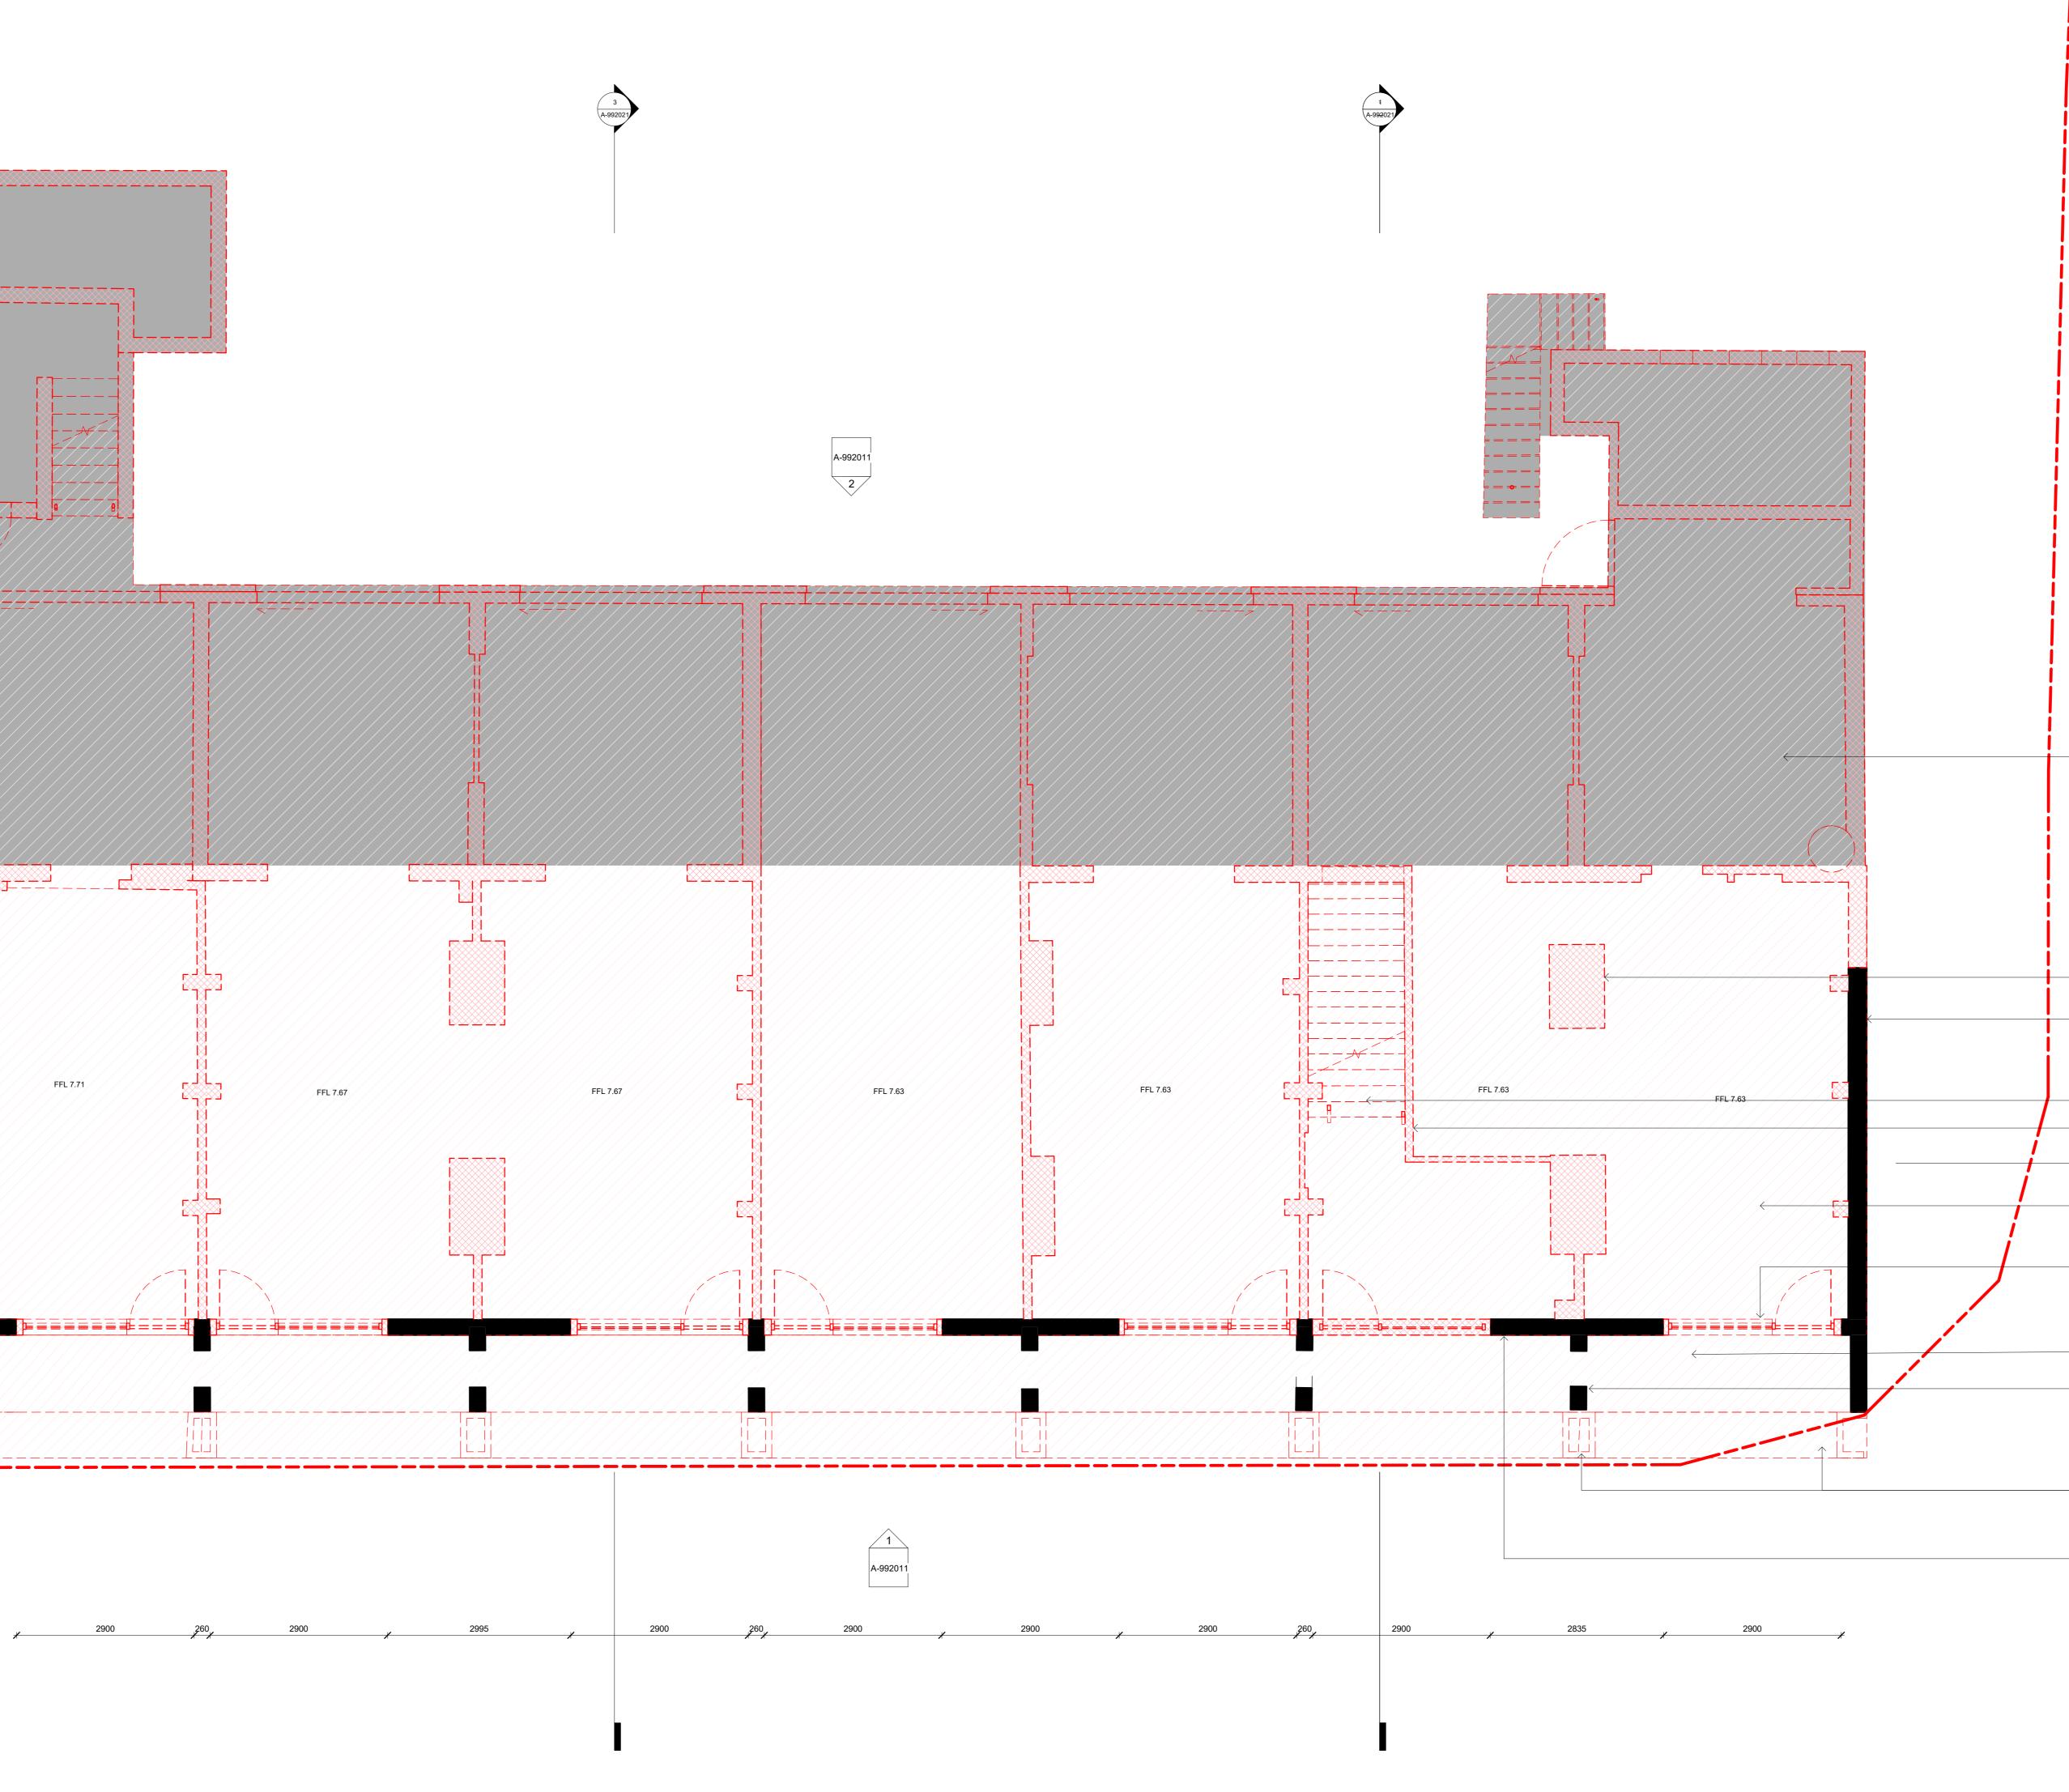

PHILLIP STREET

The extent of demolition shown grey forms part of the early works contract and will be done prior to the main works.

		WILDE AVENUE
_	Demolish existing fireplaces	
_	Retain existing wall. Support existing heritage wall during demolition and construction as per 2 A-992012 structural engineer's advice	
_	Remove existing stair	
	Remove all existing internal walls including foundations	0009
_	Remove existing Ground Level slab	
_	Remove existing storefronts including new brick infill and make good	
	Remove brick paving in the verandahs	
_	Retain existing walls	

Remove brick planter boxes and brick paving

Retain existing wall. Support existing heritage wall during demolition and construction as per structural engineer's advice

POWERHOUSE PARRAMATTA



END USER:

POWERHOUSE PARRAMAT

CONTRACTOR: твс

_____ DESIGN TEAM: LEAD DESIGNER: MOREAU KUSUNOKI 5 rue de Nemours, 75011 Paris, France T +33 1 84 16 48 10

LOCAL ARCHITECT: GENTON

Ground Floor, 71 York Street Sydney NSW 2000 T+ 612.9696.5002

MULTIDISCIPLINARY ENGINEERING (SCMEP and SPECIALISTS): ARUP Level 5 , Barrack Place, 151 Clarence St, Sydney NSW 2000

T: +61 2 9320 9320 DESIGN SUBCONSULTANTS:

LANDSCAPE ARCHITECTS: ARCH. LIGHTING: McGREGOR COXALL L'OBSERVATOIRE INT.

T: +612 9188 7500

DEP

DISCLAIMER

KINETIC STRUCTURE:


– 7 – 1 38400 Saint-Martin-d'Hères, France T: +33 4 76 62 84 54

Suite 101, Level 1, 39 East Esplanade, Manly, NSW, Australia 120 Walker Street 7th Floor East New York, New York 10013, USA T: +1 212 255 4463 EXOSKELETON: JUN SATO

2F, Kobayashi building 2-26-3, Higashiazabu, Minato-ku, Tokyo, 106-0044, Japan T: +81 3 6441 0914

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Existing fabric to be retained

Existing fabric to be demolished

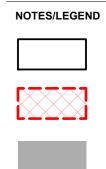Existing fabric to be demolished as part of the early works contract prior to the main works

-----REVISION _____ _____ _____ _____ 1 9/2/2021 Tender Addenda No. Date Description


-----LOCATION

POWERHOUSE PARRAMATTA 34-54 Phillip Street Parramatta, NSW 2150

_____ ARCHITECTS

LEAD DESIGNER: MOREAU KUSUNOKI


LOCAL ARCHITECT: GENTON

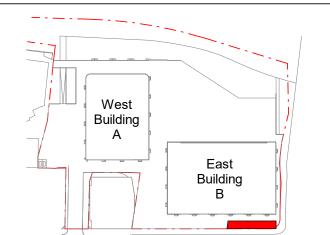


TITLE ST GEORGES TERRACE -DEMOLITION - GROUND LEVEL PLAN

SCALE: As indicated @ A0

	NOT FOR	CONSTR	RUCTION	
JOB NO.	0	DWN	СНКД	APPD
DATE	9/2/2021	Author	Checker	Approver
DRAWING	number A-99200	1	REV	ision. 1
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The extent of demolition shown grey forms part of the early works contract and will be done prior to the main works.

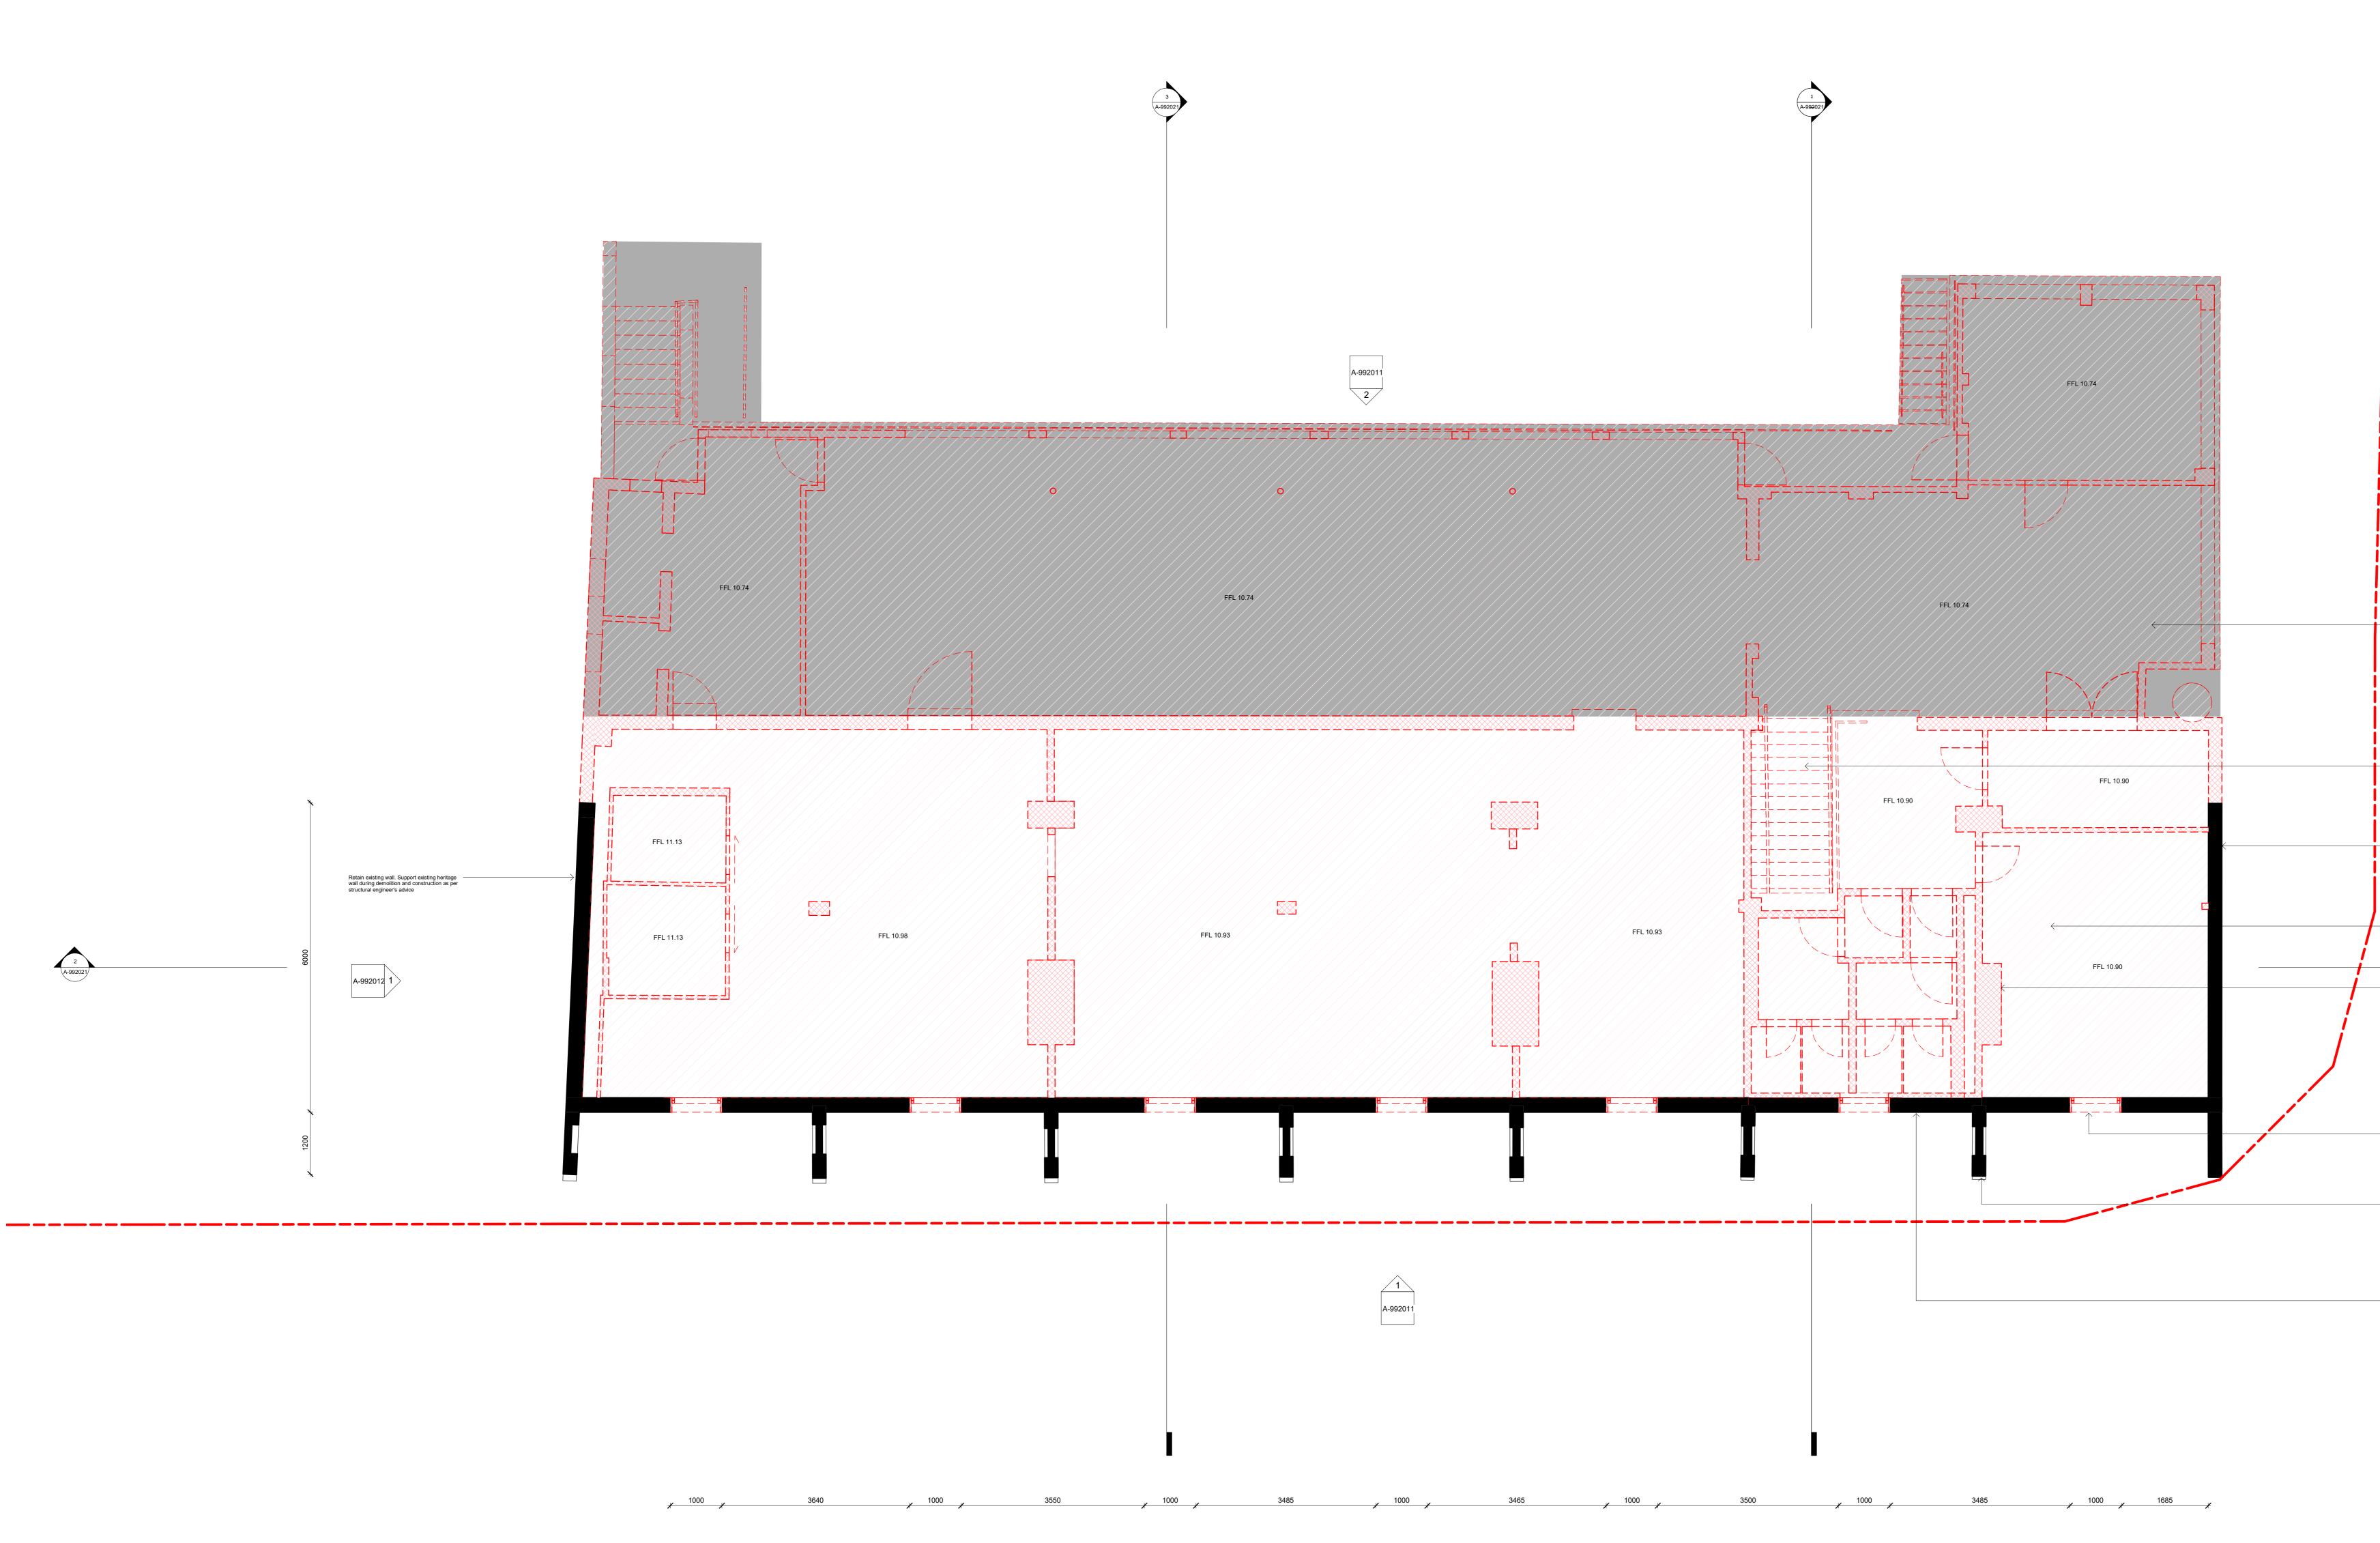Demolish existing stair

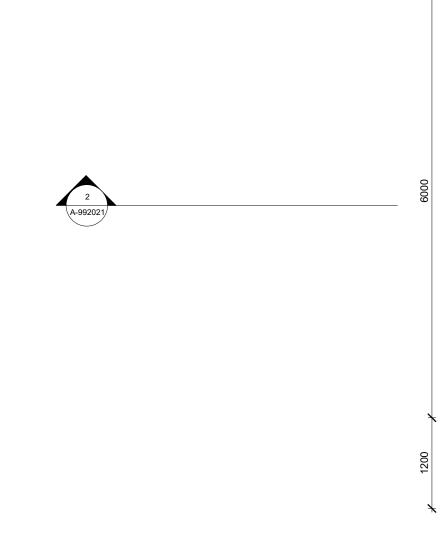Retain existing wall. Support existing heritage wall during demolition and construction as per 2 A-992012 structural engineer's advice
Demolish existing first level slab including any existing beams
Demolish all existing internal walls and fireplaces
Remove all existing windows including infills below the window openings and make good

Retain existing wall. Support existing heritage wall during demolition and construction as per structural engineer's advice

Retain existing walls

POWERHOUSE PARRAMATTA



END USER:

PARRAMA.

_____ CONTRACTOR: твс

_____ DESIGN TEAM: LEAD DESIGNER: MOREAU KUSUNOKI 5 rue de Nemours, 75011 Paris, France T +33 1 84 16 48 10

LOCAL ARCHITECT: GENTON

Ground Floor, 71 York Street Sydney NSW 2000 T+ 612.9696.5002

MULTIDISCIPLINARY ENGINEERING (SCMEP and SPECIALISTS): ARUP Level 5 , Barrack Place, 151 Clarence St, Sydney NSW 2000 T: +61 2 9320 9320

DESIGN SUBCONSULTANTS:

LANDSCAPE ARCHITECTS: ARCH. LIGHTING: McGREGOR COXALL L'OBSERVATOIRE INT.

T: +612 9188 7500

DISCLAIMER

DEP

KINETIC STRUCTURE:


– 7 – 1 38400 Saint-Martin-d'Hères, France T: +33 4 76 62 84 54

Suite 101, Level 1, 39 East Esplanade, Manly, NSW, Australia 120 Walker Street 7th Floor East New York, New York 10013, USA T: +1 212 255 4463 EXOSKELETON: JUN SATO

2F, Kobayashi building 2-26-3, Higashiazabu, Minato-ku, Tokyo, 106-0044, Japan T: +81 3 6441 0914

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Existing fabric to be retained

Existing fabric to be demolished

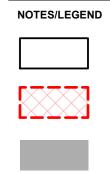Existing fabric to be demolished as part of the early works contract prior to the main works

_____ REVISION _____ ____ _____ ____ _____ _____ _____ 1 9/2/2021 Tender Addenda No. Date Description


-----LOCATION

POWERHOUSE PARRAMATTA 34-54 Phillip Street Parramatta, NSW 2150

_____ ARCHITECTS

LEAD DESIGNER: MOREAU KUSUNOKI


LOCAL ARCHITECT: GENTON

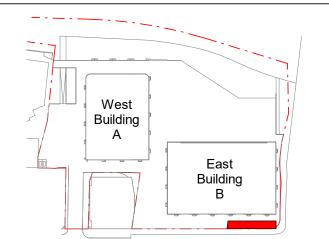

TITLE ST GEORGES TERRACE -DEMOLITION - LEVEL 1 PLAN

SCALE: As indicated @ A0 STATUS TENDER DOCUMENTATION

	NOT FOR	CONSTR	RUCTION	
OB NO.	0	DWN	СНКД	APPD
ATE	9/2/2021	Author	Checker	Approve
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The extent of demolition shown grey forms part of the early works contract and will be done prior to the main works.

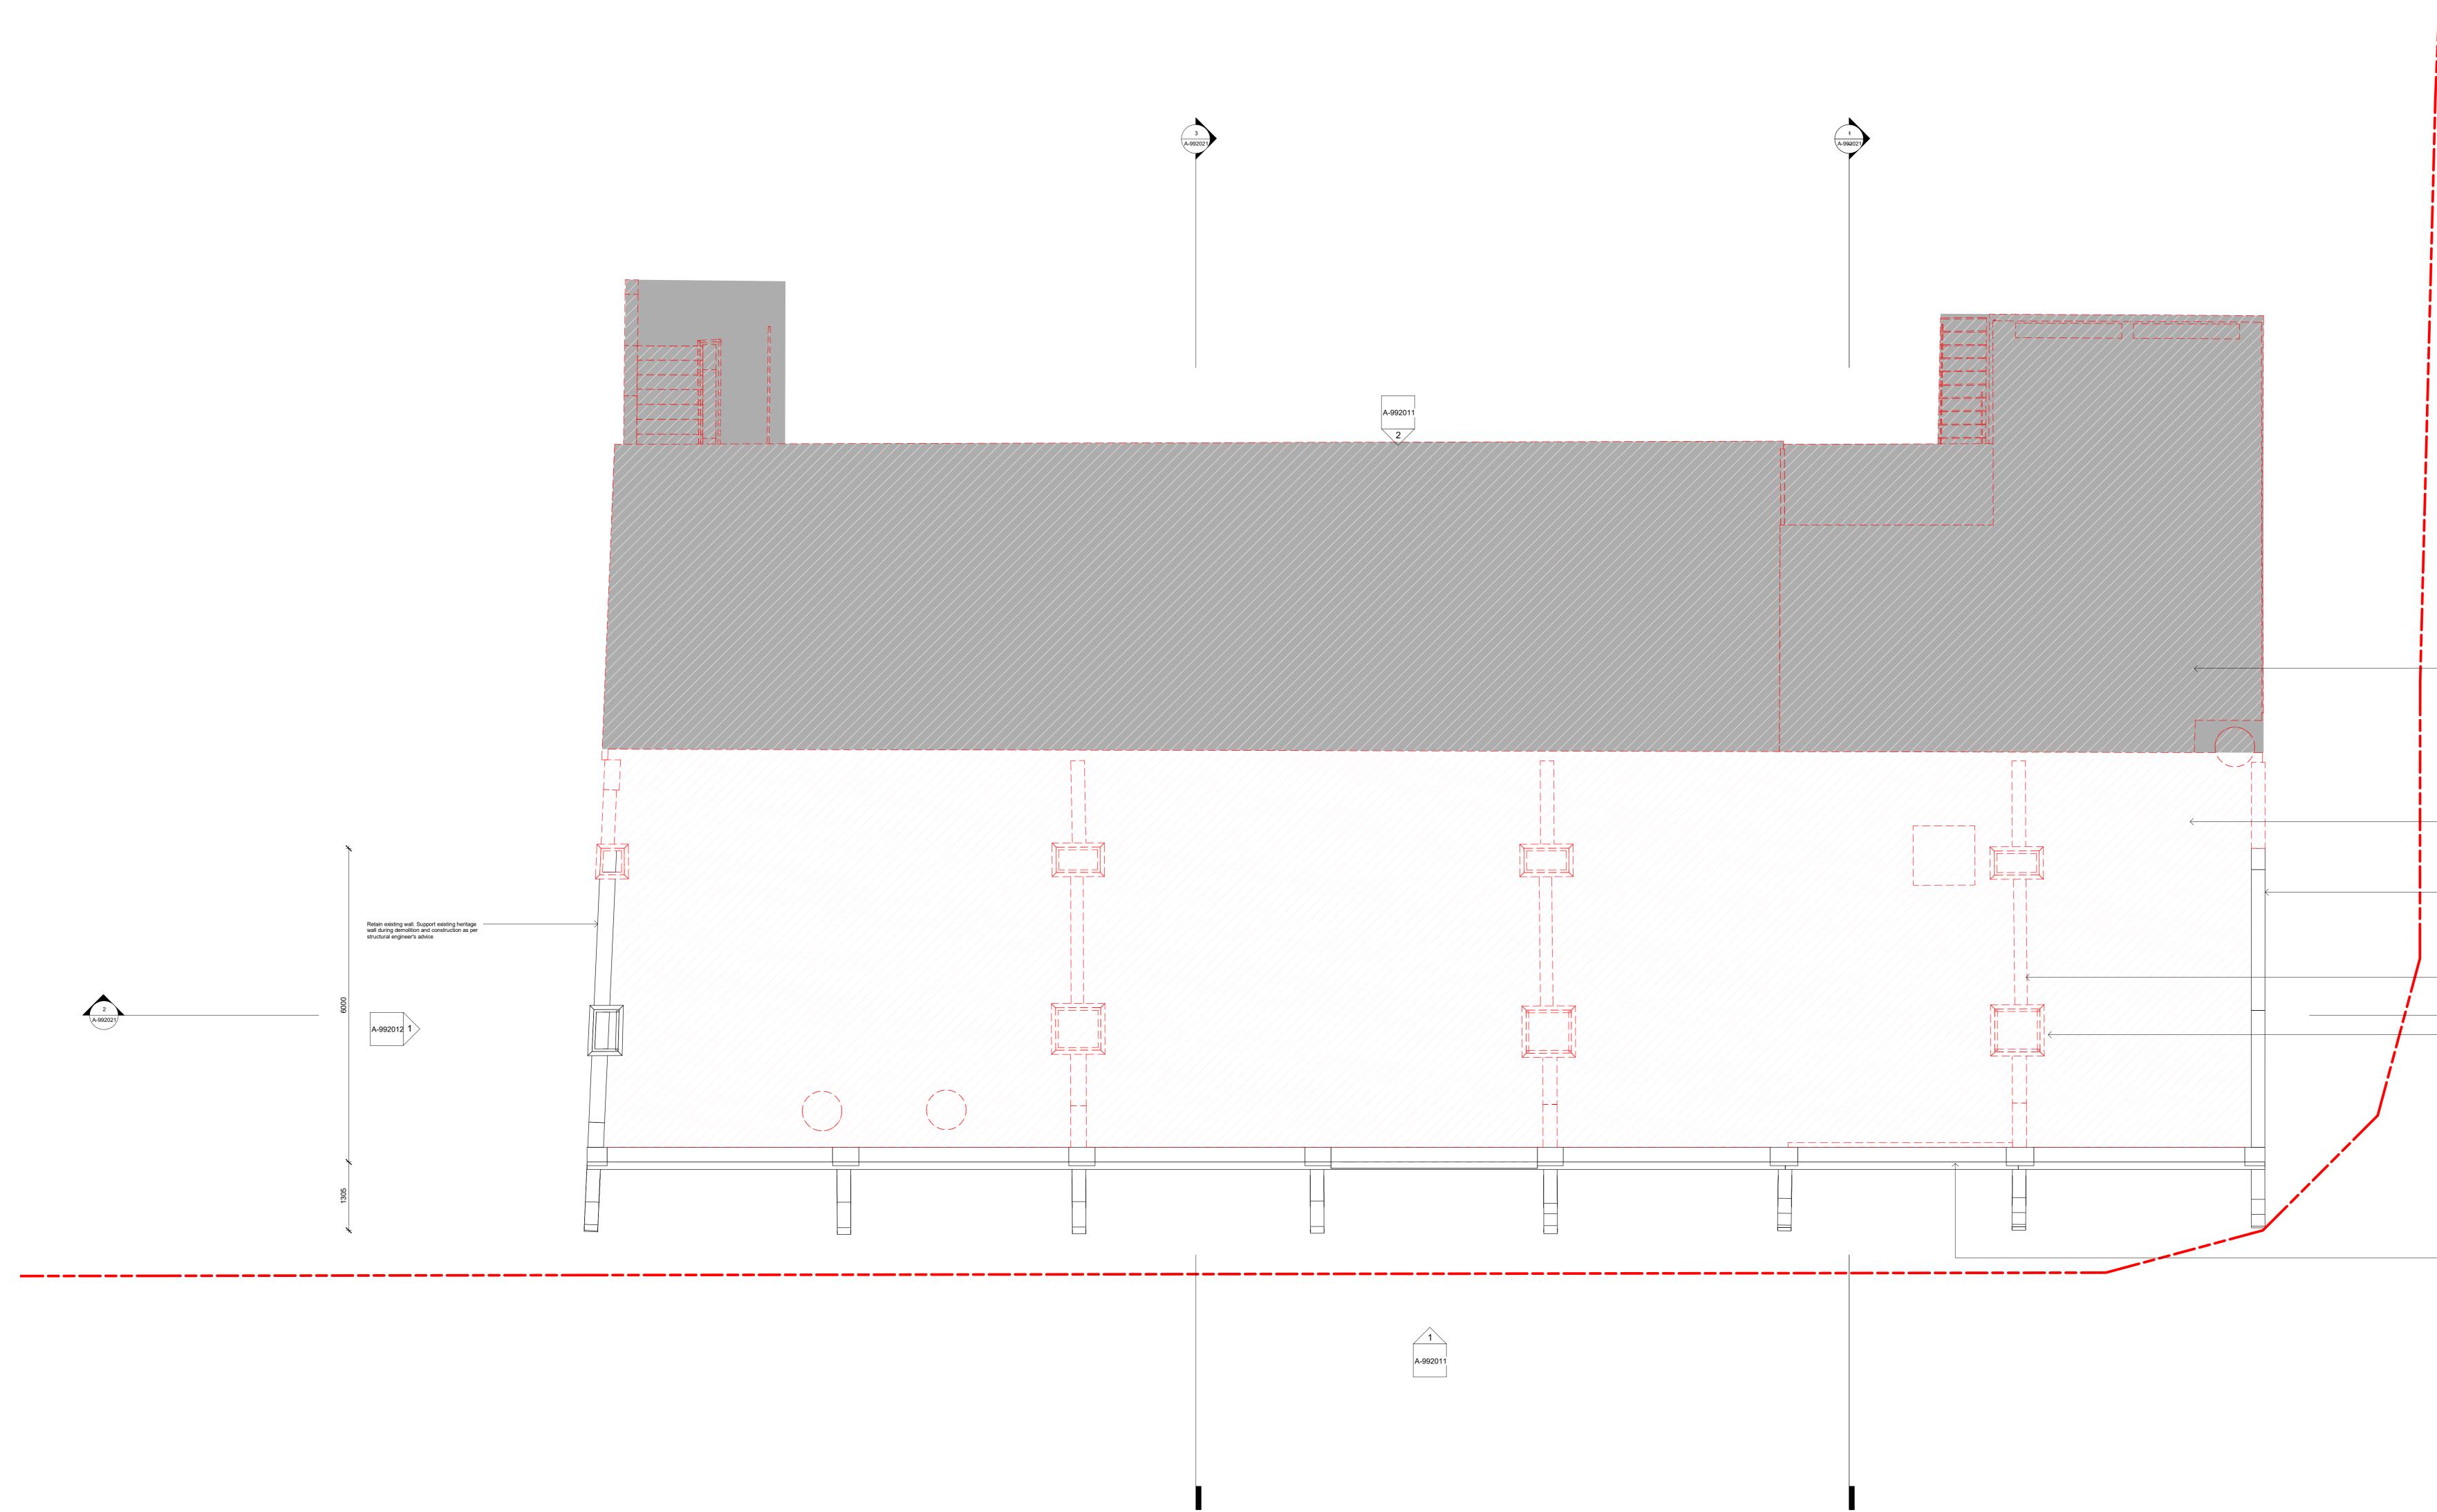Remove all existing roofs including roof structure Retain existing wall. Support existing heritage wall during demolition and construction as per 2 A-992012 structural engineer's advice Demolish existing walls Demolish existing chimneys

Retain existing wall. Support existing heritage wall during demolition and construction as per structural engineer's advice

POWERHOUSE PARRAMATTA



END USER:

POWERHOUSE PARRAMAT

_____ CONTRACTOR: твс

-----DESIGN TEAM: LEAD DESIGNER: MOREAU KUSUNOKI 5 rue de Nemours, 75011 Paris, France T +33 1 84 16 48 10

LOCAL ARCHITECT: GENTON

Ground Floor, 71 York Street Sydney NSW 2000 T+ 612.9696.5002

MULTIDISCIPLINARY ENGINEERING (SCMEP and SPECIALISTS): ARUP Level 5 , Barrack Place, 151 Clarence St, Sydney NSW 2000 T: +61 2 9320 9320

DESIGN SUBCONSULTANTS: LANDSCAPE ARCHITECTS: ARCH. LIGHTING:

McGREGOR COXALL L'OBSERVATOIRE INT.

KINETIC STRUCTURE:

– 7 – 1 38400 Saint-Martin-d'Hères, France T: +33 4 76 62 84 54

DEP

DISCLAIMER


Suite 101, Level 1, 39 East Esplanade, Manly, 120 Walker Street 7th Floor East NSW, Australia New York, New York 10013, USA T: +612 9188 7500 T: +1 212 255 4463 EXOSKELETON:

JUN SATO 2F, Kobayashi building 2-26-3, Higashiazabu, Minato-ku, Tokyo, 106-0044, Japan T: +81 3 6441 0914

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Existing fabric to be retained

Existing fabric to be demolished

Existing fabric to be demolished as part of the early works contract prior to the main works

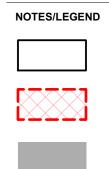RE)	REVISION			
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1	9/2/2021	Tender Addenda		
No.				
140.	Date	Description		

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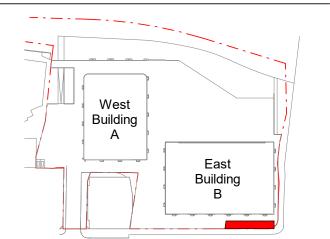
POWERHOUSE PARRAMATTA 34-54 Phillip Street Parramatta, NSW 2150

_____ ARCHITECTS LEAD DESIGNER:

MOREAU KUSUNOKI

LOCAL ARCHITECT: GENTON

RL




TITLE ST GEORGES TERRACE -DEMOLITION - ROOF PLAN

 \square SCALE: As indicated @ A0


JOB NO.	0	DWN	СНКД	APPD
DATE	9/2/2021	Author	Checker	Approver
DRAWING NUMBER REVISION				ISION.
	A-99200	3		1





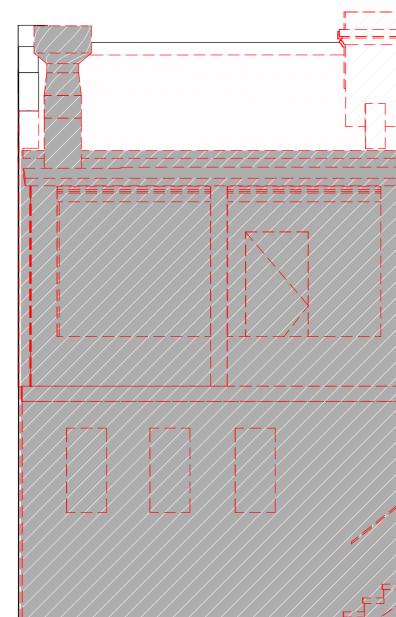



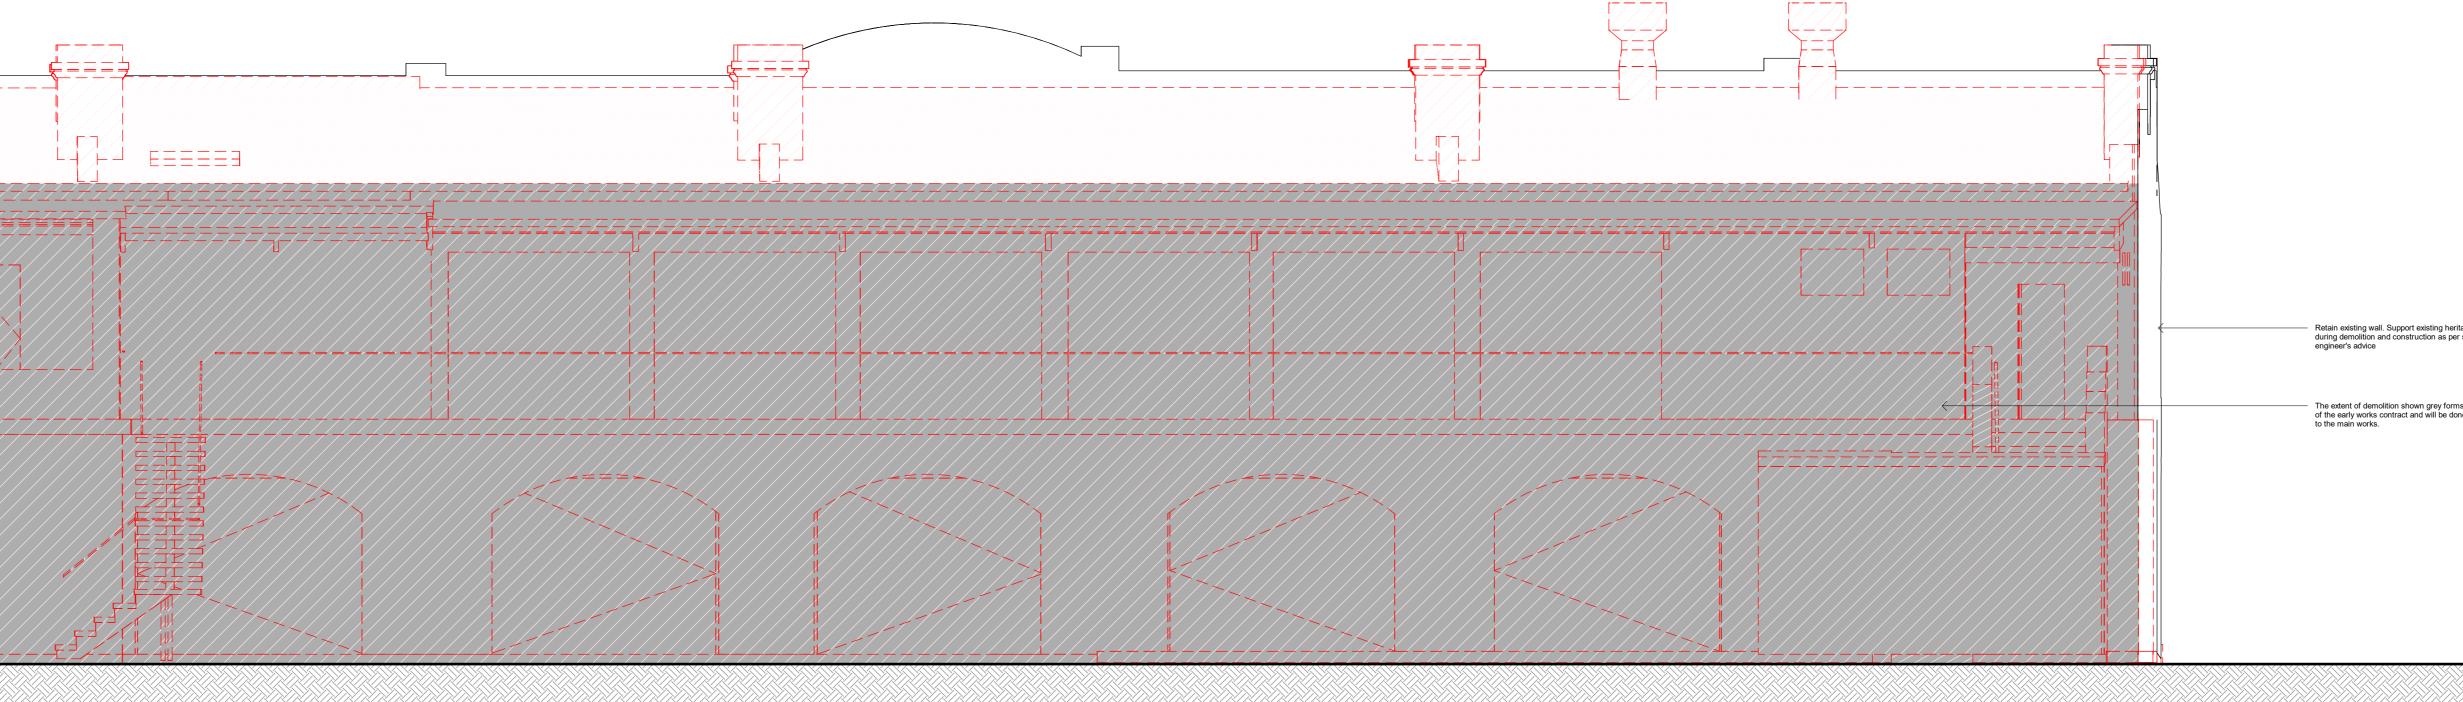

		POWERHOUSE PARRAMATTA
		CLIENT: INFRASTRUCTURE New South Wales END USER:
_	ROOF 15130.00	POWERHOUSE PARRAMATTA CONTRACTOR:
low and make good		TBC DESIGN TEAM: LEAD DESIGNER: MOREAU KUSUNOKI 5 rue de Nemours, 75011 Paris, France T +33 1 84 16 48 10 LOCAL ARCHITECT:
heritage wall lictural engineer's		GENTON Ground Floor, 71 York Street Sydney NSW 2000 T+ 612.9696.5002
		MULTIDISCIPLINARY ENGINEERING (SCMEP and SPECIALISTS ARUP Level 5 , Barrack Place, 151 Clarence St, Sydney NSW 2000 T: +61 2 9320 9320
l below and make good		DESIGN SUBCONSULTANTS: LANDSCAPE ARCHITECTS: MCGREGOR COXALL Suite 101, Level 1, 39 East Esplanade, Manly, NSW, Australia T: +612 9188 7500 KINETIC STRUCTURE: DEP 13 Rue du Béal, 38400 Saint-Martin-d'Hères, France T: +33 4 76 62 84 54 ARCH. LIGHTING: L'OBSERVATOIRE INT. 120 Walker Street 7th Floor East New York, New York 10013, USA T: +1 212 255 4463 EXOSKELETON: JUN SATO 2F, Kobayashi building 2-26-3, Higashiazabu, Minato-ku, Tokyo, 106-0044, Japan T: +81 3 6441 0914
	GROUND FLOOR 7500.00	DISCLAIMER Do not scale from this drawing. Use given dimensions only Check all dimensions on site before proceeding and prior to some necement of all shop drawings or fabrication and the Principal. Arbited Tergeneed. This work is copyright and cannot be reproduced or copied in any form or by any means graphic, electronic or mechanical, including photocopying unless prior witten approvale by any proces whatsoever is restricted to the terms of the PSC agreement of unricipal. Any licence, expressed or implied, to use this document for any purpose whatsoever is restricted to the terms of the PSC agreement or the rencipal. NoteSclEGEND Distribution and the Principal. Distribution and t
		REVISION
	<u>ROOF</u>	1 9/2/2021 No. Date Description
eritage wall		LOCATION POWERHOUSE PARRAMATTA 34-54 Phillip Street Parramatta, NSW 2150 ARCHITECTS LEAD DESIGNER: MOREAU KUSUNOKI
rms part done prior	FIRST FLOOR 10730.00	LOCAL ARCHITECT: GENTON
	GROUND FLOOR	TITLE ST GEORGES TERRACE -
		DEMOLITION - ELEVATION N, S
		SCALE: As indicated @ A0
		STATUS

STATUS TENDER DOCUMENTATION

 NOT FOR CONSTRUCTION


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 APPD

 DATE
 9/2/2021
 Author
 Checker
 Approve


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 REVISION.


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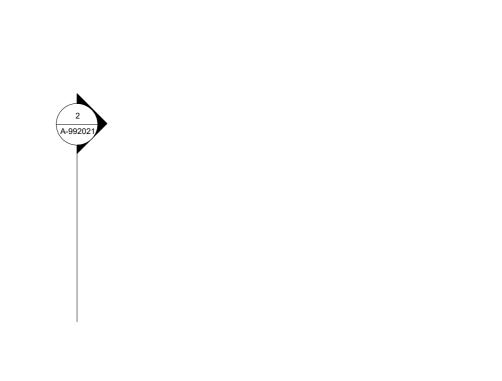





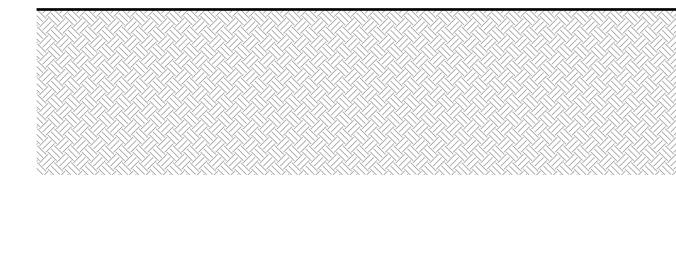

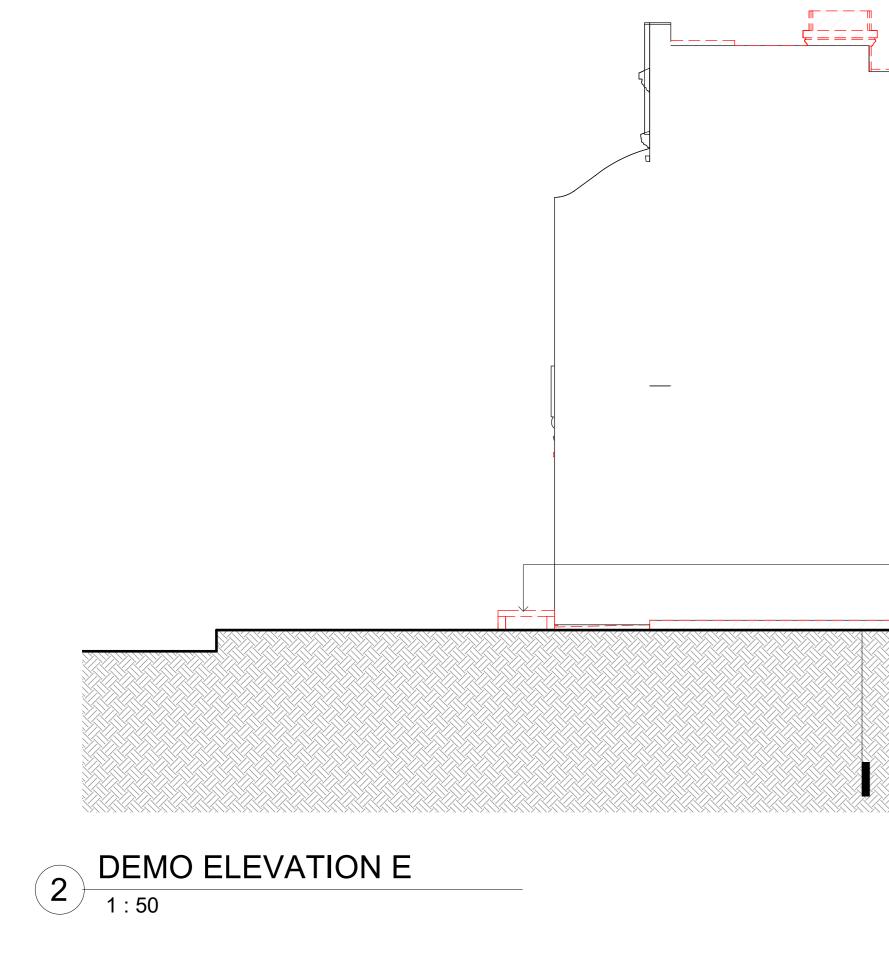

A-992021/

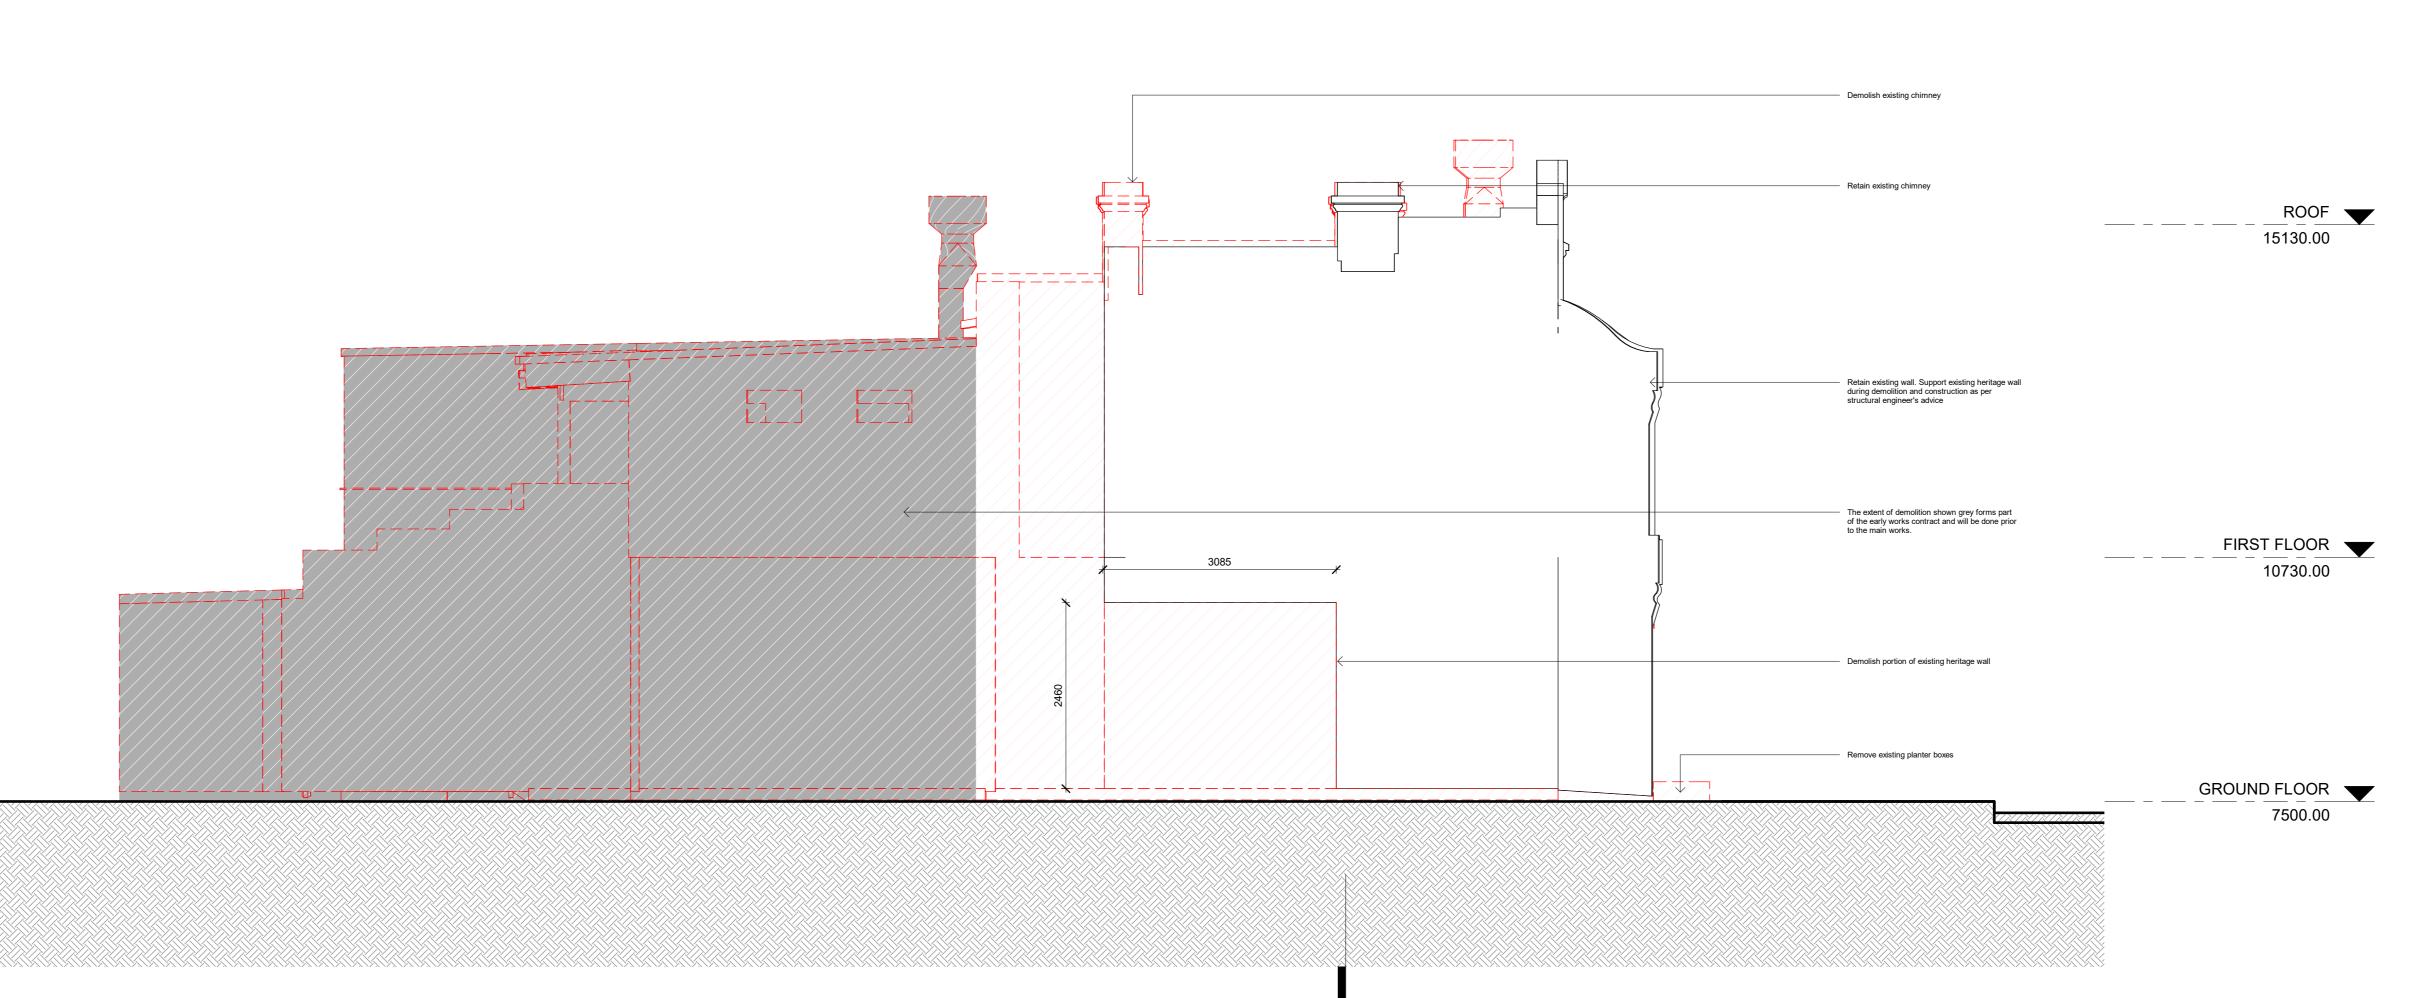

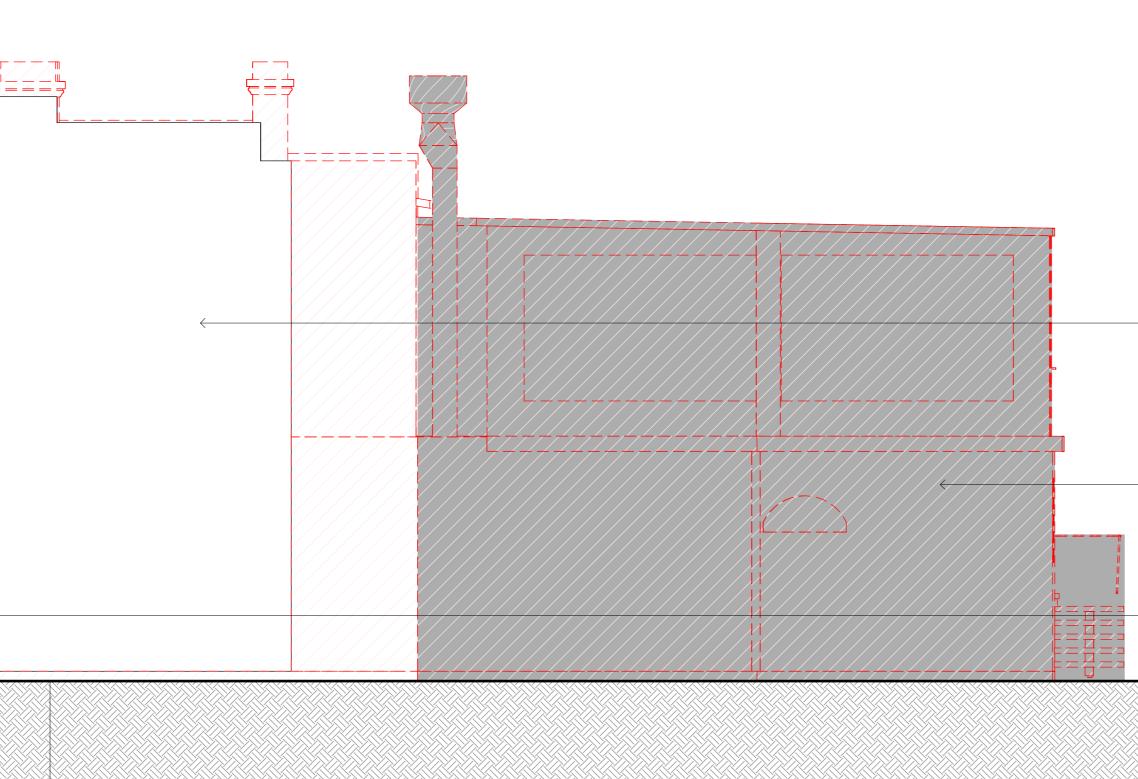

Retain existing wall. Support existing heritage wall during demolition and construction as per structural engineer's advice

 The extent of demolition shown grey forms part of the early works contract and will be done prior to the main works. Remove existing planter boxes

GROUND FLOOR **T**500.00

POWERHOUSE PARRAMATTA





CONTRACTOR: твс

_____ DESIGN TEAM: LEAD DESIGNER: MOREAU KUSUNOKI 5 rue de Nemours, 75011 Paris, France

T +33 1 84 16 48 10 LOCAL ARCHITECT:

GENTON Ground Floor, 71 York Street Sydney NSW 2000

T+ 612.9696.5002

MULTIDISCIPLINARY ENGINEERING (SCMEP and SPECIALISTS): ARUP Level 5 , Barrack Place, 151 Clarence St, Sydney NSW 2000 T: +61 2 9320 9320

DESIGN SUBCONSULTANTS: LANDSCAPE ARCHITECTS: ARCH. LIGHTING:

McGREGOR COXALL L'OBSERVATOIRE INT.

KINETIC STRUCTURE:

13 Rue du Béal, 38400 Saint-Martin-d'Hères, France T: +33 4 76 62 84 54

 Suite 101, Level 1, 39 East Esplanade, Manly,
 120 Walker Street 7th Floor East

 NSW, Australia
 New York, New York 10013, USA

 T: +612 9188 7500
 T: +1 212 255 4463
 EXOSKELETON:


JUN SATO 2F, Kobayashi building 2-26-3, Higashiazabu, Minato-ku, Tokyo, 106-0044, Japan T: +81 3 6441 0914

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Existing fabric to be retained

Existing fabric to be demolished

Existing fabric to be demolished as part of the early works contract prior to the main works

-----REVISION Description

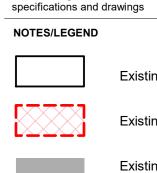_____ LOCATION


POWERHOUSE PARRAMATTA 34-54 Phillip Street Parramatta, NSW 2150

-----ARCHITECTS LEAD DESIGNER:

MOREAU KUSUNOKI


SCALE: As indicated @ A0

LOCAL ARCHITECT: GENTON

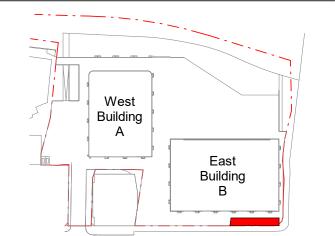


TITLE ST GEORGES TERRACE -DEMOLITION - ELEVATION E, W

NOT FOR CONSTRUCTION				
JOB NO.	0	DWN	СНКД	APPD
DATE	9/2/2021	Author	Checker	Approver
DRAWING NUMBER REVISION.				
A-992012				1
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1 DEMO SECTION 1 1 : 50

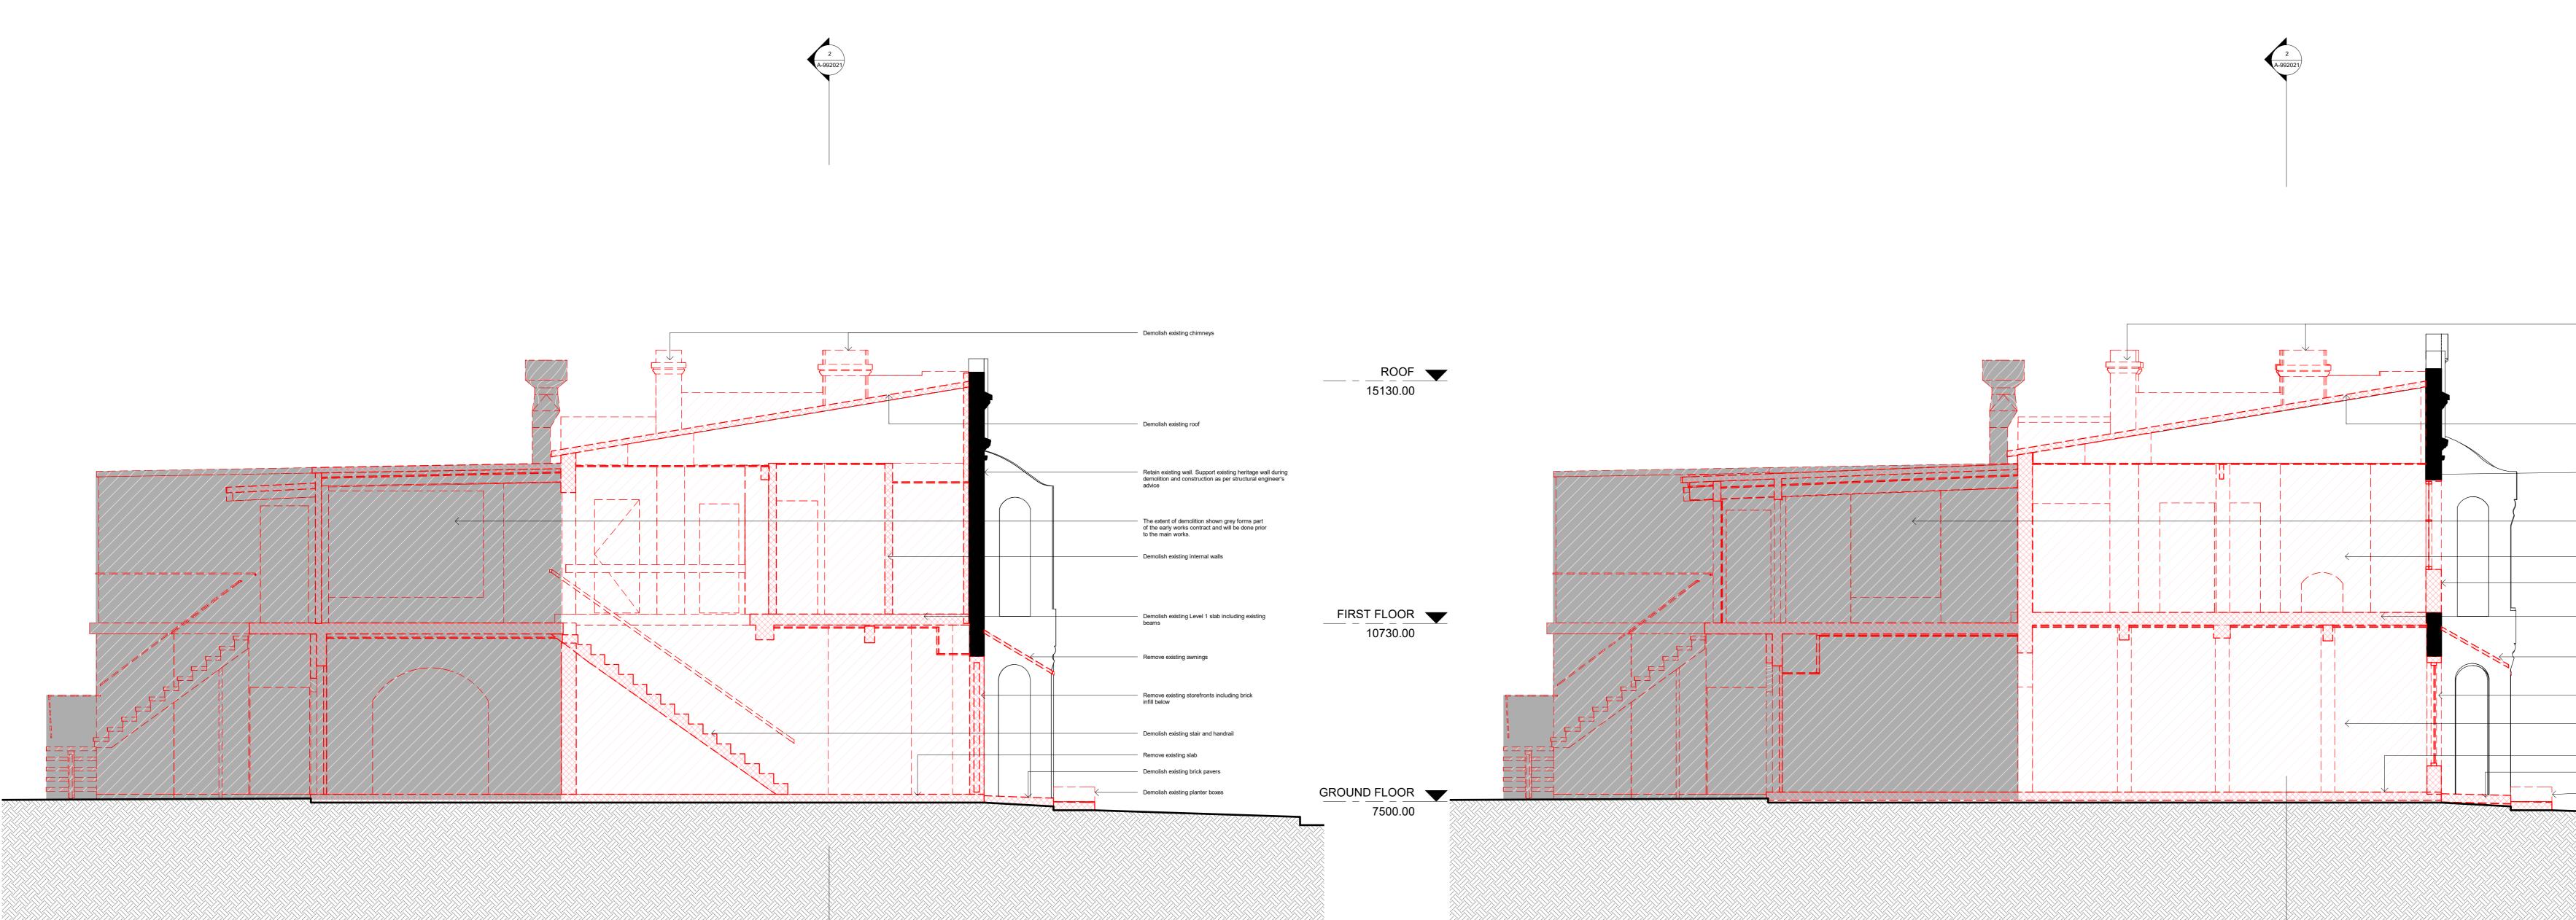



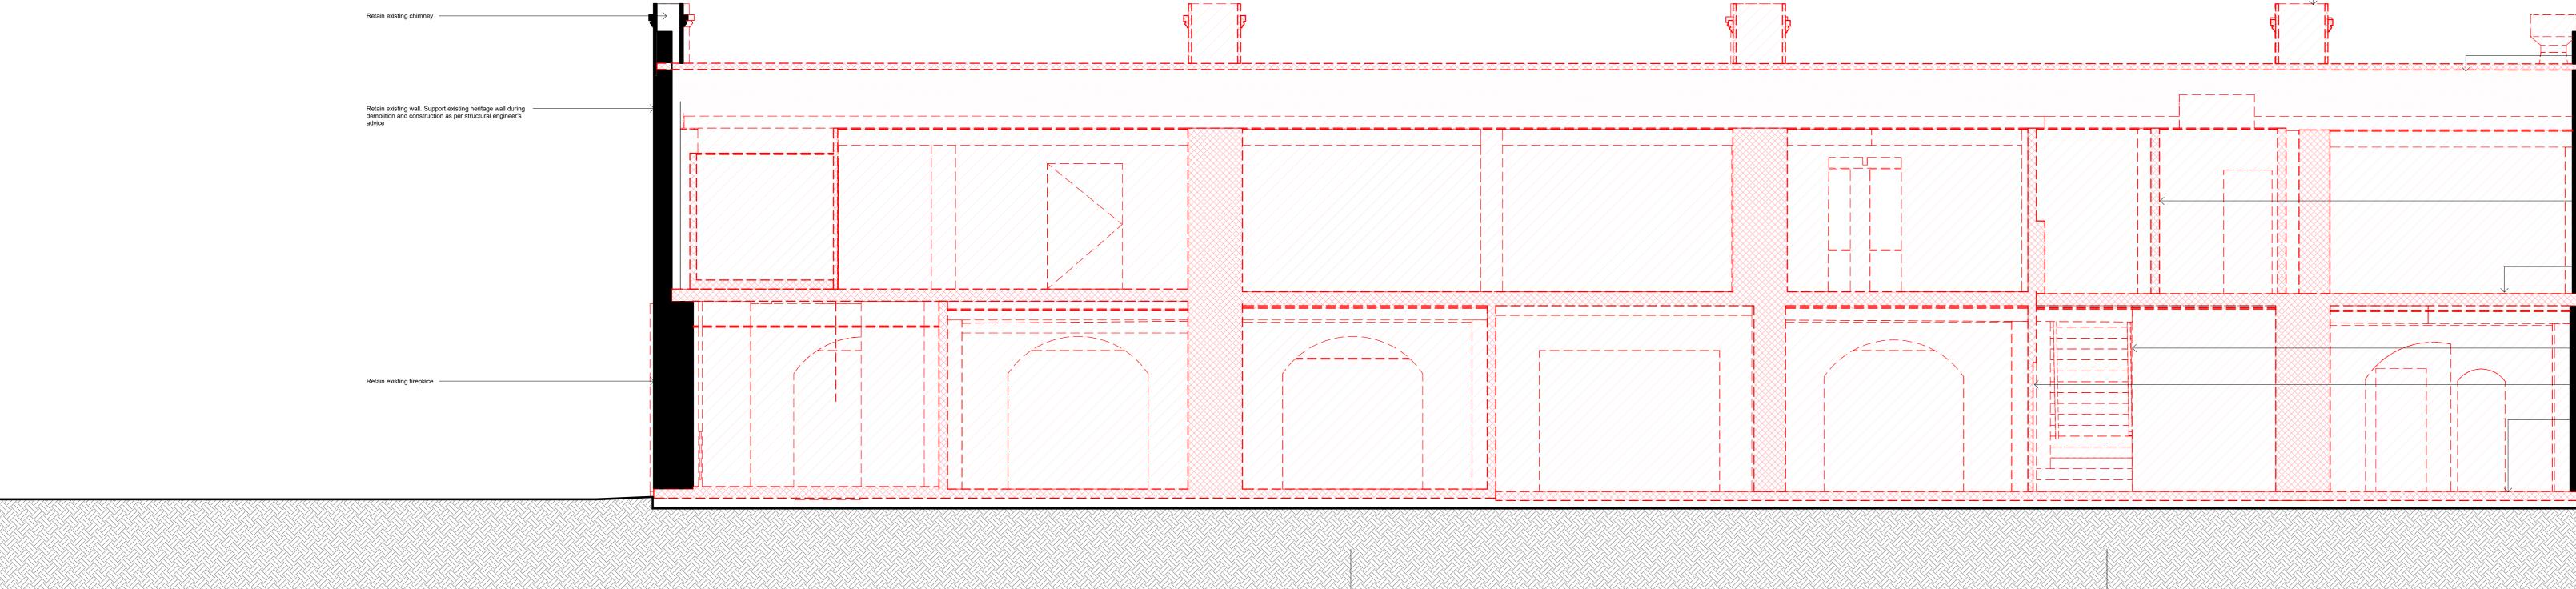



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Remove existing slab

 Demolish existing internal Demolish existing Level 1 beams Demolish existing stair Demolish existing internal v


Retain existing wall. Support demolition and construction advice


- Demolish existing roof

Demolish existing chimney


		PARRAMATTA
		CLIENT: Infrastructure New South Wales
Demolish existing chimneys	<u>ROOF</u> 15130.00	END USER: POWERHOUSE PARRAMATIA CONTRACTOR: TBC
 Retain existing wall. Support existing heritage wall during demolition and construction as per structural engineer's advice The extent of demolition shown grey forms part of the early works contract and will be done prior to the main works. 		DESIGN TEAM: LEAD DESIGNER: MOREAU KUSUNOKI 5 rue de Nemours, 75011 Paris, France T +33 1 84 16 48 10 LOCAL ARCHITECT: GENTON
Demolish existing internal walls Remove existing Level 1 windows including the infill below Demolish existing Level 1 slab including existing beams	FIRST FLOOR 10730.00	Ground Floor, 71 York Street Sydney NSW 2000 T+ 612.9696.5002 MULTIDISCIPLINARY ENGINEERING (SCMEP and SPECIALISTS): ARUP Level 5, Barrack Place, 151 Clarence St, Sydney NSW 2000 T: +61 2 9320 9320 DESIGN SUBCONSULTANTS:
Remove existing awnings Remove existing storefronts including brick infill below Demolish existing internal walls including foundations Remove existing slab		LANDSCAPE ARCHITECTS: MCGREGOR COXALL Suite 101, Level 1, 39 East Esplanade, Manly, NSW, Australia T: +612 9188 7500 KINETIC STRUCTURE: DEP 13 Rue du Béal, 38400 Saint-Martin-d'Hères, France T: +33 4 76 62 84 54 ARCH. LIGHTING: L'OBSERVATOIRE INT. 120 Walker Street 7th Floor East New York, New York 10013, USA T: +1 212 255 4463 EXOSKELETON: JUN SATO 2F, Kobayashi building 2-26-3, Higashiazabu, Minato-ku, Tokyo, 106-0044, Japan 2F, 481 3 641 0014
Demolish existing brick pavers Demolish existing planter boxes	GROUND FLOOR 7500.00	T: +81 3 6441 0914 DISCLAIMER Do not scale from this drawing. Use given dimensions only Check all dimensions on site before proceeding and prior to commencement of all shop drawings or fabrication Any discrepancies are to be referred to the Architect/Engineer/Designer prior to commencement of work All rights reserved. This work is copyright and cannot be reproduced or copied in any form or by any means graphic, electronic or mechanical, including photocopying unless prior written approval by Moreau Kusunoki and Genton and the Principal. Any licence, expressed or implied, to use this document for any purpose whatsoever is restricted to the terms of the PSC agreement or implied agreement between Moreau Kusunoki and Genton, and the Principal. This drawing must be read in conjunction with all relevant contracts, specifications and drawings NOTES/LEGEND
		Existing fabric to be retained Existing fabric to be demolished Existing fabric to be demolished as part of the early works contract prior to the main works
		REVISION
nneys		
f	ROOF 15130.00	1 9/2/2021 Tender Addenda No. Date Description
support existing heritage wall during uction as per structural engineer's mal walls		LOCATION POWERHOUSE PARRAMATTA 34-54 Phillip Street Parramatta, NSW 2150 ARCHITECTS LEAD DESIGNER: MOREAU KUSUNOKI LOCAL ARCHITECT: GENTON
r ral walls including foundations	FIRST FLOOR 10730.00	West Building A East Building B
	GROUND FLOOR 7500.00	TITLE ST GEORGES TERRACE - DEMOLITION - SECTIONS
		SCALE: As indicated @ A0 STATUS TENDER DOCUMENTATION
		NOT FOR CONSTRUCTIONJOB NO.0DWNCHKDAPPDDATE9/2/2021AuthorCheckerApproverDRAWING NUMBERREVISION.A-9920211100.511.522.5


POWERHOUSE

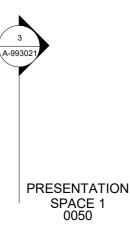

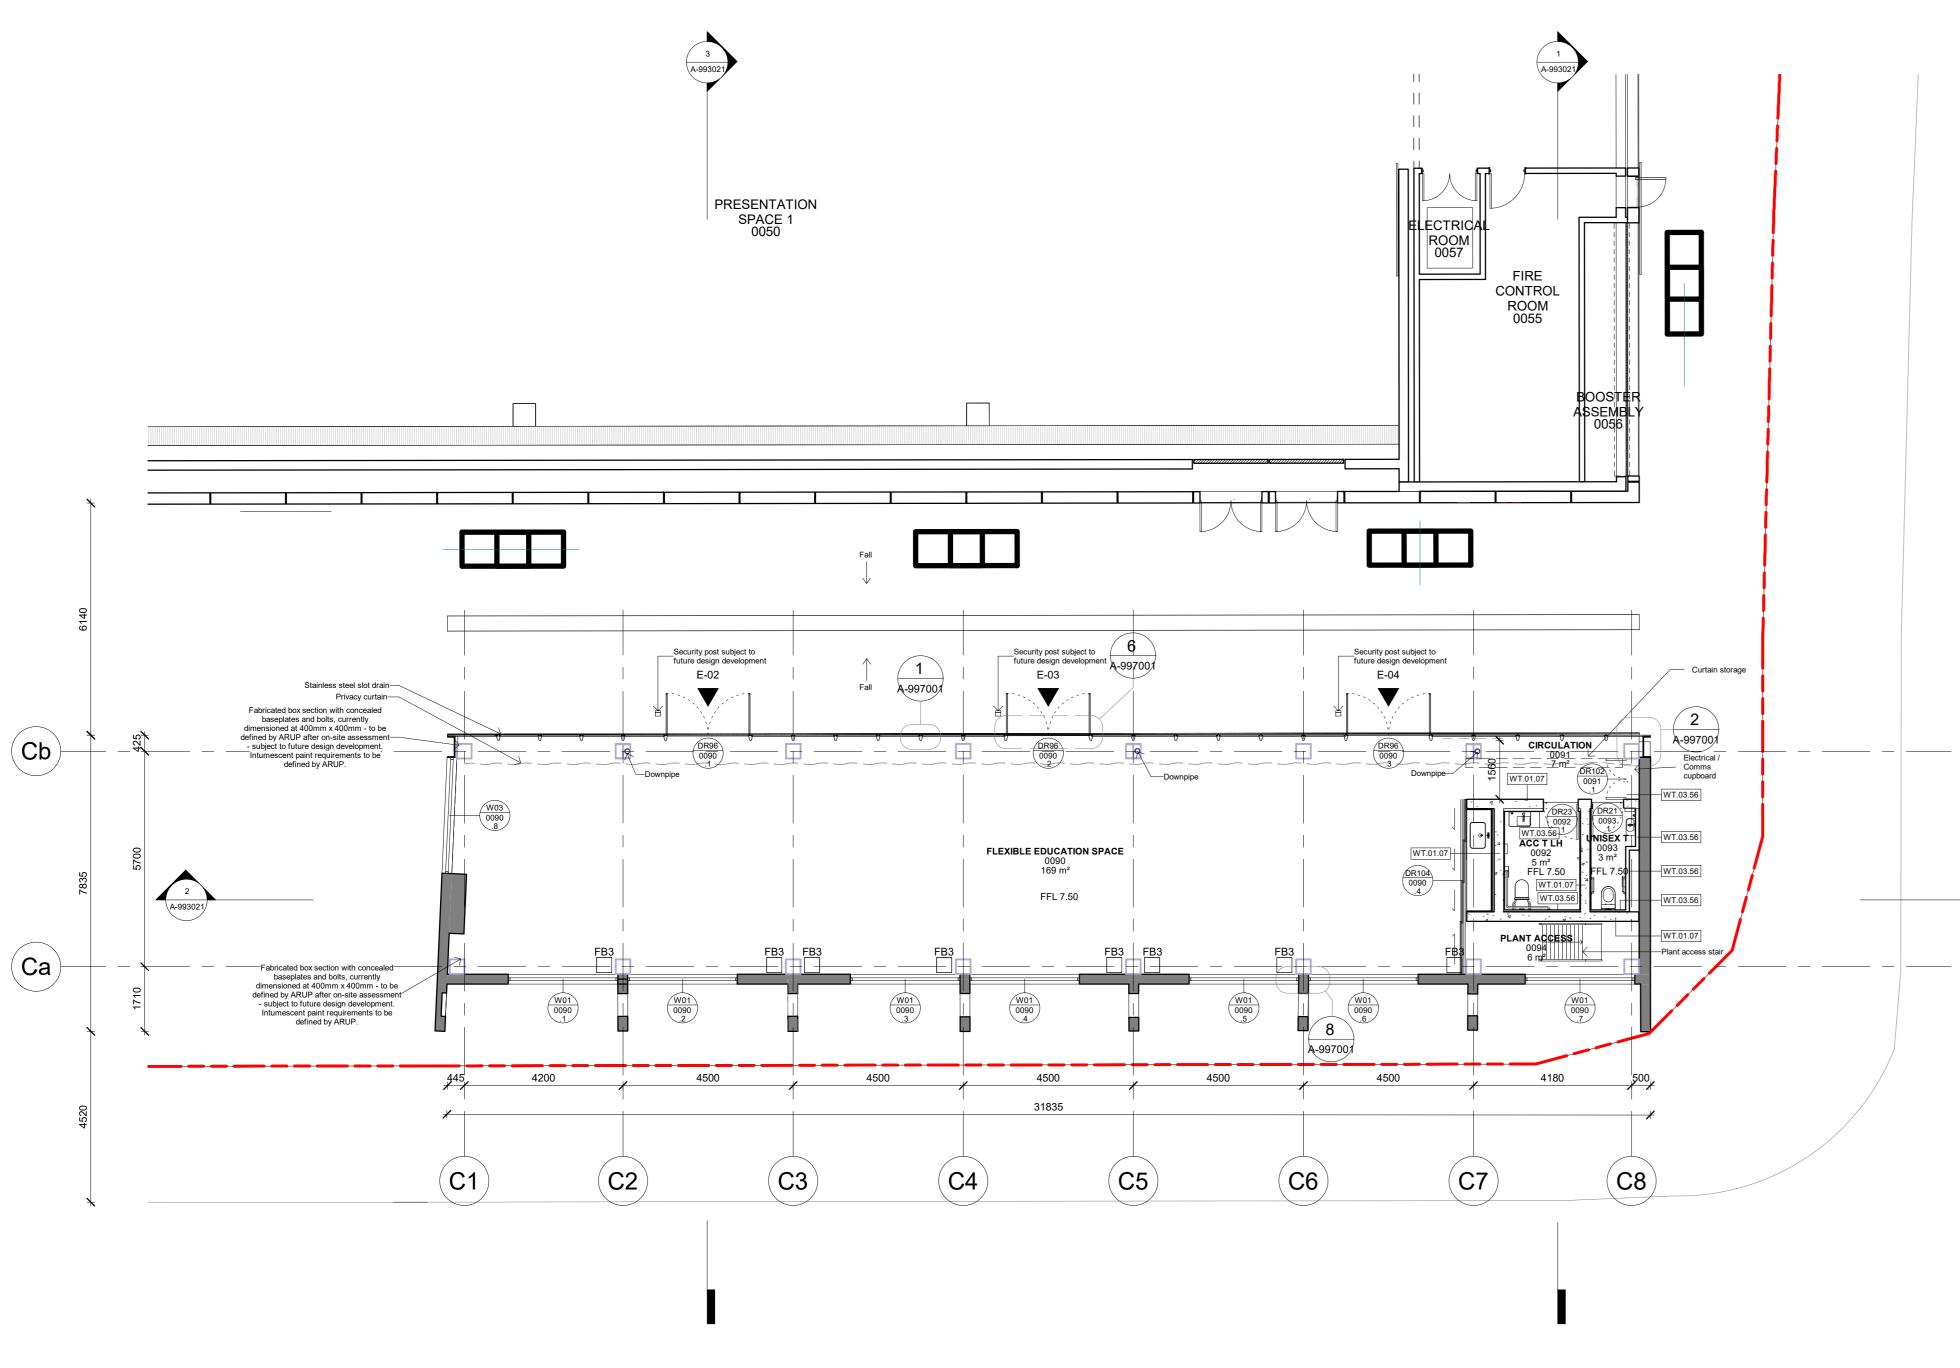




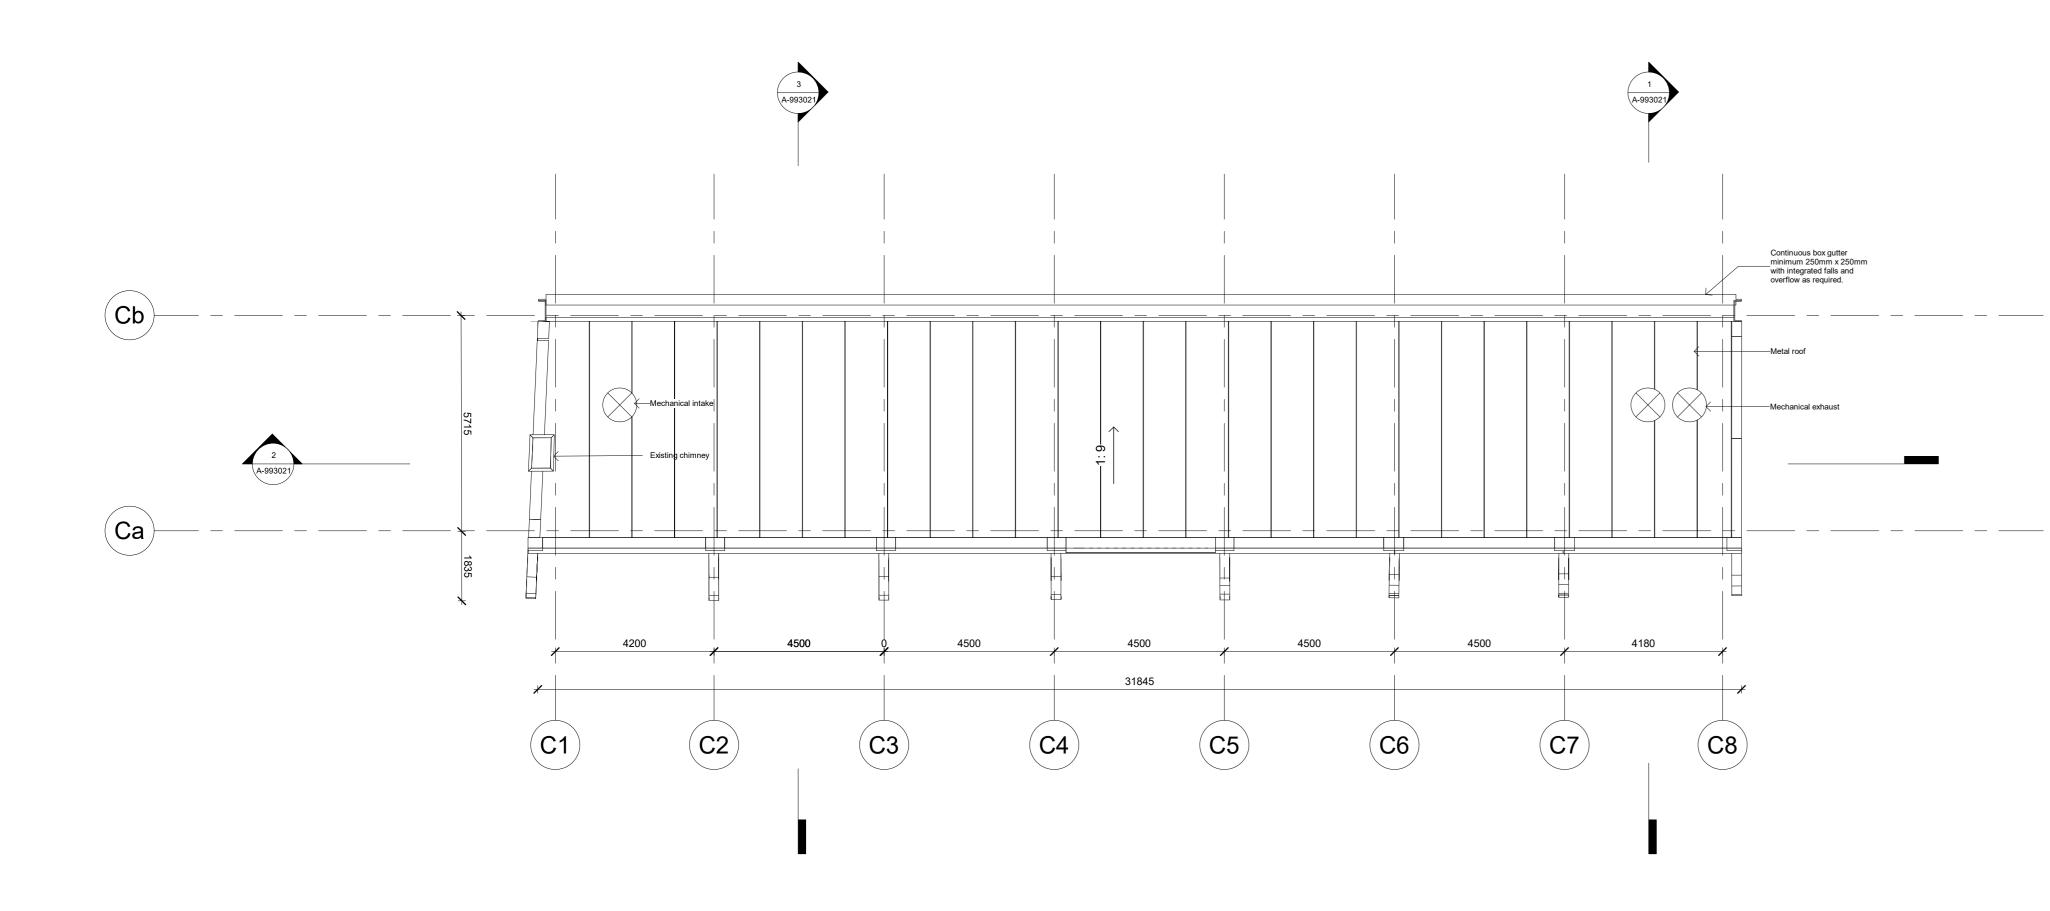

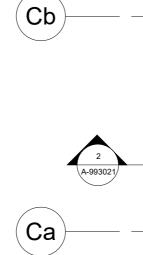



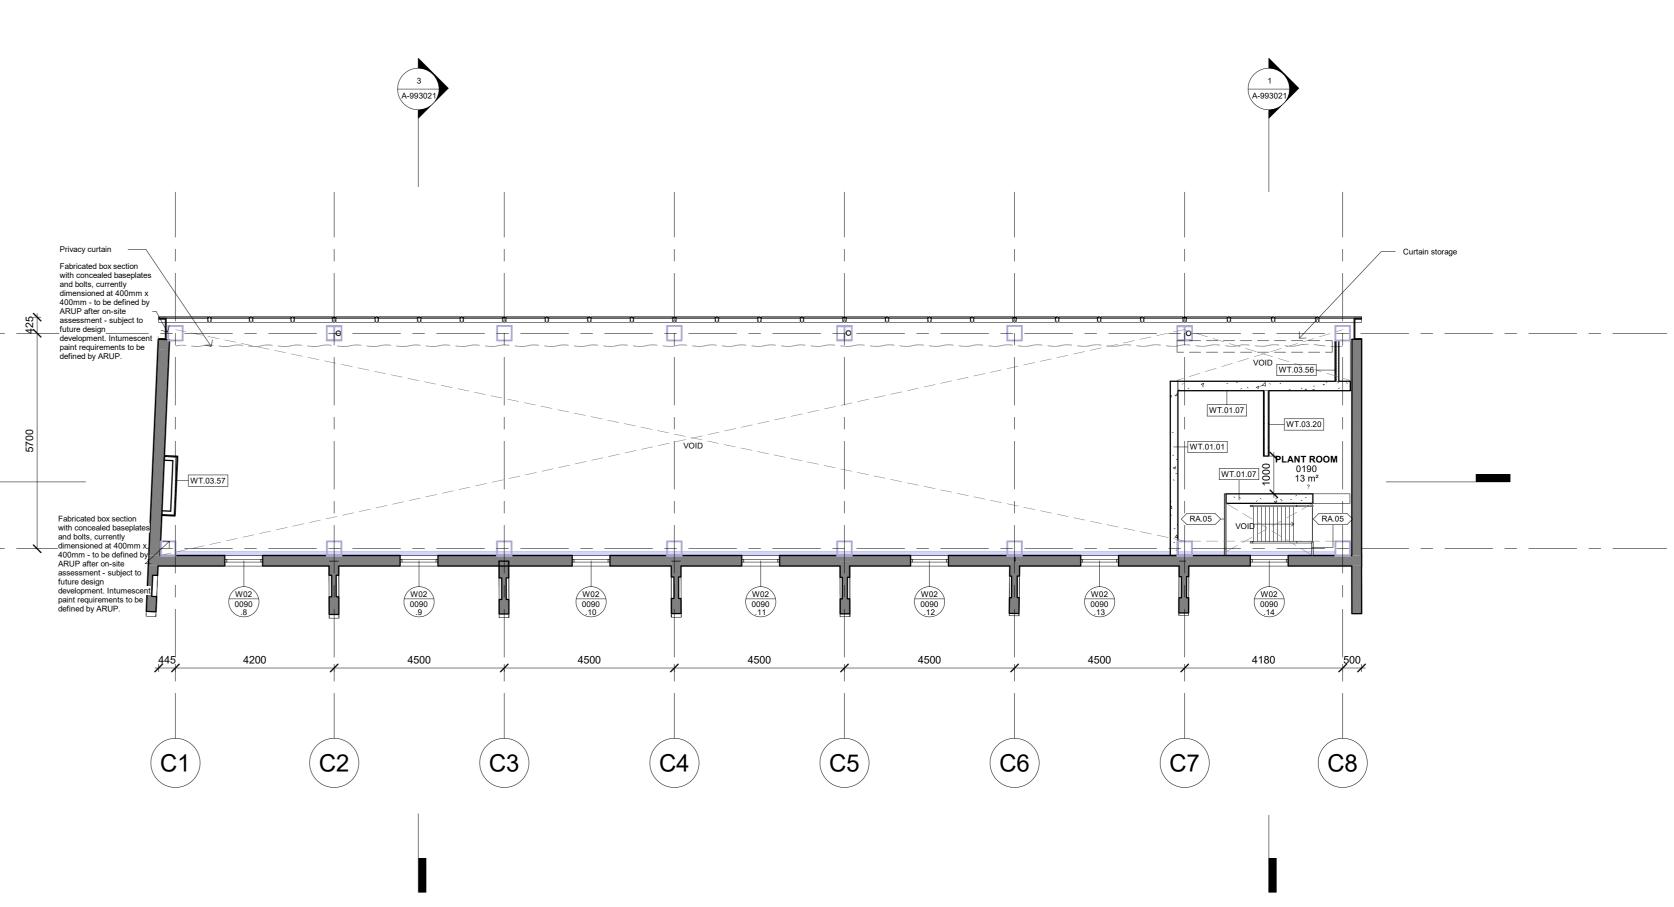

2 PROPOSED PLAN - FIRST FLOOR 1:100





END USER: **POWERHOUSE** PARRAMATI

CONTRACTOR: твс

_____ DESIGN TEAM: LEAD DESIGNER: MOREAU KUSUNOKI 5 rue de Nemours, 75011 Paris, France

LOCAL ARCHITECT: GENTON

Ground Floor, 71 York Street Sydney NSW 2000

T +33 1 84 16 48 10

T+ 612.9696.5002 MULTIDISCIPLINARY ENGINEERING (SCMEP and SPECIALISTS):

ARUP Level 5 , Barrack Place, 151 Clarence St, Sydney NSW 2000 T: +61 2 9320 9320

DESIGN SUBCONSULTANTS:

LANDSCAPE ARCHITECTS: ARCH. LIGHTING: McGREGOR COXALL

KINETIC STRUCTURE:

13 Rue du Béal, 38400 Saint-Martin-d'Hères, France T: +33 4 76 62 84 54

L'OBSERVATOIRE INT
 Suite 101, Level 1, 39 East Esplanade, Manly,
 120 Walker Street 7th Floor East

 NSW, Australia
 New York, New York 10013, USA

 T: +612 9188 7500
 T: +1 212 255 4463

EXOSKELETON: JUN SATO 2F, Kobayashi building 2-26-3, Higashiazabu, Minato-ku, Tokyo, 106-0044, Japan T: +81 3 6441 0914

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NOTES/LEGEND

LEGEND	
	Existing fabric to be retained
	Proposed
REVISION	

1	9/2/2021	Tender Addenda
No.	Date	Description


_____ LOCATION

POWERHOUSE PARRAMATTA 34-54 Phillip Street Parramatta, NSW 2150

_____ ARCHITECTS

LEAD DESIGNER: MOREAU KUSUNOKI


LOCAL ARCHITECT: GENTON

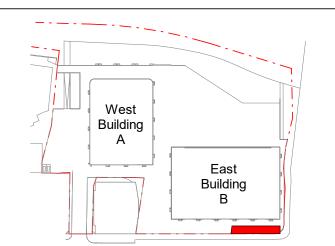


TITLE ST GEORGES TERRACE -PROPOSED - PLANS

SCALE: 1 : 100 @ A0

	NOT F	OR	CON	ISTR		NC	
JOB NO.	0		D	VN	СНК	D	APPD
DATE	9/2/2021		Au	thor	Check	er	Approver
DRAWING NUMBER RE					REVI	SION.	
	A-99	300	1				1
	0 []] 1:100	1	2	3	4	5 m	

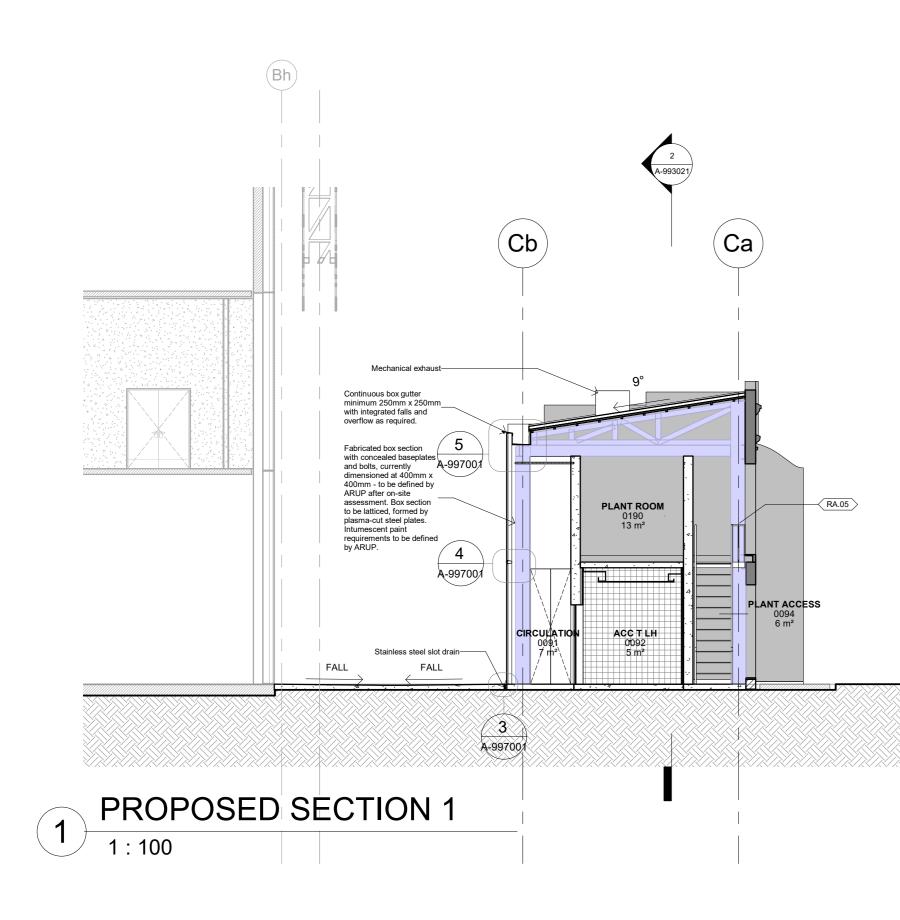


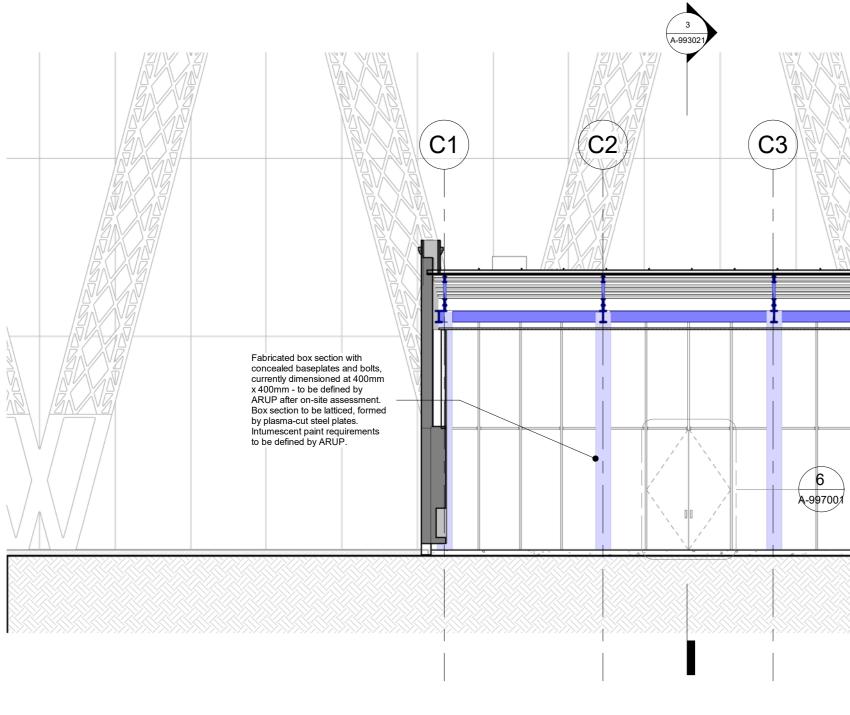

2 PROPOSED SECTION 2 1:100



VIN N **C**6 \frown (C5) (C7) $(\mathbf{C8})$ (C4) ROOF 15130.00 PLANT ROOM 0190 13 m² FIRST FLOOR 10730.00 FLEXIBLE EDUCATION SPACE KITCHENETTE ACC T LH 0092 5 m² 0090 169 m² SEX 1 GROUND FLOOR 7500.00

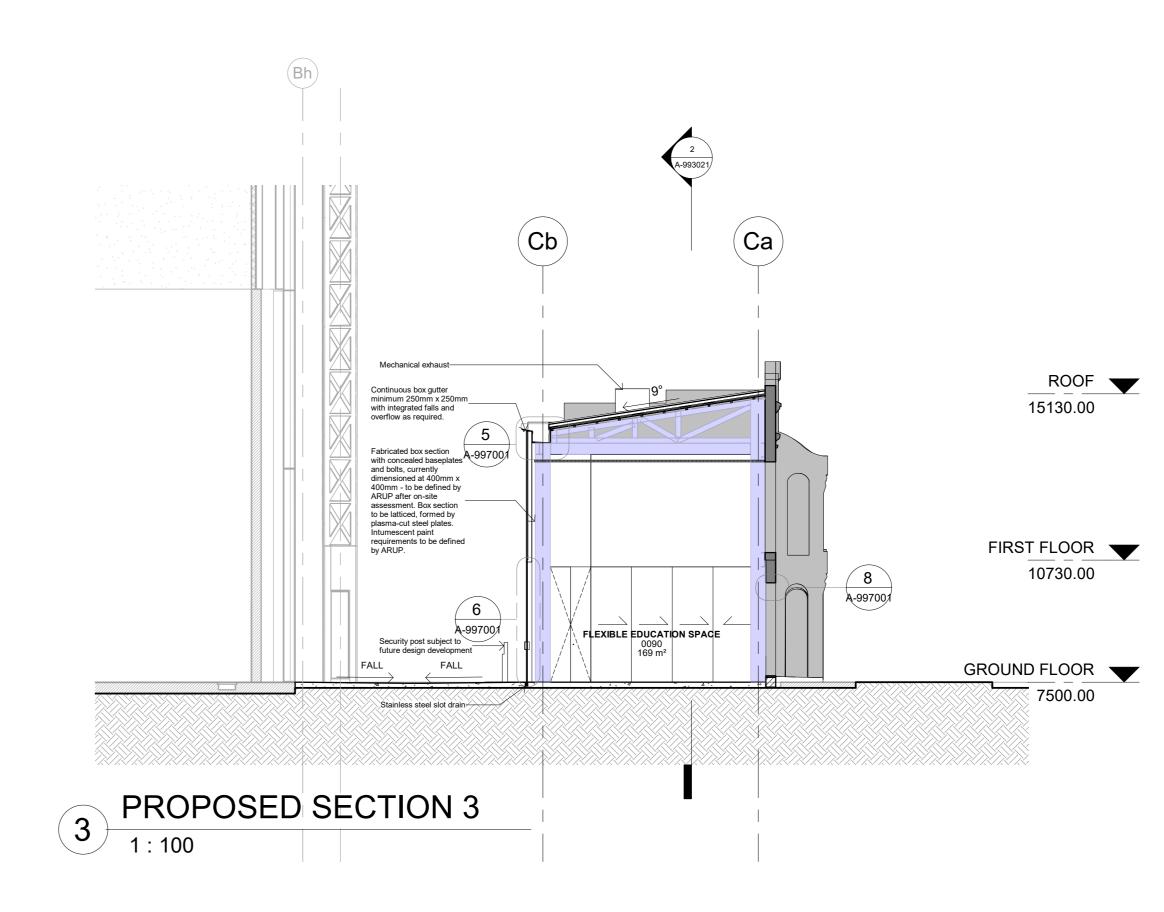

POWERHOUSE PARRAMATTA



END USER: POWERHOUSE PARRAMAT

CONTRACTOR: твс

-----DESIGN TEAM: LEAD DESIGNER: MOREAU KUSUNOKI 5 rue de Nemours, 75011 Paris, France T +33 1 84 16 48 10

LOCAL ARCHITECT:

GENTON Ground Floor, 71 York Street Sydney NSW 2000

T+ 612.9696.5002 MULTIDISCIPLINARY ENGINEERING (SCMEP and SPECIALISTS):

ARUP Level 5 , Barrack Place, 151 Clarence St, Sydney NSW 2000 T: +61 2 9320 9320

DESIGN SUBCONSULTANTS:

McGREGOR COXALL

LANDSCAPE ARCHITECTS: ARCH. LIGHTING: L'OBSERVATOIRE INT
 Suite 101, Level 1, 39 East Esplanade, Manly,
 120 Walker Street 7th Floor East

 NSW, Australia
 New York, New York 10013, USA

 T: +612 9188 7500
 T: +1 212 255 4463

> EXOSKELETON: JUN SATO 2F, Kobayashi building 2-26-3, Higashiazabu, Minato-ku, Tokyo, 106-0044, Japan T: +81 3 6441 0914

DISCLAIMER

DEP

KINETIC STRUCTURE:

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NOTES/LEGEND

LEGEND Existing fabric to be retained Proposed -----REVISION
 1
 9/2/2021
 Tender Addenda

 No.
 Date
 Description


_____ LOCATION

POWERHOUSE PARRAMATTA 34-54 Phillip Street Parramatta, NSW 2150

_____ ARCHITECTS

LEAD DESIGNER: MOREAU KUSUNOKI

LOCAL ARCHITECT: GENTON

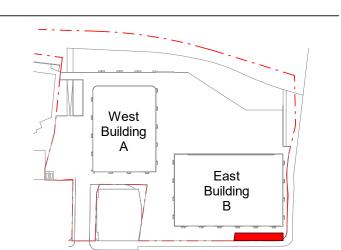



TITLE ST GEORGES TERRACE -PROPOSED - SECTIONS


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STATUS TENDER DOCUMENTATION


NOT FOR CONSTRUCTION **JOB NO.** 0 DWN CHKD APPD **DATE** 9/2/2021 Author Checker Approver DRAWING NUMBER REVISION. A-993021




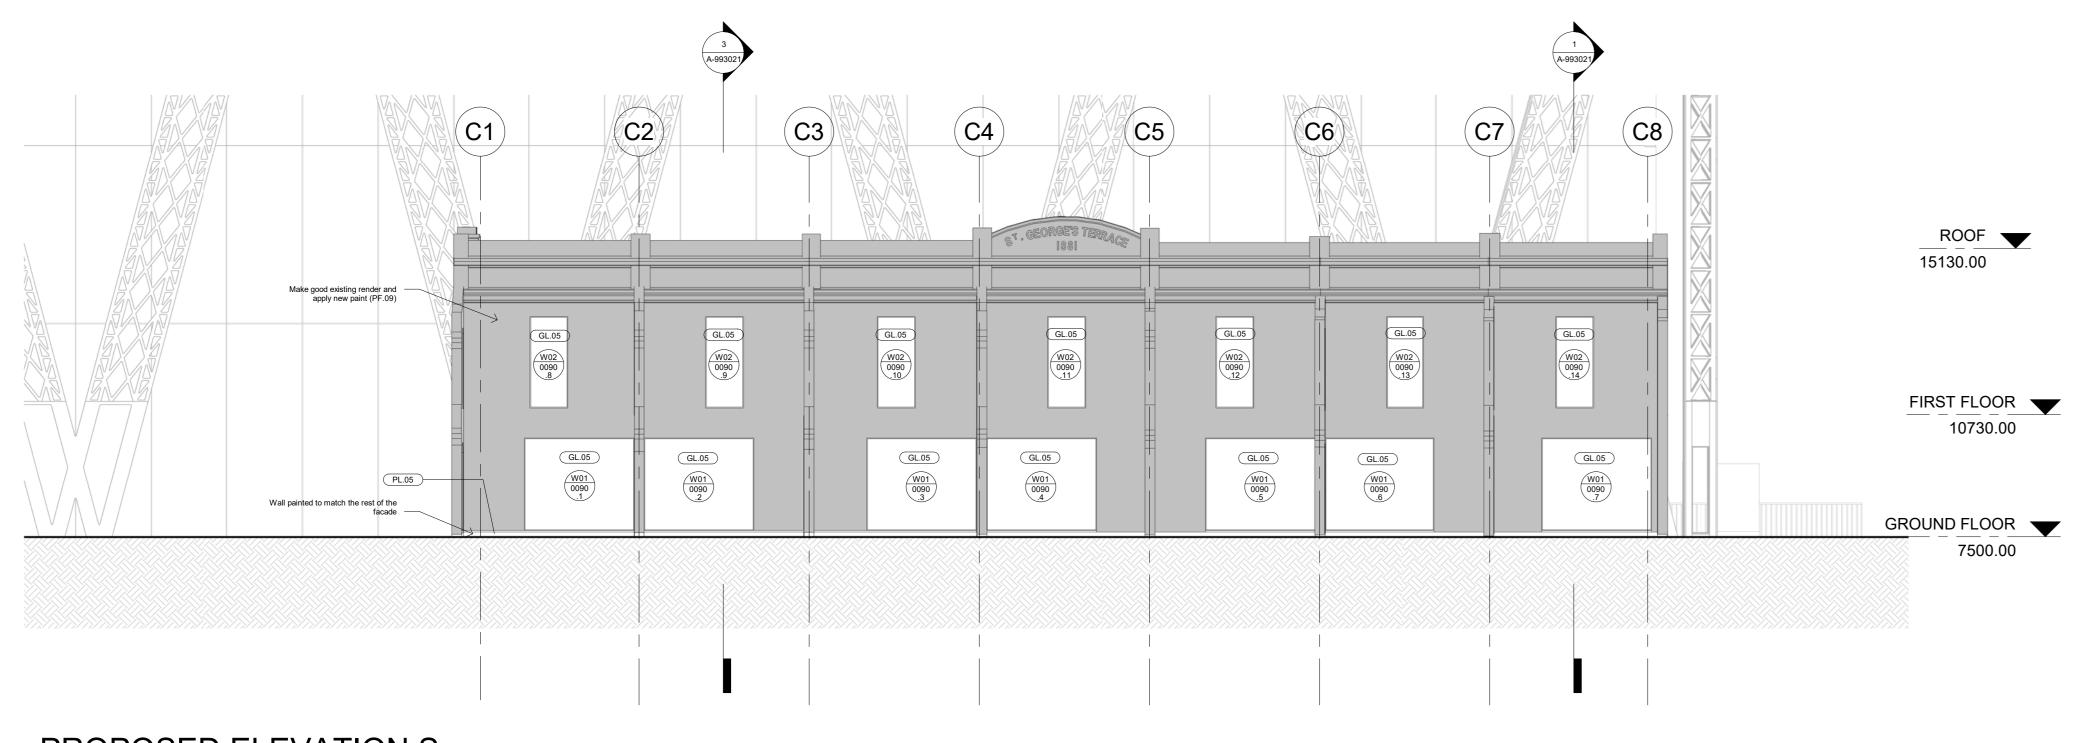

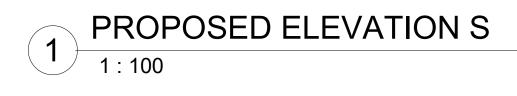


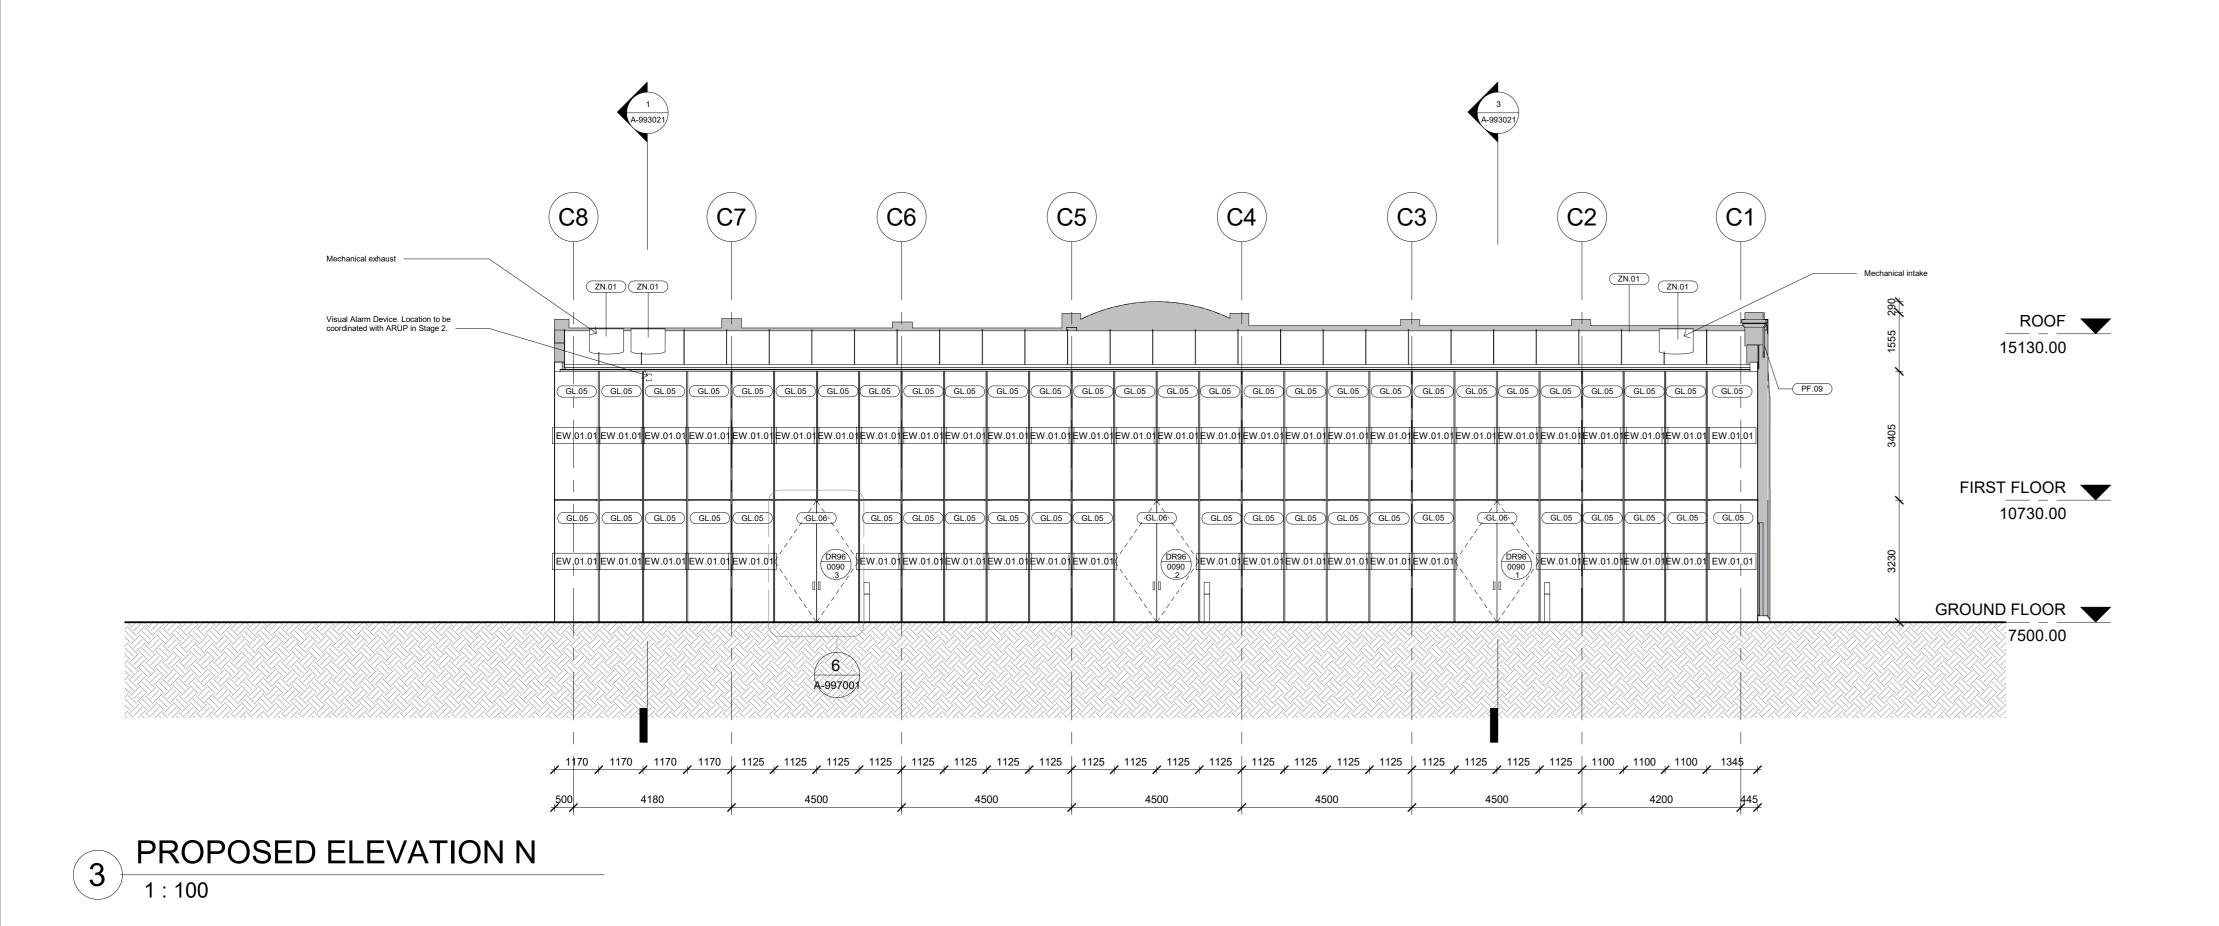

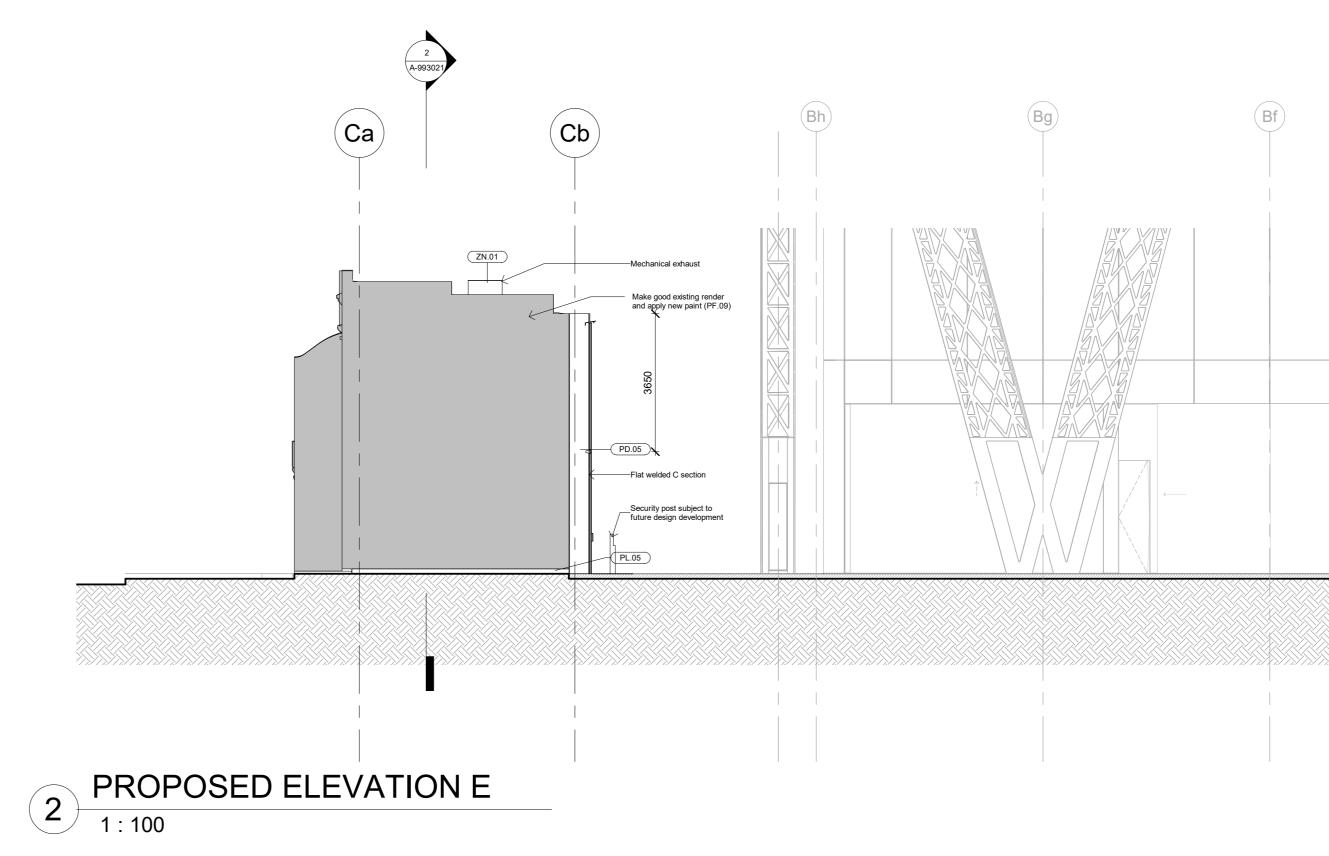

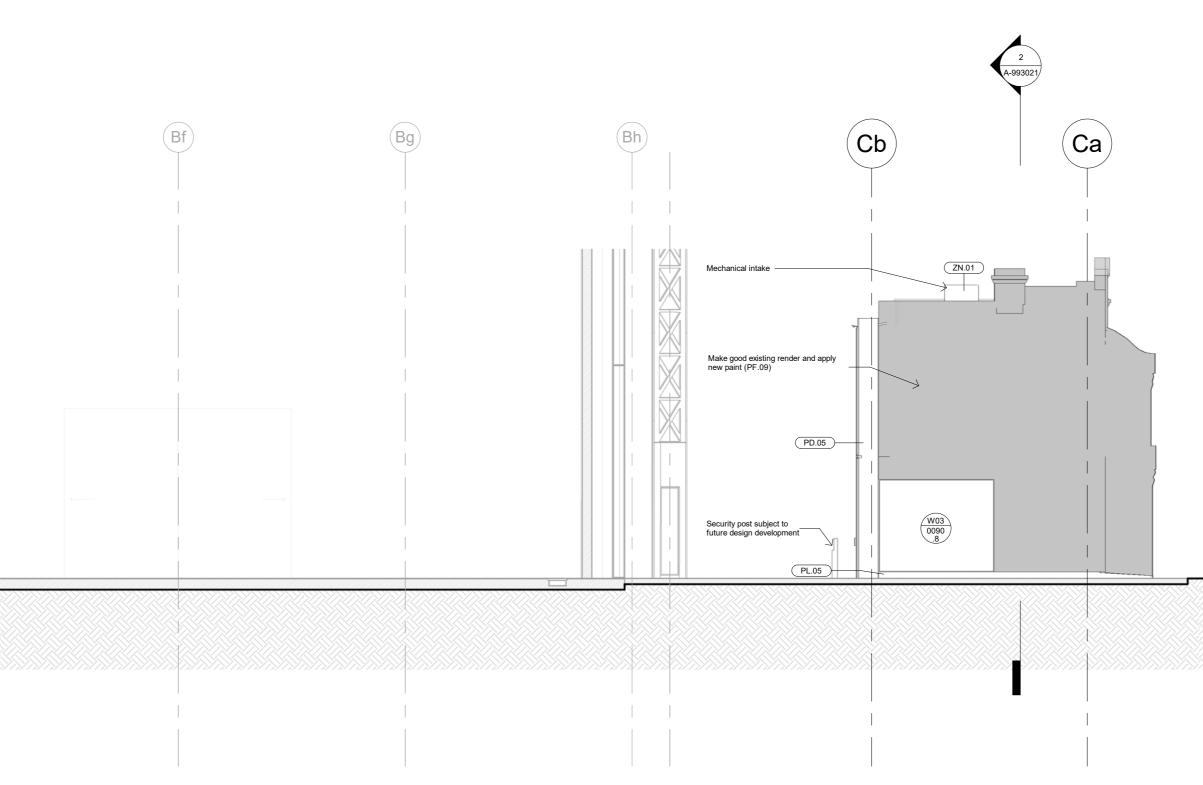



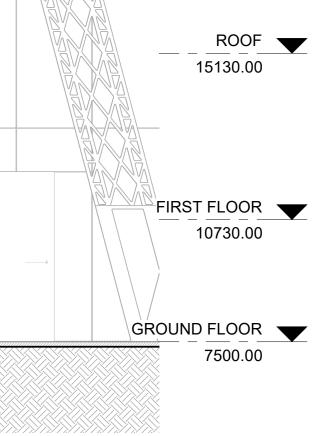

POWERHOUSE PARRAMATTA



END USER: POWERHOUSE **PARRAMATT**

CONTRACTOR: твс

_____ DESIGN TEAM: LEAD DESIGNER: MOREAU KUSUNOKI 5 rue de Nemours, 75011 Paris, France T +33 1 84 16 48 10

LOCAL ARCHITECT: GENTON

Ground Floor, 71 York Street Sydney NSW 2000 T+ 612.9696.5002

MULTIDISCIPLINARY ENGINEERING (SCMEP and SPECIALISTS): ARUP Level 5 , Barrack Place, 151 Clarence St, Sydney NSW 2000

T: +61 2 9320 9320

DESIGN SUBCONSULTANTS: LANDSCAPE ARCHITECTS: ARCH. LIGHTING: McGREGOR COXALL

L'OBSERVATOIRE INT. Suite 101, Level 1, 39 East Esplanade, Manly, NSW, Australia 120 Walker Street 7th Floor East New York, New York 10013, USA T: +1 212 255 4463 EXOSKELETON:

JUN SATO 2F, Kobayashi building 2-26-3, Higashiazabu, Minato-ku, Tokyo, 106-0044, Japan T: +81 3 6441 0914

DISCLAIMER

T: +612 9188 7500

DEP

KINETIC STRUCTURE:

13 Rue du Béal, 38400 Saint-Martin-d'Hères, France T: +33 4 76 62 84 54

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NOTES/LEGEND



Existing fabric to be retained

Proposed

RE	VISION	

No.	Date	Description
1	9/2/2021	Tender Addenda


-----LOCATION

POWERHOUSE PARRAMATTA 34-54 Phillip Street Parramatta, NSW 2150

-----ARCHITECTS LEAD DESIGNER:

MOREAU KUSUNOKI

LOCAL ARCHITECT: GENTON

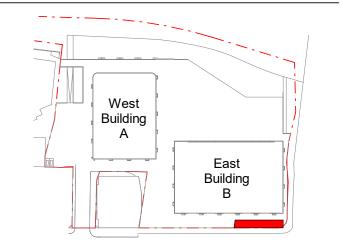

TITLE ST GEORGES TERRACE -PROPOSED - ELEVATIONS

SCALE: 1 : 100 @ A0

STATUS TENDER DOCUMENTATION


	NOT FOR	CONSTR	UCTION	
JOB NO.	0	DWN	СНКД	APPD
DATE	9/2/2021	Author	Checker	Approver
DRAWING	NUMBER		REV	SION.
	A-99301	1		1
	0 1	2 3	4 5	
	1:100		m	l

_____ROOF_____ 15130.00

FIRST FLOOR T10730.00

GROUND FLOOR 🛛 🛨

7500.00

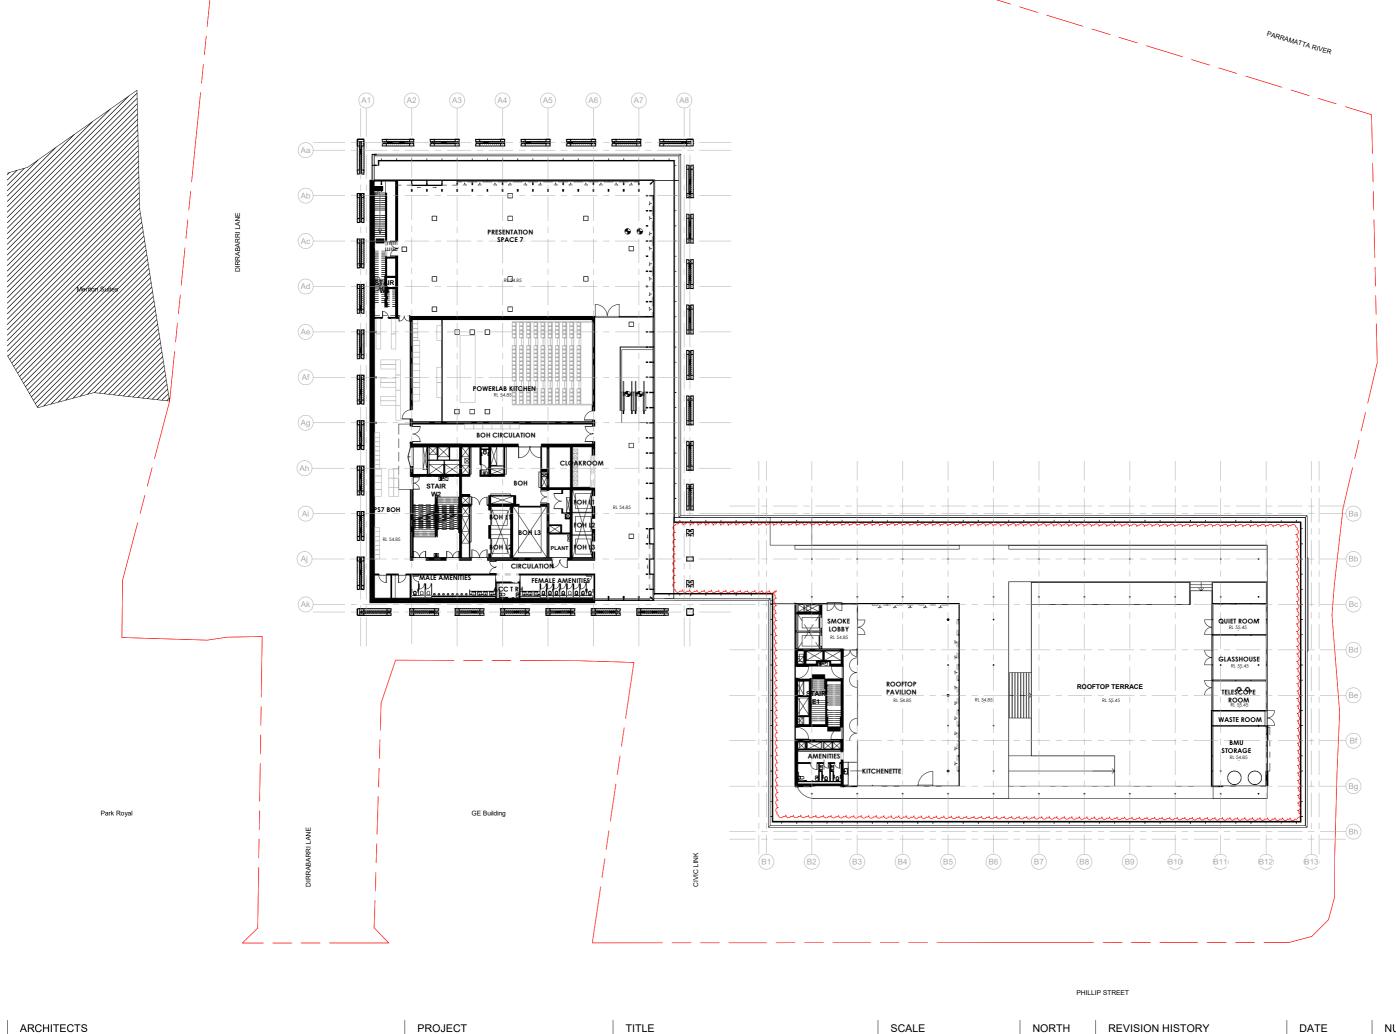

MOREAU KUSUNOKI

GENTON 5 RUE DE NEMOURS 75011 PARIS FRANCE 71 YORK ST SYDNEY NSW 2000 AUSTRALIA POWERHOUSE PARRAMATTA

LEVEL 4 PLAN

1:250 @ A1 0 25 5 7.5 10 12.5 m 1 : 250 NORTH

No Date Description 13 17/11/2021 SSDA MOD



Ä


17/11/2021

NUMBER

REVISION

13

DA140

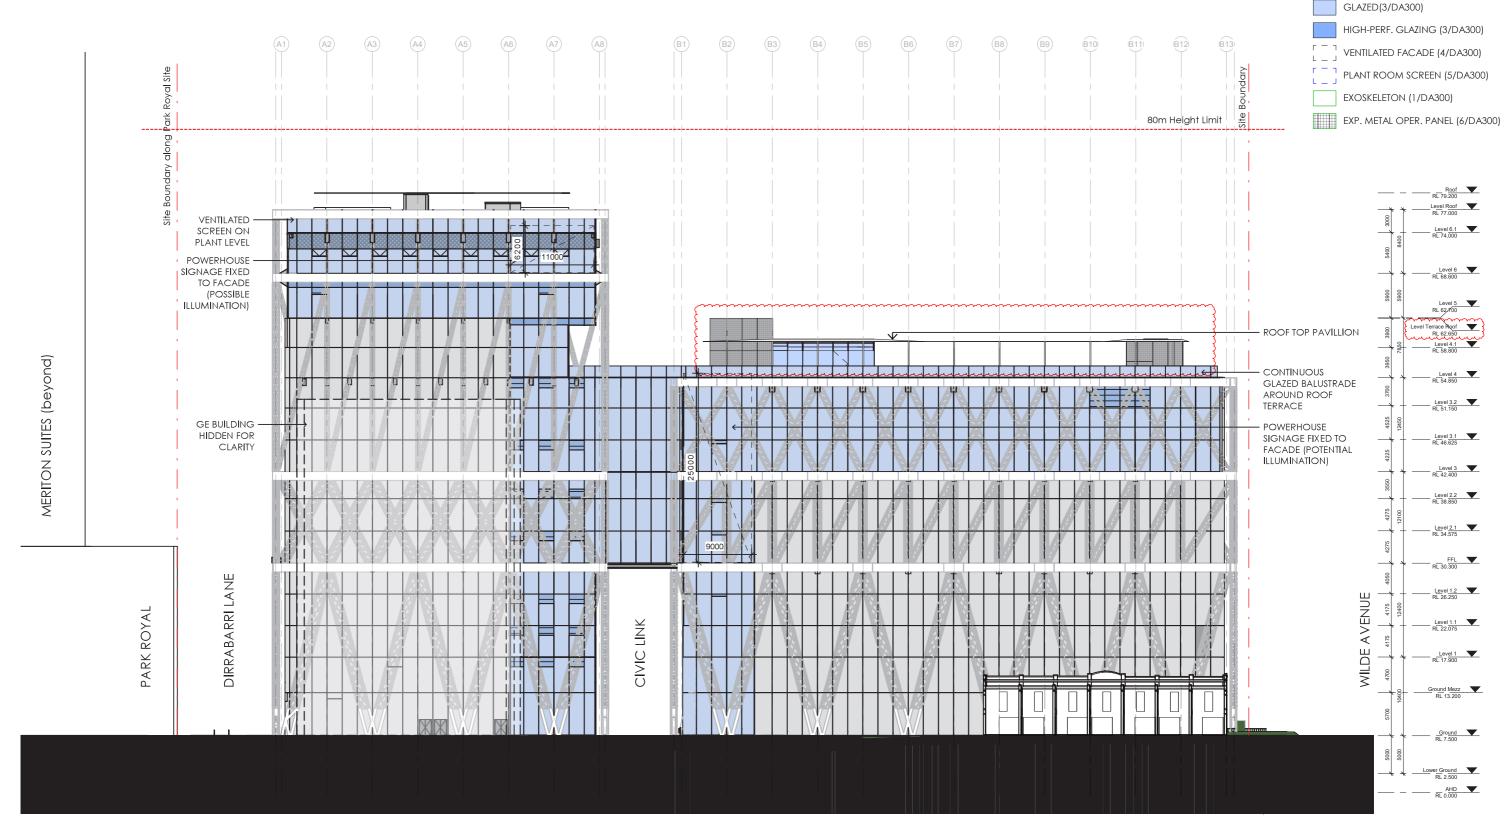

MOREAU KUSUNOKI

GENTON 5 RUE DE NEMOURS 75011 PARIS FRANCE 71 YORK ST SYDNEY NSW 2000 AUSTRALIA PROJECT

TITLE

EXTERNAL ELEVATION SOUTH

SCALE 1:250 @A1

REVISION HISTORY No Date Description 16 17/11/2021 SSDA MOD

0 25 5 7.5 10 125 m 1 : 250

POWERHOUSE PARRAMATTA

Note: Site Boundary (shown at entry from Phillip Street)

DATE

NUMBER


FACADE LEGEND

CEMENTITIOUS PANEL (4/DA300)

REVISION

17/11/2021

DA200

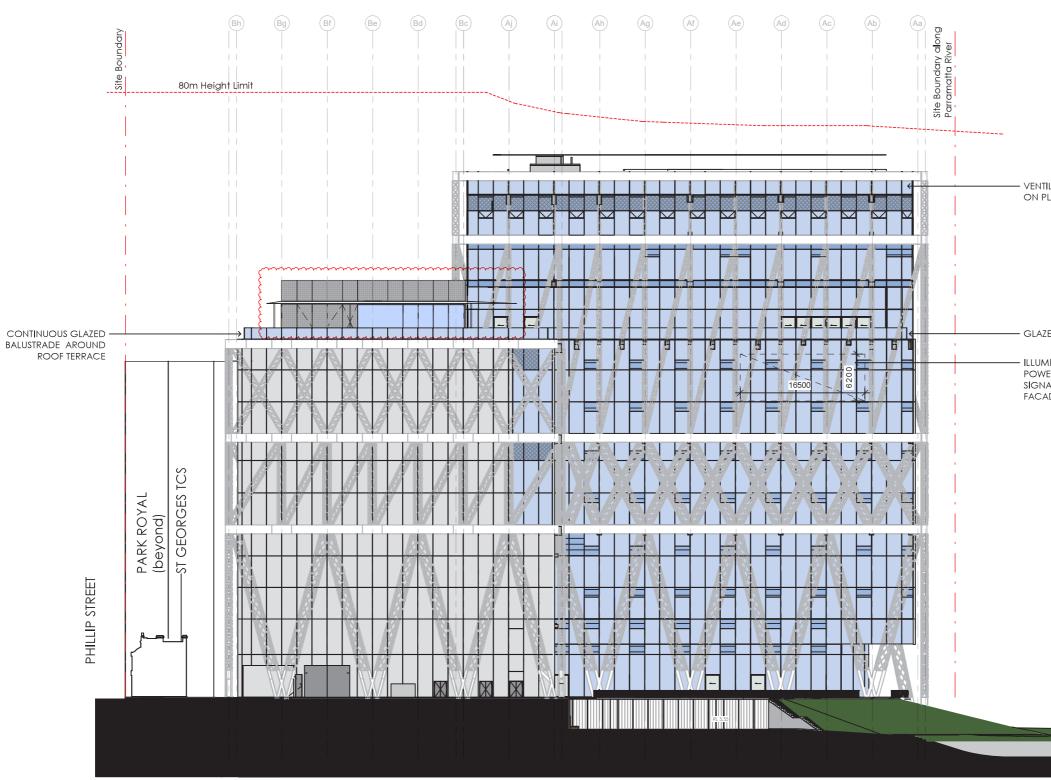

MOREAU KUSUNOKI

GENTON 5 RUE DE NEMOURS 75011 PARIS FRANCE 71 YORK ST SYDNEY NSW 2000 AUSTRALIA POWERHOUSE PARRAMATTA


PROJECT


TITLE

SCALE 1:250 @A1 0 25 5 7.5 10 12.5 m 1 : 250 **REVISION HISTORY** No Date Description 16 17/11/2021 SSDA MOD

EXTERNAL ELEVATION EAST

FACADE LEGEND

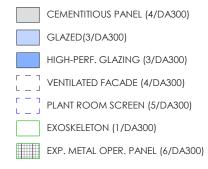

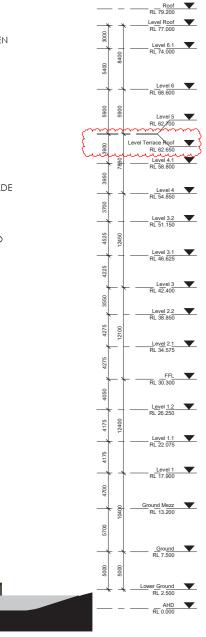

VENTILATED SCREEN ON PLANT LEVEL

- GLAZED BALUSTRADE

- ILLUMINATED POWERHOUSE SIGNAGE FIXED TO FACADE

RIVER

DATE 17/11/2021 NUMBER

DA201

REVISION



MOREAU KUSUNOKI

GENTON

PROJECT

TITLE

SCALE

1:250 @ A1 0 25 5 7.5 10 12.5 1 : 250 **REVISION HISTORY**

No Date Description 14 17/11/2021 SSDA MOD

POWERHOUSE PARRAMATTA

EXTERNAL ELEVATION NORTH

5 RUE DE NEMOURS 75011 PARIS FRANCE 71 YORK ST SYDNEY NSW 2000 AUSTRALIA

DATE

NUMBER

FACADE LEGEND

REVISION

17/11/2021

DA202



MOREAU KUSUNOKI

5 RUE DE NEMOURS 75011 PARIS FRANCE 71 YORK ST SYDNEY NSW 2000 AUSTRALIA

GENTON

PROJECT POWERHOUSE PARRAMATTA TITLE

EXTERNAL ELEVATION WEST

SCALE 1:250 @ A1

0 25 5 7.5 10 12.5 m 1 : 250

REVISION HISTORY No Date Description 14 17/11/2021 SSDA MOD


DATE

NUMBER

DA203

REVISION

17/11/2021

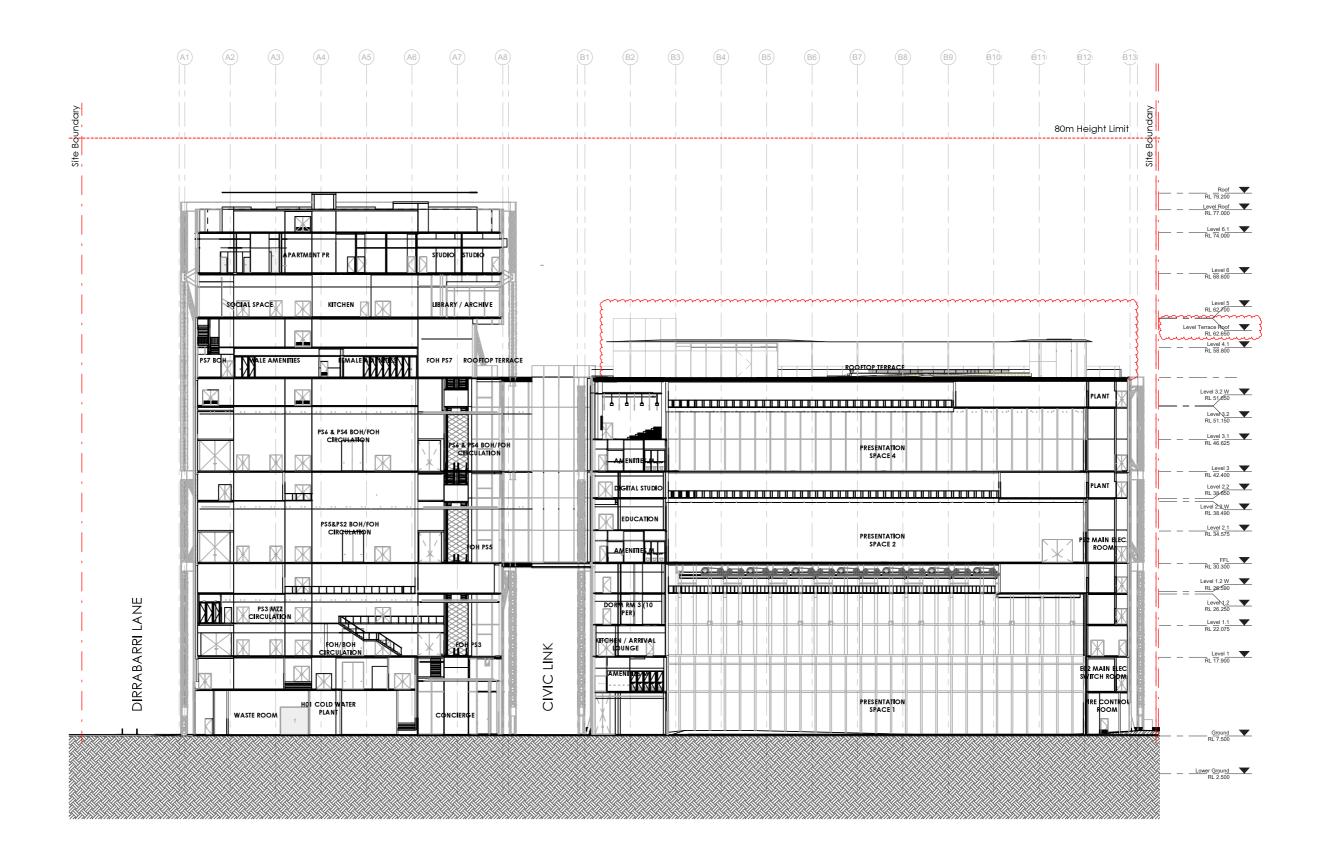

MOREAU KUSUNOKI

GENTON 5 RUE DE NEMOURS 75011 PARIS FRANCE 71 YORK ST SYDNEY NSW 2000 AUSTRALIA PROJECT

TITLE

POWERHOUSE PARRAMATTA

SECTION A

SCALE 1:250 @A1 0 2.5 5 7.5 10 12.5 m 1 : 250 **REVISION HISTORY** No Date Description 14 17/11/2021 SSDA MOD

DATE

NUMBER

REVISION

17/11/2021

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DA250
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ARCHITECTS

MOREAU KUSUNOKI

GENTON 5 RUE DE NEMOURS 75011 PARIS FRANCE 71 YORK ST SYDNEY NSW 2000 AUSTRALIA PROJECT


TITLE

POWERHOUSE PARRAMATTA

SECTION B

SCALE 1:250 @ A1

REVISION HISTORY No Date Description 14 17/11/2021 SSDA MOD

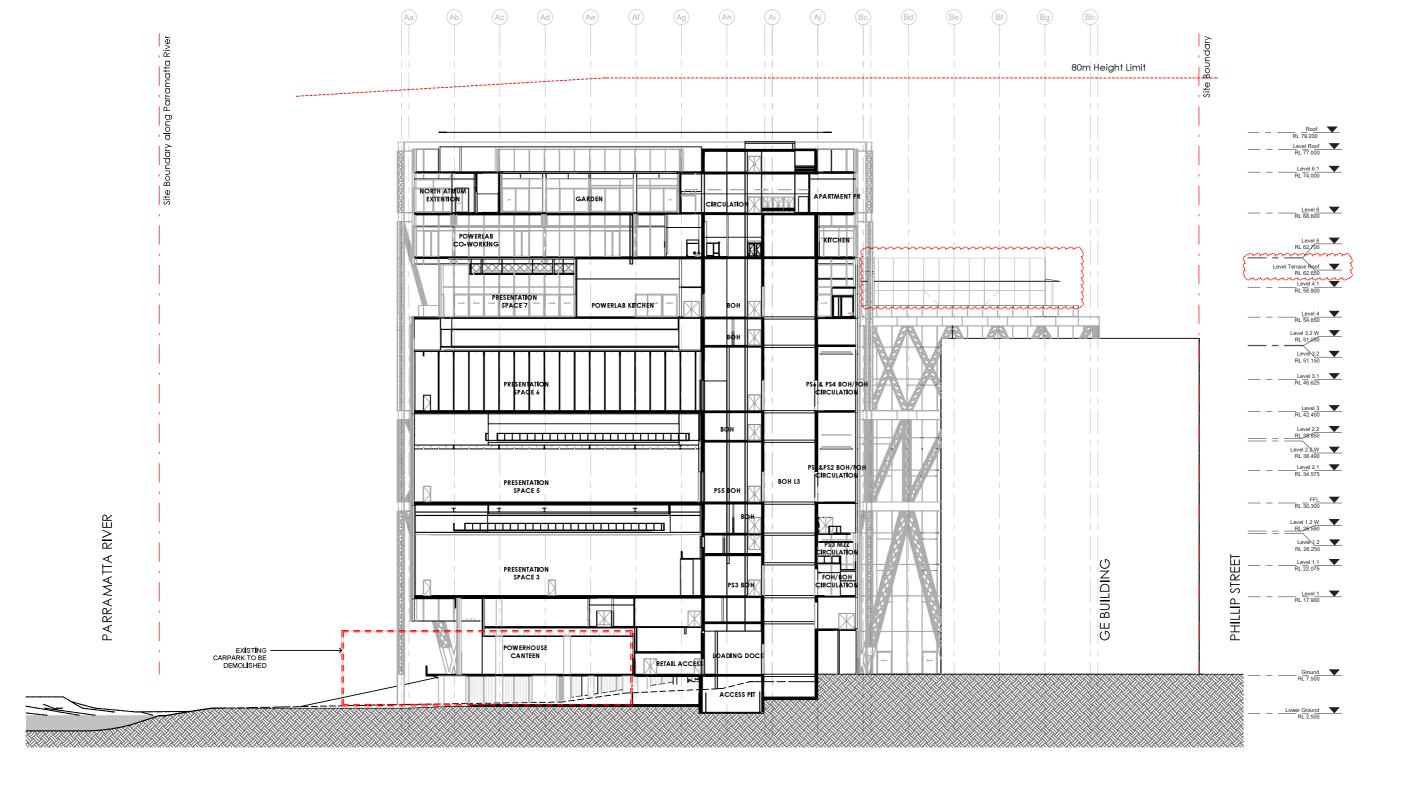


DATE

NUMBER

REVISION

17/11/2021

DA251

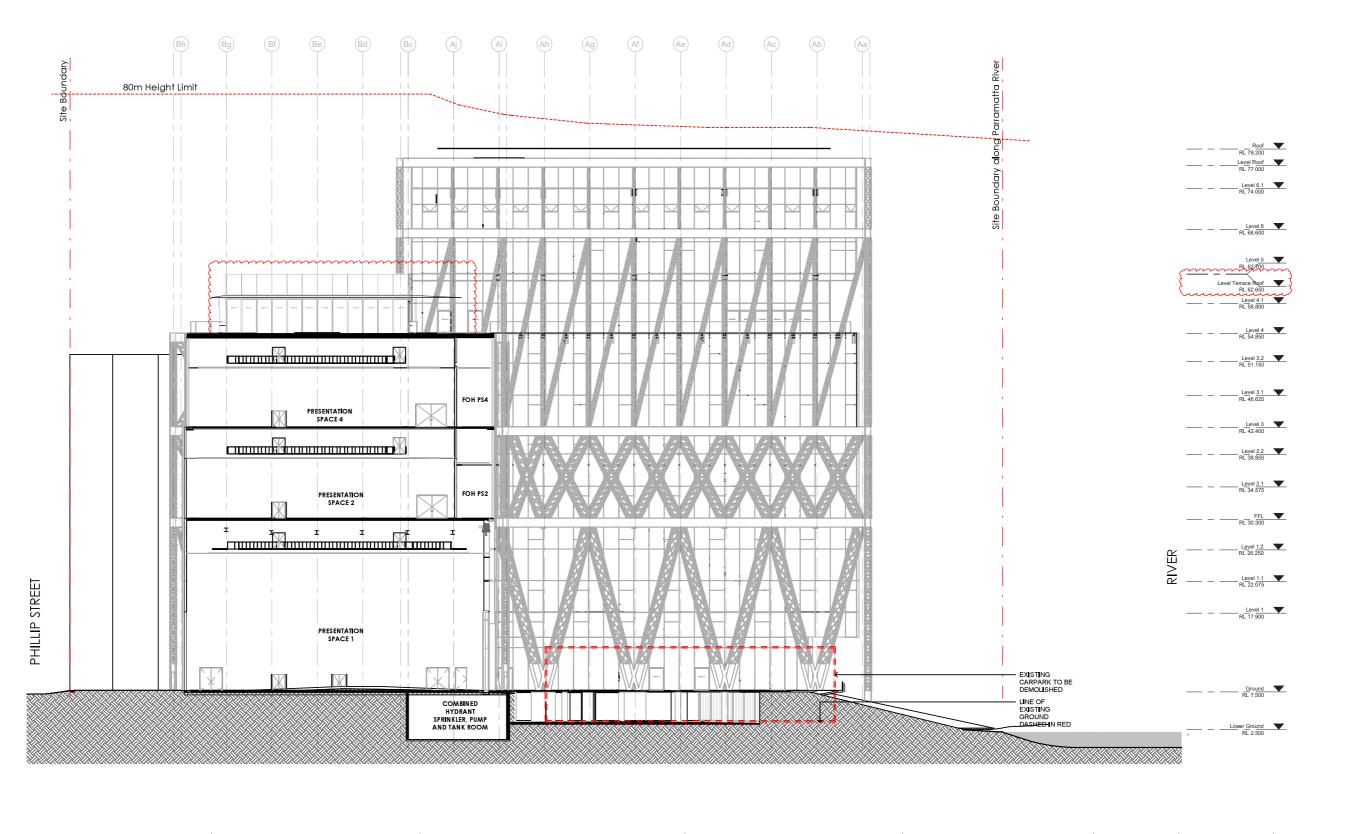

MOREAU KUSUNOKI

GENTON 5 RUE DE NEMOURS 75011 PARIS FRANCE 71 YORK ST SYDNEY NSW 2000 AUSTRALIA POWERHOUSE PARRAMATTA

PROJECT

TITLE SECTION C SCALE 1:250 @A1 **REVISION HISTORY** No Date Description 14 17/11/2021 SSDA MOD


DATE

NUMBER


REVISION

17/11/2021


DA252

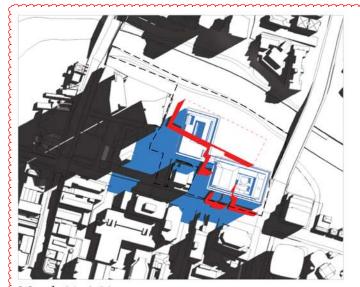


March 21, 9:00 am

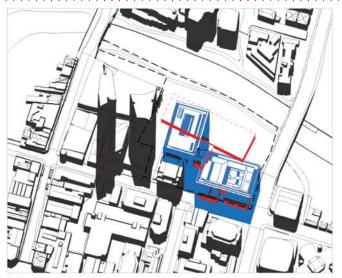


March 21, 12:00 pm

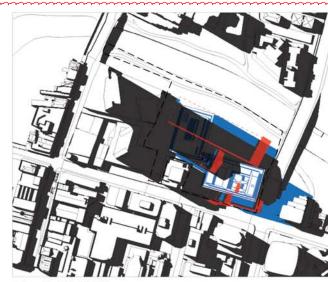


March 21, 3:00 pm

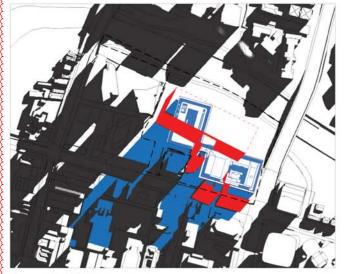


June 21, 9:00 am

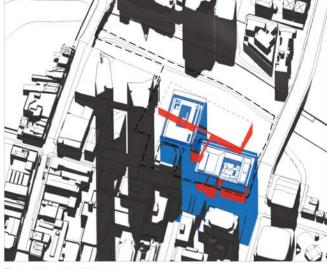


June 21, 12:00 pm

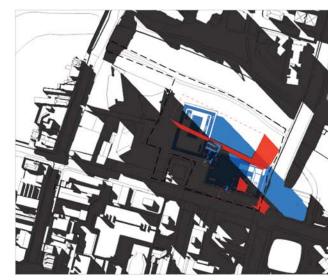

June 21, 3:00 pm

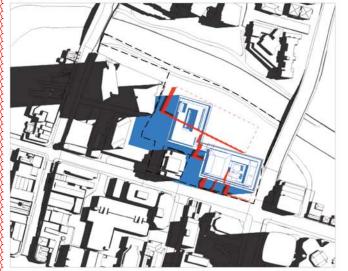

December 21, 9:00 am

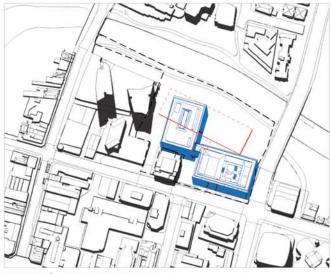

December 21, 12:00 pm



December 21, 3:00 pm

ARCHITECTS

MOREAU KUSUNOKI

GENTON 5 RUE DE NEMOURS 75011 PARIS FRANCE 71 YORK ST SYDNEY NSW 2000 AUSTRALIA POWERHOUSE PARRAMATTA

PROJECT

TITLE

SHADOW DIAGRAMS

SCALE NTS @ A1 NORTH

REVISION HISTORY No Date Description 13 17/11/2021 SSDA MOD





DATE

NUMBER


REVISION

17/11/2021

DA400


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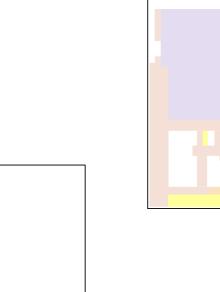
---- site boundary proposed building shadow of proposed building shadow of existing building demolished building shadow of demolished building

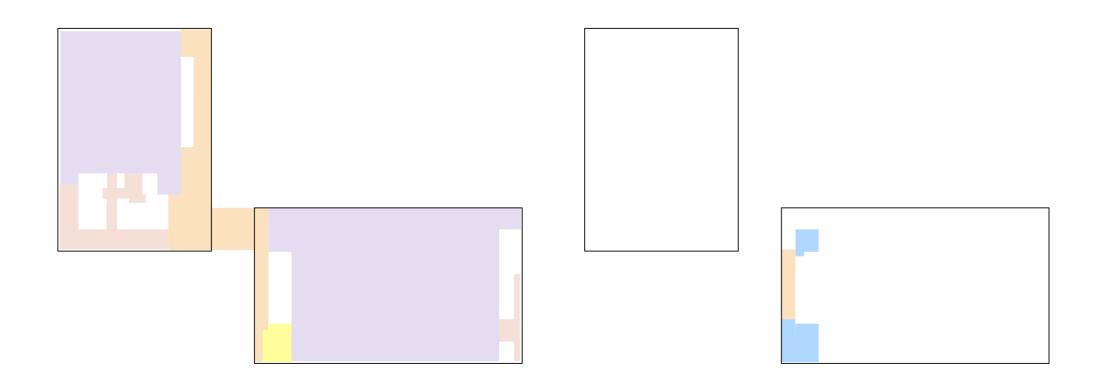


Level 3

Level 3.1



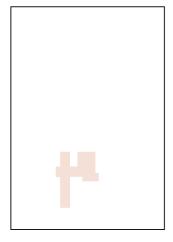

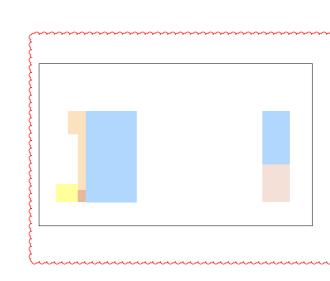



Level 3.2

ARCHITECTS

MOREAU KUSUNOKI

GENTON 5 RUE DE NEMOURS 75011 PARIS FRANCE 71 YORK ST SYDNEY NSW 2000 AUSTRALIA PROJECT

POWERHOUSE PARRAMATTA

TITLE

GFA DIAGRAM AND SCHEDULE

SCALE 1:500 @ A1

NORTH \wedge

REVISION HISTORY No Date Description 13 17/11/2021 SSDA MOD

/e**l** 4

GFA Areas

	Level 3		
	FOH CIRCULATION	719 m²	
1	PRESENTATION SPACE	2380 m²	
1	PRESENTATION SPACE	1273 m²	
1	вон	212 m²	
	вон	68 m²	
	AMENITIES	77 m²	
	вон	61 m²	
	вон	19 m²	
	Level 3.1	4809 m²	
	FOH CIRCULATION	69 m²	
	FOH OTHER	106 m ²	
	FOH OTHER	39 m²	
	Level 3.2	215 m²	
	вон	87 m²	
	Level 4	87 m²	
[PRESENTATION SPACE	608 m ²	
	FOH CIRCULATION	304 m ²	
	AMENITIES	79 m²	
	AMENITIES	5 m²	
	PRESENTATION SPACE	278 m ²	
	ВОН	337 m ²	
	ВОН	85 m²	
	ВОН	14 m²	~
	FOH OTHER	324 m²	Γ
	FOH CIRCULATION	59 m²	3
	FOH OTHER	101 m ²	3
	AMENITIES	28 m²	}
	ВОН	71 m²	ł
J	STAFF AREA	6 m ²	ک
		2300 m ²	-



ACCOMMODATION


AMENITIES

BOH

EDUCATION

FOH CIRCULATION

*BOH - BACK OF HOUSE **FOH - FRONT OF HOUSE

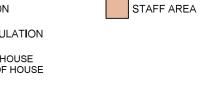

DATE

NUMBER

FOH OTHER

RETAIL

PRESENTATION SPACE

REVISION

17/11/2021

DA502

Gross Floor Area

Floor Space Ratio

19 438 sam

24 797 sqm

1.25 :1

Site Area

Gross Floor Area

Floor Space Ratio

521 m²

77 m²

361 m²

719 m²

3653 m² 4809 m²

69 m²

87 m²

87 m²

112 m² 507 m²

363 m²

426 m²

886 m²

6 m² 2300 m²

43 m²

43 m²

52 m²

440 m²

1627 m²

2120 m²

1238 m²

71 m²

599 m² 1908 m² 24797 m²

146 m² 215 m²

Cround	
Ground	

Ground	
AMENITIES	138 m²
вон	49 m²
FOH CIRCULATION	184 m²
FOH OTHER	639 m²
PRESENTATION SPACE	2192 m ²
RETAIL	802 m ²
	4004 m ²

Level 3

BOH

Level 3.1

Level 3.2 BOH

Level 4 AMENITIES

BOH

422 m²

715 m²

FOH OTHER

AMENITIES

FOH CIRCULATION

FOH CIRCULATION

FOH CIRCULATION

PRESENTATION SPACE

FOH OTHER

STAFF AREA

Level 4.1 BOH

Leve 5 вон

Level 6

BOH

EDUCATION

STAFF AREA

ACCOMMODATION

FOH CIRCULATION

PRESENTATION SPACE

Ground Mezz	
AMENITIES	183 m²
вон	51 m²
FOH CIRCULATION	86 m²
STAFF AREA	103 m ²

Ground Mezz 02	
вон	39 m²
	39 m²
Level 1	
BOH	352 m²
EDUCATION	294 m²
FOH CIRCULATION	463 m²
PRESENTATION SPACE	1224 m²
	2332 m ²

Level 1.1	
AMENITIES	82 m²
вон	154 m²
EDUCATION	292 m²
FOH CIRCULATION	187 m²

Level 1.2	
BOH	87 m²
EDUCATION	292 m²
	379 m²
Level 2	
AMENITIES	77 m²
вон	377 m²
FOH CIRCULATION	1123 m ²
PRESENTATION SPACE	3246 m ²
	4822 m ²
Level 2.1	
FRUGATION	4.402

EDUCATION	146 m²
FOH CIRCULATION	68 m²
	213 m ²

Level 2.2	
AMENITIES	54 m²
BOH	133 m²
EDUCATION	263 m ²
FOH CIRCULATION	70 m ²

The definition of Gross Floor Area is set out in Parramatta LEP 2011 as:

Gross Floor Area means the sum of the floor area of each floor of a building measured from the internal face of external walls, or from the internal face of walls separating the building from any other building, measured at a height of 1.4 metres above the floor, and includes—
(a) the area of a mezzanine, and
(b) habitable rooms in a basement or an attic, and
(c) any shop, auditorium, cinema, and the like, in a basement or attic, but excludes—

but excludes-

but excludes—
(d) any area for common vertical circulation, such as lifts and stairs, and
(e) any basement—
(i) storage, and
(ii) verticular access, loading areas, garbage and services, and
(f) plant rooms, lift towers and other areas used exclusively for mechanical
services or ducting, and
(g) car parking to meet any requirements of the consent authority (including
access to that car parking), and
(h) any space used for the loading or unloading of goods (including access
to it), and
(i) terraces and balconies with outer walls less than 1.4 metres hich, and

(i) terraces and balconies with outer walls less than 1.4 metres high, and
 (j) voids above a floor at the level of a storey or storey above.

The definition of Floor Space Ratio is set out in Parramatta LEP 2011 as:

(2) The floor space ratio of buildings on a site is the ratio of the gross floor area of all buildings within the site to the site area.

The definition of Site Area is set out in Parramatta LEP 2011 as:

(3) In determining the site area of proposed development for the purpose of applying a floor space ratio, the site area is taken to be— (a) if the proposed development is to be carried out on only one lot, the area of that lot, or (b) if the proposed development is to be carried out on 2 or more lots, the area dary lot on which the development is proposed to be carried out that has at least one common boundary with another lot on which the development is being carried out.

In addition, subclauses (4)-(7) apply to the calculation of site area for the purposes of applying a floor space ratio to proposed development.

In addition, subclauses (4)–(7) apply to the calculation of site area for the purposes of applying a floor space ratio to proposed development.
(4) Exclusions from site area The following land must be excluded from the site area—

(a) land on which the proposed development is prohibited, whether under this Plan or any other law,
(b) community land or a public place (except as provided by subclause (7)).
(c) Strats audivisions The area of a lot that is wholly or partly on top of another or others in a strata subdivision is to be included in the calculation of the site area only to the extent that it does not overlap with another lot already included in the site area calculation.
(c) Ony significant development to be included The site area for proposed development must not include a lot additional to a lot or lots on which the development is being carried out unless the proposed development includes significant development on that additional lot.
(7) Certain public land to be separately considered For the purpose of applying a floor space ratio to my proposed development, and on a near that is on, above or below that community land or rabilic place, the site area must not include any other area on which the proposed development, and may not include any other area on which the proposed development is to be carried out.

ARCHITECTS

MOREAU KUSUNOKI

GENTON 5 RUE DE NEMOURS 75011 PARIS FRANCE 71 YORK ST SYDNEY NSW 2000 AUSTRALIA

POWERHOUSE PARRAMATTA

PROJECT

GFA SCHEDULE SUMMARY

TITLE

DATE

NUMBER

REVISION

17/11/2021

DA504