PROJECT: EVENT CARPARK WORKS

PLANSET: CONCEPT ENGINEERING WORK

NEWCASTLE LEGAL AND CONVEYANCING



LOCALITY PLAN

NOT TO SCALE

# LGA: BLACKTOWN CITY COUNCIL

A1 / A3 LANDSCAPE (A1LC\_v02.0.01)

50 PETER BROCK DRIVE, EASTERN CREEK, NSW 2766 LOT 4 DP 1079897

V	DESCRIPTION	DATE	DRAWN	DESIGNED	CHECKED	APPRVD	GRID	DAT	TUM	PROJECT MANAGER	R
В	UPDATED TO ADDRESS DPIE RFI 13.05.21	30/07/2021	JS	AW/MD	GH	DM	N/A	N/A	,	GH	
Α	DPIE RFI 22.12.2020	29/03/2021	JS	AW/AVG	GH	DM	IN/ A	117 /	A	un	
							DISCLAIME	1ER & COPY	YRIGHT		
							This plan must principal certifyi			n unless signed as approved by	l by
				1			1 ' '			nerwise specified.	
										hole or part without prior written	ten
							consent of Mart		•		
			l	1	I	I	(C) Copyrigh	ignt iviartens	& Associate	es Ptv Lta	

Consulting Engineers

Environment
Water

& Associates Pty Ltd

Suite 201, 20 George St, Hornsby, NSW 2077 Australia Phone: (02) 9476 9999 Fax: (02) 9476 8767

Email: mail@martens.com.au Internet: www.martens.com.au


DEVELOPMENT APPLICATION


DRAWING TITLE


COVER SHEET


PROJECT NO. PLANSET NO. RELEASE NO. DRAWING NO. REVISION
P2108122 PS01 R03 PS01-A000 B


DWG NO.	REV	DWG TITLE
GENERAL		
PS01-A000	В	COVER SHEET
PS01-A050	В	DEVELOPMENT OVERVIEW PLAN
CONSTRU	<b>JCTION</b>	N MANAGEMENT WORKS
PS01-B300	Α	TREE REMOVAL PLAN
EARTHW	ORKS	
PS01-C100	В	EARTHWORKS GRADING PLAN
PS01-C600	В	EARTHWORKS SITE SECTIONS - SHEET 1
PS01-C601	В	EARTHWORKS SITE SECTIONS - SHEET 2
DRAINAG	Ε	
PS01-E100	В	DRAINAGE PLAN
PS01-E200	В	DRAINAGE DETAILS - SHEET 1
PS01-E201	В	DRAINAGE DETAILS - SHEET 2
PS01-E202	В	DRAINAGE DETAILS - SHEET 3
PS01-E300	В	LONGITUDINAL SECTION - SHEET 1
PS01-E301	В	LONGITUDINAL SECTION - SHEET 2
PS01-E302	В	LONGITUDINAL SECTION - SHEET 3
PS01-E600	В	ON SITE DETENTION CATCHMENT PLAN - MODELS & RESULTS
PS01-E700	В	WATER QUALITY CATCHMENT PLAN - MODELS & RESULTS
FINAL CIV	/IL W	DRKS
PS01-G300	В	CARPARK LAYOUT PLAN
PS01-GZ00	В	CARPARK SWEPT PATH PLAN - SHEET 1 - B99 VEHICLE & TRAILER CIRCULATION
PS01-GZ01	В	CARPARK SWEPT PATH PLAN - SHEET 2 - B99 VEHICLE & TRAILER PARKING
PS01-GZ02	В	CARPARK SWEPT PATH PLAN - SHEET 3 - HRV CIRCULATION

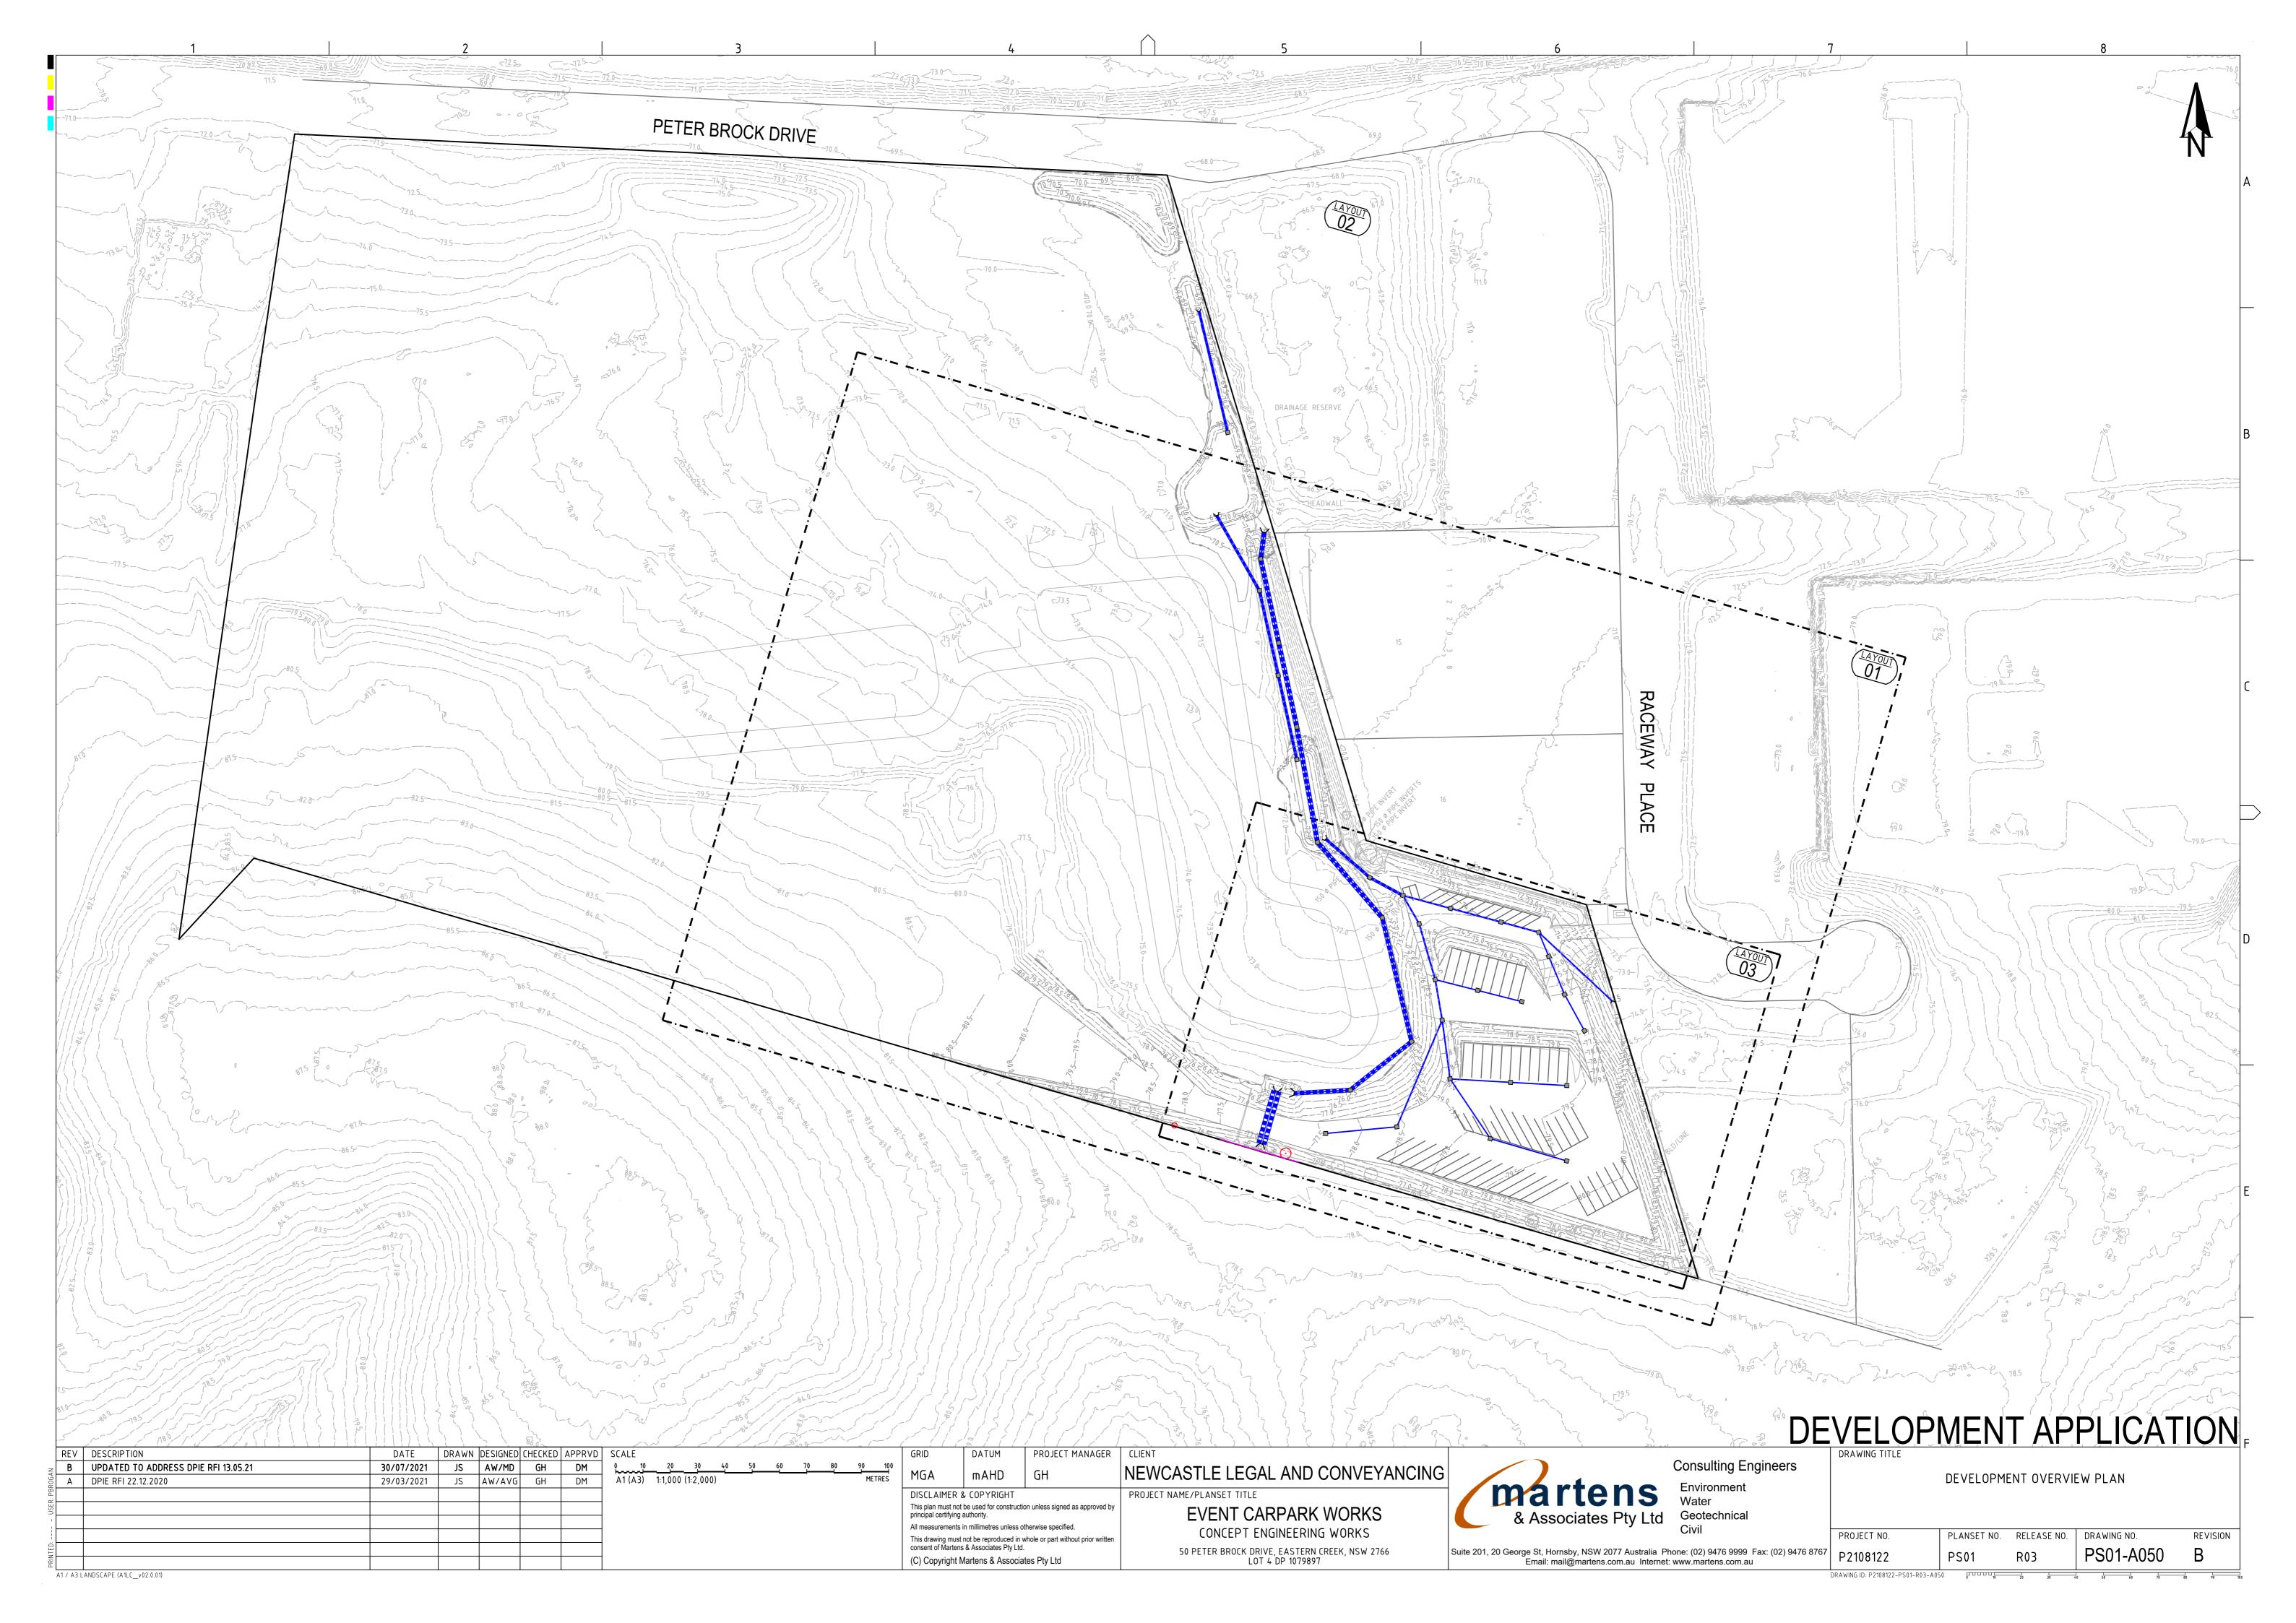


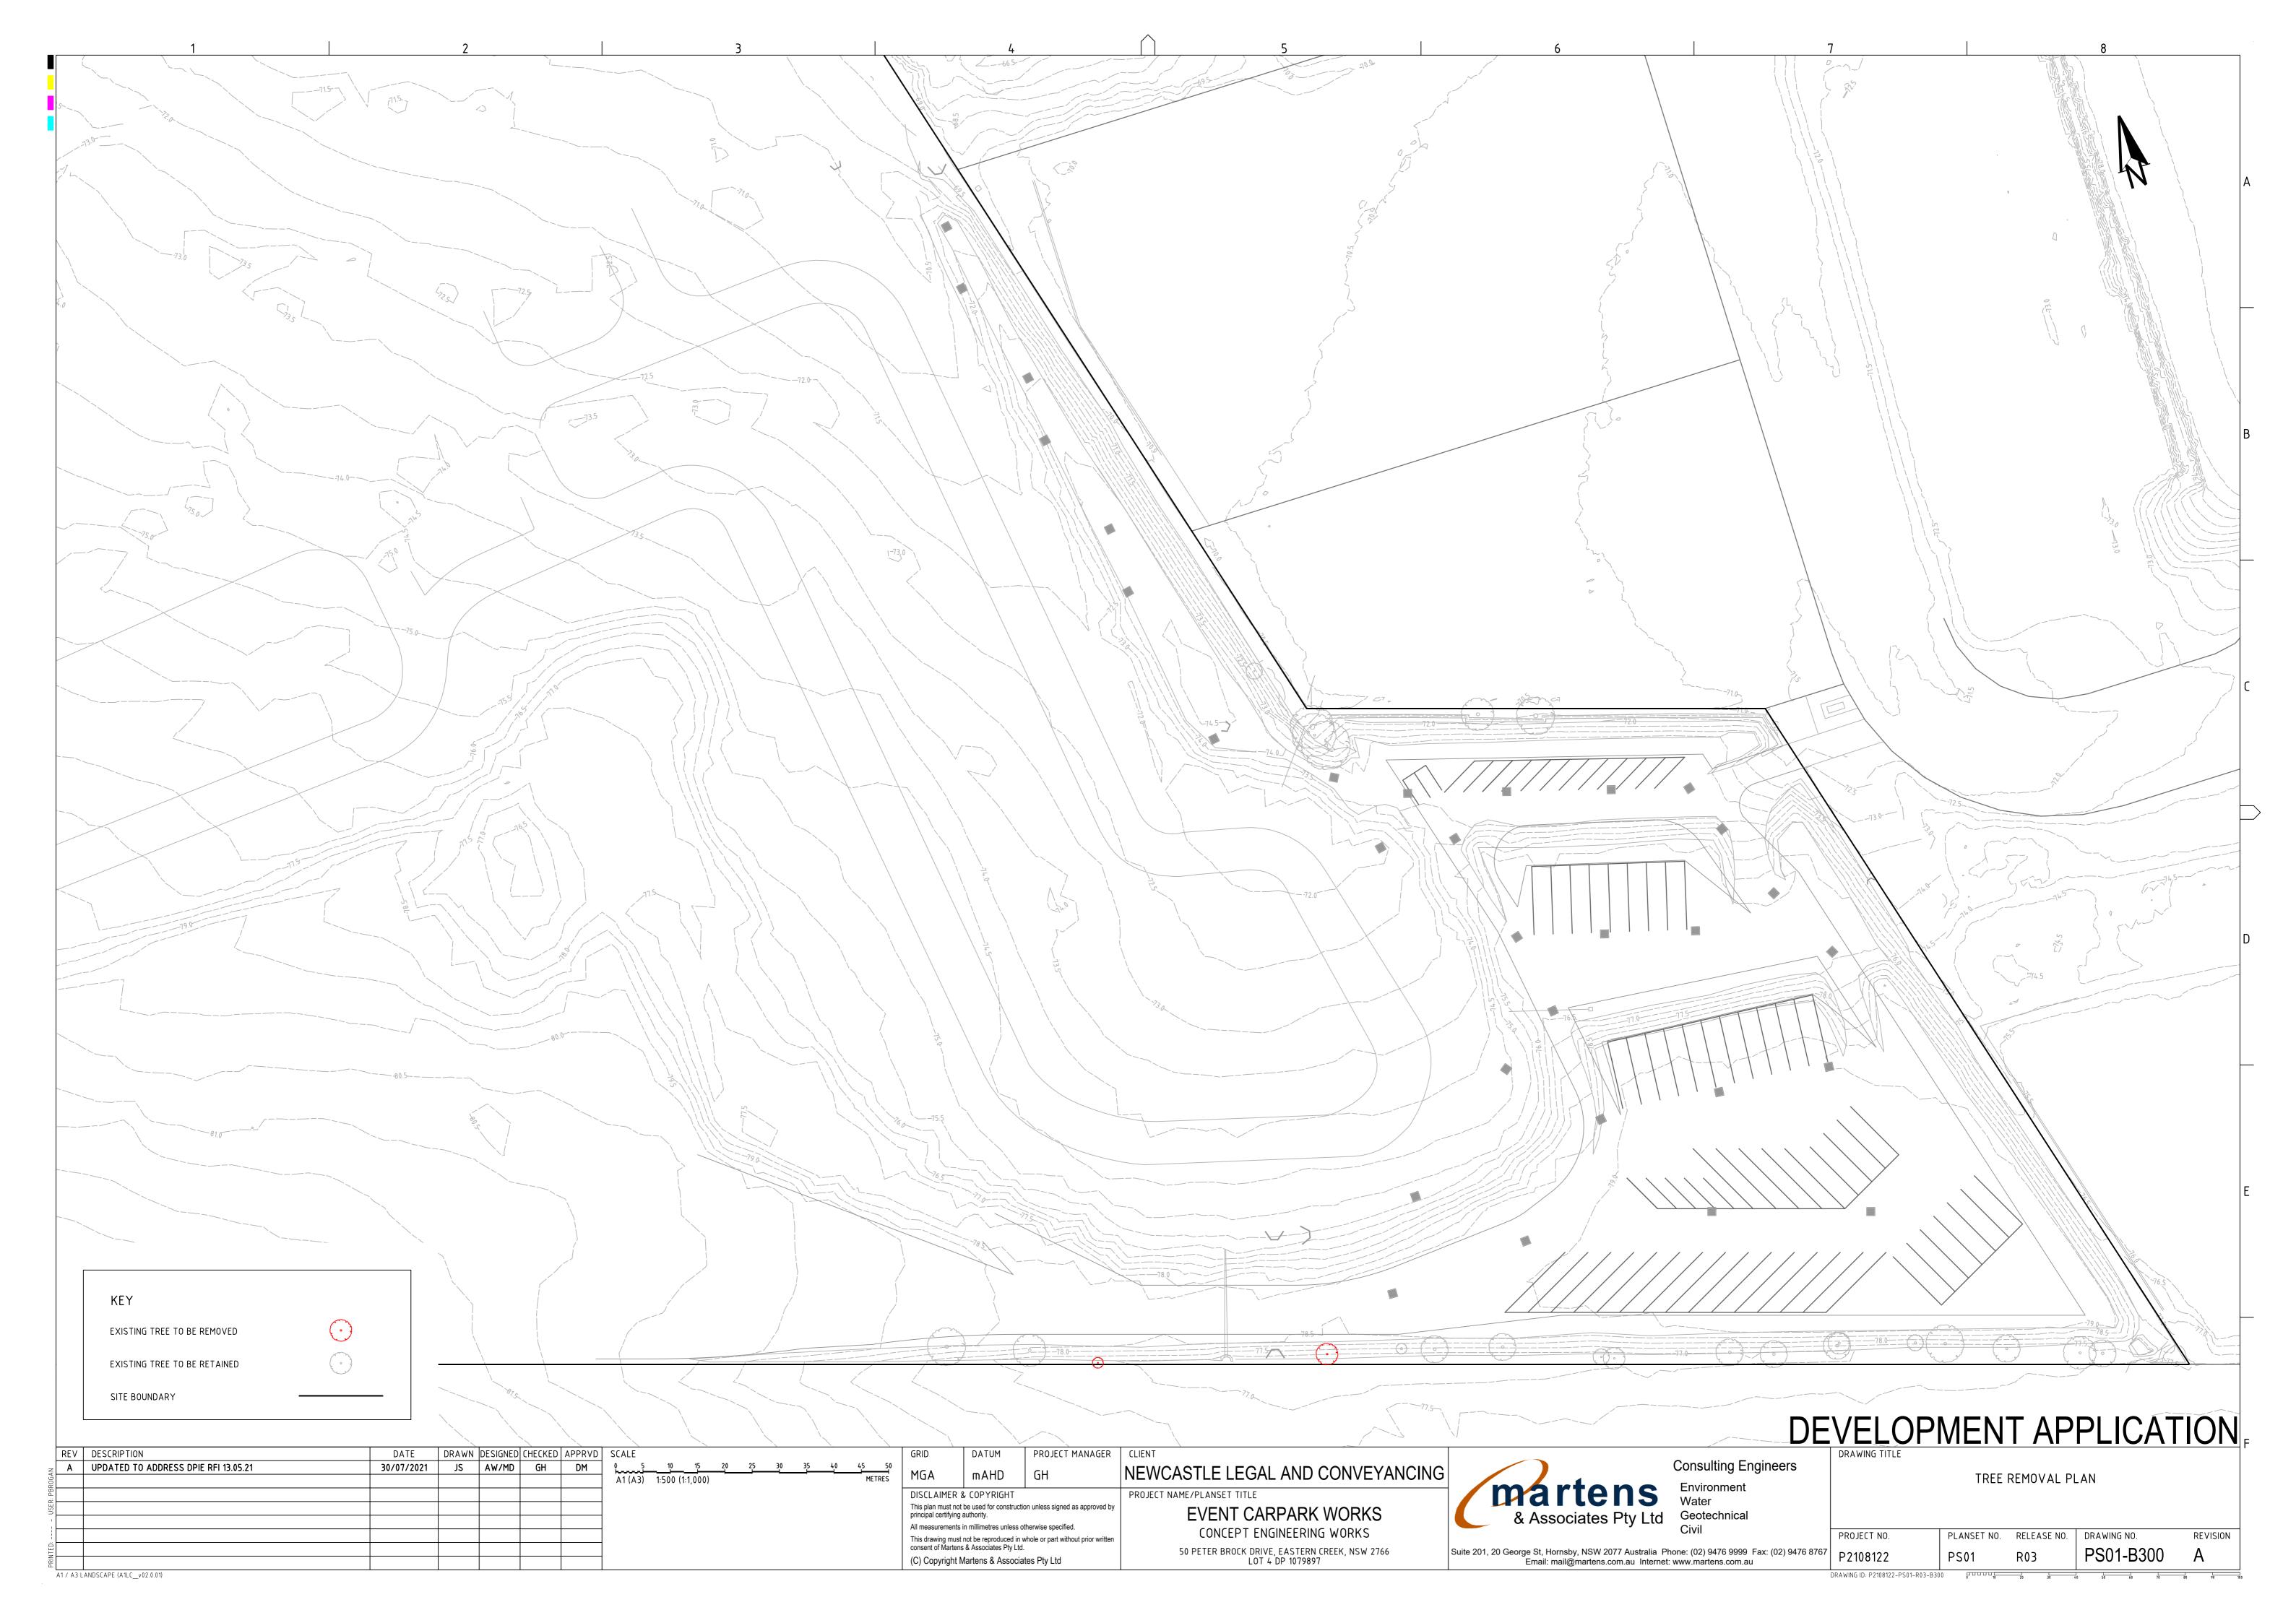


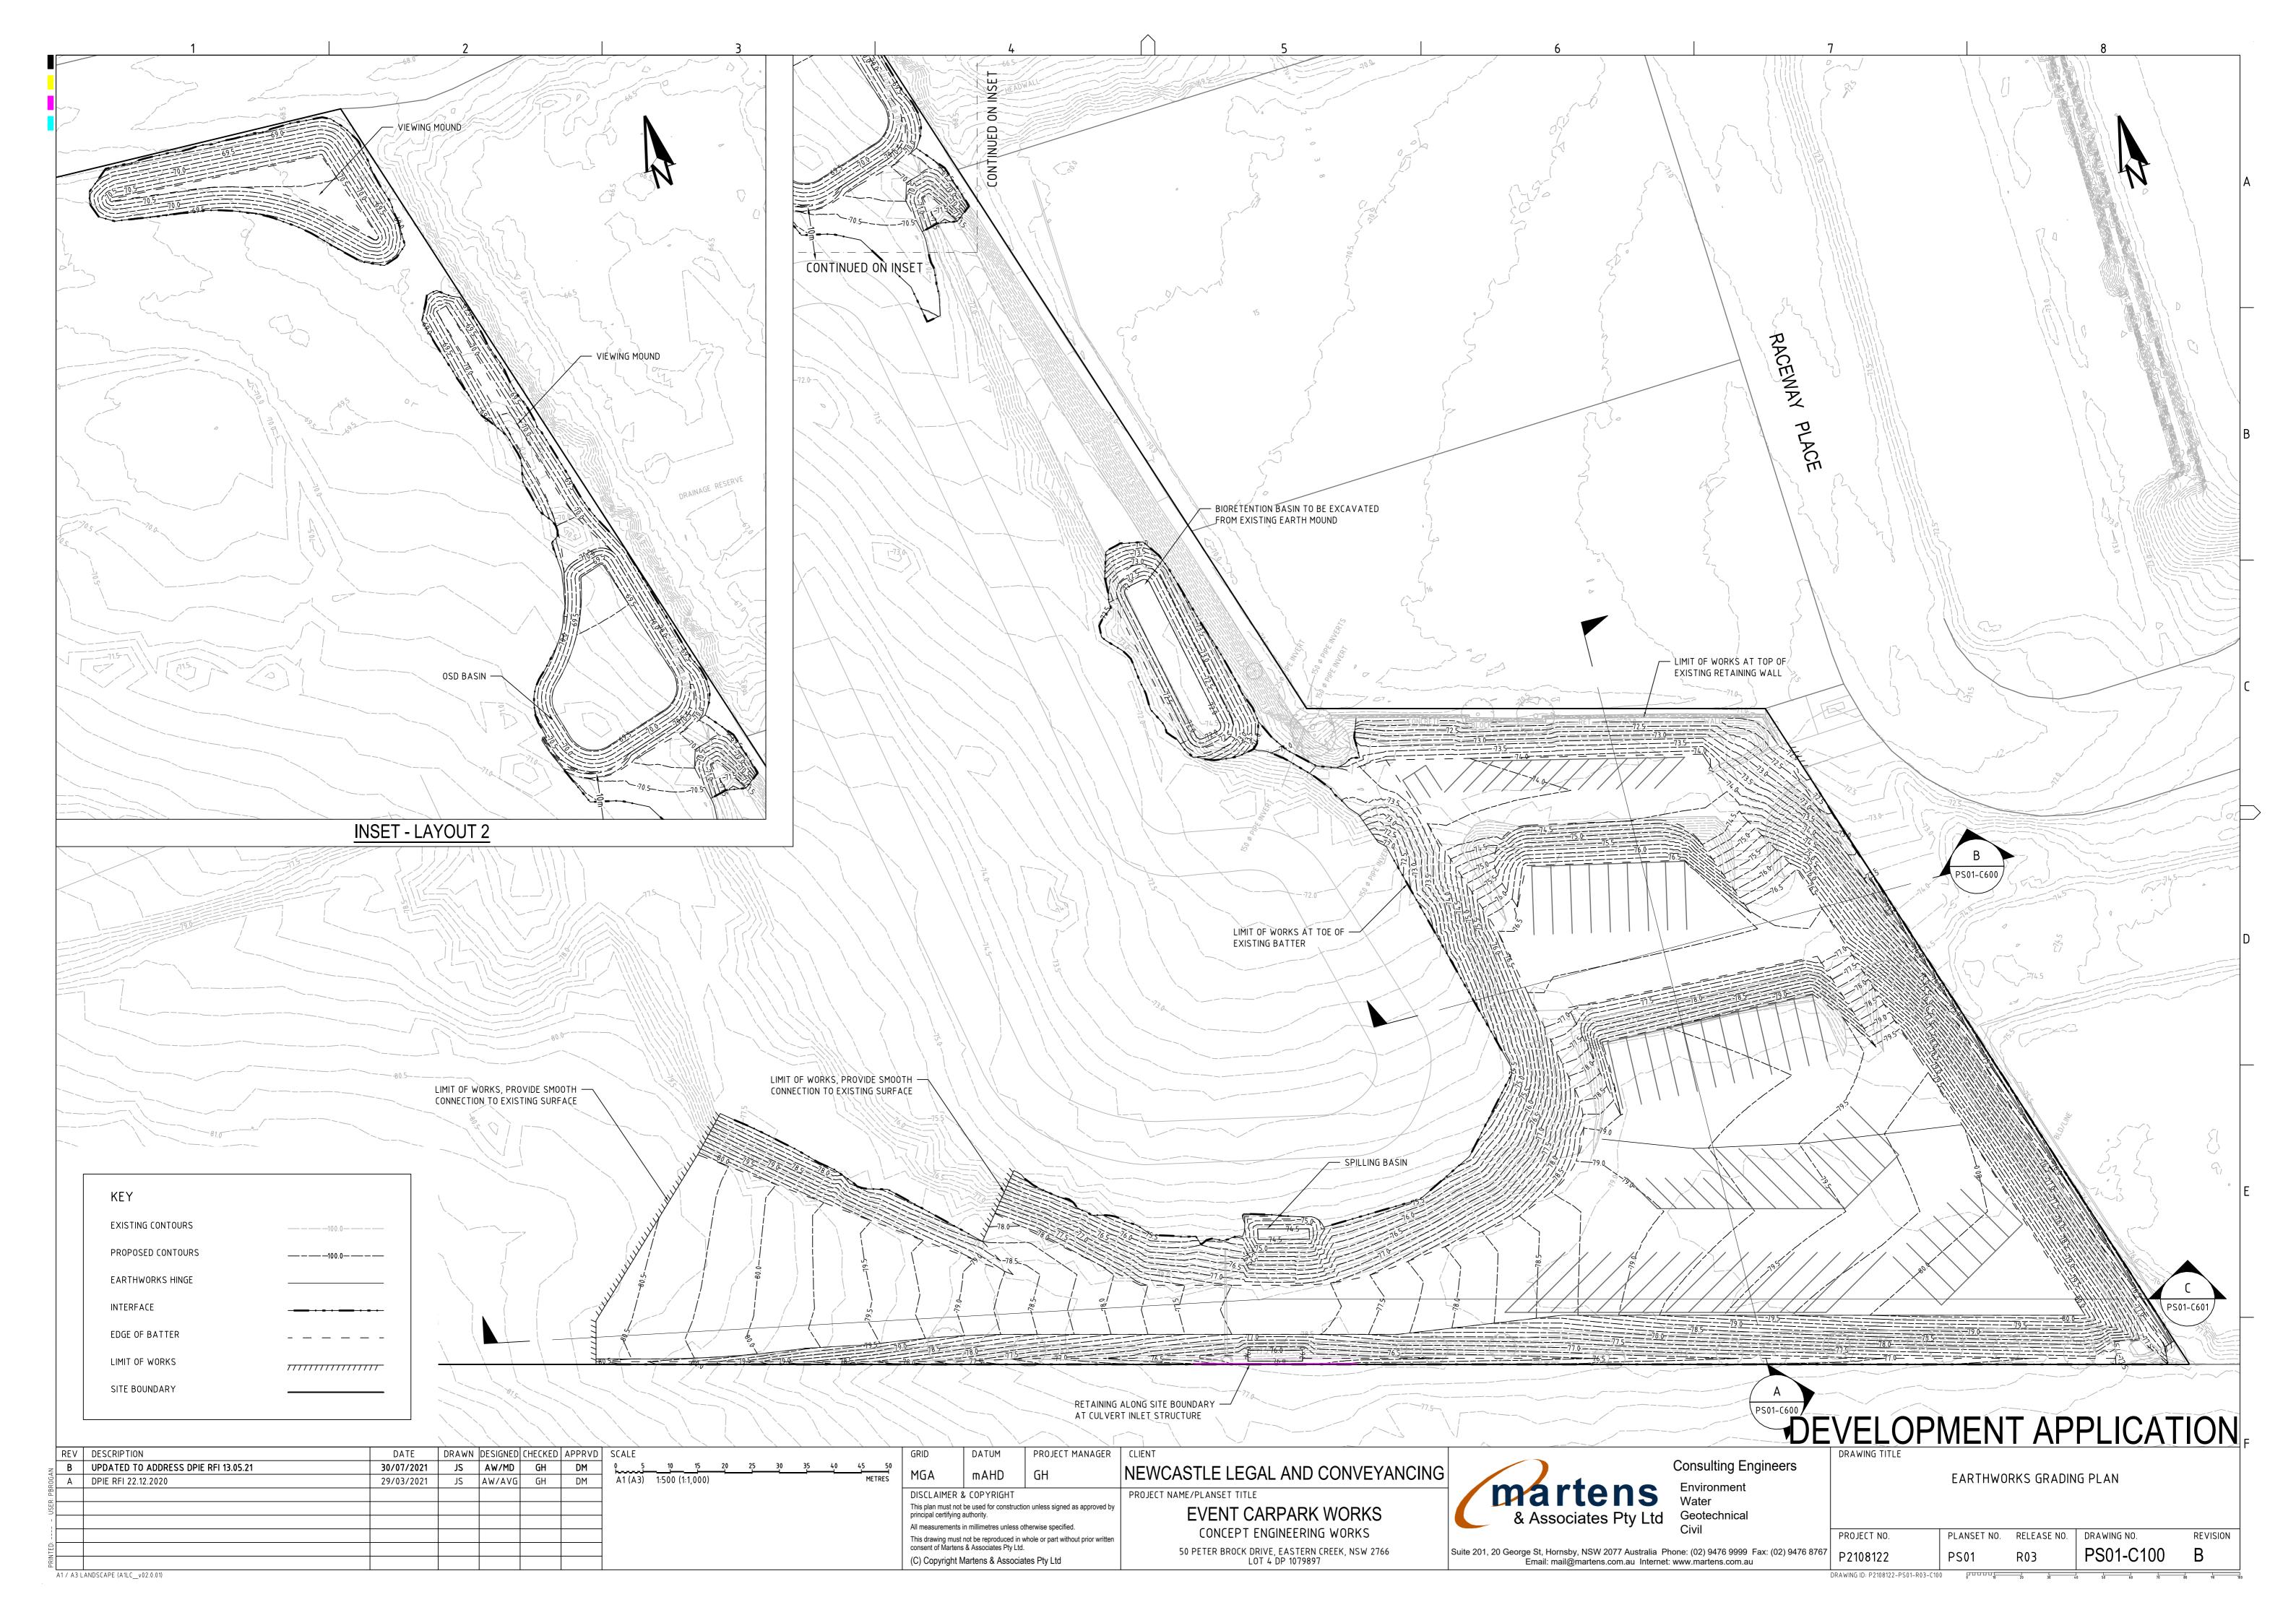


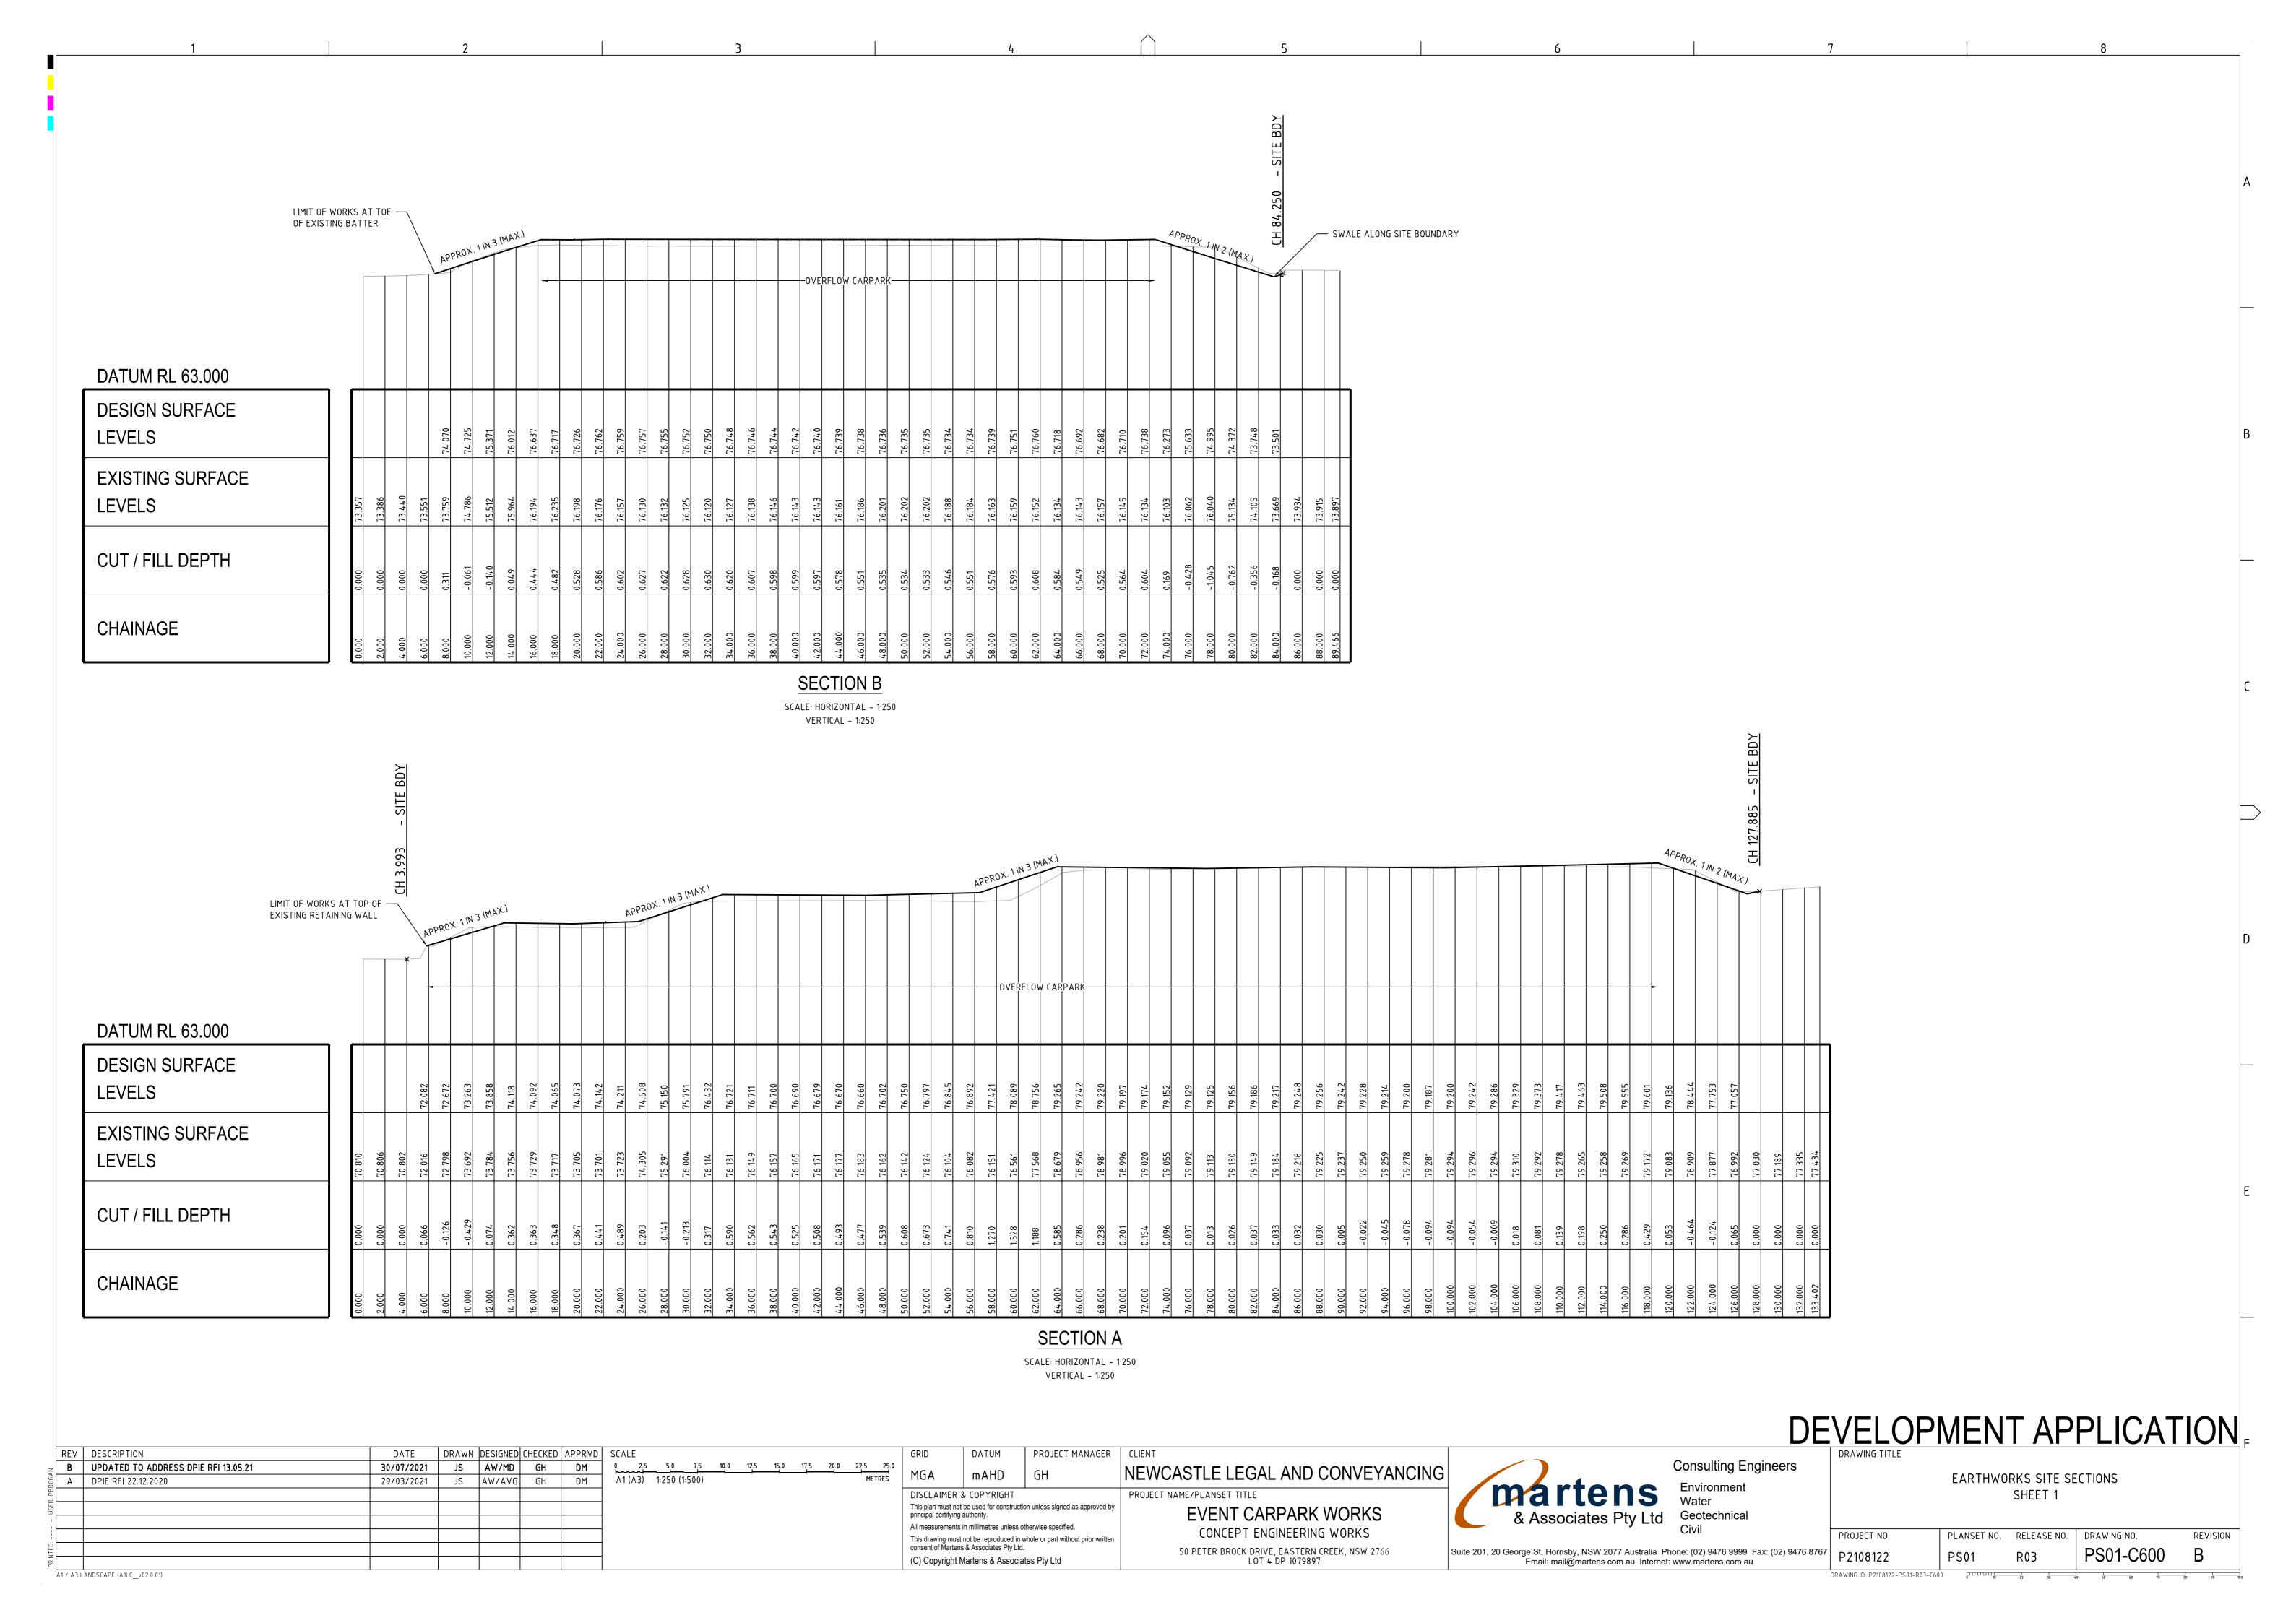


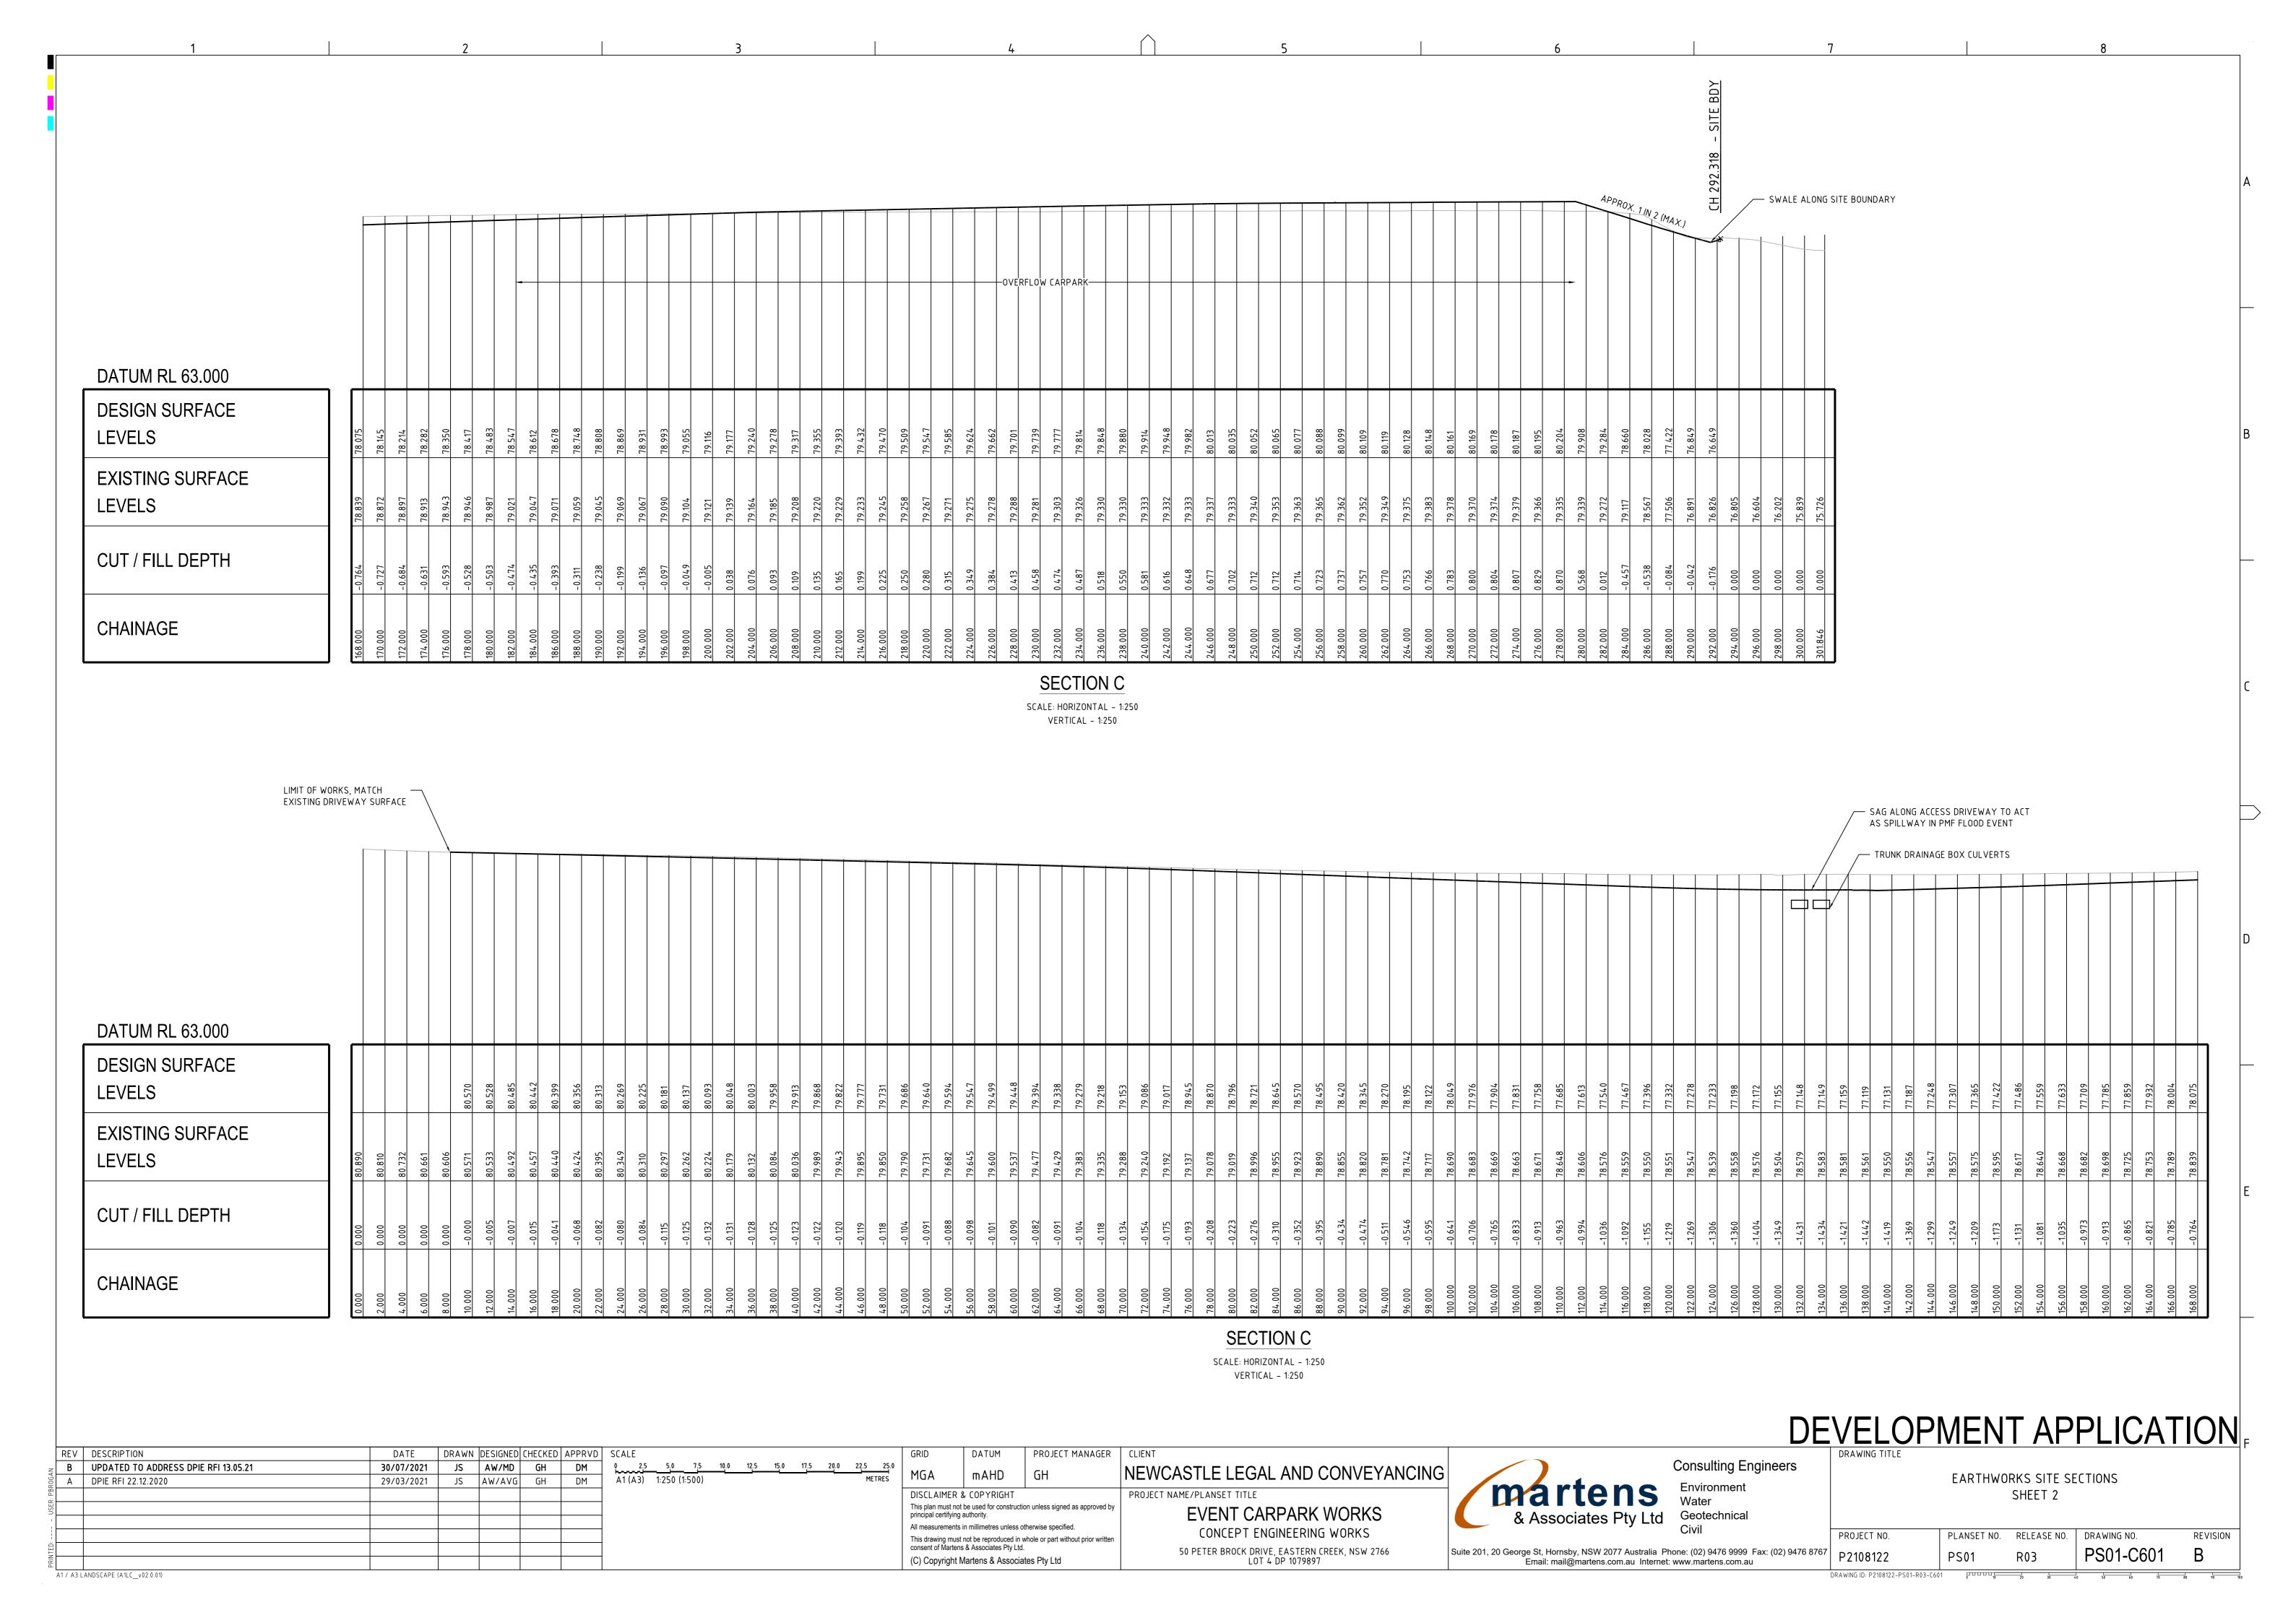

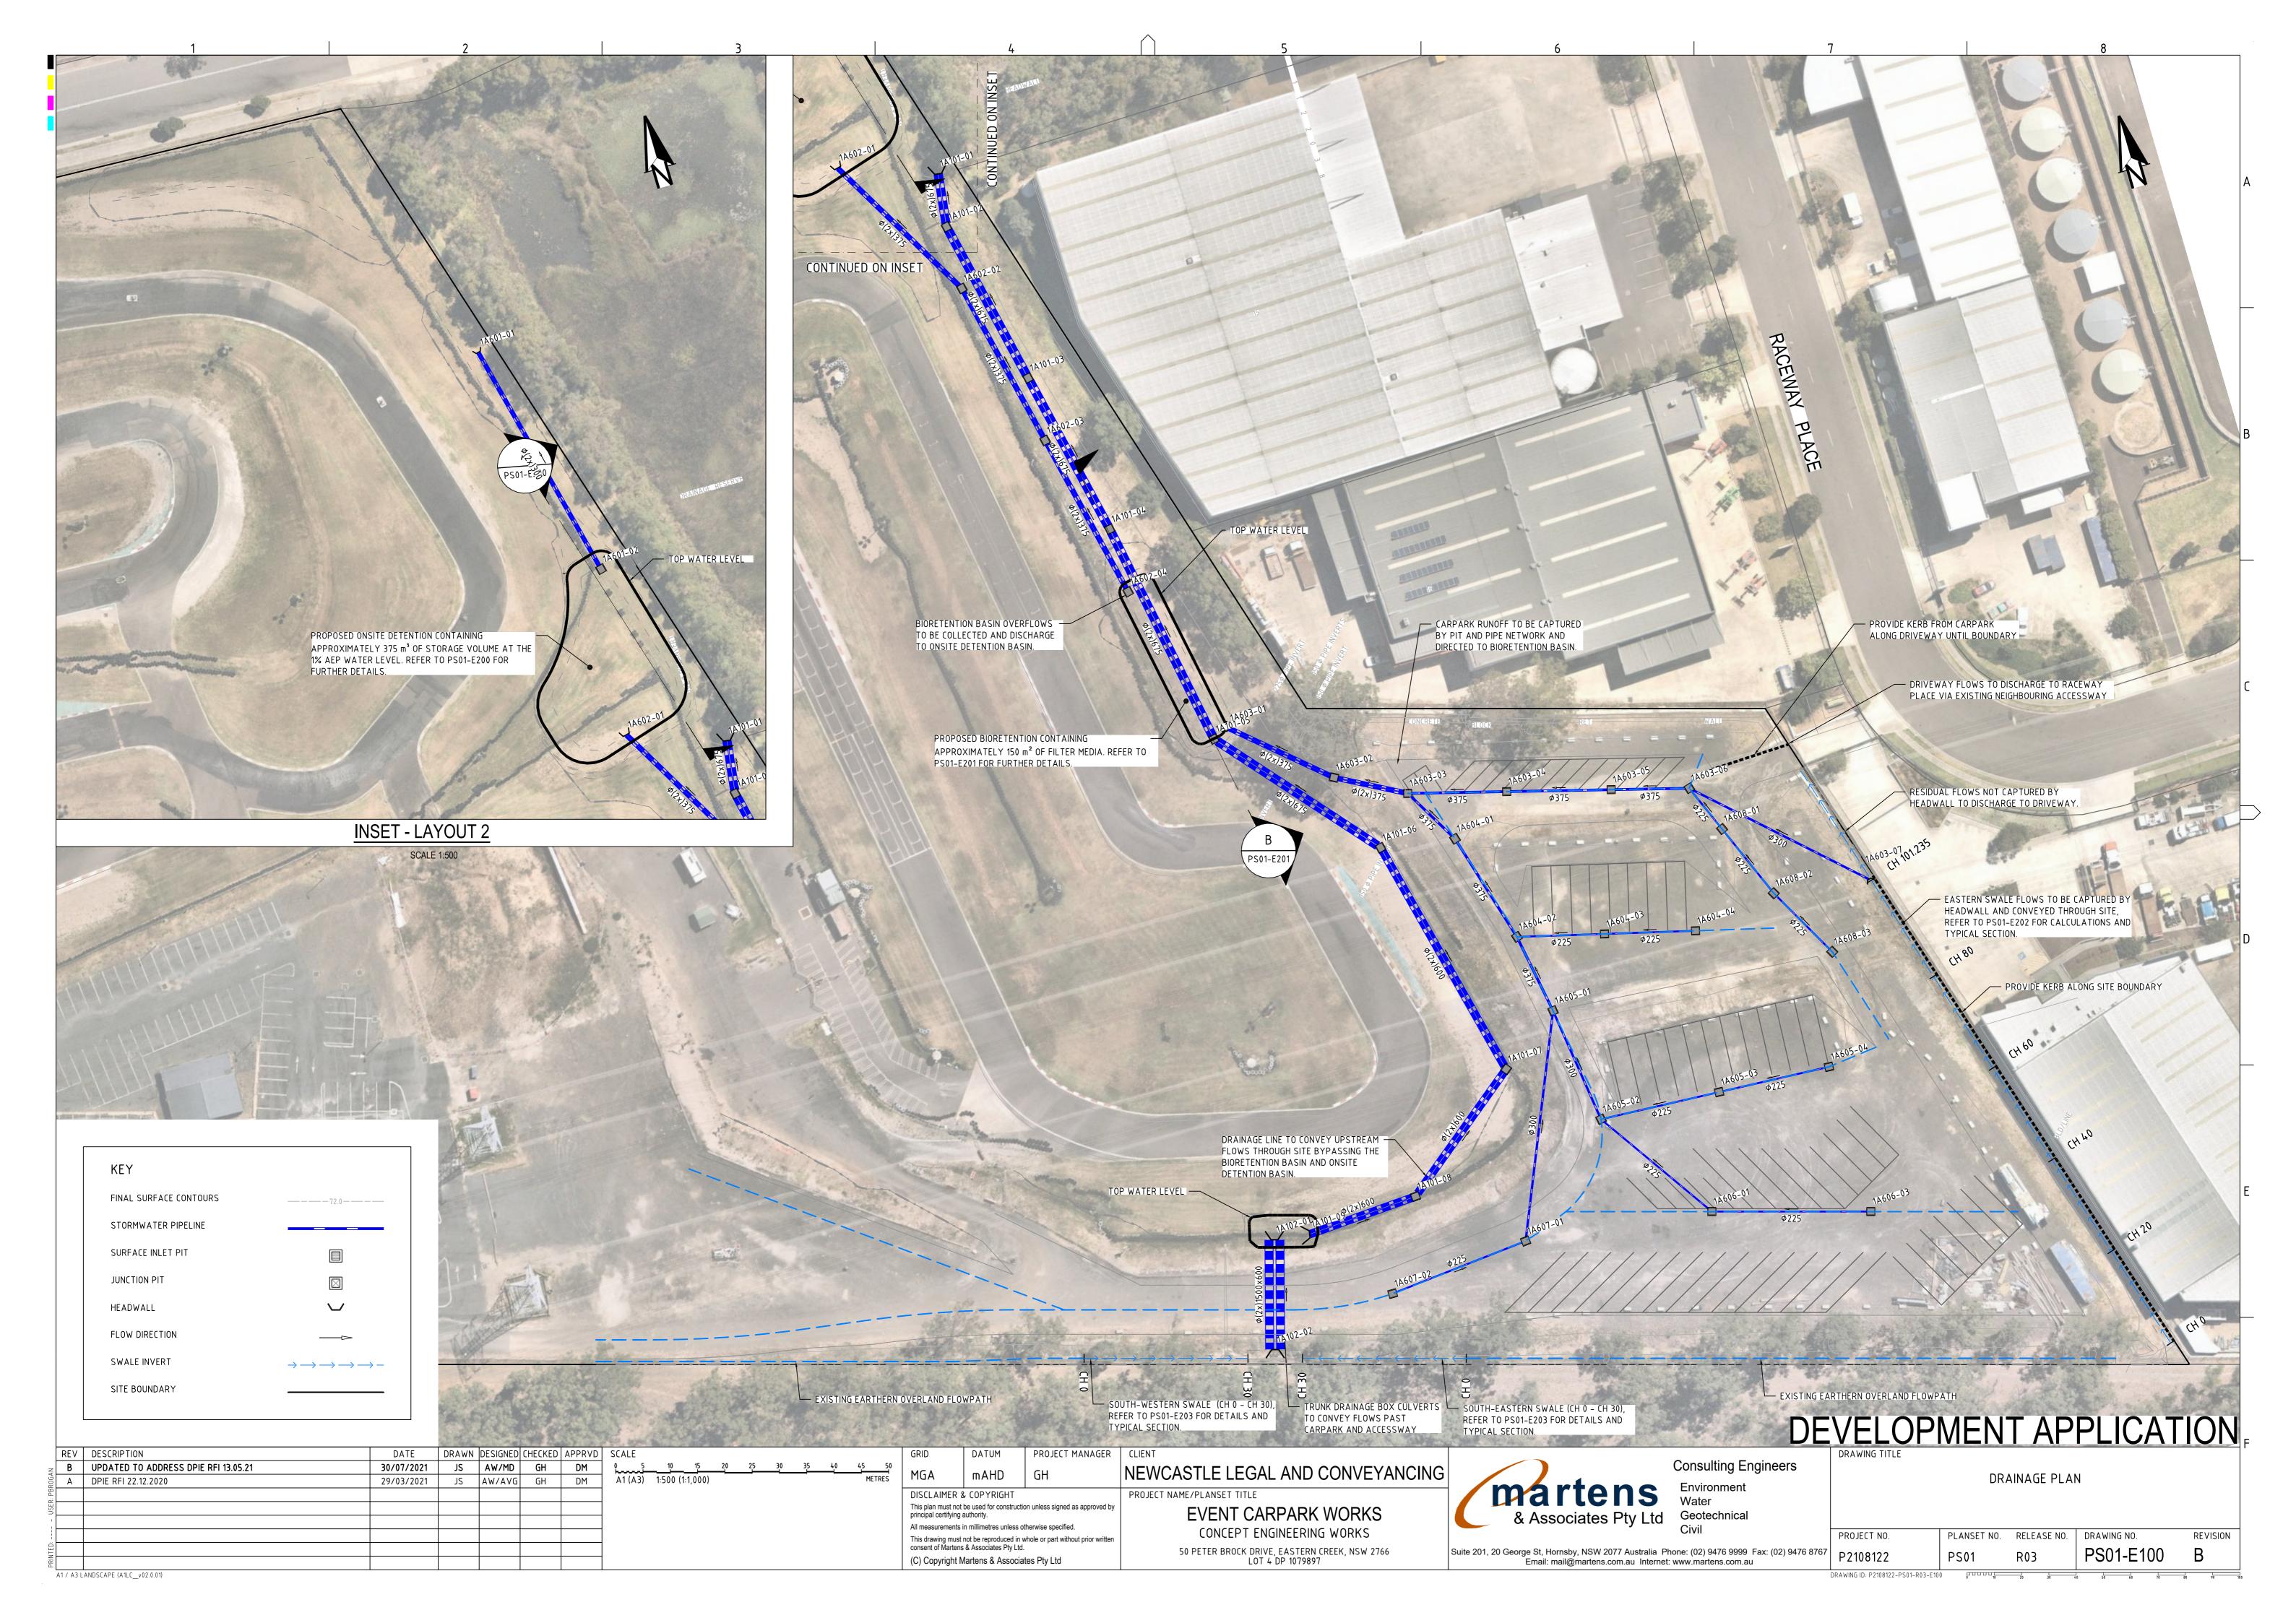

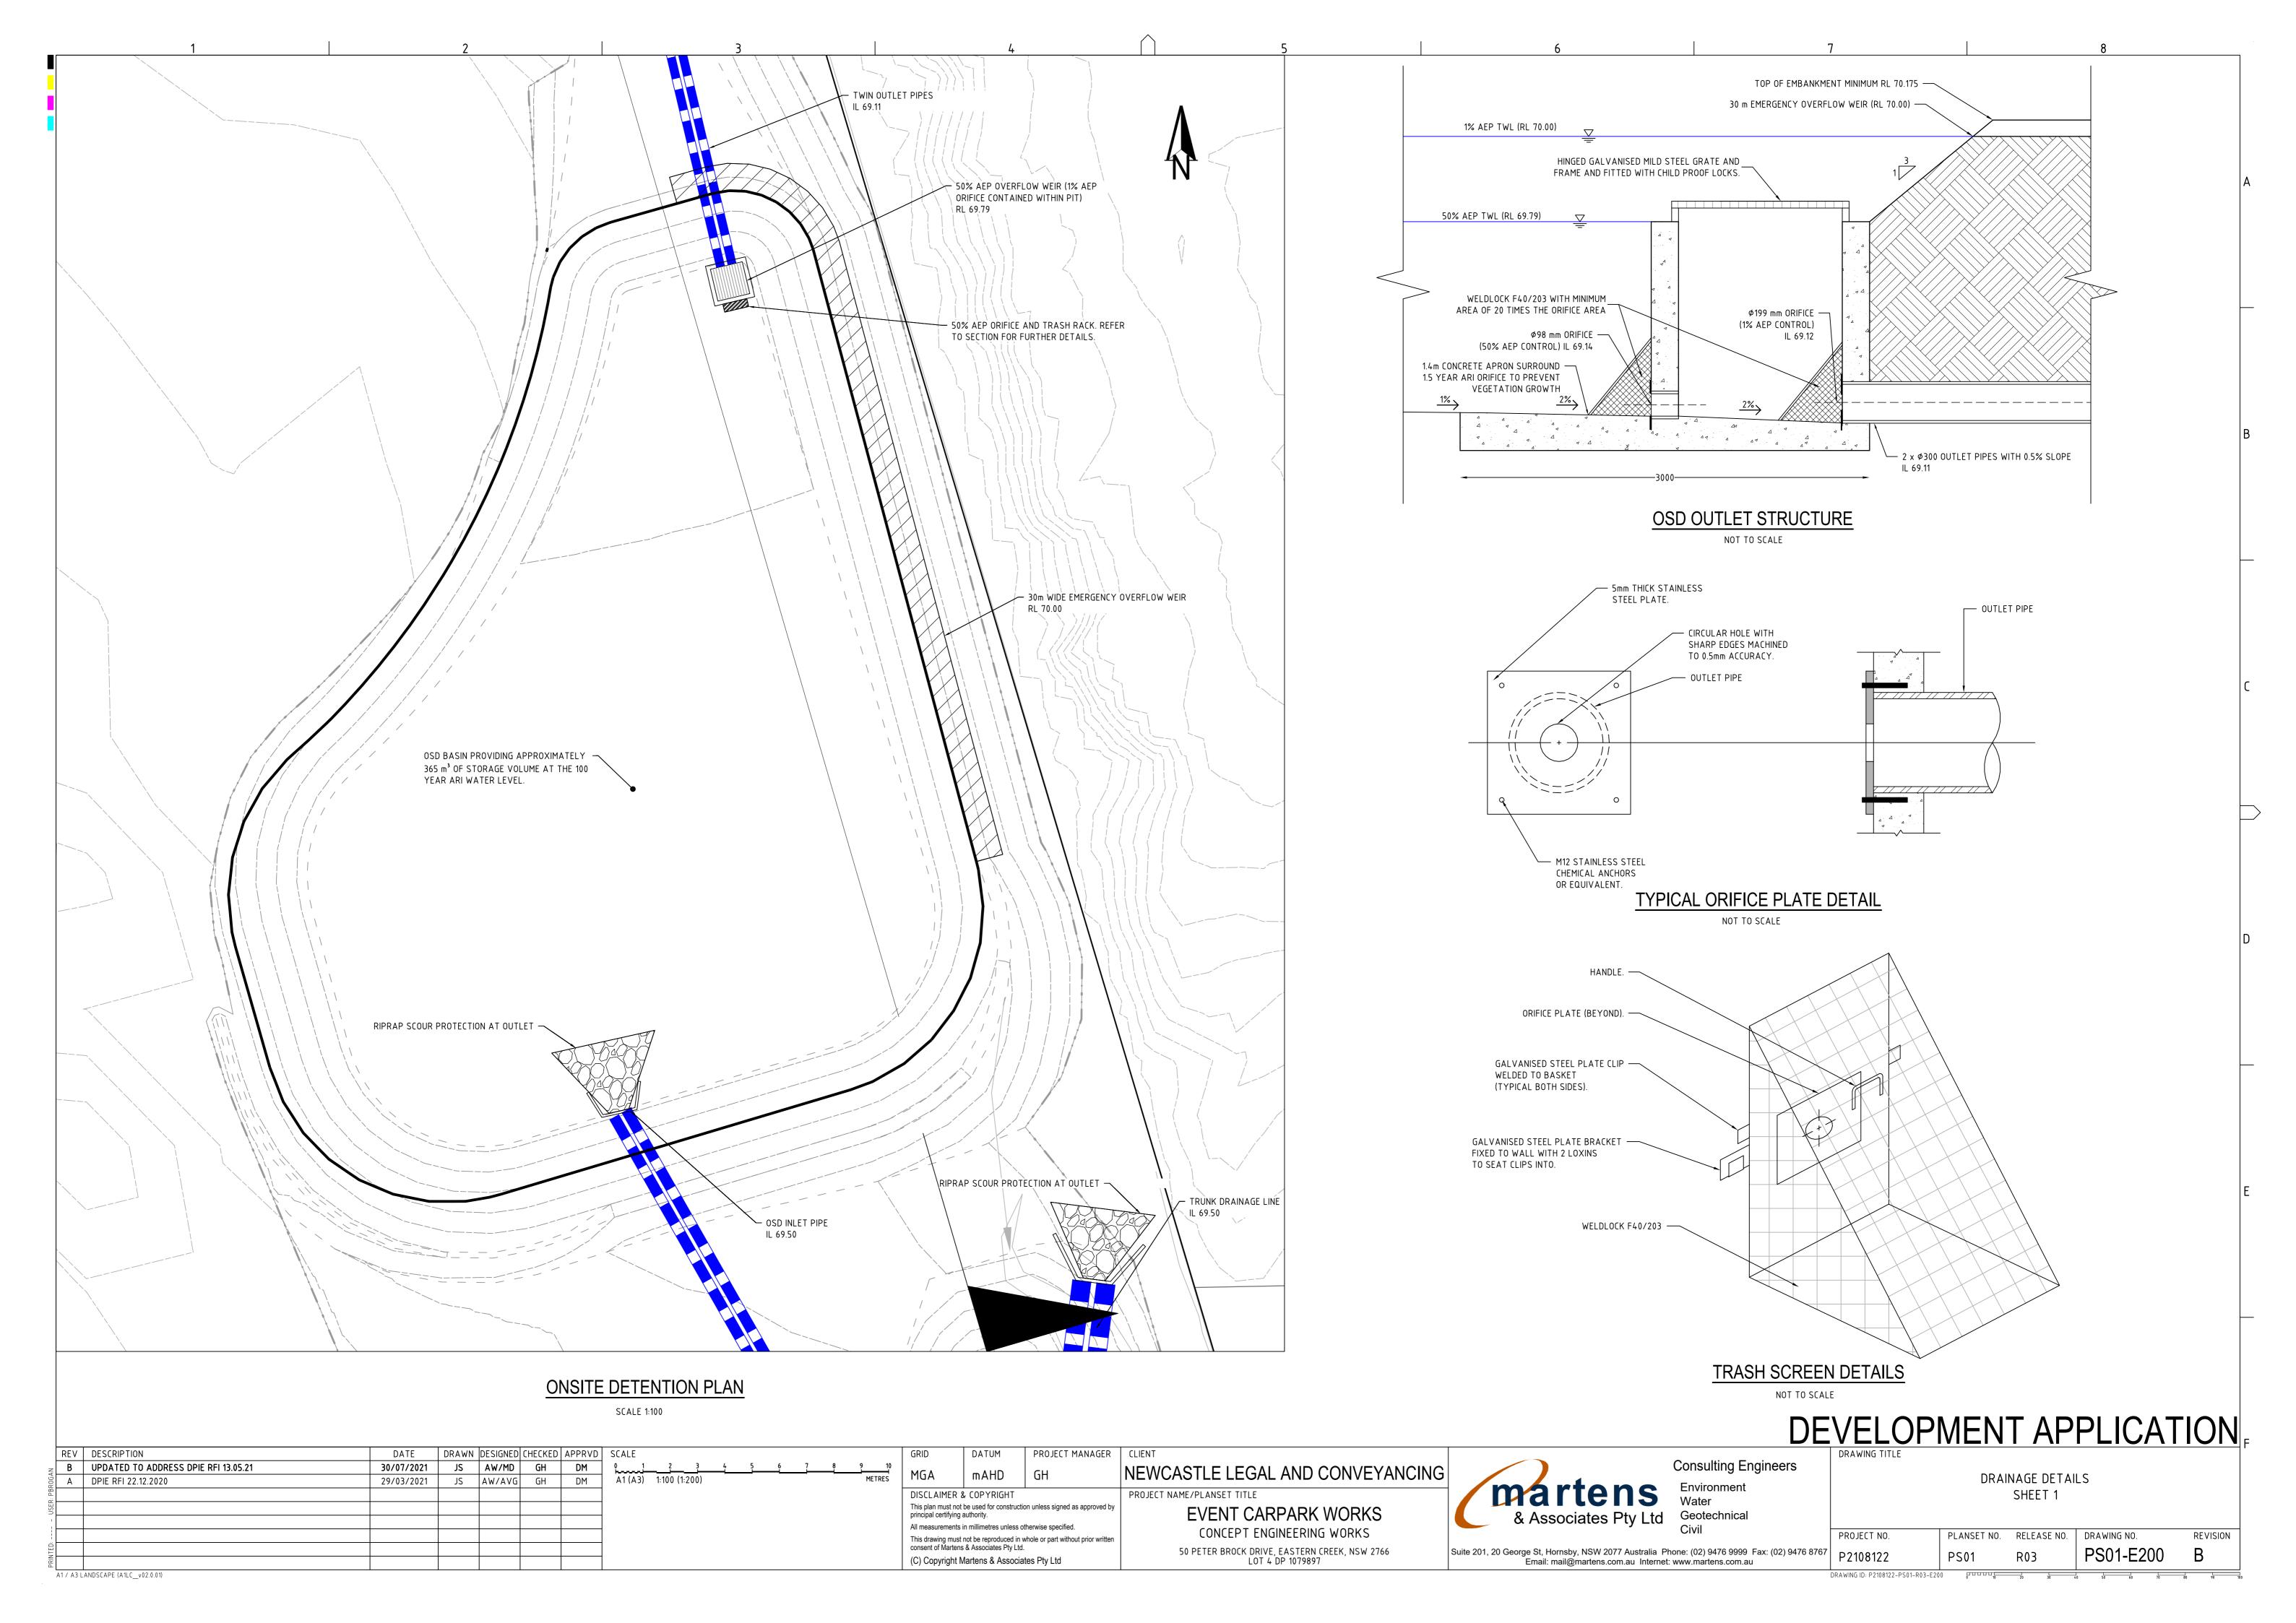

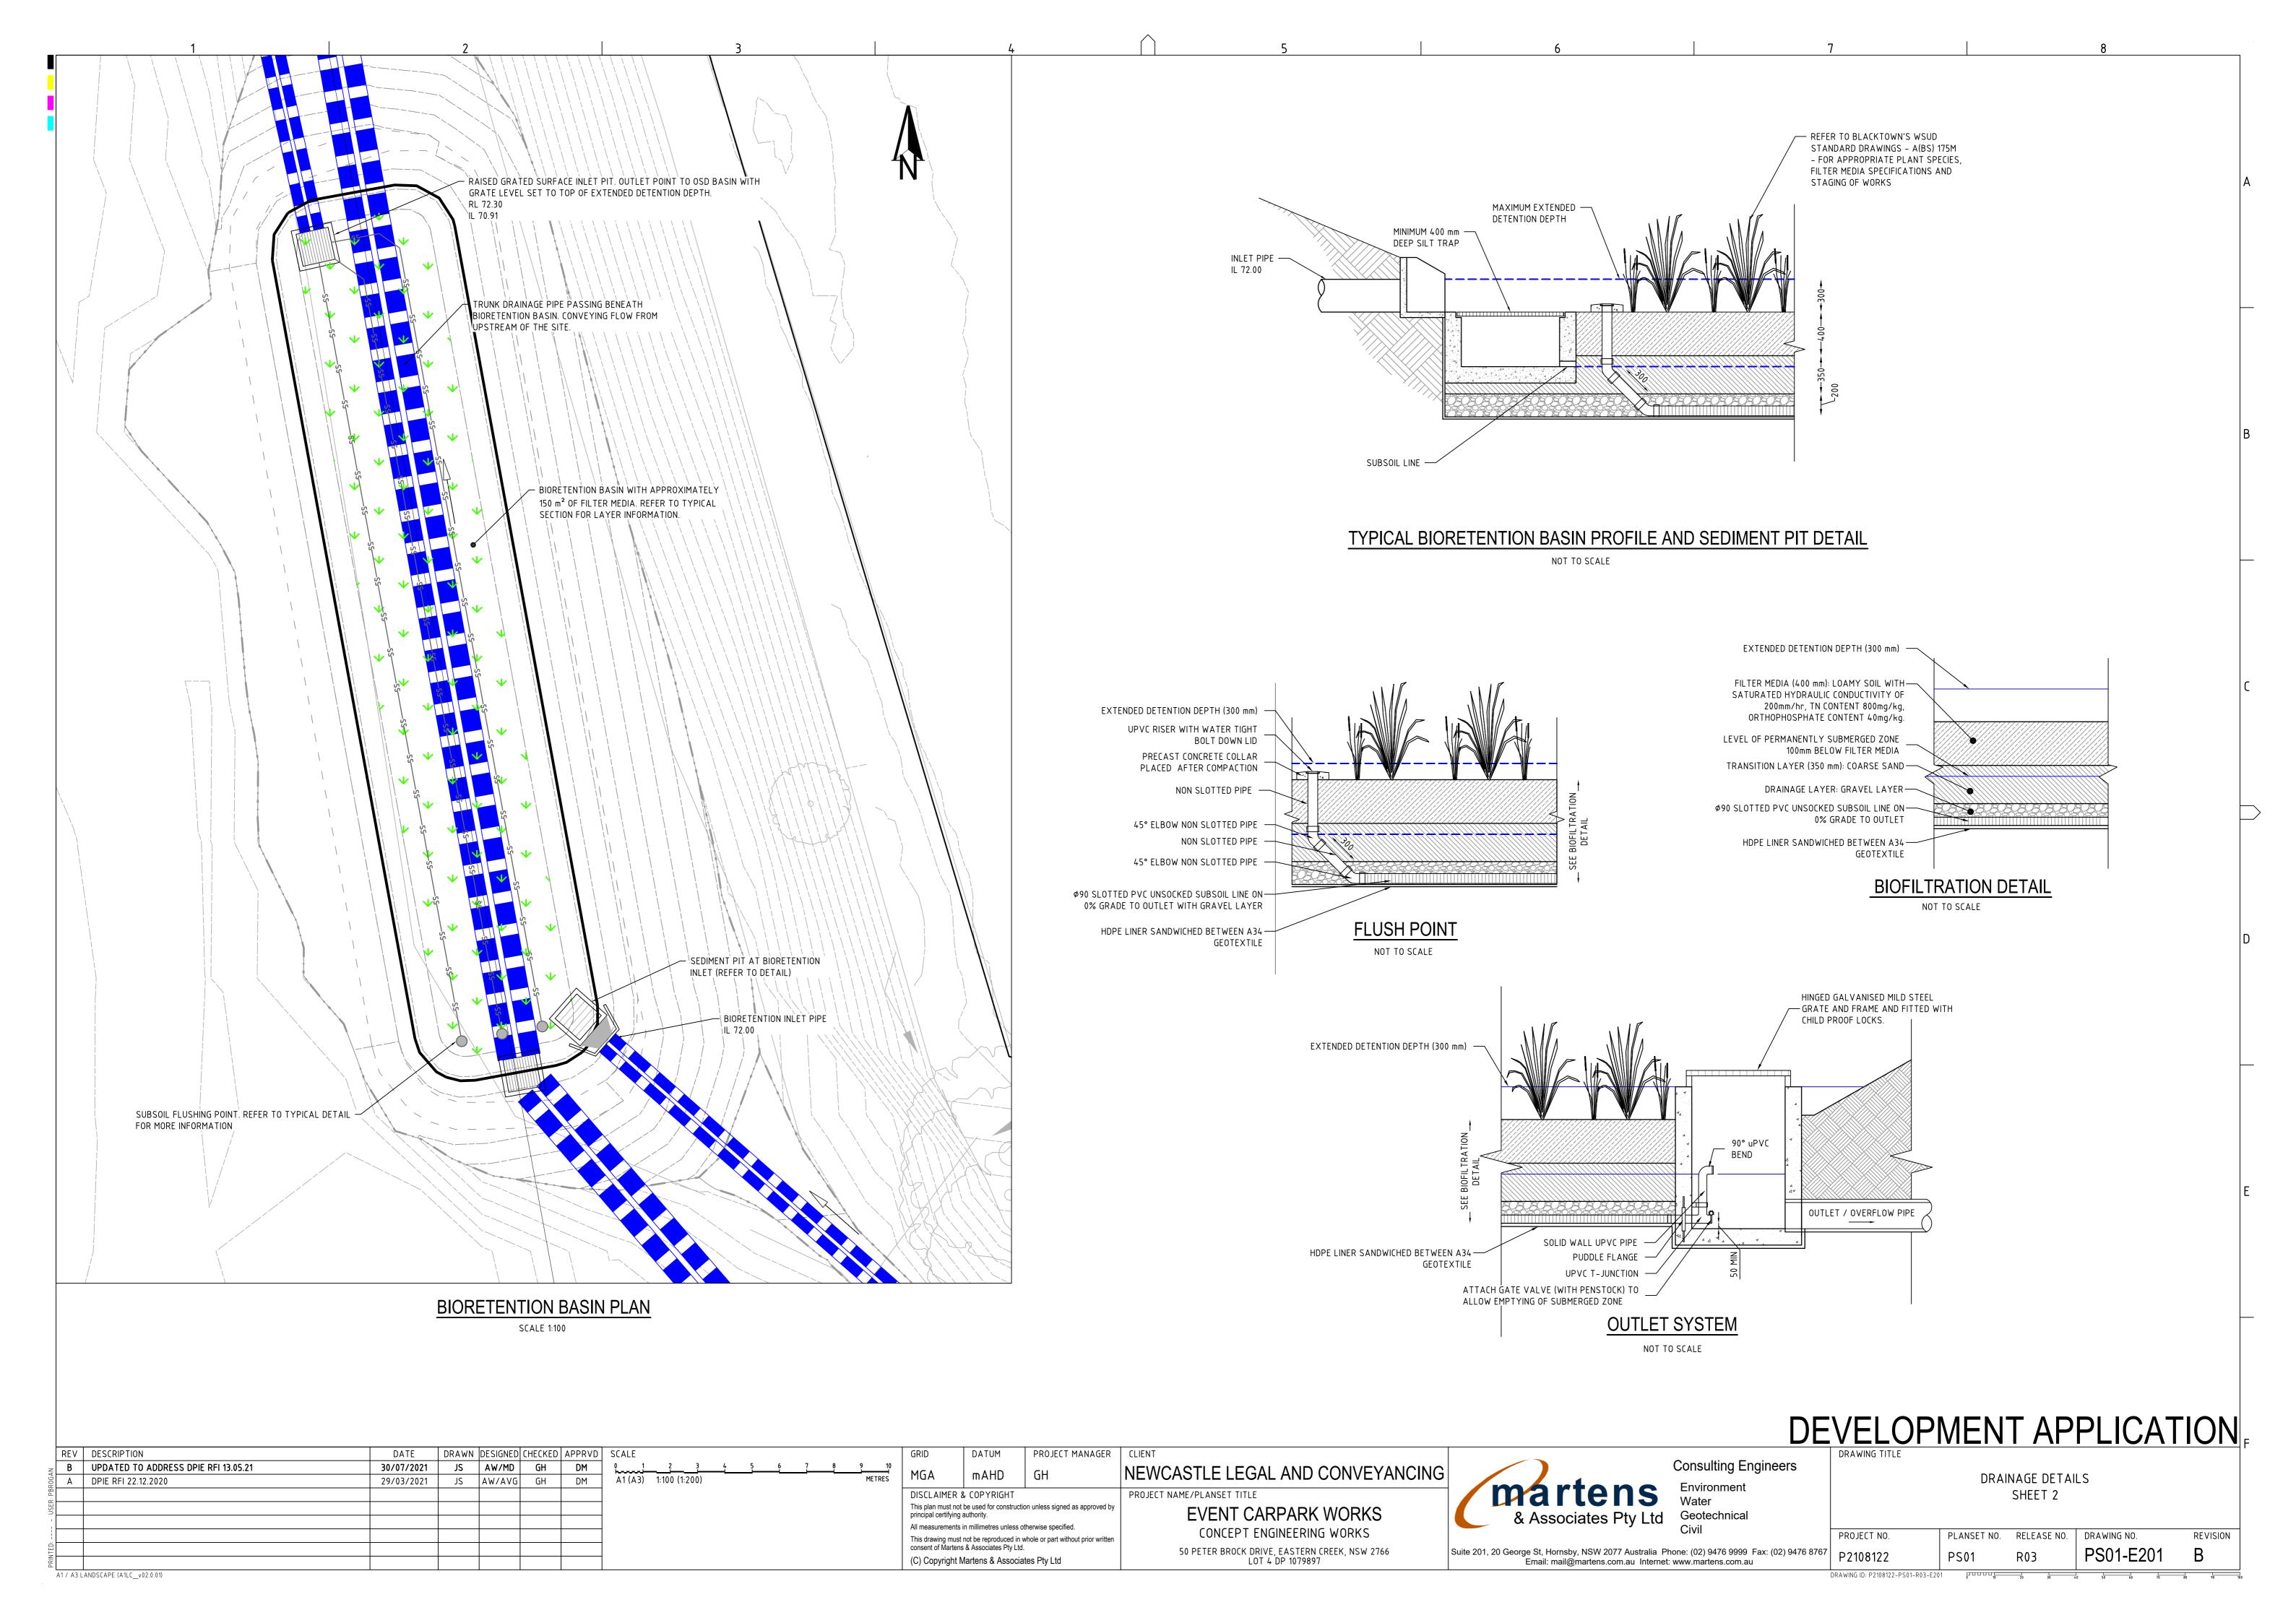


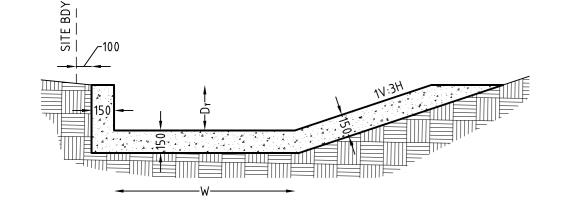

	SOUTHERN SWALE											
CHAINAGE INVERT RL BOTTOM WIDTH (W) FLOW DEPTH (D) CHANNEL DE												
EASTERN SIDE OF CULVERT	0	76.281	0.3m	0.23m	0.3							
	30	76	0.5m	0.25m	0.6							
WESTERN SIDE OF CULVERT	0	76.851	0.3m	0.18m	0.3							
	30	76	0.5m	0.18m	0.6							

### **SOUTHERN SWALE - TYPICAL SECTION**

NOT TO SCALE

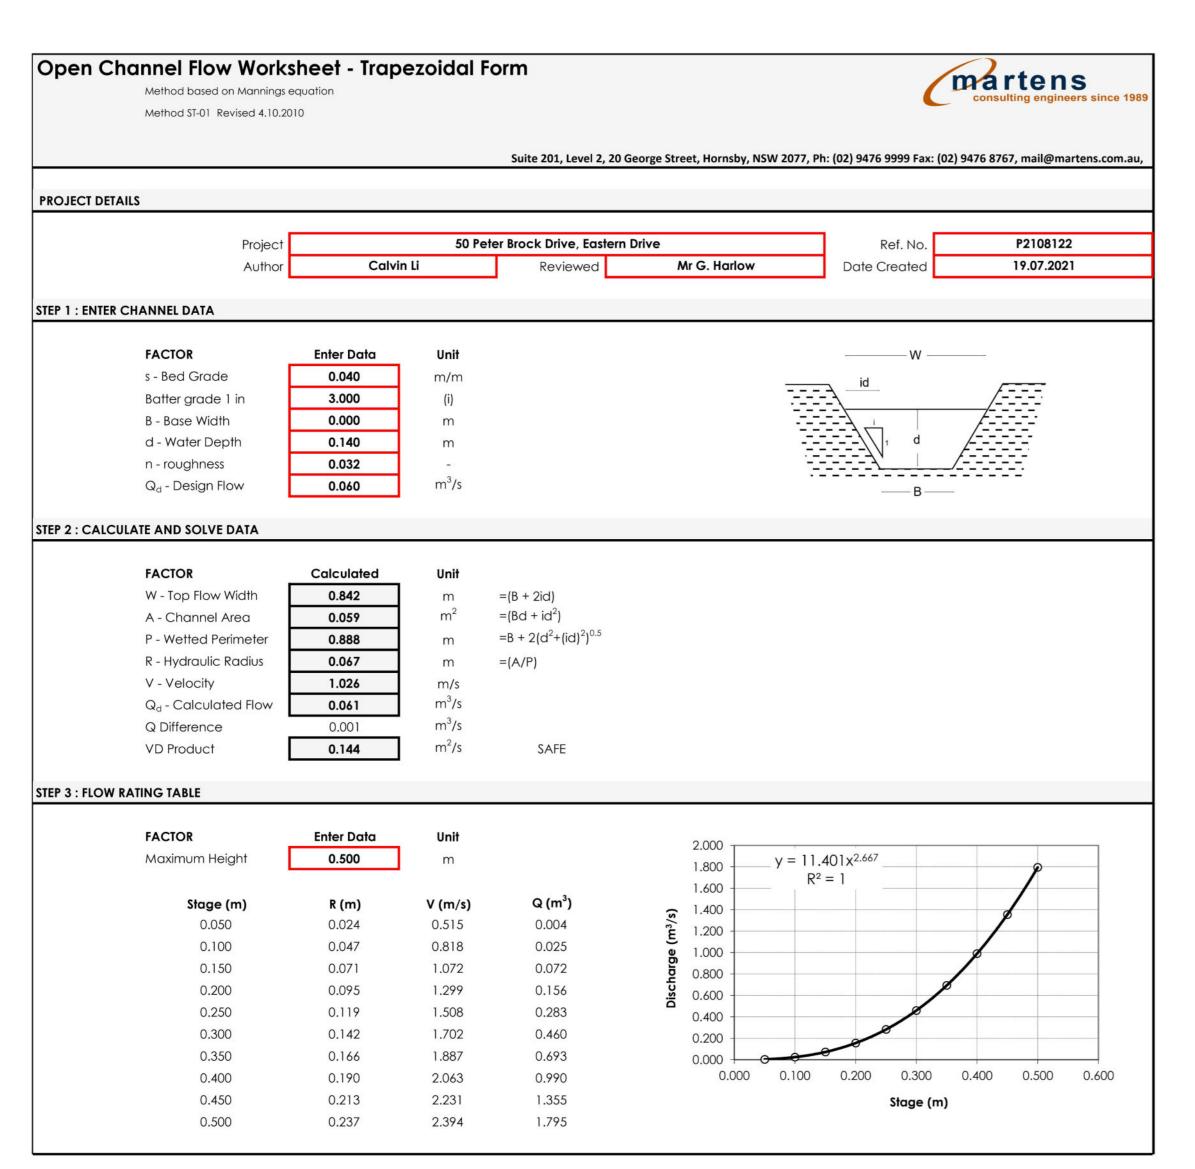

# EASTERN SWALE CALCULATION

DRAWN DESIGNED CHECKED


JS AW/MD GH

JS AW/AVG GH

30/07/2021

29/03/2021

TO MATCH EXISTING FOOTPATH HEIGHT AT 10 RACEWAY CLOSE

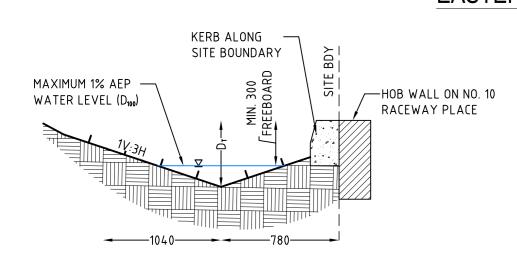

**EASTERN SWALE - TYPICAL SECTION** 

NOT TO SCALE

	EASTERN SWALE										
CHAINAGE	INVERT RL	1% AEP RL (D100)	300mm FREEBOARD REQUIREMENT	TOTAL SWALE DEPTH - INCLUDING KERB (DT)	KERB TOP RL						
0	76.64	76.71	77.01	0.419m	77.059						
20	76.222	76.308	76.608	0.538m	76.76						
40	75.912	76.038	76.338	0.540m	76.452						
60	75.449	75.607	75.907	0.644m	76.093						
80	74.408	74.528	74.828	0.513m	74.921						
101.235	73.2	73.489	73.789	0.598m	73.798						

# **DATUM RL 64.000**

**DESIGN SURFACE LEVELS EXISTING SURFACE LEVELS** CUT / FILL DEPTH CHAINAGE

**DATUM RL 62.000** 

**DESIGN SURFACE** 


**EXISTING SURFACE** 

CUT / FILL DEPTH

**LEVELS** 

**LEVELS** 


CHAINAGE

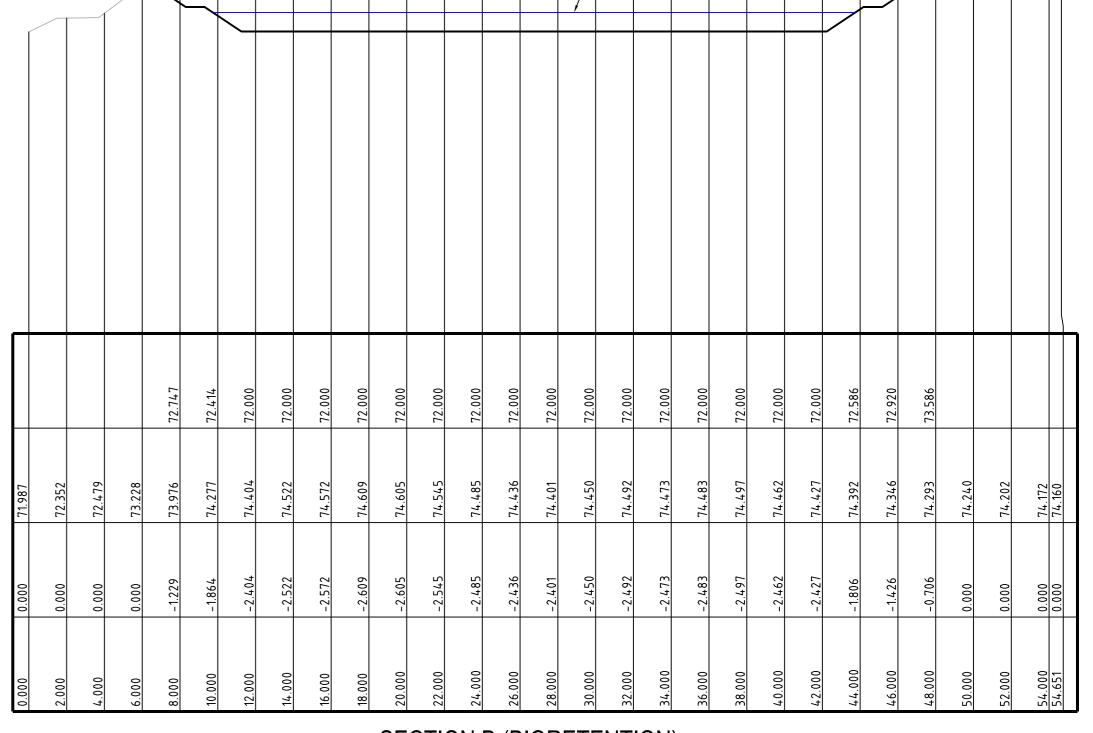

— BIORETENTION BASIN EXTENDED DETENTION DEPTH

#### SECTION B (BIORETENTION)

SCALE: HORIZONTAL - 1:200 VERTICAL - 1:100

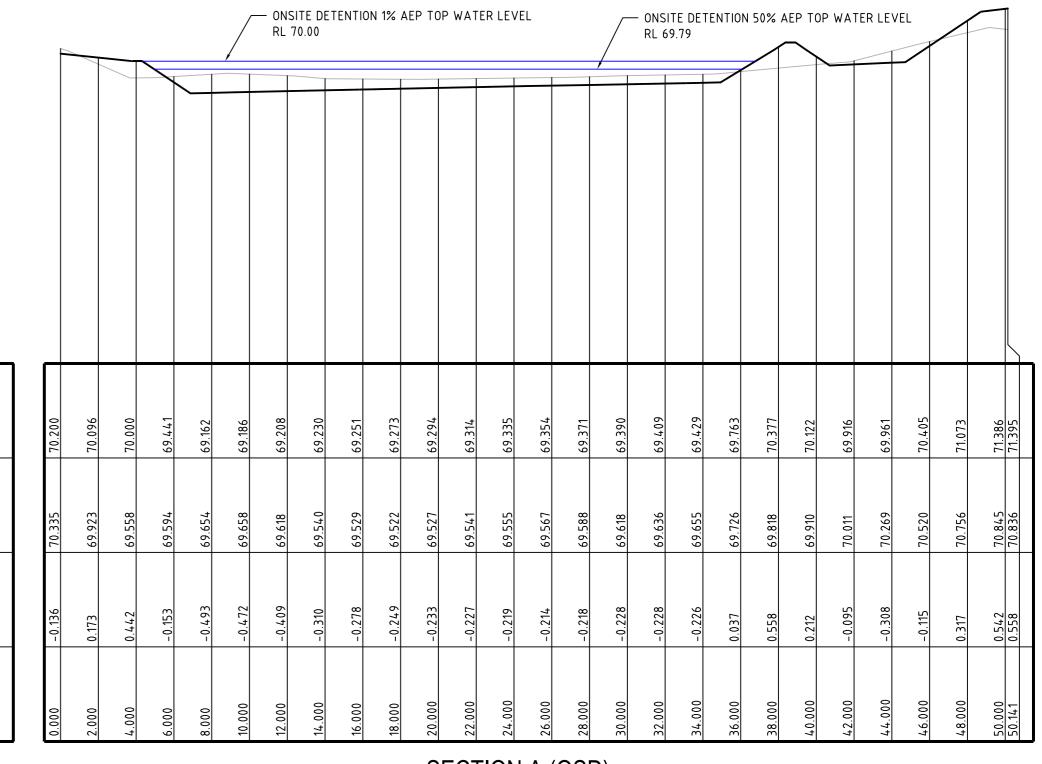

# SECTION A (OSD)

SCALE: HORIZONTAL - 1:200 VERTICAL - 1:100

DEVELOPMENT APPLICATION

	REV	DESCRIPTION
Z.	В	UPDATED TO ADDRESS DPIE RFI 13.05.21
PBROGAN	Α	DPIE RFI 22.12.2020
USER:		
ı 1		
PRINTED		
PRIN		

A1 / A3 LANDSCAPE (A1LC\_v02.0.01)

)	APPRVD	SCALE										I
	DM	0 2 	4	6	8	10	12	14	16	18	20	
	DM	A1 (A3)	1:200 (1	:400)						ME	TRES	
		0 1	2	3	4	5	6	7	8	9	10	Ī
		A1 (A3)	1:100 (1:	200)						ME	TRES	

	GRID	DATUM	PROJECT MANAGER	CLIENT					
	MGA	mAHD	GH	NEWCASTLE LEGAL AND CONVEYANCING					
	DISCLAIMER & COPYRIGHT			PROJECT NAME/PLANSET TITLE					
	This plan must not principal certifying a		on unless signed as approved by	EVENT CARPARK WORKS					
	All measurements in millimetres unless otherwise specified.			CONCEPT ENGINEERING WORKS					
	This drawing must	not be reproduced in w	whole or part without prior written	CONCELL LINGUINEELVING WOLVING					
consent of Martens & Associates Pty Ltd.				50 PETER BROCK DRIVE FASTERN CREEK NSW 2766					

(C) Copyright Martens & Associates Pty Ltd

JECT NAME/PLANSET TITLE **EVENT CARPARK WORKS** CONCEPT ENGINEERING WORKS 50 PETER BROCK DRIVE, EASTERN CREEK, NSW 2766 LOT 4 DP 1079897





Suite 201, 20 George St, Hornsby, NSW 2077 Australia Phone: (02) 9476 9999 Fax: (02) 9476 8767


Email: mail@martens.com.au Internet: www.martens.com.au

Consulting Engineers Environment Geotechnical

		DRAI	NAGE DETAI SHEET 3	LS	
	PROJECT NO.	PLANSET NO.	RELEASE NO.	DRAWING NO.	REVISION
7	P2108122	PS01	R03	PS01-E202	В
	DRAWING ID: P2108122-PS01-R03-E20	2 00000	20 30 4	0 50 60 70	80 90 1

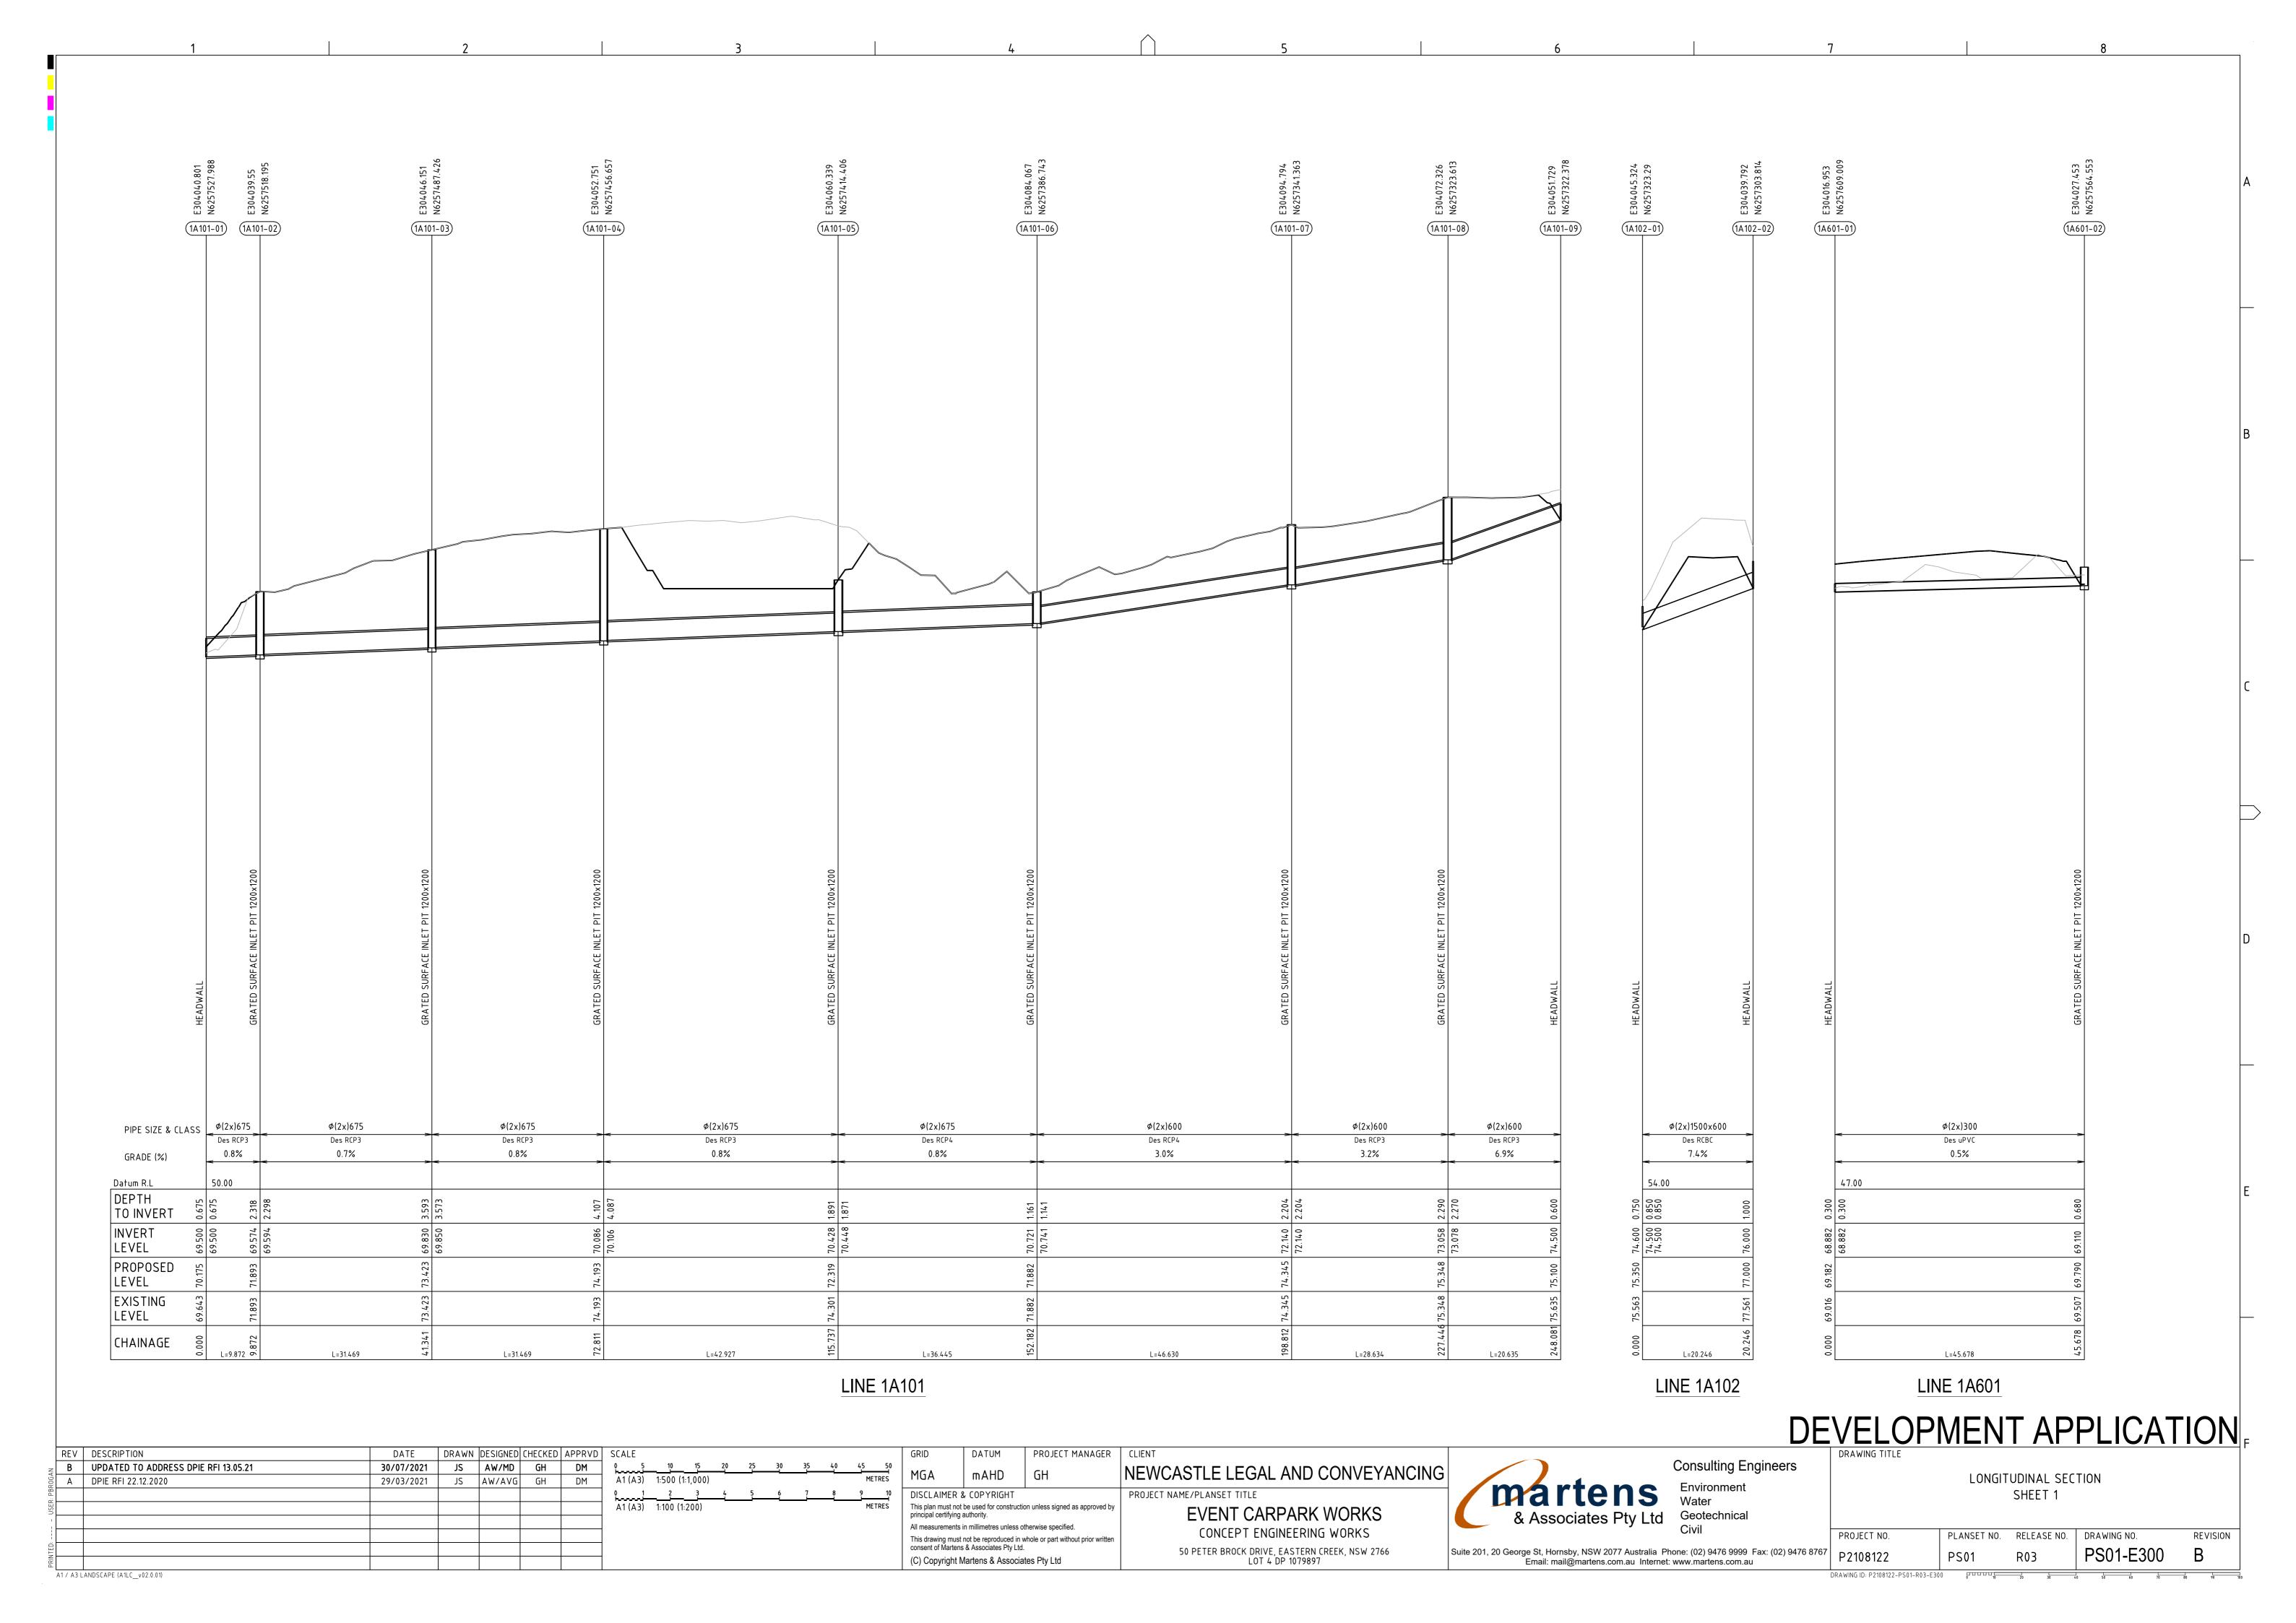

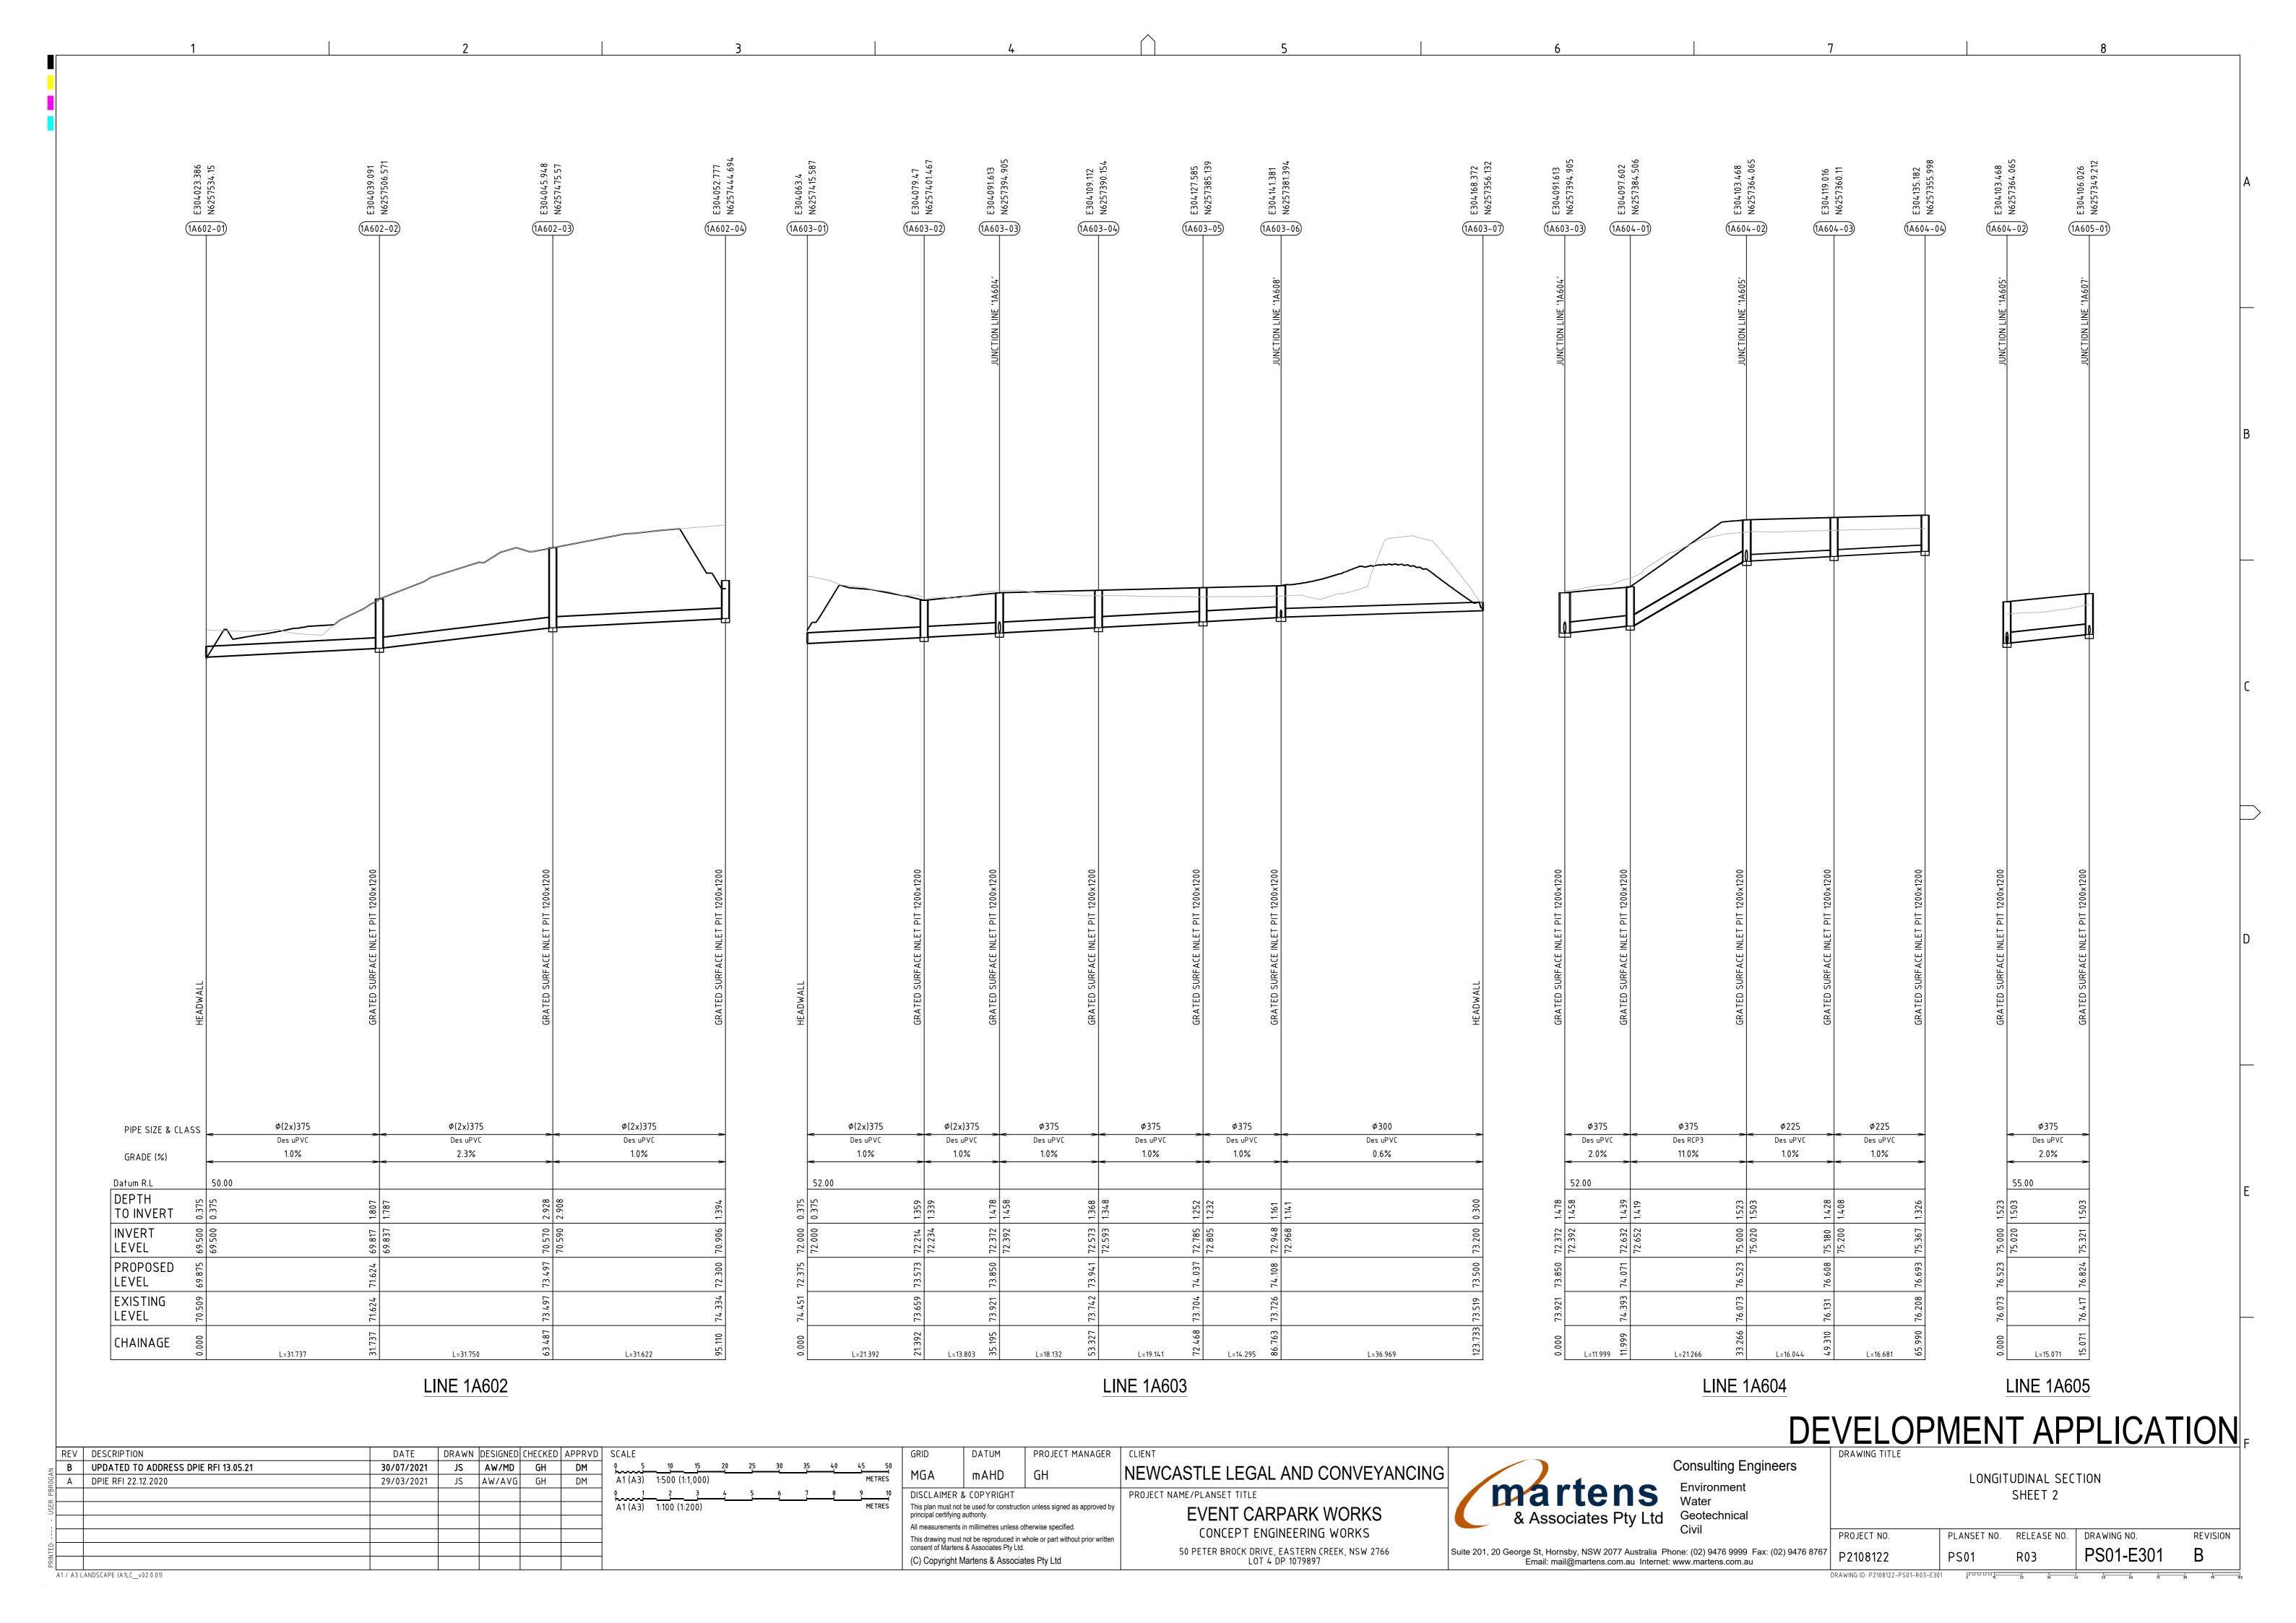

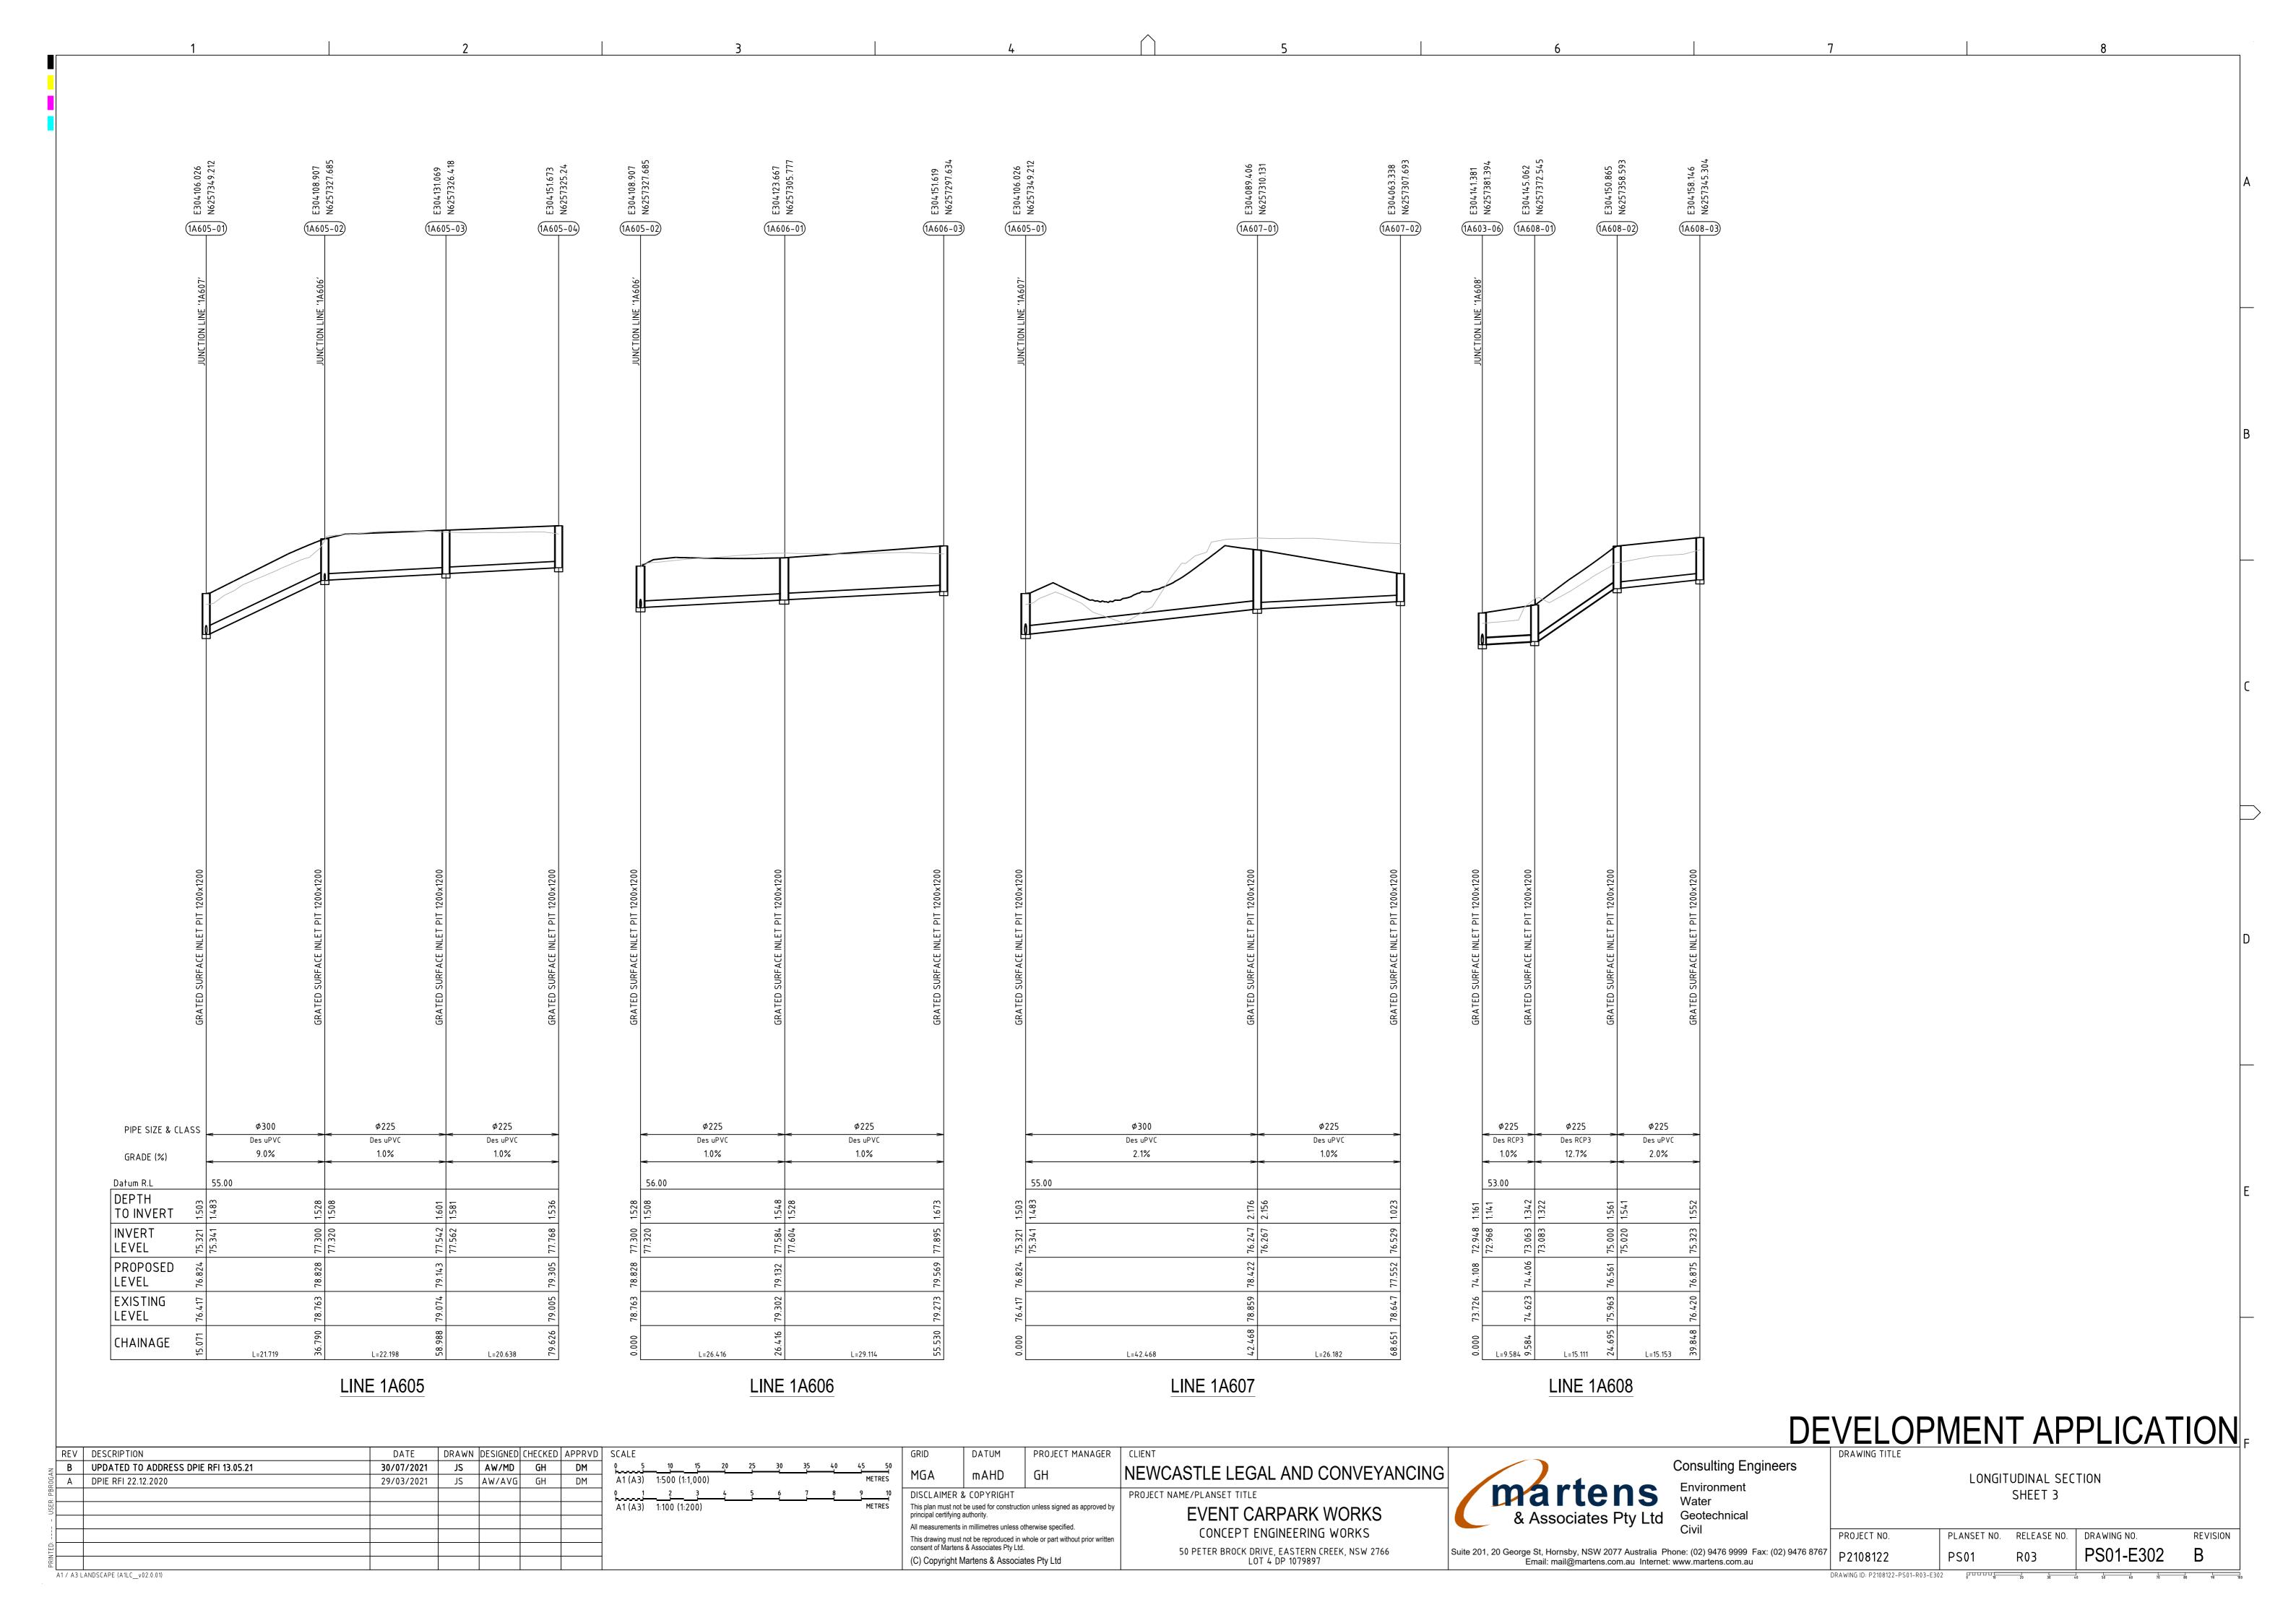

1200-200 (ACCHOMAT ACCHOMAT AC

OSD CATCHMENT PLAN (POST-DEVELOPMENT)

SCALE 1:1000

A1 / A3 LANDSCAPE (A1LC\_v02.0.01)

Project Title	50 Peter Brock Drive, Eastern C
Address	Peter Brock Drive
Reference Number	P2108122
ral Site Data;	
Site Area (m²)	8020 m <sup>1</sup>
Area Draining to OSD (m²) (Max Bypass 15%)	7694 m²
OSD Location	Above Ground
OSD Discharge Location	Channel or Swale
The preliminary storage requirements below the 50% AEP 'Weir is 240.6m' & the storage to AEP weir is 364.91m'. This requirement will differ if there is a drowned orifice.  Cartridges:	oelow the 12
Will filter cartridges be used to manage water quality?  harge Location Data;	No
	No 69.190 m
range Location Data:	
narge Location Data;  ③RL of 50% AEP Orifice Centreline	69.190 m
narge Location Data:  ③ RL of 50% AEP Orifice Centreline  Number of 50% AEP Orifices	69.190 m 2
arge Location Data:  ③ RL of 50% AEP Orifice Centreline  Number of 50% AEP Orifices  ⑥ RL of 1% AEP Orifice Centreline	69.190 m 2 69.220 m
arge Location Data:  ③ RL of 50% AEP Orifice Centreline  Number of 50% AEP Orifices  ⑥ RL of 1% AEP Orifice Centreline  Number of 1% AEP Orifices	69.190 m 2 69.220 m
narge Location Data:  ③ RL of 50% AEP Orifice Centreline  Number of 50% AEP Orifices  ⑥ RL of 1% AEP Orifice Centreline  Number of 1% AEP Orifices  Is the 1% AEP Water Surface Level in the Channel Known or Assumed	69.190 m 2 69.220 m 2 Use an Assumed WSL
narge Location Data:  ③ RL of 50% AEP Orifice Centreline  Number of 50% AEP Orifices  ⑥ RL of 1% AEP Orifice Centreline  Number of 1% AEP Orifices  Is the 1% AEP Water Surface Level in the Channel Known or Assumed  ③ Invert of channel/swale at the point of discharge  ⑥ Top of channel/swale bank at the point of discharge	69.190 m 2 69.220 m 2 Use an Assumed WSL 66.500
harge Location Data:  ③ RL of 50% AEP Orifice Centreline  Number of 50% AEP Orifices  ⑥ RL of 1% AEP Orifice Centreline  Number of 1% AEP Orifices  Is the 1% AEP Water Surface Level in the Channel Known or Assumed  ⑨ Invert of channel/swale at the point of discharge  ⑩ Top of channel/swale bank at the point of discharge	69.190 m 2 69.220 m 2 Use an Assumed WSL 66.500 68

### BLACKTOWN CITY COUNCIL OSD SPREADSHEET INPUTS

Site:	
Address Peter Brock Drive	
Site Area	8020 m'
Site Area NOT Draining to OSD	326 m <sup>1</sup>
Bypass	4%
Reduced Levels (AHD):	
@RL at top Weir	70.175
Average RL of the base of the OSD Storage Area	69.290
② RL of Emergency Overflow Weir	70.000
RL of 50% AEP Overflow Weir	69.790
3 RL of 50% AEP Orifice Center Line	69.190
6 RL of 1% AEP Orifice Center Line	69.220
	66.500
RL of Channel Bank at point of discharge	68.000
Minimum RL of Garage Floor	70.175
Minimum RL of Habitable Floor	70.275
DSD Volume:	
Required Storage BELOW the 50% AEP Overflow Weir	240.600
Required Storage BELOW Emergency Overflow Weir	364,910
Discharge Details:	
Using Filter Cartridges to manage Water Quality	No
Discharge Location Channel/Swale With	an Assumed WSL
Length of Emergency Overflow Weir	30.000
Maximum 50% AEP Site Discharge	30.124
Maximum 50% AEP Orifice Discharge	30.124
Maximum 1% AEP Site Discharge	134.124
Maximum 1% AEP Orifice Discharge	134.124
Orifice Details:	
Number of 50% AEP Orifices	2.000
Number of 1% AEP Orifices	2.000
50% AEP Orifice Diameter (mm)	36,000

### BLACKTOWN CITY COUNCIL OSD SPREADSHEET OUTPUTS

	REV	DESCRIPTION	DATE	DRAWN	DESIGNED	CHECKED /	APPRVD	VD SCALE	GRID	DATUM	PROJECT MANAGER	CLIENT
Z.	В	UPDATED TO ADDRESS DPIE RFI 13.05.21	30/07/2021	JS	AW/MD	GH	DM	0 10 20 30 40 50 60 70 80 90 100	MCV	_ ^ ND	l cu	NEWCASTLE LEGAL AND CONVEYANCING
R06/	Α	DPIE RFI 22.12.2020	29/03/2021	JS	AW/AVG	GH	DM	A1 (A3) 1:1,000 (1:2,000) METRES	MGA	mAHD	GH	INCINCASTLE LEGAL AND CONVETANCING
S: PB									DISCLAIMER	& COPYRIGHT		PROJECT NAME/PLANSET TITLE
- USEF									This plan must not principal certifying		on unless signed as approved by	EVENT CARPARK WORKS
ijŀ						$\vdash$	'		All measurements	in millimetres unless of	therwise specified.	CONCEPT ENGINEERING WORKS
ا اة						<del></del>					whole or part without prior written	
RINTE						<del>                                     </del>			1	s & Associates Pty Ltd. Martens & Associat		50 PETER BROCK DRIVE, EASTERN CREEK, NSW 2766

Consulting Engineers

Environment
Water

& Associates Pty Ltd

Suite 201, 20 George St, Hornsby, NSW 2077 Australia Phone: (02) 9476 9999 Fax: (02) 9476 8767

Email: mail@martens.com.au Internet: www.martens.com.au


DE	DEVELOPMENT APPLICATION										
eers	DRAWING TITLE	– – . – .	SITE DETENTION CATCHMENT PLAN MODELS & RESULTS								
(02) 9476 8767	PROJECT NO. P2108122	PLANSET NO. PS01	RELEASE NO.	PS01-E600	REVISION B						

DRAWING ID: P2108122-PS01-R03-E600 0 10 10 20 30 40 50 60 70 80 90 100


CARPARK CATCHMENT (1A-02)
BYPASSING BIORETENTION
AREA: 0.008 ha CARPARK CATCHMENT (1A-01)-DIRECTED TO BIORETENTION AREA: 0.772 ha CARPARK CATCHMENT -BYPASSING OSD AREA: 0.022 ha

WATER QUALITY CATCHMENT PLAN

SCALE 1:1000

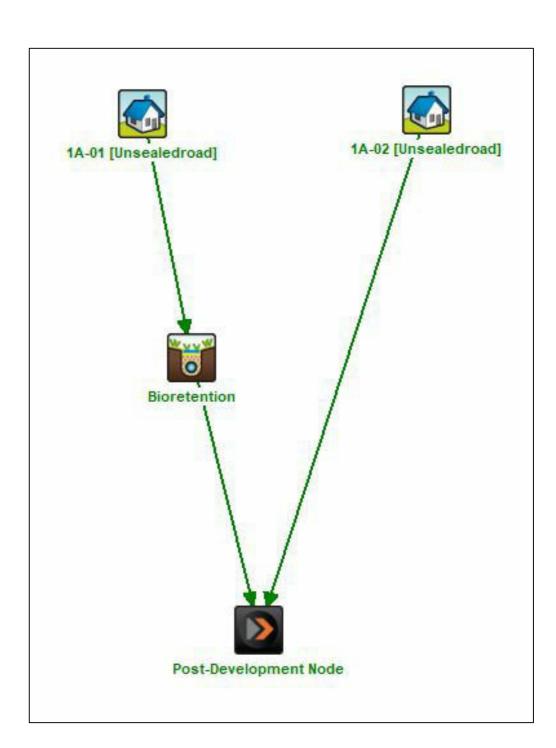

MUSIC MODEL LAYOUT (P2108122MUS01V01)

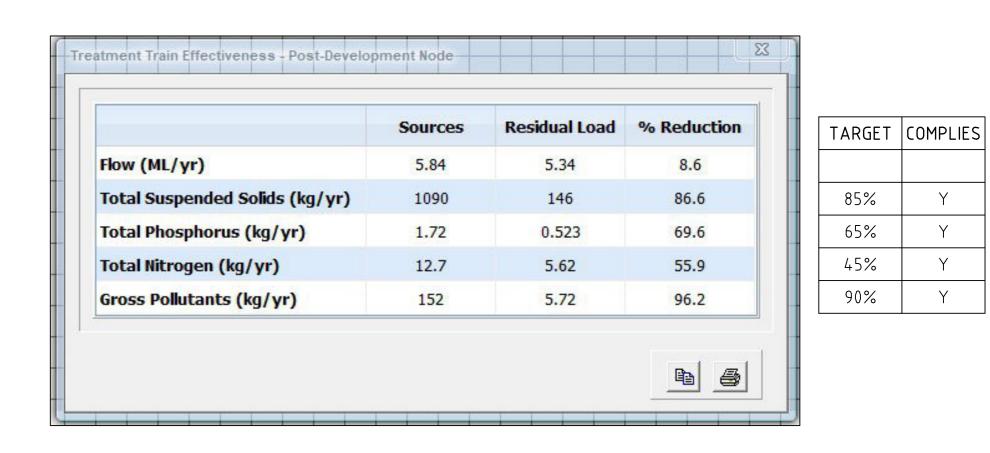

MUSIC MODEL RESULTS (P2108122MUS01V01)

REV DESCRIPTION DRAWN DESIGNED CHECKED APPRVD SCALE PROJECT MANAGER | CLIENT DATUM B UPDATED TO ADDRESS DPIE RFI 13.05.21 DM 30/07/2021 JS AW/MD GH NEWCASTLE LEGAL AND CONVEYANCING mAHD GH A1 (A3) 1:1,000 (1:2,000) A DPIE RFI 22.12.2020 29/03/2021 JS AW/AVG GH DM PROJECT NAME/PLANSET TITLE DISCLAIMER & COPYRIGHT This plan must not be used for construction unless signed as approved by principal certifying authority.

All measurements in millimetres unless otherwise specified.

(C) Copyright Martens & Associates Pty Ltd

This drawing must not be reproduced in whole or part without prior written consent of Martens & Associates Pty Ltd.

**EVENT CARPARK WORKS** CONCEPT ENGINEERING WORKS 50 PETER BROCK DRIVE, EASTERN CREEK, NSW 2766 LOT 4 DP 1079897

Consulting Engineers Environment Geotechnical Suite 201, 20 George St, Hornsby, NSW 2077 Australia Phone: (02) 9476 9999 Fax: (02) 9476 8767 Email: mail@martens.com.au Internet: www.martens.com.au

DEVELOPMENT APPLICATION WATER QUALITY CATCHMENT PLAN MODELS & RESULTS PROJECT NO. PLANSET NO. RELEASE NO. DRAWING NO. REVISION PS01-E700 P2108122 

85%

65%

45%

90%

A1 / A3 LANDSCAPE (A1LC\_v02.0.01)

