

Do not scale off this drawing. Use figured dimensions only. Resolve discrepancies with the architect before proceeding. Copyright of this drawing and designs executed herein vests in Dickson Rothchild.

DRAFT

$\left\{ \begin{array}{l} 0-7.2 = \text{FILL, SAND, CLAY} \\ 7.2-7.9 = \text{ELS} \\ 7.9-10.1 = \text{MS} \\ 11.1-11.6 = \text{George Street} \end{array} \right.$

$\left\{ \begin{array}{l} 0-8 = \text{SAND CLAY} \\ 8-9.8 = \text{MS} \end{array} \right.$

$\left\{ \begin{array}{l} 0-4.0 = \text{clay} \\ 4.0-5.7 = \text{ELS} \\ 5.7-6.2 = \text{MS} \\ 6.2-8.3 = \text{HS} \end{array} \right.$


$\left\{ \begin{array}{l} 0-4.3 = \text{sand + clay} \\ 4.3-4.8 = \text{ELS-LS} \\ 4.8-9.5 = \text{MS-HS} \end{array} \right.$

$\left\{ \begin{array}{l} 0-3.1 = \text{sand + clay} \\ 3.1-4.4 = \text{VLS-LS} \\ 4.4-9.0 = \text{MS-HS} \end{array} \right.$

$\left\{ \begin{array}{l} 0-4.8 = \text{clay + sand} \\ 4.8-6.0 = \text{ELS} \\ 6.0-9.7 = \text{MS-HS} \end{array} \right.$

ELS = extremely low strength
 VLS = very low
 LS = low
 MS = medium
 HS = high

Barrack Lane

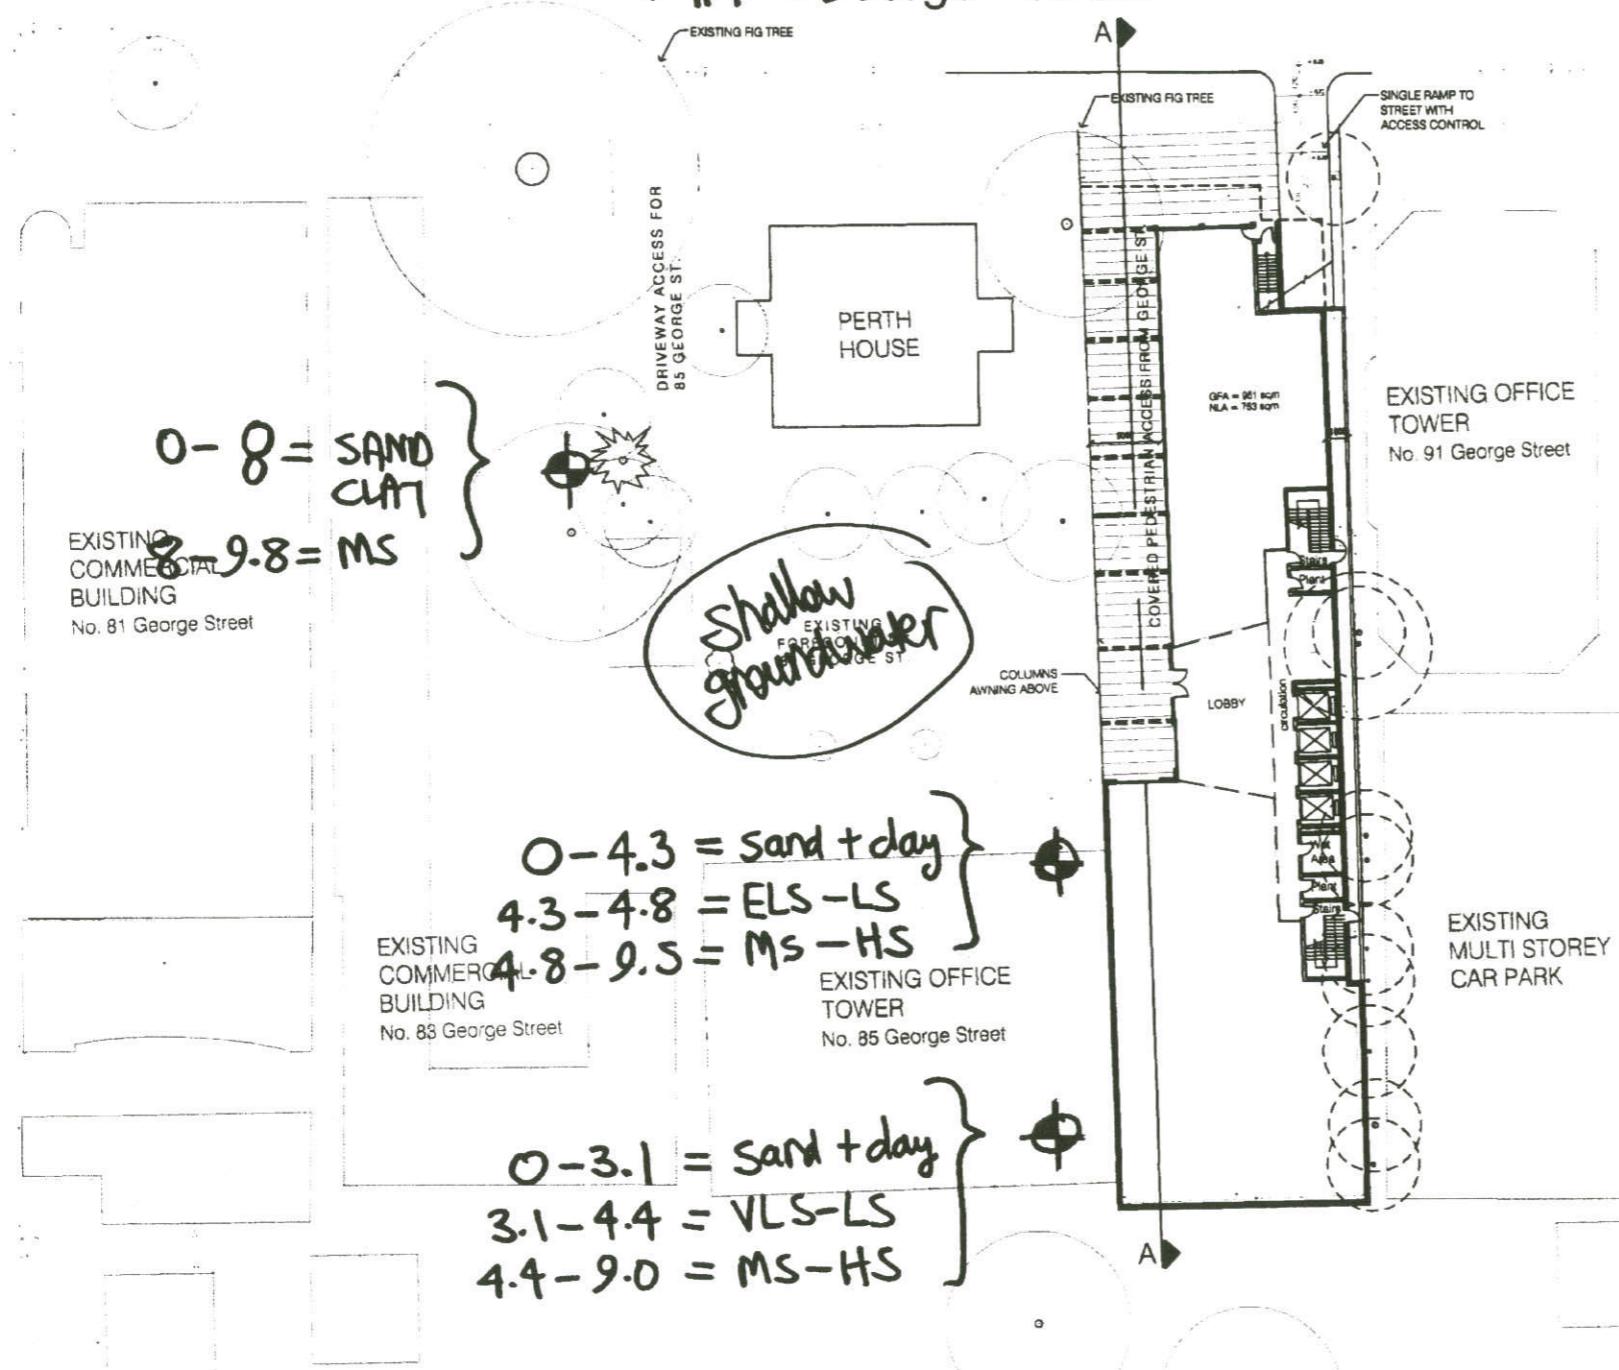

REV	DATE	DESCRIPTION	DR	APPD
B	02-08-07	Preliminary	GC	
A	20-07-07	Layout updated	GC	

URBAN DESIGNER: Dickson Rothchild P/L
 ARCHITECTS: WOODS BAGOT

PROJECT: 89 George Street Parramatta

CLIENT: Duxton Developments Pty Ltd Parramatta

DRAWING: SITE Context
 Site Plan

PROJECT NO	DRAWING NO	REVISION
06-091	PDA-001	B
SCALE @ AT	DATE	DRAWN / CHECKED
1:250	02-08-07	SD / GC



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A1 SITE CONTEXT
 DA 101 SCALE 1:200