

19

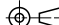


Individually fabricated internally lit letters.
Area: 14.7m²
Front face in white
Sides PMS 1817 Deep Red

H3

H4

1:150

D	Issued for DA			04.01.10
C	Issued for DA			15.12.09
B	Issued for DA			09.12.09
A	Issued for DA			25.11.09
Drawn: SD		Checked: HG	Sheet 1 of 1	Date: 17.11.09
Client: Aurora Projects Pty Ltd Project: Macquarie University Hospital External Signage - DA Document				 A3
				Do not scale Dimensions in mm
Job No. S3027	Dwg. 19		Issue D	Scale NTS/AS SHOWN

NOTE

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2. Structural design and certification
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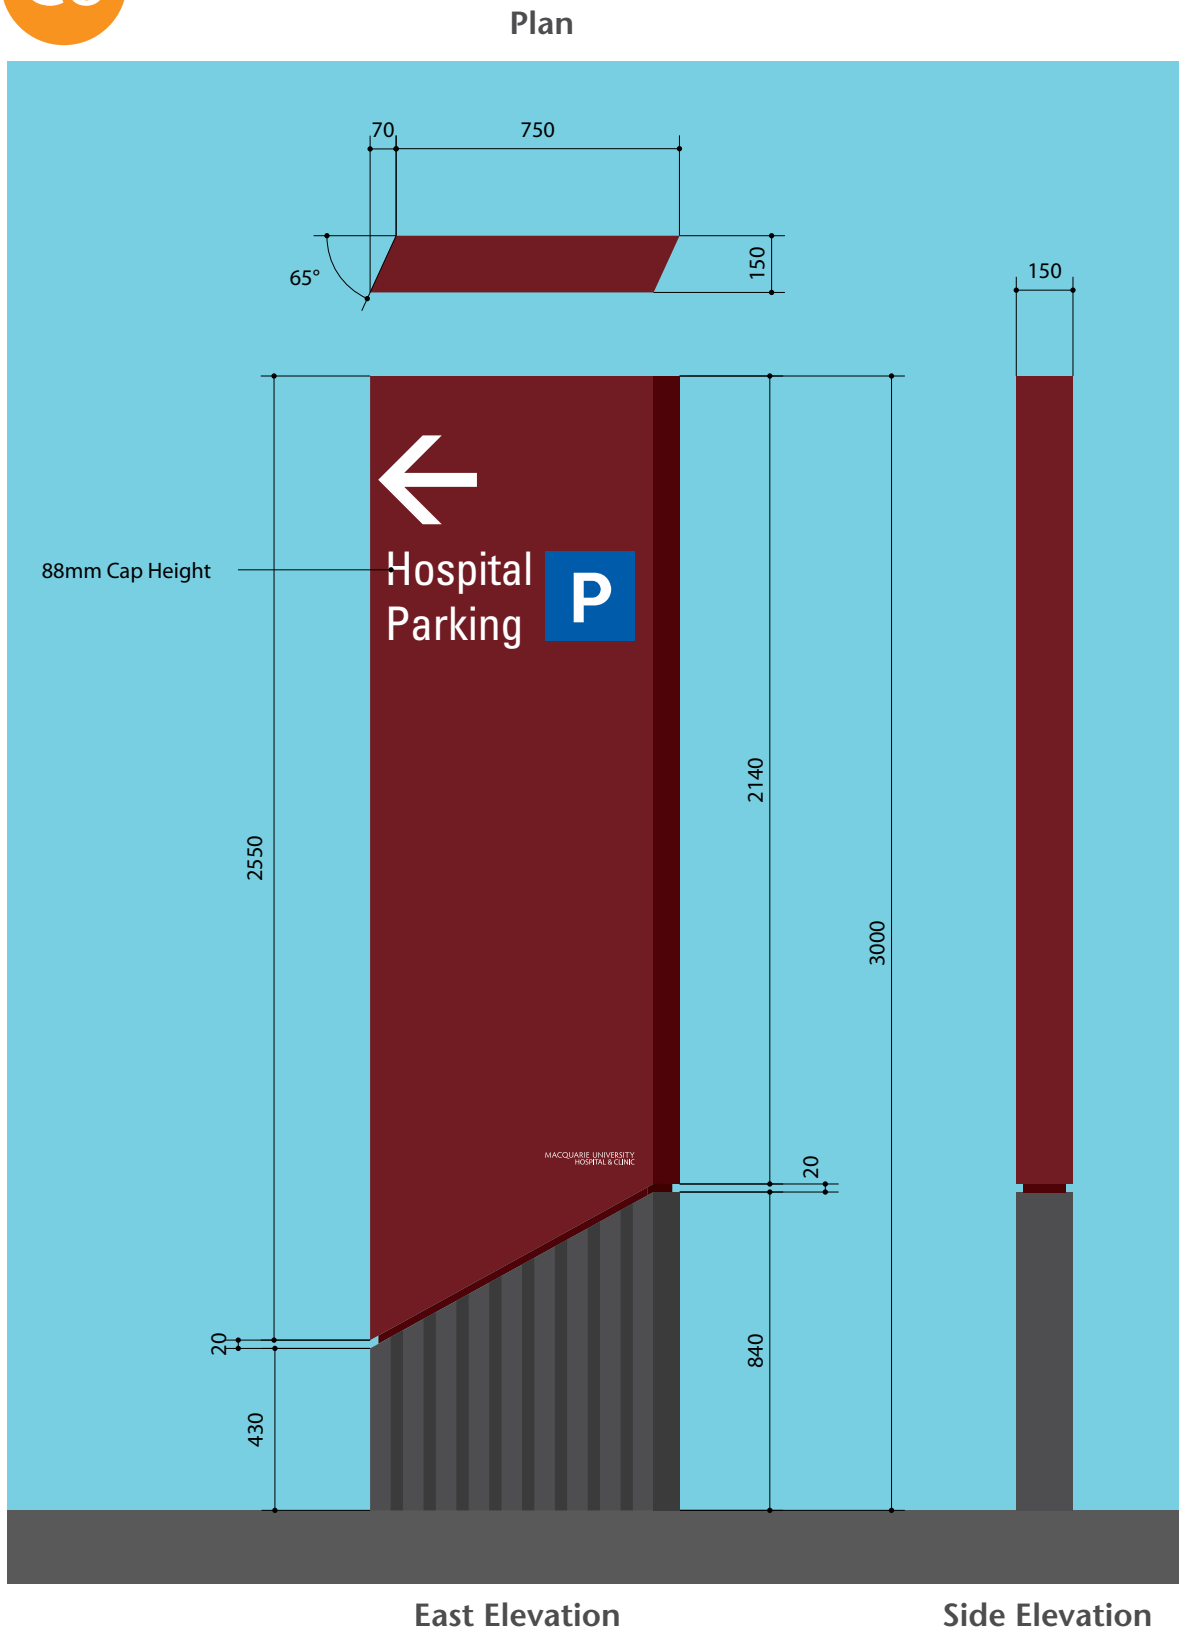
3. No electronic artwork supplied unless otherwise specified.
4. Application of graphics to sign is subject to client approval.

5. Manufacture subject to approved contractors shop drawing.
6. Dimensions to be verified onsite by contractor.
7. All fixings to be non-corrosive.

8. All workmanship and materials to be strictly in accordance with current and relevant S.A.A. codes and Local Government requirements.

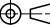
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Total area east & west face 4.5sqm

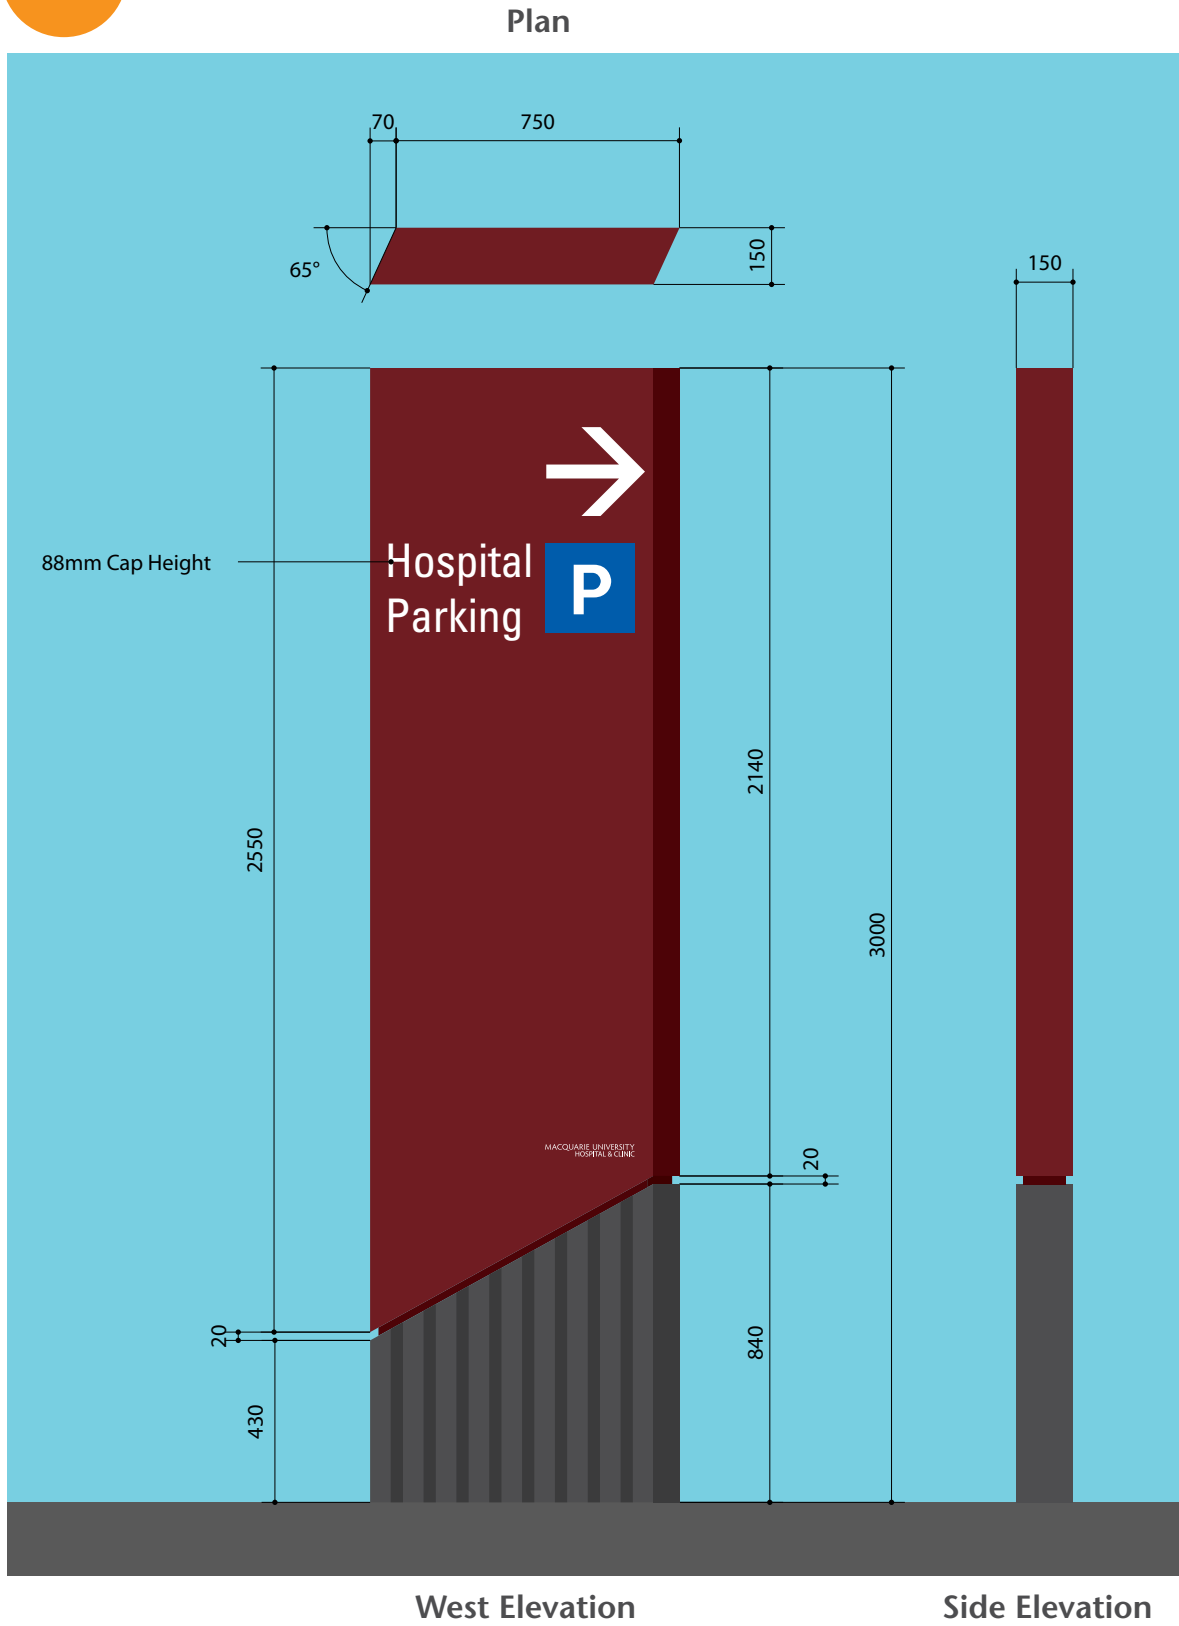


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Project: Macquarie University Hospital External Signage - DA Document					
Job No. S3027		Dwg. 20		Issue D	Scale NTS/AS SHOWN

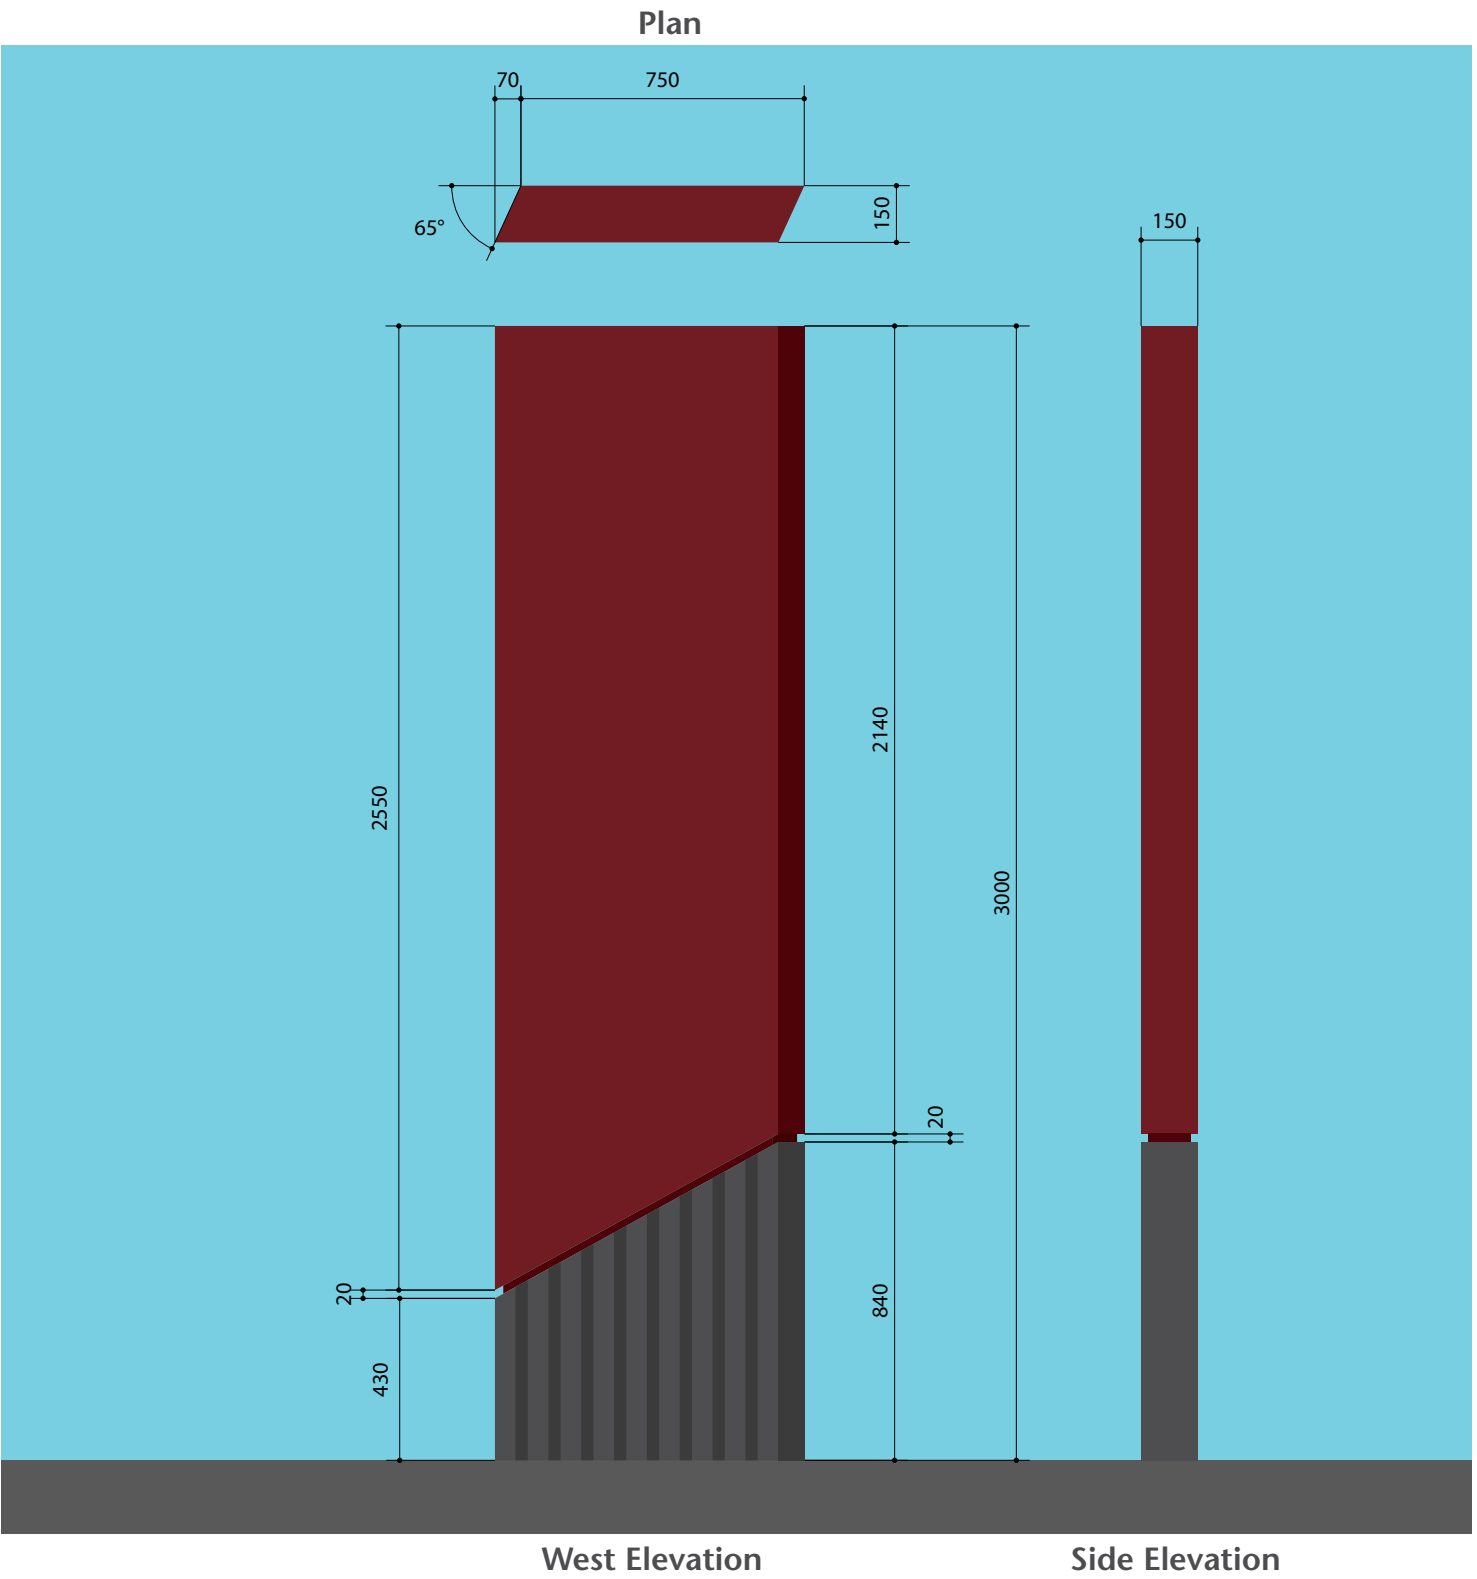
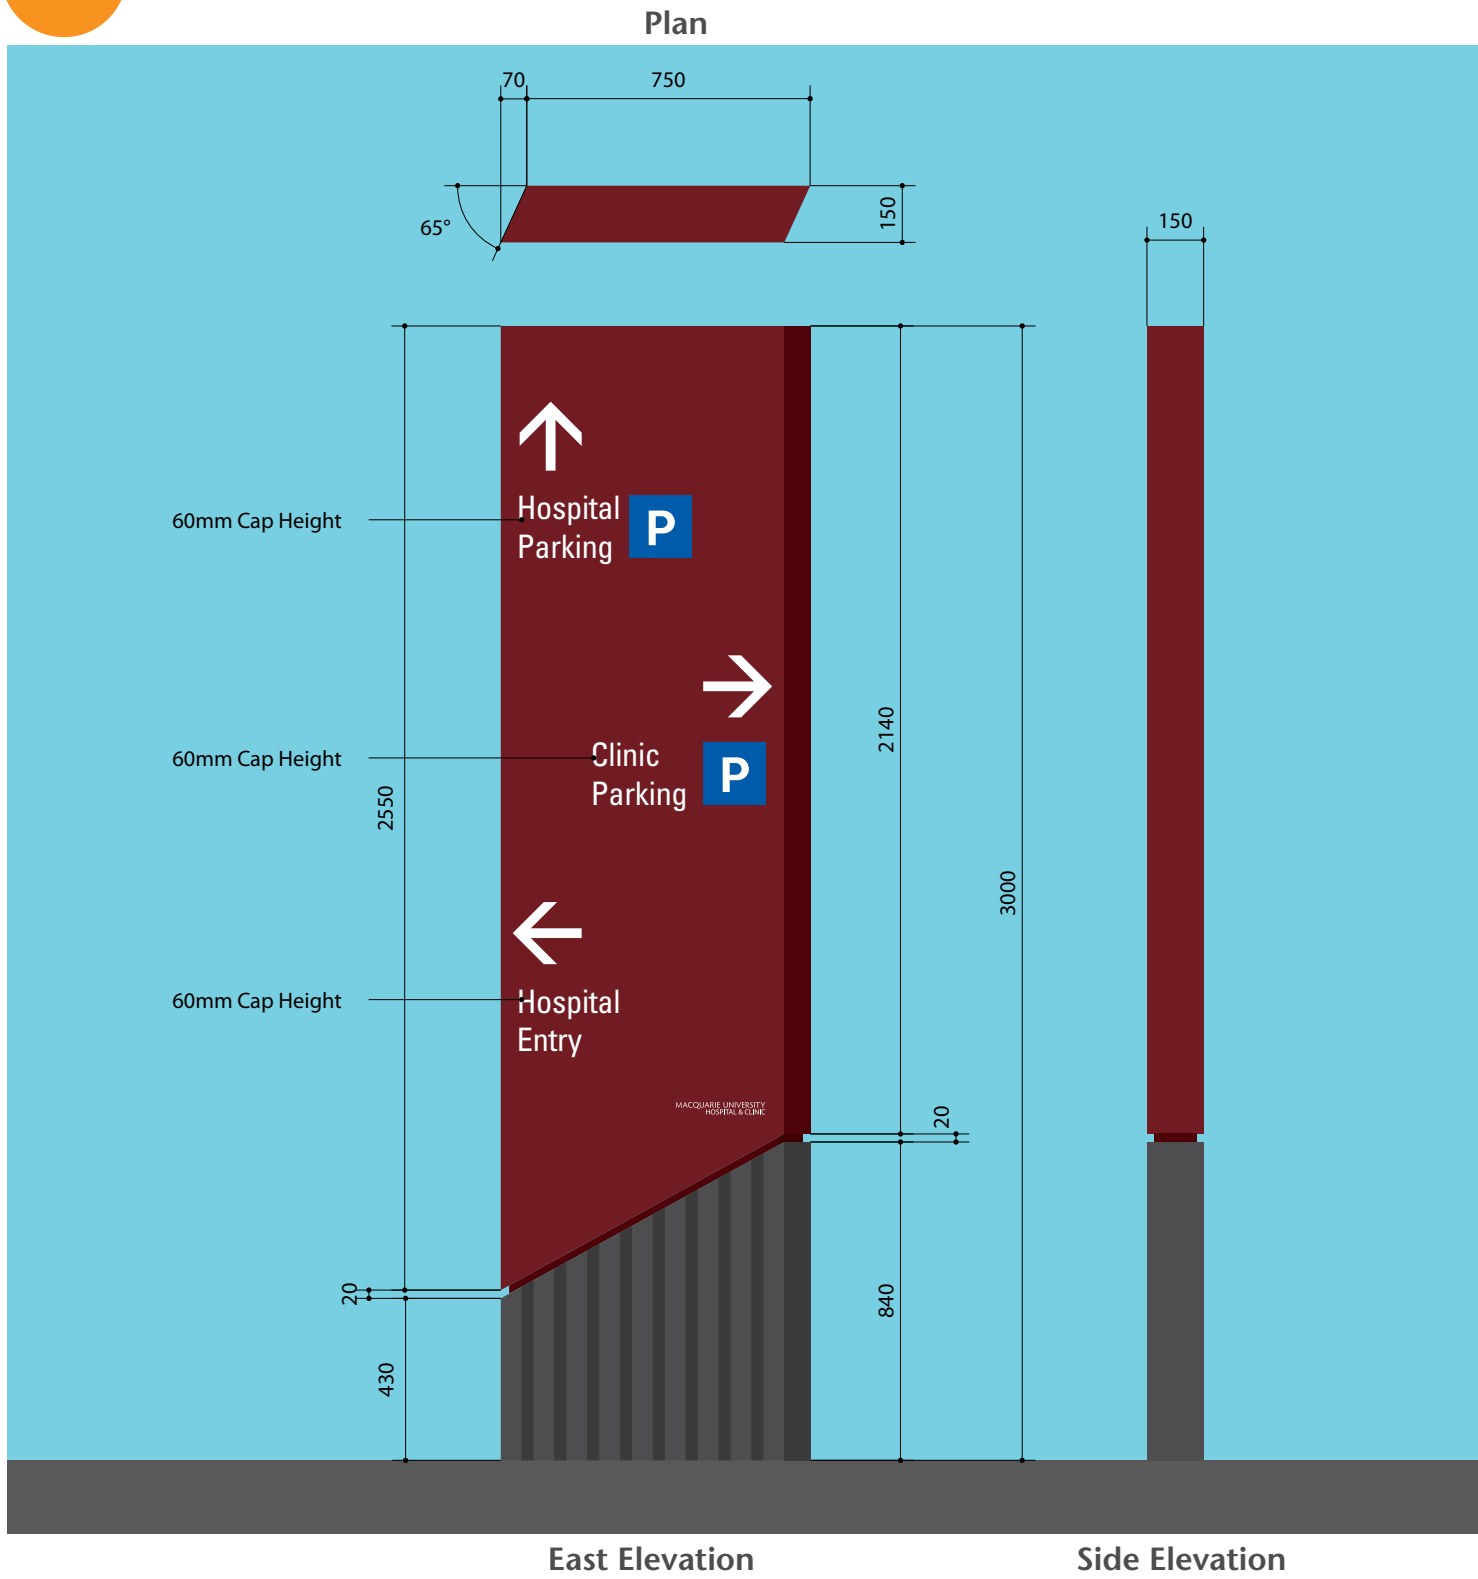
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
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	Project: Macquarie University Hospital External Signage - DA Document			
	Job No. S3027	Dwg. 21	Issue D	Scale NTS/AS SHOWN



Total area east & west face 4.5sqm

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				Do not scale Dimensions in mm
Job No. S3027		Dwg. 22	Issue D	Scale NTS/AS SHOWN

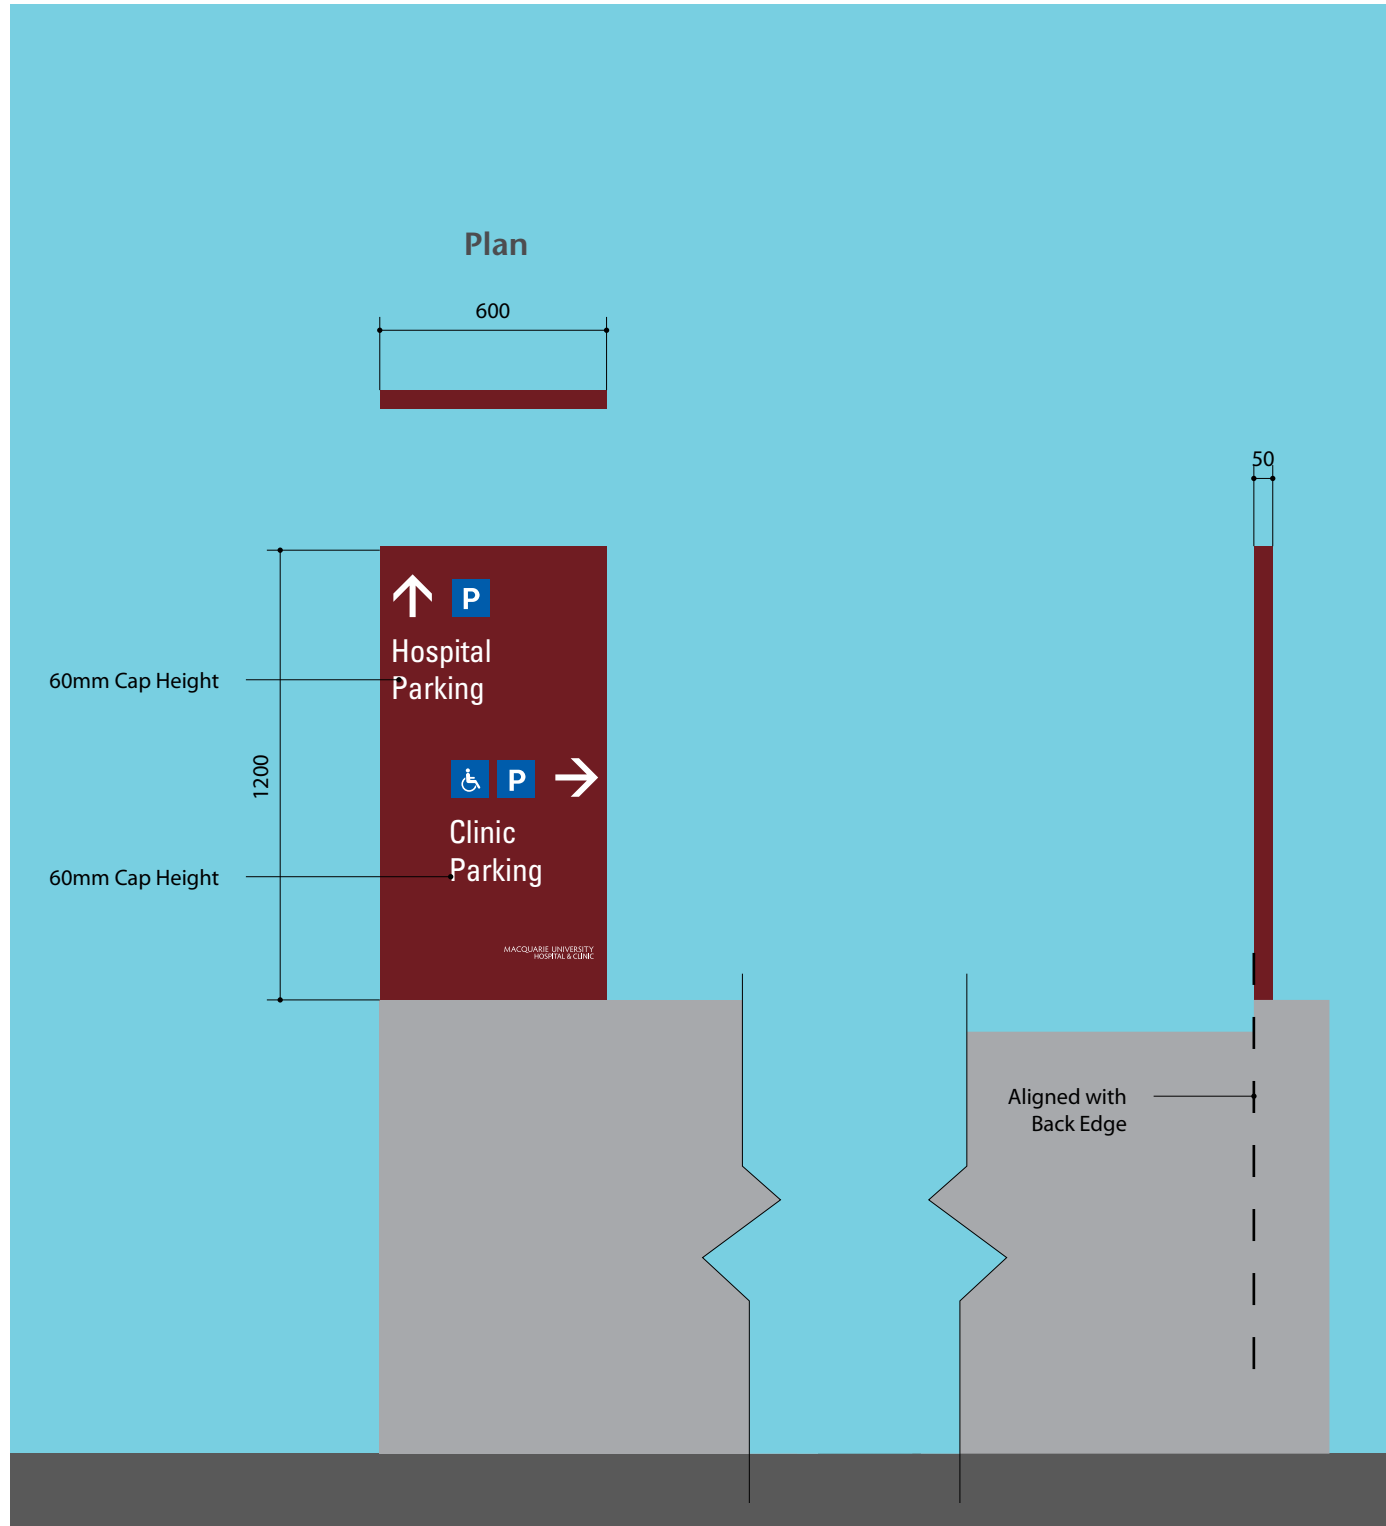
- NOTE

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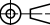


East Elevation

Side Elevation

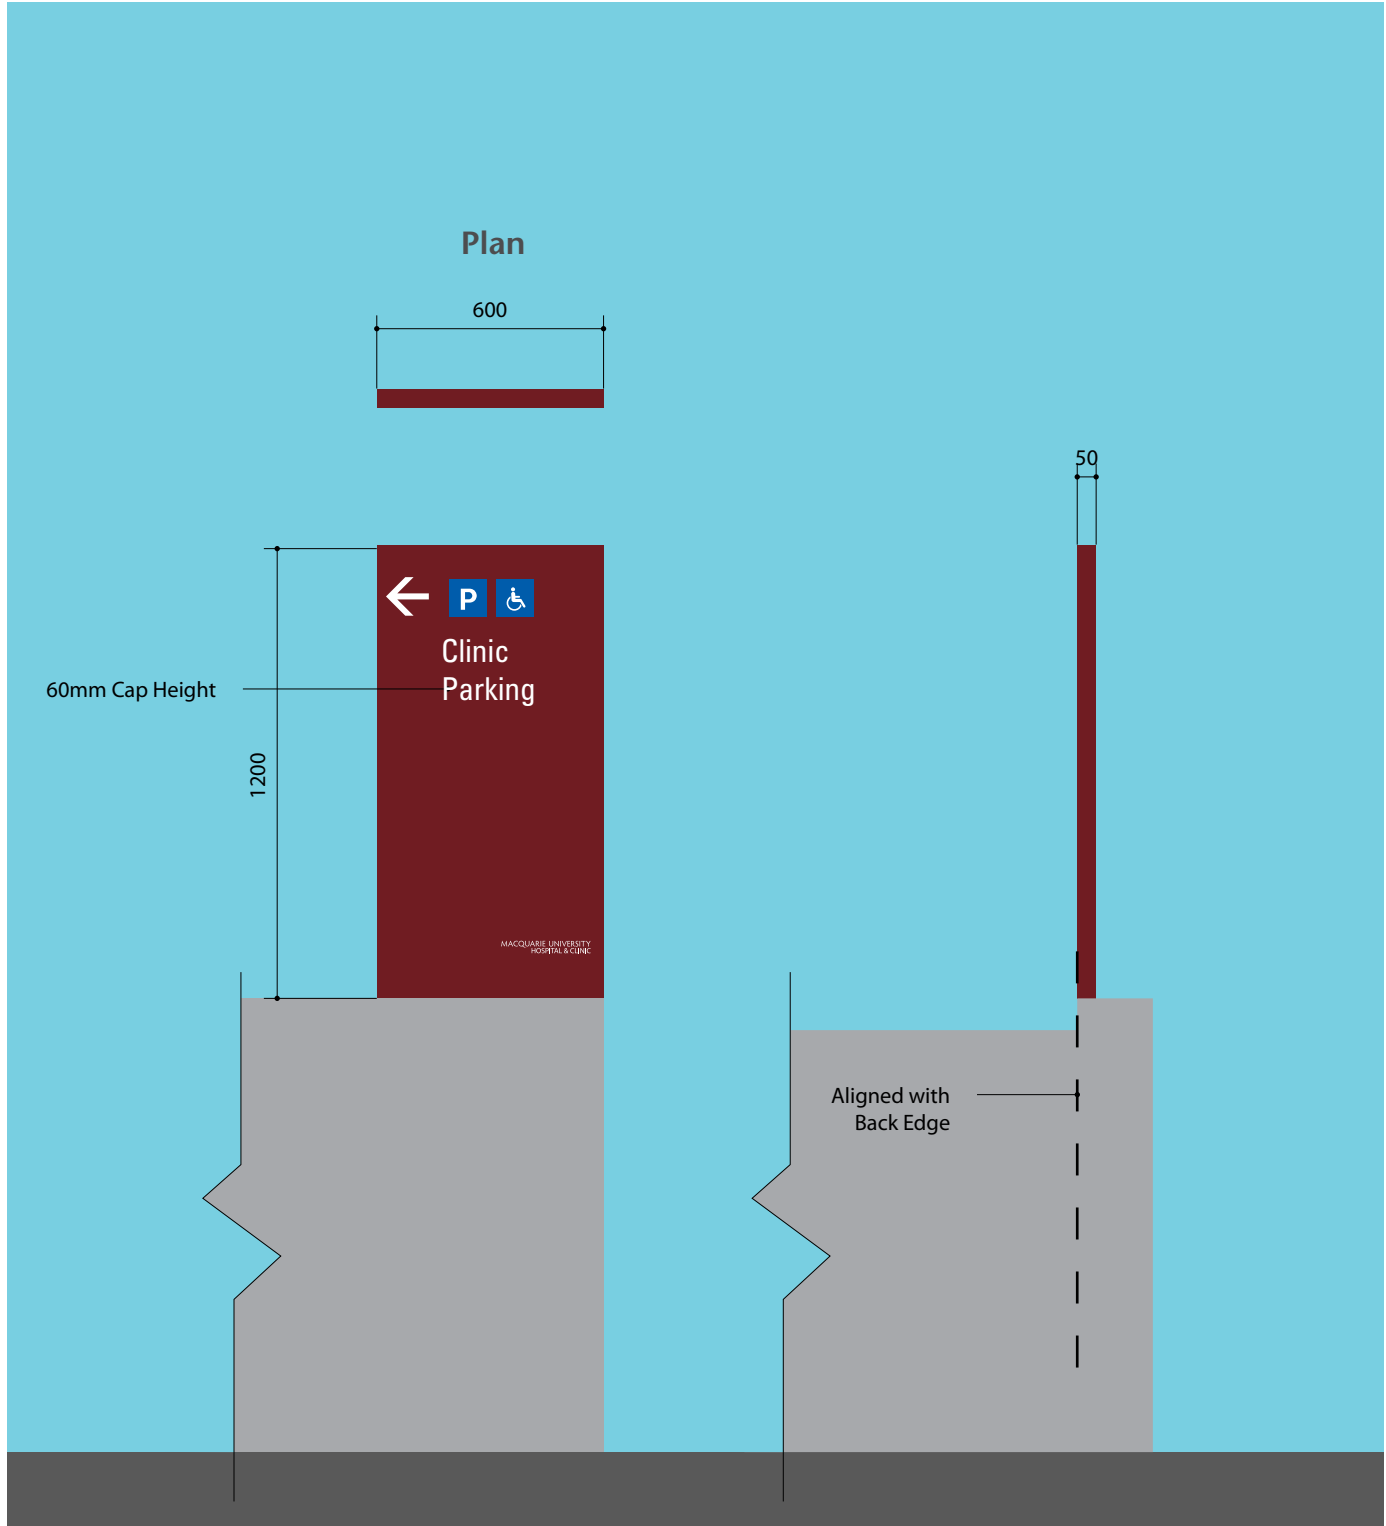
Total area east & west face 1.44sqm



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Job No. S3027		Dwg. 23		Issue D	Scale NTS/AS SHOWN

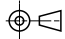
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West Elevation

Side Elevation

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Project: Macquarie University Hospital External Signage - DA Document					
Job No. S3027		Dwg. 24		Issue D	Scale NTS/AS SHOWN

NOTE

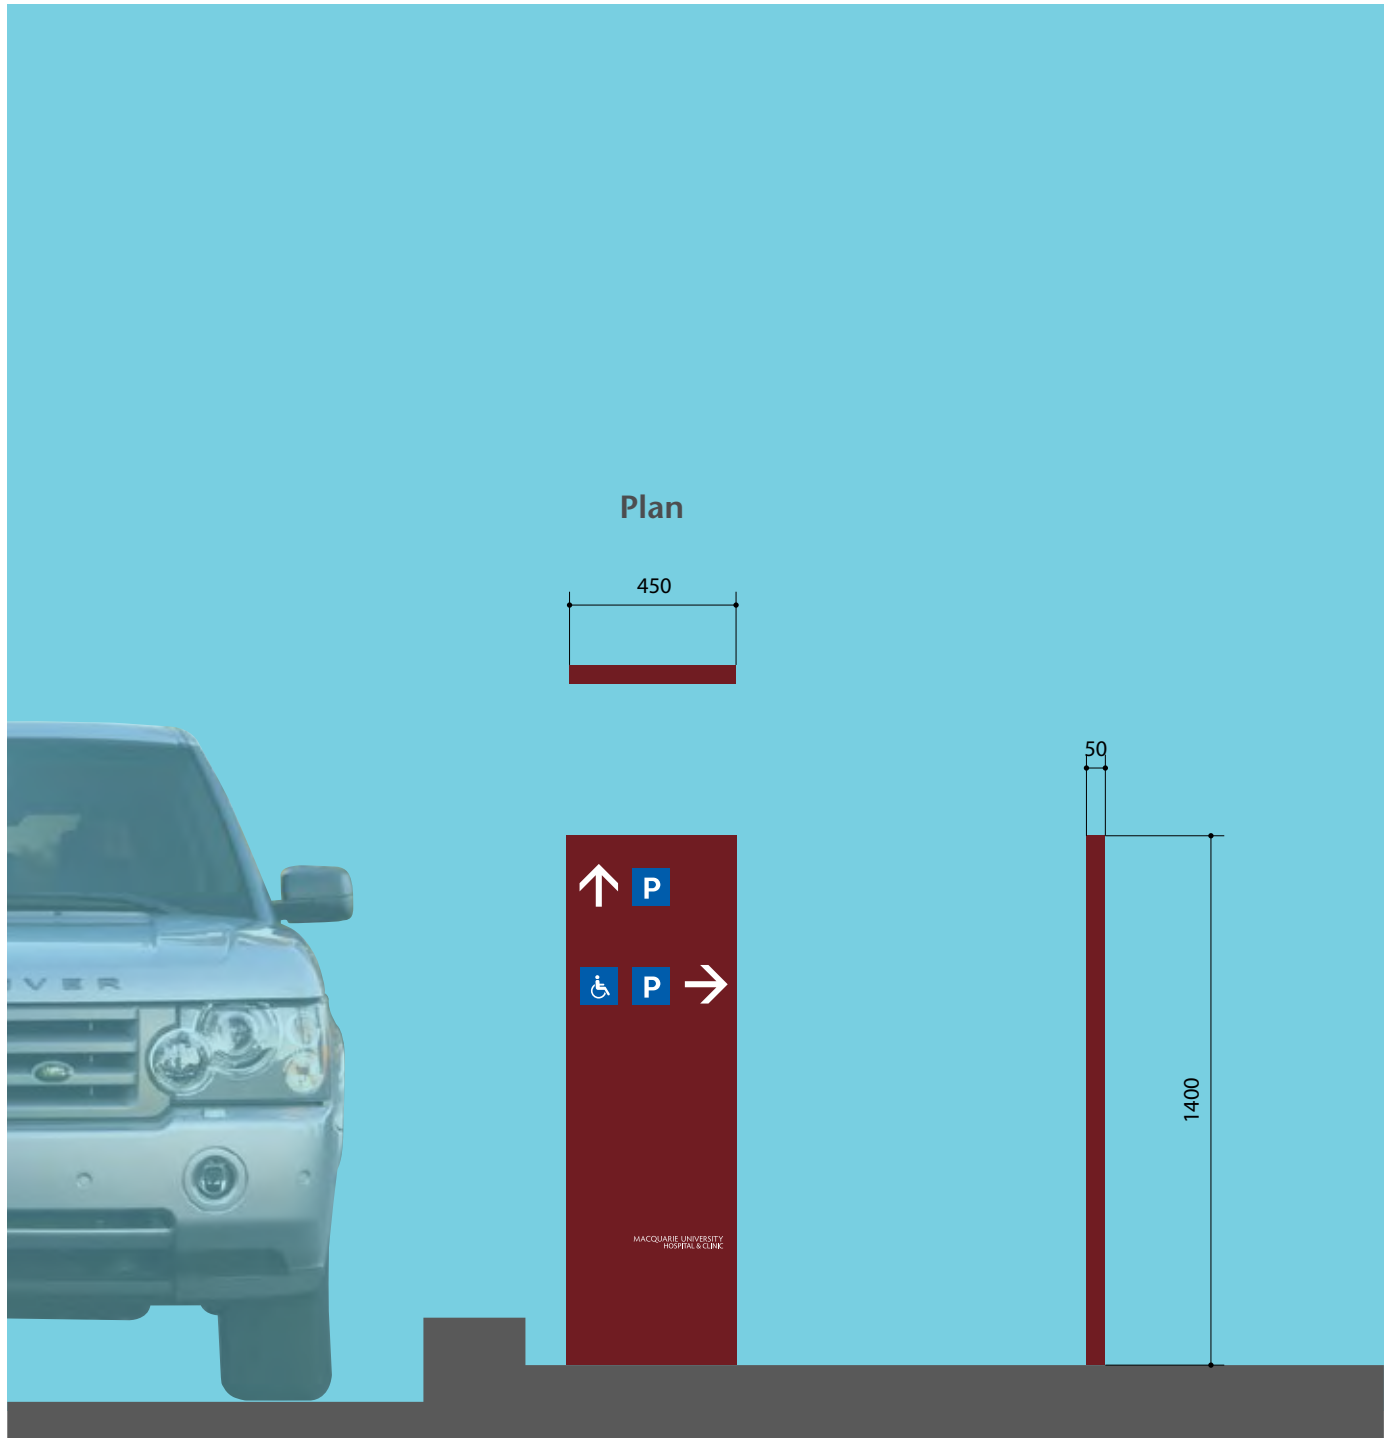
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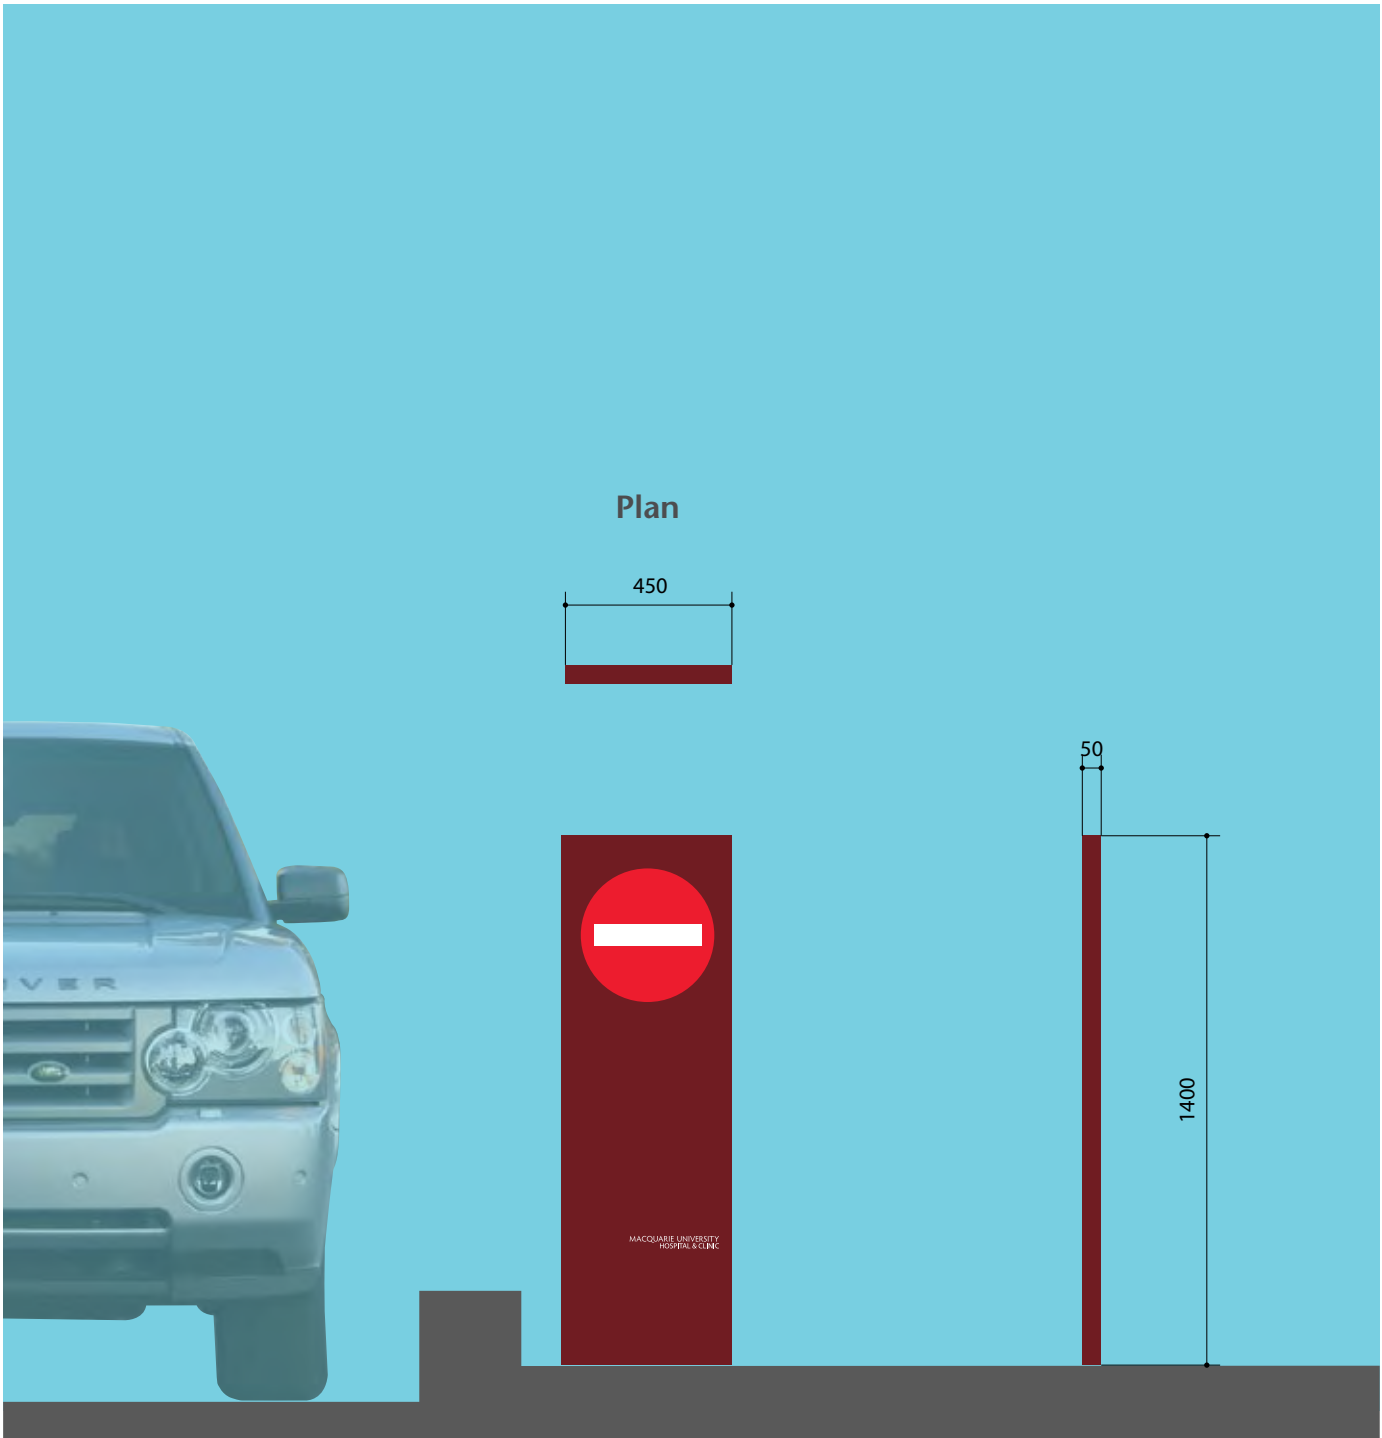
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


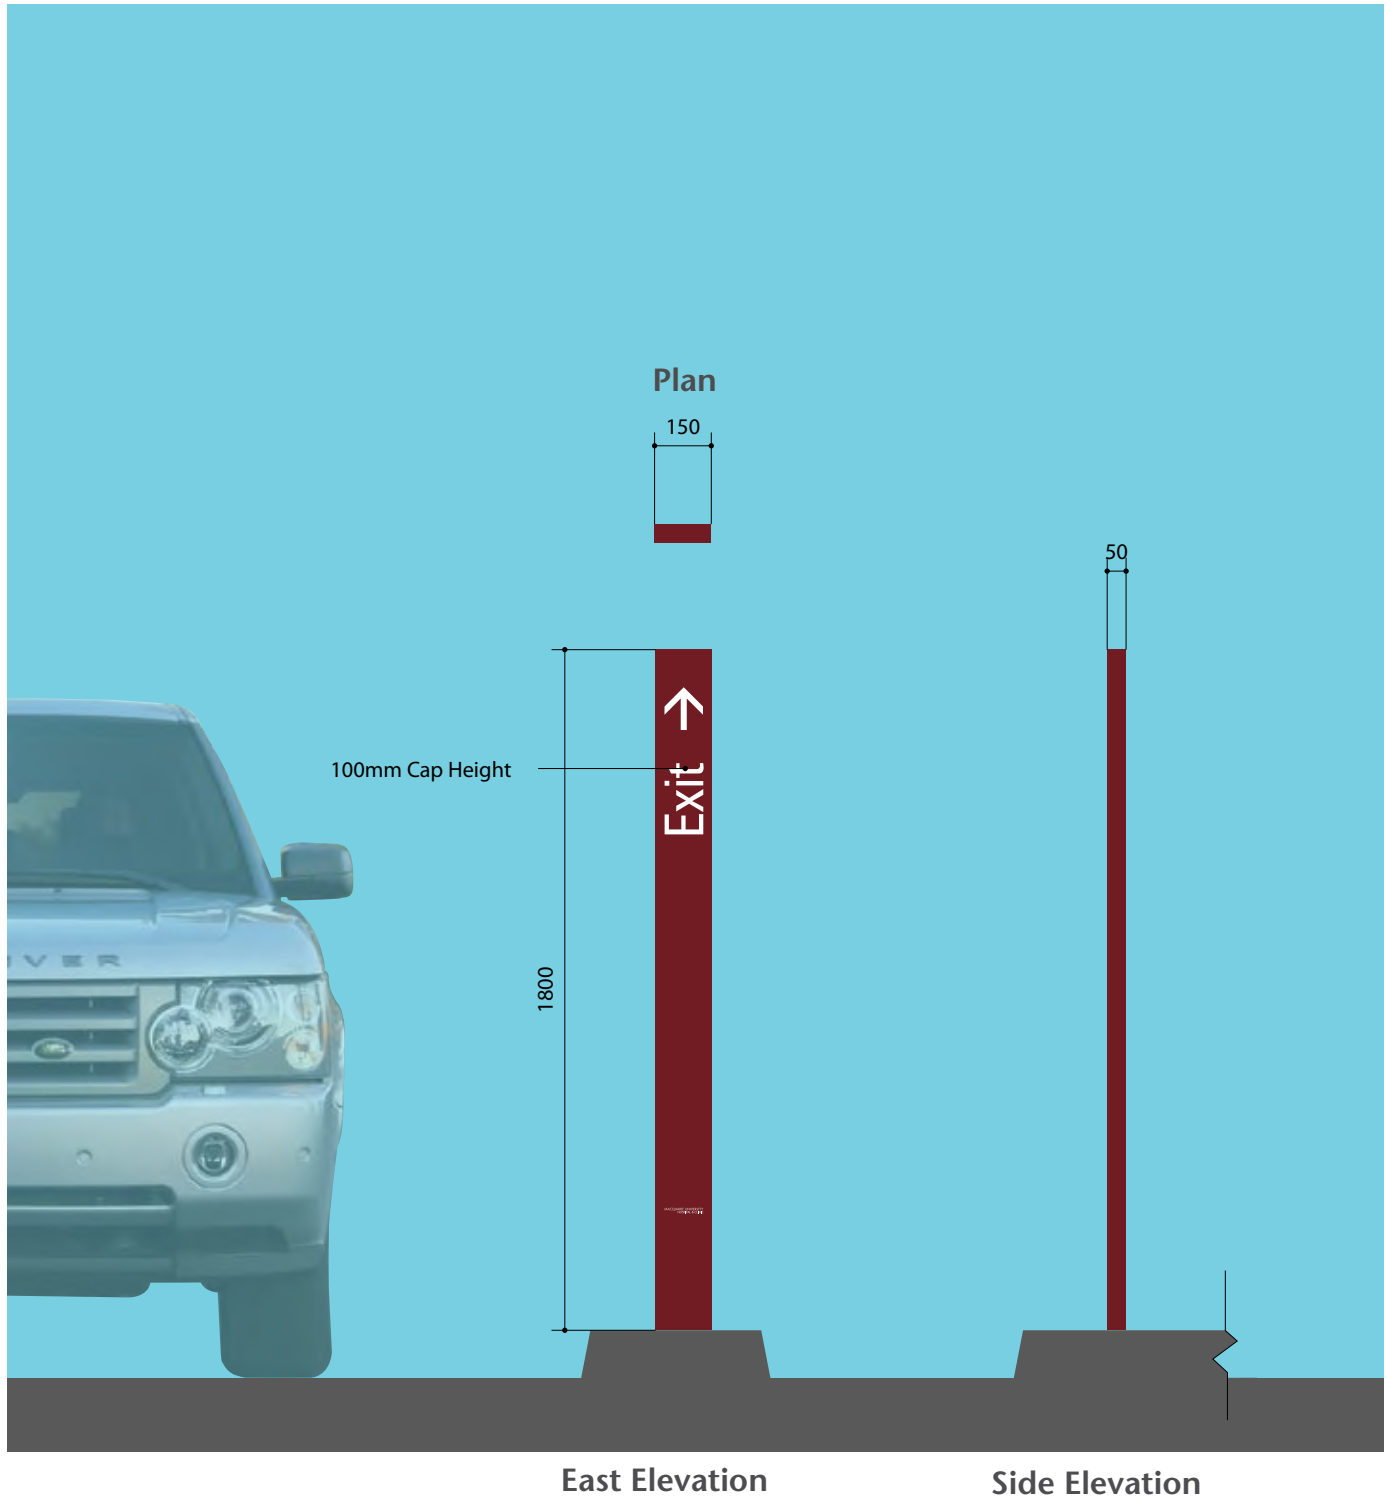
South Elevation Side Elevation

Total area north & south face 1.12sqm

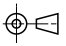


North Elevation Side Elevation

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Drawn: SD		Checked: HG	Sheet 1 of 1
Date: 17.11.09			
Client: Aurora Projects Pty Ltd			A3
Project: Macquarie University Hospital External Signage - DA Document			
Do not scale Dimensions in mm			
Job No. S3027	Dwg. 25	Issue D	Scale NTS/AS SHOWN



Total area west face 0.27sqm

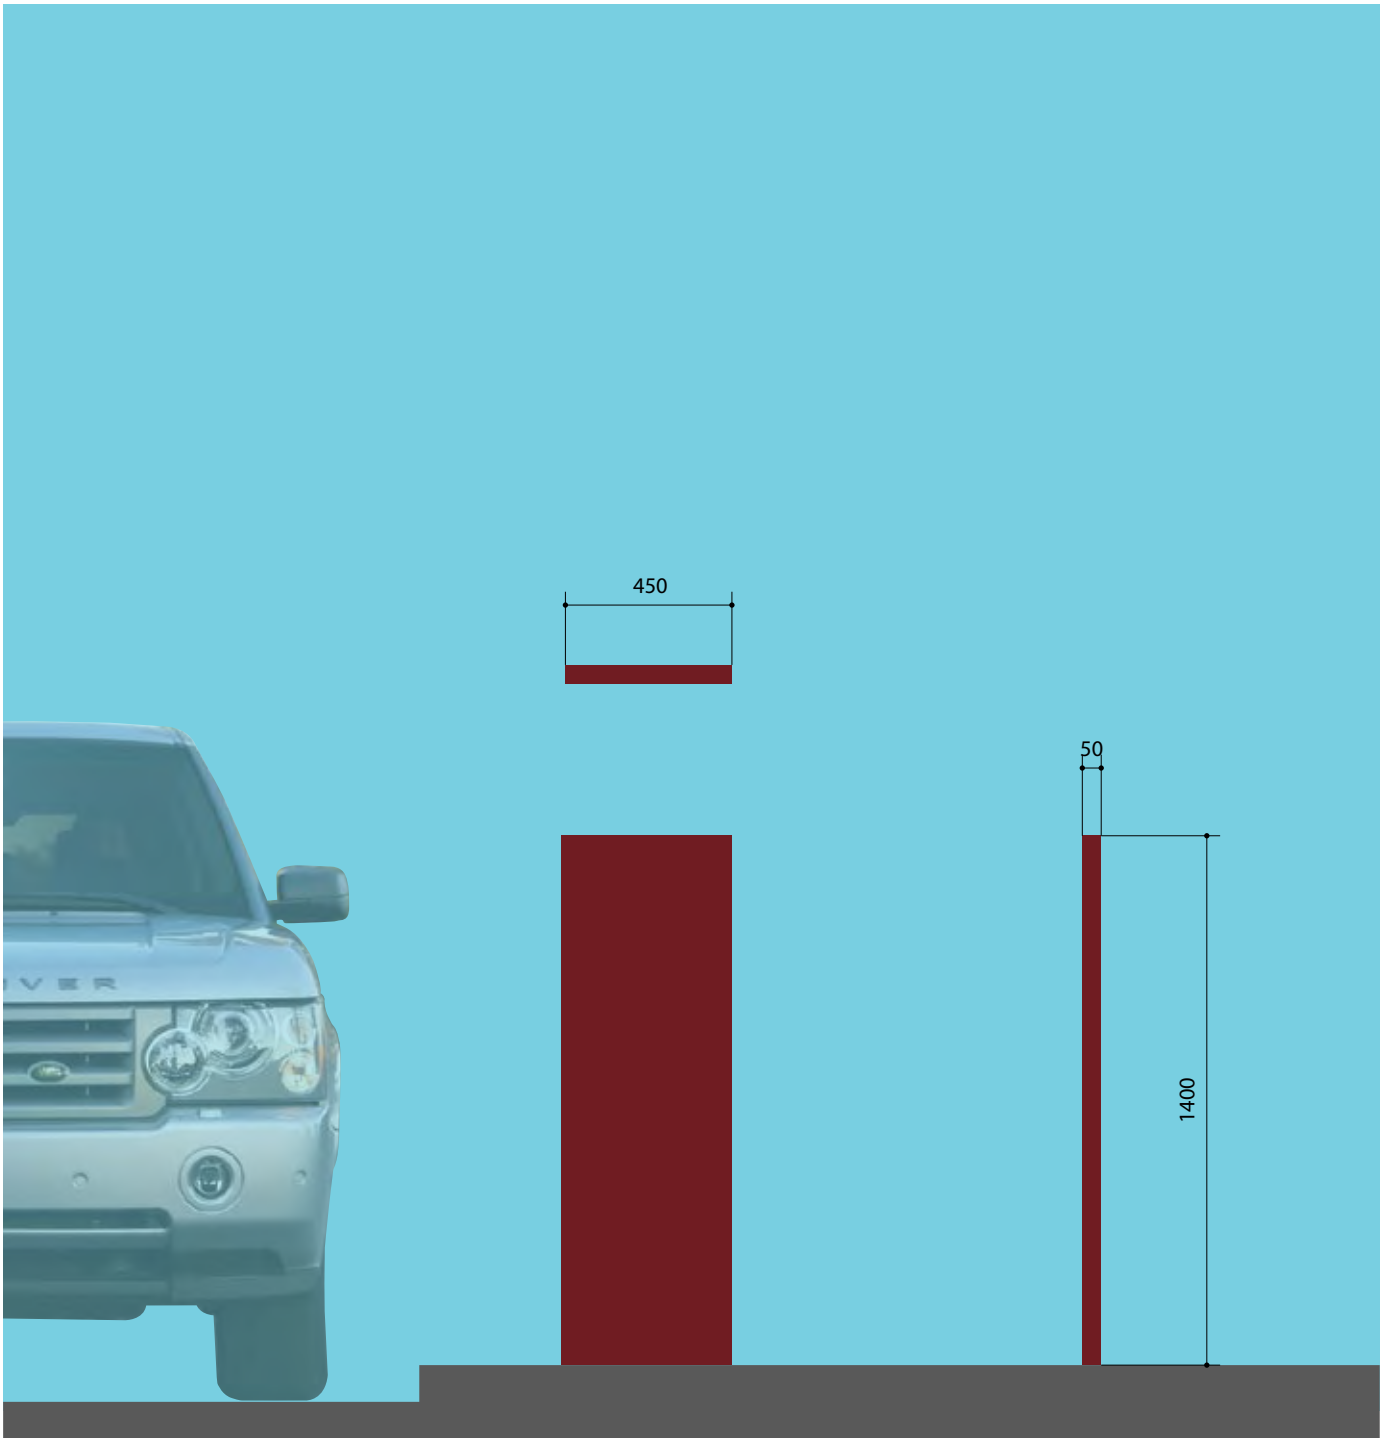
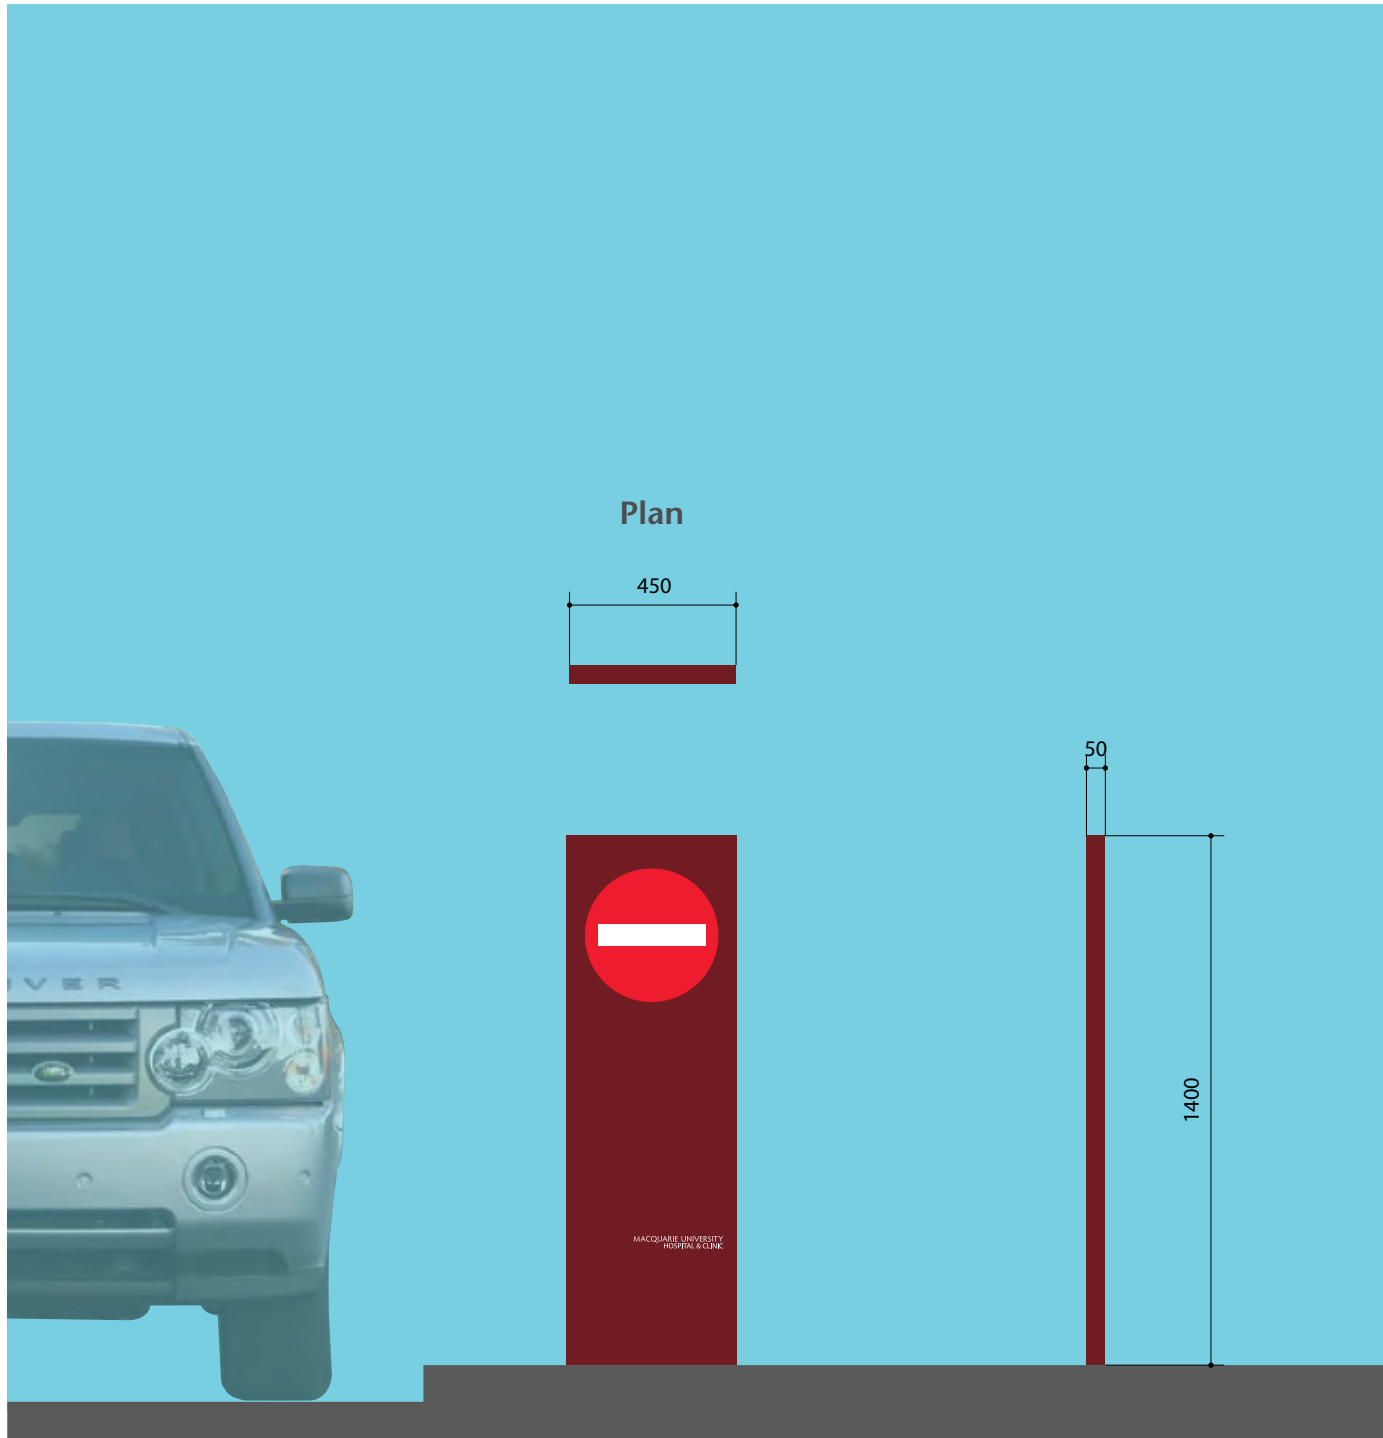
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Project: Macquarie University Hospital External Signage - DA Document			
Job No. S3027		Dwg. 26	Issue D
			Scale NTS/AS SHOWN

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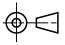
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West Elevation Side Elevation

East Elevation Side Elevation

Total area west & east face 1.12sqm

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Client: Aurora Projects Pty Ltd Project: Macquarie University Hospital External Signage - DA Document				 A3
				Do not scale Dimensions in mm
Job No. S3027		Dwg. 27	Issue D	Scale NTS/AS SHOWN

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- C1

Main Entry Marker - Double Sided

Solid concrete base articulated with vertical recesses.
Concrete footing to engineers details and certification.
Galvanised internal frame mechanically fixed to concrete base.
Cladding in aluminium sheeting or composite paneling.
Intracut graphics with flush opal acrylic.
Coloured graphics applied with translucent vinyl.
Internally illuminated with Fluorescent tubes or similar.
Graphics in lower part of sign to be confirmed.
- C2

Freestanding Directional Marker - Double Sided

Solid concrete base articulated with vertical recesses.
Concrete footing to engineers details and certification.
Galvanised internal frame mechanically fixed to concrete base.
Cladding in aluminium sheeting or composite paneling.
Intracut graphics with flush opal acrylic.
Coloured graphics applied with translucent vinyl.
Internally illuminated with Fluorescent tubes or similar.
Graphics to be confirmed.
- C3

Individually Fabricated Letters

Max. 150mm deep, individually concealed fixing.
Metal letters with opal (white) acrylic faces.
Colour of metal letters satin PMS1817 Deep Red.
Internal illumination with LED subject to sample.
Power cabling surface mounted with cover/colour to match colour of feature brick work.
- C4

Wall Mounted Clinic Loading Dock Identification

Standard aluminium extrusion, 250mm deep.
Flexface type-frameless- vinyl, mask and spray graphics.
Internal illumination with cool white FL tubes.
Sign frame painted PMS1817 Deep Red.
Height restriction bar by others

- C5

Wall Mounted Clinic Carpark Identification

Standard aluminium extrusion, 250mm deep.
Flexface type-frameless- vinyl, mask and spray graphics.
Internal illumination with cool white FL tubes.
Sign frame painted PMS1817 Deep Red.
Height restriction bar by others
- C6

Freestanding Directional Marker - Double Sided

Solid concrete base articulated with vertical recesses.
Concrete footing to engineers details and certification.
Galvanised internal frame mechanically fixed to concrete base.
Cladding in aluminium sheeting or composite paneling.
Intracut graphics with flush opal acrylic.
Coloured graphics applied with translucent vinyl.
Internally illuminated with Fluorescent tubes or similar.
Graphics to be confirmed.
- C7

Freestanding Directional Marker - Double Sided

Galvanised internal frame mechanically fixed to concrete base.
Cladding in aluminium sheeting or composite paneling.
Graphics to be white vinyl (not matt) or 3M Scotchlite whiye reflective. Graphics to be confirmed.
Sign is non illuminated.
- C8

Freestanding Directional Marker - Double Sided

Galvanised internal frame mechanically fixed to concrete base.
Cladding in aluminium sheeting or composite paneling.
Graphics to be white vinyl (not matt) or 3M Scotchlite whiye reflective. Graphics to be confirmed.
Sign is non illuminated.

- C9

Freestanding Exit Marker

Galvanised internal frame mechanically fixed to concrete base.
Concrete footing to engineers details and certification.
Cladding in aluminium sheeting or composite paneling.
Graphics to be white vinyl (not matt) or 3M Scotchlite whiye reflective. Graphics to be confirmed.
Sign is non illuminated.
- C10

Freestanding Directional Marker - Double Sided

Galvanised internal frame mechanically fixed to concrete base.
Cladding in aluminium sheeting or composite paneling.
Graphics to be white vinyl (not matt) or 3M Scotchlite whiye reflective. Graphics to be confirmed.
Sign is non illuminated.
- C11

Freestanding Directional Marker - Double Sided

Solid concrete base articulated with vertical recesses.
Concrete footing to engineers details and certification.
Galvanised internal frame mechanically fixed to concrete base.
Cladding in aluminium sheeting or composite paneling.
Intracut graphics with flush opal acrylic.
Coloured graphics applied with translucent vinyl.
Internally illuminated with Fluorescent tubes or similar.
Graphics to be confirmed.

H1

Individually Fabricated Letters

Max. 150mm deep, individually concealed fixing.
Metal letters with opal (white) acrylic faces.
Colour of metal letters satin PMS1817 Deep Red.
Internal illumination with LED subject to sample.
Power cabling surface mounted with cover/colour to match colour of feature brick work.

H2

Wall Mounted Hospital Carpark Identification

Standard aluminium extrusion, 250mm deep.
Flexface type-frameless- vinyl, mask and spray graphics.
Internal illumination with cool white FL tubes.
Sign frame painted PMS1817 Deep Red.
Height restriction bar by others.

H3

Directional Sign to Hospital Loading Dock

4 mm aluminium panel mask and spray.
Nom.40x40 shs frame behind.
Sign is non illuminated.

H4

Wall Mounted Hospital Loading Dock Identification

4 mm aluminium panel mask and spray.
Nom.100x40 rhs frame behind, 100mm deep.
Sign is non illuminated.

Macquarie University Hospital & Clinic
Identification and Directional Signage

- C1

Main Entry Marker - Double Sided
11000 mm x 2750 mm x 600 mm
60.5 sqm
- C3

Individually Fabricated Letters
11180 mm x 1533 mm x 150 mm
14.7 sqm
- H1

Individually Fabricated Letters
11180 mm x 1533 mm x 150 mm
14.7 sqm

Total Signage Area: 89.9 sqm

Macquarie University Hospital & Clinic
Loading Dock Signage

- C4

Wall Mounted Clinic Loading Dock Identification
3500 mm x 600 mm x 250 mm
2.1 sqm
- H4

Wall Mounted Hospital Loading Dock Identification
12000 mm x 1200 mm x 4 mm
14.4 sqm

Total Signage Area: 16.5 sqm

Macquarie University Hospital & Clinic
Directional Signage

- C2

Freestanding Directional Marker - Double Sided
3000 mm x 750 mm x 150 mm
4.5 sqm
- H3

Directional Sign to Hospital Loading Dock
2400 mm x 1200 mm x 4 mm
2.88 sqm
- C6

Freestanding Directional Marker - Double Sided
3000 mm x 750 mm x 150 mm
4.5 sqm
- C7

Freestanding Directional Marker - Double Sided
1200 mm x 600 mm 50 mm
1.44 sqm
- C8

Freestanding Directional Marker - Double Sided
1400 mm x 400 mm 50 mm
1.12 sqm
- C9

Freestanding Exit Marker
1800 mm x 150 mm x 50 mm
0.27 sqm
- C10

Freestanding Directional Marker - Double Sided
1400 mm x 400 mm 50 mm
1.12 sqm
- C11

Freestanding Directional Marker - Double Sided
3000 mm x 750 mm x 150 mm
4.5 sqm

Total Signage Area: 20.33 sqm

Macquarie University Hospital & Clinic
Carpark Signage

- C5

Wall Mounted Clinic Carpark Identification
7775 mm x 1475 mm x 250 mm
11.5 sqm
- H2

Wall Mounted Hospital Carpark Identification
11200 mm x 1200 mm x 250 mm
13.44 sqm

Total Signage Area: 24.94 sqm