20009DA - 104-116 REGENT STREET, REDFERN

Development Application


WEE HUR June 2022

Council City of Sydney Lot & DP DP 1026349

Zoning B3 Site Area 1366m²

Drawing Schedule

Sheet Number	Sheet Name	Revision	Rev Date
DA1.01	Site Analysis	В	13.12.2021
DA1.03	Setbacks - Site Plan	В	13.12.2021
DA1.04	Setbacks - Levels	D	08.06.2022
DA2.01	Demolition Plan - Ground Floor	В	13.12.2021
DA3.01	Site Plan	E	08.06.2022
DA3.02	Level 01/Level 02	E	08.06.2022
DA3.03	Level 03 /Level 04	E	08.06.2022
DA3.04	Level 05 to 08/ Level 09 to 15	E	08.06.2022
DA3.05	Level 16 /Level 17 to 18	E	08.06.2022
DA3.06	Plant Level/Roof Level	F	08.06.2022
DA4.01	Long Section + Short Section	D	08.06.2022
DA5.01	Regent St - Elevation	E	08.06.2022
DA5.02	Northern Elevation + Southern Elevation	E	08.06.2022
DA5.03	William Ln - Elevation	E	08.06.2022
DA6.01	Project Data Schedule	G	08.06.2022
DA6.02	Shadow Diagrams - 21 JUNE 2022.1	D	08.06.2022
DA6.03	Shadow Diagrams - 21 JUNE 2022.2	В	08.06.2022
DA6.05	Gross Building Area Calculation	С	08.06.2022
DA7.01	CGIs	С	08.06.2022
DA7.02	Material Board	Е	08.06.2022
DA7.03	Signage Details	D	08.06.2022
DA8.01	Notification Plan	Α	13.12.2021
Total: 22			

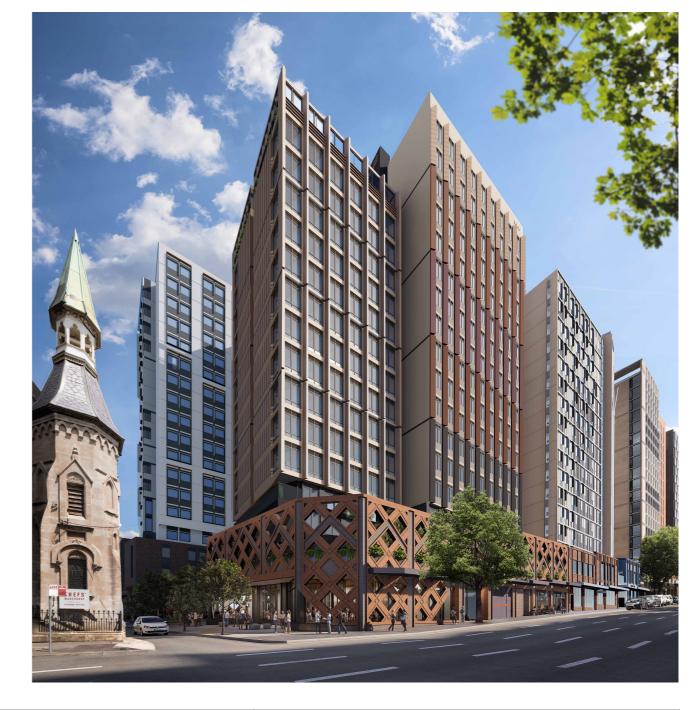

BASIX Commitments

COMMITMENTS FOR RESIDENTIAL FLAT BUILDINGS					COMMITMENTS FOR COMMON AREAS AND CENTRAL SYSTEMS/	FACILITIES FOR THE DEVELOPMENT (NON-BUILDING SPECIFIC)
DWELLINGS			COMMON AREAS AND CENTRA	AL SYSTEMS/FACILITIES	COMMON AREAS AND CENTRAL SYSTEMS/FACILITIES	
WATER	ENERGY	THERMAL COMFORT	WATER	ENERGY	WATER COMMITMENTS	ENERGY COMMITMENTS
The applicant must comply with the commitments listed below in carrying out the development of a dwelling listed in the BASIX certificate. The applicant must plant indigenous or low water use species of vegetation throughout the area of land specified for the dwelling in the "Indigenous species" column of the BASIX table, as private landscaping for that dwelling. (This area of indigenous vegetation is to be contained within the "Area of garden and lawn" for the dwelling specified in the "Description of Project" table). The applicant must not install a private swimming pool or spa for the dwelling, with a volume exceeding that specified for it in the BASIX certificate. The applicant must install, for the dwelling, each alternative water supply system, with the specified size, listed for that dwelling in the table of the BASIX certificate Each system must be configured to collect run-off from the areas specified (excluding any area which supplies any other alternative water supply system), and to divert overflow as specified. Each system must be connected as specified.	The applicant must install each hot water system specified for the dwelling in the table of the BASIX certificate, so that the dwelling is hot water is supplied by that system. If the table specifies a central hot water system for the dwelling, then the applicant must connect that central system to the dwelling, so that the dwelling's hot water is supplied by that central system. This commitment applies to each room or area of the dwelling which is referred to in a heading to the "Natural lighting" column of the table in the BASIX certificate, (but only to the extent specified for that room or area). The applicant must ensure that each such room or area is fitted with a window and/or skylight.	- The development will be a Class 3 building. The applicant must include in the documentation accompanying the application for a construction certificate (or complying development certificate, if applicable), a report demonstrating that the development will meet Section J of the National Construction Code - Volume 1.	The applicant must install (or ensure that the development is serviced by) the alternative water supply system(s) specified in the "Central systems" column of the table in the BASIX certificate. In each case, the system must be sized, be configured, and be connected, as specified in the table. A swimming pool or spa listed in the table must not have a volume (in kLs) greater than that specified for the pool or spa in the table.	The applicant must install the systems and fixtures specified in the "Central energy systems" column of the table in the BASIX certificate. In each case, the system or fixture must be of the type, and meet the specifications, listed for it in the table.	The applicant must install (or ensure that the development is serviced by) the alternative water supply system(s) specified in the "Central systems" column of the table of the BASIX certificate. In each case, the system must be sized, be configured, and be connected, as specified in the table. A swimming pool or spa listed in the table must not have a volume (in kLs) greater than that specified for the pool or spa in the table.	The applicant must install the systems and fixtures specified in the "Central energy systems" column of the table in the BASIX certificate. In each case, the system or fixture must be of the type, and meet the specifications, listed for it in the table.

Refer to BASIX certificate for more information

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Issued for revised DA submission

25 13 24 ANTONIADES ARCHITECTS

Nominated Architect: Andreas Antoniac
 NSW Registration 798

DEVELOPMENT APPLICATION

FOR SUBMISSION

PROJECT NO.

20009DA

PROJECT

REGENT STREET

ADDRESS

104-116 REGENT STREET

Overa

Overall Plans


Cover Page

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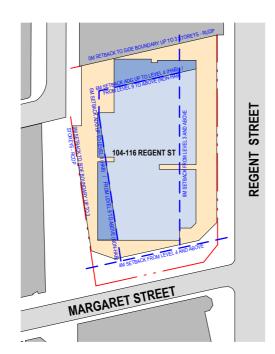
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SCALE NTS @A3






Floor Plan 1:800

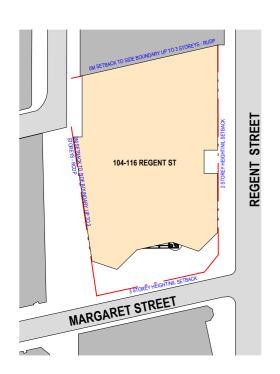


Setbacks- Level 02 to 03

Floor Plan 1:800

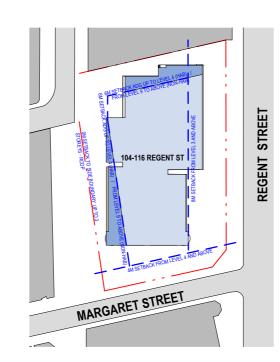


Setbacks- Level 04

Floor Plan 1:800

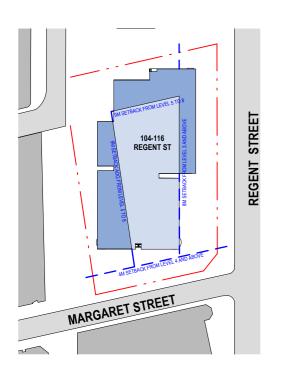


Setbacks - Level 05 to 08

Floor Plan 1:800

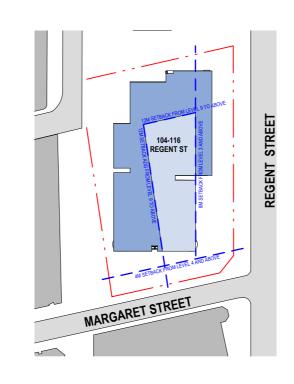


Setbacks - Level 09 to 16

Floor Plan 1:800

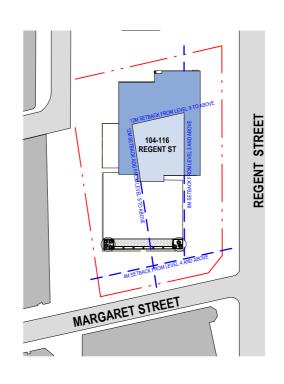

Setbacks - Level 17 and Above

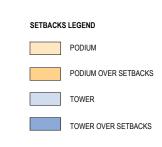

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DATE 25.11.2021 13.12.2021 24.05.2022 08.06.2022



DEVELOPMENT APPLICATION

FOR SUBMISSION

PROJECT NO. 20009DA
PROJECT
REGENT STREET ADDRESS 104-116 REGENT STREET CLIENT WEE HUR

DRAWING SERIES Site Information

Setbacks - Levels

DA1.04 0m 6.4 Scale 1:800





ABBREVIATIONS LEGEND

ACC. = Comms Cupboard/Riser
CH = Garbage Chute
COMMS = Communication Services
E = Electrical Cupboard/Riser
FB = Fire Brigade Booster Assembly
FCR = Fire Control Room
FPR = Fire Sprinkler Riser
H = Hydraulic Riser
KE = Kitchen Exhaust
LR = Stair Pressurisation Relief Shaft
MCP = Mechanical Condenser Plant
MSB Room = Main SwitchBoard Room
O/SE = Oil Separator
OSD = On-Site Detention (Tank)
RF = Mechanical Refrigerant Riser
SP = Stair Pressurisation Shaft
TH = Tower Main Hydraulic Riser
WC = Water Closet

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 DESCRIPTION
 BY
 DATE

 A
 Issued for information
 29.10.2021

 B
 Issued for coordination
 25.11.2021

 C
 Issued for DA Submission
 13.12.2021

 D
 Issued for Coordination
 24.05.2022

 E
 Issued for revised DA submission
 08.06.2022

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NSW Registration 7954

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ACN 129 731 559

PROJECT PHASE
DEVELOPMENT
APPLICATION
STATUS
FOR SUBMISSION

PROJECT NO.
20009DA

PROJECT
REGENT STREET

ADDRESS
104-116 REGENT STREET

CLIENT
WEE HUR

DRAWING SERIES
Overall Plans

DRAWING TITLE
Site Plan

DA3.01

SCALE

REVISION DRAWN BY
ZD
CHECKED BY
AA
NORTH
8 10m

90-102 REGENT STREET STREET 11 GIBBONS WILLIAM STREE REGENT OSD TANK BELOW — 13-23 GIBBONS STREET MARGARET STREET Level 1 (Ground) Floor Plan 1:200

90-102 REGENT STREET STREET 11 GIBBONS LOUVRED WALLS WITH MIN 50% FREE AREA STREET BUILDING SEPARATION OUTDOOR AREA 253 m² BUILDING SEPARATIL MARGARET STREET Level 02 Floor Plan 1:200

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DESCRIPTION DATE 29.10.2021 Issued for information Issued for coordination 25.11.2021 Issued for DA Submission 13.12.2021 Issued for Coordination 24.05.2022 08.06.2022 Issued for revised DA submission

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PROJECT PHASE DEVELOPMENT **APPLICATION** STATUS FOR SUBMISSION

PROJECT NO. 20009DA REGENT STREET ADDRESS 104-116 REGENT STREET WEE HUR

DRAWING SERIES **Overall Plans**

Level 01/Level 02

DRAWING NO. **DA3.02** REVISION

ABBREVIATIONS LEGEND

Comms Cupboard/Riser

Communication Services Electrical Cupboard/Riser

Fire Brigade Booster Assembly

Stair Pressurisation Relief Shaft Mechanical Condenser Plant

On-Site Detention (Tank)

Stair Pressurisation Shaft

Tower Main Hydraulic Riser Water Closet

ROOMS LEGEND:

Studio A Unit

Ensuite Unit

DDA Unit

Communal

Bicycle Parking

2 Bedroom Unit

Mechanical Refrigerant Riser

MSB Room = Main SwitchBoard Room

Accessible

Garbage Chute

Fire Control Room

Fire Pump Room

Fire Sprinkler Riser Hydraulic Riser Kitchen Exhaust

ACC. =

C = CH =

E = FB =

FPR =

FR =

OSD =

RF =

SP=

TH =

CHECKED BY

DRAWN BY

90-102 REGENT STREET STREET GIBBONS STREE 03.25 3 GIBBONS STREET 13-23 BUILDING SEPARATION MARGARET STREET

90-102 REGENT STREET GIBBONS STREET WILLIAM REGENT STREET 6340 BUILDING SEPARATION 04.02 13-23 GIBBONS STREET BUILDING SEPARATION MARGARET STREET

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Level 03

Floor Plan

DATE DESCRIPTION 29.10.2021 Issued for information Issued for coordination 25.11.2021 Issued for DA Submission 13.12.2021 Issued for Coordination 24.05.2022 08.06.2022 Issued for revised DA submission

1:200

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PROJECT PHASE DEVELOPMENT **APPLICATION** STATUS

FOR SUBMISSION

Level 04

Floor Plan

PROJECT NO. 20009DA **PROJECT** REGENT STREET ADDRESS 104-116 REGENT STREET WEE HUR

1:200

DRAWING SERIES **Overall Plans** Level 03 /Level 04

DRAWING NO. **DA3.03** 1:200

REVISION DRAWN BY

ABBREVIATIONS LEGEND

Comms Cupboard/Riser

Communication Services Electrical Cupboard/Riser

Fire Brigade Booster Assembly

Stair Pressurisation Relief Shaft Mechanical Condenser Plant

On-Site Detention (Tank)

Stair Pressurisation Shaft

ROOMS LEGEND:

Studio A Unit **Ensuite Unit**

2 Bedroom Unit

DDA Unit

Communal

Bicycle Parking

Tower Main Hydraulic Riser Water Closet

Mechanical Refrigerant Riser

MSB Room = Main SwitchBoard Room

Accessible

Garbage Chute

Fire Control Room Fire Pump Room

Fire Sprinkler Riser Hydraulic Riser Kitchen Exhaust

ACC. =

C = CH =

E = FB =

FPR = FR =

O/SE = OSD =

RF = SP=

TH =

CHECKED BY AA

90-102 REGENT STREET GIBBONS STREET WILLIAM REGENT STREET BUILDING SEPARATION MARGARET STREET



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PROJECT PHASE
DEVELOPMENT
APPLICATION
STATUS

FOR SUBMISSION

Level 09-15
Floor Plan

PROJECT NO.
20009DA
PROJECT
REGENT STREET

ADDRESS
104-116 REGENT STREET

CLIENT
WEE HUR

1:200

DRAWING SERIES
Overall Plans
DRAWING TITLE

Level 05 to 08/ Level 09 to 15

DA3.04

SCALE
1:200

REVISION DRAWN BY

ZD
CHECKED BY
AA
NORTH

ABBREVIATIONS LEGEND

C = CH =

E = FB =

FPR =

OSD =

TH =

Comms Cupboard/Riser

Communication Services Electrical Cupboard/Riser

Fire Sprinkler Riser Hydraulic Riser Kitchen Exhaust

Fire Brigade Booster Assembly

Stair Pressurisation Relief Shaft Mechanical Condenser Plant

On-Site Detention (Tank)

Mechanical Refrigerant Riser Stair Pressurisation Shaft

Tower Main Hydraulic Riser Water Closet

ROOMS LEGEND:

Studio A Unit

Ensuite Unit

Communal

Bicycle Parking

2 Bedroom Unit

MSB Room = Main SwitchBoard Room

Garbage Chute

SCALE
1: 200 @A1

Om 4 8 10m

Scale 1:200

90-102 REGENT STREET 90-102 REGENT STREET STREET 11 GIBBONS DA5.01 B BUILDING SEPARATION MARGARET STREET MARGARET STREET

ABBREVIATIONS LEGEND

ACC. = Comms Cupboard/Riser C = CH = Garbage Chute **Communication Services** Electrical Cupboard/Riser E = Fire Brigade Booster Assembly FB = Fire Control Room FPR = Fire Pump Room Fire Sprinkler Riser Hydraulic Riser Kitchen Exhaust Stair Pressurisation Relief Shaft Mechanical Condenser Plant MSB Room = Main SwitchBoard Room OSD = On-Site Detention (Tank) RF = Mechanical Refrigerant Riser SP= Stair Pressurisation Shaft Tower Main Hydraulic Riser Water Closet TH =

> **ROOMS LEGEND:** Studio A Unit

Ensuite Unit 2 Bedroom Unit Communal

Bicycle Parking

STREET

TAEGENT (DA5.01)

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Level 16 Floor Plan

1:200

DATE

22.10.2021

25.11.2021

13.12.2021

24.05.2022 08.06.2022

STREET

11 GIBBONS

13-23 GIBBONS STREET

BUILDING SEPARATION

WILLIAM

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ACN 129 731 559

PROJECT PHASE DEVELOPMENT **APPLICATION** STATUS

FOR SUBMISSION

NSW Registration 7954

Level 17 - 18

PROJECT NO. 20009DA **REGENT STREET** ADDRESS 104-116 REGENT STREET WEE HUR

1:200

DRAWING SERIES **Overall Plans** Level 16 /Level 17 to 18

DRAWING NO. **DA3.05**

REVISION DRAWN BY CHECKED BY

90-102 REGENT STREET STREET 11 GIBBONS WILLIAM DA5.03 1 1 **Q**DA5.01 **B** FIRE PUMP ROOM BUILDING SEPARATION 13-23 GIBBONS STREET MARGARET STREET Plant Level 1:200

90-102 REGENT STREET 11 GIBBONS STREET WILLIAM LANE PL 83-400 OPEN TO SKY REGENT STREET DA5.03 1 MESH ROOF 42 SOLAR PANELS BUILDING SEPARATION RL. 85.100 13-23 GIBBONS STREET MARGARET STREET Roof Level 1:200

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Nominated Architect: Andreas Antoniades.com.au

ACN 129 731 559

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PROJECT PHASE
DEVELOPMENT
APPLICATION
STATUS

FOR SUBMISSION

PROJECT NO.
20009DA

PROJECT

REGENT STREET

ADDRESS
104-116 REGENT STREET

CLIENT
WEE HUR

Overall Plans

DRAWING TITLE

Plant Level/Roof Level

DRAWING NO.

DA3.06

SCALE
1:200

REVISION DRAWN BY

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AA
NORTH

ABBREVIATIONS LEGEND

Comms Cupboard/Riser

Garbage Chute Communication Services

Electrical Cupboard/Riser

Fire Control Room

Fire Pump Room

Fire Sprinkler Riser Hydraulic Riser Kitchen Exhaust

Fire Brigade Booster Assembly

Stair Pressurisation Relief Shaft Mechanical Condenser Plant

On-Site Detention (Tank)

Stair Pressurisation Shaft

Tower Main Hydraulic Riser Water Closet

ROOMS LEGEND:

Studio A Unit

Ensuite Unit

DDA Unit

Communal

Bicycle Parking

2 Bedroom Unit

Mechanical Refrigerant Riser

MSB Room = Main SwitchBoard Room

Accessible

ACC. =

C =

CH =

E =

FB = FCR =

FPR =

FR =

LR =

O/SE = OSD =

RF =

SP=

TH =



ABBREVIATIONS LEGEND

Accessible Comms Cupboard/Riser C = CH = Garbage Chute Communication Services Electrical Cupboard/Riser E = FB = Fire Brigade Booster Assembly Fire Control Room FPR = Fire Pump Room FR = Fire Sprinkler Riser Hydraulic Riser KE = Kitchen Exhaust Stair Pressurisation Relief Shaft Mechanical Condenser Plant MSB Room = Main SwitchBoard Room OSD = On-Site Detention (Tank) RF = Mechanical Refrigerant Riser SP= Stair Pressurisation Shaft Tower Main Hydraulic Riser TH = Water Closet

ROOMS LEGEND:

Studio A Unit **Ensuite Unit** 2 Bedroom Unit DDA Unit

Communal Bicycle Parking

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BY DATE 29.10.2021 13.12.2021 24.05.2022 08.06.2022

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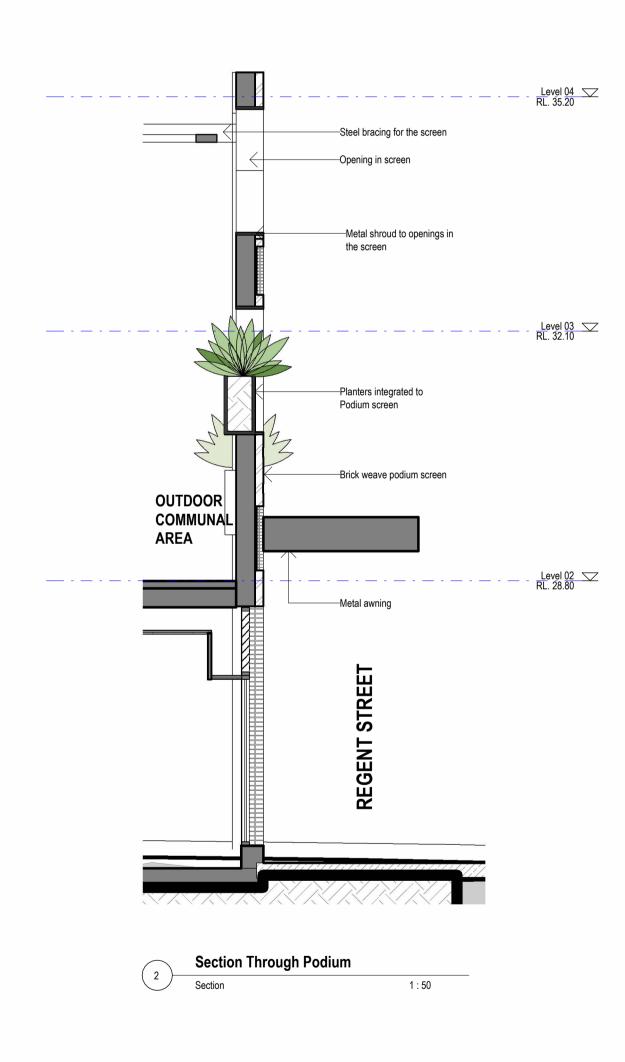
PROJECT PHASE DEVELOPMENT **APPLICATION** FOR SUBMISSION

PROJECT NO. 20009DA REGENT STREET ADDRESS 104-116 REGENT STREET WEE HUR

DRAWING SERIES **Sections** Long Section + Short Section

DRAWING NO. REVISION DRAWN BY **DA4.01** CHECKED BY 1:200





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ANTONIADES ARCHITECTS

Nominated Architect: Andreas Antoniades

NSW Registration 7954

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ACN 129 731 559

PROJECT PHASE
DEVELOPMENT
APPLICATION
STATUS

FOR SUBMISSION

PROJECT NO.
20009DA

PROJECT

REGENT STREET

ADDRESS
104-116 REGENT STREET

CLIENT
WEE HUR

DRAWING SERIES
Elevations

DRAWING TITLE
Regent St - Elevation

DRAWING NO.

DA5.01


REVISION


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As indicated

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Reckli Artwork callout

Drafting View 1:1

North Elevation

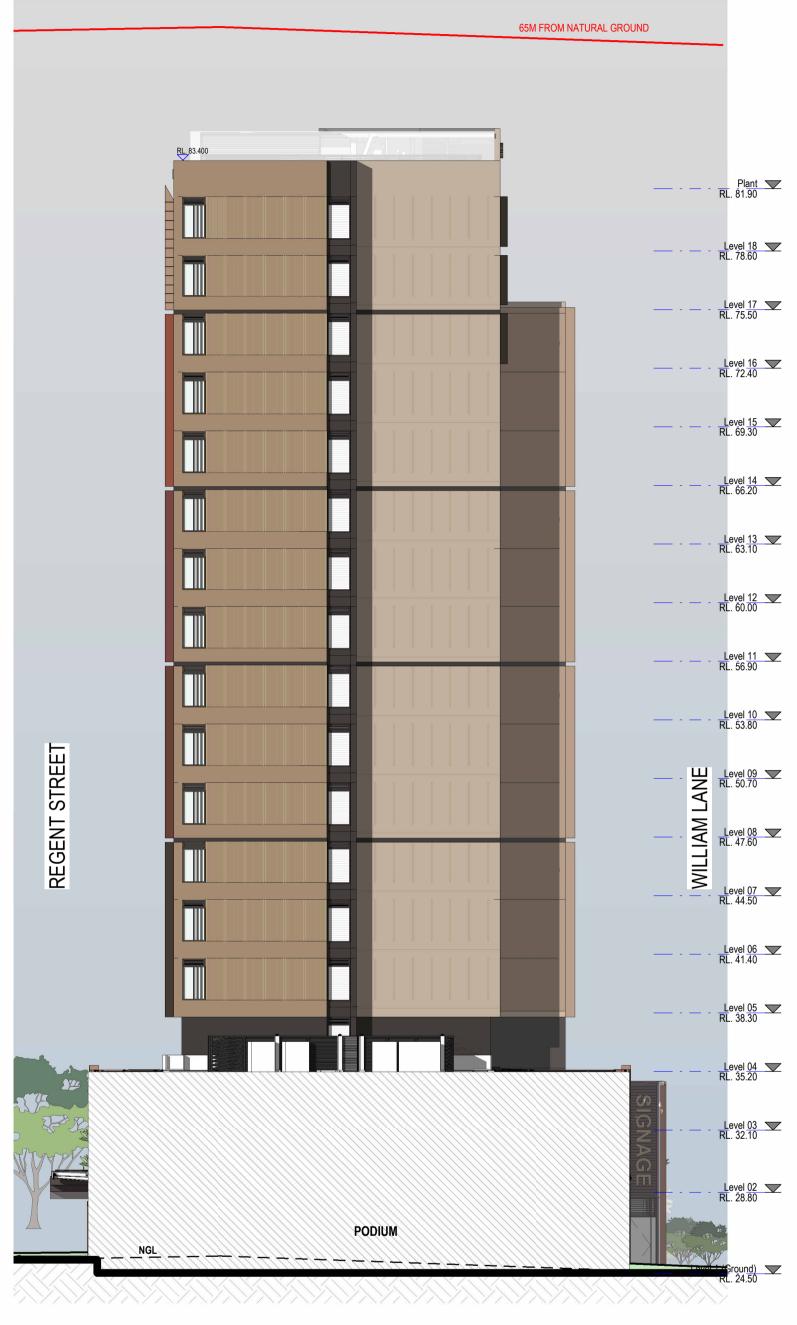1:200

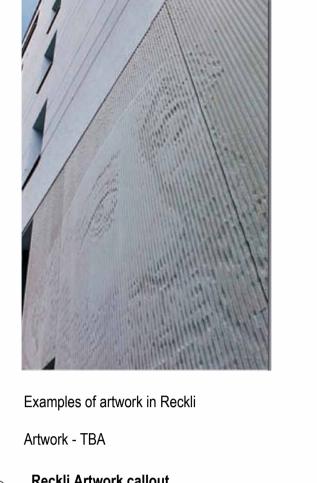1:200

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ACN 129 731 559

Nominated Architect: Andreas Antoniades

NSW Registration 7954

PROJECT PHASE DEVELOPMENT **APPLICATION** STATUS


FOR SUBMISSION

PROJECT NO. 20009DA PROJECT REGENT STREET ADDRESS 104-116 REGENT STREET WEE HUR

DRAWING SERIES **Elevations**

Northern Elevation + Southern **Elevation**

DRAWING NO. REVISION DRAWN BY **DA5.02** CHECKED BY As indicated

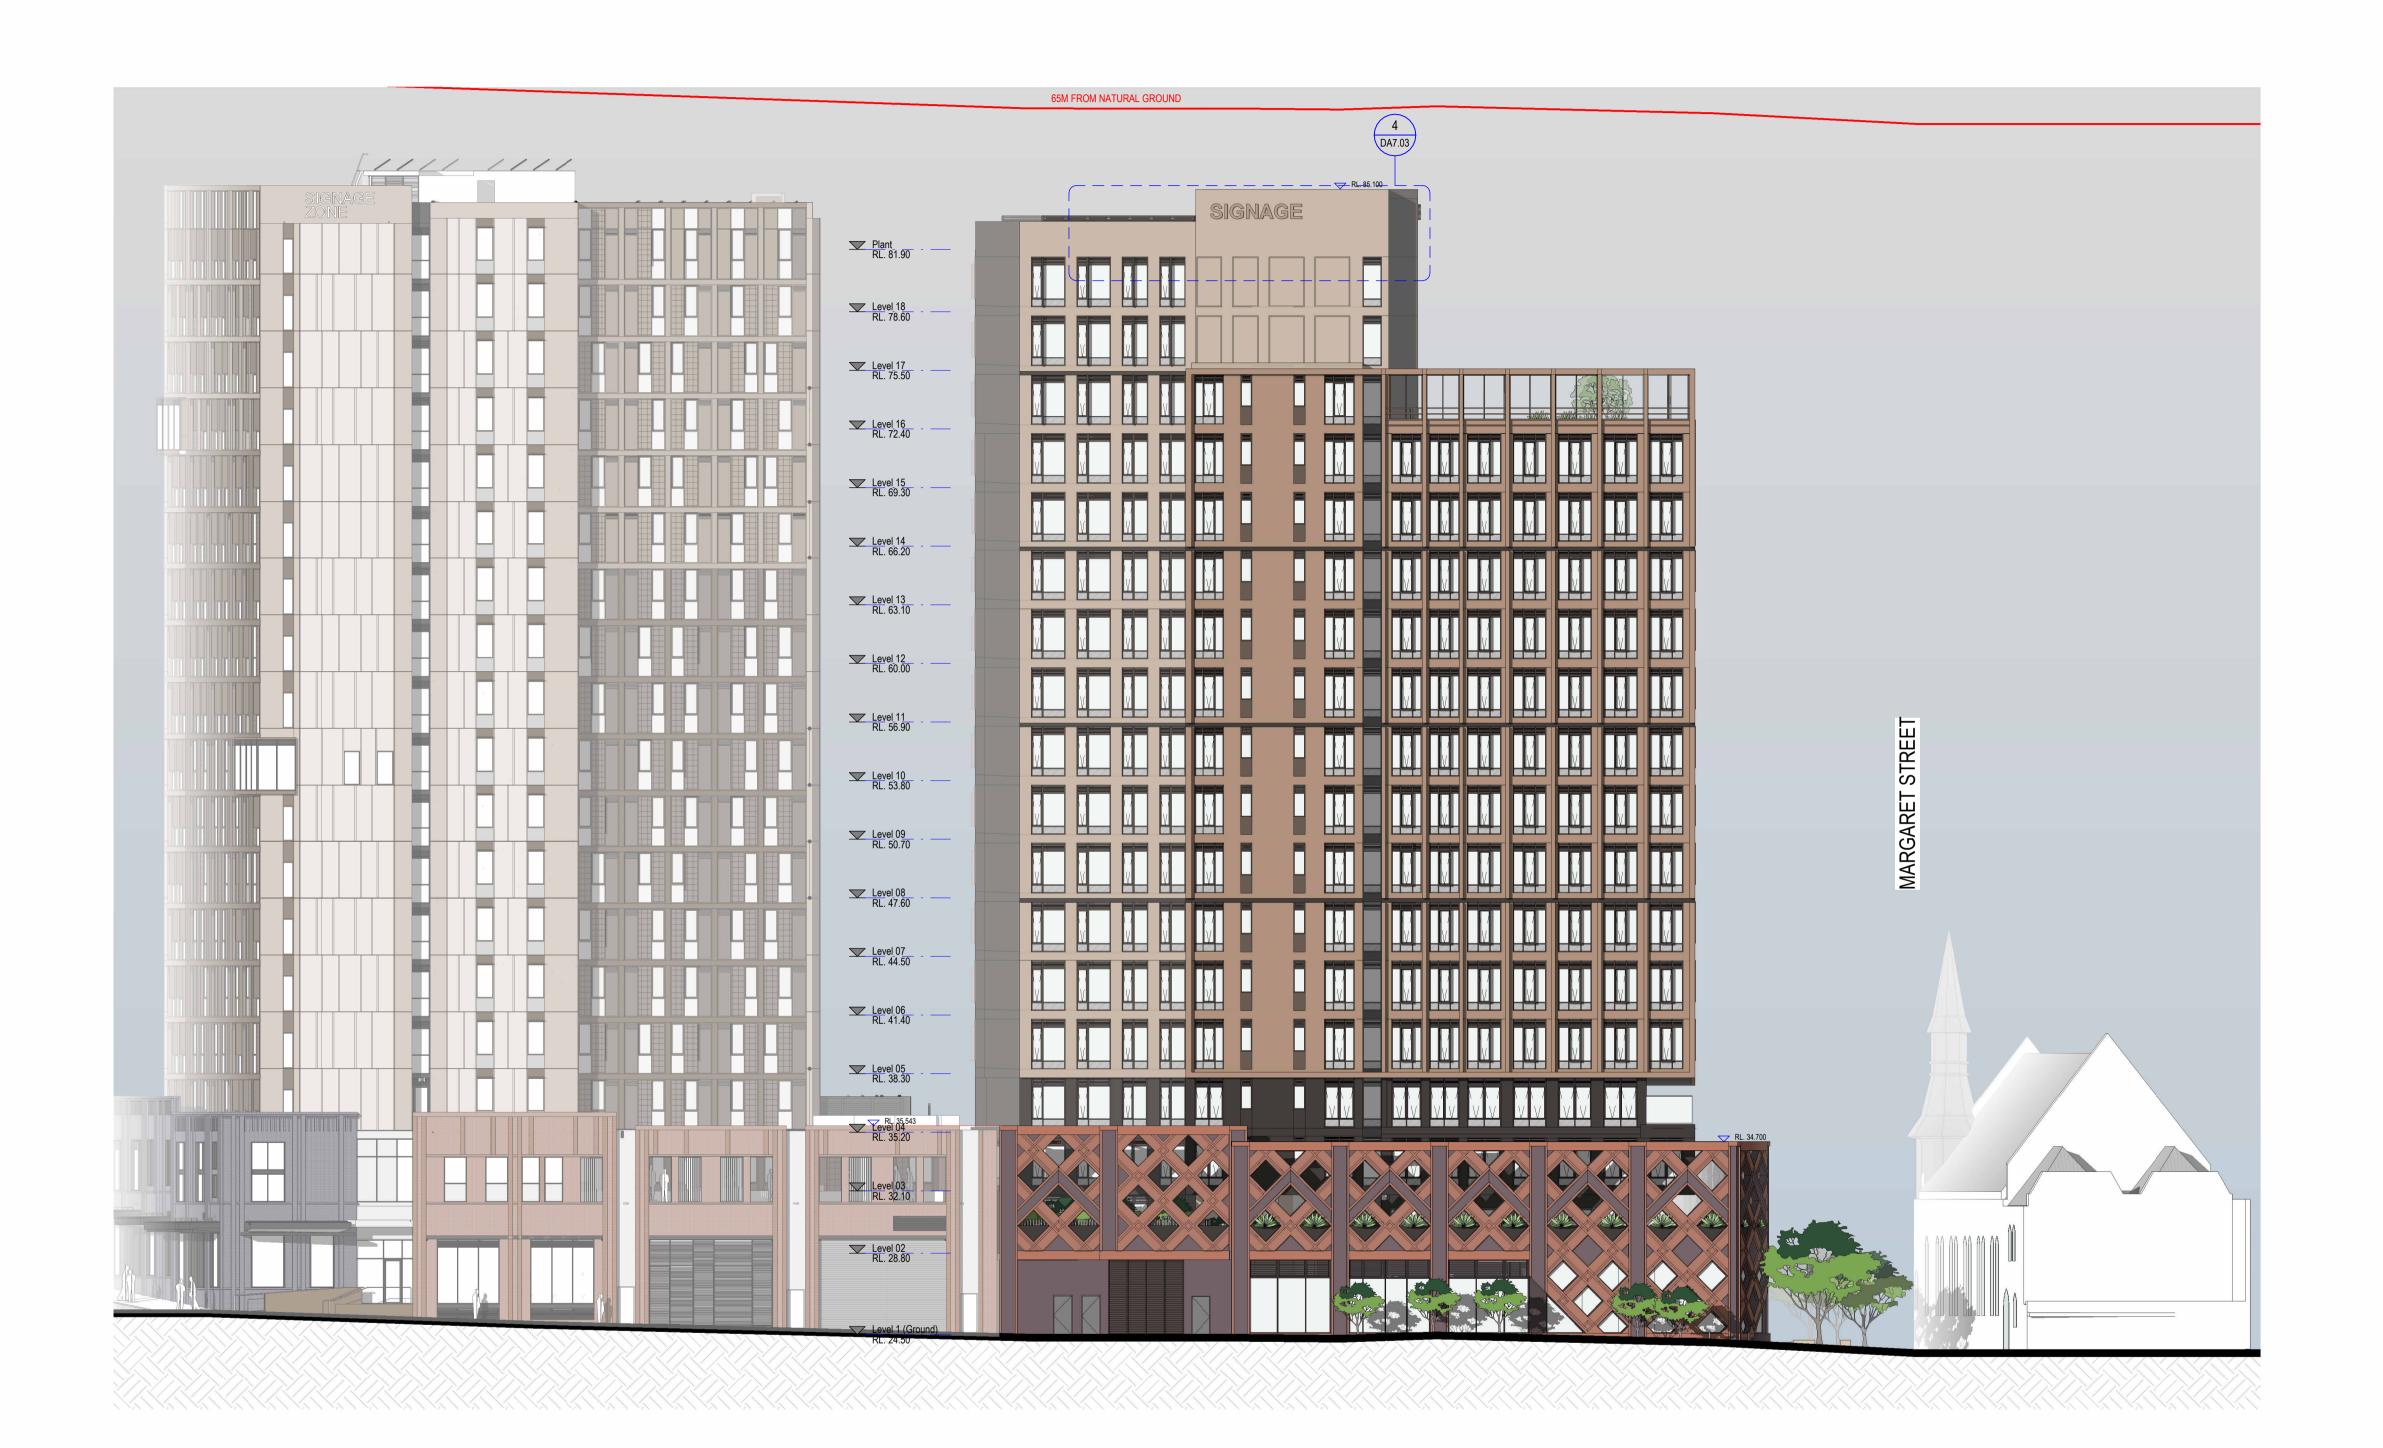





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 DESCRIPTION
 BY
 DATE

 Issued for information
 29.10.2021

 Issued for coordination
 25.11.2021

 Issued for DA Submission
 13.12.2021

 Issued for Coordination
 24.05.2022

 Issued for revised DA submission
 08.06.2022

ANTONIADES ARCHITECTS

Www.antoniades.com.au

Nominated Architect: Andreas Antoniades

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NSW Registration 7954

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DEVELOPMENT
APPLICATION
STATUS

FOR SUBMISSION

PROJECT NO.
20009DA
PROJECT
REGENT STREET

ADDRESS
104-116 REGENT STREET

CLIENT
WEE HUR

DRAWING SERIES
Elevations

William Ln - Elevation

DA5.03

SCALE
As indicated.

SCALE
As indicated

Om 4 8 10m


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REVISION


DRAWN BY

CHECKED BY





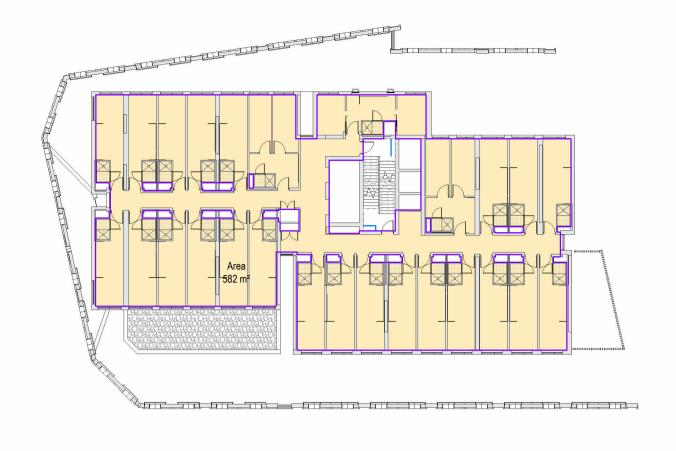

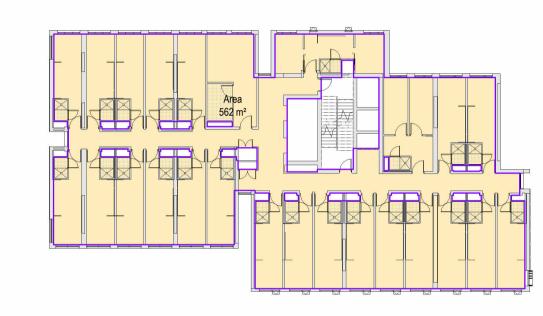



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Le Le Le Le	evel 13				2	1	27				
Le Le Le	THE STATE OF THE S	562		0	2	1	27				
Le Le	evel 14		22	0	2	1	27				
Le Le		562	22	0	2	1	27				
Le	evel 15	562	22	0	2	1	27				
	evel 16	318	11	0	2	0	15		251	251	
۱۵	evel 17	289	11	0	1	0	13				
LE	evel 18	289	11	0	1	0	13				
							Total	642	461	684	1
	Total Room	s	307	21	37	7	372				
	Beds		307	21	74	7					
	Total Beds	%	75%	5%	18%	2%	1				
	Total Beds	5		4(09						
	Total per be	ed .						1.6			
	Proposed			Con	itrol	1					
GFA		9542		GFA	9562	1					


- Site Area 1366

 * Com. Indoor Area refers to all Indoor communal areas with minimum dimensions of 3m x 3m (as per the SEPP Housing 2021 Definition) * Landscaped Area refers to all outdoor areas with pavings, vegetation, outdoor furniture
- * Com. Outdoor Area refers to all outdoor communal areas with minimum dimensions of 3m x 3m (as per the SEPP Housing 2021 Definition) * Maintenance Outdoor Area refers to all outdoor landscaped areas that are not accessible by students (these areas will be accessed for maintenance only)

WORK IN PROGRESS

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7 Level 16
Area Plan

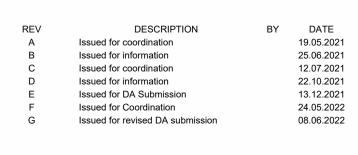

1:300



1:300

ACN 129 731 559




FOR SUBMISSION


PROJECT NO. 20009DA
PROJECT REGENT STREET
ADDRESS 104-116 REGENT STR
CLIENT WEE HUR

DRAWING SERIES	
General	Information


Project Data Schedule

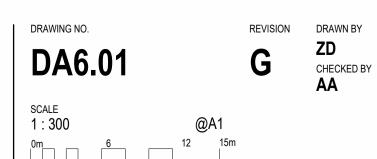




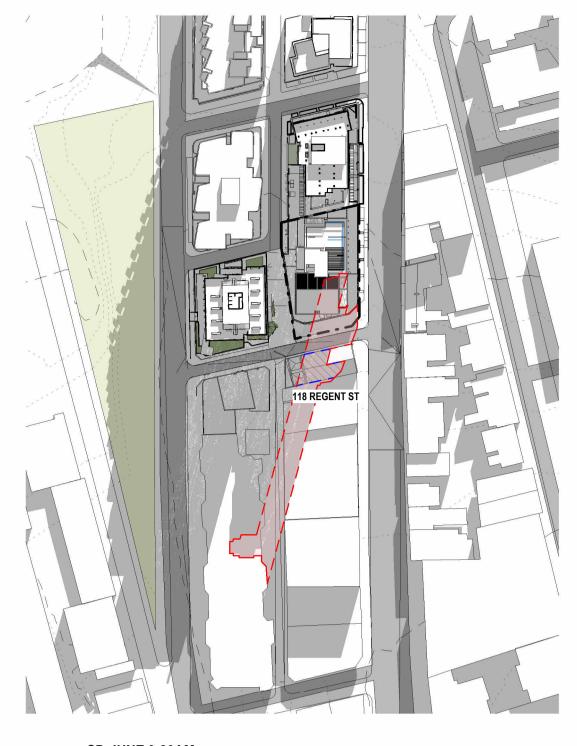

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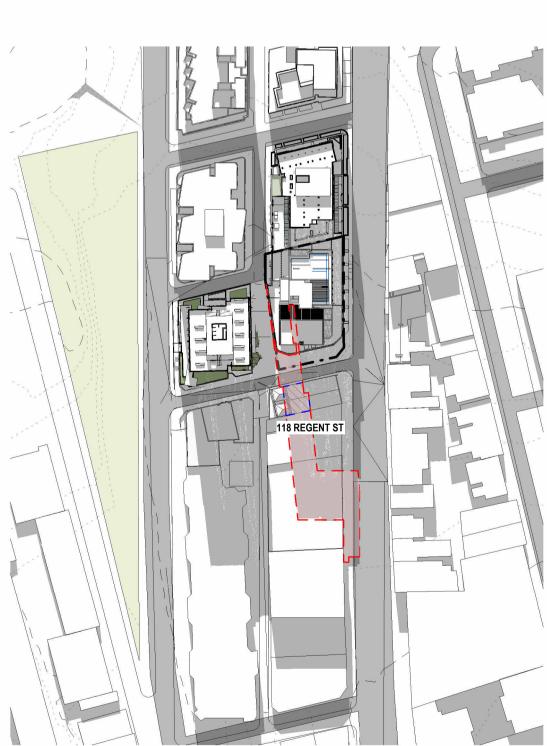


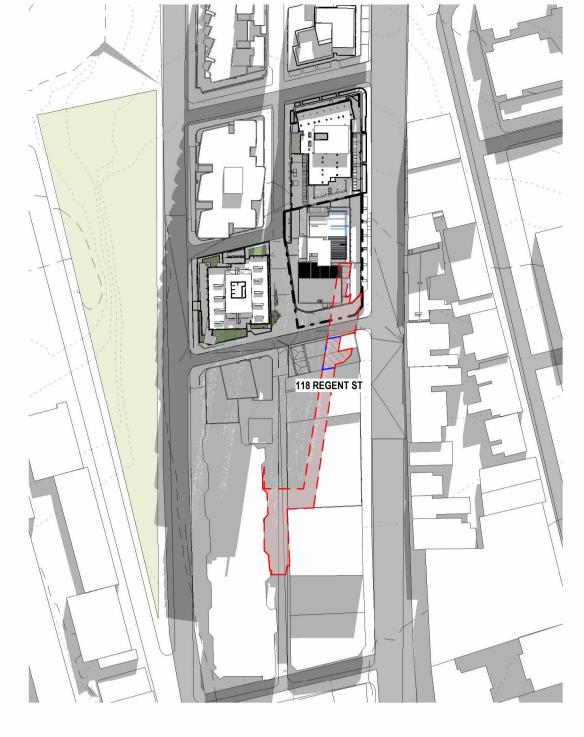

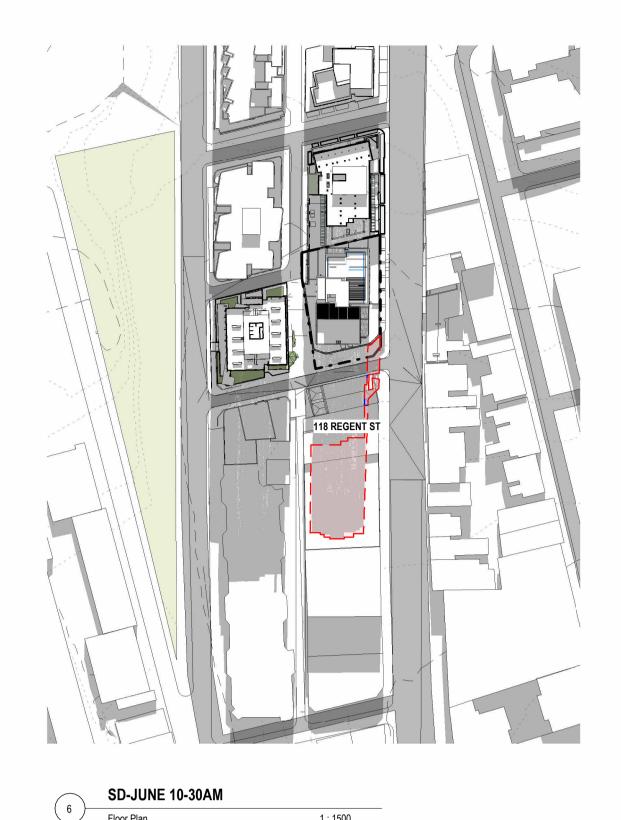










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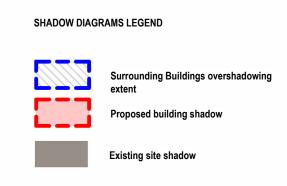

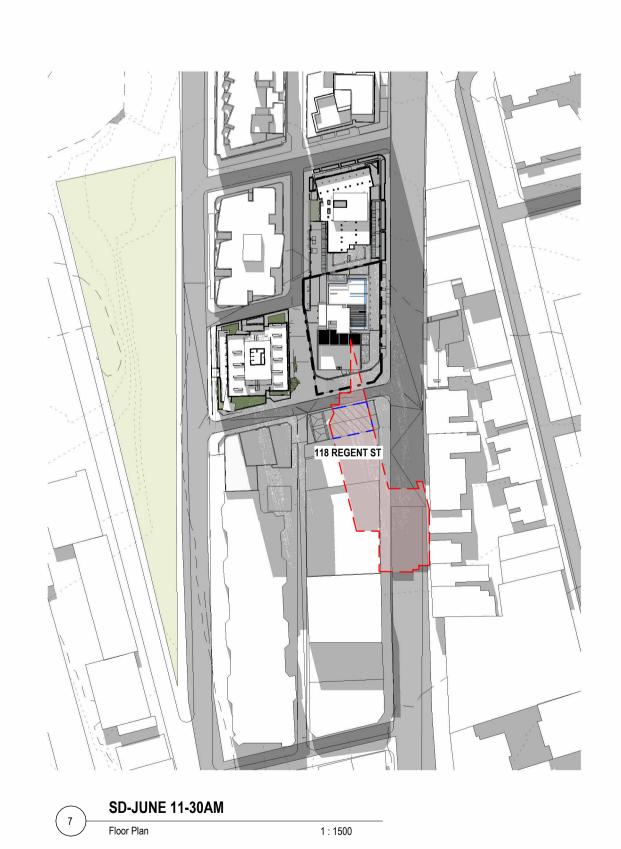
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SD-JUNE 11AM

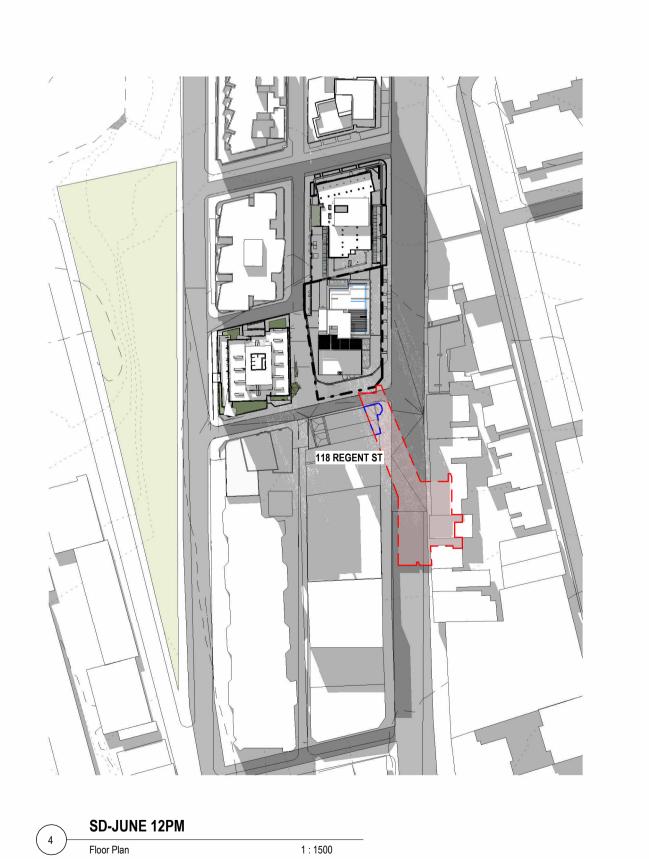DESCRIPTION BY DATE 25.11.2021 Issued for coordination Issued for DA Submission 13.12.2021 Issued for Coordination 24.05.2022 Issued for revised DA submission 08.06.2022

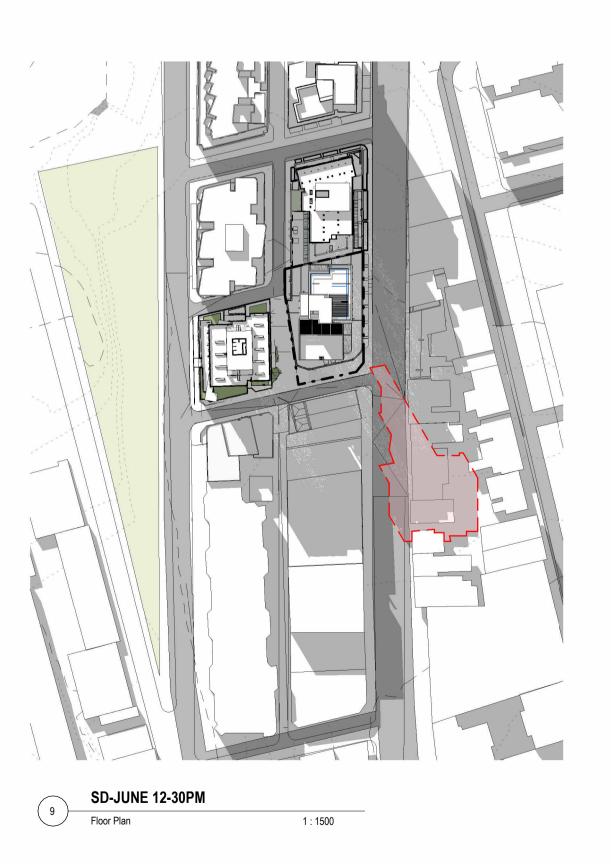




PROJECT PHASE DEVELOPMENT **APPLICATION** STATUS FOR SUBMISSION


PROJECT NO. 2009DA PROJECT
REGENT STREET ADDRESS 104-116 REGENT STREET WEE HUR

Design Analysis

Shadow Diagrams - 21 JUNE 2022.1

DRAWING NO. **DA6.02** SCALE
As indicated

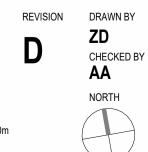

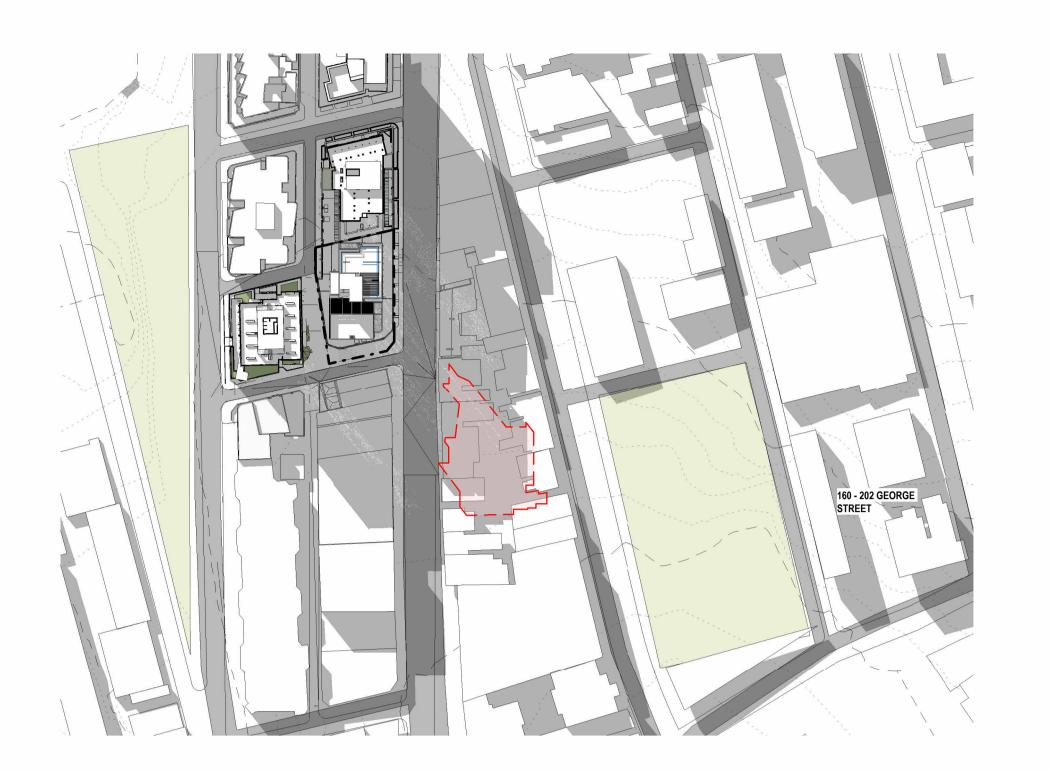





SD-JUNE 02PM

Floor Plan 1 : 1500

160 - 282 GORGE STREET



SD-JUNE 02-30PM
Floor Plan

SD-JUNE 01PM

Floor Plan

REV A Issued fo

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DESCRIPTION BY DATE
Issued for Coordination 24.05.2022
Issued for revised DA submission 08.06.2022

SHADOW DIAGRAMS LEGEND

Surrounding Buildings overshadowing extent

Proposed building shadow

SD-JUNE 01-30PM
Floor Plan

ANTONIADES ARCHITECTS

www.antoniades.com.au

ACN 129 731 559

Nominated Architect: Andreas Antoniades NSW Registration 7954

PROJECT PHASE
DEVELOPMENT
APPLICATION
STATUS
PRELIMINARY

PROJECT NO.
20009DA

PROJECT

REGENT STREET

ADDRESS
104-116 REGENT STREET

CLIENT
WEE HUR


Design Analysis


Shadow Diagrams - 21 JUNE 2022.2


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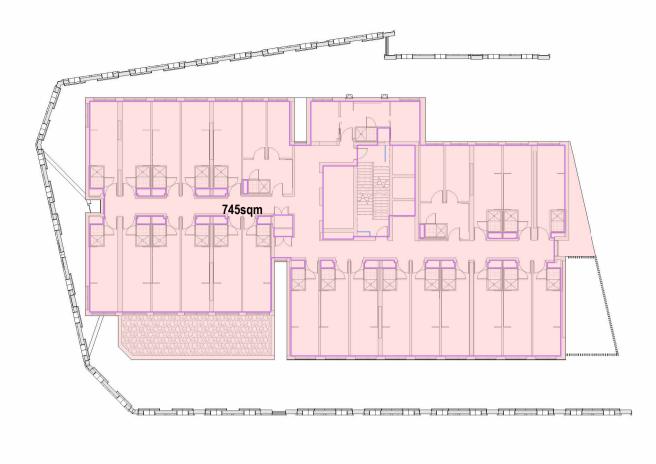
SCALE
As indicated


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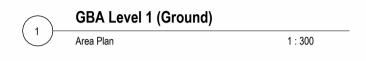




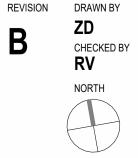


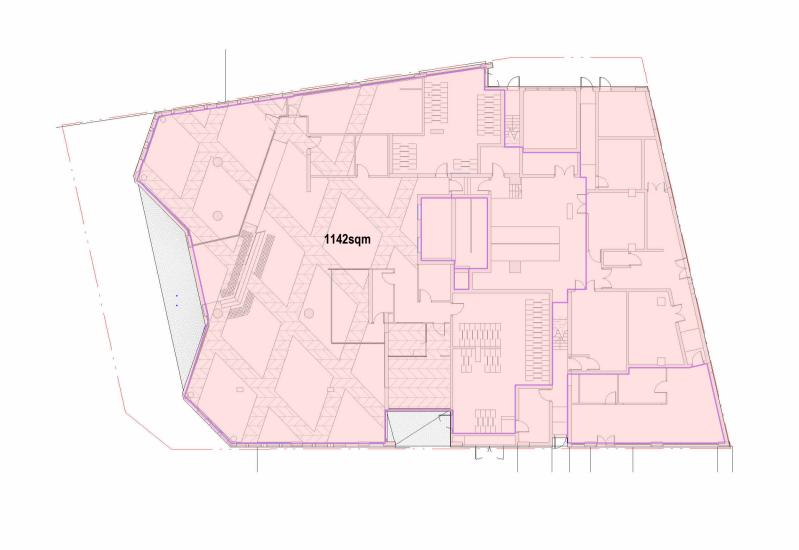

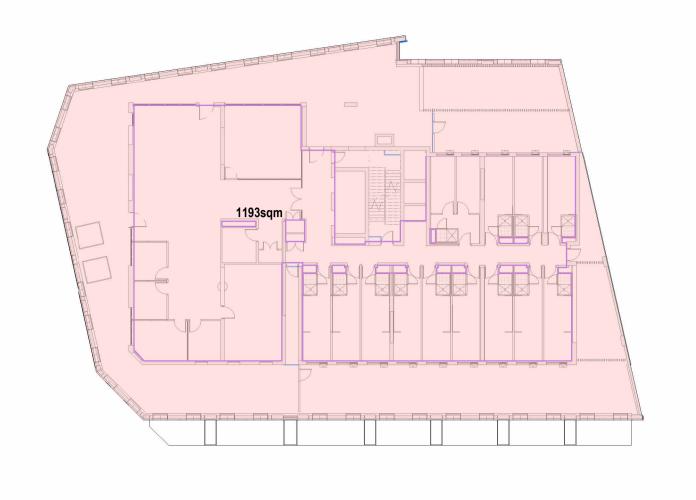


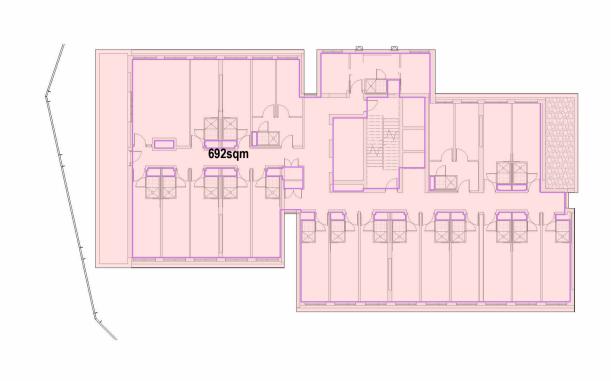




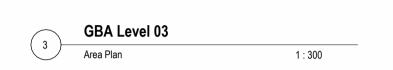




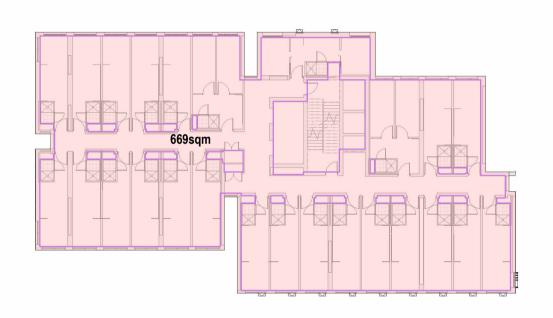

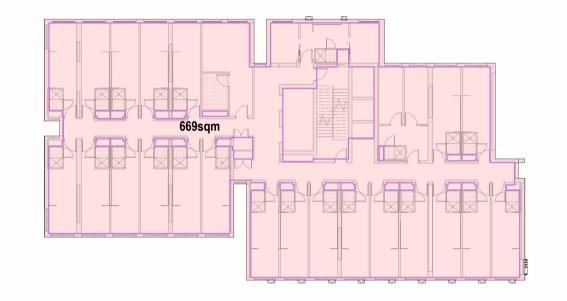



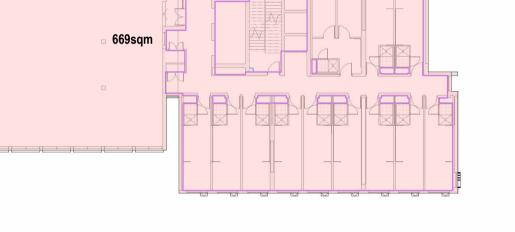

163sqm





7	GBA Level 16	
' 厂	Area Plan	1

LEVELS

104-116 REGENT STREET

LEVELS	GBA
Level GF	1142
Level 02	1193
Level 03	745
Level 04	692
Level 05	669
Level 06	669
Level 07	669
Level 08	669
Level 09	669
Level 10	669
Level 11	669
Level 12	669
Level 13	669
Level 14	669
Level 15	669
Level 16	669
Level 17	402
Level 18	369
ROOF	369
PLANT	163
Total	13713

Pr	oposed
GBA	1371
GFA	954
FSR	6.98535871
Site Area	136



369sqm	
a a	.0 /c



	GBA Level 17 - 18	
$^{\circ}$	Area Plan	1 : 300

9	GBA Roof	
g	Area Plan	1:300

oof	
	1:300

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PROJECT PHASE DEVELOPMENT APPLICATION

STATUS PRELIMINARY

PROJECT NO. 2009DA REGENT STREET ADDRESS 104-116 REGENT STREET CLIENT WEE HUR

DRAWING NO. **DA6.05**

REVISION	DRAWN BY	DRAW
C	DP CHECKED BY Checker	Ge
	NORTH	DRAW
		Gr

General Information

FAWING TITLE

Fross Building Area Calculation

ANTONIADES ARCHITECTS

www.antoniades.com.au Nominated Architect: Andreas Antoniades ACN 129 731 559 NSW Registration 7954 ACN 129 731 559



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ACN 129 731 559 NSW Registration 7954 ACN 129 731 559

PROJECT PHASE DEVELOPMENT **APPLICATION**

STATUS FOR SUBMISSION PROJECT NO. 20009DA PROJECT
REGENT STREET ADDRESS 104-116 REGENT STREET

WEE HUR

DRAWING SERIES **Photomontage**

DRAWING TITLE


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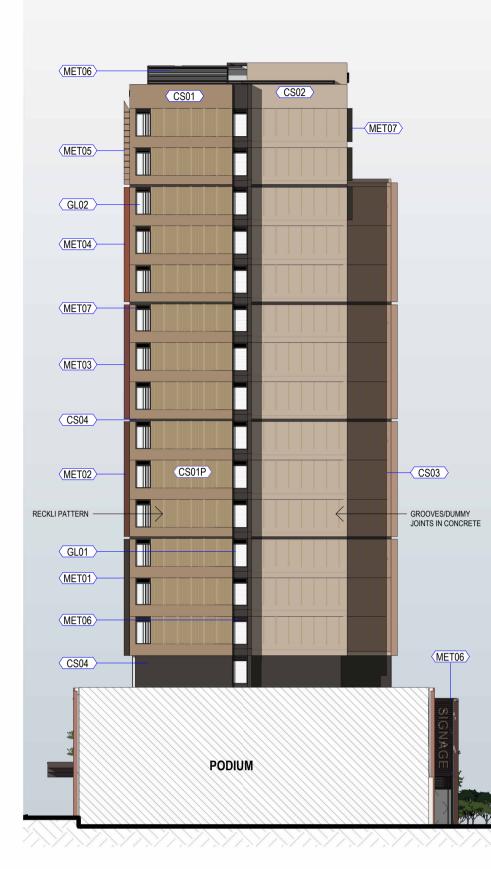
DRAWING NO. **DA7.01**

SCALE NTS

CHECKED BY **RV**






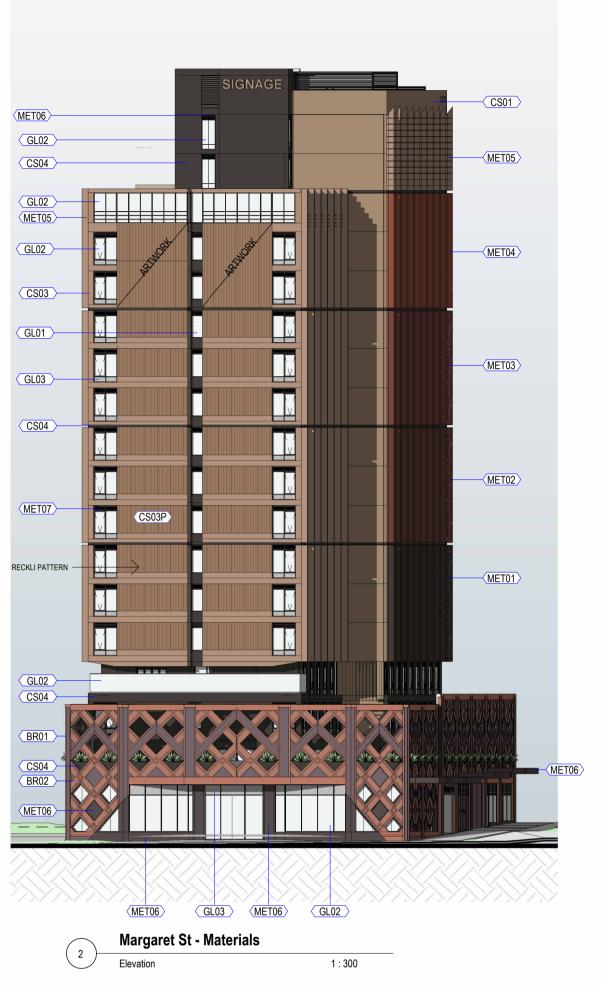


North Elevation - Materials

FINISHES SCHEDULE

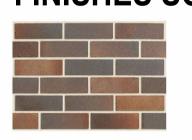

BR - 01 PODIUM BRICKS:DRY PRESSED **MACARTHUR MIX**

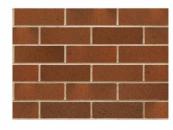

BR - 02 PODIUM BRICKS: DRY PRESSED MCKINLAY BROWN



MET - 01 DULUX POWDERCOAT ANOTEC MID BRONZE MATT 27251014 FOR: - REGENT ST BLADES



MET - 06 DULUX POWDERCOAT DARK BRONZE 729067S FOR: - WINDOW/DOOR FRAME - AWNING - COLUMN CLADDING (GF)

- LOUVRES



MET - 02

TERRAIN MATT

2608234M FOR:

DULUX POWDERCOAT

- TOWER RECESS 03

- REGENT ST BLADES

MET - 07 DULUX POWDERCOAT JASPER MATT 2608252M FOR: - WINDOWS FRAME/LOUVRES

- WILLIAM LANE FINS




MET - 03 DULUX **POWDERCOAT MANOR RED MATT** 959-52094 FOR: - REGENT ST BLADES



CS - 02 CONCRETE MINERAL STAIN / INTEGRAL COLOUR TO CONCRETE: RGB 193/176/158 OR TO MATCH DULUX COLOUR -WARM NEUTRAL (P13D3)



MET - 04 DULUX POWDERCOAT HEADLAND MATT 959-84615 FOR: - REGENT ST BLADES

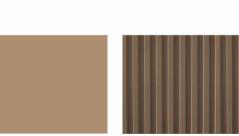

CS - 03 INTEGRAL COLOUR TO CONCRETE: RGB 174/143/115 OR **SMOOTH CARAMEL (S11D5)**



MET - 05 DULUX POWDERCOAT STONE BEIGE MATT 27232538 FOR: - WILLIAM LN WINDOW HOODS - REGENT ST BLADES



CS-03P CONCRETE MINERAL STAIN / RECKLI CS-03P RIB PATTERN (2/75 KOCHER) RGB 174/143/115 OR TO MATCH DULUX COLOUR -TO MATCH DULUX COLOUR - SMOOTH CARAMEL (S11D5)



CS-01P

COLOUR -

RECKLI CS-01P RIB

TO MATCH DULUX

PATTERN (2/75 KOCHER)

RGB 164/140/114 OR


SNUGGLE PIE (P12D5)

CS - 01 CONCRETE MINERAL STAIN / INTEGRAL COLOUR TO CONCRETE: RGB 164/140/114 OR TO MATCH DULUX COLOUR -**SNUGGLE PIE (P12D5)**




CS - 04 CONCRETE MINERAL STAIN / INTEGRAL COLOUR TO CONCRETE: - L3/L4/L16-ROOF LEVEL WALL COLOR - GRC PODIUM WALL PLANTER **BOXES** RGB 67/63/59 OR TO MATCH DULUX COLOUR -

NAMADJI (PN2E9)

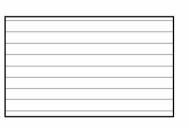

GL-01 GLASS - LOUVRES

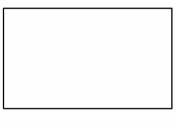

GL-02 GLASS - CLEAR



Examples of artwork in Reckli

Artwork - TBA

GL-03 GLASS - COLORBACK

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Nominated Architect: Andreas Antoniades www.antoniades.com.au NSW Registration 7954 ACN 129 731 559

PROJECT PHASE DEVELOPMENT **APPLICATION** STATUS

FOR SUBMISSION

PROJECT NO. 20009DA **PROJECT** REGENT STREET ADDRESS 104-116 REGENT STREET CLIENT

WEE HUR

Materials & Finishes

DRAWING TITLE **Material Board**

DRAWING NO. REVISION DRAWN BY ZD **DA7.02** CHECKED BY As indicated

