
Yiribana Logistics Estate - Warehouse 1

Landscape Development Application Lots 59 - 60 Mamre Rd, Kemps Creek

Drawing Schedule

Drawing Number	Drawing Title	Scale
000	Landscape Coversheet	N/A
001	Landscape Masterplan	1:500
101	Landscape Plan	1:200
102	Landscape Plan	1:200
103	Landscape Plan	1:200
104	Landscape Plan	1:200
501	Landscape Details	As Shown
502	Landscape Details	As Shown
503	Landscape Specification	N/A

	Plant Schedule						
Code	Botanic Name	Common Name		Pot Size	Density		
			(h x w) (m)				
_	TREES	0 11 0 1 1 1 1	20.11.0	4001			
Ac	Angophora costata	Smooth Barked Apple	20 X 9	100L	As Show		
Ad	Acacia decurrens	Black wattle	15 x 7	100L	As Show		
Ар	Acacia parramattensis	Parramatta Wattle	10 x 6	100L	As Show		
Bm	Backhousia myrtifolia	Grey Myrtle	4 X 3	100L	As Show		
Сс	Corymbia citriodora	Lemon Scented gum	30 x 8	100L	As Show		
Cm	Corymbia maculata	Spotted Gum	30 x 8	100L	As Show		
Ec	Eucalyptus crebra	Narrow Leaved Iron Bark	35X 10	100L	As Show		
Ee	Eucalyptus eugenioides	Thin leaved stringybark	20 x 8	100L	As Show		
Em	Eucalyptus moluccana	Grey Box	25 X 8	100L	As Shov		
Er	Eleocrapus reticulatus	Blueberry Ash	9 x 3	100L	As Shov		
Eu	Elaeocarpus Eumundi	Quandong	7 x 2	100L	As Shov		
Ms	Melaleuca styphelioides	Prickly Leaved Paperbark	8 x 6	100L	As Show		
Wf	Waterhousea floribunda	Weeping Lily Pilly	10x 6	100L	As Shov		
	SHRUBS & ACCENTS						
An	Acmena smithii var. minor	Lilly Pilly	2 x 1.2	200mm	As Show		
AsM	Atriplex nummularia	Old man saltbush	2 x 2	200mm	As Show		
Bv	Baeckea virgata	Tall Backea	3 x 2	200mm	As Sho		
Ca	Correa alba	White correa	1.5 x 1	200mm	As Show		
CLJ	Callistemon 'Little John'	Dwarf Bottle Brush	1.5 x 1	200mm	As Sho		
De	Doryanthes excelsa	Gymea Lily	1.8 x 1.5	200mm	As Sho		
Du	Daviesia ulicifolia	Gorse Bitter Pea	3 x 2.5	200mm	As Show		
Dv	Dodonea viscosa	Hop Bush	1 x 1	200mm	As Show		
Em	Eremophila maculata	Emu bush	.5 x 1.2	200mm	As Show		
Gj	Grevillea juniperina	Juniper leaf grevillea	1.5 x 1	200mm	As Show		
MCT	Melaleuca linariifolia 'Claret Tops'	Honey Myrtle	1 x 1	200mm	As Show		
PP	Phormium tenax 'Purpureum'	Bronze Flax	1.5 x 1	200mm	As Show		
Wf	Westringia fruticosa	Coastal Roasemary	1 x 1	150mm	As Show		
	GRASSES AND GROUNDCOVERS						
Ва	Brunoniella australis	Blue Trumpets	0.3x	150mm	5/m²		
Bd	Bothriochloa decipiens car. Decipiens	Pitted Blue Grass	1	150mm	5/m²		
Ca	Carex appressa	Tall Sedge	0.9 x 1	150mm	5/m²		
Cas	Centella asiatica	Indian Pennywort	.2 x 1	150mm	5/m²		
Ct	Chloris truncata	Windmill Grass	.5 x .3	150mm	5/m²		
Dc	Dianella caerulea	Flax Lily	0.8x 0.5	150mm	5/m²		
Dr	Dichondra repens	Kidney Weed	.1 x 1	150mm	5/m ²		
Em	Entolasia marginata	Bordered Panic	0.8 x 0.5	150mm	5/m ²		
Eo	Echinopogon ovatus	Forest Hedgehog Grass	1.2	150mm	5/m ²		
Gt	Gazania tomentosa	Silver Gazania	.15 x 1	150mm	5/m ²		
Hs	Hibbertia scandens	Climbing Guinea Flower	climbing	150mm	5/m ²		
lc	Imperata cylindrica	Blady Grass	.75 x .3	150mm	5/m²		
Ju	Juncus usitatus	Common Grass	.6 x 1	150mm	5/m ²		
LJR	Liriope 'Just Right'	Liriope	.4 x .4	150mm	5/m²		
LI	Lomandra longifolia	Mat Rush	1 x 1	150mm	5/m²		
Мр	Myoporum parvifolium	Creeping Boobialla	.3 x 2	150mm	5/m ²		
Ms	Microlaena stipoides	Weeping Grass	0.7 x 0.3	150mm	5/m ²		
Ta	Themeda australis	Kangaroo Grass	1 x .5	150mm	5/m ²		
Vh	Viola hederacea	Native Violet	.15 x 1	150mm	5/m ²		
Wc	Wahlenbergia communis	Tufted Bluebell	0.75	150mm	5/m ²		

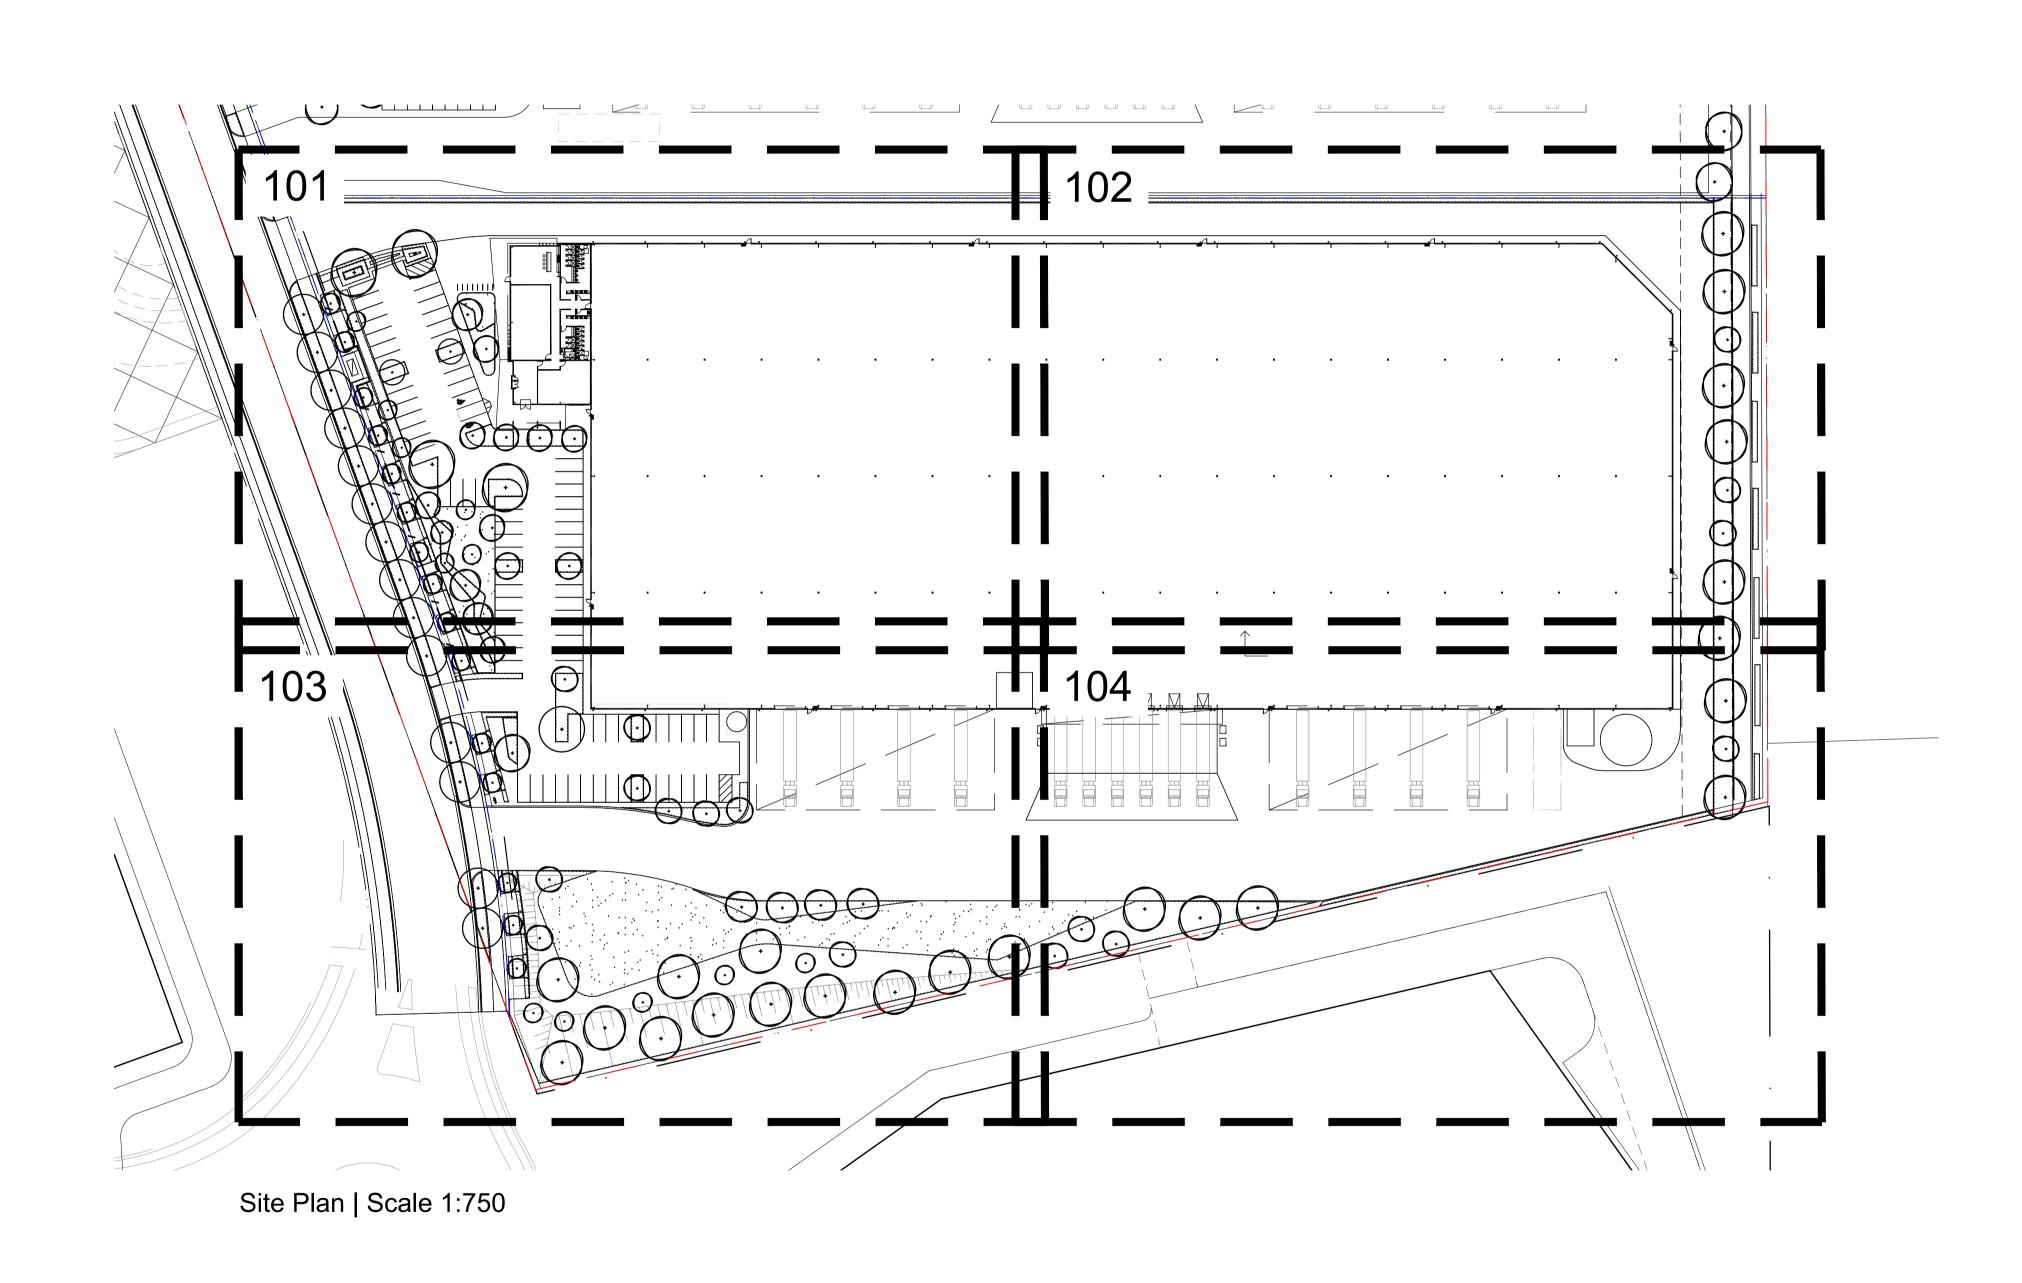

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B Architectural & Civil Coordination A For Coordination

CK NM 12.04.2022 SK NW 14.05.2021 Drawn Check Date Issue Revision Description

LEGEND

Key Plan:



The GPT Group

Yiribana Logistics Estate Lots 59-60 Mamre Road Kemps Creek


Landscape Coversheet


DEVELOPMENT APPLICATION


Job Number:

SS21-4623


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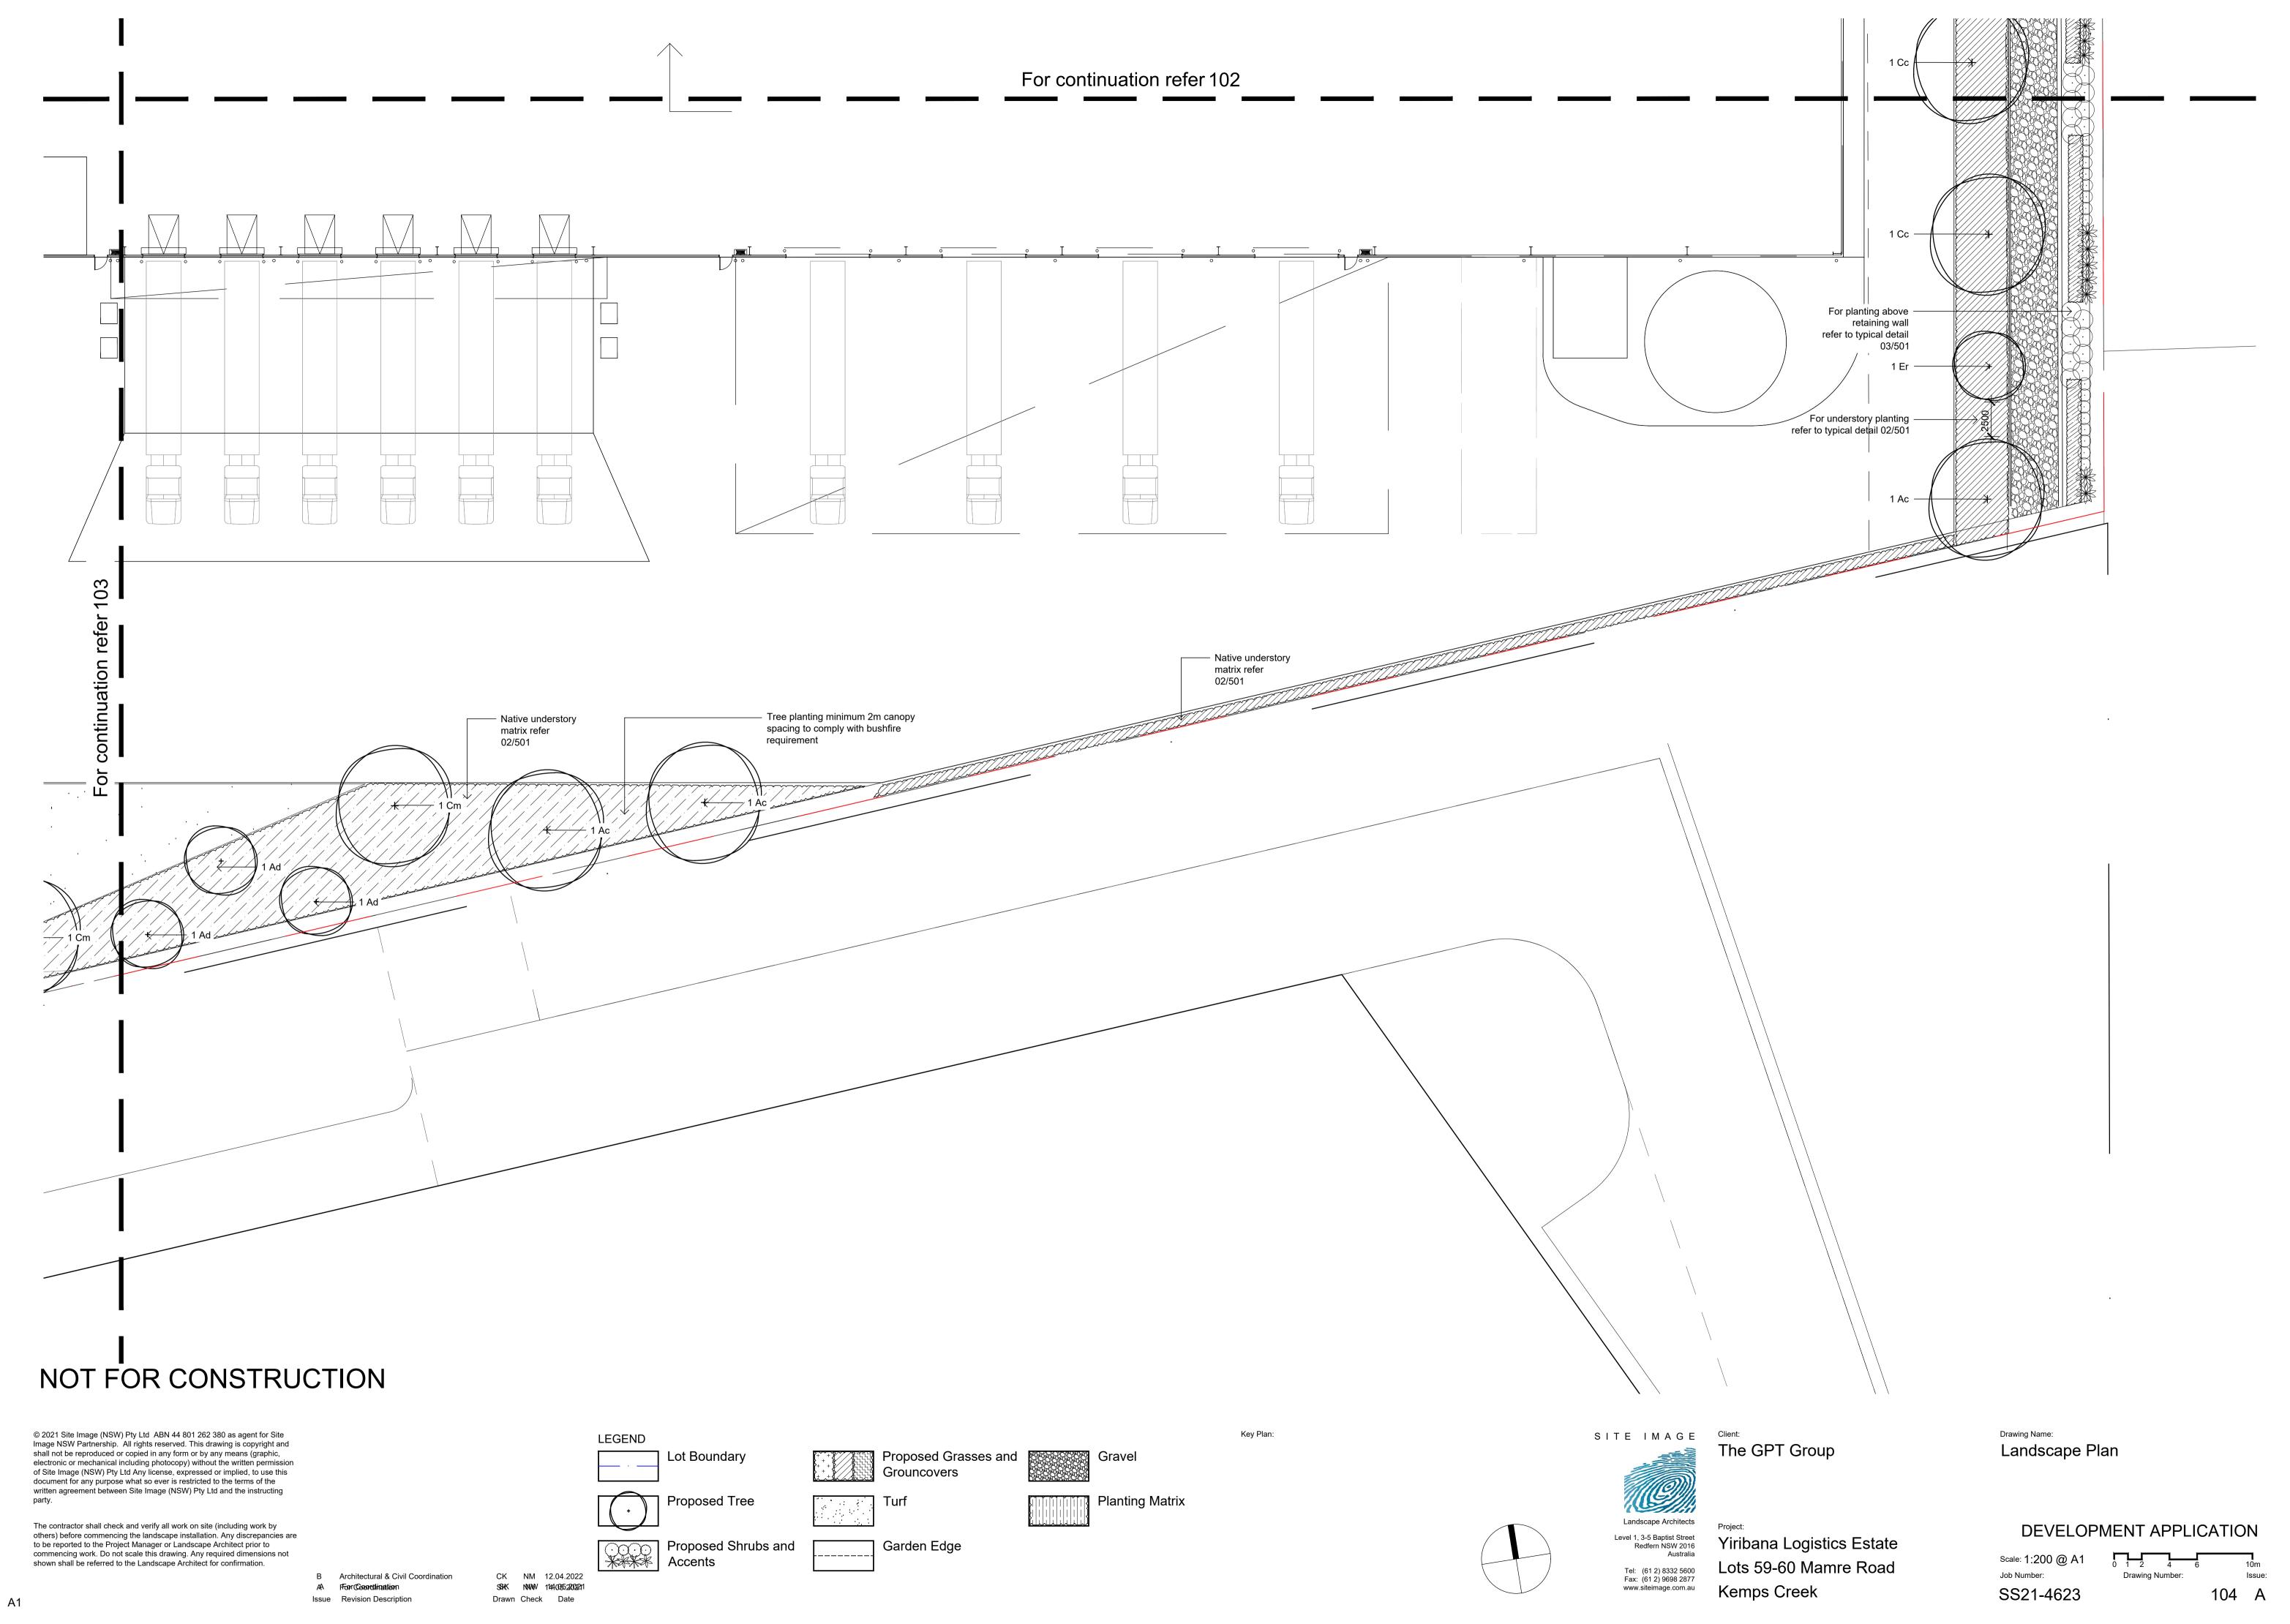


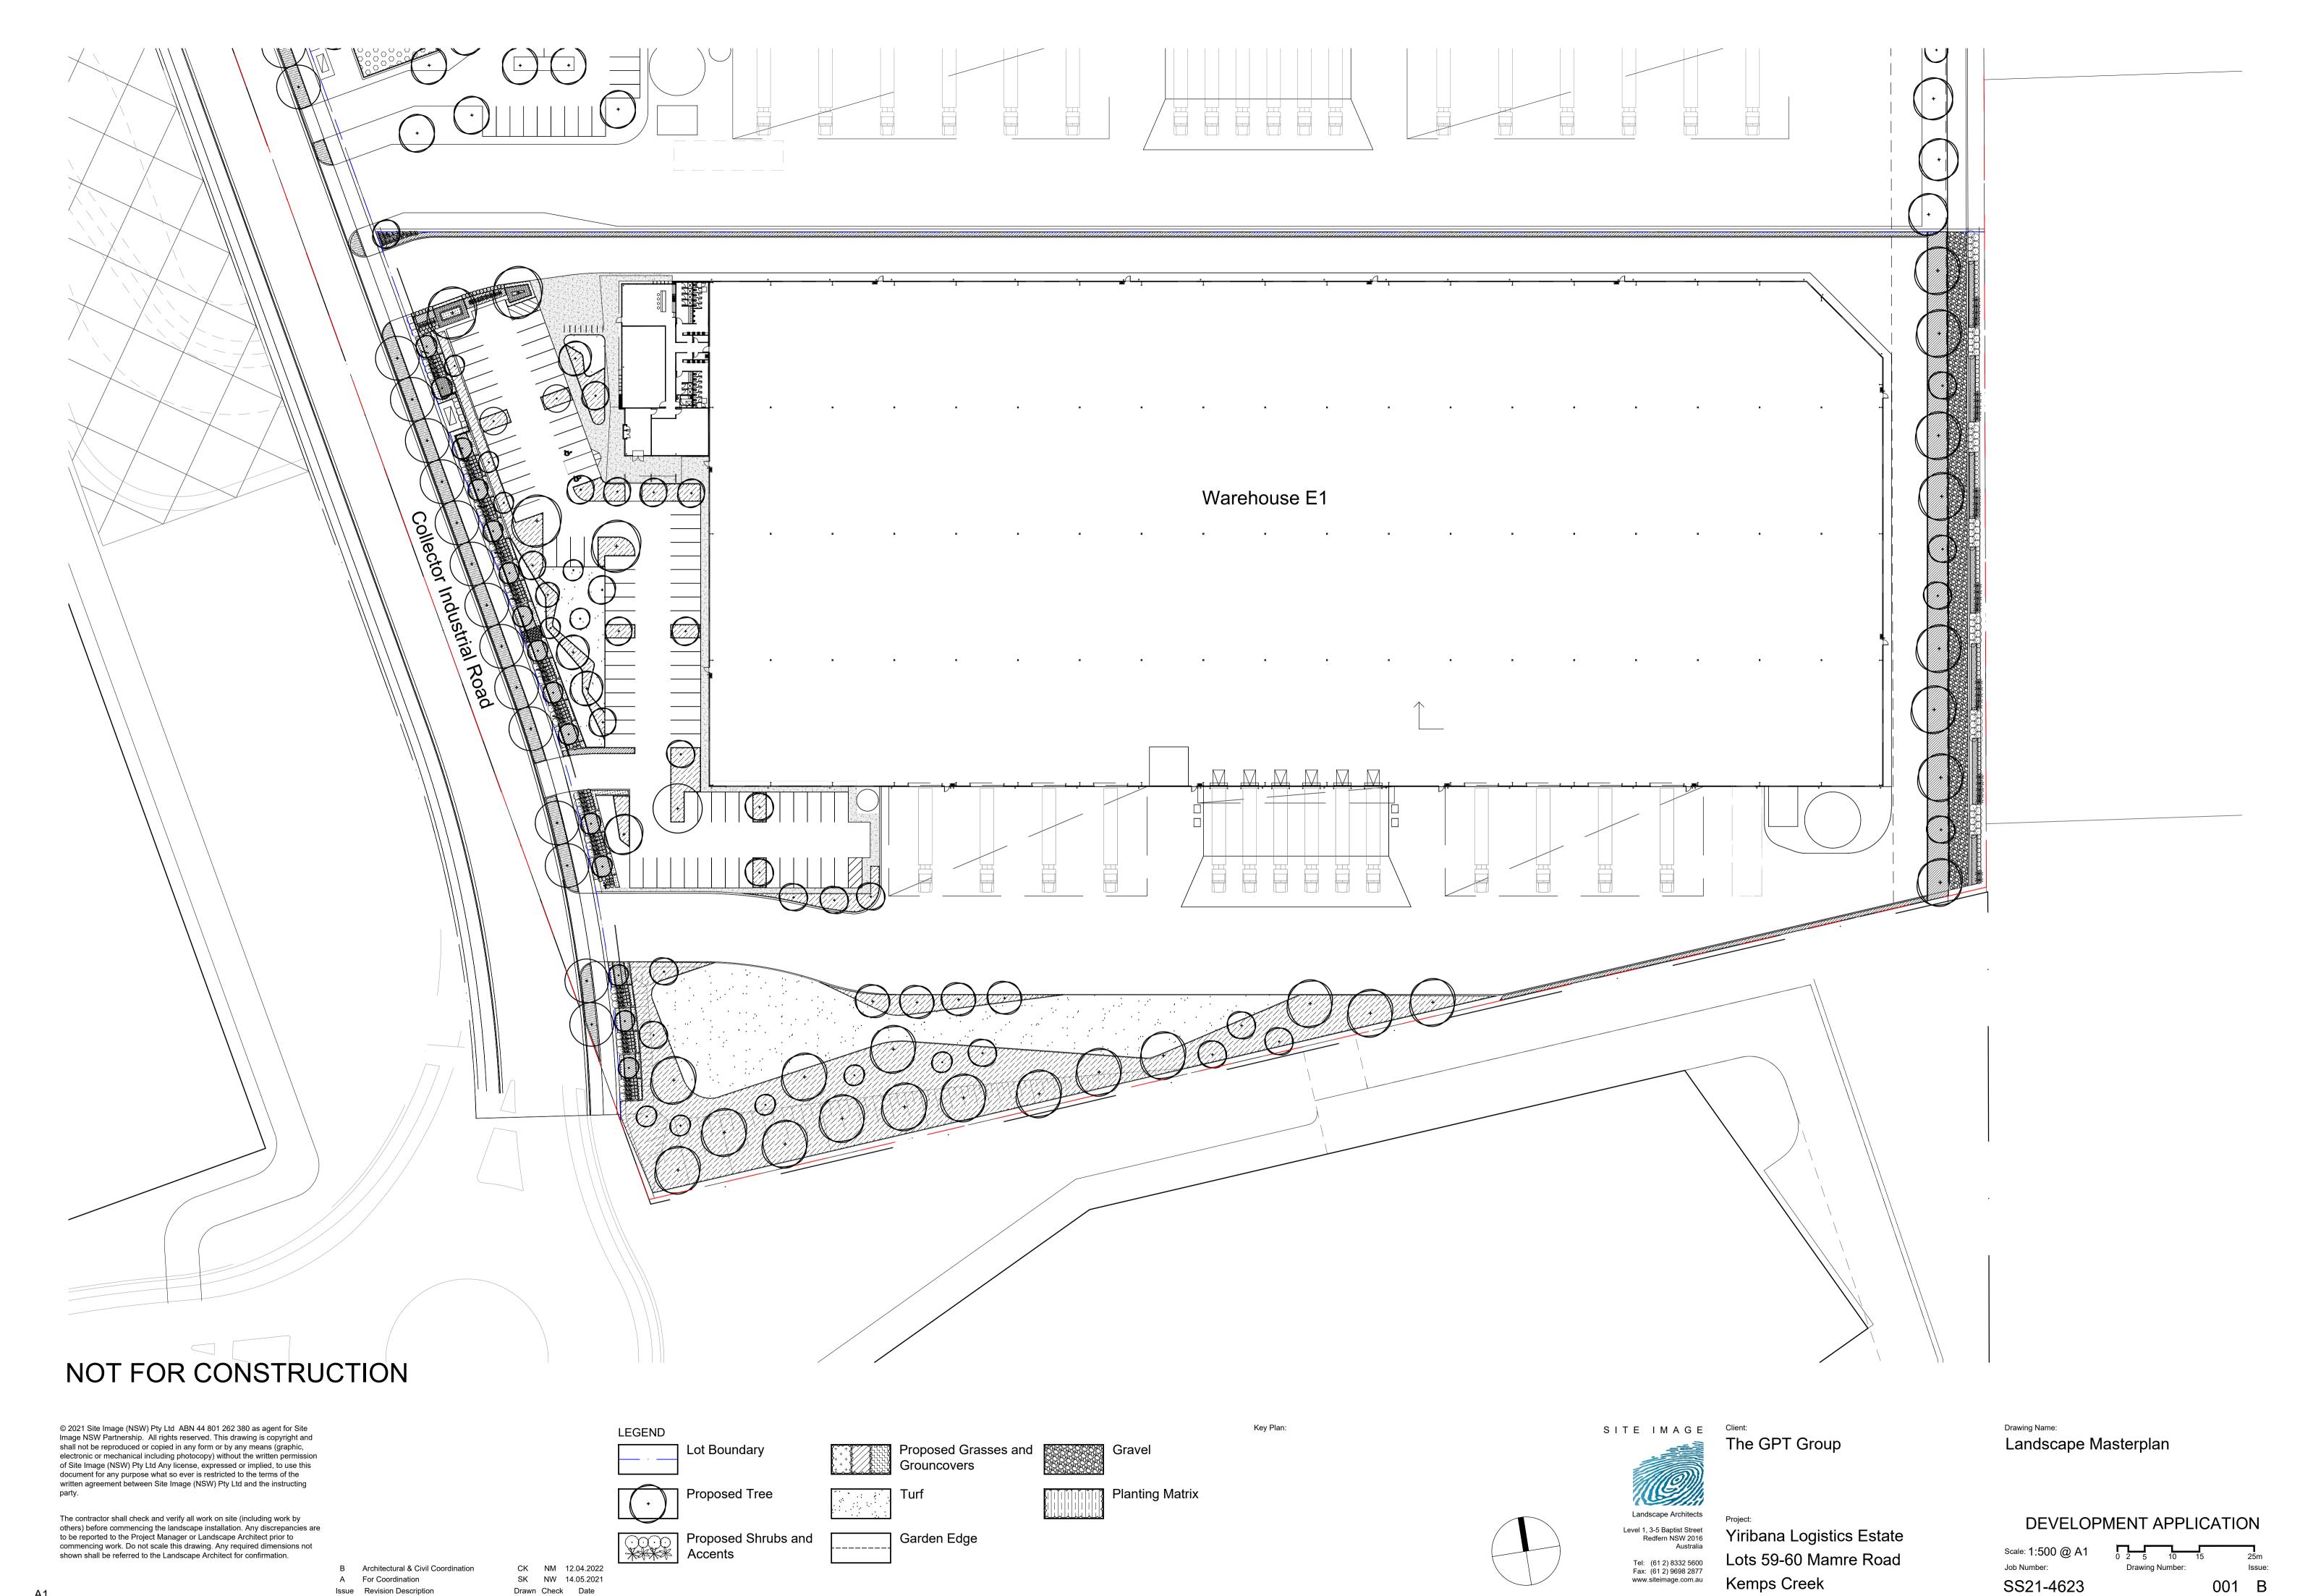


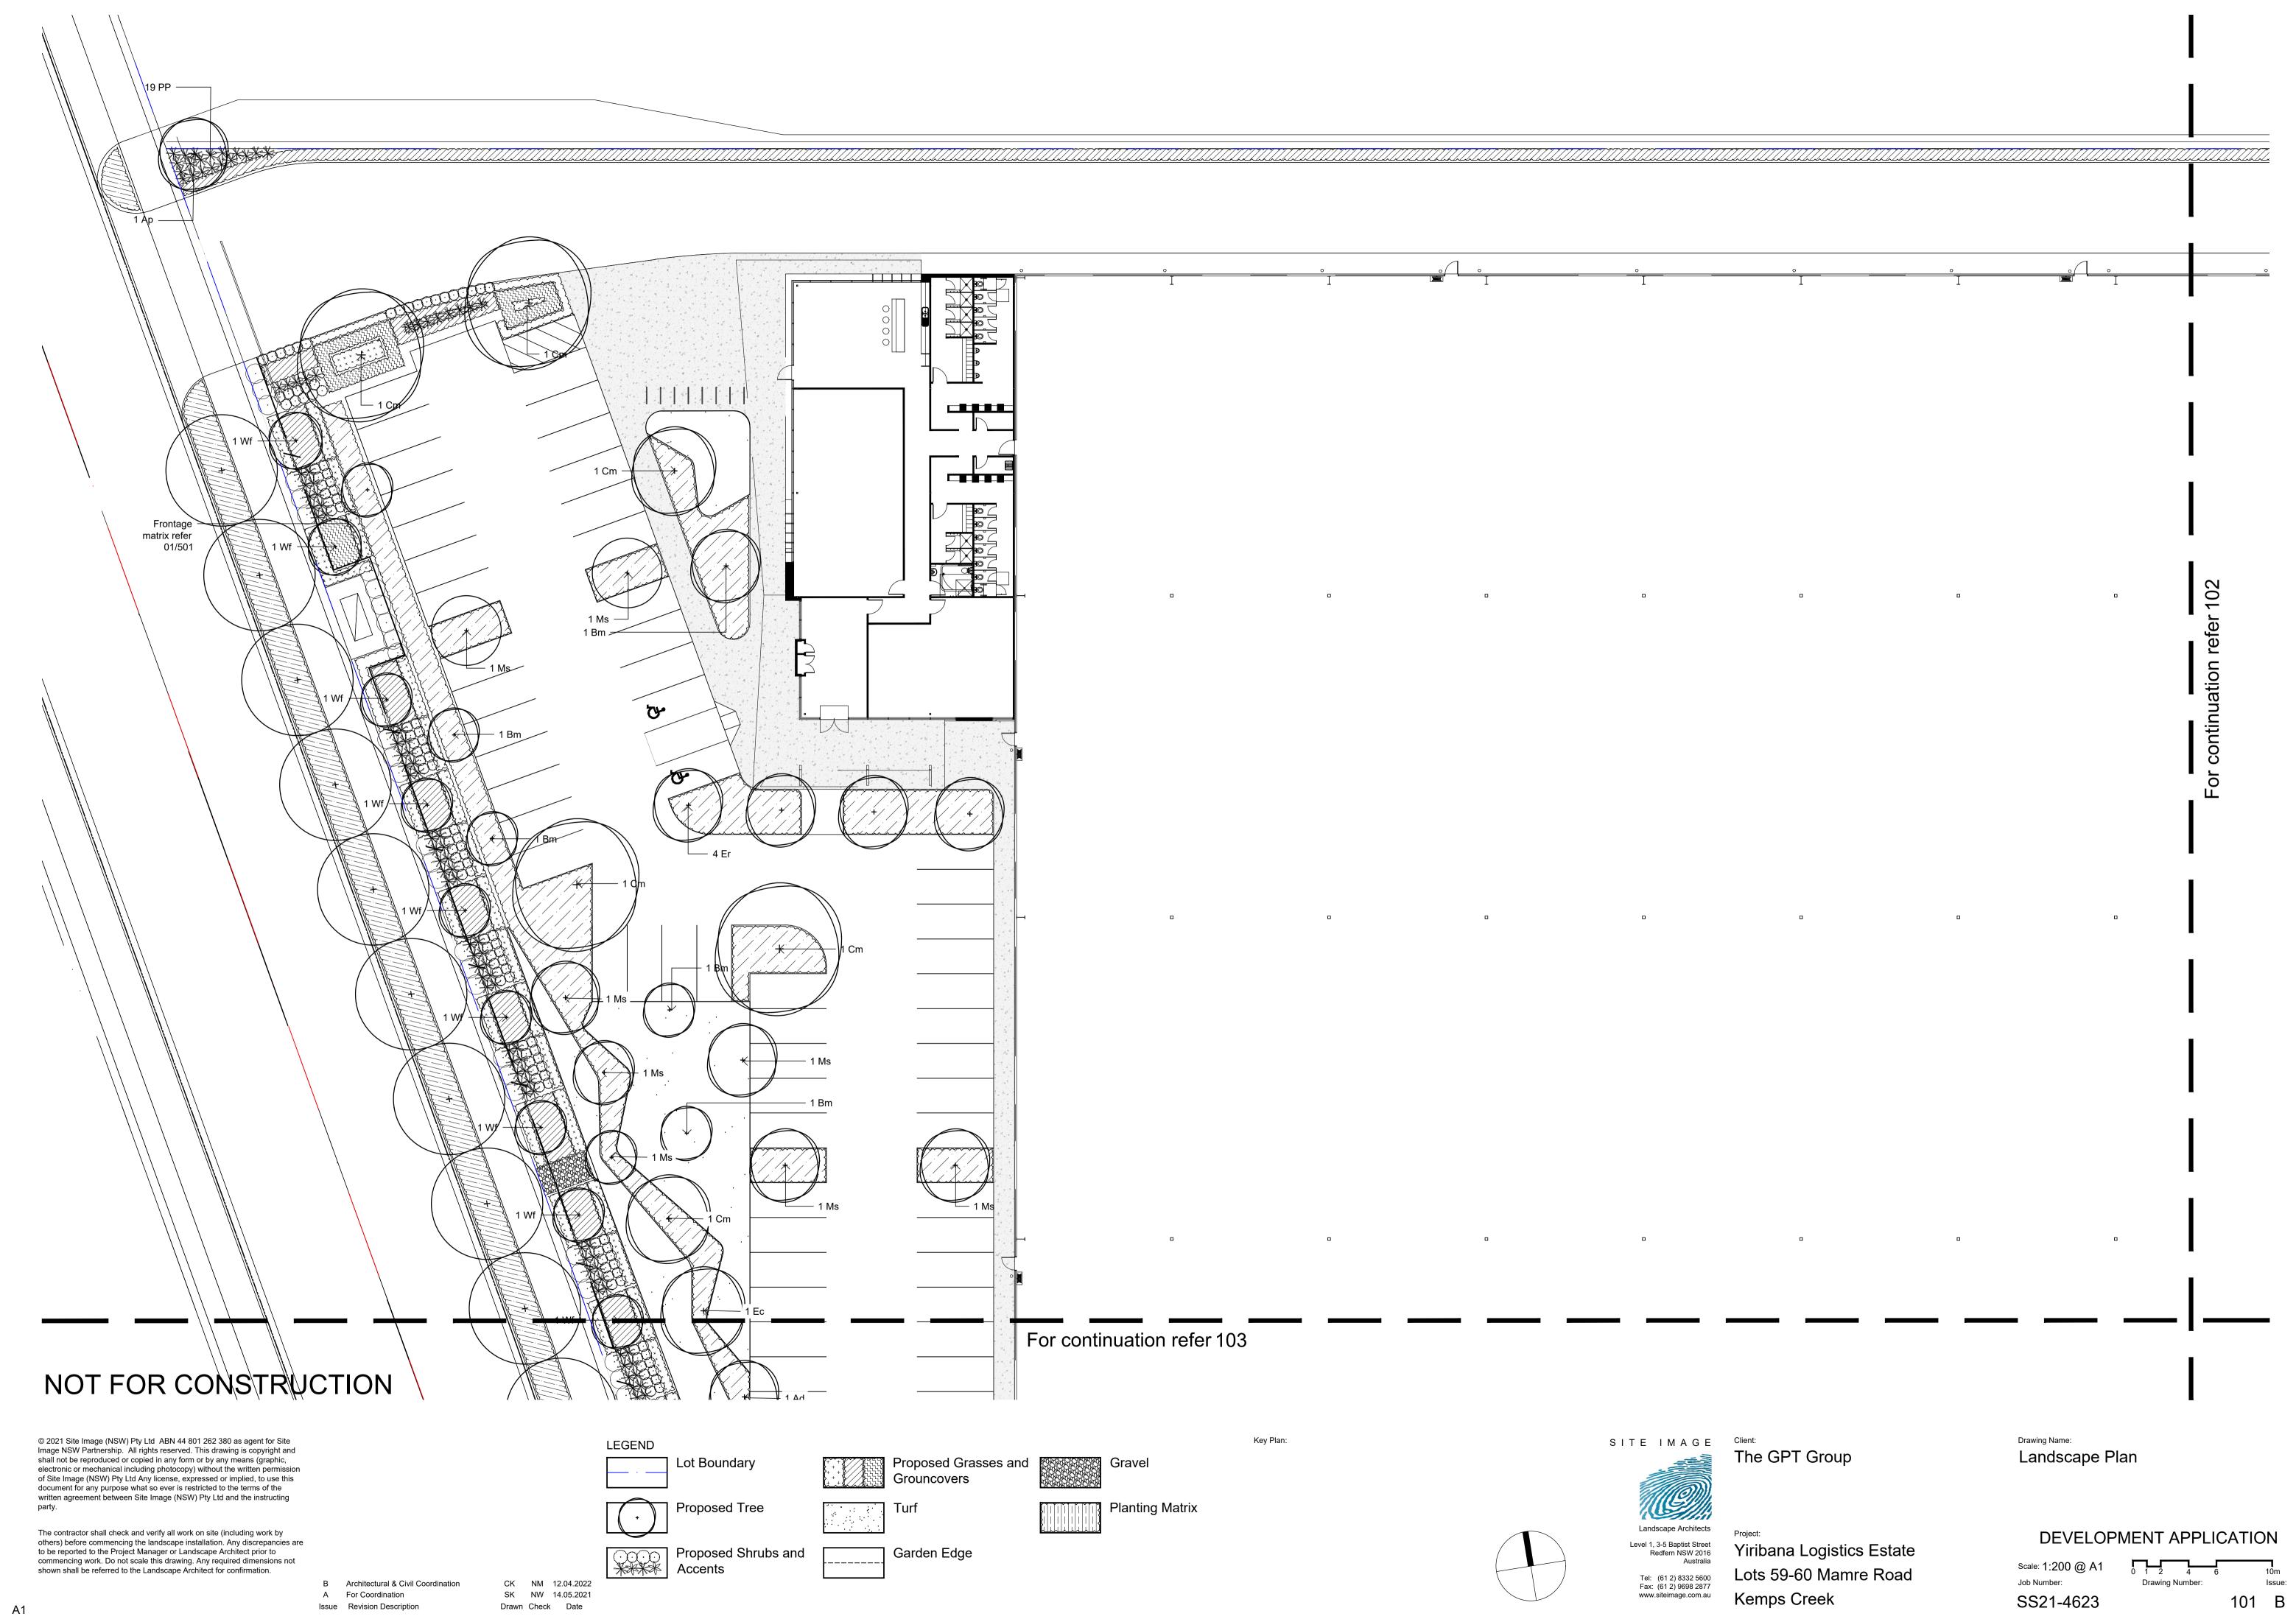

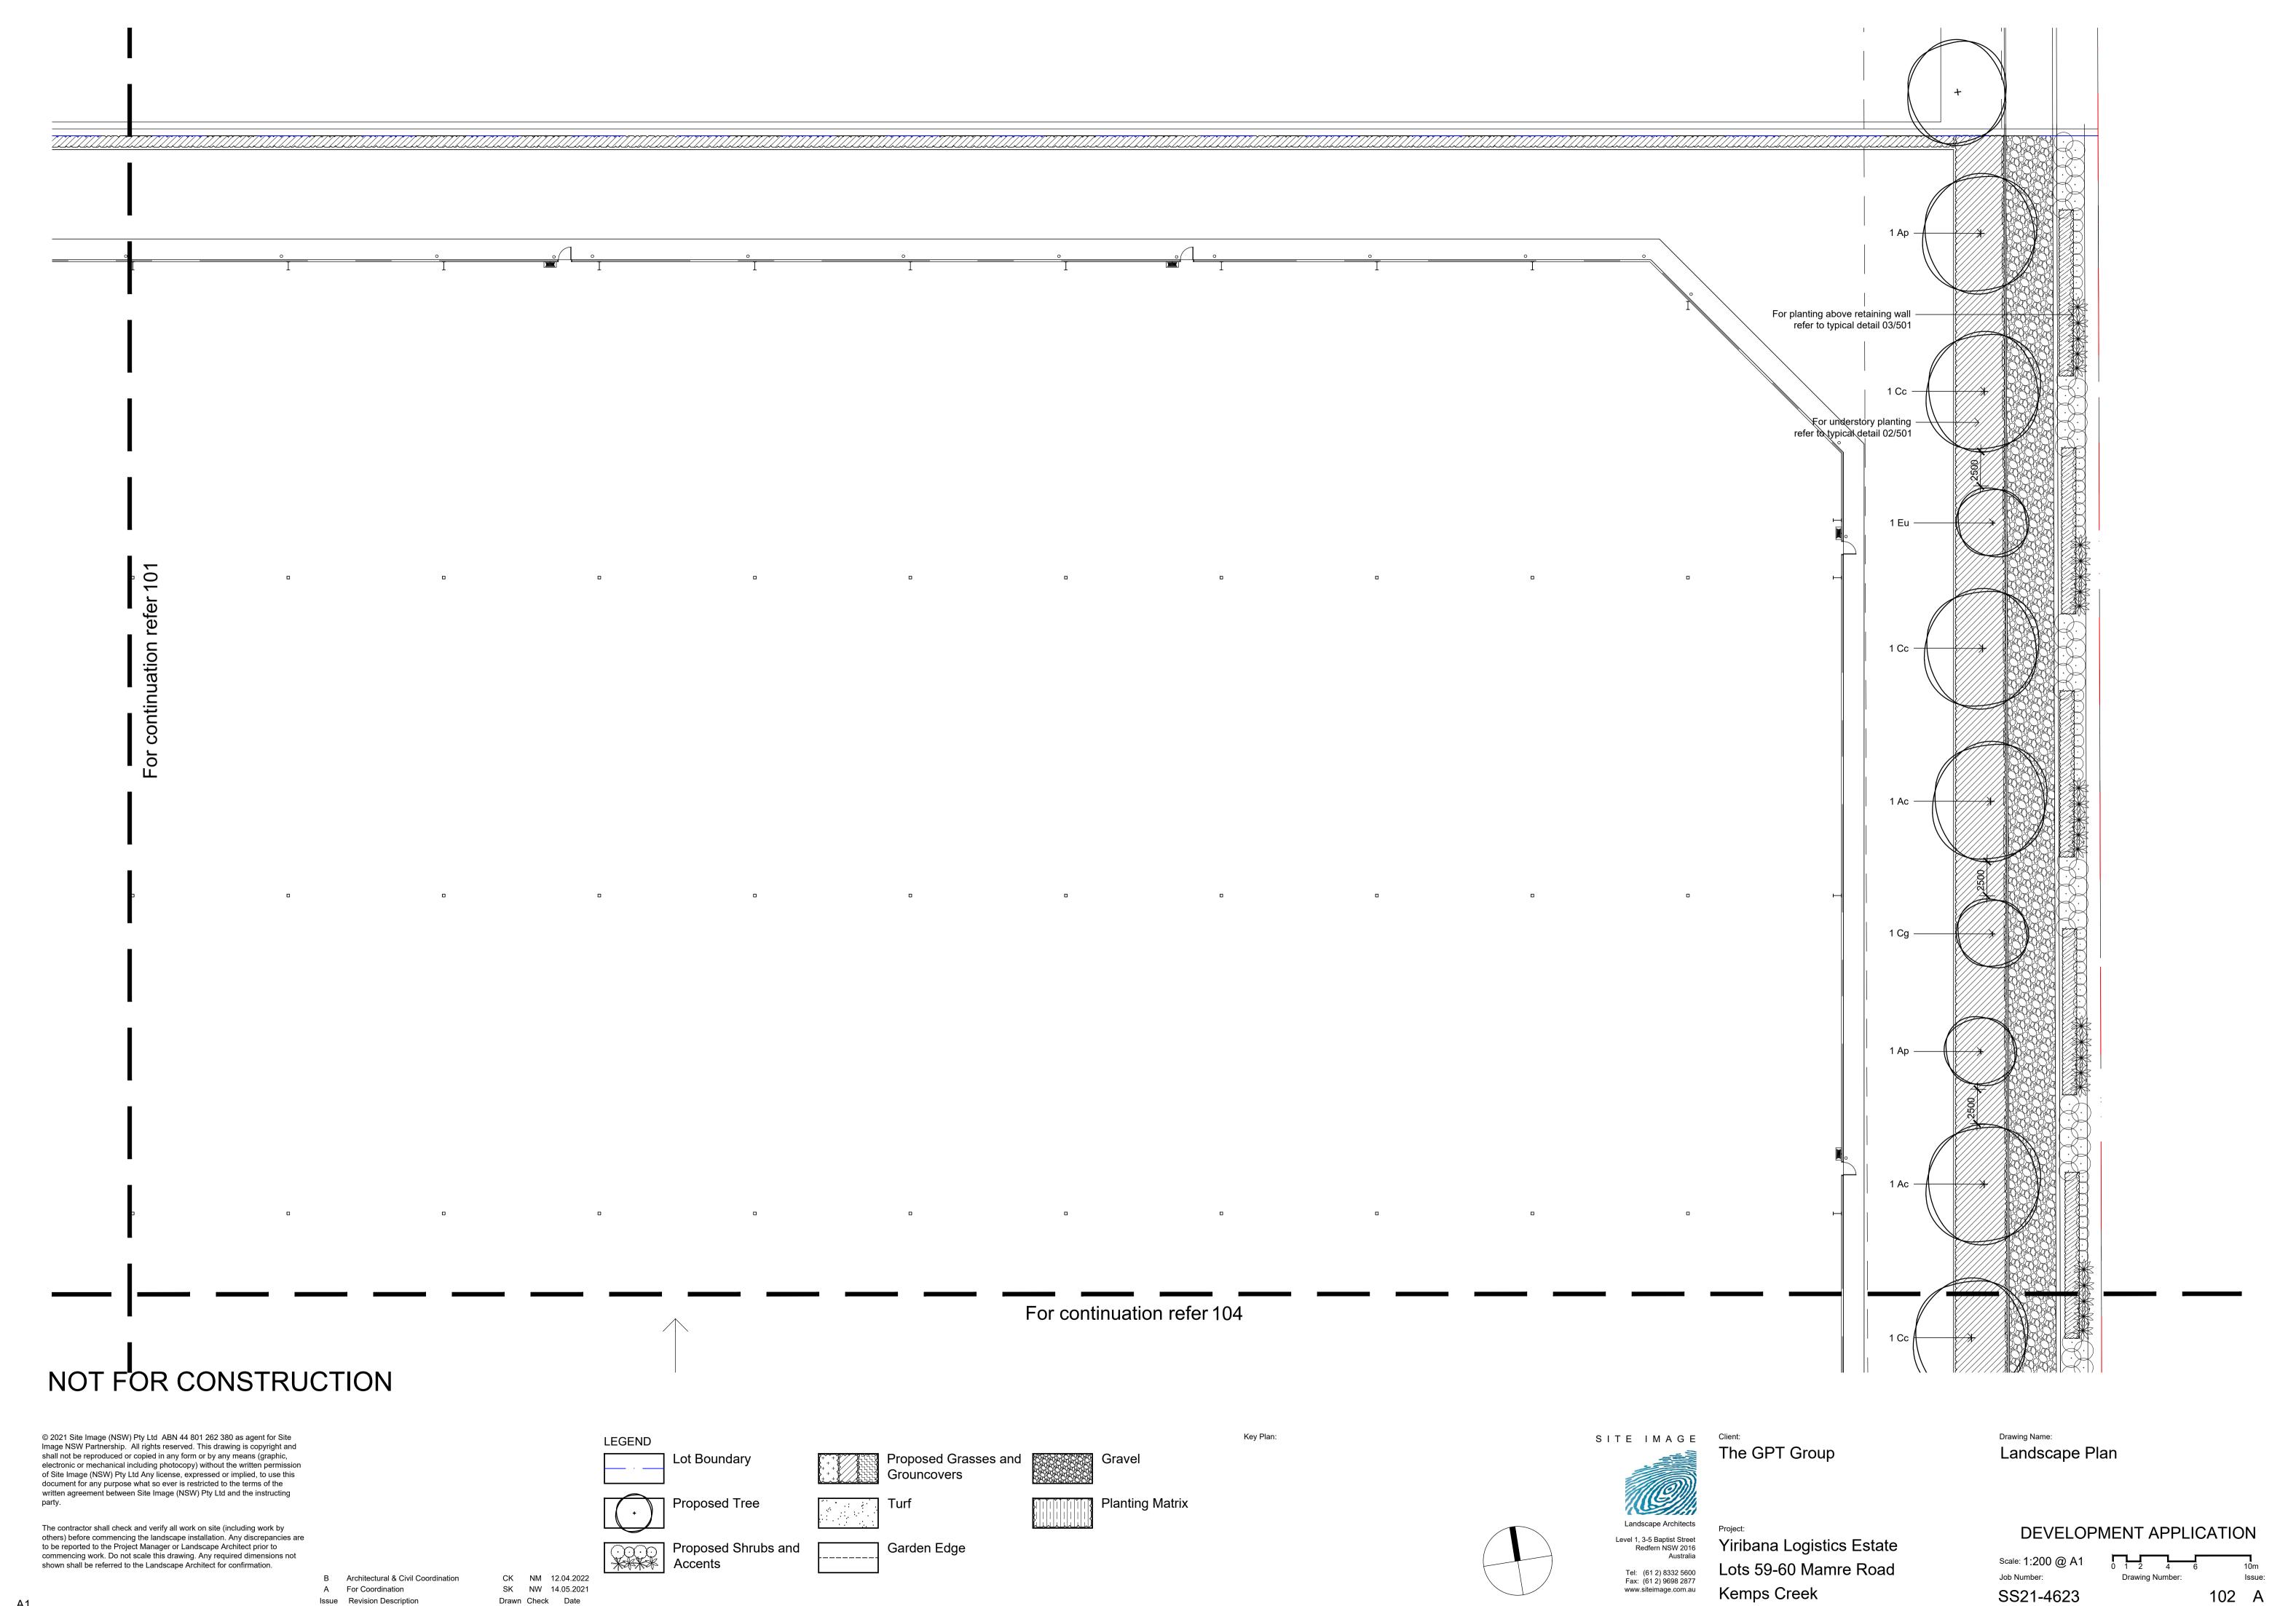Issue Revision Description



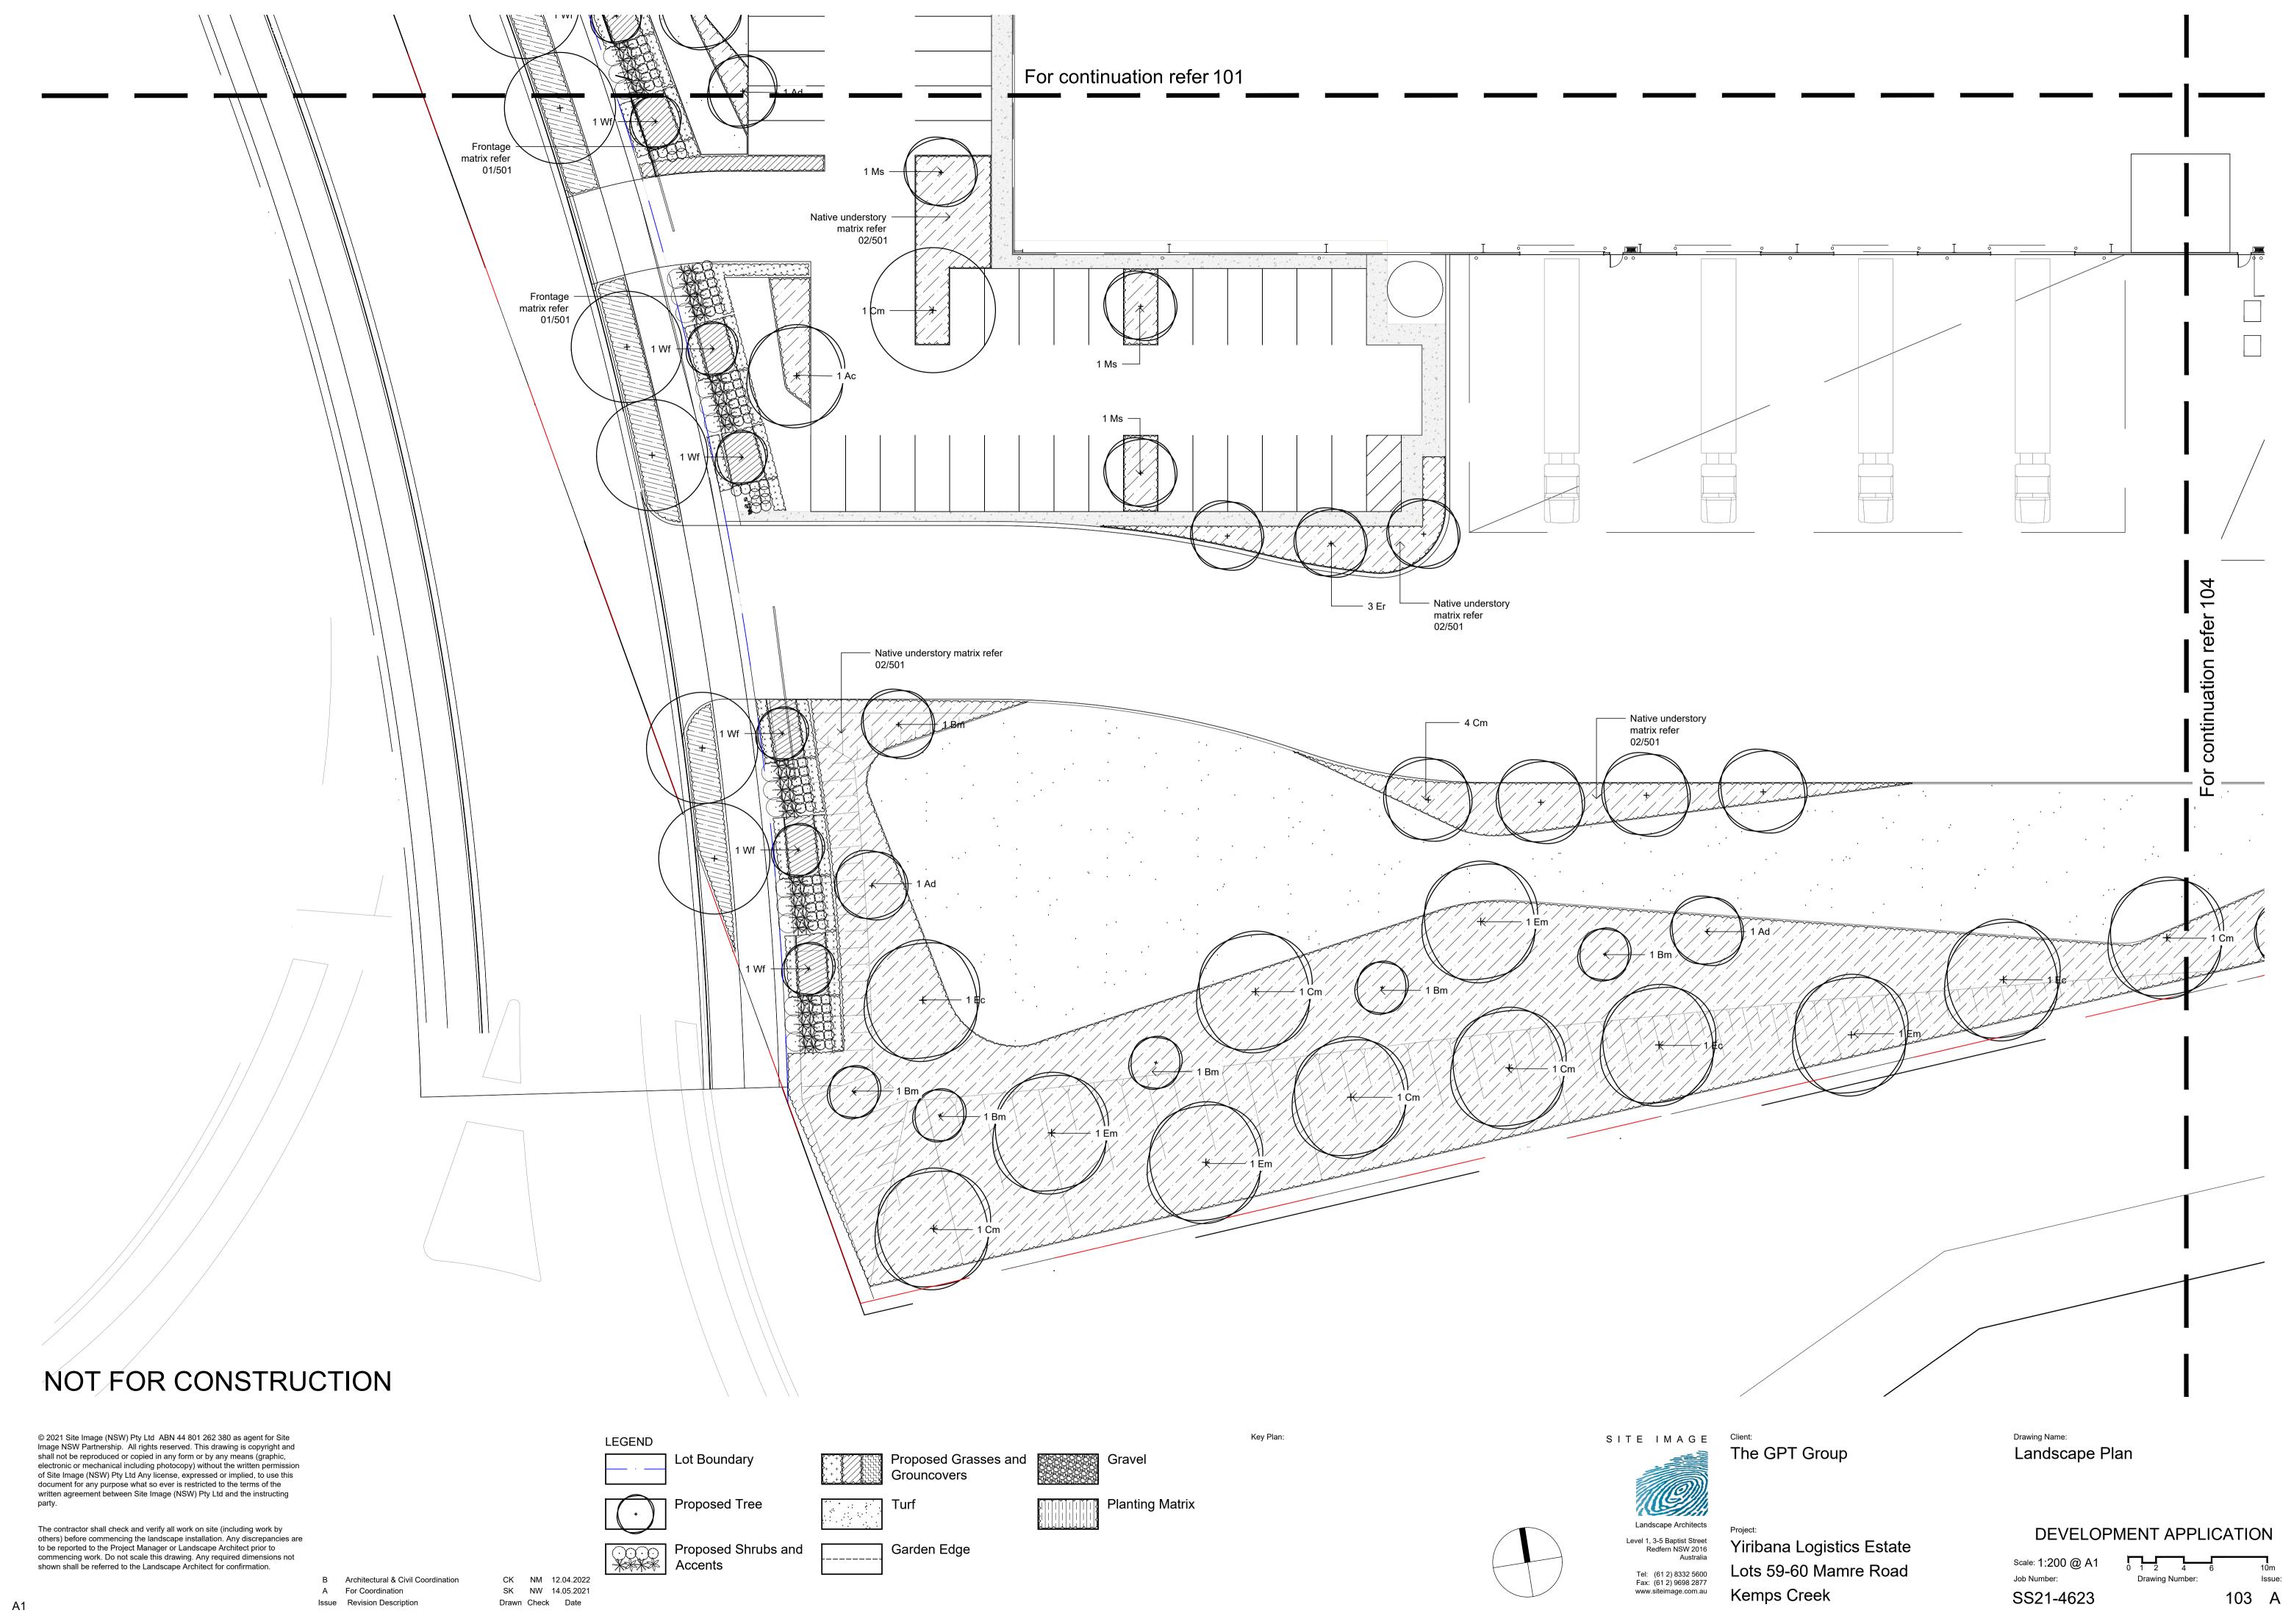

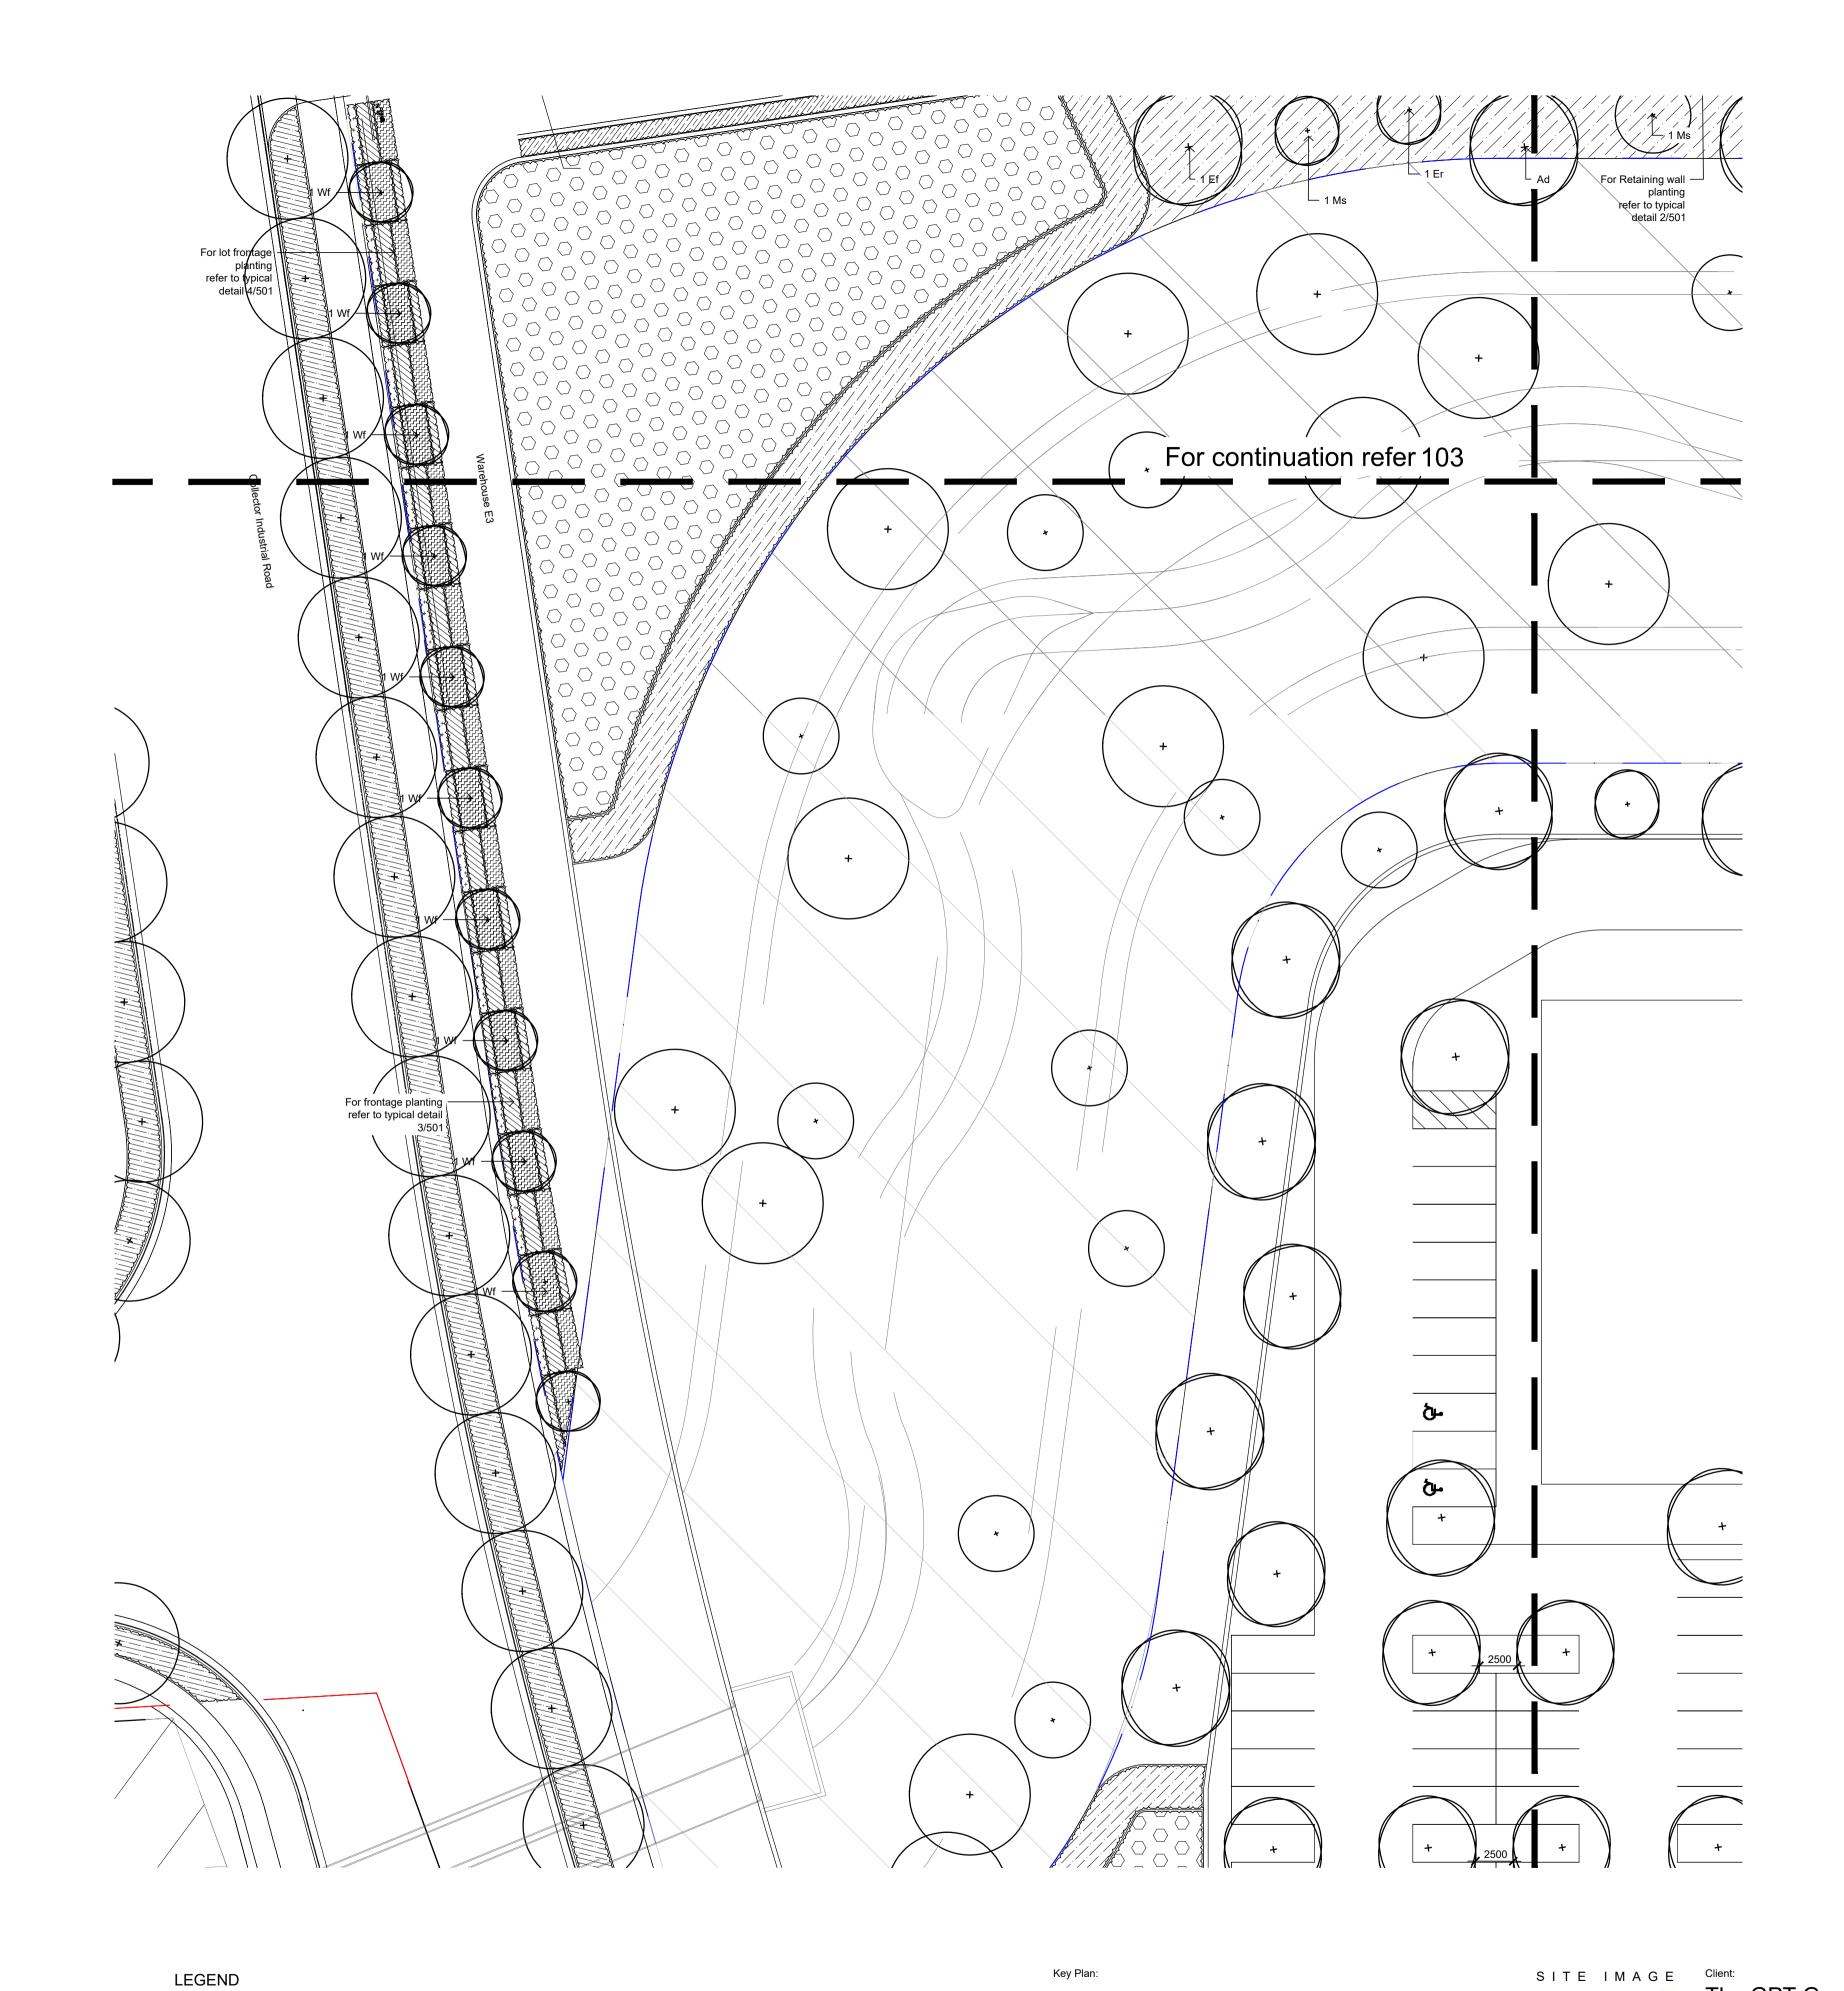

Gravel

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Drawn Check Date


CK NM 12.04.2022 SK NW 14.05.2021

Site Boundary Proposed Tree

Proposed Shrubs and Accents

Grouncovers

Garden Edge

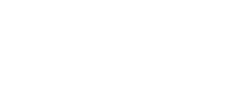

Landscape Architects Level 1, 3-5 Baptist Street Redfern NSW 2016 Australia Tel: (61 2) 8332 5600 Fax: (61 2) 9698 2877


The GPT Group


Yiribana Logistics Estate Lots 59-60 Mamre Road Kemps Creek

Drawing Name: Landscape Plan


DEVELOPMENT APPLICATION


Scale: 1:250 @ A1 0 1 2 4 6 Job Number: Drawing Number: SS21-4623 105 B

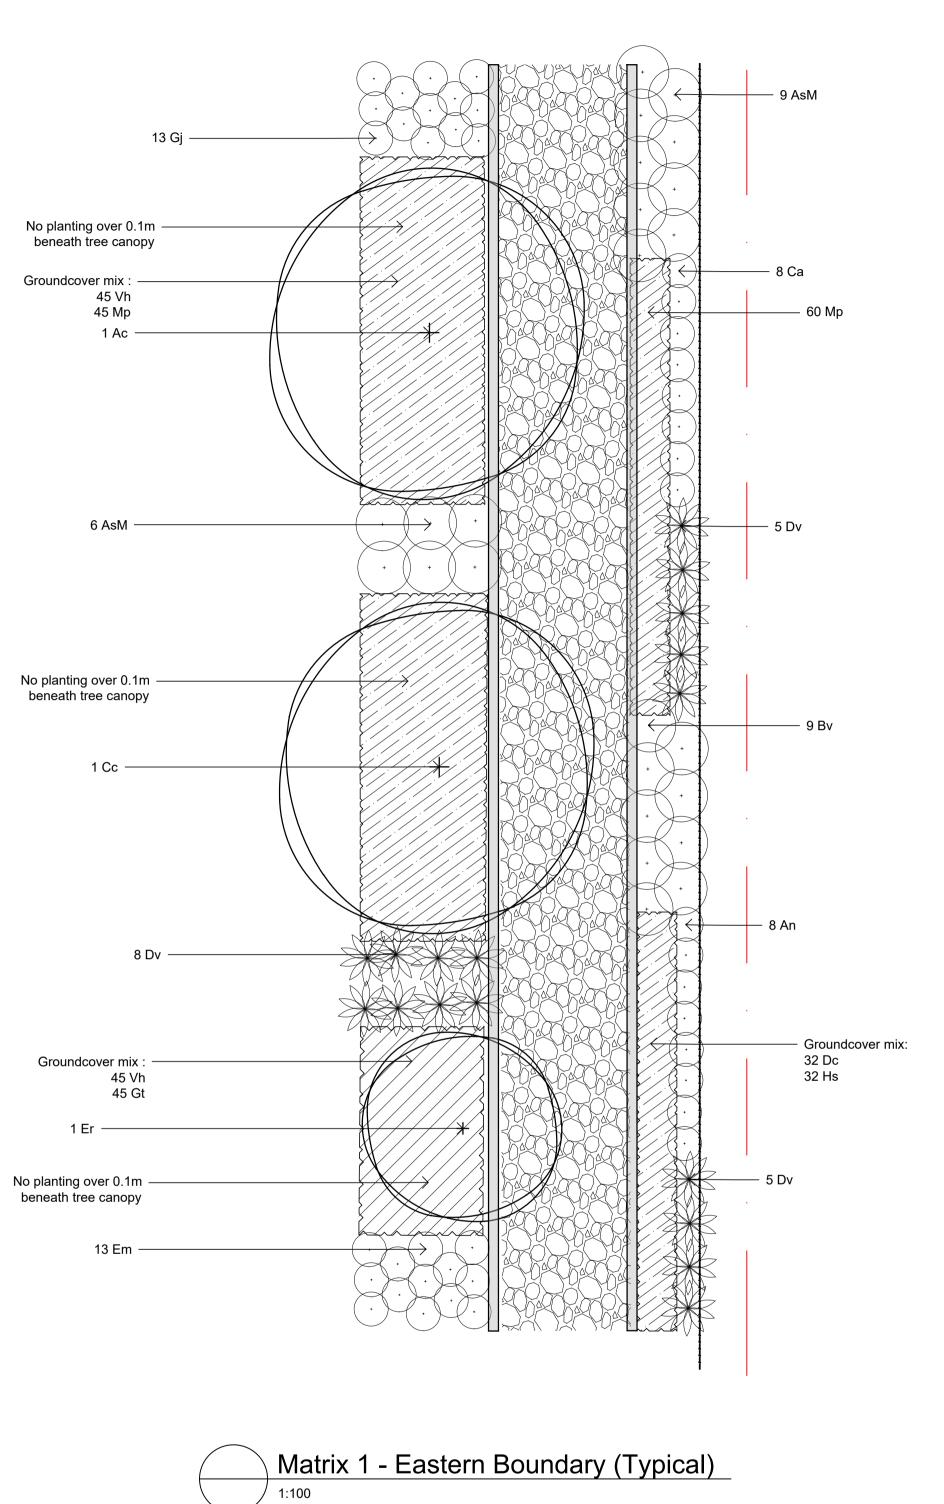

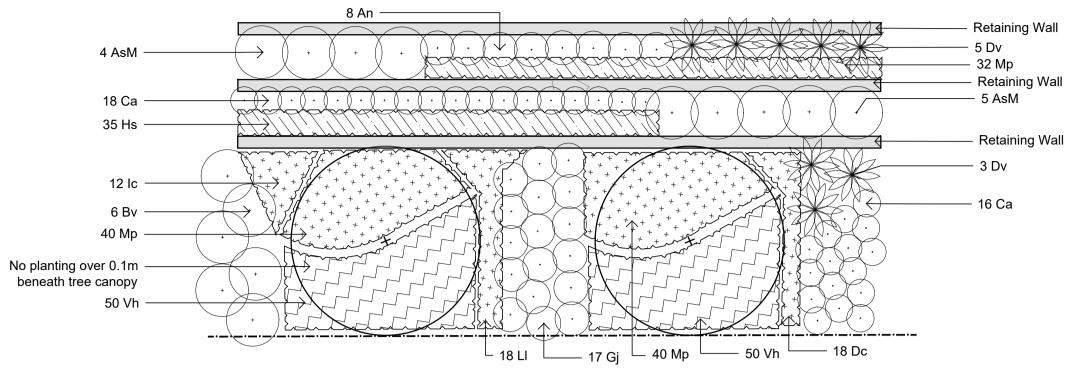

Matrix 2 - Typical Retaining Wall Planting

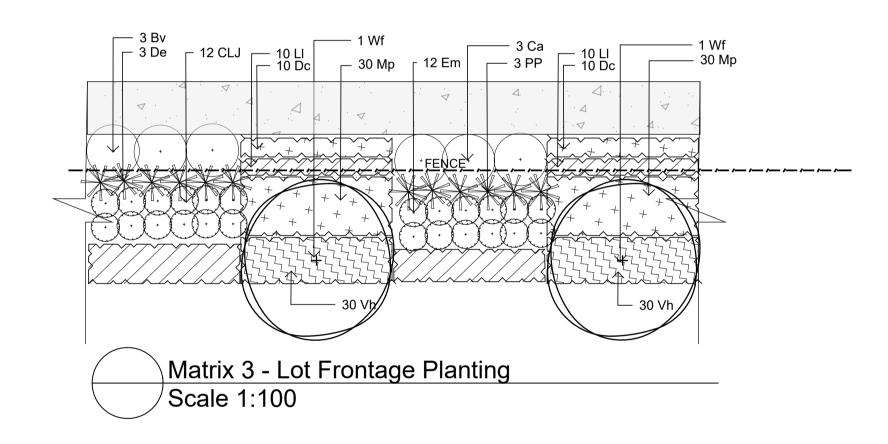

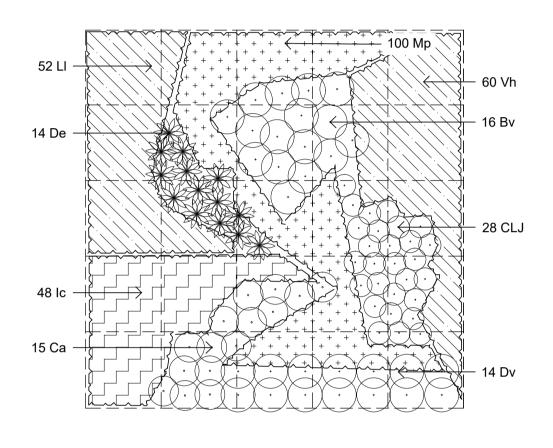

Matrix 4 - Native Understory Planting

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CK NM 12.04.2022 SSK NWW 1141-0955-22002211 Drawn Check Date

LEGEND

Key Plan:



The GPT Group

Yiribana Logistics Estate Lots 59-60 Mamre Road Kemps Creek

Planting Matrix Details

DEVELOPMENT APPLICATION

Job Number: Drawing Number: 501 A

SS21-4623

SPECIFICATION

References

All plans and details included in the project documents shall be read in as it was above the soil in the container. Apply fertiliser, as conjunction with this specification. All structural and civil works components of the landscape design shall be referenced to engineers' manufacturer's recommendations around the plants in the soil at the details and specifications. Read this specification in conjunction with time of planting. the plant and materials schedule on this drawing. If in doubt about any detail or if conflicts are found in the documents, seek advice.

Workmanship and Materials

trained and qualified landscape contractor who is experienced in The landscape contractor shall hold a current Building Contractors License and/or be a financial member of LNA Landscape Association and compacted, and U-shaped galvanised steel pegs at 1000 mm NSW & ACT or equivalent organisations in other states.

EXISTING TREES

Trees to be Retained and Protected

Identify and mark trees and shrubs to be retained using a suitable non-injurious, easily visible and removable means of identification. Protect from damage the trees and shrubs to be retained, including those beyond the site area, both above and below the ground. If a tree becomes damaged during the works or it is proposed to perform work **Mulch** on a tree, give written notice immediately and obtain instructions.

Work near Trees

Keep the area of the drip-line free from construction material and debris. Do not place bulk materials and harmful materials under or near design surface levels. Over fill to allow mulch to settle to the specified trees. Do not place spoil from excavations against tree trunks. Prevent depth. wind-blown materials such as cement from harming trees and plants. Do not remove topsoil from, or add topsoil to, the area within the drip-line of trees.

EARTHWORKS

Excavation, Trimming and Filling

Except as otherwise note in the contract, bulk excavation is excluded from the landscape works. Trim and fill the excavated ground surfaces to achieve design levels to accommodate finish materials as detailed. Turf Compact the finished surface as required for the finished ground treatment.

Sub-soil Drainage

supply and install sub-soil drainage pipes as required for the new works to ensure that all gardens are well drained. Connect the sub-soil • In stretcher pattern, joints staggered and close butted; drainage pipes to the nearest downstream stormwater pits. Include pipe filter socks.

SOFTWORKS

Undertake at least two (2) soil tests, in locations as advised by Project

Manager, and provide results and recommendations for the improvement of plant growth and to adjust the soil to achieve appropriate planting medium (including pit levels) for successful plant growth.

finished design levels. Shape the subsoil to fall to subsoil drains where emitters that provide a drifting mist that may wet paths and the applicable. Do not excavate within the drip line of trees to be retained. buildings. Cultivate the subsoil to a further depth of 100mm. Remove stones exceeding 25mm, clods of earth exceeding 50mm, and weeds, rubbish LANDSCAPE MAINTENANCE or other deleterious material brought to the surface during cultivation. results and to manufacturer's recommendations. Trim the surface to design levels after cultivation.

Topsoil

Import topsoil for the garden and turf areas, unless the topsoil can be • Pruning; provided from material recovered from the site, as recommended in the • Insect and pest control; soil testing results. Spread the topsoil on the prepared subsoil and • Fertilising; grade evenly, compact lightly and uniformly in 150mm layers. Avoid • Stakes and ties; differential subsidence and excess compaction and produce a finished • Maintaining mulch topsoil surface which has the following characteristics:

- flush with adjoining hard surfaces such as paths and edge; Smooth and free from stones or lumps of soil;
- Graded to drain freely, without ponding, to catchment points;
- Graded evenly to adjoining surfaces; and Ready for planting.
- Compost

animal manure, free from harmful chemicals, grass and weed growth.

Fertiliser Provide proprietary fertilisers, delivered to the site in sealed bags

ratio, recommended uses and application rates.

- Supply plants in accordance with the landscape drawings and schedules, which have the following characteristics: • Large healthy root systems, with no evidence of root curl, restriction
- or damage; Vigorous, well established, free from disease and pests, of good
- form consistent with the species or variety: Hardened off, not soft or forced, and suitable for planting in the
- natural climatic conditions prevailing at the site, and in particular
- shade conditions; • Grown in final containers for not less than twelve weeks;
- Trees, unless required to be multi-stemmed, shall have a single
- leading shoot: and • Containers shall be free from weeds and of appropriate size in relation to their container.

Plant Installation

Following excavation of the planting hole place and spread 15gms of wetting agent pre-mixed with one (1) litre of water. Place the plant correctly orientated to north or for best presentation. Backfill the

planting holes with specified topsoil mixture. Lightly tamp and water to Product brand / manufacturer's name, eliminate air pockets. Ensure the topsoil is not placed over the top of the rootball. Keep the plant stem at the same height above the ground recommended in the soil testing results or in accordance with the

Chemical / product name,

Application quantity and rate,

Results of application, and

Use approval authority.

fertilising including:

correct depth as specified.

necessarv

Date of application and location,

Product brand / manufacturer's name,

Application quantity and rate, and

Date of application and location.

depressions and hollows in the surface.

Provide additional watering, if necessary.

Fertiliser / product name,

Fertilising - Fertilise gardens with a proprietary slow release

fertiliser applied in accordance with the manufacturer's directions and

Stakes and ties - Adjust and replace as required to ensure

plants remain correctly staked. Remove those not required at the end

• Maintaining mulch - Maintain the surface in a clean, tidy and

weed free condition and reinstate the mulch as necessary to ensure

height of between 30-50mm. Do not remove more than one third of

that each individual plant receives the required amount of water to

maintain healthy and vigorous growth, adjust and rectify as required.

Erosion control - Where necessary, maintain the erosion

control devices in a tidy and weed free condition and reinstate as

necessary to ensure control measures are effective where deemed

Weeding and rubbish removal - During the plant establishment

re-occur throughout all planted, mulched and paved areas. The

infestation of unwanted plants by seed distribution. Whenever

possible, time weed removal to precede flowering and seed set.

contractor shall target weeds that are capable of producing a major

Mowing and top dressing - Mow the turf to maintain a grass

the grass height at any one time. Remove grass clippings from the site

Irrigation and watering - Maintain the irrigation system to sure

of the planting establishment period (Defects Liability Period).

after each mowing. Top dress to a maximum of 10mm to fill

recommendations. Record in the logbook all relevant details of

Chemical contents,

Embankment Stabilisation

Where necessary to prevent soil erosion or soil movement, stabilise embankments. As a minimum this should be on slopes >1:3. Stabilise The whole of the landscape works shall be carried out by a competent, embankments using biodegradable fibre reinforced with heavy weight polymer mesh. Lay mesh from top to bottom of slope. Install in horticultural practices, landscape construction and planting techniques. accordance with manufacturer's specification, including 300 x 300 mm anchor trenches at top and bottom, backfilled with soil over the mesh centres and 250mm centres at edge overlaps. Plant after matting is

Root Barrier

Supply and install root control barriers to all new tree plantings adjacent to walls, paths and all trunk service trenches, where their proximity poses a threat to the stability of the infrastructure. Install in accordance with manufacturer's recommendations.

Mulch shall be approved recycled wood fibre or pine bark mulch. Place • mulch in all garden beds to a depth of 75mm, after all specified plants are installed. Keep mulch clear of all plant stems and rake to an even surface flush with the surrounding surfaces evenly graded between

Stakes and Ties

pointed at one end, in the following quantities and sizes for each of the period remove by hand, rubbish and weed growth that may occur or

Stakes shall be durable hardwood, straight, free of knots and twists,

- Plants (>25 lt): 1 off 38 x 38 x 1200mm; • Semi-advanced plants (≥75 lt): 2 off 50x50x 1800mm;
- Advanced (>100 lt): 3 off 50 x 50 x 2400mm.

Turf shall be delivered to site as 25mm minimum thick cut rolls. Obtain turf from a specialist grower of cultivated turf. Provide turf of even thickness, free from weeds and other foreign matter. Deliver turf to the site within 24 hours of being cut, and lay it within 24 hours of delivery. Keep the excavated works drained and free of standing water. Allow to Prevent it form drying out between cutting and laying. Lay the turf in the

following manner: Parallel long sides of level areas, with contours on slopes; &

To finish flush, after tamping, with adjacent finished surfaces of

IRRIGATION

All proposed landscape areas shall be irrigated.

The irrigation system shall be an automatic fixed drip system, with an irrigation controller self operated via a soil moisture sensor. The system shall be compatible to the type of plant material and rates of water required. Where appropriate adjustable and fully serviceable. The layout of the entire irrigation is to ensure that each individual plant receives the required amount of water to maintain healthy and vigorous Excavate all garden beds to bring the subsoil to at least 300mm below growth. The irrigation system shall be such that, component theft, finished design levels. Shape the subsoil to fall to subsoil drains where vandalism, over-spray and wetting of paths shall be reduced to a applicable. Do not excavate within the drip line of trees to be retained. minimum or completely eliminated by the use of drip, pop-up sprinklers Excavate all turf areas to bring the subsoil to at least 100mm below and judiciously placed fixed spray emitters. Do not use fine mist type

Do not disturb services or tree roots, if necessary cultivate these areas The Landscape Contractor shall rectify defects during installation and by hand. During cultivation, thoroughly mix in materials required to be that become apparent in the works under normal use for the duration of incorporated into the subsoil, as recommended in the soil testing the contract Defects Liability Period. The Landscape Contractor shall maintain the contract areas by the implementation of industry accepted horticultural practices for 52 weeks. The landscape maintenance works shall include, but not be limited to, the following:

- Replacing failed plants;

- Mowing and top dressing: • Finished to design levels, allowing for mulch or turf, which is to finish • Irrigation and watering;
 - Erosion control: and
 - Weeding and rubbish removal.

Maintenance Log Book Implement and keep a maintenance log book recording when and what

maintenance work has been undertaken and what materials, actions and decisions have been used, implemented and concluded to keep Provide, in accordance with AS 4454, well rotted vegetative material or the landscape always looking its best.

Maintenance Activities

Schedule the following activities to occur on a timely basis.

- marked to show manufacturer or vendor, weight, fertiliser type, N:P:K Plant replacement - Replace plants that have failed to mature, die or are damaged. Replacement plants shall be in a similar size and quality and identical species or variety to the plant that has failed. Replacement of plants shall be at the cost of the landscape contractor unless advised otherwise. If the cause of the failure is due to a controllable situation then correct the situation prior to replacing
 - Pruning Prune dead wood, broken limbs, dead or infected foliage and as needed to develop strong, healthy plants to achieve the
 - shape and form expected of the plant type. Insect and pest control - Avoid spraying:
 - o if ever possible: in wet weather or if wet weather is imminent;
 - if target plants are still wet after rain;

B Architectural & Civil Coordination

in windy weather; and if non-target species are too close.

Immediately report to the Project Manager any evidence of intensive weed infestation, insect attack or disease amongst plant material. Submit all proposals to apply chemicals and obtain approval before starting this work. When approved, spray with herbicide, insecticide, fungicide as appropriate in accordance with the manufacturers' recommendations. Record in the logbook all relevant details of spraying activities including:

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LEGEND

CK NM 12.04.2022

Maintenance Program

Logbook

Plant Replacement

Mulch

Erosion Control

Stakes and ties

Weed and Rubbish removal

Pruning

Spraying

Urgent Works

Planting and fertilising

Watering

12 Mowing, top dressing and edging

4

11

Frequency

D W 2W 3W M 3M 6M

+

Action

Complete a logbook entry every day at site and at least every two

request, make the logbook available for inspection. Submit copies of

new entries in the logbook to the Contract Administrator on a monthly

should result in less maintenance work when problems are observed

basis. Please note that more frequent, short, occasional inspection

Inspect and replace failed plants within 2 weeks of observation of

failure. Match species, size (original) and location of new with old.

turning to a depth of at least 100mm, roughly level the soil and then

place mulch. Do not disturb major plant roots while aerating soil.

Inspect every two weeks, adjust and/or replace as necessary but

Inspect and remove immediately upon observation. Leave no waste

on site. Dispose of waste material at a designated waste disposal

Inspect every 2 weeks and prune as necessary to remove dead

Inspect every 2 weeks and action as necessary. Do not spray if

Complete within 1 week (7 days) of notification. Inspect and clear

Inspect every 2 weeks and remove spent flowers and dead stalks as

they become apparent. Fertilise gardens every 3 months or other

frequency in accordance with fertiliser manufacturer's directions.

Water when and where necessary every day at site and at least

every 2 weeks generally. Do not allow soil and plants to dehydrate.

Allow for prolonged rain, windy and dry periods. Water in the early

morning or late afternoon to avoid excessive evaporation during the

+ Summer fortnightly. Winter monthly. Top-dress 6 monthly.

heat of the day.

Spray for disease control only when absolutely necessary.

other non-chemical methods will satisfy the need to remove insects.

wood, improve plant shape and promote healthy vigorous new

observation. Prior to placing new mulch aerate the soil by fork

Inspect every two weeks and repair ground, soil and mulch

immediately. Maintain erosion control device as necessary.

remove as plants mature and are able to support themselves.

weeks. All actions listed below require a logbook entry. Upon

earlier than they might otherwise have been seen.

Inspect and replace mulch deficiencies within 2 weeks of

Key Plan:





Fax: (61 2) 9698 2877

SITE IMAGE Client: The GPT Group

> Yiribana Logistics Estate Lots 59-60 Mamre Road Kemps Creek

Landscape Specification


DEVELOPMENT APPLICATION


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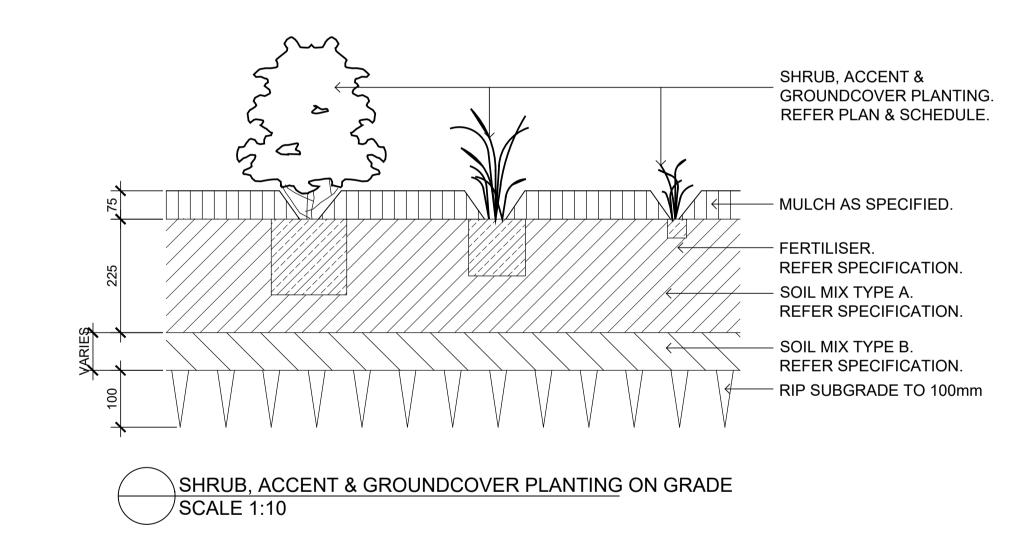
Drawing Number: SS21-4623

501

SK NW 14.05.2021 A For Coordination Issue Revision Description Drawn Check Date



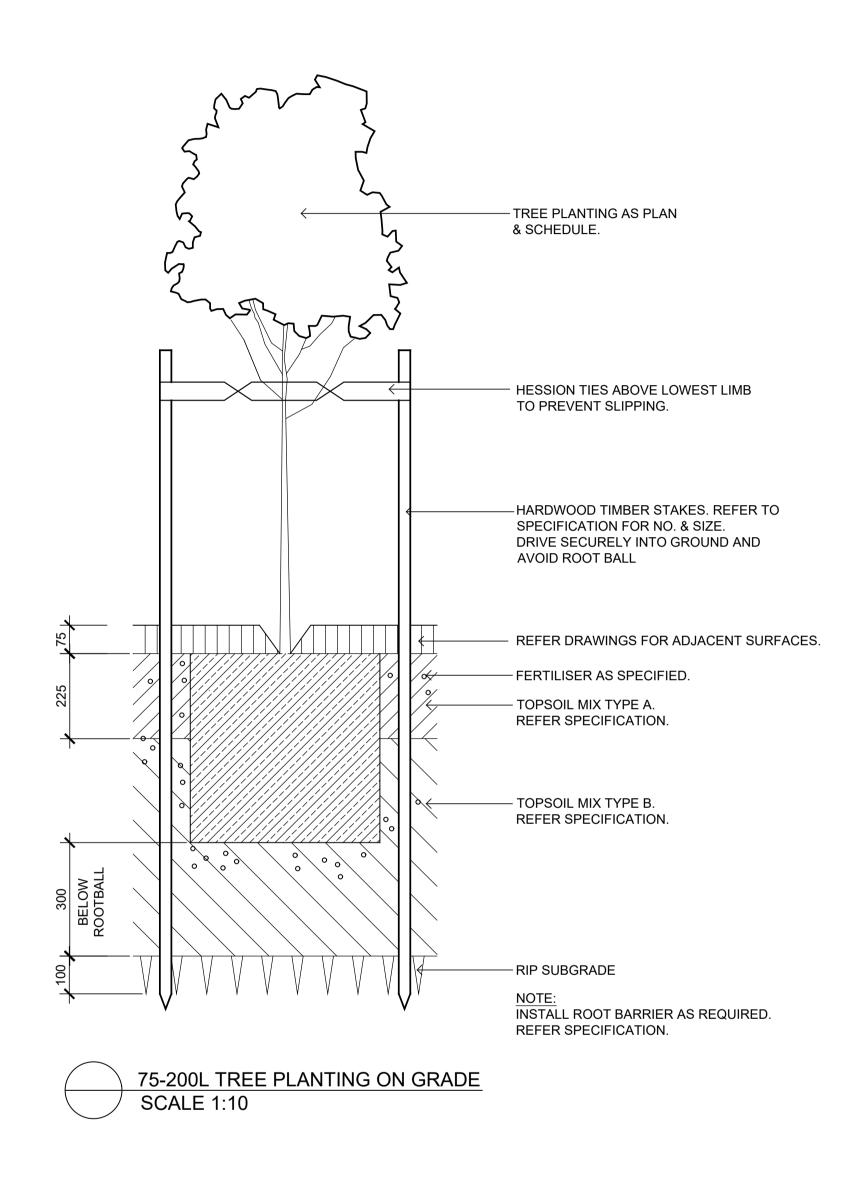

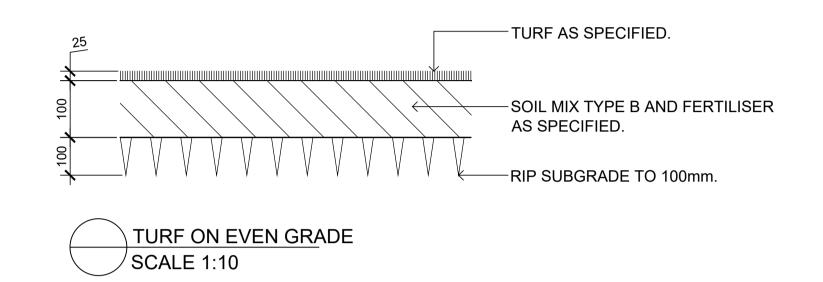

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LEGEND

Key Plan:



The GPT Group

Yiribana Logistics Estate Lots 59-60 Mamre Road Kemps Creek

Landscape Details

DEVELOPMENT APPLICATION

Job Number: Drawing Number:

A For Coordination Issue Revision Description

Drawn Check Date

SK NW 14.05.2021

SS21-4623 502 A

SPECIFICATION

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Work near Trees

Keep the area of the drip-line free from construction material and trees. Do not place spoil from excavations against tree trunks. Prevent depth. wind-blown materials such as cement from harming trees and plants. Do not remove topsoil from, or add topsoil to, the area within the drip-line of trees.

EARTHWORKS

Excavation, Trimming and Filling

Except as otherwise note in the contract, bulk excavation is excluded from the landscape works. Trim and fill the excavated ground surfaces to achieve design levels to accommodate finish materials as detailed. Turf Compact the finished surface as required for the finished ground treatment.

Sub-soil Drainage

supply and install sub-soil drainage pipes as required for the new works to ensure that all gardens are well drained. Connect the sub-soil • In stretcher pattern, joints staggered and close butted; drainage pipes to the nearest downstream stormwater pits. Include pipe filter socks.

SOFTWORKS

Undertake at least two (2) soil tests, in locations as advised by Project Manager, and provide results and recommendations for the improvement of plant growth and to adjust the soil to achieve appropriate planting medium (including pit levels) for successful plant growth.

Excavate all garden beds to bring the subsoil to at least 300mm below growth. The irrigation system shall be such that, component theft. finished design levels. Shape the subsoil to fall to subsoil drains where vandalism, over-spray and wetting of paths shall be reduced to a finished design levels. Shape the subsoil to fall to subsoil drains where emitters that provide a drifting mist that may wet paths and the applicable. Do not excavate within the drip line of trees to be retained. buildings. Cultivate the subsoil to a further depth of 100mm. Remove stones exceeding 25mm, clods of earth exceeding 50mm, and weeds, rubbish LANDSCAPE MAINTENANCE or other deleterious material brought to the surface during cultivation. esults and to manufacturer's recommendations. Trim the surface to design levels after cultivation.

Topsoil

Import topsoil for the garden and turf areas, unless the topsoil can be Pruning; provided from material recovered from the site, as recommended in the • Insect and pest control; soil testing results. Spread the topsoil on the prepared subsoil and • Fertilising; grade evenly, compact lightly and uniformly in 150mm layers. Avoid • Stakes and ties; differential subsidence and excess compaction and produce a finished • Maintaining mulch topsoil surface which has the following characteristics:

- Finished to design levels, allowing for mulch or turf, which is to finish Irrigation and watering; flush with adjoining hard surfaces such as paths and edge;
- Smooth and free from stones or lumps of soil; Graded to drain freely, without ponding, to catchment points;
- Graded evenly to adjoining surfaces; and Ready for planting.

Compost

Provide, in accordance with AS 4454, well rotted vegetative material or the landscape always looking its best. animal manure, free from harmful chemicals, grass and weed growth.

Fertiliser

Provide proprietary fertilisers, delivered to the site in sealed bags marked to show manufacturer or vendor, weight, fertiliser type, N:P:K ratio, recommended uses and application rates.

Supply plants in accordance with the landscape drawings and

- schedules, which have the following characteristics: • Large healthy root systems, with no evidence of root curl, restriction or damage;
- Vigorous, well established, free from disease and pests, of good form consistent with the species or variety: Hardened off, not soft or forced, and suitable for planting in the
- natural climatic conditions prevailing at the site, and in particular shade conditions;
- Grown in final containers for not less than twelve weeks; • Trees, unless required to be multi-stemmed, shall have a single
- leading shoot: and • Containers shall be free from weeds and of appropriate size in

Plant Installation

relation to their container.

Following excavation of the planting hole place and spread 15gms of wetting agent pre-mixed with one (1) litre of water. Place the plant correctly orientated to north or for best presentation. Backfill the

planting holes with specified topsoil mixture. Lightly tamp and water to Product brand / manufacturer's name, eliminate air pockets. Ensure the topsoil is not placed over the top of the rootball. Keep the plant stem at the same height above the ground recommended in the soil testing results or in accordance with the

Chemical / product name,

Application quantity and rate,

Results of application, and

Use approval authority.

fertilising including:

correct depth as specified.

necessarv

Date of application and location,

Product brand / manufacturer's name,

Application quantity and rate, and

Date of application and location.

depressions and hollows in the surface.

Provide additional watering, if necessary.

Fertiliser / product name,

Fertilising - Fertilise gardens with a proprietary slow release

fertiliser applied in accordance with the manufacturer's directions and

Stakes and ties - Adjust and replace as required to ensure

plants remain correctly staked. Remove those not required at the end

Maintaining mulch - Maintain the surface in a clean, tidy and

weed free condition and reinstate the mulch as necessary to ensure

height of between 30-50mm. Do not remove more than one third of

Mowing and top dressing - Mow the turf to maintain a grass

the grass height at any one time. Remove grass clippings from the site

Irrigation and watering - Maintain the irrigation system to sure

maintain healthy and vigorous growth, adjust and rectify as required.

Erosion control - Where necessary, maintain the erosion

control devices in a tidy and weed free condition and reinstate as

re-occur throughout all planted, mulched and paved areas. The

infestation of unwanted plants by seed distribution. Whenever

possible, time weed removal to precede flowering and seed set.

contractor shall target weeds that are capable of producing a major

necessary to ensure control measures are effective where deemed

of the planting establishment period (Defects Liability Period).

after each mowing. Top dress to a maximum of 10mm to fill

recommendations. Record in the logbook all relevant details of

Chemical contents,

Embankment Stabilisation

Where necessary to prevent soil erosion or soil movement, stabilise embankments. As a minimum this should be on slopes >1:3. Stabilise The whole of the landscape works shall be carried out by a competent, embankments using biodegradable fibre reinforced with heavy weight polymer mesh. Lay mesh from top to bottom of slope. Install in horticultural practices, landscape construction and planting techniques. accordance with manufacturer's specification, including 300 x 300 mm anchor trenches at top and bottom, backfilled with soil over the mesh centres and 250mm centres at edge overlaps. Plant after matting is

Root Barrier

Supply and install root control barriers to all new tree plantings adjacent to walls, paths and all trunk service trenches, where their proximity poses a threat to the stability of the infrastructure. Install in accordance with manufacturer's recommendations.

Mulch shall be approved recycled wood fibre or pine bark mulch. Place • mulch in all garden beds to a depth of 75mm, after all specified plants that each individual plant receives the required amount of water to are installed. Keep mulch clear of all plant stems and rake to an even surface flush with the surrounding surfaces evenly graded between debris. Do not place bulk materials and harmful materials under or near design surface levels. Over fill to allow mulch to settle to the specified

Stakes and Ties

- Stakes shall be durable hardwood, straight, free of knots and twists,

 Weeding and rubbish removal During the plant establishment pointed at one end, in the following quantities and sizes for each of the period remove by hand, rubbish and weed growth that may occur or
- Semi-advanced plants (≥75 lt): 2 off 50x50x 1800mm; Advanced (>100 lt): 3 off 50 x 50 x 2400mm.

• Plants (>25 lt): 1 off 38 x 38 x 1200mm;

Turf shall be delivered to site as 25mm minimum thick cut rolls. Obtain turf from a specialist grower of cultivated turf. Provide turf of even thickness, free from weeds and other foreign matter. Deliver turf to the site within 24 hours of being cut, and lay it within 24 hours of delivery. Keep the excavated works drained and free of standing water. Allow to Prevent it form drying out between cutting and laying. Lay the turf in the

following manner:

 Parallel long sides of level areas, with contours on slopes; & To finish flush, after tamping, with adjacent finished surfaces of

IRRIGATION

All proposed landscape areas shall be irrigated.

The irrigation system shall be an automatic fixed drip system, with an irrigation controller self operated via a soil moisture sensor. The system shall be compatible to the type of plant material and rates of water required. Where appropriate adjustable and fully serviceable. The layout of the entire irrigation is to ensure that each individual plant receives the required amount of water to maintain healthy and vigorous applicable. Do not excavate within the drip line of trees to be retained. minimum or completely eliminated by the use of drip, pop-up sprinklers Excavate all turf areas to bring the subsoil to at least 100mm below and judiciously placed fixed spray emitters. Do not use fine mist type

Do not disturb services or tree roots, if necessary cultivate these areas The Landscape Contractor shall rectify defects during installation and by hand. During cultivation, thoroughly mix in materials required to be that become apparent in the works under normal use for the duration of incorporated into the subsoil, as recommended in the soil testing the contract Defects Liability Period. The Landscape Contractor shall maintain the contract areas by the implementation of industry accepted horticultural practices for 52 weeks. The landscape maintenance works shall include, but not be limited to, the following:

- Replacing failed plants;

- Mowing and top dressing;
- Erosion control: and Weeding and rubbish removal.
- Maintenance Log Book

Implement and keep a maintenance log book recording when and what maintenance work has been undertaken and what materials, actions and decisions have been used, implemented and concluded to keep

Maintenance Activities

Schedule the following activities to occur on a timely basis.

- Plant replacement Replace plants that have failed to mature, die or are damaged. Replacement plants shall be in a similar size and quality and identical species or variety to the plant that has failed. Replacement of plants shall be at the cost of the landscape contractor unless advised otherwise. If the cause of the failure is due to a controllable situation then correct the situation prior to replacing
- **Pruning** Prune dead wood, broken limbs, dead or infected foliage and as needed to develop strong, healthy plants to achieve the
- shape and form expected of the plant type.
- Insect and pest control Avoid spraying: o if ever possible:
- in wet weather or if wet weather is imminent; if target plants are still wet after rain;
- in windy weather; and
- if non-target species are too close.

B Architectural & Civil Coordination

A For Coordination

Immediately report to the Project Manager any evidence of intensive weed infestation, insect attack or disease amongst plant material. Submit all proposals to apply chemicals and obtain approval before starting this work. When approved, spray with herbicide, insecticide, fungicide as appropriate in accordance with the manufacturers' recommendations. Record in the logbook all relevant details of spraying activities including:

NOT FOR CONSTRUCTION

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The contractor shall check and verify all work on site (including work by others) before commencing the landscape installation. Any discrepancies are to be reported to the Project Manager or Landscape Architect prior to commencing work. Do not scale this drawing. Any required dimensions not shown shall be referred to the Landscape Architect for confirmation.

LEGEND

Key Plan:

Maintenance Program

Logbook

Plant Replacement

Mulch

Erosion Control

Stakes and ties

Weed and Rubbish removal

Pruning

Spraying

Urgent Works

Planting and fertilising

Watering

12 Mowing, top dressing and edging

4

11

Frequency

D W 2W 3W M 3M 6M

Action

Complete a logbook entry every day at site and at least every two

request, make the logbook available for inspection. Submit copies of

new entries in the logbook to the Contract Administrator on a monthly

should result in less maintenance work when problems are observed

basis. Please note that more frequent, short, occasional inspection

Inspect and replace failed plants within 2 weeks of observation of

failure. Match species, size (original) and location of new with old.

turning to a depth of at least 100mm, roughly level the soil and then

place mulch. Do not disturb major plant roots while aerating soil.

Inspect every two weeks, adjust and/or replace as necessary but

Inspect and remove immediately upon observation. Leave no waste

on site. Dispose of waste material at a designated waste disposal

Inspect every 2 weeks and prune as necessary to remove dead

Inspect every 2 weeks and action as necessary. Do not spray if

Complete within 1 week (7 days) of notification. Inspect and clear

they become apparent. Fertilise gardens every 3 months or other

frequency in accordance with fertiliser manufacturer's directions.

Water when and where necessary every day at site and at least

every 2 weeks generally. Do not allow soil and plants to dehydrate.

Allow for prolonged rain, windy and dry periods. Water in the early

morning or late afternoon to avoid excessive evaporation during the

+ Summer fortnightly. Winter monthly. Top-dress 6 monthly.

heat of the day.

Inspect every 2 weeks and remove spent flowers and dead stalks as

Spray for disease control only when absolutely necessary.

other non-chemical methods will satisfy the need to remove insects.

wood, improve plant shape and promote healthy vigorous new

observation. Prior to placing new mulch aerate the soil by fork

Inspect every two weeks and repair ground, soil and mulch


immediately. Maintain erosion control device as necessary.

remove as plants mature and are able to support themselves.

weeks. All actions listed below require a logbook entry. Upon

earlier than they might otherwise have been seen.

Inspect and replace mulch deficiencies within 2 weeks of

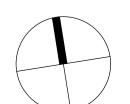



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The GPT Group

Yiribana Logistics Estate Lots 59-60 Mamre Road Kemps Creek

Landscape Specification

DEVELOPMENT APPLICATION

Job Number:

Drawing Number: SS21-4623

501

Issue Revision Description Drawn Check Date

CK NM 12.04.2022 SK NW 14.05.2021