

## ATC LEGER LAWN


LANDSCAPE ARCHITECTURAL DEVELOPMENT APPLICATION Issue: E Date: 22.01.2020

FOR: MOSTYN COPPER GROUP






## LOCATION & CONTEXT

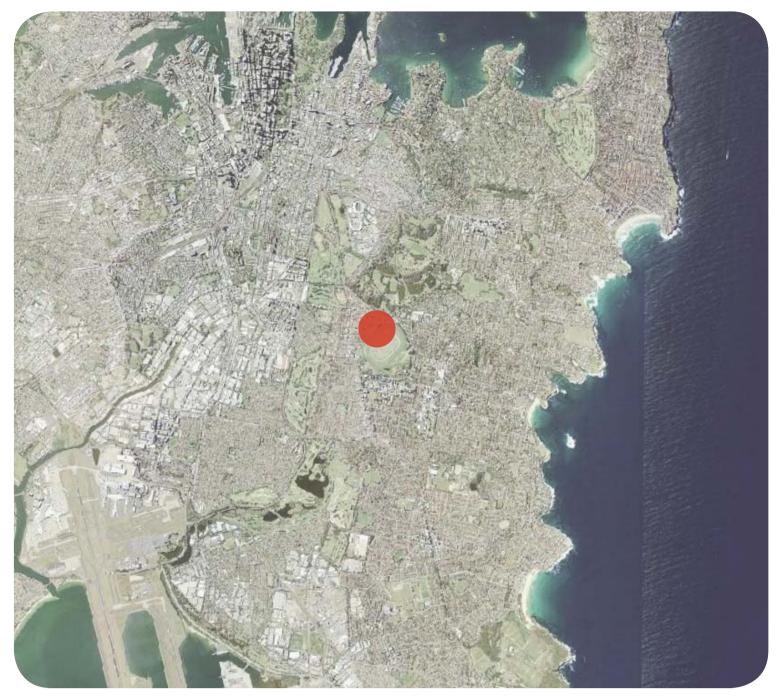

**GREATER CONTEXT** 

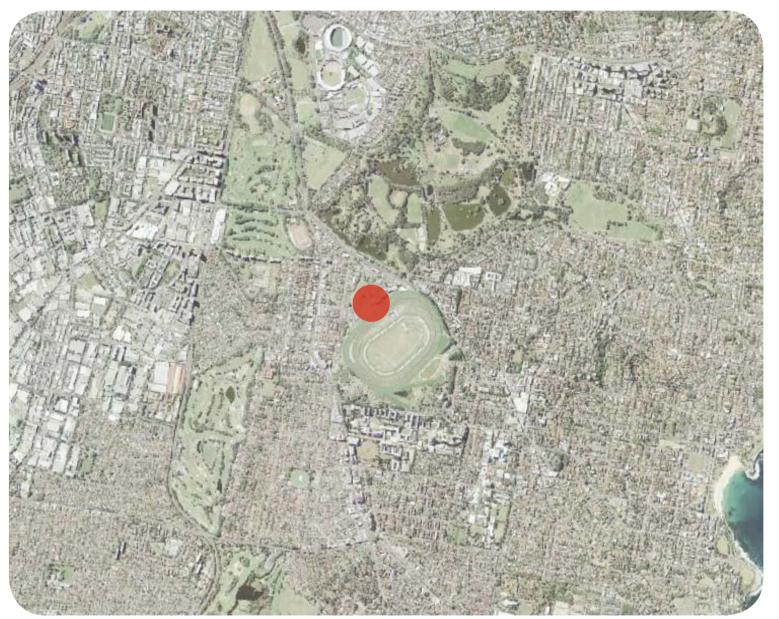


#### LOCAL CONTEXT

ATC Leger Lawn and proposed Winx Stand is located 5.5km South-East of Sydney CBD and is part of the Royal Randwick Racecourse.

The site sits between the Queen Elizabeth II Grandstand, the multideck carpark and the race track.

The proposed development is a 100m long grandstand called the 'Winx Stand' and will be two stories tall. Surrounding the building will be a landscape terrace for race viewing, the laneway and a long stretch of landscaped area that will be the location of portable eateries.

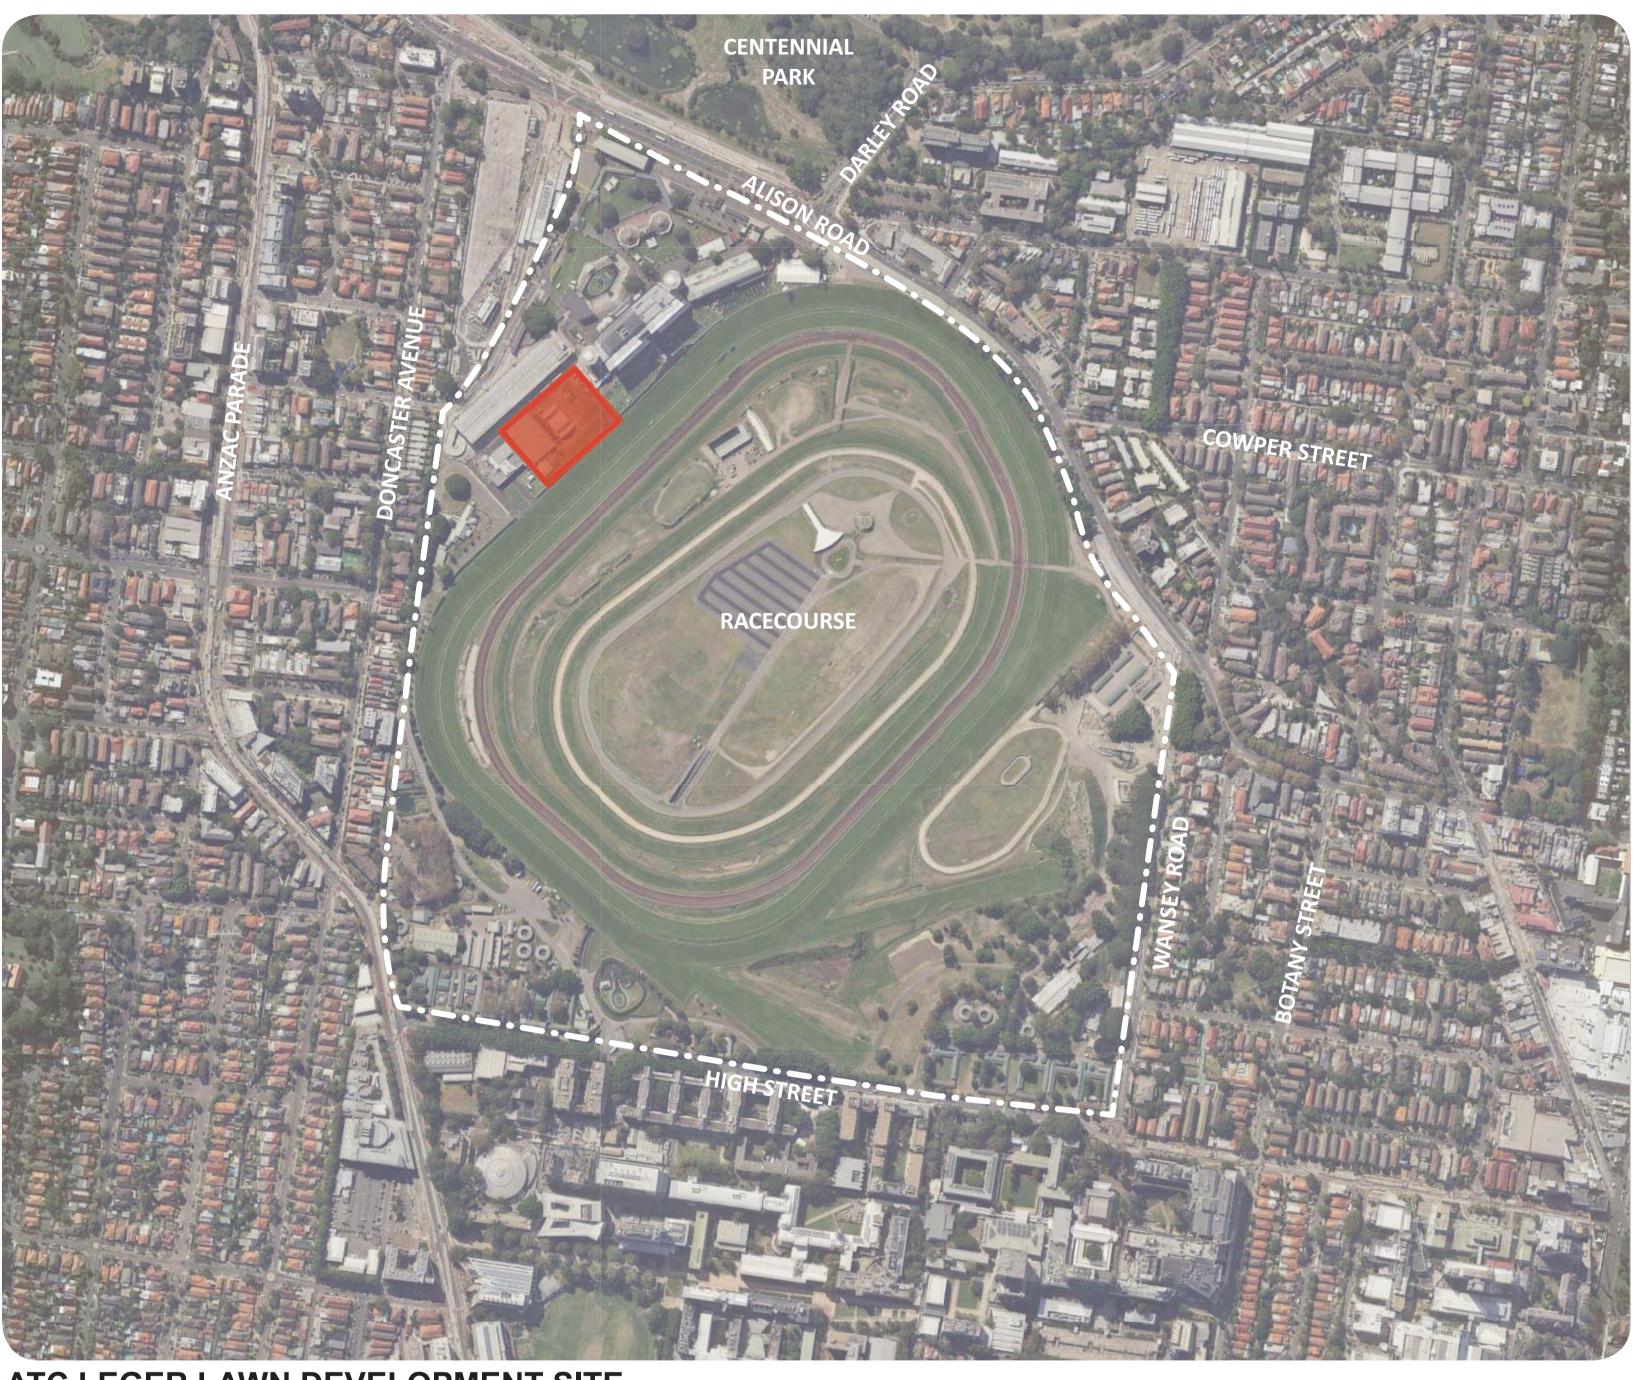

The landscape viewing terrace will comprise of in-situ concrete terraced steps oriented toward the finish line, which will allow a large volume of people to view the races, and create an atmosphere that facilitates socialising.

The landscaped zones will be integrated with lush low maintenance planting, in keeping with other areas of the spectators precinct at the racecourse. Flowering native vines to steel cables and cascading roof planters will provide greenery and ambiance. Further terraced areas

ATC LEGER LAWN DEVELOPMENT SITE

will be created through integrating planting and seating into stairways, which will create many multiple casual seating spaces that can be used for small gatherings of people, and compliment casual seating and utility adjacent to the laneway.

The planting palette will be consistent to other species found around Randwick Racecourse, to create a landscape cohesive with the greater precinct.



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Associates

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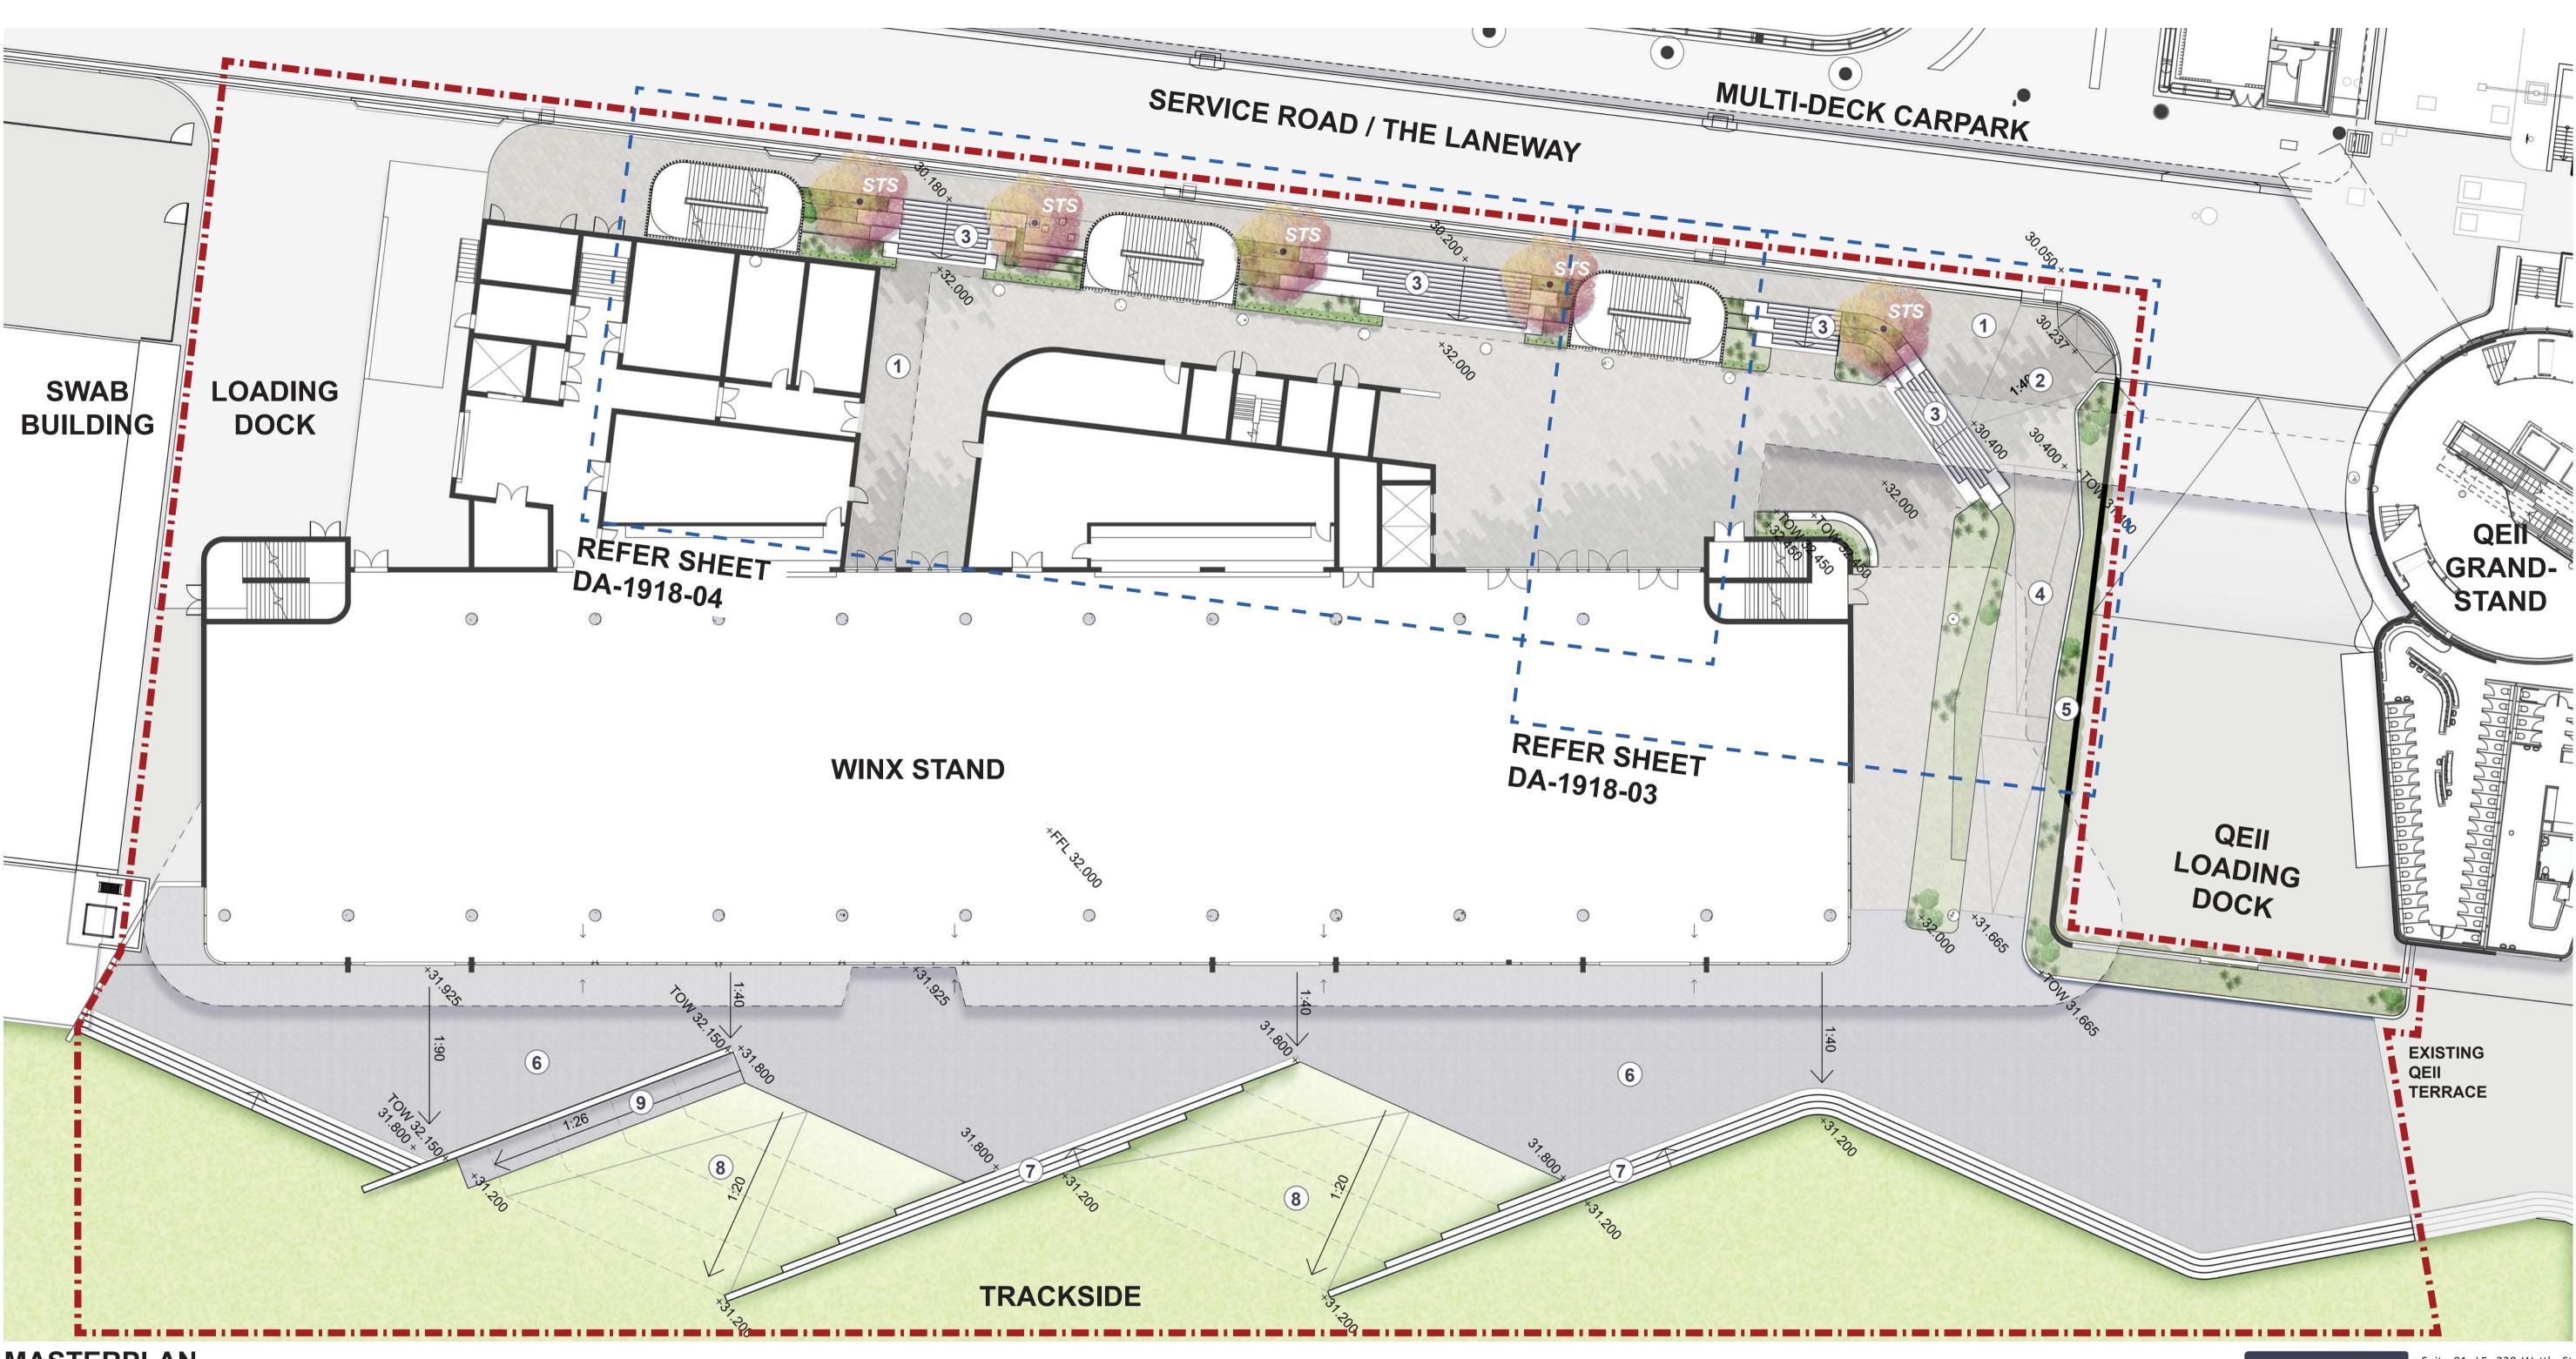
CLIENT MOSTYN COPPER GROUP

DRAWING **LOCATION & CONTEXT** 

DRAWING NO DA-1918-01 D jw/wl

DATE 30.10.2019

#### **GROUND FLOOR**



MASTERPLAN

#### NOTES


- Unit paving to main entry 1.
- Two tone paving defines entry to the Winx Stand 2.
- 3. Concrete stairs, seating edges and planting create active edges and entries
- Access path 4.
- Raised planter creates green edge to path. 5. Trailing plants green wall of the QEII loading dock
- 6. Asphalt terrace provides an outdoor spill out space facing the race track and links into the existing terrace in front of the QEII Grandstand
- 7. Terraced stairs define the outdoor terrace, create viewing edges oriented toward the finish line and provide access to the open lawn areas below
- 8. Graded lawn areas provide a link between the terrace and the open lawn for people and maintenance vehicles

9. 2m wide asphalt path to trackside lawn area (1:26 grade over 16m). Adjacent lawn to match grade of path.

#### LEGEND

|             | Site Boundar                                 |
|-------------|--|
| +98.000     | Proposed lev<br>EX = Existing<br>TOW = Top o |
|             | Contours                                     |
| <i>∠:XX</i> | Proposed fall                                |
| -           | Proposed tre                                 |



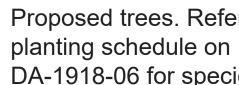



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vels g level of wall

lls

ees. Refer to DA-1918-06 for species

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DRAWING **GROUND FLOOR MASTERPLAN** 

DRAWING NO DA-1918-02 E jw/wl

DATE 22.01.2020




1:200@A1 1:400@A3


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Scale


### **GROUND FLOOR**

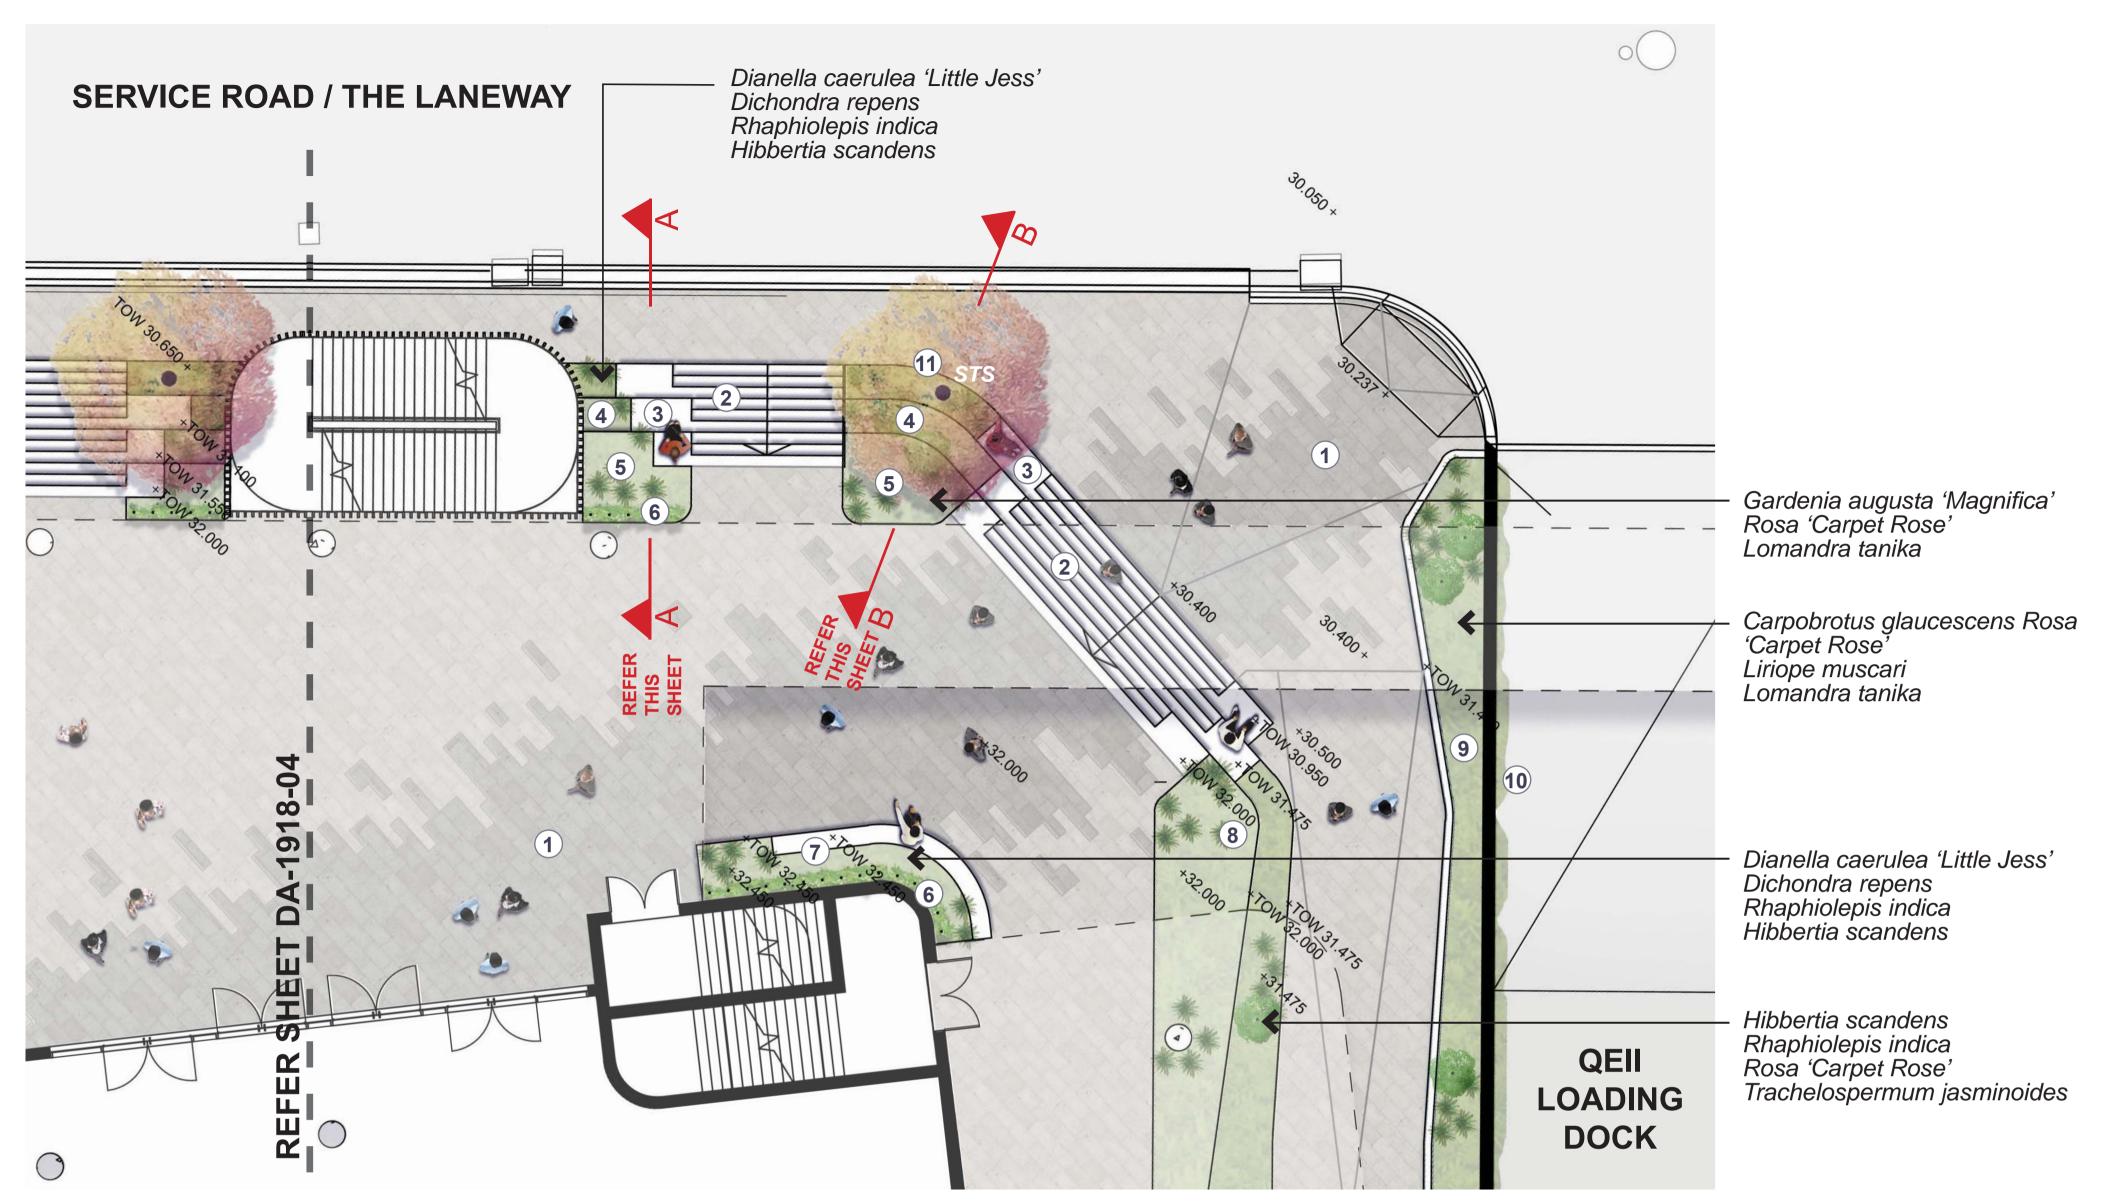

#### **CORNER ENTRY DETAIL PLAN** SCALE 1:100 @ A1

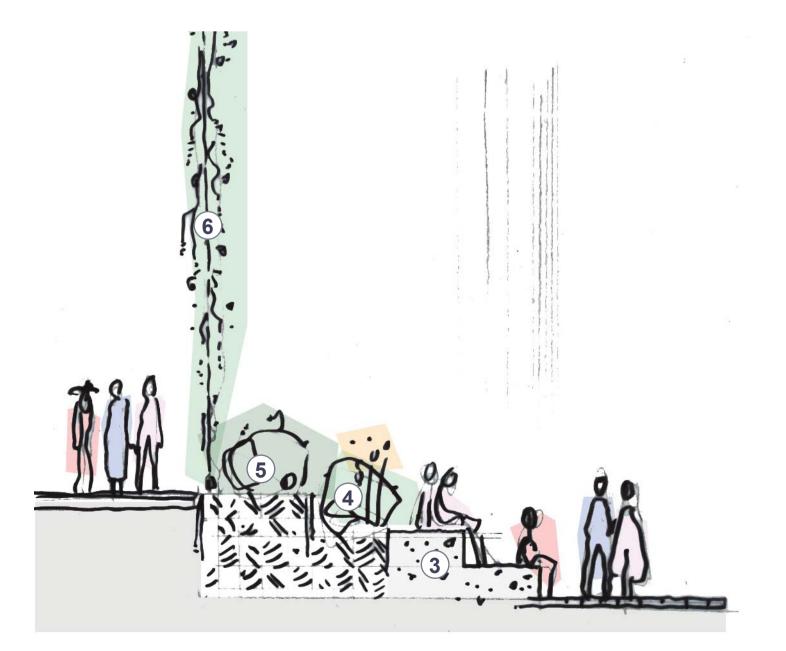

**SECTION A-A** SCALE 1:200 @ A1 REFER THIS SHEET

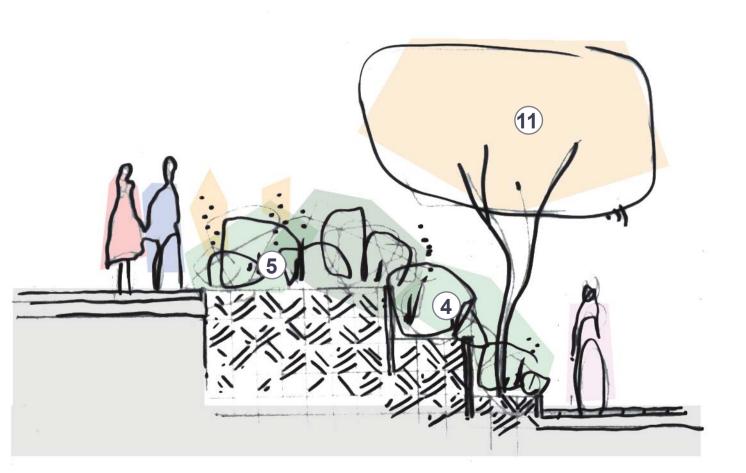

# **SECTION B-B**

SCALE 1:200 @ A1 REFER THIS SHEET

#### NOTES

- 1. Two tone paving defines entry to the Winx Stand
- 2. Wide entry stairs
- 3. Seating block ends to stairs provide informal seating areas
- 4. Planting and blade walls terrace down in line with seating blocks to the laneway, greening the change in level and providing edges to seating areas
- 5. Planting areas level with Winx Stand paving
- Stainless steel cables with native vines extend 6. from garden beds to the roof creating a flowering green curtain
- 7. Raised garden bed with lush planting and seating wall
- 8. Lush planting and blade walls create green terraces between the changes in paving level
- 9. 1m high raised planter creates green edge to path and helps direct pedestrians toward the racetrack.
- 10. Trailing plants green the wall of the QEII loading dock below
- 11. Medium sized feature tree provides seasonal interest



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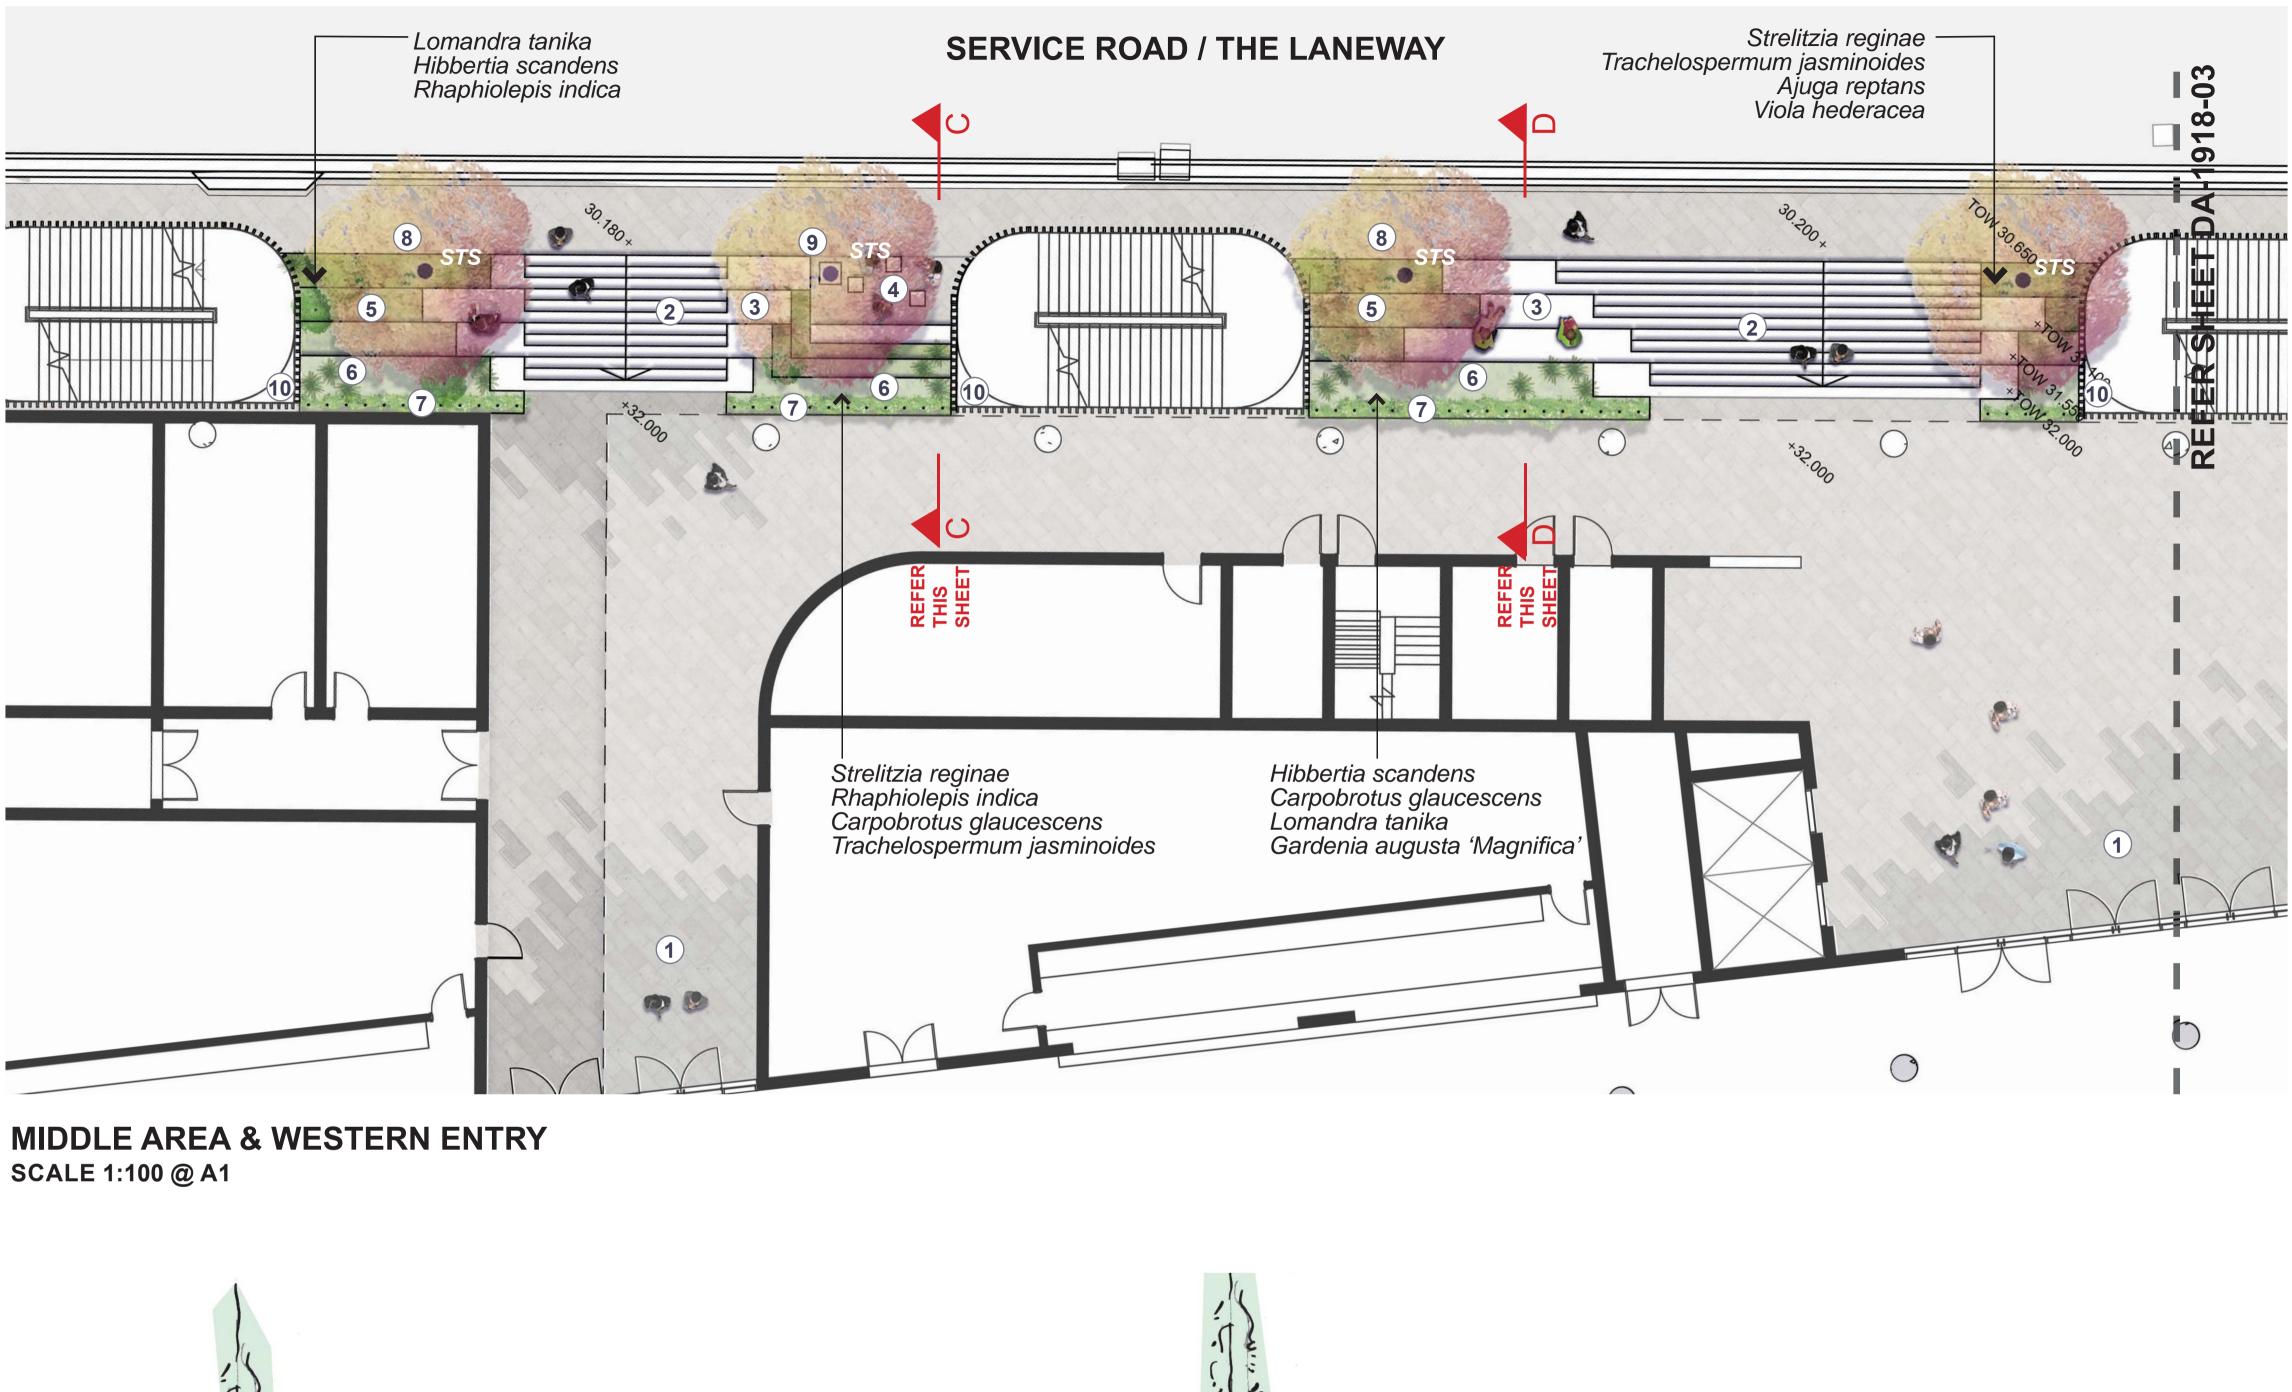
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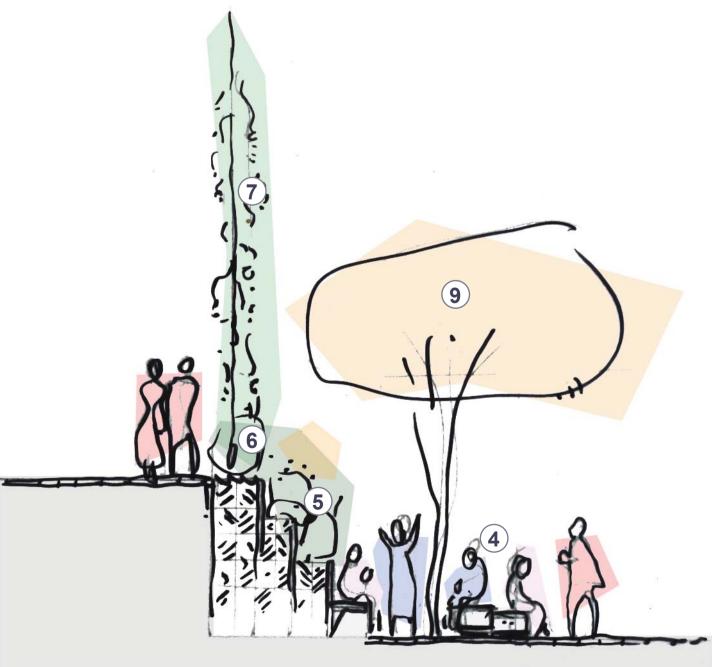
DRAWING **GROUND FLOOR CORNER ENTRY** 

**DRAWING No** DATE 30.10.2019 DA-1918-03 D jw/wl


:100@A1

#### **GROUND FLOOR**





**SECTION C-C** SCALE 1:200 @ A1 REFER THIS SHEET

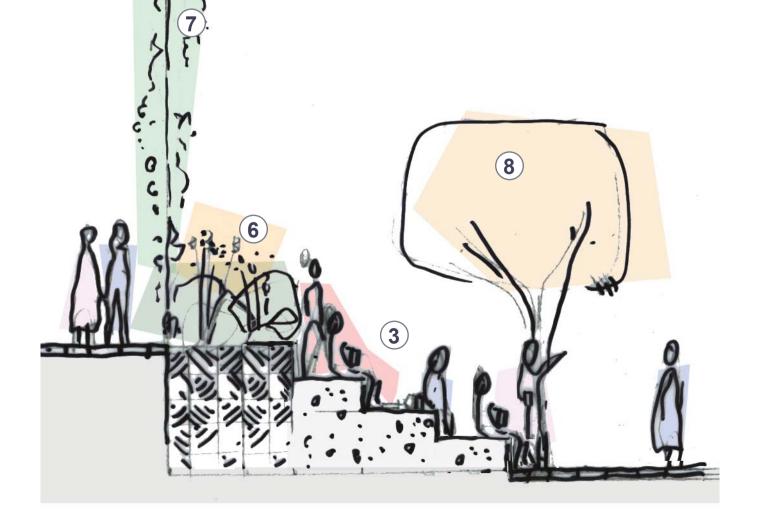

**SECTION D-D** SCALE 1:200 @ A1 REFER THIS SHEET

#### NOTES

- 1. Two tone paving defines entry to the Winx Stand
- 2. Wide entry stairs
- Seating block ends to stairs provide informal 3. seating areas
- Inset area with 900mm high standing / leaning 4. wall and block seats
- 5. Planting and blade walls terrace down in line with seating blocks to the laneway, greening the change in level and providing edges to seating areas
- 6. Planting areas level with Winx Stand paving
- Stainless steel cables with native vines extend 7. from garden beds to the roof creating a flowering green curtain
- 8. Medium sized feature tree provides seasonal interest
- 9. Medium sized feature tree set in tree grate in paved area
- 10. Runoff from fire stair roof top planters directed into ground area terraced garden beds



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DRAWING **GROUND FLOOR - MIDDLE AREA AND** WESTERN ENTRY DRAWING No. ISSUE DRAWN DATE

DA-1918-04 D


jw/wl

30.10.2019



1:100@A1

### LEVEL 1 AND ROOF

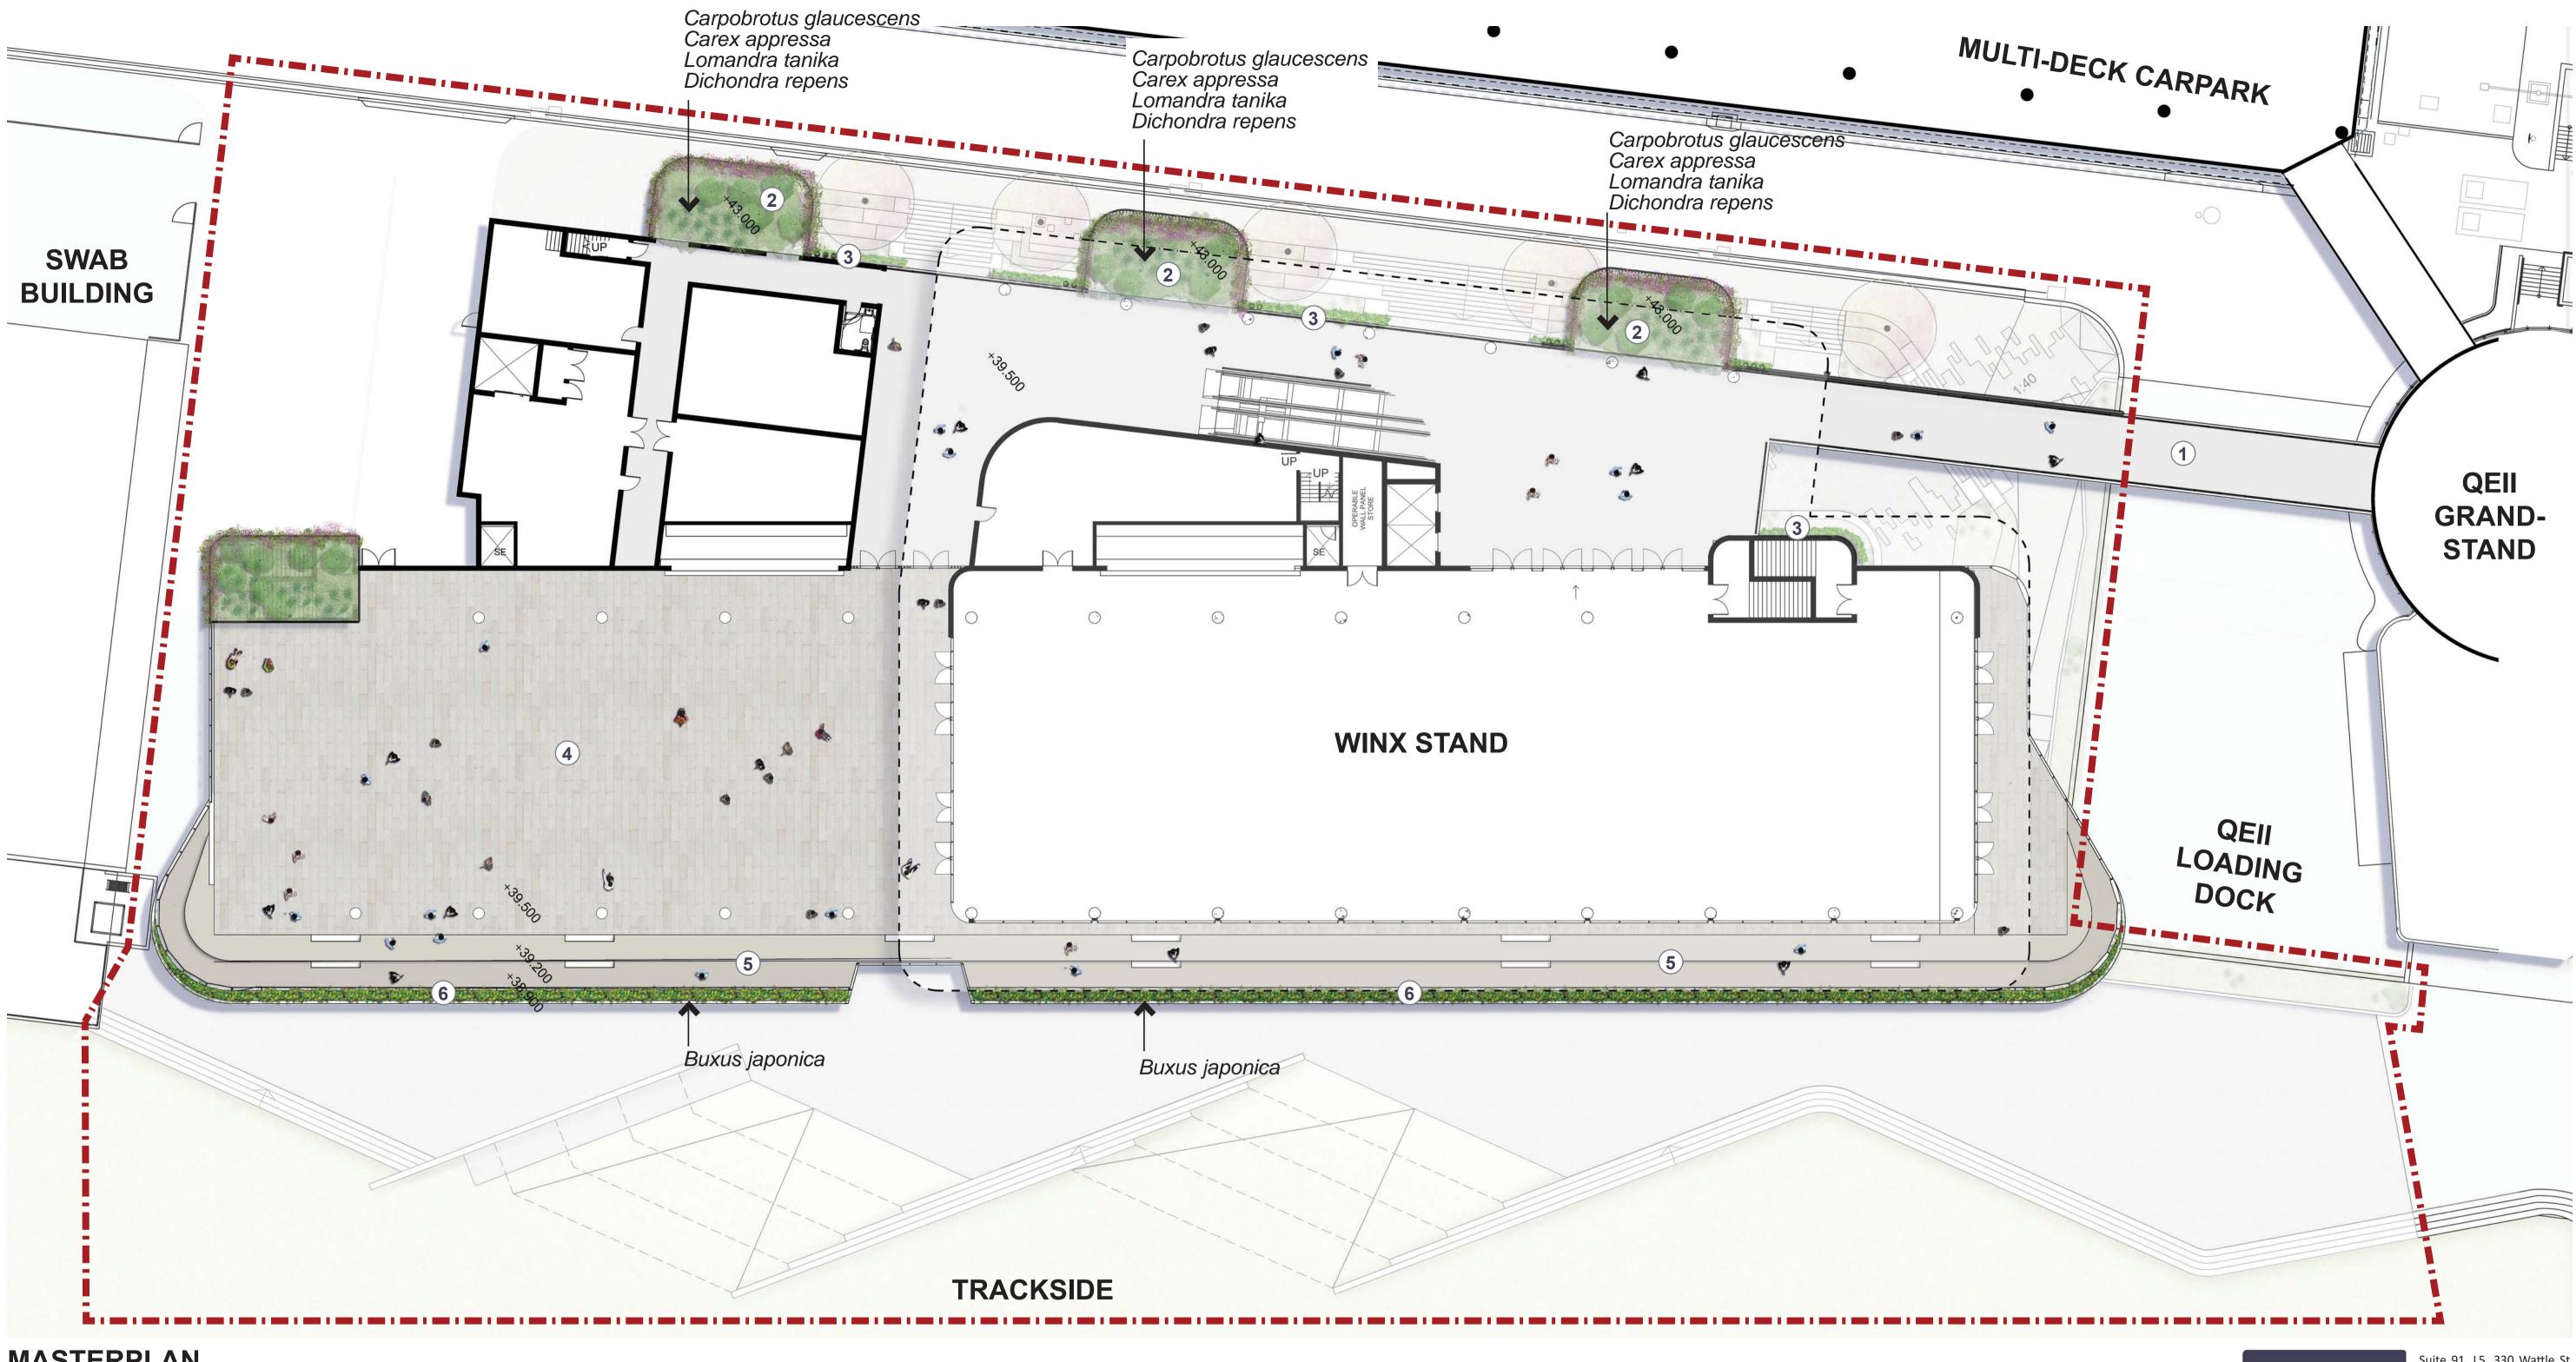

#### MASTERPLAN

#### NOTES

- 1. Pedestrian bridge to QEII Grandstand
- 2. Roof top planting to fire stairs. Trailing plants to cascade over edges
- 3. Stainless steel cables with native vines extend from garden beds to the roof creating a flowering green curtain
- 4. Level 1 terrace
- 5. Stepped edge to level 1 terrace

6. Low clipped box hedge to edge of level 1 terrace creates a green edge

LEGEND . . . . . . . . . . .

+98.000

Site Boundary



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DRAWING LEVEL 1 MASTERPLAN

DATE DRAWING No. DRAWN SSUF 22.01.2020 DA-1918-05 E jw/wl

Scale

10m 1:200@A1 1:400@A3

### SKETCH PERSPECTIVE



LOOKING SOUTH DOWN THE LANEWAY

#### NOTES

- 1. Wide entry stairs
- 2. Seating block ends to stairs provide informal seating areas
- Planting and blade walls terrace down in line with seating blocks to the laneway, greening the change in level and providing edges to seating areas
- 4. Medium sized feature tree provides seasonal interest
- 5. Stainless steel cables with native vines extend from garden beds to the roof creating a flowering green curtain
- 6. Roof top planting to fire stairs. Trailing plants to cascade over edges
- 7. Pedestrian bridge to QEII Grandstand



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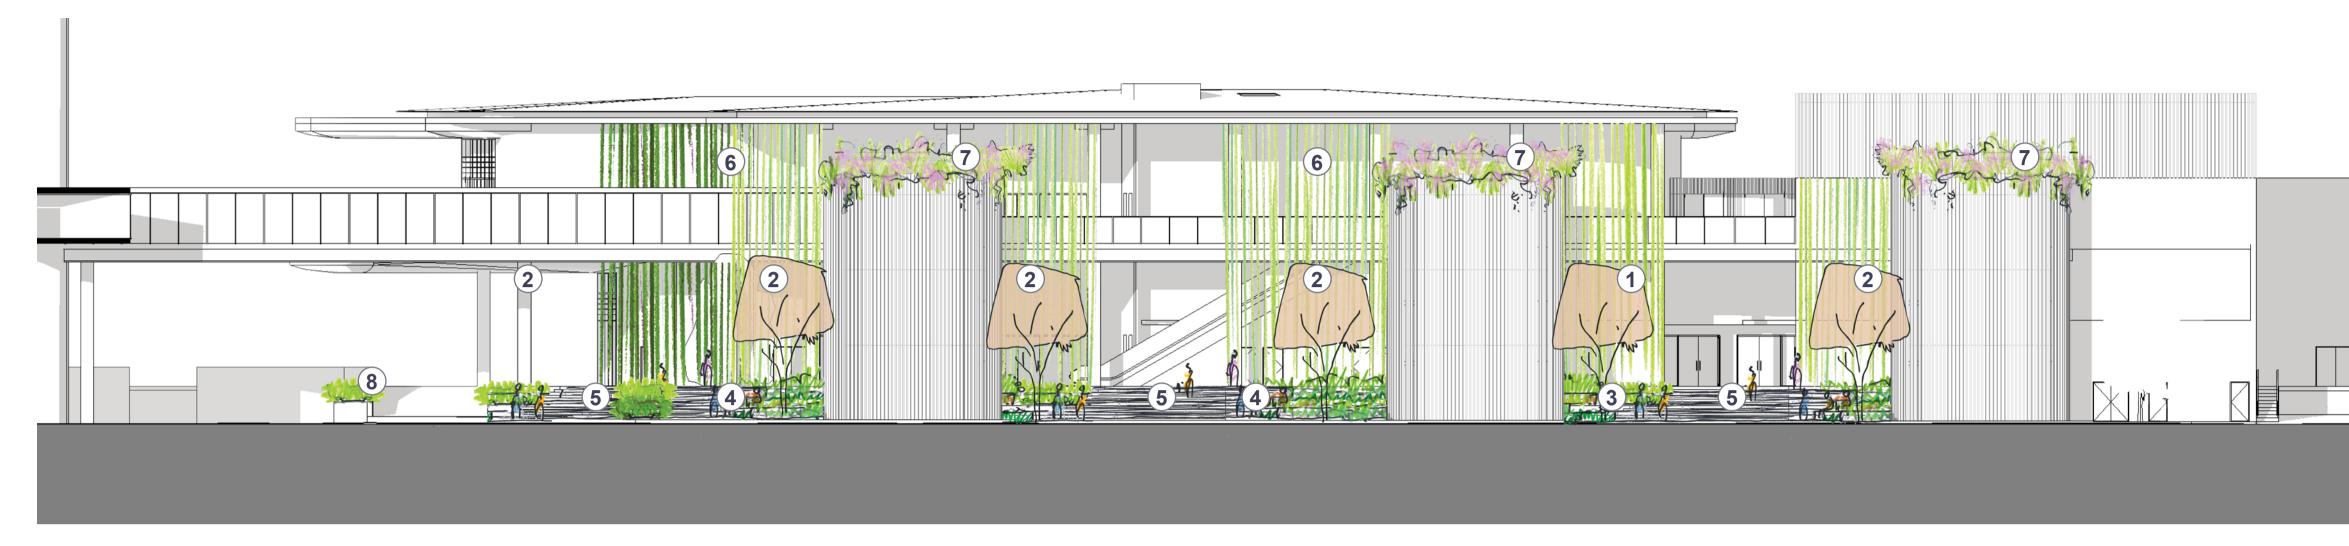
#### DRAWING SKETCH PERSPECTIVE

 DRAWING No.
 ISSUE
 DRAWN


 DA-1918-06
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 jw/wl

DATE **30.10.2019** 

### DESIGN ELEVATION



THE LANEWAY ELEVATION

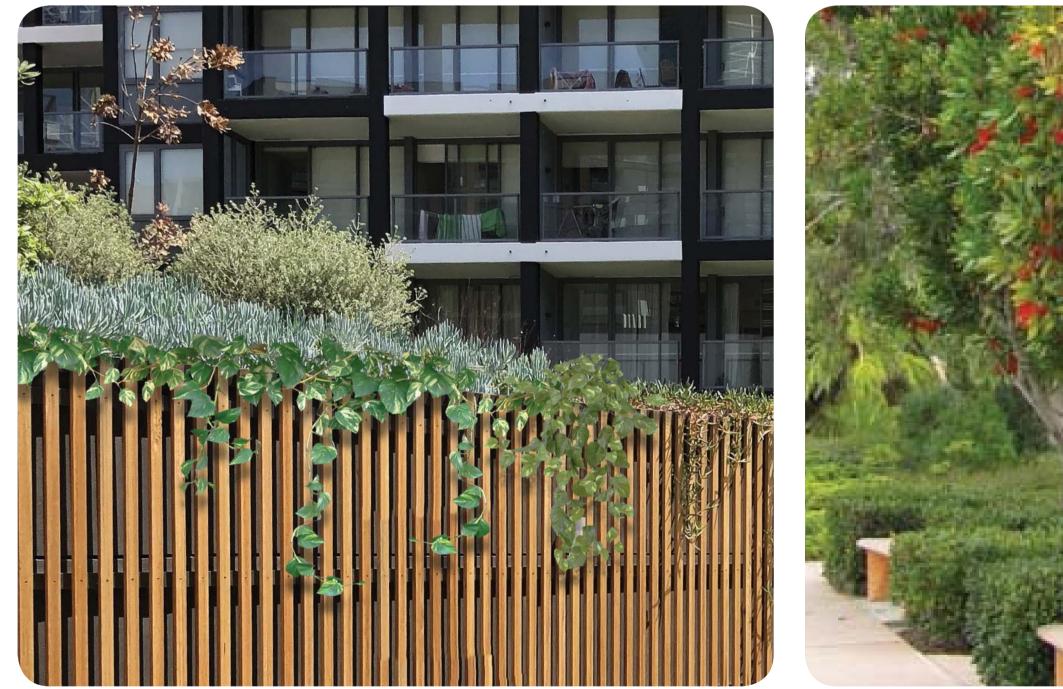

Trailing plants to cascade over edges

Feature tree planting





Planted terraces tie into stairs

#### NOTES

- 1. Medium sized feature tree set in tree grate in paved area
- Medium sized feature tree set in planting area provides seasonal interest
- Inset area with 900mm high standing / leaning wall and block seats
- 4. Seating block ends to stairs provide informal seating areas
- 5. Wide entry stairs
- 6. Stainless steel cables with native vines extend from garden beds to the roof creating a flowering green curtain
- Roof top planting to fire stairs. Trailing plants to cascade over edges
- 1m high raised planter creates green edge to path and helps direct pedestrians toward the racetrack.



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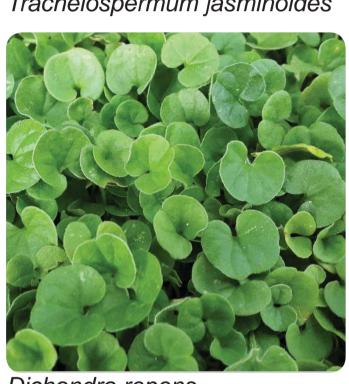
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#### DRAWING DESIGN ELEVATION

### INDICATIVE PLANTING SCHEDULE

|     | BOTANICAL NAME                              | COMMON NAME                | POT<br>SIZE | SPACING | HEIGHT &<br>WIDTH |
|-----|---|----------------------------|-------------|---------|-------------------|
|     | TREES                                       |                            |             |         |                   |
| STS | Stenocarpus sinuatus                        | Firewheel Tree             | 100L        | A.S.    | 15 x 6m           |
|     |   |                            |             |         |                   |
|     | SHRUBS & GROUNDCOVERS                       |                            |             |         |                   |
|     | Ajuga reptans                               | Blue Bugle                 | 150mm       | 0.3m    | 0.2 x 0.4m        |
|     | Buxus japonica                              | Japanese Box               | 5L          | 0.5m    | 1 x 0.5m          |
|     | Carex appressa                              | Tall Sedge                 | 150mm       | 0.5m    | 0.8 x 0.7m        |
|     | Carpobrotus glaucescens                     | Pigface                    | 150mm       | 0.3m    | 0.2 x 1m          |
|     | Dianella caerulea 'Little Jess'             | Blue Flax-Lily             | 150mm       | 0.6m    | 0.4 x 0.4m        |
|     | Dichondra repens                            | Kidney Weed                | Tube        | 0.2m    | 0.2 x 2m          |
|     | Gardenia augusta 'Magnifica'                | Gardenia                   | 5L          | 0.6m    | 1 x 0.5m          |
|     | Hibbertia scandens                          | Guinea flower              | 150mm       | 0.3m    | 4 x 1m            |
|     | <i>Liriope muscari</i> 'Evergreen<br>Giant' | Liriope Evergreen<br>Giant | 150mm       | 0.5m    | 0.6 x 0.5m        |
|     | Lomandra longifolia 'Tanika'                | Lomandra Tanika            | 150mm       | 0.5m    | 0.6 x<br>0.65m    |
|     | Rhaphiolepis indica 'Spingtime'             | Indian Hawthorn            | 5L          | 0.7m    | 2 x 3m            |
|     | Rosa noatraum 'Carpet Rose'                 | Carpet Rose                | 5L          | 0.7m    | 0.9 x 0.9m        |
|     | Strelitzia reginae                          | Bird of Paradise           | 25L         | 0.6m    | 1.5 x 1.5m        |
|     | Trachelospermum jasminoides                 | Star Jasmine               | 5L          | 0.5m    | 0.6 x 1m          |
|     | Viola hederacea                             | Native Violet              | Tube        | 0.2m    | 0.13 x 1m         |
|     |   |                            |             |         |                   |







#### PLANTING




Hibbertia scandens



Trachelospermum jasminoides

Dichondra repens

Carpobrotus glaucescens

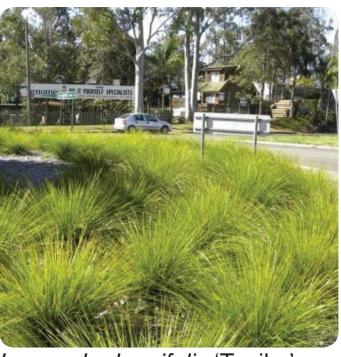

Lomandra longifolia 'Tanika'



Viola hederacea



Dianella caerulea 'Little Jess'



Ajuga reptans




Gardenia augusta 'Magnifica'


### PRECEDENT IMAGES



Two-tone paving

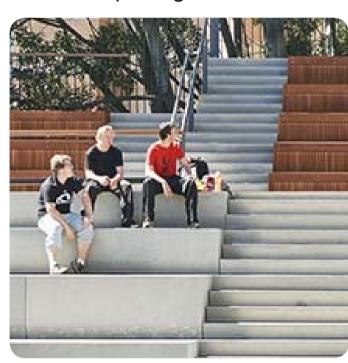


Seating steps

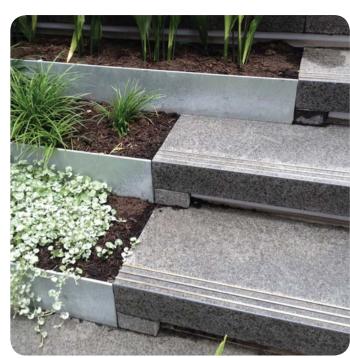





Terraced steps

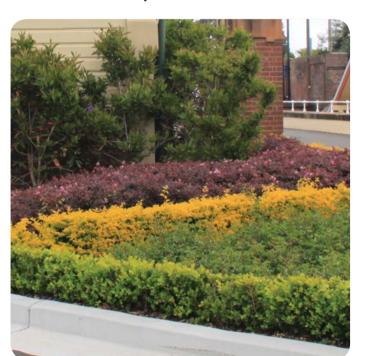

Layered planting



Concrete seating wall





#### Planting terraces

Planting and seating steps



Native vines to steel cables

Green roof to fire stairs

Raised concrete planter



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DRAWING INDICATIVE PLANTING SCHEDULE

DRAWING No. DA-1918-08 E

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